

**SEQUENCE OF CONSTRUCTION - STAGE 3**

**STAGE 3 TRAFFIC**  
 SET UP TEMPORARY TRAFFIC CONTROL USING THESE PLANS IN CONJUNCTION WITH STANDARD 701321.

INSTALL TEMPORARY TRAFFIC SIGNALS AND LOOP DETECTORS AT LOCATIONS SHOWN IN THESE PLANS AND IN STANDARD 701321.

PLACE TEMPORARY CONCRETE BARRIER AND PAVEMENT MARKING IN ACCORDANCE WITH THESE PLANS AND STANDARD 701321.

REMOVE ANY CONFLICTING PAVEMENT MARKINGS.

CHANNEL ALL TRAFFIC TO THE SOUTH SIDE OF IL ROUTE 16.

WREN ROAD WILL BE CLOSED DURING STAGE 3 USING STANDARD BLR 21.

**STAGE 3 CONSTRUCTION**  
 MODIFY TEMPORARY SOIL RETENTION SYSTEM AS NEEDED.

REMOVE AND REPLACE NORTH PORTION OF BOX CULVERT.

REMOVE AND REPLACE PAVEMENT ON NORTH SIDE OF IL ROUTE 16.

COMPLETE EARTHWORK, DRAINAGE, RIPRAP, AND SEEDING ON NORTH SIDE OF IL ROUTE 16.

REMOVE TEMPORARY GUARDRAIL FROM NORTH SIDE OF IL ROUTE 16.

**POST - STAGE TRAFFIC**

REMOVE TEMPORARY TRAFFIC SIGNALS AND TEMPORARY CONCRETE BARRIER.

OPEN WREN ROAD TO TRAFFIC.


SHIFT TRAFFIC AS NECESSARY TO INSTALL HMA SURFACE ON SHOULDER AND PAVEMENT USING STANDARD 701306.

**POST - STAGE CONSTRUCTION**

FOLLOWING COMPLETION OF STAGE 3 CONSTRUCTION, INSTALL HMA LEVELING BINDER AND SURFACE COURSE ON PAVEMENT AND SHOULDER, INSTALL AGGREGATE SHOULDERS, COMPLETE ENTRANCES AND SIDE ROADS, INSTALL FINAL STRIPING, AND COMPLETE FINAL EARTHWORK AND SEEDING.

**GENERAL STAGING NOTES**

- CONTRACTOR SHALL MAINTAIN ACCESS TO PRIVATE ENTRANCES AT ALL TIMES.
- ACCESS MUST BE PROVIDED TO ALL ENTRANCES. NO SIGNALS WILL BE REQUIRED.
- THIS TRAFFIC CONTROL PLAN SHALL BE USED IN CONJUNCTION WITH THE REFERENCED STANDARDS AND AS DIRECTED BY THE ENGINEER.
- TEMPORARY PAVEMENT MARKING AND WORK ZONE PAVEMENT MARKING REMOVAL REQUIRED FOR TRAFFIC CONTROL STANDARDS WILL NOT BE PAID FOR SEPARATELY.

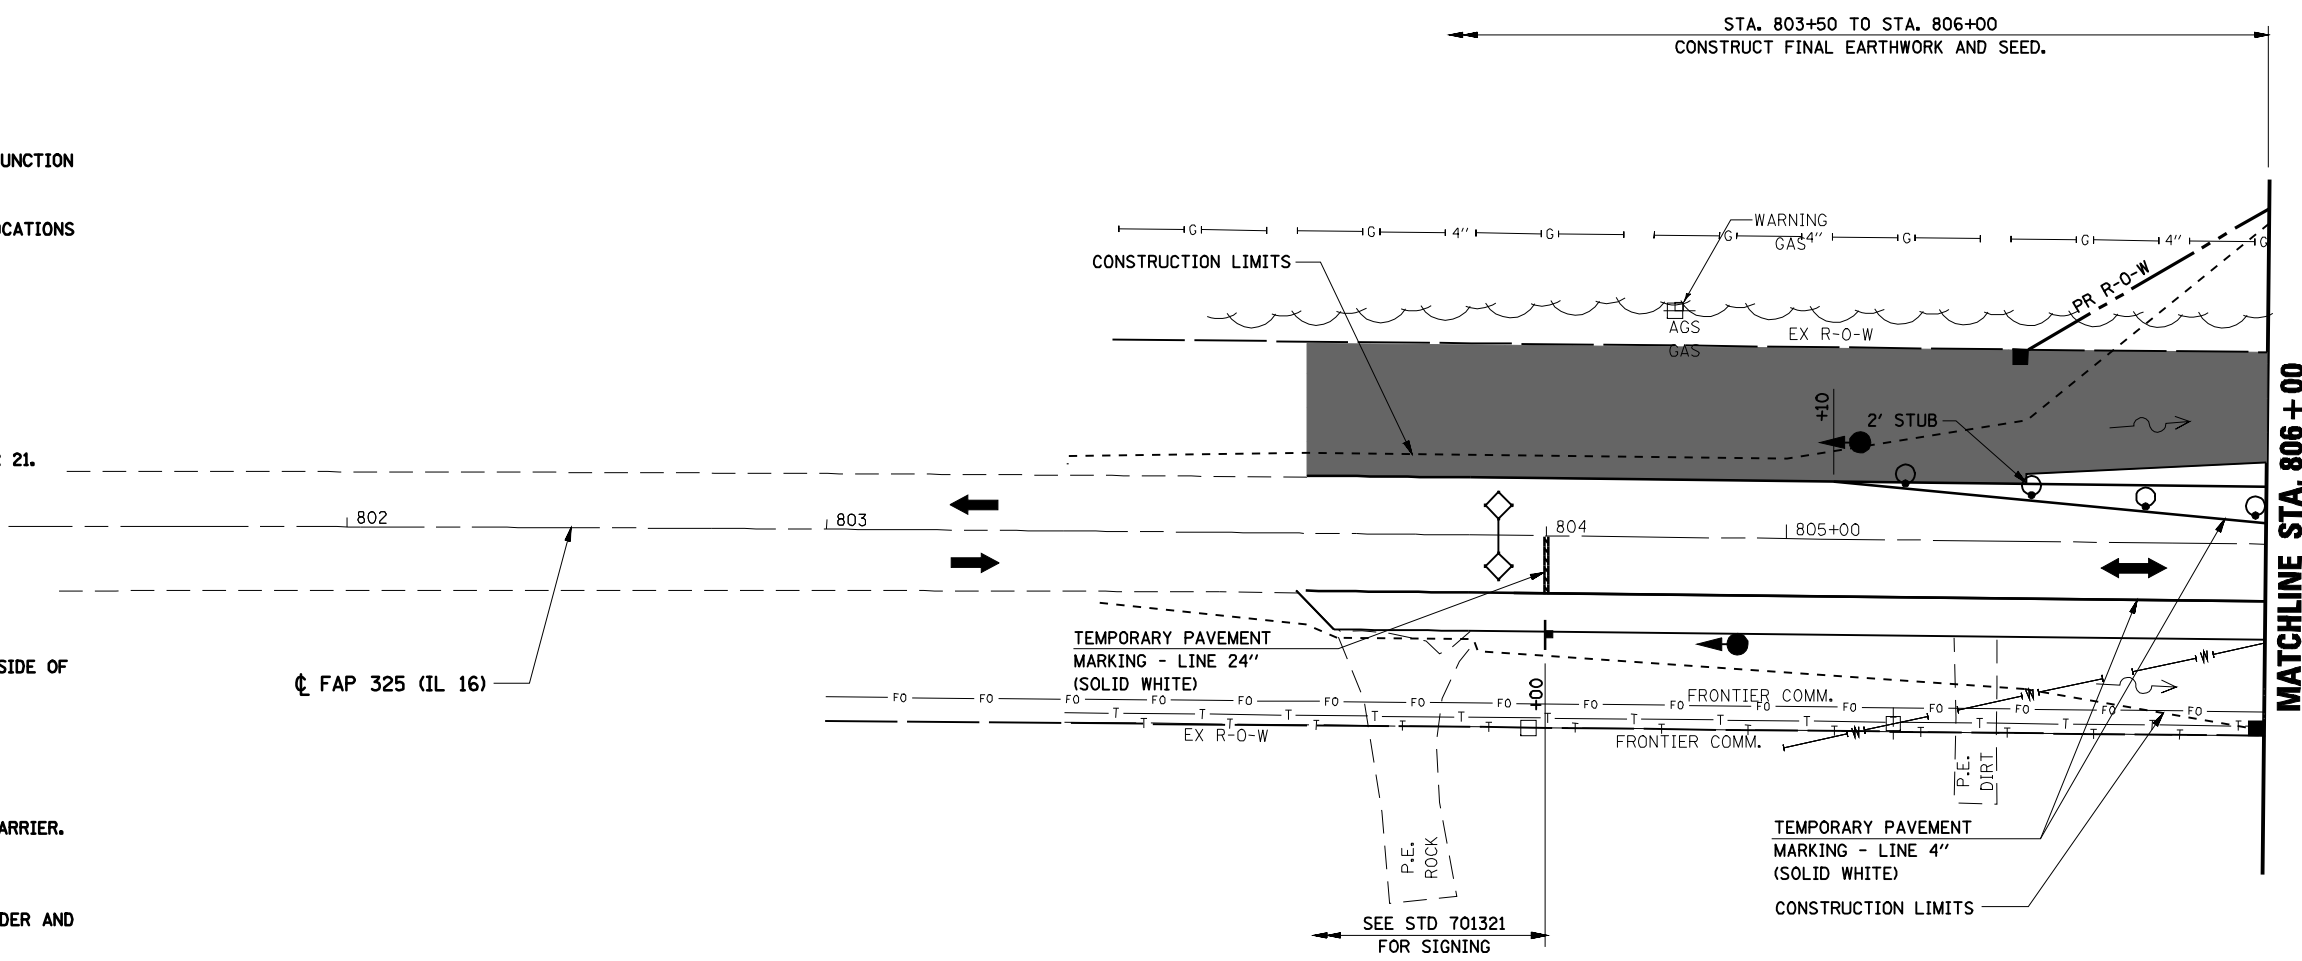

MATCHLINE STA. 806+00

**LEGEND**

- WORK AREA
- SIGN
- TYPE III BARRICADE
- DRUM WITH STEADY BURNING LIGHT
- TRAFFIC SIGNAL
- TYPE C BIDIRECTIONAL REFLECTOR
- TEMPORARY CONCRETE BARRIER
- IMPACT ATTENUATOR
- STEADY BURNING LIGHTS AND DOUBLE VERTICAL PANELS
- TRAFFIC FLOW

**NOTE:**

SEE "STORM WATER POLLUTION PREVENTION PLANS" FOR TEMPORARY EROSION CONTROL.

FILE NAME =	USER NAME = laughlinr1	DESIGNED -	REVISED -	<b>STATE OF ILLINOIS DEPARTMENT OF TRANSPORTATION</b>	<b>MAINTENANCE OF TRAFFIC STAGE 3</b>	F.A.P. RTE.	SECTION	COUNTY	TOTAL SHEETS	SHEET NO.
es:\pwork\PWIDOT\LAUGHLINRL\0169540\803\STAGING3.dgn	DRAWN - TRF	REVISED -	325			114 (B-1)	MACOUPIN	57	22	
PLOT SCALE = 40.0000' / IN.	CHECKED - RG	REVISED -	CONTRACT NO. 72646							
PLOT DATE = Oct-21-2009 11:05:59AM	DATE - 7/31/09	REVISED -	ILLINOIS FED. AID PROJECT							
					SCALE: 1"=20'	SHEET NO. OF SHEETS		STA. 803+50 TO STA. 806+00		