


| NAMEPLATES | | |
|------------|--------|-------------------------|
| NAME PLATE | LINE | ENGRAVING |
| NP 1 | LINE 1 | CONTROL POWER AVAILABLE |
| | LINE 2 | SERVICE 1 FAILURE |
| NP 3 | LINE 1 | FIRE ALARM TROUBLE |
| | LINE 2 | FIRE ALARM |
| NP 4 | LINE 1 | - |
| | LINE 2 | - |
| NP 5 | LINE 1 | ELEVATOR PIT HIGH WATER |
| | LINE 2 | INTRUSION |
| NP 6 | LINE 1 | - |
| | LINE 2 | - |
| NP 7 | LINE 1 | - |
| | LINE 2 | - |
| NP 8 | LINE 1 | COMMON ALARM |
| | LINE 2 | ON OFF DUTY DUTY |
| NP 9 | LINE 1 | ALARM |
| | LINE 2 | RESET |
| NP 10 | LINE 1 | ALARM |
| | LINE 2 | SILENCE |
| NP 11 | LINE 1 | - |
| | LINE 2 | - |


NAMEPLATES 1" X 2" WHITE WITH BLACK 1/8" LETTERS ATTACHED WITH STAINLESS STEEL HARDWARE

| BILL OF MATERIAL | | | | |
|------------------|------|----------------------|----------------|---|
| ITEM NO. | QTY. | MANUFACTURER | CATALOG NUMBER | DESCRIPTION |
| 1 | 1 | ILLINOIS SWITCHBOARD | BY DESCRIPTION | GASKETTED CONSOLE STYLE ENCLOSURE SIMILAR TO HOFFMANN C-12C16 EXCEPT MADE FROM 304 STAINLESS STEEL BRUSH FINISH |
| 2 | 6 | EATON | 10250T297LRP2A | FULL VOLTAGE PUSH TO TEST INDICATING LIGHT WITH RED LENS AND RED LED |
| 3 | 1 | EATON | 10250T297LGP2A | FULL VOLTAGE PUSH TO TEST INDICATING LIGHT WITH GREEN LENS AND GREEN LED |
| 4 | 1 | EATON | 10250T297LAP2A | FULL VOLTAGE PUSH TO TEST INDICATING LIGHT WITH AMBER LENS AND AMBER PUSH TO TEST |
| 5 | 1 | EATON | 10250T3011 | BLACK LEVER OPERATED 2 POSITION SELECTOR SWITCH 1 N.O. CONTACT BLOCK |
| 6 | 1 | EATON | 10250T101 | BLACK PUSH BUTTON OPERATOR 1 N.O. CONTACT BLOCK |
| 7 | 1 | EATON | 10250T53 | BLACK PUSHBUTTON OPERATOR 1 N.C. CONTACT BLOCK |
| 8 | 1 | MALLORY | SC110R | SONALERT ALARM BUZZER CONTINUOUS TONE 120V AC 80dB |
| 9 | 3 | SQD | 8501NR61 | 11 PIN SOCKET DIN RAIL MOUNT |
| 10 | 3 | SQD | RUMC3AB2F7 | 3 PDT RELAY FULL FEATURE 120 VOLT AC COIL |
| 11 | 3 | SQD | RUZC200 | RELAY HOLD DOWN CLIP |
| 12 | 11 | USD | NSS3 | 3 POINT 30 AMP 600 VOLT, SCREW TYPE TERMINAL BLOCK |

ALL CONTROL WIRING AWG #14 TYPE SIS ASSEMBLY TO BEAR UL INDUSTRIAL CONTROL LABEL

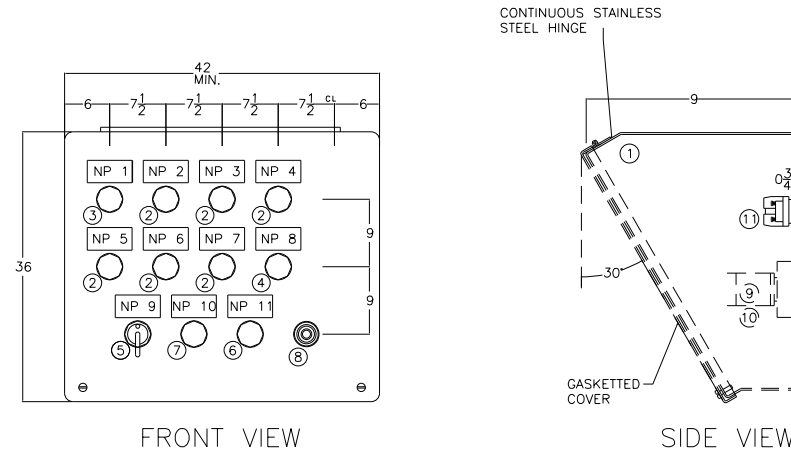

2 REMOTE KIOSK PANEL
SCALE: NTS

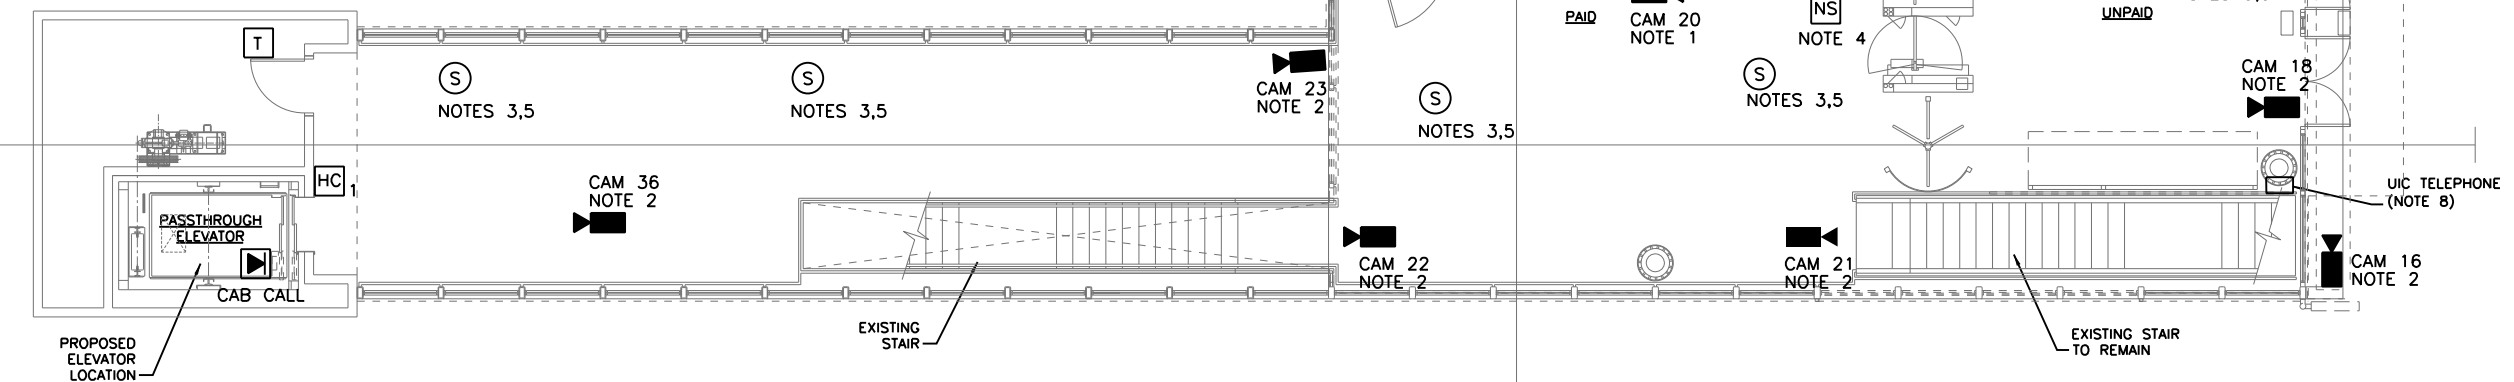

1 COMMUNICATIONS PLAN
SCALE: 3/16" = 1'-0"

- NOTES:**
1. PROVIDE NEW CCTV CAMERAS. REMOVE EXISTING CAMERAS AND HAND OVER TO CTA.
 2. NEW CAMERA, INSTALL AT LOCATION AS SHOWN.
 3. NEW SPEAKER INSTALL AT LOCATION AS SHOWN.
 4. NEW EQUIPMENT. INSTALL AT LOCATION AS SHOWN.
 5. SPEAKER MOUNTED IN FILLER SECTION OF CONTINUOUS LTG. PROVIDE INSULATED BACK BOX. REFER TO LIGHTING PLAN FOR EXACT LOCATION.
 6. EXISTING EQUIPMENT IN RELOCATED POSITION.
 7. PROVIDE WALL FIELD WITH PUNCH DOWN TERMINAL BLOCKS.
 8. PROVIDE 3/4" EMPTY CONDUIT TO COMM. ROOM. SEE ELECTRICAL SITE PLAN FOR ADDITIONAL WORK.

AAA ENGINEERING
W8/DBE CERTIFIED
3940 West Touhy Avenue, Suite 210, Niles, IL 60714
Phone: 847-647-9999 • Fax: 847-647-4719

TranSystems

| | | |
|-----------------------------|------------|---------|
| USER NAME = habib | DESIGNED - | REVISED |
| | CHECKED - | REVISED |
| PLOT SCALE = 10:8 "1" / in. | DRAWN - | REVISED |
| PLOT DATE = 10/28/2013 | CHECKED - | REVISED |

**STATE OF ILLINOIS
DEPARTMENT OF TRANSPORTATION**

**PEORIA STREET STATION
COMMUNICATION STATION LEVEL EQUIPMENT PLAN**

SHEET NO. 107 OF 117 SHEETS

PRELIMINARY NOT FOR CONSTRUCTION

| MUN | SECTION | COUNTY | TOTAL SHEETS | SHEET NO. |
|--------------|-----------|--------|--------------|-----------|
| 2090 | 2013-011R | COOK | 356 | 298 |
| CONTRACT NO. | | | 60W29 | |

ILLINOIS FED. AID PROJECT

7:16:44 PM 298-60W29.dgn

