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STATE OF ILLINOIS

DEPARTMENT OF TRANSPORTATION

PROPOSED HIGHWAY PLANS


F.A.I. ROUTE 57: I-57

AT IL ROUTE 1 (HALSTED ST.)

SECTION: 2019–056–BR **PROJECT: STP**–0652(581)

BRIDGE & JOINT REPAIR, BRIDGE DECK OVERLAY

COOK COUNTY C-91-417-19

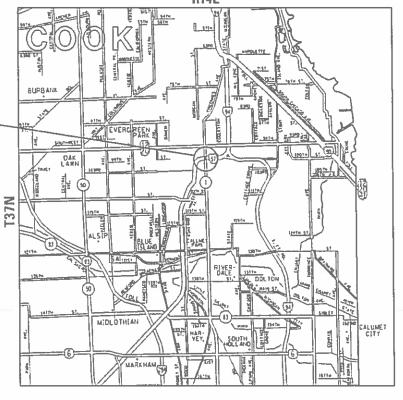

LAKE TOWNSHIP

GROSS LENGTH = 250 FT. = 0.0473 MILE

NET LENGTH = 250 FT. = 0.0473 MILE


FOR INDEX OF SHEETS, SEE SHEET NO. 2

TRAFFIC DATA
IL RTE 1:
EXISTING ADT = 26600 (2018)

I-57: EXISTING ADT = 128800 (2018) POSTED SPEED LIMIT = 55 MPH

POSTED SPEED LIMIT = 30 MPH

THE IMPROVEMENT IS LOCATED IN THE CITY OF CHICAGO

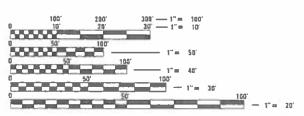

LOCATION OF

IMPROVEMENT:

SN 016-2036

FULL SIZE PLANS HAVE BEEN PREPARED USING STANDARD ENGINEERING SCALES. REDUCED SIZED PLANS WILL NOT CONFORM TO STANDARD SCALES. IN MAKING MEASUREMENTS ON REDUCED PLANS, THE ABOVE SCALES MAY BE USED.

C.U.A.N. CHICAGO UTILITY ALERT NETWORK 1-312-744-7000

PROJECT ENGINEER: ALAIN MIDY (847) 221–3056
PROJECT MANAGER: FAWAD AQUEEL (847) 705–4247

CONTRACT NO. 62J33

D-91-183-19

STATE OF ILLINOIS
DEPARTMENT OF TRANSPORTATION

SUBMITTED OCTOPES SOLVEN HEGIONAL ENGINEER

ENGINEER OF DESIGN AND ENVIRONMENT

20

DIRECTOR OF HIGHWAYS PROJECT IMPLEMENTATION

LOCATION OF SECTION INDICATED THUS: - -

PRINTED BY THE AUTHORITY OF THE STATE OF ILLINOIS

INDEX OF SHEETS

	COVER SHEET
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-4	SUMMARY OF QUANTITIES
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1	TRAFFIC CONTROL TYPICAL SECTIONS (IL ROUTE 1 - HALSTED ST.)
5-18	TRAFFIC CONTROL STAGING (IL ROUTE 1 - HALSTED ST.)
9	TRAFFIC CONTROL TYPICAL SECTIONS (I-57)
D-21	TRAFFIC CONTROL STAGING (I-57)
2-23	PROPOSED PAVEMENT MARKING
4	TRAFFIC CONTROL AND PROTECTION FOR SIDEROADS, INTERSECTIONS AND DRIVEWAYS (TC-10) $$
5	TRAFFIC CONTROL AND PROTECTION AT TURNBAYS (TC-14)
ô	SHORT TERM PAVEMENT MARKING LETTERS AND SYMBOLS (TC-16)
7	TRAFFIC CONTROL DETAILS FOR FREEWAY SHOULDER CLOSURES AND PARTIAL RAMP CLOSURES (TC-17)
В	ARTERIAL ROAD INFORMATION SIGN (TC-22)
9-31	CITY OF CHICAGO TYPICAL PAVEMENT MARKINGS (TC-24)

STATE STANDARDS

701101-05	OFF-RD OPERATIONS, MULTILANE, 15' (4.5 m) TO 24" (600 mm) FROM PAVEMENT EDGE
701427-05	LANE CLOSURE, MULTILANE, INTERMITTENT OR MOVING OPER., FOR SPEEDS < 40 MPH
701601-09	URBAN LANE CLOSURE, MULTILANE, 1W OR 2W WITH NONTRAVERSABLE MEDIAN
701701-10	URBAN LANE CLOSURE, MULTILANE INTERSECTION
701801-06	SIDEWALK, CORNER OR CROSSWALK CLOSURE
701901-08	TRAFFIC CONTROL DEVICES

GENERAL NOTES – LIGHTING

 MEADE ELECTRIC CO. DISTRICT ONE ELECTRICAL MAINTENANCE CONTRACTOR LOCATES IDOT ELECTRICAL EQUIPMENT AND UNDERGROUND CABLES 773-287-7672

GENERAL NOTES


- 1. BEFORE STARTING ANY EXCAVATION, THE CONTRACTOR SHALL CALL C.U.A.N. AT (312) 744-7000 FOR FIELD LOCATIONS OF BURIED ELECTRIC, TELEPHONE AND GAS UTILITIES. (48 HOUR NOTIFICATION IS REQUIRED).
- 2. THE CONTRACTOR SHALL COORDINATE CONSTRUCTION ACTIVITIES WITH UTILITY COMPANIES AND THE CITY OF CHICAGO.
- 3. THE CONTRACTOR WILL NOT BE ALLOWED TO SET UP A YARD OR FIELD OFFICE ON STATE PROPERTY WITHOUT WRITTEN PERMISSION FROM THE DEPARTMENT.
- 4. ALL DAMAGE TO EXISTING PAVEMENT MARKINGS OR RAISED REFLECTIVE PAVEMENT MARKERS OUTSIDE THE REMOVAL LINE SHOWN ON THE PLANS SHALL BE REPLACED AT NO ADDITIONAL COST TO THE DEPARTMENT.
- 5. BEFORE BEGINNING ANY WORK, THE CONTRACTOR SHALL RETAIN AND RECORD FOR FUTURE REFERENCE, ALL EXISTING PAVEMENT MARKING LINES (AND RAISED REFLECTIVE PAVEMENT MARKERS) IN ORDER THAT THESE LOCATIONS CAN BE RE-ESTABLISHED FOR STRIPING. EXACT LOCATIONS OF ALL PAVEMENT MARKINGS SHALL BE AS DIRECTED BY THE ENGINEER.
- 6. IT SHALL BE THE CONTRACTORS RESPONSIBILITY TO VERIFY ALL DIMENSIONS AND CONDITIONS EXISTING IN THE FIELD PRIOR TO CONSTRUCTION AND ORDERING OF MATERIALS.
- 7. THE CONTRACTOR SHALL CONTACT THE DISTRICT ONE TRAFFIC CONTROL SUPERVISOR AT KALPANA.KANNAN-HOSADURGA@ILLINOIS.GOV FOR ARTERIALS AND (847) 705-4151 FOR EXPRESSWAYS A MINIMUM OF 72 HOURS IN ADVANCE OF BEGINNING WORK.
- 8. THE CONTRACTOR SHALL REQUEST AND GAIN APPROVAL FROM THE ILLINOIS DEPARTMENT OF TRANSPORTATION'S EXPRESSWAY TRAFFIC OPERATIONS ENGINEER AT WWW.IDOTLCS.COM AT LEAST 24 HOURS IN ADVANCE OF ALL DAILY LANE, RAMP, AND SHOULDER CLOSURES AND 7 DAYS IN ADVANCE OF ALL PERMANENT AND WEEKEND CLOSURES ON ALL FREEWAYS AND/OR EXPRESSWAYS. THIS ADVANCE NOTIFICATION IS CALCULATED BASED ON WORKWEEK OF MONDAY THROUGH FRIDAY AND SHALL NOT INCLUDE WEEKENDS AND HOLIDAYS.
- 9. THE ENGINEER SHALL EMAIL PATRICE HARRIS, AREA TRAFFIC FIELD TECHNICIAN, AT PATRICE.HARRIS@ILLINOIS.GOV A MINIMUM OF TWO (2) WEEKS PRIOR TO THE PLACEMENT OF PERMANENT PAVEMENT MARKINGS.
- 10. THESE PLANS HAVE BEEN PREPARED FROM NOTES RECEIVED FROM THE BUREAU
- 11. THE CONTRACTOR SHALL BE REQUIRED TO PROVIDE ACCESS TO ABUTTING PROPERTY AT ALL TIMES DURING THE CONSTRUCTION OF THIS PROJECT.
- 12. DO NOT SCALE PLANS FOR CONSTRUCTION DIMENSIONS.
- 13. THE "ARTERIAL ROAD INFORMATION SIGN (TC-22)" IS APPLICABLE ONLY TO ARTERIAL ROADS AND SHALL NOT BE APPLIED TO EXPRESSWAYS/TOLLWAYS.

USER NAME = rothjp	DESIGNED -	REVISED -
	DRAWN -	REVISED -
PLOT SCALE = 100.0000 ' / in.	CHECKED -	REVISED -
PLOT DATE = 10/16/2019	DATE -	REVISED -

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[SUMMARY OF QUANTITIES				CONST	TRUCTION	TYPE C	ODE			SLIMMAE	RY OF QUANTITIES				CON	STRUCTION	TYPE CO	DE	
	CODE NO	ITEM	UNIT	URBAN TOTAL QUANTITIES	0013 20% STATE 80% FED.						CODE NO	55	ITEM	UNIT	URBAN TOTAL QUANTITIES	0013 20% STATE 80% FED.					
	X0900053	PREFORMED JOINT SEAL 2 1/4"	FOOT	108.5	108.5					*	78009006	MODIFIED URE	THANE PAVEMENT MARKING -	FOOT	294	294					
	64300450	IMPACT ATTENUATORS (NON-REDIRECTIVE), TEST LEVEL 3	EACH	1	1							LINE 6"									
ĺ	52000040	PREFORMED JOINT SEAL 3 1/2"	FOOT	108.5	108.5					*	78200011	BARRIER WALL RE	EFLECTORS, TYPE C	EACH	8	8					
										*	x0327577	PROTECT AND	MAINTAIN EXISTING UNDERPASS	L SUM	1	1					
	67000400	ENGINEER'S FIELD OFFICE. TYPE A	CAL MO	6	6							LUMINAIRE									
			_																		
	67100100	MOBILIZATION	L SUM	1	1						x0327980		KING REMOVAL - WATER	SO FT	1065	1065					
	70200100	NIGHTTIME WORK ZONE LIGHTING	L SUM	1	1							BLASTING									
					•						x5870015	BRIDGE DECK	CONCRETE SEALER	SO FT	3740	3740					
	70300900	PAVEMENT MARKING TAPE, TYPE IV -	SO FT	301.6	301.6																
		LETTERS AND SYMBOLS									X7010216	TRAFFIC CONT	ROL AND PROTECTION.	L SUM	1	1					
												(SPECIAL)									
	70300904	PAVEMENT MARKING TAPE, TYPE IV 4"	FOOT	7432	7432																
	70400100	TEMPORARY CONCRETE BARRIER	FOOT	250	250						X7011015	TRAFFIC CONT	ROL AND PROTECTION	L SUM	1	1					
	70300906	PAVEMENT MARKING TAPE, TYPE IV 6"	FOOT	469	469							(EXPRESSWAYS	1								
*	78000200	THERMOPLASTIC PAVEMENT MARKING - LINE	FOOT	652	652						x7030005	TEMPORARY PA	VEMENT MARKING REMOVAL	SO FT	2478	2478					
		4"									Z0012102	CONCRETE BRI	DGE DECK SCARIFICATION 3/8	SO YD	1701	1701					
*	78000400	THERMOPLASTIC PAVEMENT MARKING - LINE	FOOT	567	567						20012102	INCH	DGE DECK SCARIFICATION 376	30 10	1701	1701		<u> </u>			1
/\`		6"																			
											Z0012193	BRIDGE DECK	THIN POLYMER OVERLAY 3/8"	SQ YD	1701	1701					
*	78000650	THERMOPLASTIC PAVEMENT MARKING - LINE	F00T	87	87																
		24"									Z0012754	STRUCTURAL R	EPAIR OF CONCRETE (DEPTH	SO FT	1218	1218					
												EQUAL TO OR	LESS THAN 5 INCHES)								
*	78009000	MODIFIED URETHANE PAVEMENT MARKING -	SO FT	72.8	72.8																
		LETTERS AND SYMBOLS									Z0012755	STRUCTURAL R	EPAIR OF CONCRETE (DEPTH	SO FT	12	12					
									1			GREATER THAN	5 INCHES)						1		
*	78009004	MODIFIED URETHANE PAVEMENT MARKING -	FOOT	1250	1250																
		LINE 4"	100.5								Z0030850	TEMPORARY IN	FORMATION SIGNING	SO FT	102.8	102.8	Ir			1 -	1014/ /5::55
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		PLOT SCALE = 100,0000 '/ In. CHE PLOT DATE = 10/18/2019 DAT	CKED -		REVISED REVISED			DI	EPARTME	NI OF TR	ANSPORTA	IIUN	SCALE: SHEET NO. 1 OF 2 SHE			D STA.	FED. ROAD	DIST. NO. 1 (ILLI			NO. 62J33

	SUMMARY OF QUANTITIES			CONSTRUCTION	ON TYPE C	ODE			CUMMA	UDV OF QUANTITIES			CO	NSTRUCTION	I TYPE COD	E
	SUMMART OF QUANTITIES		URBAN 0013						SUMMA	ARY OF QUANTITIES		URBAN 0005				
CODE NO	ITEM	UNIT	URBAN TOTAL 0013 20% STATE 80% FED.					CODE NO		ITEM	UNIT	OUANTITIES 80% FED.				
Z0073200	TEMPORARY SHORING AND CRIBBING	EACH	4 4													
1																
FILE NAME = pw:\\planroom.dotJIIInol.	USER NAME = rdthjp Spon-PHIDOT\Documents\DOT Of (rlees\District \text{NFro} jeds\District \text{SIB3/9\CADdata\Design\District}) District Spon-PHIDOT\Documents\DOT Of (rlees\District \text{NFro} jeds\District \text{District})		REVISED - REVISED -		-	STA	ATE OF	ILLINOIS	FION	I-57 AT	IL ROUTE 1 (HAL)	STED ST.) Fities	F.A.I. RTE. 57	SECTION 2019-056-	-BR	OUNTY TOTAL SHE SHEETS NO COOK 31 4
	PLOT SCALE = 100,0000 ' / In. PLOT DATE = 10/18/2019	CHECKED - DATE -	REVISED - REVISED -		D	EPARTMEI	NI OF T	RANSPORTAT	IIUN		OF 2 SHEETS ST.		FED. RO	AD DIST. NO. 1 ILL	INOIS FED. AID PRO	ONTRACT NO. 62J3

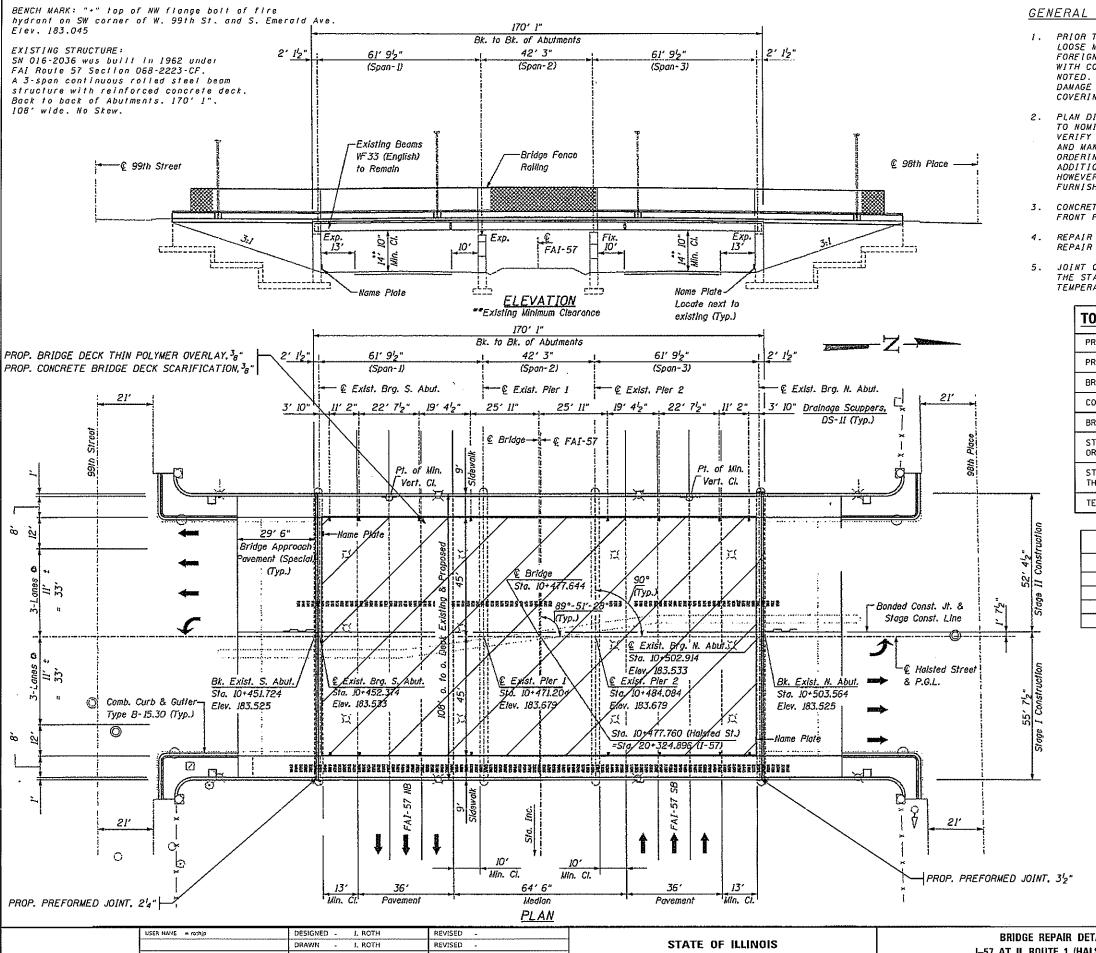

GENERAL NOTES:


- 1. PRIOR TO THE POURING OF NEW CONCRETE. ALL HEAVY OR LOOSE RUST. LOOSE MILL SCALE. AND OTHER LOOSE OR POTENTIALLY DETRIMENTAL FOREIGN MATERIAL SHALL BE REMOVED FROM THE SURFACES IN CONTACT WITH CONRETE, TIGHTLY ADHERED PAINT MAY REMAIN UNLESS OTHERWISE NOTED. REMOVAL SHALL BE ACCOMPLISHED BY METHODS THAT WILL NOT DAMAGE THE STEEL AND THE COST WILL BE INCLUDED IN THE PAY ITEM COVERING REMOVAL OF THE EXISTING CONCRETE.
- PLAN DIMENSIONS AND DETAIL RELATIVE TO EXISTING PLANS ARE SUBJECT TO NOMINAL CONSTRUCTION VARIABLES. THE CONTRACTOR SHALL FIELD VERIFY EXISTING DIMENSIONS AND DETAILS AFFECTING NEW CONSTRUCTION AND MAKE NECESSARY APPROVED ADJUSTMENTS PRIOR TO CONSTRUCTION OR ORDERING OF MATERIALS. SUCH VARIATIONS SHALL NOT BE CAUSE FOR ADDITIONAL COMPENSATION FOR A CHANGE IN SCOPE OF THE WORK. HOWEVER, THE CONTRACTOR WILL BE PAID FOR THE QUANTITY ACTUALLY FURNISHED AT THE UNIT PRICE BID FOR THE WORK.
- CONCRETE SEALER TO BE APPLIED ON TOP OF SIDEWALKS AND TOP AND FRONT FACE OF PARAPETS
- REPAIR AREAS ARE ESTIMATED. THE ENGINEER SHALL DETERMINE ACTUAL REPAIR LOCATIONS AND RECORD THEM ON THE AS-BUILT PLANS.
- JOINT OPENINGS SHALL BE ADJUSTED ACCORDING TO ARTICLE 520.04 OF THE STANDARD SPECIFICATIONS WHEN THE DECK IS POURED AT AN AMBIENT TEMPERATURE OTHER THAN 50° F


TOTAL BILL OF MATERIALS:						
PREFORMED JOINT SEAL 21/4"	FOOT	108.5				
PREFORMED JOINT SEAL 31/2"	FOOT	108.5				
BRIDGE DECK CONCRETE SEALER	SO FT	3740				
CONCRETE BRIDGE DECK SCARIFICATION 3/8 INCH	SO YD	1701				
BRIDGE DECK THIN POLYMER OVERLAY 3/8"	SQ YD	1701				
STRUCTURAL REPAIR OF CONCRETE (DEPTH EQUAL TO OR LESS THAN 5 INCHES)	SO FT	1218				
STRUCTURAL REPAIR OF CONCRETE (DEPTH GREATER THAN 5 INCHES)	SO FT	12				
TEMPORARY SHORING AND CRIBBING	EACH	4				

INTERIOR	GIRDER REACTION	ON TABLE
	ABUTMENTS	PIERS
ROL (Kip)	29.5	64.1
RLL (Kîp)	33.3	38.4
Imp (Kîp)	9.0	8.3
R (Total) (Kip)	71.7	110.8




TOTAL SHEET NO. SECTION COUNTY BRIDGE REPAIR DETAILS COOK 31 5 2019-056-BR 57 I-57 AT IL ROUTE 1 (HALSTED ST.) PLOT SCALE # 100.0000 ' / in. CHECKED - A. MIDY REVISED -**DEPARTMENT OF TRANSPORTATION** CONTRACT NO. 62J33 PLOT DATE = 12/3/2019 SCALE: SHEET 1 OF 5 SHEETS STA. TO STA. DATE REVISED -

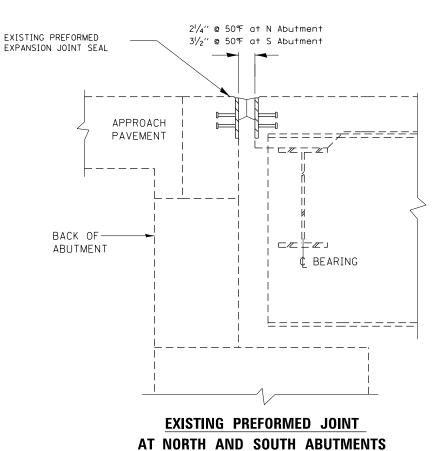

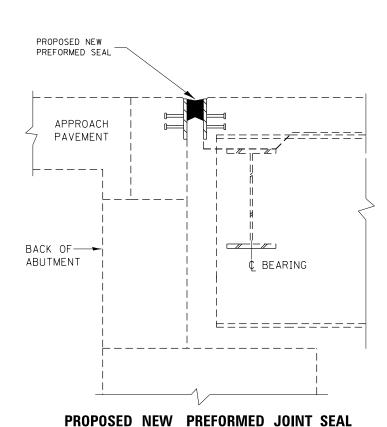

AT NORTH AND SOUTH ABUTMENTS

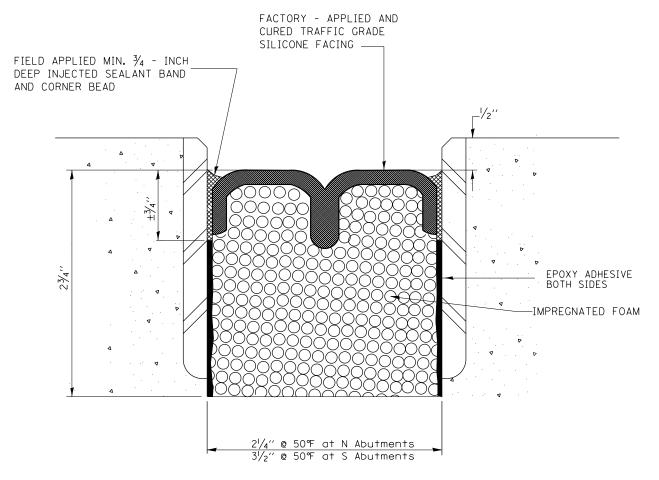

PREFORMED JOINT SEAL AT NORTH AND SOUTH ABUTMENTS

BILL OF MATERIALS

	Item	Unit	Quantity
N	Preformed Joint Seal 21/4"	Foot	108.5
S	Preformed Joint Seal 3 ¹ 2"	Foot	108.5


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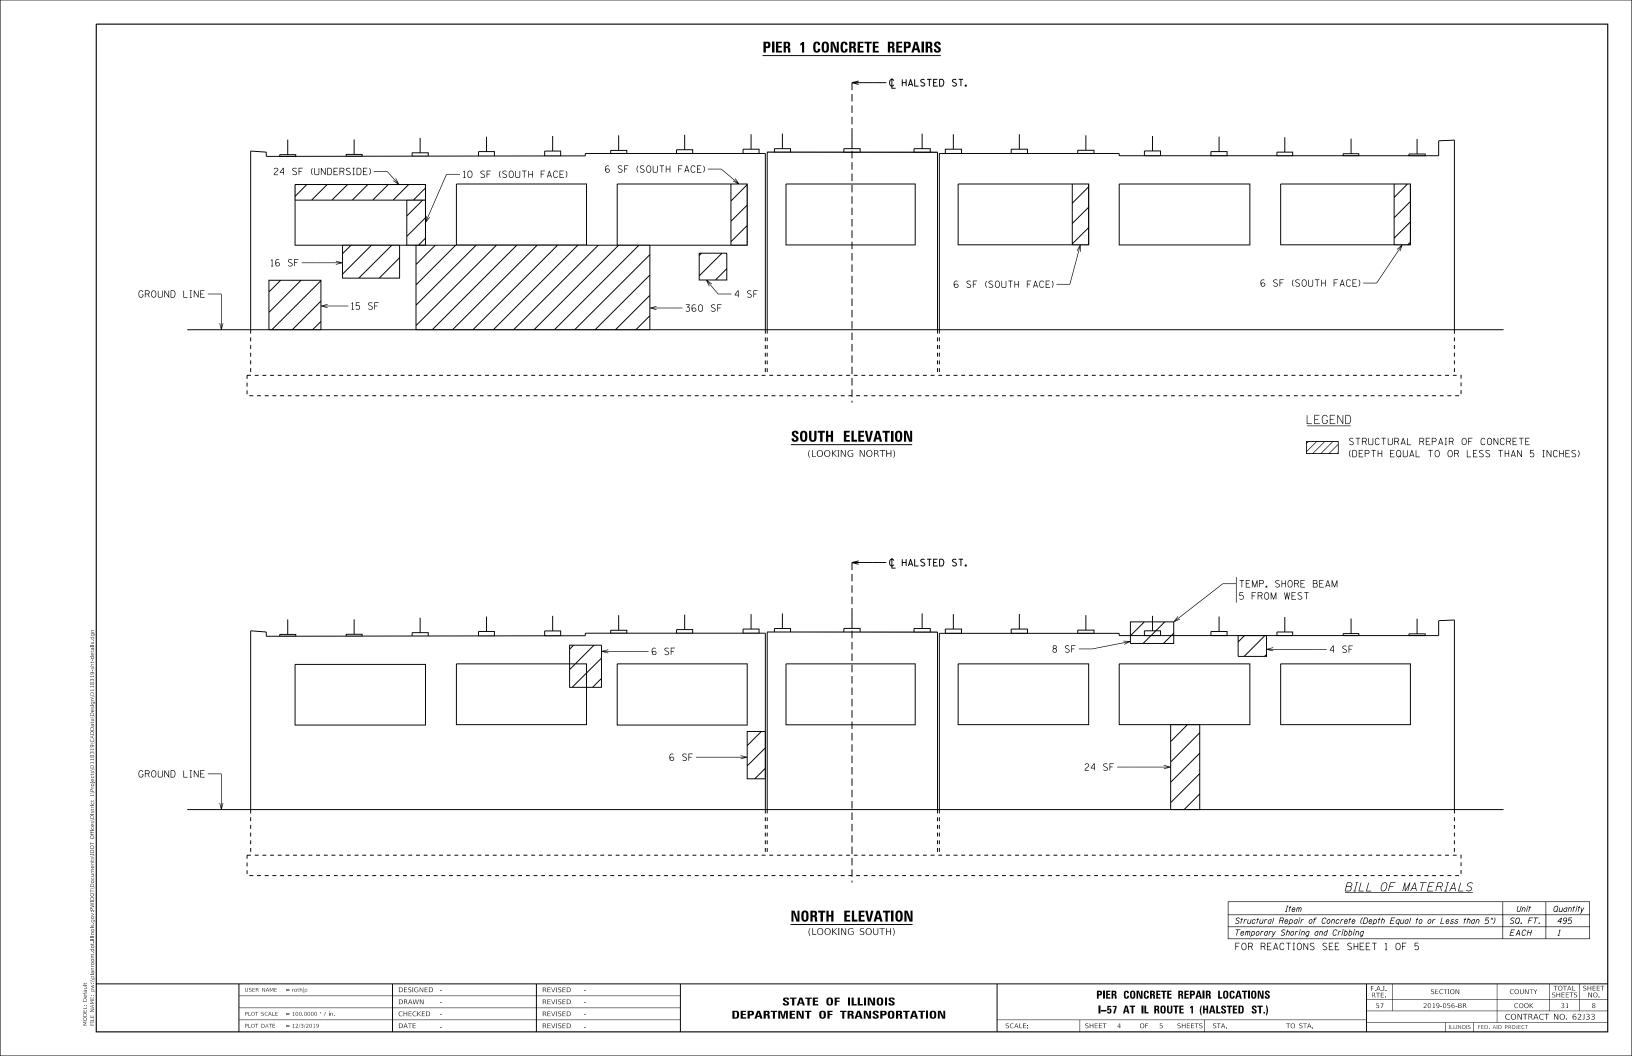
- 1. JOINT SEALS SHALL BE PREFORMED PRE-COMPRESSED, SILICONE COATED SELF-EXPANDING SEALANT SYSTEM.
- 2. THE REMOVAL OF THE EXISTING JOINT IS INCLUDED IN THE COST OF THE PREFORMED JOINT SEAL


USER NAME = rothjp	DESIGNED -	REVISED -		
	DRAWN -	REVISED -	STATE OF ILLINOIS	
PLOT SCALE = 100,0000 ' / in.	CHECKED -	REVISED -	DEPARTMENT OF TRANSPORTATION	
PLOT DATE = 12/3/2019	DATE -	REVISED -		SCALE:


BRIDGE REPAIR DETAILS	F.A.I. RTE.	SECTION
I-57 AT IL ROUTE 1 (HALSTED ST.)	57	2019-056-BR
I-37 AT IL HOUTE I (HALSTED 31.)		

COOK 31 6 CONTRACT NO. 62J33 SHEET 2 OF 5 SHEETS STA.



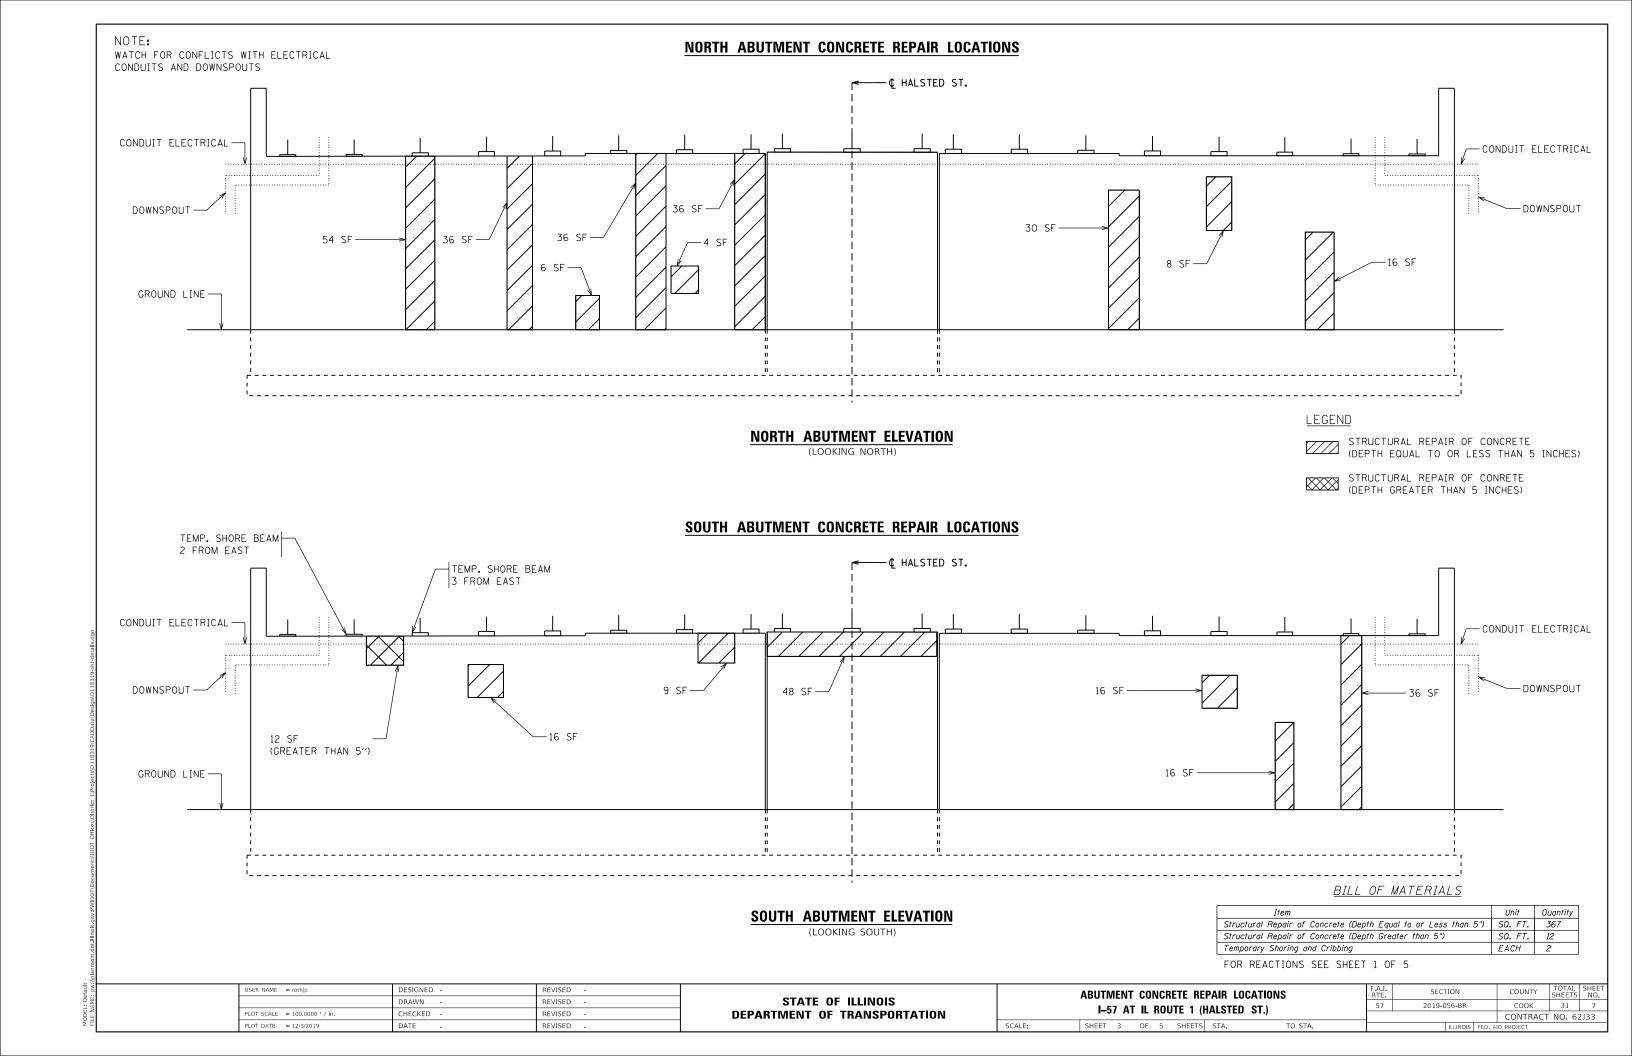

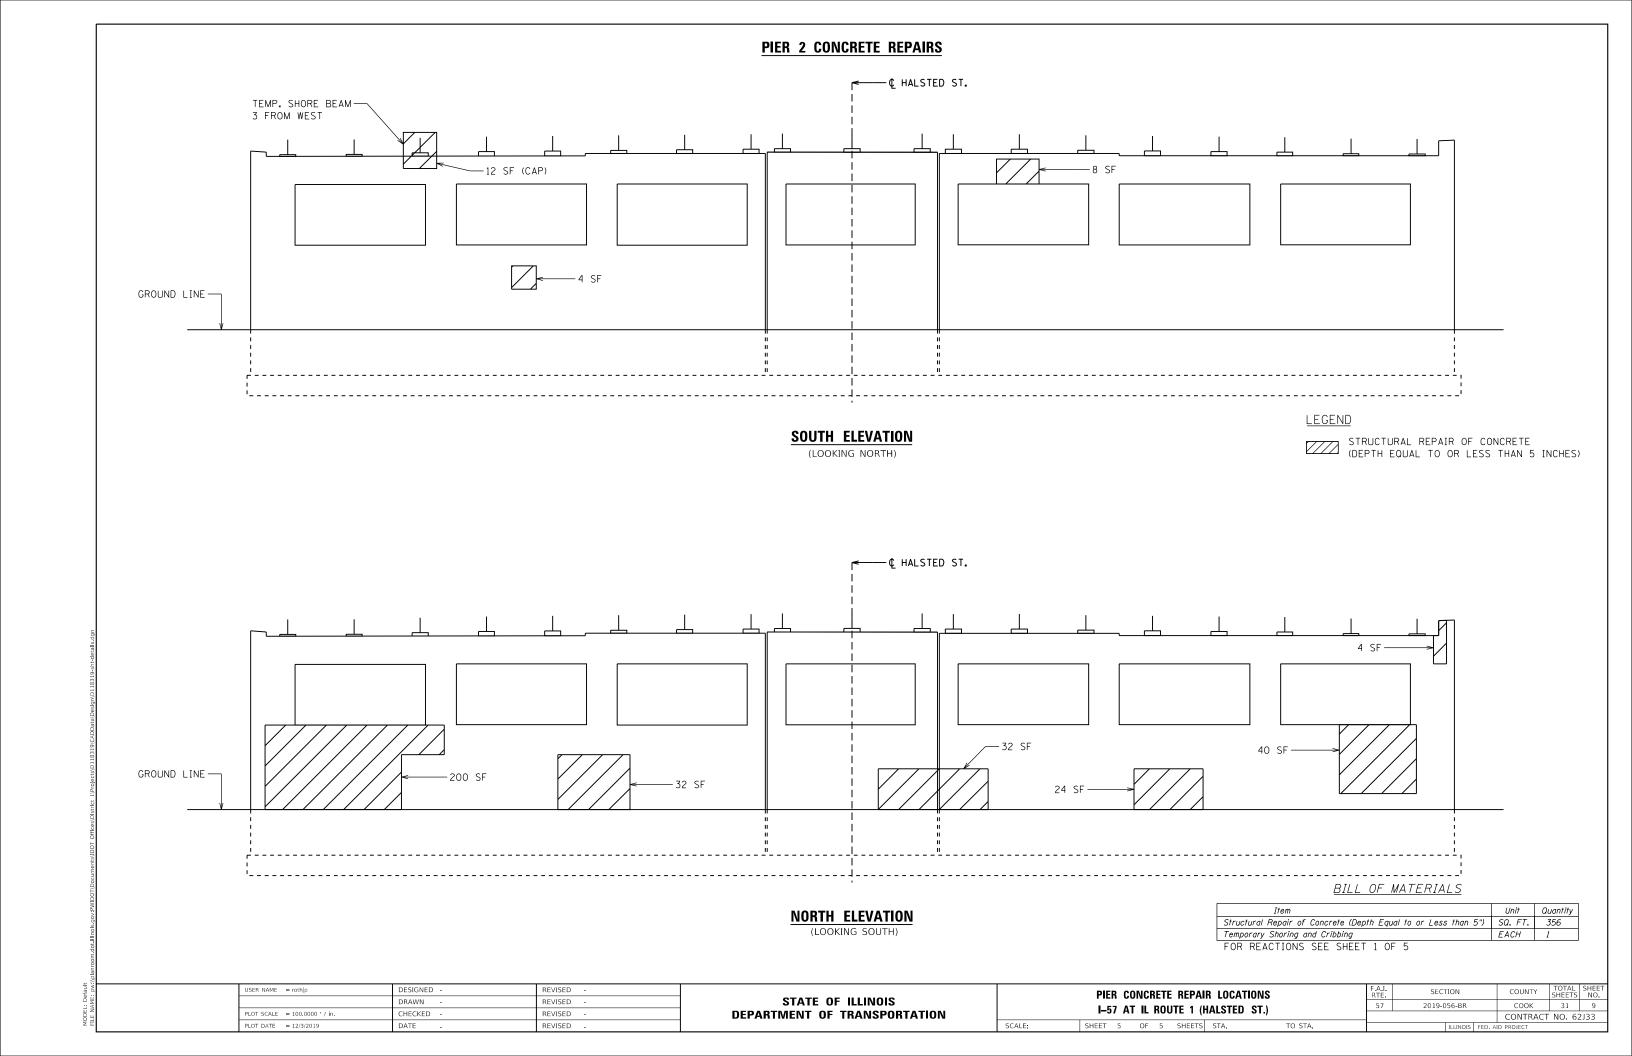

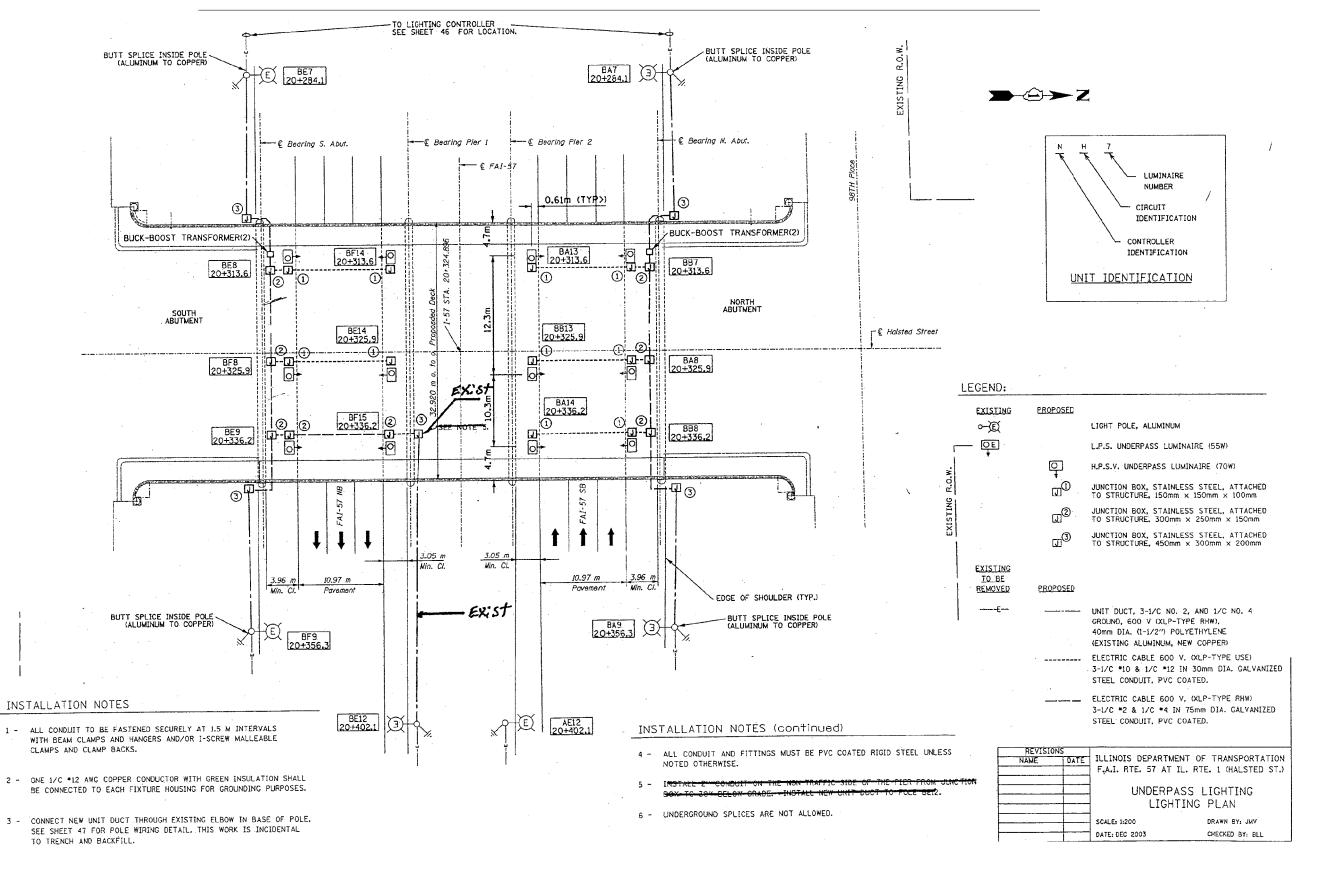

JSER NAME = rothjp

PLOT DATE = 10/16/2019

STATE OF ILLINOIS
DEPARTMENT OF TRANSPORTATION

BRIDGE LIGHTING DETAILS — FOR INFORMATION ONLY


I-57 AT IL ROUTE 1 (HALSTED ST.)

SHEET 1 OF 4 SHEETS STA. TO STA.


F.A.I. SECTION COUNTY TOTAL SHEETS NO.

57 2019-056-BR COOK 31 10


CONTRACT NO. 62J33

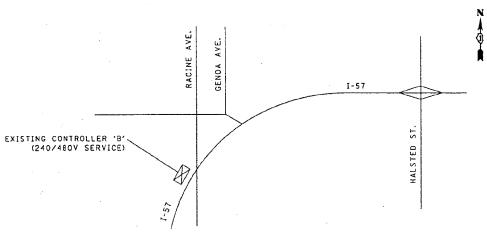

I-57 LIGHTING CONTROLLER LOCATION

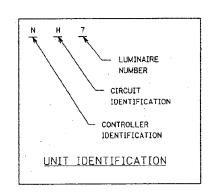

		Phase A (Red)	Phase B (Black
Ckt *	Description	(comps)	(omps)
Α .	5-400W , 2-200W , 3-55W , 3-70W	14.4	}
В	5-400W , 2-200W , 3-55W , 3-70W		14.4
С	8-400W , 3-55W	17.2	
D	8-400W , 3-55W		17.2
Ε	6-400W , 2-200W , 3-55W , 4-85W , 3-70W	18.4	
F	5-400W , 3-200W , 3-55W , 2-85W , 3-70W		16.4
G	7-400W . 3-55W . 2-85W	16.2	
Н	8-400W , 3-55W , 2-85W		18.2
	Totals	66.2	66.2

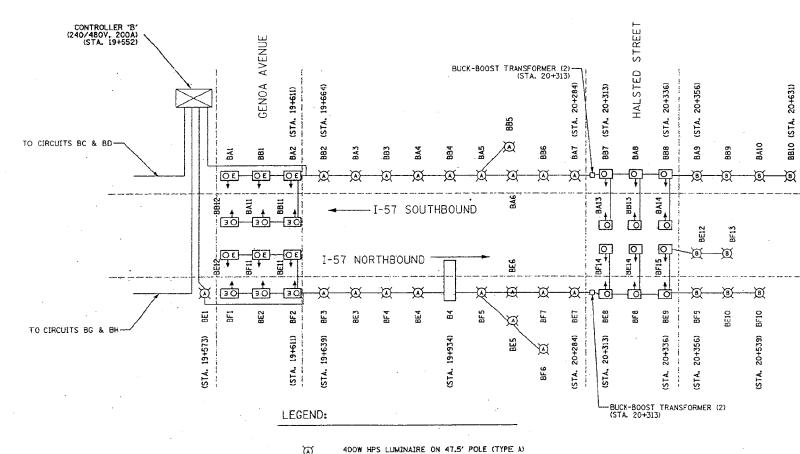

200W HPS LUMINAIRE ON 35' POLE (TYPE B)

55W LPS UNDERPASS LUMINAIRE

70W HPS UNDERPASS LUMINAIRE

USER NAME = rothjp	DESIGNED	-	J. ROTH	REVISED -
	DRAWN	-	J. ROTH	REVISED -
PLOT SCALE = 100.0000 ' / in.	CHECKED	-	A. MIDY	REVISED -
PLOT DATE = 10/16/2019	DATE	-	9/18/2019	REVISED -

STATE OF ILLINOIS **DEPARTMENT OF TRANSPORTATION**

BRIDG	E LIGHTIN	IG DETAI	LS – FOF	INFO	RMATION	ONLY
	I-57	AT IL RO	UTE 1 (H	ALSTED	ST.)	
	CHEET 3	OF 4	CHEETC	CTA	-	O CTA


F.A.I. RTE	SECT	COUNTY	TOTAL SHEETS	SHEET NO.		
57	2019-0	56-BR		соок	31	11
			CONTRACT NO. 62J33			
		ILLINOIS	FED. A	ID PROJECT		

DRAWN BY: JMV CHECKED BY: BLL

ILLINOIS DEPARTMENT OF TRANSPORTATION

F.A.I. RTE. 57 AT IL. RTE. 1 (HALSTED ST.)

UNDERPASS LIGHTING ONE LINE DIAGRAM

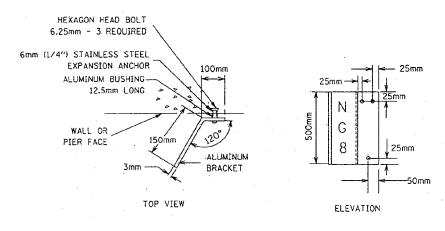


LUMINAIRE NUMBERING
DECAL BRACKET-TYPICAL

SLUG FUSE SLUG GROUND LUG GROUND LUG GROUND LUG GROUND LUG GROUND LUG GROUND CAN SEUTRAL GROUND


TYPICAL WIRING DIAGRAM

HEAT SHRINKABLE CAP WITH FACTORY APPLIED - WATERPROOF SEALANT (SIZED TO ACCOMODATE NUMBER OF CABLES) TRIMMED CABLES -COMPRESSION TYPE COPPER SLEEVE (SIZED FOR ACTUAL NUMBER OF CABLES - EXPOSED SEALANT AND MFR. SUGGESTED CRIMP TOOL USED) ELECTRIC CABLE TO LUMINAIRE SEALANT TAPE OR INSERT (AROUND (SIZE AS NOTED AND THRU CROTCH OF SPLICE) ELSEWHERE IN THESE PLANS) ELECTRIC FEEDER CABLES, SUCH AS UNIT DUCT (SIZE AS NOTED ON CONTRACT DRAWINGS)

ELECTRIC CABLE SPLICE DETAIL

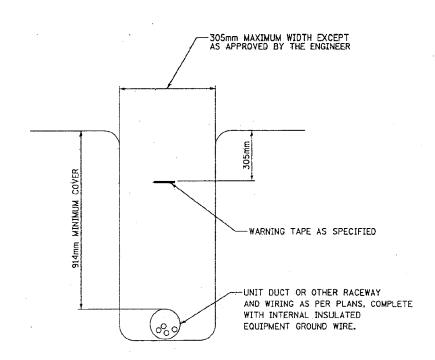

TYPICAL WIRING IN TRENCH DETAIL

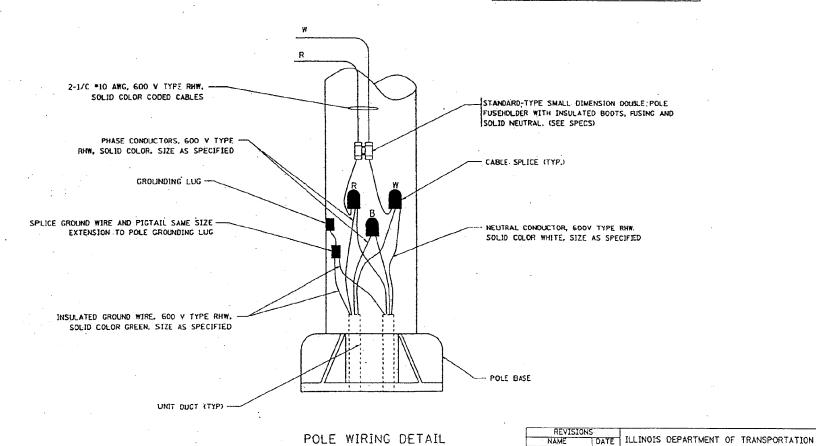

N.T.S.

STATE OF ILLINOIS
DEPARTMENT OF TRANSPORTATION

BRIDGE LIGHTING DETAILS — FOR INFORMATION ONLY

I-57 AT IL ROUTE 1 (HALSTED ST.)

SHEET 3 OF 4 SHEETS STA. TO STA.


F.A.I. RTE. 57 AT IL. RTE. 1 (HALSTED ST.)

UNDERPASS LIGHTING DETAILS

DRAWN BY: JMV

SCALE: NONE

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STATE OF ILLINOIS
DEPARTMENT OF TRANSPORTATION

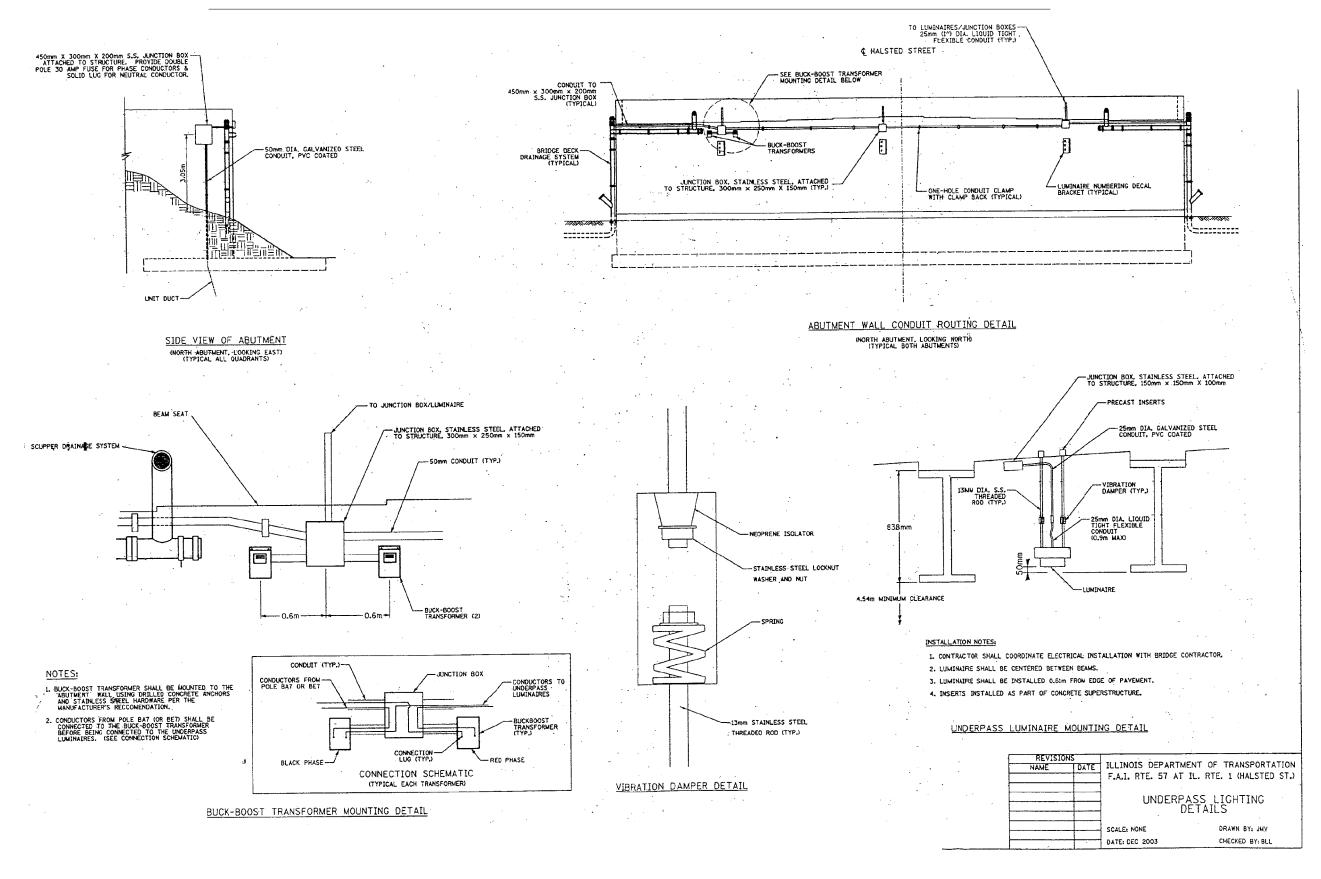J. ROTH

J. ROTH


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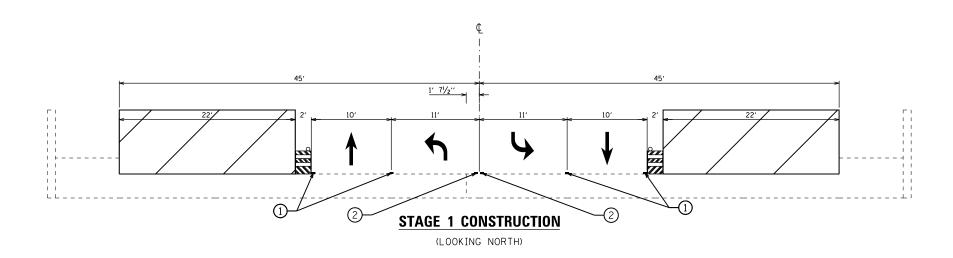
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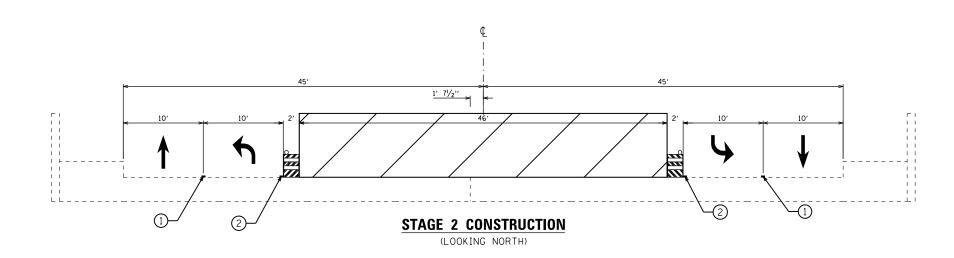
REVISED

REVISED

BRIDGE LIGHTING DETAILS — FOR INFORMATION ONLY I—57 AT IL ROUTE 1 (HALSTED ST.)






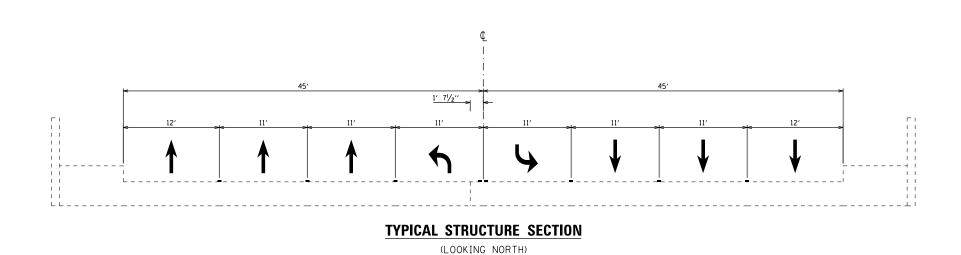


- 1 TEMP. PAVEMENT MARKING TAPE, TYPE IV (WHITE)
- 2 TEMP. PAVEMENT MARKING TAPE, TYPE IV (YELLOW)

USER NAME = rothjp	DESIGNED -	REVISED -		MAINI	TENANCE OF TRAFFIC TYPICAL CROSS SECTIONS (IL RTE. 1)	F.A.I.	SECTION	COUNTY	TOTAL	SHEET
	DRAWN -	REVISED -	STATE OF ILLINOIS	I WAIN		57	2019-056-BR	соок	31	14
PLOT SCALE = 100.0000 / in.	CHECKED -	REVISED -	DEPARTMENT OF TRANSPORTATION		I-57 AT IL ROUTE 1 (HALSTED ST.)			CONTRAC	T NO. 6	2J33
PLOT DATE = 10/16/2019	DATE -	REVISED -		SCALE:	SHEET 1 OF 1 SHEETS STA. TO STA.		JULINOIS FED. A	AID PROJECT		

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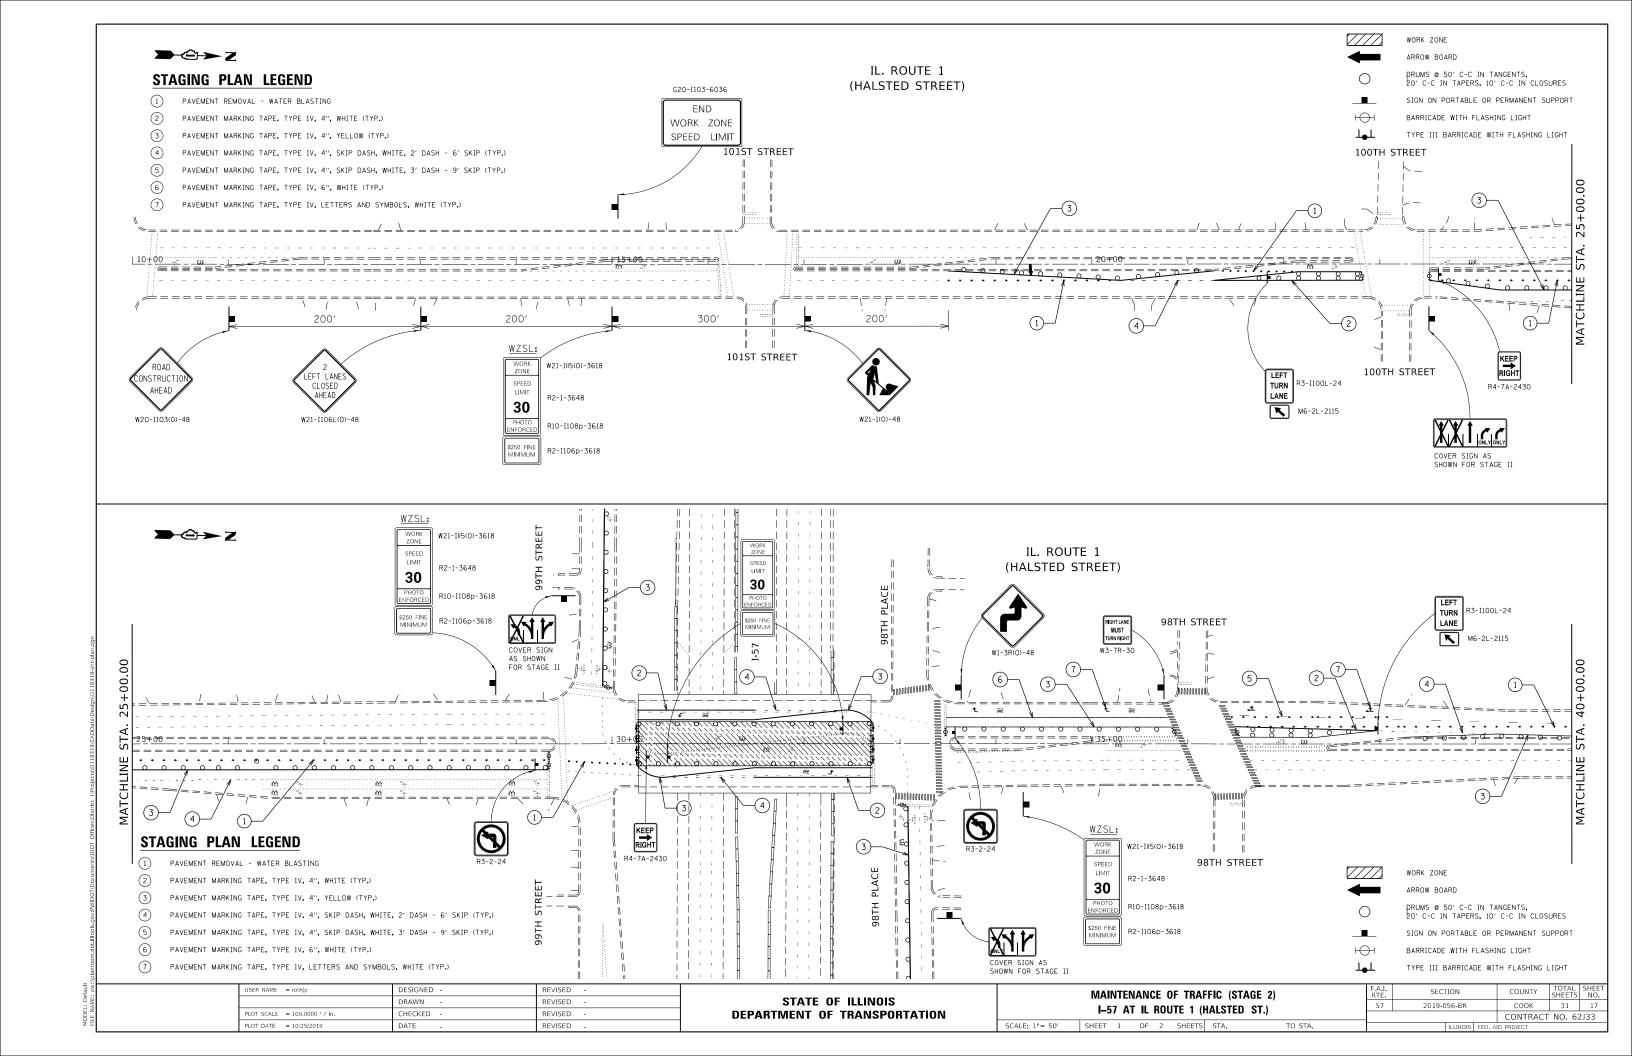


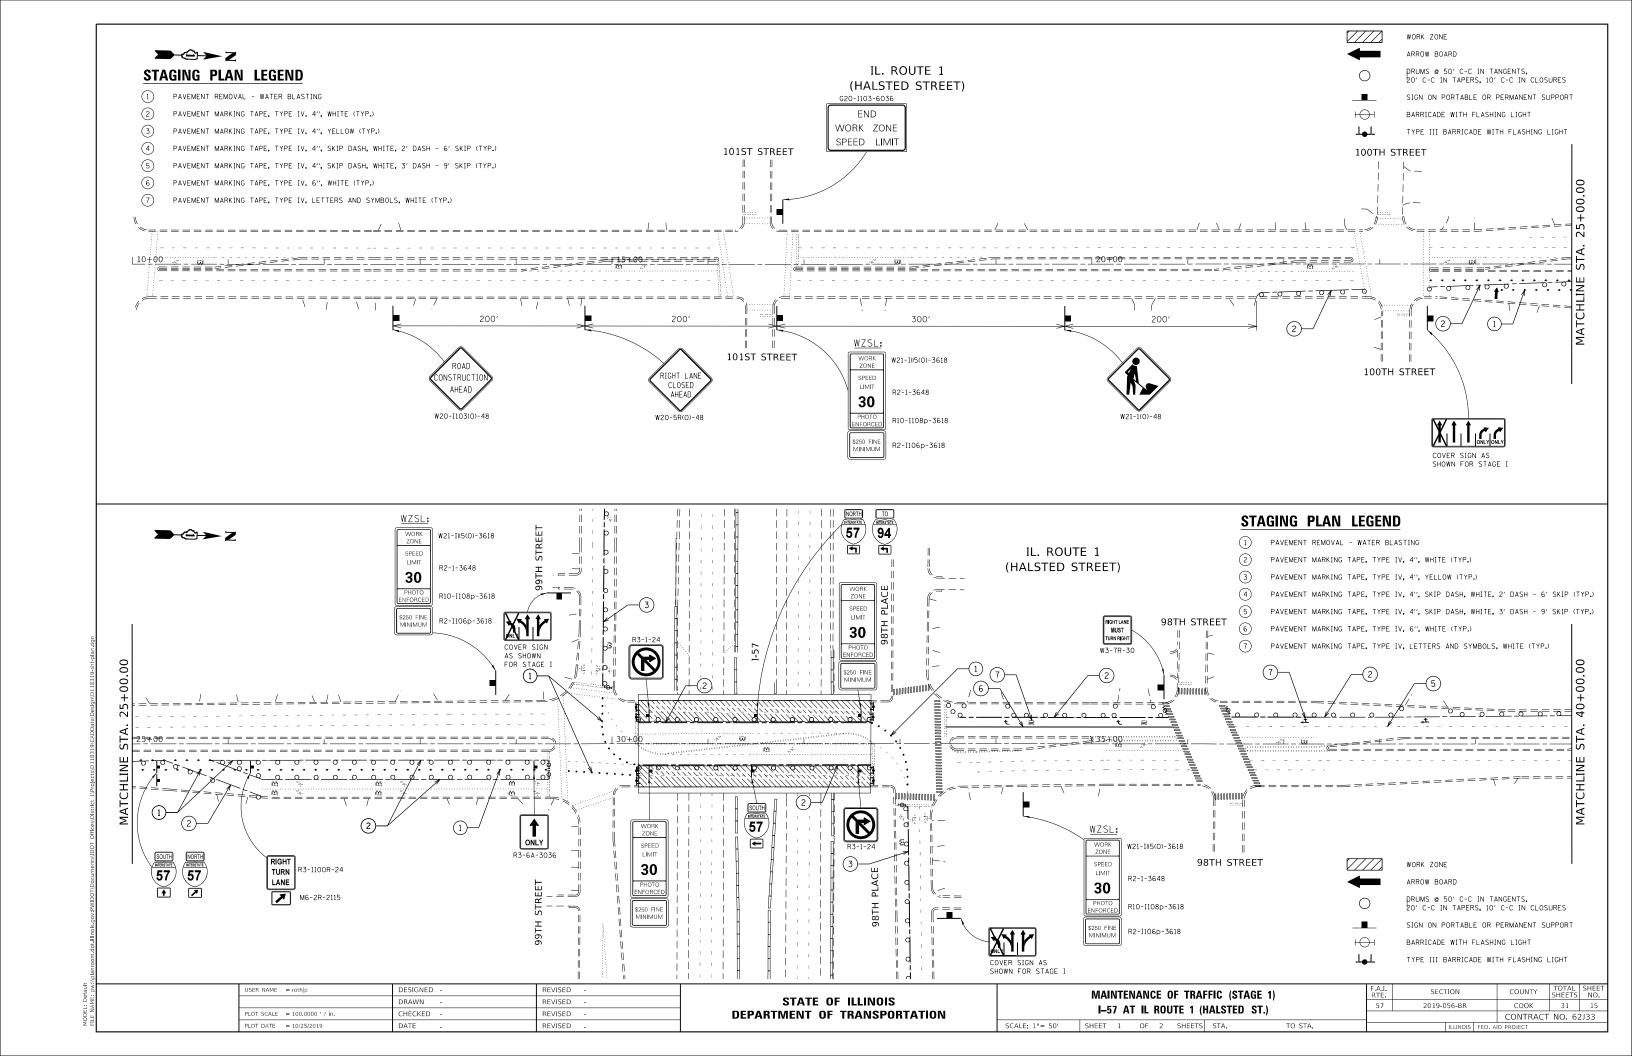


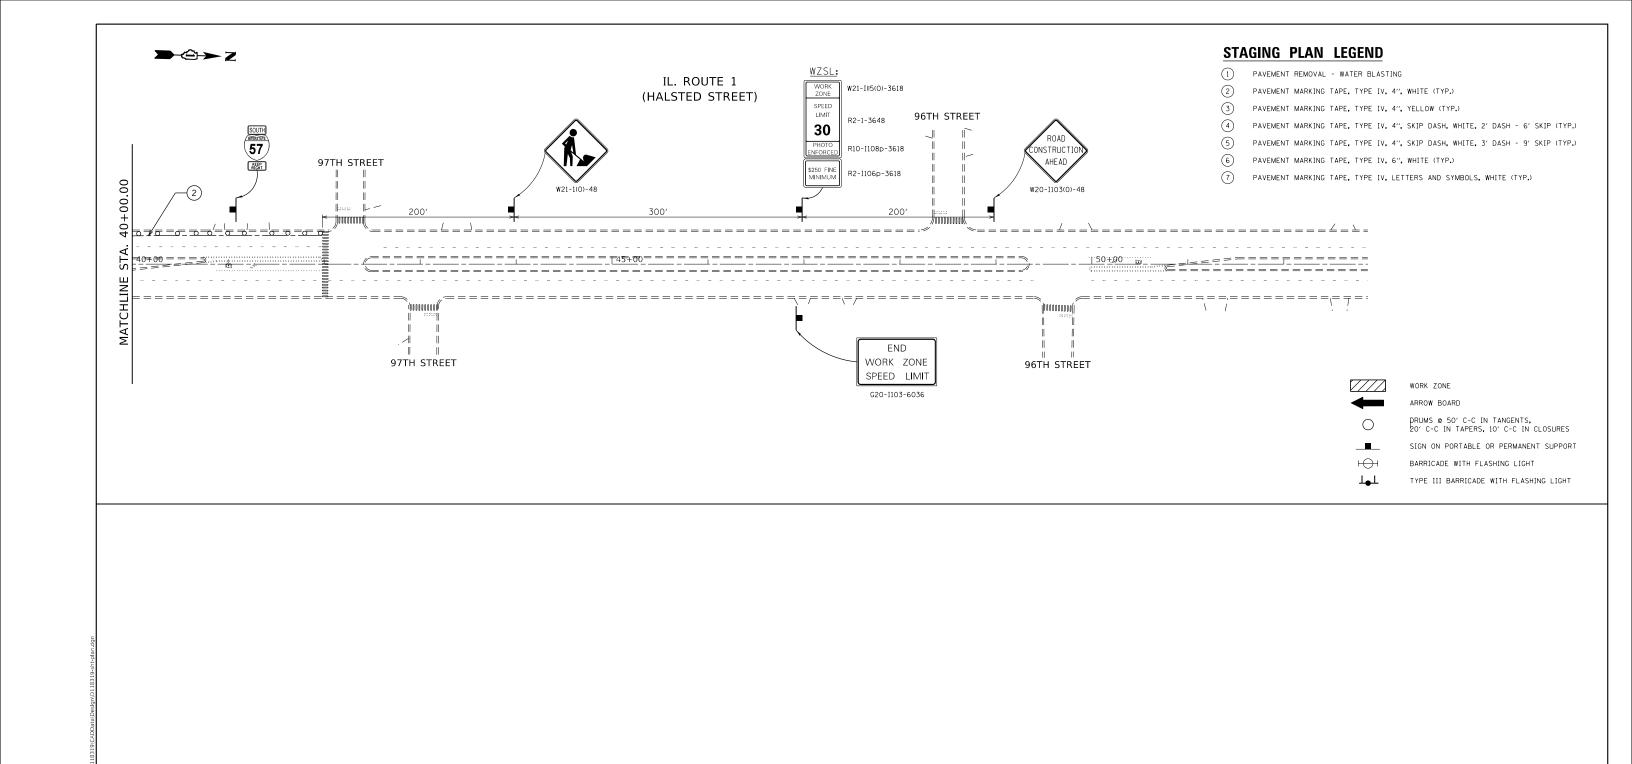USER NAME = rothjp	DESIGNED -	REVISED -	
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PLOT SCALE = 100.0000 / in.	CHECKED -	REVISED -	
PLOT DATE = 10/25/2019	DATE -	REVISED -	

						FIC (ST.	•
SCALE: 1"= 50"	SHEET	2	OF	2	SHEETS	STA.	TO STA.

F.A.I. RTE	SECT	ΠΟN	COUNTY	TOTAL SHEETS	SHEET NO.	
57	2019-0	56-BR		соок	31	16
				CONTRACT	NO. 62	2J33




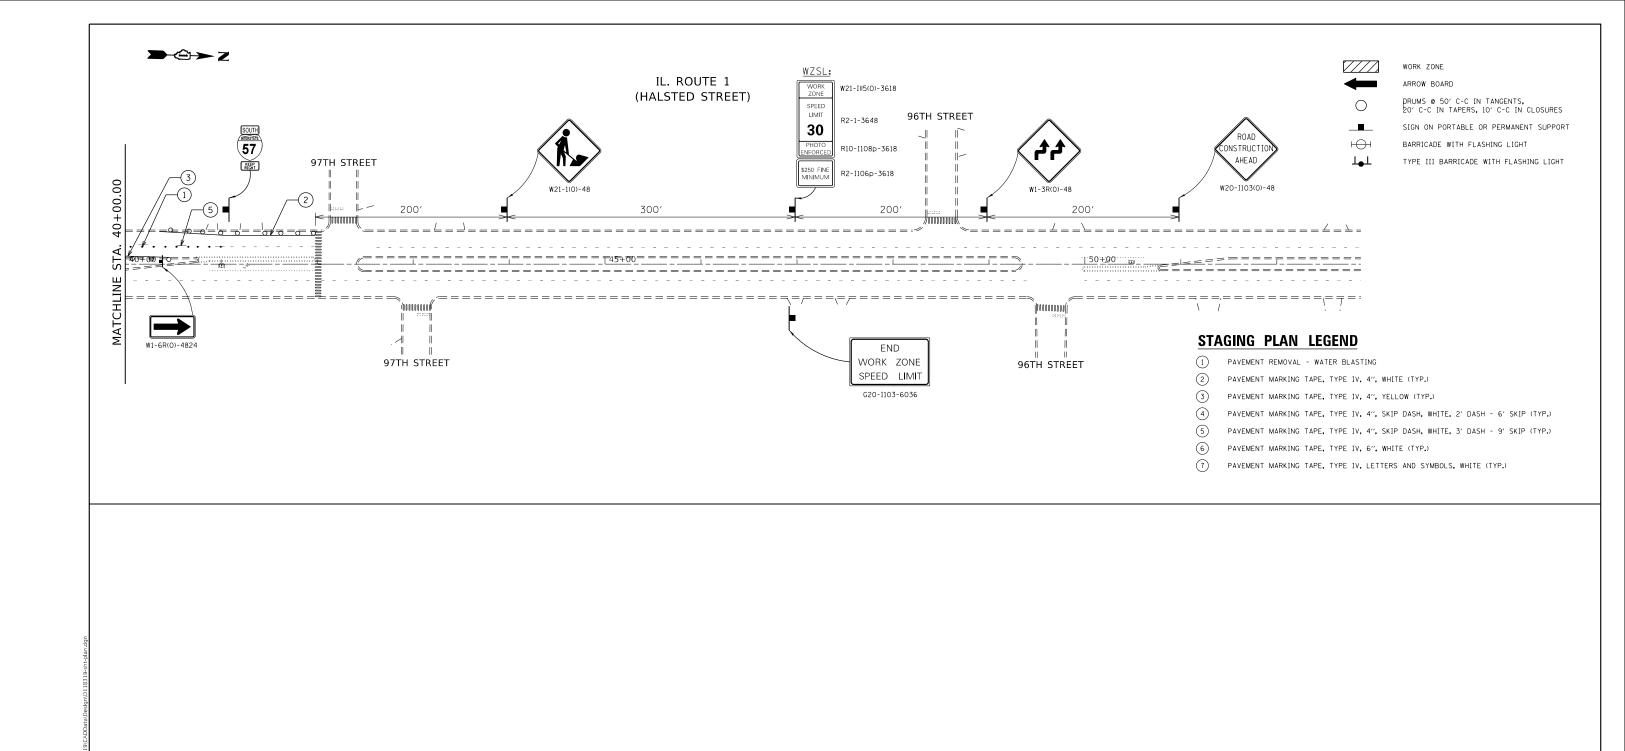


USER NAME = rothjp	DESIGNED -	REVISED -	
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PLOT SCALE = 100.0000 ' / in.	CHECKED -	REVISED -	
PLOT DATE = 10/25/2019	DATE -	REVISED -	

						FIC (STA	•
SCALE: 1"= 50'	SHEET	2	OF	2	SHEETS	STA.	TO STA.

F.A.I. RTE	SECT	ΠΟN			COUNTY	TOTAL SHEETS	SHEE NO.
57	2019-0	56-BR		T	COOK	31	18
				T	CONTRACT	NO. 62	2133
		ILLINIOIC.	EED /	A 11	D DDOJECT		

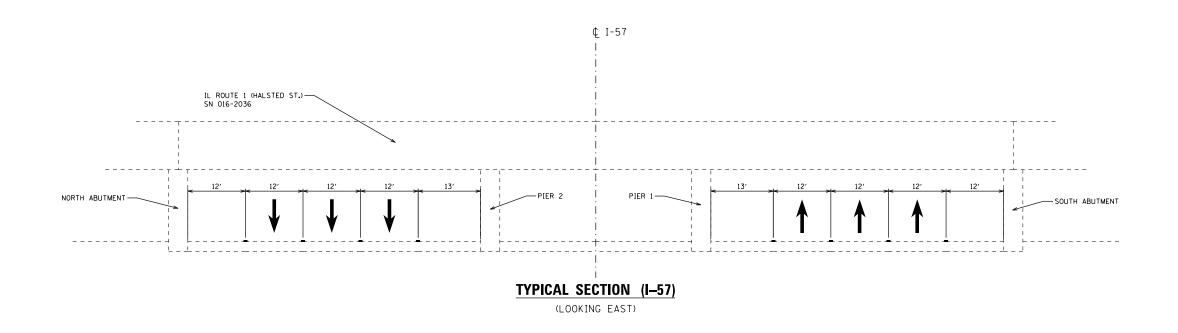

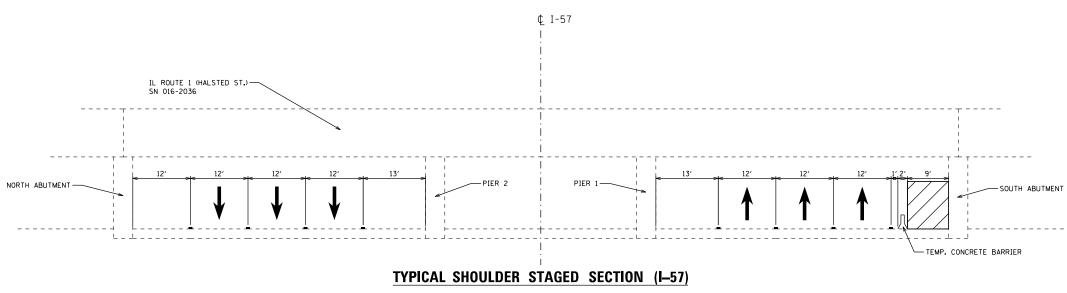

(LOOKING EAST)

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 PLOT SCALE = 100,0000 ' / in.
 CHECKED REVISED

 PLOT DATE = 10/16/2019
 DATE REVISED

STATE OF ILLINOIS
DEPARTMENT OF TRANSPORTATION

MAINTENANCE OF TRAFFIC TYPICAL CROSS SECTIONS (I–57)


I–57 AT IL ROUTE 1 (HALSTED ST.)


SHEET 1 OF 1 SHEETS STA. TO STA.

F.A.I. RTE. SECTION COUNTY TOTAL SHEETS NO.

57 2019-056-BR COOK 31 19

CONTRACT NO. 62 J 33

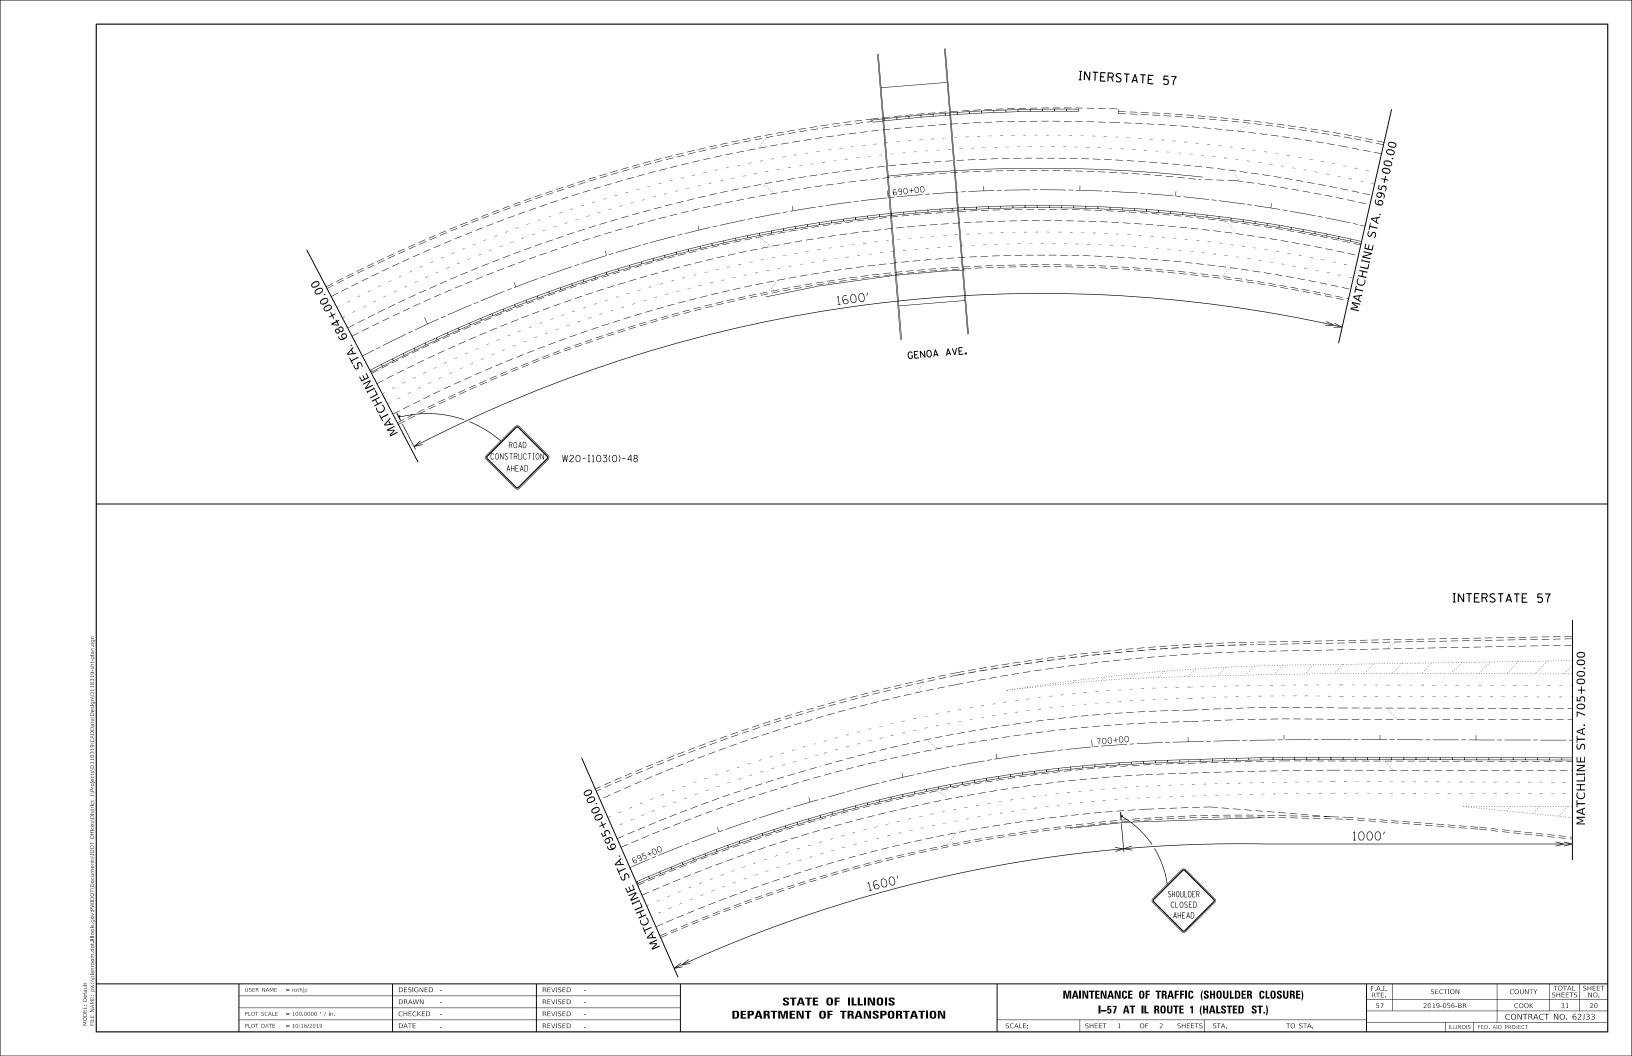

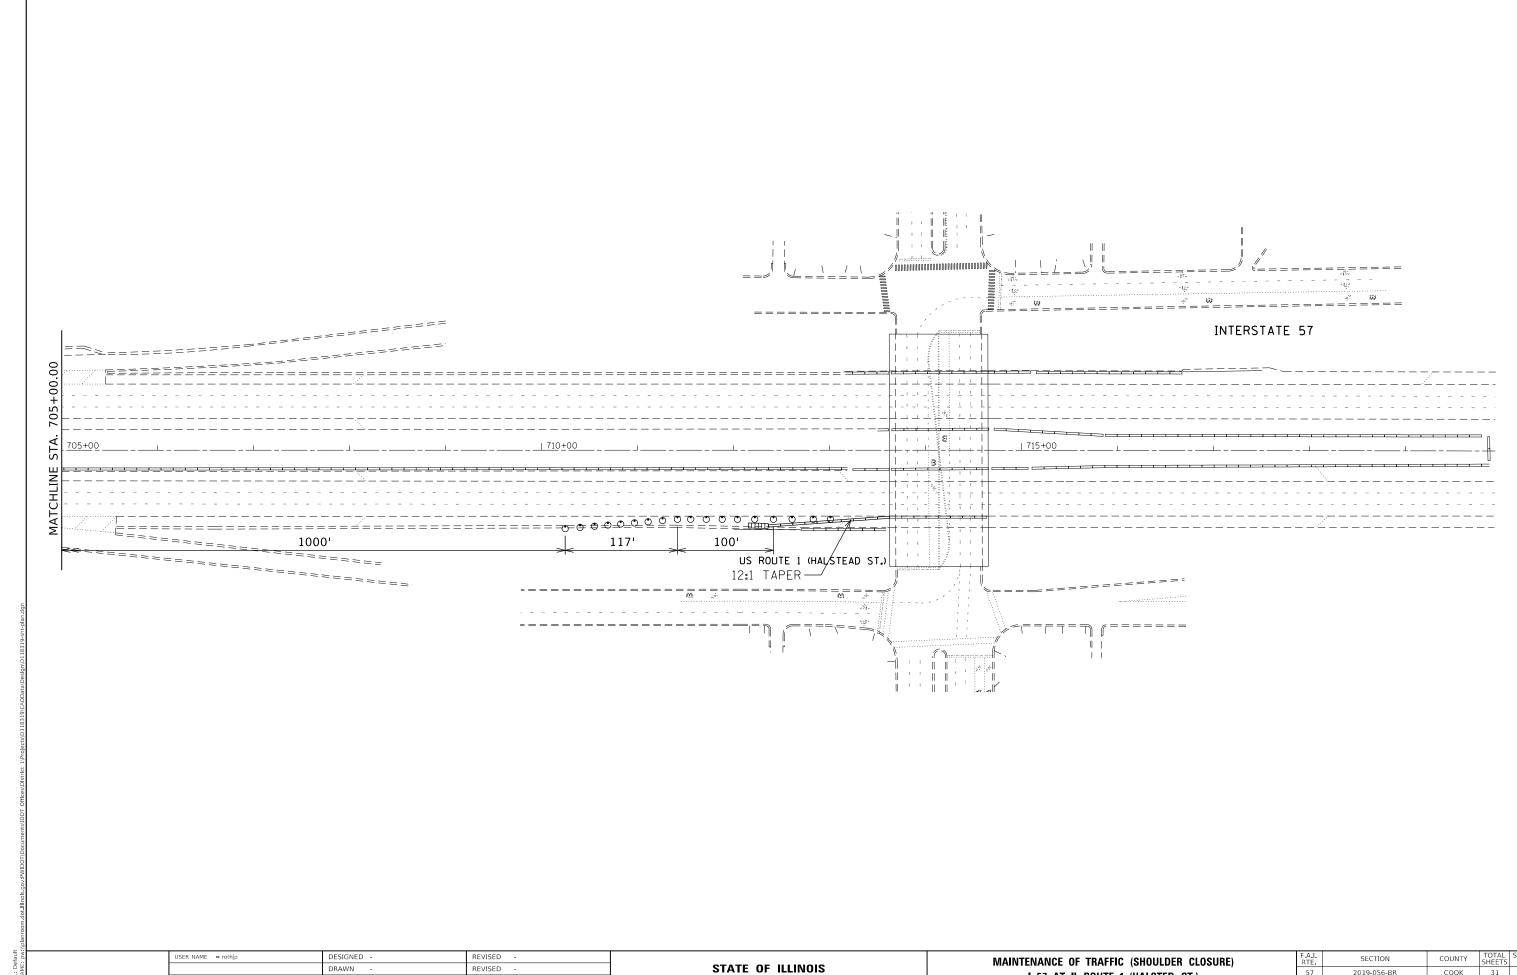

PLOT SCALE = 100.0000 / in.

CHECKED -


REVISED -


DEPARTMENT OF TRANSPORTATION

I-57 AT IL ROUTE 1 (HALSTED ST.) SHEET 2 OF 2 SHEETS STA.

COUNTY TOTAL SHEET NO.

COOK 31 21 2019-056-BR CONTRACT NO. 62J33

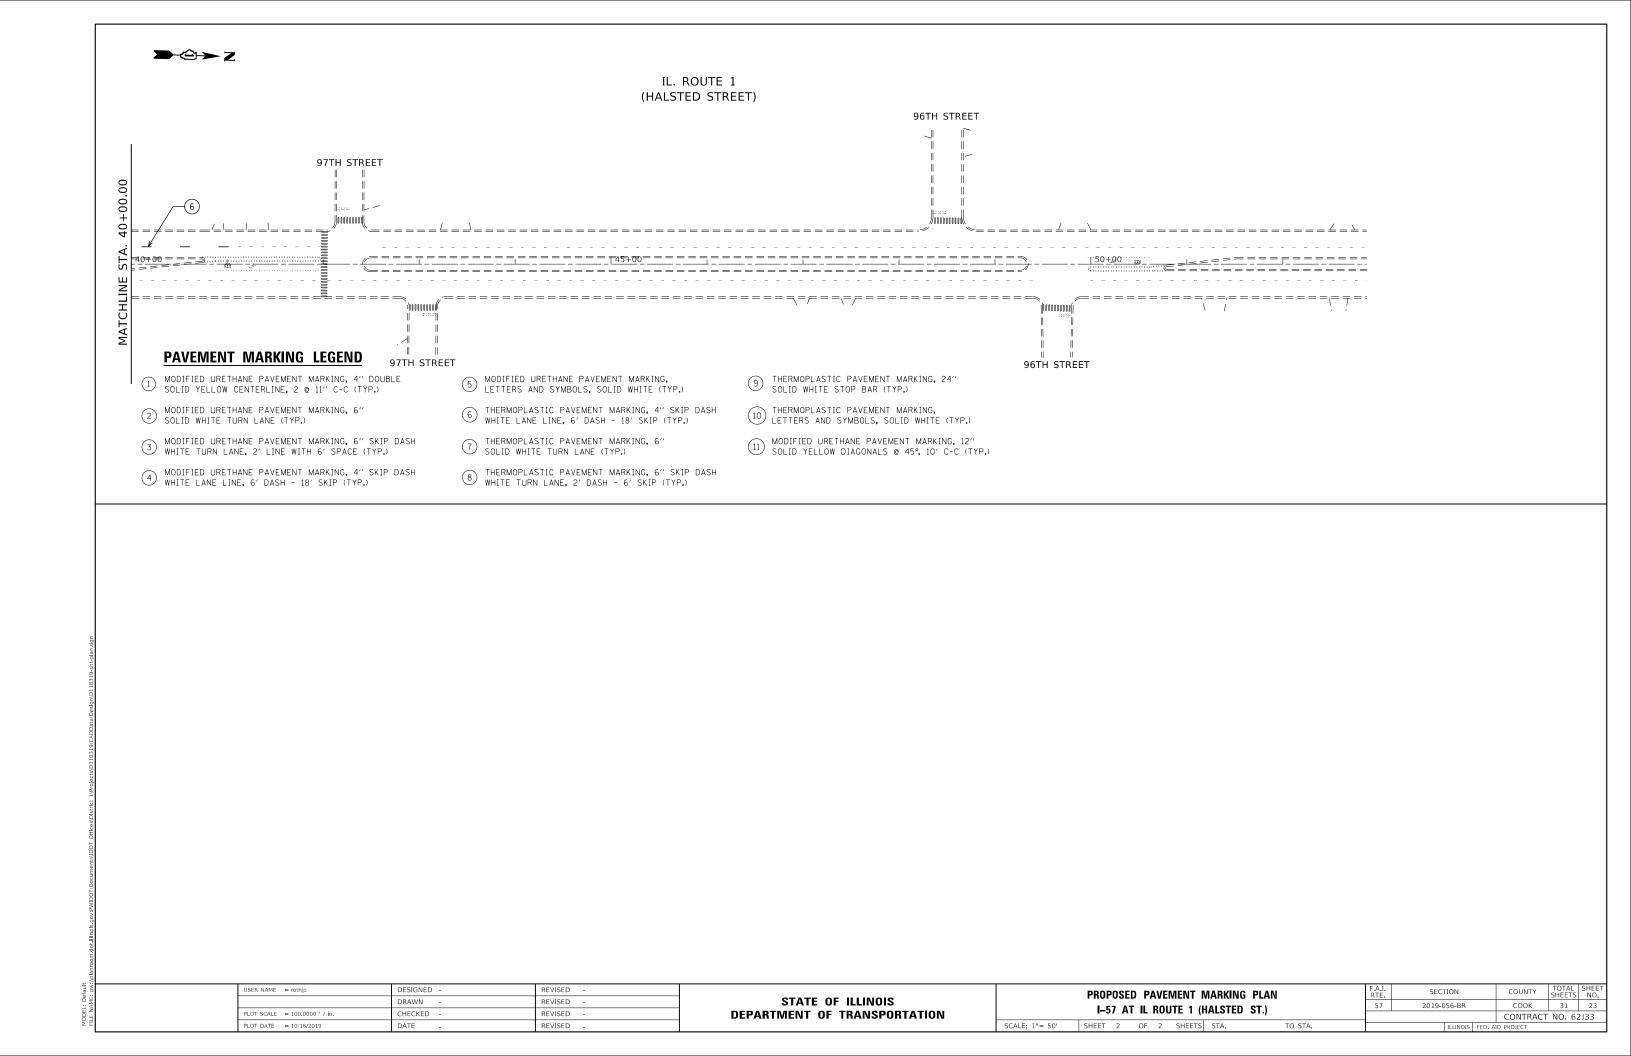

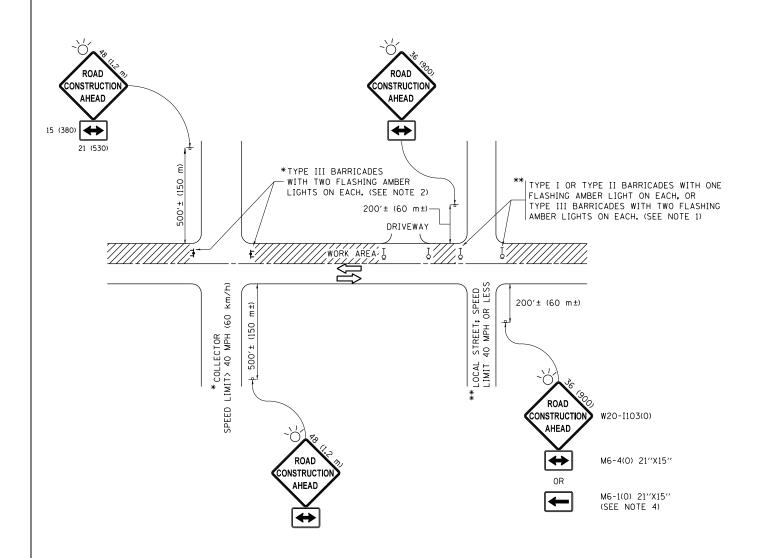

NOTES:

- SIDE ROAD WITH A SPEED LIMIT OF 40 MPH (60 km/h) OR LESS AS SHOWN ON THE DRAWING AND AS DIRECTED BY THE ENGINEER:
 - a) ONE "ROAD CONSTRUCTION AHEAD" SIGN 36 x 36 (900x900) WITH A FLASHER MOUNTED ON IT APPROXIMATELY 200" (60 m) IN ADVANCE OF THE MAIN ROUTE.
 - b) THE CLOSED PORTION OF THE MAIN ROUTE SHALL BE PROTECTED BY BLOCKING WITH TYPE I, TYPE II OR TYPE III BARRICADES, 1/3 OF THE CROSS SECTION OF THE CLOSED PORTION.
- 2. SIDE ROAD WITH A SPEED LIMIT GREATER THAN 40 MPH (60 km/h) AS SHOWN ON THE DRAWING AND AS DIRECTED BY THE ENGINEER:
 - a) ONE "ROAD CONSTRUCTION AHEAD" SIGN 48 \times 48 (1.2 m \times 1.2 m) WITH A FLASHER MOUNTED ON IT APPROXIMATELY 500" (150 m) IN ADVANCE OF THE MAIN ROUTE.
 - b) THE CLOSED PORTION OF THE MAIN ROUTE SHALL BE PROTECTED BY BLOCKING WITH TYPE III BARRICADES, 1/2 OF THE CROSS SECTION OF THE CLOSED PORTION.
- 3. CONES MAY BE SUBSTITUTED FOR BARRICADES OR DRUMS AT HALF THE SPACING DURING DAY OPERATIONS. CONES SHALL BE A MINIMUM OF 28 (710)
- 4. WHEN THE SIDE ROAD LIES BETWEEN THE BEGINNING OF THE MAINLINE SIGNING AND THE WORK ZONE, A SINGLE HEADED ARROW (M6-1) SHALL BE USED IN LIEU OF THE DOUBLE HEADED ARROW (M6-4).

SCALE: NONE

- 5. WHEN WORK IS BEING PERFORMED ON A SIDE ROAD OR DRIVEWAY, FOLLOW THE APPLICABLE STANDARD(S). THE DIRECTIONAL ARROW (M6-1 OR M6-4) SHALL BE COVERED OR REMOVED WHEN NO LONGER CONSISTENT WITH THE TRAFFIC CONTROL SET-UP.
- 6. ADVANCE WARNING SIGNS ARE TO BE OMITTED ON DRIVEWAYS UNLESS OTHERWISE SPECIFIED IN THE PLANS OR BY THE ENGINFER.
- 7. THE TRAFFIC CONTROL AND PROTECTION FOR SIDE ROADS, INTERSECTIONS, AND DRIVEWAYS SHALL BE INCLUDED IN THE COST OF SPECIFIED TRAFFIC CONTROL STANDARDS OR ITEMS.

All dimensions are in inches (millimeters) unless otherwise shown.

FILE NAME =	USER NAME = rothjp	DESIGNED - L.H.A.	REVISED	- A. HOUSEH 10-15-96
pw:\\planroom.dot.illinois.gov:PWIDOT\Docu	nents\IDOT Offices\District 1\Projects\D118319	\ DRXXWN a\Design\DistStd.dgn	REVISED	-T. RAMMACHER 01-06-00
	PLOT SCALE = 100.0000 ' / in.	CHECKED -	REVISED	- A. SCHUETZE 07-01-13
Default	PLOT DATE = 10/16/2019	DATE - 06-89	REVISED	- A. SCHUETZE 09-15-16

STATE OF IL	LINOIS
DEPARTMENT OF TRA	ANSPORTATION

	TRAFFIC CONTROL AND PROTECTION FOR						SECTION	
СI	SIDE ROADS, INTERSECTIONS, AND DRIVEWAYS					57 2019-056-BR		
31	SIDE NUADS, INTERSECTIONS, AND DRIVEWAYS				TC-10			
	SHEET 1	OF 1	SHEETS	STA.	TO STA.		ILLINOIS	

	ILLINOIS FED.	AID PROJECT		
	TC-10	CONTRACT	NO. 6	2J33
57	2019-056-BR	соок	31	24
RTE.	SECTION	COUNTY	SHEETS	NO.

TURN BAY ENTRANCE AT START OF LANE CLOSURE TAPER

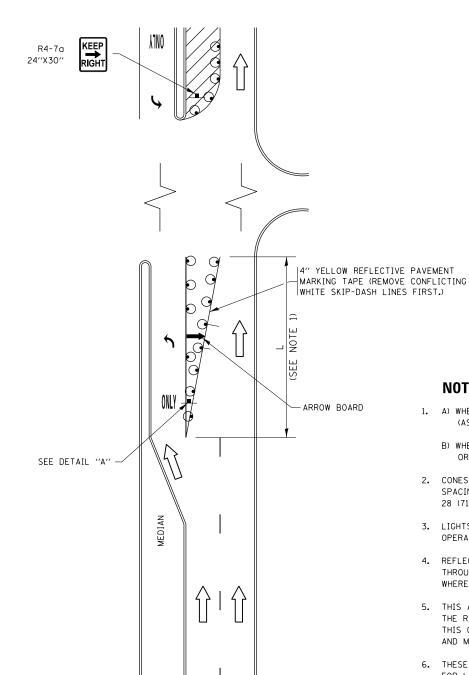


FIGURE 1


LEGEND WORK AREA LANE OPEN TO TRAFFIC ARROW BOARD TYPE I OR II BARRICADE OR DRUM WITH STEADY BURN LIGHT DRUM WITH STEADY BURN LIGHT SIGN ASSEMBLY

TYPE I OR II CHECK BARRICADE WITH FLASHING LIGHT

NOTES:

- 1. A) WHEN "L" IS < THE STORAGE LENGTH OF THE TURN LANE (AS SHOWN IN FIG. 1), USE FIGURE 1.
 - B) WHEN "L" IS > THE STORAGE LENGTH OF THE TURN LANE OR THE TURN LANE IS WITHIN THE LANE CLOSURE, USE FIGURE 2.
- 2. CONES MAY BE SUBSTITUTED FOR BARRICADES OR DRUMS AT HALF THE SPACING DURING DAY OPERATIONS. CONES SHALL BE A MINIMUM OF 28 (710) IN HEIGHT.
- 3. LIGHTS WILL NOT BE REQUIRED ON BARRICADES OR DRUMS FOR DAY OPERATIONS. ALL LIGHTS SHALL BE MONODIRECTIONAL.
- 4. REFLECTIVE TEMPORARY PAVEMENT MARKINGS SHALL BE PLACED THROUGHOUT THE BARRICADED AREAS OF EACH TURN BAY AS SHOWN WHERE THE CLOSURE TIME IS GREATER THAN FOURTEEN (14) DAYS.
- 5. THIS APPLICATION ALSO APPLIES WHEN WORK IS BEING PERFORMED IN THE RIGHT LANE(S) AND THE RIGHT TURN BAY IS TO REMAIN OPEN. UNDER THIS CONDITION, "RIGHT TURN LANE" R3-I100R 24 x 24 (600 x 600) AND M6-2R 21 \times 15 (530 \times 380) SHALL BE USED.
- 6. THESE CONTROLS SHALL SUPPLEMENT MAINLINE TRAFFIC CONTROL FOR LANE CLOSURES.
- 7. THE SIGNS SHALL BE MOUNTED ABOVE THE BARRICADES/DRUMS ON SEPARATE SIGN SUPPORTS THAT MEET NCHRP 350 OR MASH PREQUIREMENTS.
- 8. TRAFFIC CONTROL AND PROTECTION AT TURN BAYS (TO REMAIN OPEN TO TRAFFIC) SHALL BE INCLUDED IN THE COST OF SPECIFIED TRAFFIC CONTROL STANDARDS OR ITEMS.

TURN BAY ENTRANCE WITHIN A LANE CLOSURE

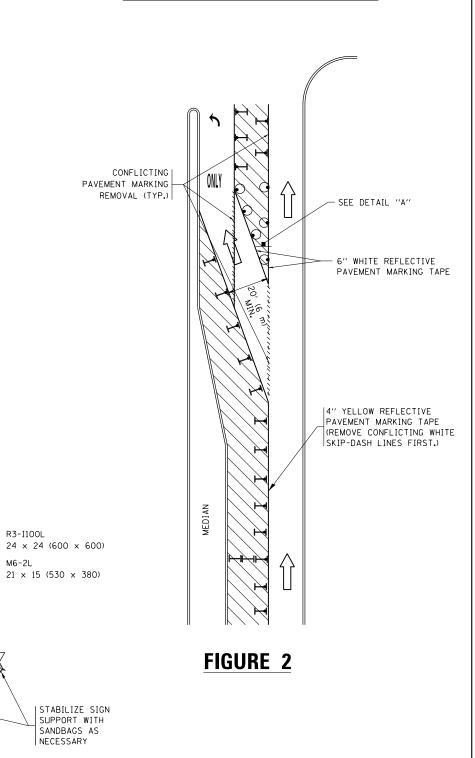


DETAIL A

TURN


All dimensions are in inches (millimeters) unless otherwise shown.

FIL		USER NAME = rothjp	REVISED -T. RAMMACHER 09-08-94 REVISED - R. BORO 09-14-09		TRAFFIC CONTROL AND PROTECTION AT TURN BAYS	RTE.	SECTION	COUNTY	SHEETS	10"
pw	:\\planroom.dot.ıllınoıs.gov:PWIDOT\Docu	ments\IDOT Offices\District l\Projects\Di1831	REVISED - A. SCHUETZE 07-01-13		(TO REMAIN OPEN TO TRAFFIC)	57	2019-056-BR	соок		25
		PLOT SCALE = 100.0000 '/ in.	REVISED - A. HOUSEH 10-12-96 REVISED - A. SCHUETZE 09-15-16	DEPARTMENT OF TRANSPORTATION	(TO REIVIAIN OPEN TO TRAFFIC)		TC-14	CONTRACT	T NO. 62	J33
De	efault	PLOT DATE = 10/16/2019	REVISED -T. RAMMACHER 01-06-00 REVISED -		SCALE: NONE SHEET 1 OF 1 SHEETS STA. TO STA.		ILLINOIS FED. A	ID PROJECT		

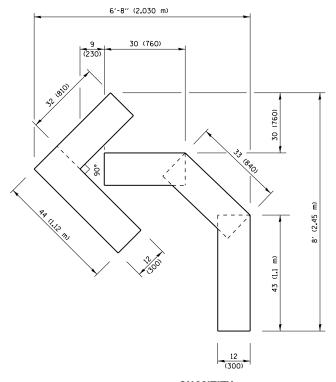


QUANTITY

4 (100) LINE = 45.5 ft. (13.9 m) 15.2 sq. ft. (1.41 sq. m)

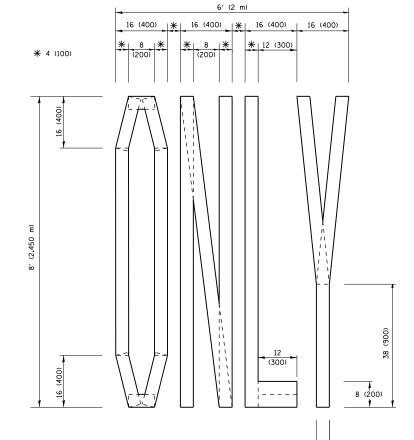

4 (100) LINE = 64.1 ft. (19.5 m) 21.4 sq. ft. (1.99 sq. m)

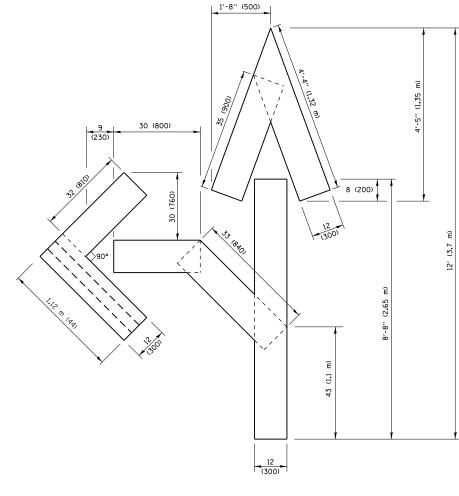


QUANTITY

4 (100) LINE = 82.5 ft. (25.1 m) 27.5 sq. ft. (2.53 sq. m)

NOTE:

ALL QUANTITIES OF PLACEMENT ARE REPRESENTED IN LINEAR FEET OF 4" LINES TO MATCH THE 4" TEMPORARY TAPE PAY ITEM AND REPRESENTS THE TOTAL QUANTITY OF 4" TAPE REQUIRED.

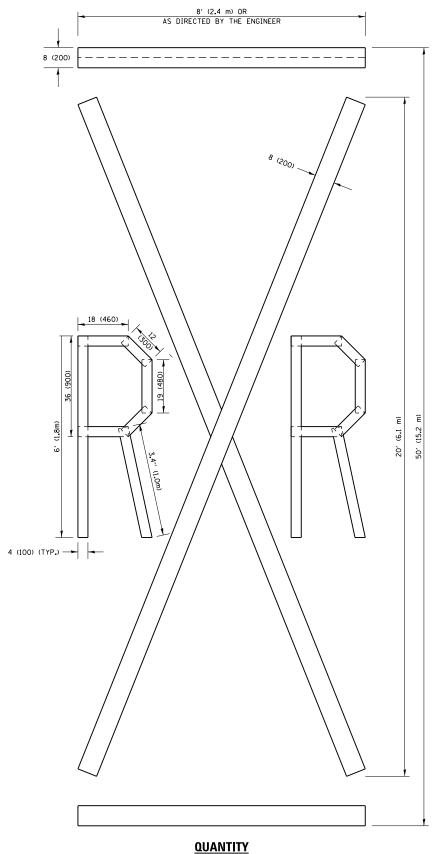

4 (100) LINE = 225.9 ft. (68.9 m) 75.3 sq. ft. (6.99 sq. m)


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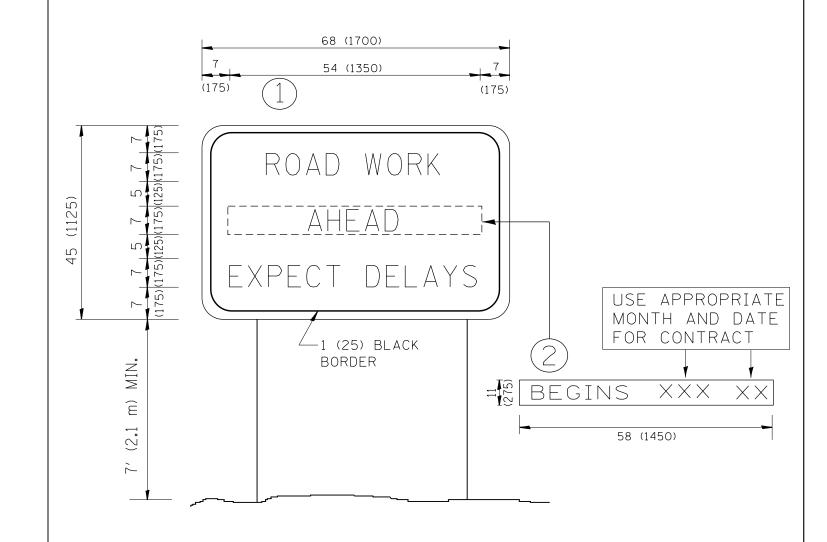
FILE NAME =	USER NAME = rothjp	DESIGNED -	REVISED	-T. RAMMACHER 03-02-98
pw:\\planroom.dot.illinois.gov:PWIDOT\Docu	nents\IDOT Offices\District 1\Projects\Di1831	\ DRAWN o\Design\DistStd.dgn	REVISED	-E. GOMEZ 08-28-00
	PLOT SCALE = 100.0000 '/ in.	CHECKED -	REVISED	-E. GOMEZ 08-28-00
	PLOT DATE = 10/16/2019	DATE - 09-18-94	REVISED	- A. SCHUETZE 09-15-16

QUANTITY

STATE OF ILLINOIS **DEPARTMENT OF TRANSPORTATION**

	l 6			F.A.I. RTE.	SECTION	COUNTY	TOTAL SHEETS	SHEET NO.			
	SHORT TERM PAVEMENT MARKING LETTERS AND SYMBOLS					57	2019-056-BR	соок	31	26	
							TC-16	CONTRACT NO. 62J33			
	SCALE: NONE	SHEET N	IO. 1 OF 1	SHEETS	STA.	TO STA.	EED B	OAD DIST NO 1 THE INDIS EED AT	D PPO IECT		



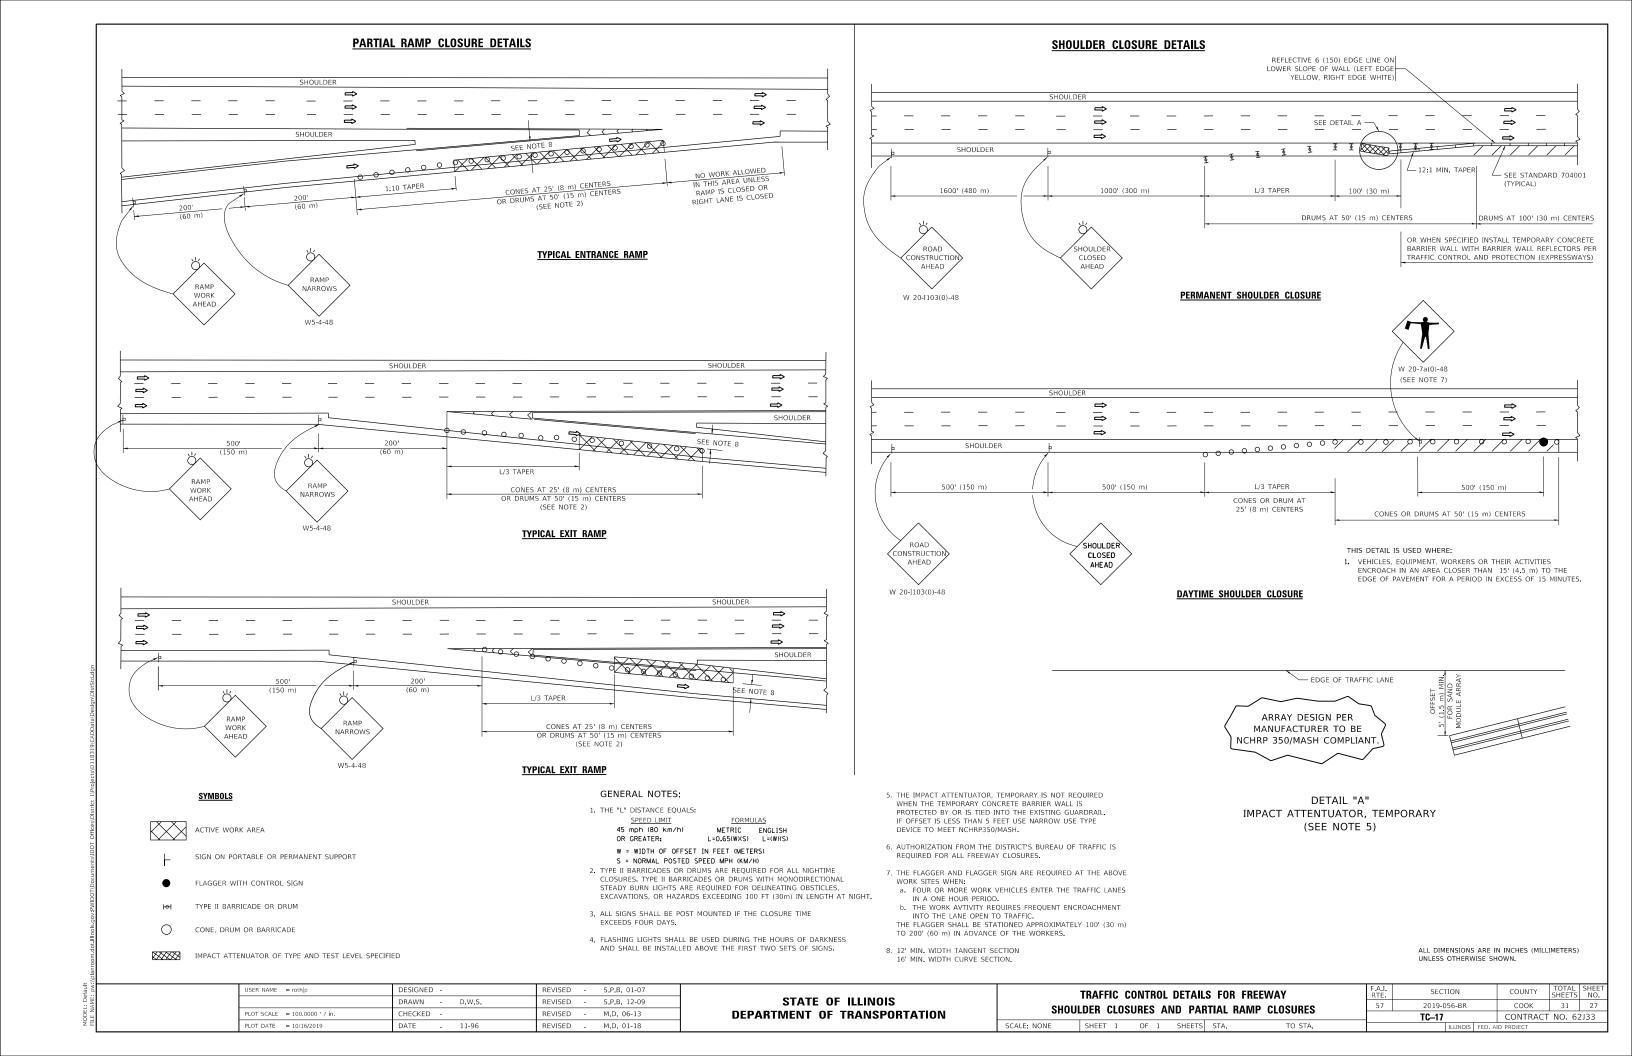



NOTES:


- 1. USE BLACK LETTERING ON ORANGE BACKGROUND.
- 2. ERECT SIGNS IN ADVANCE OF THE LOCATION FOR THE "ROAD CONSTRUCTION AHEAD" SIGN AT LOCATIONS AS DIRECTED BY THE ENGINEER.
- 3. ERECT SIGN (1) WITH INSTALLED PANEL (2) ONE WEEK PRIOR TO THE START OF CONSTRUCTION.
- 4. REMOVE PANEL (2) SOON AFTER THE START OF CONSTRUCTION.
- 5. SEE SPECIAL PROVISION FOR "TEMPORARY INFORMATION SIGNING" FOR ADDITIONAL INFORMATION.
- 6. ONE SIGN ASSEMBLY EQUALS 25.70 SQ. FT. (2.3 SQ. M.)
- 7. SHALL BE PAID FOR AS TEMPORARY INFORMATION SIGNING.

ALL DIMENSIONS ARE IN INCHES (MILLIMETERS) UNLESS OTHERWISE SHOWN.


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pw://planroom.dot.illino	ois.gov:PWIDOT\Documents\IDC	OT Offices\District 1\Projects\Di1831	\ DAXWN b\Design\DistStd.dgn		R. MIRS 12-11-97	STATE OF ILLINOIS		INFORMATION S			57	2019-056-BR	соок	31	28
	PLOT SO	CALE = 100.0000 '/ in.	CHECKED -	REVISED -T.	. RAMMACHER 02-02-99	DEPARTMENT OF TRANSPORTATION						TC-22	CONTRACT	T NO. 67	2J33
	PLOT DA	ATE = 10/16/2019	DATE -	REVISED -	C. JUCIUS 01-31-07		SCALE: NONE	SHEET NO. 1 OF 1 SHEETS	STA.	TO STA.	FED. ROAD	DIST. NO. 1 ILLINOIS FED. A	.D PROJECT		

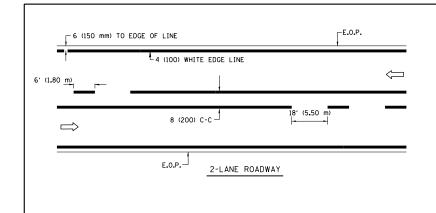


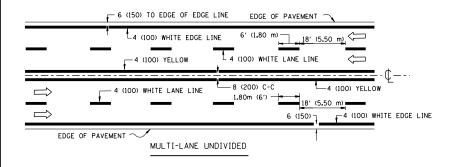

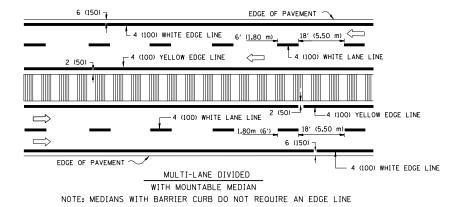


TYPICAL LANE AND EDGE LINE MARKING

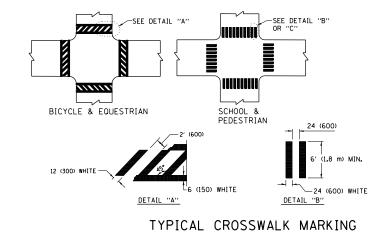


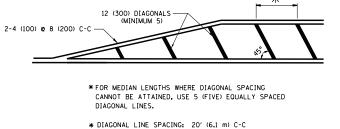

PAINTED MEDIANS

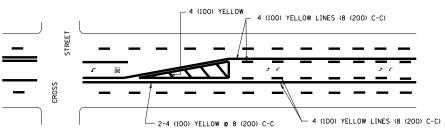


A MINIMUM OF TWO PAIRS OF TURN ARROWS SHALL BE USED, WHITE IN COLOR. ADDITIONAL PAIRS SHALL BE PLACED AT 200' (60 m) TO 300' (90 m) INTERVALS

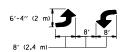

MEDIAN WITH TWO-WAY LEFT TURN LANE

TYPICAL PAINTED MEDIAN MARKING

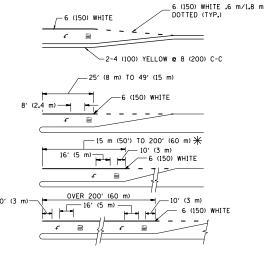


FULL SIZE LETTERS 8' (2.4 m) AND ARROWS SHALL BE USED. \P AREA = 15.8 SO. FT. (1.47 m²) ONLY AREA = 22.9 SO. FT. (2.13 m²)

* TURN LANES IN EXCESS OF 400' (120 m) IN LENGTH MAY HAVE AN ADDITIONAL SET OF ARROW - "ONLY" INSTALLED MIDWAY BETWEEN THE OTHER TWO SETS OF ARROW - "ONLY".

TYPICAL LEFT (OR RIGHT) TURN LANE

TYPICAL TURN LANE MARKING

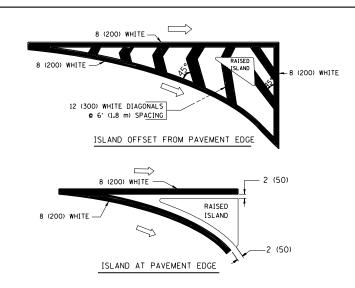

TYPICAL ISLAND MARKING

TYPE OF MARKING	WIDTH OF LINE	PATTERN	COLOR	SPACING / REMARKS
CENTERLINE ON 2 LANE PAVEMENT	4 (100)	SKIP-DASH	YELLOW	6' (1.80 m) LINE WITH 18' (5.50 m) SPACE
CENTERLINE ON MULTI-LANE UNDIVIDED PAVEMENT	2 @ 4 (100)	SOLID	YELLOW	8 (200) C-C
NO PASSING ZONE LINES: FOR ONE DIRECTION FOR BOTH DIRECTIONS	4 (100) 2 @ 4 (100)	SOLID SOLID	YELLOW YELLOW	8 (200) C-C
LANE LINES	4 (100) 5 (125) ON FREEWAYS	SKIP-DASH SKIP-DASH	WHITE WHITE	6' (1.80 m) LINE WITH 18' (5.50 m) SPACE
DOTTED LINES (EXTENSIONS OF CENTER, LANE OR TURN LANE MARKINGS)	SAME AS LINE BEING EXTENDED	SKIP-DASH	SAME AS LINE BEING EXTENDED	2' (600) LINE WITH 6' (1.8) SPACE
EDGE LINES	4 (100)	SOLID	YELLOW-LEFT WHITE-RIGHT	OUTLINE MOUNTABLE MEDIANS IN YELLOW: EDGE LINES ARE NOT USED NEXT TO BARRIER CURB
TURN LANE MARKINGS	6 (150) LINE: FULL SIZE LETTERS & SYMBOLS (8' (2.4 m))	SOLID	WHITE	SEE TYPICAL TURN LANE MARKING DETAIL
TWO WAY LEFT TURN MARKING	2 @ 4 (100) EACH DIRECTION	SKIP-DASH AND SOLID	YELLOW	6' (1.8 m) LINE WITH 18' (5.50 m) SPACE FOR SKIP-DASH: 8 (200) C-C BETWEEN SOLID LINE AND SKIP-DASH LINE
	8' (2.4 m) LEFT ARROW	IN PAIRS	WHITE	SEE TYPICAL TWO-WAY LEFT TURN MARKING DETAIL
CROSSWALK LINES A. DIAGONALS (BIKE & EQUESTRIAN) B. LONGITUDINAL BARS (SCHOOL & PEDESTRIAN)	12 (300) © 45° 24 (600) © 90°	SOLID SOLID	WHITE WHITE	2' (600) APART 2' (600) APART SEE TYPICAL CROSSWALK MARKING DETAILS.
STOP LINES	24 (600)	SOLID	WHITE	PLACE 4' (1.2 m) IN ADVANCE OF AND PARALLEL TO CROSSMALK, IF PRESENT, OTHERNISE, PLACE AT DESIRED STOPPING POINT. PARALLEL TO CROSSROAD CENTERLINE, WHERE POSSIBLE
PAINTED MEDIANS	2 @ 4 (100) WITH 12 (300) DIAGONALS @ 45°	SOLID	YELLOW: TWO WAY TRAFFIC WHITE: ONE WAY TRAFFIC	8 (200) C-C FOR THE DOUBLE LINE SEE TYPICAL PAINTED MEDIAN MARKING.
GORE MARKING AND CHANNELIZING LINES	8 (200) WITH 12 (300) DIAGONALS @ 45°	SOLID	WHITE	DIACONALS: 20' (6.1 m) (LESS THAN 30 MPH (50 km/h))
RAILROAD CROSSING	24 (600) TRANSVERSE LINES; "RR" IS 6' (1.8 m) LETTERS; 16 (400) LINE FOR "X"	SOLID	WHITE	SEE STATE STANDARD 780001 AREA OF: "R"=3,6 SO. FT. (0.33m ²) EACH "X"=54,0 SO. FT. (5,0 m ²)

FOR FURTHER DETAILS ON PAVEMENT MARKING REFER TO STREET MARKING STANDARDS, PRINTED BY CITY OF CHICAGO, DEPARTMENT OF TRANSPORTATION, BUREAU OF TRAFFIC.

ALL DIMENSIONS ARE IN INCHES (MILLIMETERS) UNLESS OTHERWISE SHOWN.

FILE NAME =	USER NAME = rothjp	DESIGNED -	REVISED	-T. RAMMACHER	12-07-00
pw://planroom.dot.illinois.gov:PWIDOT/Docu	nents\IDOT Offices\District 1\Projects\Di1831	\ DRAWN o\Design\DistStd.dgn	REVISED	- K. ENG	02-28-12
	PLOT SCALE = 100.0000 '/ in.	CHECKED -	REVISED	-	
	PLOT DATE = 10/16/2019	DATE -	REVISED	-	

24 (600) WHITE


DETAIL "C"


CENTRAL DOWNTOWN

BUSINESS DISTRICT

STATE OF ILLINOIS DEPARTMENT OF TRANSPORTATION


	CITY OF CHICA	RTE.	SECTION	COUNTY	SHEETS	NO.				
	TYPICAL DAVEMENT	57	соок	31	29					
	TYPICAL PAVEMENT MARKINGS					TC-24 CONTRACT NO				
SCALE: NONE	SHEET NO. 1 OF 3 SHEETS	STA.	TO STA.	FED. ROAD DIST. NO. 1 ILLINOIS FED. AID PROJECT						

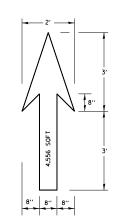

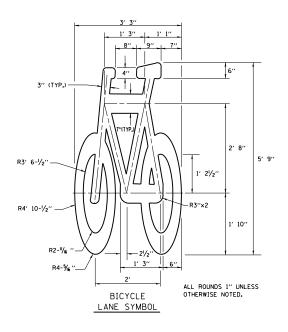

- NOTE:
 1.) FOR BIKE LANE SYMBOLS ONLY,
 USE PRE-FORMED THERMOPLASTIC
 WITH A MINIMUM THICKNESS OF 90 MILS,
 MINIMUM SKID RESISTANCE VALUE OF 60 BPN,
 & A MINIMUM INDEX OF REFRACTION OF 1.50.
- 2.) THE RESIDENT ENGINEER SHALL CONTACT MR. BEN GOMBERG AT 312-744-8093 AT LEAST ONE CALENDAR WEEK PRIOR TO INSTALLING BIKE LANE SYMBOLS.

TYPICAL BIKE LANE SYMBOLS
DRAWING *28

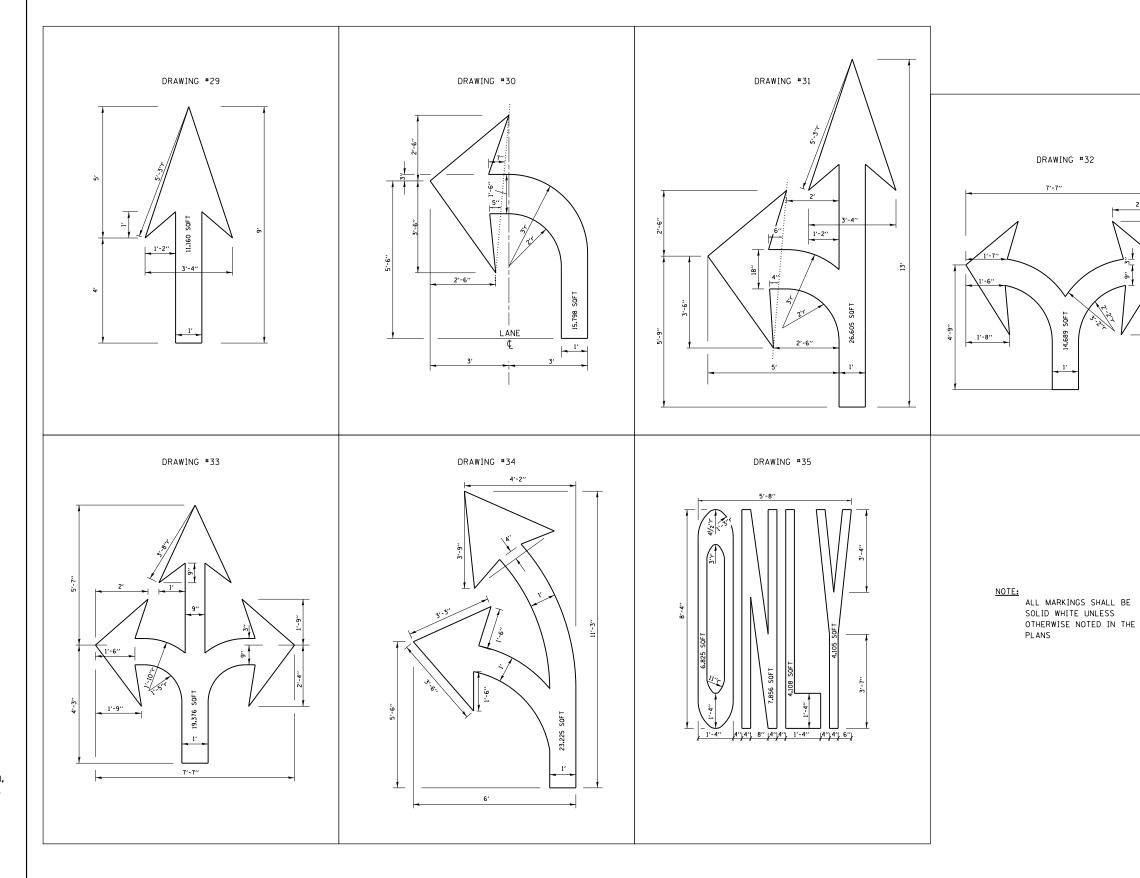

FILE NAME =	USER NAME = rothjp	DESIGNED -	REVISED -T. RAMMACHER 12-07-00		CITY OF CHICAGO			F.A.I.	SECTION	COUNTY	TOTAL SHEET SHEETS NO.	
pw:\\planroom.dot.ıllınoıs.gov:PWIDOT\Docu	ents\IDOT Offices\District 1\Projects\D11831	\ DRXXWN a\Design\DistStd.dgn	REVISED - K. ENG 01-12-12	STATE OF ILLINOIS					57	2019-056-BR	СООК	31 30
	PLOT SCALE = 100.0000 ' / in.	CHECKED -	REVISED -	DEPARTMENT OF TRANSPORTATION	TYPICAL PAVEMENT MARKINGS				TC-24	CONTRAC	CT NO. 62J33	
	PLOT DATE = 10/16/2019	DATE -	REVISED -		SCALE: NONE	SHEET NO. 2 OF 3 SHEETS	STA.	TO STA.	FED. ROA	D DIST. NO. 1 ILLINOIS	FED. AID PROJECT	

