FOR INDEX OF SHEETS, SEE SHEET NO. 2

STATE OF ILLINOIS DEPARTMENT OF TRANSPORTATION

FAU 1372 22 BJ CONTRACT NO. 62T41 * 50 + 3 = 53 TOTAL SHEETS


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D-91-294-22

1372



LOCATION OF SECTION INDICATED THUS: -

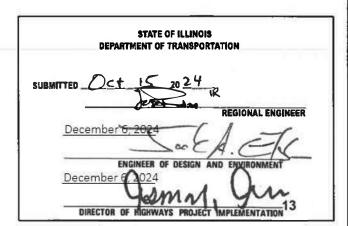

PRINTED BY THE AUTHORITY OF THE STATE OF ILLINOIS

PROPOSED HIGHWAY PLANS

F.A.U. ROUTE 1372 (ADDISON STREET) OVER FAI 90/94 AND CTA SECTION FAU 1372 22 BJ PROJECT BR-47AB(268) BRIDGE DECK OVERLAY AND JOINT REPAIR COOK COUNTY

C-91-348-22

PROJECT LOCATION **STRUCTURE NO. 016-0669**



LOCATION MAP

GROSS LENGTH = 921 FT. = 0.17 MILE NET LENGTH = 921 FT. = 0.17 MILE

PROJECT IS LOCATED IN CITY OF CHICAGO

TRAFFIC_DATA

0

0

0

ADDISON STREET:

FUNCTIONAL CLASS = MAJOR COLLECTOR

ADT (2023) = 17,400

POSTED SPEED LIMIT = 30 MPH


FAI 90/94 (KENNEDY EXPRESSWAY): **FUNCTIONAL CLASS = INTERSTATE** ADT (2023) = 205,000POSTED SPEED LIMIT = 55 MPH



Ander 1 O Bin SIGNATURE

10/11/2024

10/11/2024

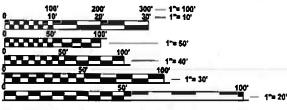

FULL SIZE PLANS HAVE BEEN PREPARED USING STANDARD ENGINEERING SCALES. REDUCED SIZED PLANS WILL NOT CONFORM TO STANDARD SCALES. IN MAKING MEASUREMENTS ON REDUCED PLANS, THE ABOVE SCALES MAY BE USED.

DIGGER (312) 744-7000

PROJECT MANAGER: PRAVEEN KAINI, P.E. (847)705-4237

CONTRACT NO. 62T41

INDEX OF SHEETS

- COVER SHEET
- INDEX OF SHEETS, HIGHWAY STANDARDS, AND GENERAL NOTES
- SUMMARY OF QUANTITIES
- MAINTENANCE OF TRAFFIC PLANS 6-14A
- CUSTOM OVERHEAD SIGNAGE DETAILS
- TEMPORARY TRAFFIC SIGNAL PLANS 15-17 REMOVAL PLAN
- 19 ROADWAY PLAN
- ADA RAMP DETAILS
- 20-21 PAVEMENT MARKING PLAN
- 23-34 STRUCTURE PLANS
- 35-50 DISTRICT DETAILS

HIGHWAY STANDARDS

STANDARD NO.	DESCRIPTION
000001-08	STANDARD SYMBOLS, ABBREVIATIONS, AND PATTERNS
001001-02	AREAS OF REINFORCEMENT BARS
424001-12	PERPENDICULAR CURB RAMPS FOR SIDEWALKS
606001-08	CONCRETE CURB TYPE B AND COMBINATION CONCRETE CURB AND GUTTER
701301-04	LANE CLOSURE, 2L 2W, SHORT TIME OPERATIONS
701311-03	LANE CLOSURE, 2L 2W, MOVING OPERATIONS DAY ONLY
701400 - 12	APPROACH TO LANE CLOSURE, FREEWAY/EXPRESSWAY
701401-13	LANE CLOSURE, FREEWAY/EXPRESSWAY
701406-13	LANE CLOSURE, FREEWAY/EXPRESSWAY, DAY OPERATIONS ONLY
701427-05	LANE CLOSURE MULTILANE INTERMITTENT OR MOVING OPERATIONS 40MPH OR LESS
701428-01	TRAFFIC CONTROL, SETUP AND REMOVAL, FREEWAY/EXPRESSWAY
701446-11	TWO LANE CLOSURE FREEWAY/EXPRESSWAY
701606 - 10	URBAN SINGLE LANE CLOSURE, MULTILANE, 2W WITH MOUNTABLE MEDIAN
701611-01	URBAN HALF ROAD CLOSURE, MULTILANE, 2W WITH MOUNTABLE MEDIAN
701701-10	URBAN LANE CLOSURE, MULTILANE INTERSECTION
701801-06	SIDEWALK, CORNER OR CROSSWALK CLOSURE
701901-10	TRAFFIC CONTROL DEVICES
704001-08	TEMPORARY CONCRETE BARRIER
780001-05	TYPICAL PAVEMENT MARKINGS
782006-01	GUARDRAIL AND BARRIER WALL REFLECTOR MOUNTING DETAILS

IDOT DISTRICT 1 STANDARD DETAILS

STANDARD NO.	DESCRIPTION
BD-17	DETAILS FOR P.C CONCRETE DRIVEWAY, ALLEY RETURN AND SIDEWALK
BD-24	CURB OR CURB AND GUTTER REMOVAL AND REPLACEMENT
BD-32	BUTT JOINT AND HMA TAPER DETAILS
BD-33	HMA TAPER AT EDGE OF P.C.C. PAVEMENT
BD-58	CITY OF CHICAGO DETECTABLE WARNINGS
TC-8	ENTRANCE AND EXIT RAMP CLOSURE DETAILS
TC-9	SINGLE LANE WEAVE AND MULTI-LANE WEAVE
TC-10	TRAFFIC CONTROL AND PROTECTION FOR SIDE ROADS, INTERSECTIONS, AND DRIVEWAYS
TC-12	MULTI-LANE FREEWAY PAVEMENT MARKING DETAILS
TC-16	SHORT-TERM PAVEMENT MARKING LETTERS AND SYMBOLS
TC-17	TRAFFIC CONTROL AND DETAILS FOR FREEWAY SHOULDER CLOSURES AND PARTIAL RAMP CLOSURES
TC-21	DETOUR SIGNING FOR CLOSING STATE HIGHWAYS
TC-22	ARTERIAL ROAD INFORMATION SIGN
TC-24	CITY OF CHICAGO TYPICAL PAVEMENT MARKINGS

HMA MIXTURE REQUIREMENTS

MIXTURE TYPE	AIR VOIDS @ NDES	QUALITY MANAGEMENT PROGRAM (QMP)				
HMA OVERLAY AND BUTT JOINT						
POLYMERIZED HMA SURFACE COURSE IL-9.5 MIX E N70; 1 3/4" 4% AT 70 GYR. QC/QA						
QMP DESIGNATIONS: QUALITY CONTROL/QUALITY ASSURANCE (QC/QA), QUALITY CONTROL FOR PERFORMANCE (QCP), PAY FOR PERFORMANCE (PFP)						

- 1. THE UNIT WEIGHT USED TO CALCULATE ALL HOT-MIX ASPHALT SURFACE MIXTURE QUANTITIES IS 112 LBS/SQYD/IN.
- 2. THE "AC TYPE" FOR POLYMERIZED HMA MIXES SHALL BE "SBS/SBR PG 76-22" AND FOR NON-POLYMERIZED HMA THE "AC TYPE" SHALL BE "PG 64-22" UNLESS MODIFIED BY RECLAIMED MATERIALS SPECIFICATIONS.

GENERAL NOTES

- 1. BEFORE STARTING ANY EXCAVATION, THE CONTRACTOR SHALL CALL DIGGER AT (312) 744-7000 FOR FIELD LOCATIONS OF BURIED ELECTRIC TELEPHONE AND GAS FACILITIES (48 HOUR NOTIFICATION REQUIRED).
- 2. THE CONTRACTOR WILL NOT BE ALLOWED TO SET UP A YARD OR FIELD OFFICE ON STATE OR CITY PROPERTY WITHOUT WRITTEN PERMISSION FROM THE DEPARTMENT.
- 3. IT SHALL BE THE CONTRACTOR'S RESPONSIBILITY TO VERIFY ALL DIMENSIONS AND CONDITIONS EXISTING IN THE FIELD PRIOR TO CONSTRUCTION AND ORDERING OF MATERIALS.
- 4. THE CONTRACTOR SHALL TAKE EXTREME CARE WHEN PERFORMING DEMOLITION AND REMOVAL AROUND THE EXITING FACILITIES TO REMAIN IN PLACE, IF EXISTING ELEMENTS ARE DAMAGED, THE CONTRACTOR SHALL REPAIR/RESTORE TO MATCH THE EXISTING
- 5. BEFORE BEGINNING ANY WORK, THE CONTRACTOR SHALL RETAIN AND RECORD FOR FUTURE REFERENCES, ALL EXISTING PAVEMENT MARKING LINES (AND RAISED REFLECTIVE PAVEMENT MARKERS) IN ORDER THAT THESE LOCATIONS CAN BE RE-ESTABLISHED FOR
- 6. THE CONTRACTOR SHALL CONTACT KALPANA KANNAN-HOSADURGA, THE DISTRICT ONE TRAFFIC CONTROL SUPERVISOR, AT KALPANA.KANNAN-HOSADURGA@ILLINOIS.GOV A MINIMUM OF 72 HOURS IN ADVANCE OF BEGINNING WORK.
- 7. TWO WEEKS PRIOR TO THE PLACEMENT OF PERMANENT PAVEMENT MARKINGS, THE ENGINEER SHALL CONTACT MR. EMAD ALHUSSEINI, AREA TRAFFIC FIELD ENGINEER, AT EMAD.ALHUSSEINI@ILLINOIS.GOV.
- 8. NO WORK SHALL COMMENCE UNTIL TRAFFIC CONTROL REQUIREMENTS ARE MET.
- 9. DURING CONSTRUCTION OPERATIONS, WHENEVER LOOSE MATERIAL IS DEPOSIT IN THE FLOW LINE OF GUTTER, DRAINAGE STRUCTURES, DITCHES, ETC. SUCH THAT THE NATURAL FLOW LINE OF WATER IS OBSTRUCTED. THE LOOSE MATERIAL SHALL BE REMOVED AT THE CLOSE OF EACH WORKING DAY, AT THE CONCLUSION OF THE CONSTRUCTION OPERATIONS, ALL DRAINAGE STRUCTURES AND FLOW LINES SHALL BE FREE FROM DIRT AND DEBRIS.
- 10. WHEN ARTIFICIAL LIGHTS ARE USED THE CONTRACTOR SHALL EXERCISE THE UTMOST PRECAUTIONS IN PREVENTING ADVERSE VISIBILITY TO THE MOTORING PUBLIC AND ADJOINING RESIDENTIAL AREAS.
- 11. SAW CUTS (FULL DEPTH) SHALL BE REQUIRED WITHIN THE PAVEMENT, SIDEWALK, AND CURB & GUTTER AND THAT TO BE LEFT IN PLACE OR DIRECTED BY THE ENGINEER. THE WORK WILL NOT BE PAID FOR SEPARATELY BUT SHALL BE INCLUDED IN THE COST OF REMOVAL
- 12. TEN (10) FOOT TRANSITIONS SHALL BE USED TO MATCH PROPOSED CURB AND GUTTER AND MEDIAN ITEMS OF WORK TO EXISTING CURB AND GUTTER AND MEDIAN IN THE FIELD.
- 13. THE CONTRACTOR SHALL BE RESPONSIBLE FOR THE PROTECTION OF ALL UNDERGROUND OR SURFACE UTILITIES EVEN THOUGH THEY MAY NOT BE SHOWN ON THE PLANS. ANY UTILITY THAT IS DAMAGED DURING CONSTRUCTION SHALL BE REPAIRED OR REPLACED TO THE SATISFACTION OF THE ENGINEER, THIS WORK SHALL BE AT THE CONTRACTOR'S EXPENSE.
- 14. THE CONTRACTOR SHALL TAKE WHATEVER PRECAUTIONS WHICH MAY BE NECESSARY TO PROTECT THE PROPERTY OF THE VARIOUS PUBLIC UTILITIES WHICH MAY BE LOCATED UNDERGROUND OR ABOVE GROUND, AT OR ADJACENT TO THE SITE OF THIS IMPROVEMENT, HE WILL BE REQUIRED TO REPAIR OR REPLACE AT HIS OWN EXPENSE, OR BEAR THE COST, TO REPAIR OR REPLACE, ANY PUBLIC UTILITY PROPERTY WHICH HAS BEEN DAMAGED HIS EFFORTS.
- 15. CONTRACTOR SHALL NOT ALTER THE BRIDGE VERTICAL CLEARANCE.

CITY OF CHICAGO GENERAL NOTES

- 1. IN CASE OF DAMAGE TO CITY OF CHICAGO SEWERS, PRIVATE AND PUBLIC DRAINS SEWER STRUCTURES AND/OR BENCH MONUMENTS, THE CONTRACTOR SHALL IMMEDIATELY CONTACT THE DEPARTMENT OF SEWERS AT (312) 747-7892 OR (312) 747-7893.
- 2. THE CONTRACTOR SHALL CONTACT THE CITY OF CHICAGO TRANSIT AUTHORITY (CTA) AT TRAFFIC.PLANNING@TRANSITCHICAGO.COM SIX (6) WEEKS PRIOR TO CONSTRUCTION TO REPORT TRAFFIC IMPACTS
- 3. IF CTA BUS STOP SIGNS ARE TO BE IMPACTED BY CONSTRUCTION. CONTRACTOR SHALL CONTACT CTA TO COORDINATE BUS STOP RELATED SIGNING REVISIONS/CHANGES AND SIGN FABRICATION, CTA BUS STOP SIGNS ARE FABRICATED BY CTAAND WILL BE REMOVED & INSTALLED
- 4. EXISTING FACILITY PROTECTION EFP-127619 WAS SUBMITTED BY IDOT TO THE OFFICE OF UNDERGROUND COORDINATION (OUC) FOR PHASE 2 REVIEW ONLY. EFP-127619 RECEIVED OUC PERMIT ISSUANCE AUTHORIZATION. THE CONTRACTOR IS RESPONSIBLE TO OBTAIN ALL CITY OF CHICAGO PERMITS, WHICH MAY REQUIRE THE CONTRACTOR TO START A NEW EFP IN THE OUC PORTAL IF DIRECTED TO DO SO BY OUC. THE CONTRACTOR CAN CONTACT THE CDOT PERMITTING OFFICE AT 312-744-4652 ANDCDOTPERMITSUPPORT@CITYOFCHICAGO.ORG.
- 5. THE CONTRACTOR NEEDS TO SUBMIT CONSTRUCTION PROCESS (CPP'S) TO CTA FOR REVIEW AND COMMENTS PRIOR TO THE COMMENCEMENT OF ANY WORK

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LOT SCALE = \$SCALE\$	CHECKED - MVW/AMS	REVISED -
LOT DATE = 8/30/2024	DATE - 6/21/2024	REVISED -

STATE OF ILLINOIS **DEPARTMENT OF TRANSPORTATION**

ADDISON STREET OVER I-90/94 AND CTA INDEX OF SHEETS, HIGHWAY STANDARDS, AND GENERAL NOTES SHEET OF #### SHEETS STA.

SECTION COUNTY 1372 FAU 1372 22 BJ COOK 50 2 CONTRACT NO. 62T41 LILLINGIS (FED. AID PROJECT

				I
28000500	INLET AND PIPE PROTECTION	EACH	2	İ
				l
31101200	SUBBASE GRANULAR MATERIAL, TYPE B 4"	SQ YD	48	l
				l
40600290	BITUMINOUS MATERIALS (TACK COAT)	POUND	101	ļ
40600985	PORTLAND CEMENT CONCRETE SURFACE REMOVAL - BUTT JOINT	SQ YD	225	ł
		34.5		l
40604172	POLYMERIZED HOT-MIX ASPHALT SURFACE COURSE, IL-9.5, MIX "E", N70	TON	43.3	ļ
				ļ
42400200	PORTLAND CEMENT CONCRETE SIDEWALK 5 INCH	SQFT	427	ļ
44000600	SIDEWALK REMOVAL	SQFT	427	l
				t
50102400	CONCRETE REMOVAL	CU YD	25.9	İ
				l
50157300	PROTECTIVE SHIELD	SQ YD	1910	ļ
50300255	CONCRETE SUPERSTRUCTURE	CU YD	28.8	ł
		00.15	20.0	ł
50300300	PROTECTIVE COAT	SQ YD	2166	İ
50800205	REINFORCEMENT BARS, EPOXY COATED	POUND	3650	ļ
E0000515	DAD CDLICEDS	FACIL	24	ļ
50800515	BAR SPLICERS	EACH	24	ł
		1		1

ITEM

	·			CODE 90% FED 10% STATE
				BRIDGE
CODE			TOTAL	0059
NO.	ITEM	UNIT	QUANTITY	S.N. 016-0669
			Te e	<u>e</u> n
60406000	FRAMES AND LIDS, TYPE 1, OPEN LID	EACH	2	2
60406100	FRAMES AND LIDS, TYPE 1, CLOSED LID	EACH	1	1
67100100	MOBILIZATION	L SUM	1	1
70107025	CHANCEARI E MESSACE SION	CAL DA	100	100
70107025	CHANGEABLE MESSAGE SIGN	CAL DA	108	108
70300150	SHORT TERM PAVEMENT MARKING REMOVAL	SQ FT	2009	2009
70300241	TEMPORARY PAVEMENT MARKING - LINE 6"- PAINT	FOOT	721	721
70307100	TEMPORARY PAVEMENT MARKING LETTERS AND SYMBOLS - TYPE IV TAPE	SQ FT	77	77
,				
70307120	TEMPORARY PAVEMENT MARKING - LINE 4" - TYPE IV TAPE	FOOT	5811	5811
70307130	TEMPORARY PAVEMENT MARKING - LINE 6" - TYPE IV TAPE	FOOT	143	143
70307160	TEMPORARY PAVEMENT MARKING - LINE 12"- TYPE IV TAPE	FOOT	190	190
70307210	TEMPORARY PAVEMENT MARKING - LINE 24"- TYPE IV TAPE	FOOT	103	103
70400100	TEMPORARY CONCRETE BARRIER	FOOT	375	375
		. 331	5,0	
70400200	RELOCATE TEMPORARY CONCRETE BARRIER	FOOT	362.5	362.5
70600241	IMPACT ATTENUATORS, TEMPORARY (NON- REDIRECTIVE, NARROW), TEST LEVEL 2	EACH	2	2

* INDICATES SPECIALTY ITEM

PREFORMED JOINT STRIP SEAL



52000110

CODE

NO.

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PLOT DATE = 8/30/2024	DATE - 6/21/2024	REVISED _

SCALE:

CONSTR. CODE

90% FED 10% STATE BRIDGE

0059

2

48

101

225

43.3

427

427

25.9

1910

28.8

2166

3650

24

161

QUANTITY S.N. 016-0669

TOTAL

UNIT

FOOT

161

	SUMMARY OF QUANTITIES			F.A.U. RTE.	SECTION	COUNTY	SHEETS	SHEET NO.		
				1372	FAU 1372 22 BJ	соок	50	3		
								CONTRA	CT NO. 6	2T41
	SHEET	OF ##	## SHEETS	STA.	TO STA.		ILLINOIS FE	D. AID PROJECT		

CONSTR.

	CODE NO.			ľ	90% FED 10% STATE
					BDIDGE
					BRIDGE
				TOTAL	0059
		ITEM	UNIT	QUANTITY	S.N. 016-0669
	0600341	IMPACT ATTENUATORS, RELOCATE (NON- REDIRECTIVE, NARROW), TEST	EACH	2	2
		LEVEL 2			
* 78	8000200	THERMOPLASTIC PAVEMENT MARKING - LINE 4"	FOOT	1219	1219
70	0000200	THERMOPLASTIC PAVEMENT MARKING - LINE 4	F001	1219	1219
* 78	8000400	THERMOPLASTIC PAVEMENT MARKING - LINE 6"	FOOT	24	24
-					
* 78	8000600	THERMOPLASTIC PAVEMENT MARKING - LINE 12"	FOOT	41	41
4-					
-100:					
* 78	8000650	THERMOPLASTIC PAVEMENT MARKING - LINE 24"	FOOT	160	160
			, , , ,		
* 78	8004620	PREFORMED PLASTIC PAVEMENT MARKING, TYPE D - STANDARD - LINE 4"	FOOT	404	404
" [/°	0004620	PREFORMED PLASTIC PAVEMENT MARKING, TYPE D - STANDARD - LINE 4	F001	404	404
		<u> </u>			
* 78	8004635	PREFORMED PLASTIC PAVEMENT MARKING, TYPE D - STANDARD - LINE 7"	FOOT	115	115
,					
* 78	8004645	PREFORMED PLASTIC PAVEMENT MARKING, TYPE D - STANDARD - LINE 9"	FOOT	234	234
1					
					-
* 78	8009000	MODIFIED URETHANE PAVEMENT MARKING - LETTERS AND SYMBOLS	SQFT	77	77
-		+			
* 78	8009004	MODIFIED URETHANE PAVEMENT MARKING - LINE 4"	FOOT	227	227
			. = = .		
* 78	8009006	MODIFIED URETHANE PAVEMENT MARKING - LINE 6"	FOOT	23	23
<u></u>	0008000	INIODII ILD ORE II IAINE PAVEIVIENT IVIARRIIVO - LIIVE 0	FUUT		۷۵
* 78	8009012	MODIFIED URETHANE PAVEMENT MARKING - LINE 12"	FOOT	85	85
* 78	8009024	MODIFIED URETHANE PAVEMENT MARKING - LINE 24"	FOOT	372	372
-					
* 78	8011025	GROOVING FOR RECESSED PAVEMENT MARKING 5"	FOOT	404	404
-		+			2

				CONSTR CODE 90% F 10% STAT
CODE NO.	ITEM	UNIT	TOTAL QUANTITY	9059 S.N. 016-06
				**
78011040	GROOVING FOR RECESSED PAVEMENT MARKING 8"	FOOT	115	115
78011050	GROOVING FOR RECESSED PAVEMENT MARKING 10"	FOOT	234	234
78300202	PAVEMENT MARKING REMOVAL - WATER BLASTING	SQ FT	1751	1751
				8
85000200	MAINTENANCE OF EXISTING TRAFFIC SIGNAL INSTALLATION	EACH	2	2
X 0325839	SIGNAL TIMING	L SUM	1	1
X4240800	DETECTABLE WARNINGS (SPECIAL)	SQ FT	39	39
X4400100	PORTLAND CEMENT CONCRETE SURFACE REMOVAL (VARIABLE DEPTH)	SQ YD	183	183
X4400503	COMBINATION CURB AND GUTTER REMOVAL AND REPLACEMENT GREATER THAN 10 FEET	FOOT	191	191
X4406803	PORTLAND CEMENT CONCRETE SURFACE REMOVAL 1/4"	SQ YD	240	240
X5030250	BRIDGE DECK GROOVING (LONGITUDINAL)	SQ YD	1615	1615
X6700407	ENGINEER'S FIELD OFFICE, TYPE A (D1)	CAL MO	12	12
X7010216	TRAFFIC CONTROL AND PROTECTION, (SPECIAL)	L SUM	1	1
				10
X7011015	TRAFFIC CONTROL AND PROTECTION (EXPRESSWAYS)	L SUM	1	1
X7013820	TRAFFIC CONTROL SURVEILLANCE, EXPRESSWAYS	CAL DA	14	14

* INDICATES SPECIALTY ITEM

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1		ORION
4	\	ENGINEERS

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STATE OF ILLINOIS DEPARTMENT OF TRANSPORTATION

SCALE:

CONSTR. CODE

0					F.A.U. RTE.	SECTION		COUNTY	TOTAL SHEETS	SHEET NO.
SUMI	MARY	OF QUA	ANTITIES		1372	FAU 1372 22 BJ		соок	50	4
								CONTRAC	CT NO. 6	2T41
SHEET	OF ###	# SHEETS	STA.	TO STA.		ILLINOIS	FED. AID	PROJECT		

				10% STATE
		i	1	BRIDGE
CODE			TOTAL	0059
NO.	ITEM	EM UNIT QUANTITY S.I EPTH) SQ YD 1 RLAY, 2 1/2 INCHES SQ YD 1575 SQ YD 1393 DEPTH EQUAL TO OR LESS THAN 5 SQ FT 219 DEPTH GREATER THAN 5 INCHES) SQ FT 25 BE ADJUSTED EACH 7 CAL MO 2 JRANCE L SUM 1	S.N. 016-0669	
3:				
Z0001800	APPROACH SLAB REPAIR (PARTIAL DEPTH)	SQ YD	1	1
Z0006014	BRIDGE DECK LATEX CONCRETE OVERLAY, 2 1/2 INCHES	SQ YD	1575	1575
Z0012130	BRIDGE DECK SCARIFICATION 3/4"	SO YD	1393	1393
20012130	BRIDGE BEOR GOART TOATION 3/4	00.15	1555	1555
Z0012754	STRUCTURAL REPAIR OF CONCRETE (DEPTH EQUAL TO OR LESS THAN 5 INCHES)	SQ FT	219	219
Z0012755	STRUCTURAL REPAIR OF CONCRETE (DEPTH GREATER THAN 5 INCHES)	SQ FT	25	25
Z0017400	DRAINAGE & UTILITY STRUCTURES TO BE ADJUSTED	EACH	7	7
Z0029090	DIAMOND GRINDING (BRIDGE SECTION)	SQ YD	1496	1496
Z0033028	MAINTENANCE OF LIGHTING SYSTEM	CAL MO	2	2
Z0048665	RAILROAD PROTECTIVE LIABILITY INSURANCE	L SUM	1	1
72000200	SIGN PANEL - TYPE 2	SQ FT	72	72
4.5 7.6				£
72400320	REMOVE SIGN PANEL - TYPE 2	SQ FT	72	72
X6640210	TEMPORARY CHAIN LINK FENCE (PORTABLE)	FOOT	523	523
			1	
Z0030850	TEMPORARY INFORMATION SIGNING	SQ FT	52	52

* INDICATES SPECIALTY ITEM



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- 1	PLOT DATE = 8/30/2024	DATE	-	6/21/2024	REVISED	-


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CONSTR. CODE 90% FED

SUMMA	RY OF (QUANTI	TIES		F.A.U. RTE. 1372	SECTION FAU 1372 22 BJ	COUNTY	SHEETS 50	5	
SHEET OF	#### SHE	ETS STA.	Т	O STA.		ILLINOIS FED. AID				

MAINTENANCE OF TRAFFIC GENERAL NOTES

- 1. ALL MAINTENANCE OF TRAFFIC (MOT) LANE CLOSURES CAN BE COMPLETED WITH IDOT HIGHWAY STANDARDS (ADDISON STREET AND I-90/I-94). THE MOT PLANS SHALL SERVE AS A GUIDE FOR THE SAFE DIVERSION OF TRAFFIC DURING THE EXECUTION OF THIS CONTRACT. HOWEVER, THE CONTRACTOR MAY MODIFY THE MOT PLANS TO MEET THE CONSTRUCTION NEEDS BUT NOT AT THE EXPENSE OF PUBLIC SAFETY OR CONVENIENCE. ANY CHANGES TO THE MOT PLANS SHALL BE SUBMITTED TO THE ENGINEER FOR APPROVAL.
- THE CONTRACTOR SHALL CONTACT THE DISTRICT ONE TRAFFIC CONTROL SUPERVISOR ATKALPANA.KANNAN-HOSADURGA@ILLINOIS.GOV AND EXPRESSWAY TRAFFIC CONTROL SUPERVISOR AT CARLOS.MUNOZ@ILLINOIS.GOV A MINIMUM OF 72 HOURS IN ADVANCE OF REGINNING WORK.
- ADDISON STREET WORK ZONE SPEED LIMIT SHALL BE AS SHOWN TO THE RIGHT.
- 4. CHANGEABLE MESSAGE SIGNS SHALL BE INSTALLED TWO WEEKS PRIOR TO ALL TRAFFIC STAGE CHANGES ON EACH APPROACH OF THE AFFECTED ROADWAY TO WARN MOTORISTS OF THE UPCOMING EVENT. THESE SIGNS SHALL BE REMOVED TWO WEEKS THEREAFTER UNLESS THE SIGNS ARE NEEDED AGAIN FOR A SUBSEQUENT FUTURE EVENT THAT WILL OCCUR WITHIN TWO WEEKS ON THE SAME APPROACH OF THE AFFECTED ROADWAY. THE SIGN LOCATIONS SHALL BE DETERMINED BY THE ENGINEER.
- ALL EXISTING SIGNAGE THAT CONFLICTS WITH THE TRAFFIC STAGING CONFIGURATIONS SHOWN SHALL BE EITHER COVERED OR REMOVED AS APPROVED BY THE ENGINEER.
- 6. ALL EXISTING PAVEMENT MARKINGS THAT ARE IN CONFLICT WITH THE PROPOSED STAGING CONFIGURATIONS SHALL BE REMOVED AND PAID FOR AS "PAVEMENT MARKING REMOVAL WATER BLASTING".
- 7. THE CONTRACTOR SHALL REQUEST AND GAIN APPROVAL FROM THE ILLINOIS DEPARTMENT OF TRANSPORTATION'S EXPRESSWAY TRAFFIC OPERATIONS ENGINEER AT WWW.IDOTLCS.COM TWENTY-FOUR (24) HOURS IN ADVANCE OF ALL DAILY LANE, RAMP, AND SHOULDER CLOSURES AND SEVEN DAYS IN ADVANCE OF ALL PERMANENT AND WEEKEND CLOSURES ON ALL FREEWAYS AND/OR EXPRESSWAYS IN DISTRICT ONE. THIS ADVANCE NOTIFICATION IS CALCULATED BASED ON THE WORKWEEK OF MONDAY THROUGH FRIDAY AND SHALL NOT INCLUDE WEEKENDS OR HOLIDAYS.
- 9. ALL TRIPLE LANE CLOSURES ON THE KENNEDY SHALL START FROM THE LEFT.
- ANY LANE CLOSURES ALONG I-90/94 KENNEDY SHALL ONLY OCCUR DURING NIGHTTIME HOURS AS PER KEEPING THE EXPRESSWAY OPEN TO TRAFFIC SPECIAL PROVISION
- 11. CTA ADDISON STATION ACCESS TO REMAIN OPEN AT ALL TIMES.
- 12. CTA WILL BE NOTIFIED AT LEAST TWO WEEK PRIOR TO THE BEGINNING OF CONSTRUCTION.
- 13. THE CONTRACTOR MUST CONTACT CDOT'S DIVISION OF INFRASTRUCTURE MANAGEMENT AND SUBMIT A REQUEST FOR A STREET CLOSURE PERMIT. THE PERMIT MUST BE OBTAINED VIA EMAIL AT LEAST 4 WEEKS IN ADVANCE, AS ONLINE APPLICATIONS ARE NOT ACCEPTED.
- CONTRACTOR SHALL PLACE A TEMPORARY INFORMATION SIGN ALONG EASTBOUND AND WESTBOUND ADDISON ST. PRIOR TO CONSTRUCTION PER DISTRICT 1 STANDARD TC-22.

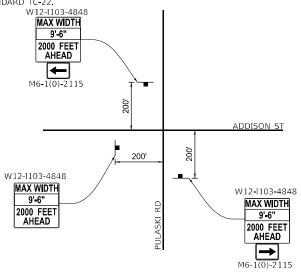

ADDISON STREET CONSTRUCTION STAGING

STAGE 1 - CONSTRUCTION:

 SCARIFY AND OVERLAY EXISTING BRIDGE AND APPROACH PAVEMENT WITHIN LIMITS OF THE WORK ZONE AS SHOWN ON THE MAINTENANCE OF TRAFFIC PLANS AND TYPICAL SECTIONS. PLACE BRIDGE DECK PATCHING ON ADDISION ST BRIDGE AS NECESSARY.

STAGE 1 - TRAFFIC:

- CLOSE THE NORTHERN HALF OF THE BRIDGE AND MAINTAIN ONE LANE OF TRAFFIC IN EACH DIRECTION ON THE SOUTHERN HALF OF THE BRIDGE.
- 2. SET UP DETOURS FOR LEFT TURN RESTRICTIONS.
- 3. CLOSE WEST SIDE OF NORTH SIDEWALK (STAGE 1A WORK ZONE, SEE PEDESTRIAN DETOUR PLANS) USING IDOT STANDARD DETAIL 701801-06 SIDEWALK, CORNER OR CROSSWALK CLOSURE TO RECONSTRUCT BRIDGE JOINT. SET UP PEDESTRIAN DETOURS TO MAINTAIN PEDESTRIAN ACCESS TO THE CTA STATION FROM THE EAST.
- 4. CLOSE EAST SIDE OF NORTH SIDEWALK (STAGE 1B WORK ZONE, SEE PEDESTRIAN DETOUR PLANS) USING IDOT STANDARD DETAIL 701801-06 SIDEWALK, CORNER OR CROSSWALK CLOSURE TO RECONSTRUCT BRIDGE JOINT. SET UP PEDESTRIAN DETOURS TO MAINTAIN PEDESTRIAN ACCESS TO THE CTA STATION FROM THE WEST.

STAGE 2 - CONSTRUCTION:

 SCARIFY AND OVERLAY EXISTING BRIDGE AND APPROACH PAVEMENT WITHIN LIMITS OF THE WORK ZONE AS SHOWN ON THE MAINTENANCE OF TRAFFIC PLANS AND TYPICAL SECTIONS. PLACE BRIDGE DECK PATCHING ON ADDISION ST BRIDGE AS NECESSARY.

STAGE 2 - TRAFFIC:


- 1. CLOSE THE SOUTHERN HALF OF THE BRIDGE AND MAINTAIN ONE LANE OF TRAFFIC IN EACH DIRECTION ON THE NORTHERN HALF OF THE BRIDGE.
- 2. MAINTAIN DETOURS SET UP IN STAGE 1.
- 3. CLOSE SOUTH SIDEWALK TO RECONSTRUCT BRIDGE JOINTS. SET UP PEDESTRIAN DETOURS TO REDIRECT PEDESTRIAN TRAFFIC TO THE NORTH SIDEWALK.

STAGE 3 - CONSTRUCTION:

 SCARIFY AND OVERLAY EXISTING APPROACH PAVEMENT WITHIN THE REMAINING SECTION ON THE WEST APPROACH. PLACE BRIDGE DECK PATCHING ON ADDISION ST BRIDGE AS NECESSARY.

STAGE 3 - TRAFFIC:

- CLOSE THE MIDDLE LANES OF TRAFFIC IN THE EB AND WB DIRECTIONS
 (INCLUDING EB LEFT TURN LANE) AND MAINTAIN ONE LANE OF TRAFFIC IN EACH
 DIRECTION AT THE WEST SIDE OF BRIDGE. REOPEN ADDITIONAL EB THRU LANE
 AND EB LEFT TURN LANE AT THE EAST SIDE OF BRIDGE.
- . MAINTAIN EASTBOUND KENNEDY EXPRESSWAY OFF-RAMP DETOUR SET UP IN STAGE 1.

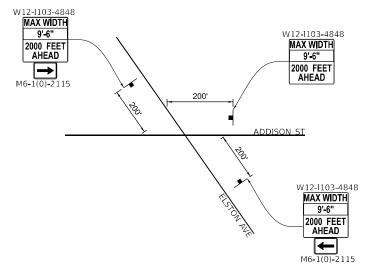

ADVANCE MAX WIDTH SIGNING DETAILS (STAGES 1 - 3)

Peralte-Clark

USER NAME = MET	DESIGNED	-	ARP	REVISED	-
	DRAWN	-	ARP	REVISED	-
PLOT SCALE = 100.000 / in.	CHECKED	-	ASO	REVISED	-
PLOT DATE = 11/21/2024	DATE	-	06/21/2024	REVISED	-

STATE OF ILLINOIS DEPARTMENT OF TRANSPORTATION

SCALE: N/A

ADDISON STREET WORK ZONE SPEED LIMIT

	EXISTING POSTED SPEED	PROPOSED POSTED SP
STAGE 1:	30 MPH	30 MPH
STAGE 2:	30 MPH	30 MPH
STAGE 3:	30 MPH	30 MPH

I-90/94 CONSTRUCTION STAGING

THE ADDISON STREET BRIDGE OVER I-90/94 SHALL BE REPAIRED BY TEMPORARY LANE/SHOULDER CLOSURES DURING ALLOWABLE TIMES. SEE BELOW FOR ALLOWABLE LANE/SHOULDER CLOSURE TIMES AND ADDITIONAL NOTES.

STAGE A - CONSTRUCTION:

 COMPLETE BRIDGE ABUTMENT REPAIRS OVER I-90/94 OUTSIDE SHOULDERS AND EMBANKMENTS IN BOTH EB AND WB DIRECTIONS. COMPLETE PIER REPAIRS OVER I-90/94 INSIDE SHOULDERS IN BOTH EB AND WB DIRECTIONS.

STAGE A - TRAFFIC:

1. CLOSE EB AND WB SHOULDER IN BOTH DIRECTIONS AND EB AND WB OUTSIDE TRAVEL LANE PER IDOT STD. 701400-12 APPROACH TO LANE CLOSURE FREEWAY EXPRESSWAY AND IDOT STD. 701401-13 LANE CLOSURE FREEWAY EXPRESSWAY

I-90/94 WORK ZONE SPEED LIMIT

EXISTING POSTED SPEED PROPOSED POSTED SPEED STAGE A: 55 MPH 55 MPH

LOCATION: I-90/94 KENNEDY: E. RIVER ROAD TO OHIO

WEEK NIGHT	TYPE OF CLOSURE	ALLOWABLE LAI	NE C	CLOSURE HOURS
SUNDAY - THURSDAY	1-LANE*	9:00 P.M.	то	5:00 A.M.
SUNDAT - THURSDAT	2-LANE	11:59 P.M.	то	5:00 A.M.
FRIDAY	1-LANE*	10:00 P.M. (FRI)	то	8:00 A.M.(SAT)
FRIDAT	2-LANE	11:59 P.M. (FRI)	то	6:00 A.M. (SAT)
SATURDAY	1-LANE*	9:00 P.M. (SAT)	то	10:00 A.M. (SUN)
SATURDAT	2-LANE	11:59 P.M. (SAT)	то	8:00 A.M. (SUN)

TEMPORARY SHOULDER/LANE CLOSURES ARE REQUIRED TO PERFORM SUBSTRUCTURE REPAIRS. LANE CLOSURES ALONG I-90/94 SHALL ONLY OCCUR DURING NIGHTTIME HOURS PER KEEPING THE EXPRESSWAY OPEN TO TRAFFIC SPECIAL PROVISION. LANE CLOSURE TIMES ARE ALSO LISTED ABOVE.

*KENNEDY 1-LANE CLOSURE HOURS MAY BE MORE RESTRICTIVE IF THE REVERSIBLE LANES ARE CLOSED.

LOCATION: I-90/94 KENNEDY REVERSIBLES

WEEK NIGHT	TYPE OF CLOSURE	ALLOWABLE LANE CLOSURE HOURS		CLOSURE HOURS
SUNDAY - THURSDAY	1-LANE	9:00 P.M.	то	5:00 A.M.
FRIDAY	2-LANE	11:59 P.M. (FRI)	то	6:00 A.M. (SUN)
SATURDAY	1-LANE	11:00 P.M. (SAT)	то	8:00 A.M.(SUN)

ADDISON STREET OVER 1–90/94 AND CTA

MAINTENANCE OF TRAFFIC STAGE GENERAL NOTES

SHEET OF SHEETS STA. TO STA.


F.A.U. SECTION COUNTY TOTAL SHEETS SHEETS NO.

1372 FAU 1372 22 BJ COOK 50 6


CONTRACT NO. 62T41

NOTES

1. TEMPORARY CONCRETE BARRIER SHALL NOT BE ANCHORED WITHIN BRIDGE LIMITS INCLUDING PCC BRIDGE APPROACH

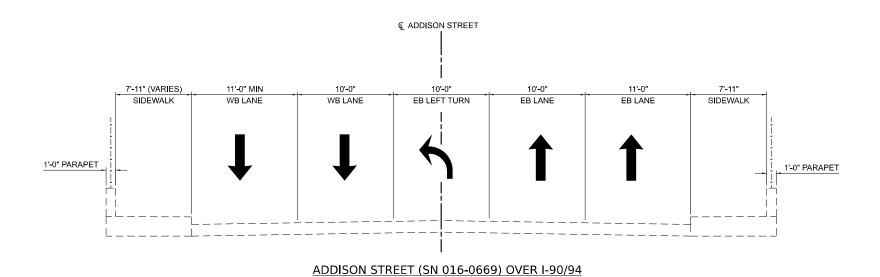

EXISTING TYPICAL SECTION

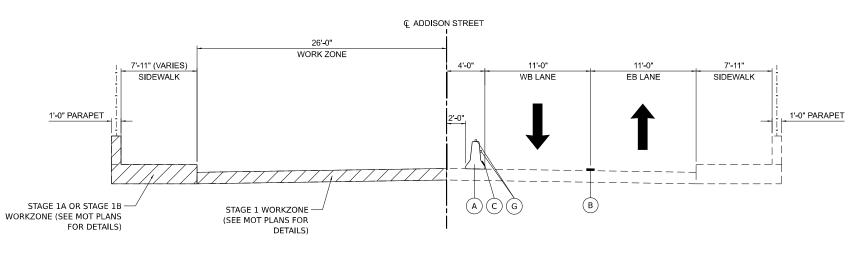

ADDISON STREET (SN 016-0669) OVER I-90/94 STAGE 1 CONSTRUCTION

LEGEND

WORK ZONE

DIRECTION OF TRAVEL

TEMPORARY CONCRETE BARRIER WITH TYPE C REFLECTORS (PER STD. 704001 AND 782006)

TEMPORARY PAVEMENT MARKING - LINE 4" - TYPE IV TAPE (DBL YELLOW @ 8" C-C)

TEMPORARY PAVEMENT MARKING - LINE 6" - PAINT (WHITE) (BOTTOM FLANGE OF CONCRETE BARRIER)

TEMPORARY PAVEMENT MARKING - LINE 4" - TYPE IV TAPE

(SKIP DASH WHITE @ 18' SKIP - 6' DASH) TEMPORARY PAVEMENT MARKING - LINE 4" - TYPE IV TAPE (YELLOW)

BARRICADE TYPE II OR DRUMS WITH STEADY BURNING

MONO-DIRECTIONAL LIGHT PLACED ON CENTER @50' ON TANGENT, 20' ON TAPERS AND 10' ON RADII

TYPE C BI-DIRECTIONAL CRYSTAL REFLECTORS (PER STANDARDS 704001 AND 792006)

(H)TEMPORARY PAVEMENT MARKING - LINE 6" - TYPE IV TAPE (WHITE)

Peralte-
Clark

USER NAME = MET	DESIGNED	-	APG	REVISED -
	DRAWN	-	APG	REVISED -
PLOT SCALE = 10.000 / in.	CHECKED	-	ASO	REVISED -
PLOT DATE = 10/11/2024	DATE	-	06/21/2024	REVISED -


STATE OF ILLINOIS **DEPARTMENT OF TRANSPORTATION**

	ADDISON	I STREET	OVER I-	-90⁄94 AND	CTA	
MAINTENA	ANCE OF	TRAFFIC	TYPICAL	SECTIONS	(ADDISON	ST.)
SCALE: N.T.S.	SHEET	OF	SHEETS	STA.	TO STA.	


A.U. TE	SECTION		COUNTY	TOTAL SHEETS	SHEET NO.		
372	FAU 1372 22 B	J	соок	50	7		
			CONTRACT	NO. 62	T41		
	HI MOSE SED AID PROJECT						

NOTES

1. TEMPORARY CONCRETE BARRIER SHALL NOT BE ANCHORED WITHIN BRIDGE LIMITS INCLUDING PCC BRIDGE APPROACH

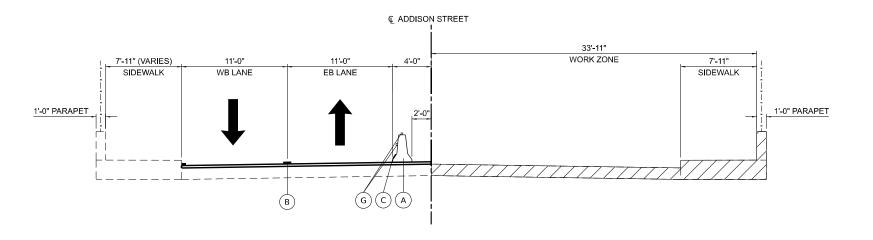

ADDISON STREET (SN 016-0669) OVER I-90/94 **STAGE 2 CONSTRUCTION**

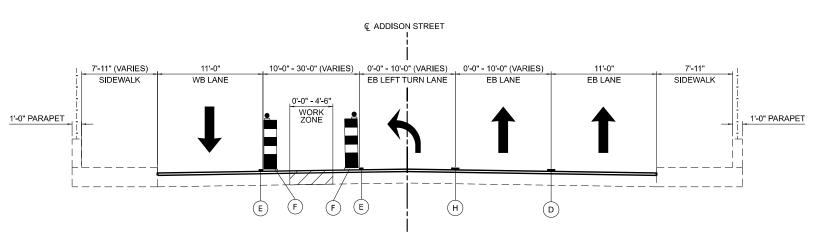

ADDISON STREET (SN 016-0669) OVER I-90/94 **STAGE 3 CONSTRUCTION**

LEGEND

WORK ZONE

DIRECTION OF TRAVEL

TEMPORARY CONCRETE BARRIER WITH TYPE C REFLECTORS (PER STD. 704001 AND 782006)

TEMPORARY PAVEMENT MARKING - LINE 4" - TYPE IV TAPE (DBL YELLOW @ 8" C-C)

TEMPORARY PAVEMENT MARKING - LINE 6" - PAINT (WHITE) (BOTTOM FLANGE OF CONCRETE BARRIER)

TEMPORARY PAVEMENT MARKING - LINE 4" - TYPE IV TAPE (SKIP DASH WHITE @ 18' SKIP - 6' DASH)

TEMPORARY PAVEMENT MARKING - LINE 4" - TYPE IV TAPE (YELLOW)


BARRICADE TYPE II OR DRUMS WITH STEADY BURNING MONO-DIRECTIONAL LIGHT PLACED ON CENTER @50' ON TANGENT, 20' ON TAPERS AND 10' ON RADII


TYPE C BI-DIRECTIONAL CRYSTAL REFLECTORS (PER STANDARDS 704001 AND 792006)


TEMPORARY PAVEMENT MARKING - LINE 6" - TYPE IV TAPE (WHITE)


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	DRAWN	-	APG	REVISED -
PLOT SCALE = 10.000 / in.	CHECKED	-	ASO	REVISED -
PLOT DATE = 10/11/2024	DATE	-	06/21/2024	REVISED -

F.A.U. RTE	SECTION	COUNTY	TOTAL SHEETS	SHEET NO.		
1372	FAU 1372 22 BJ	СООК	50 8			
		CONTRACT	NO. 62	T41		
	ILLINOIS FED. A	ID PROJECT				

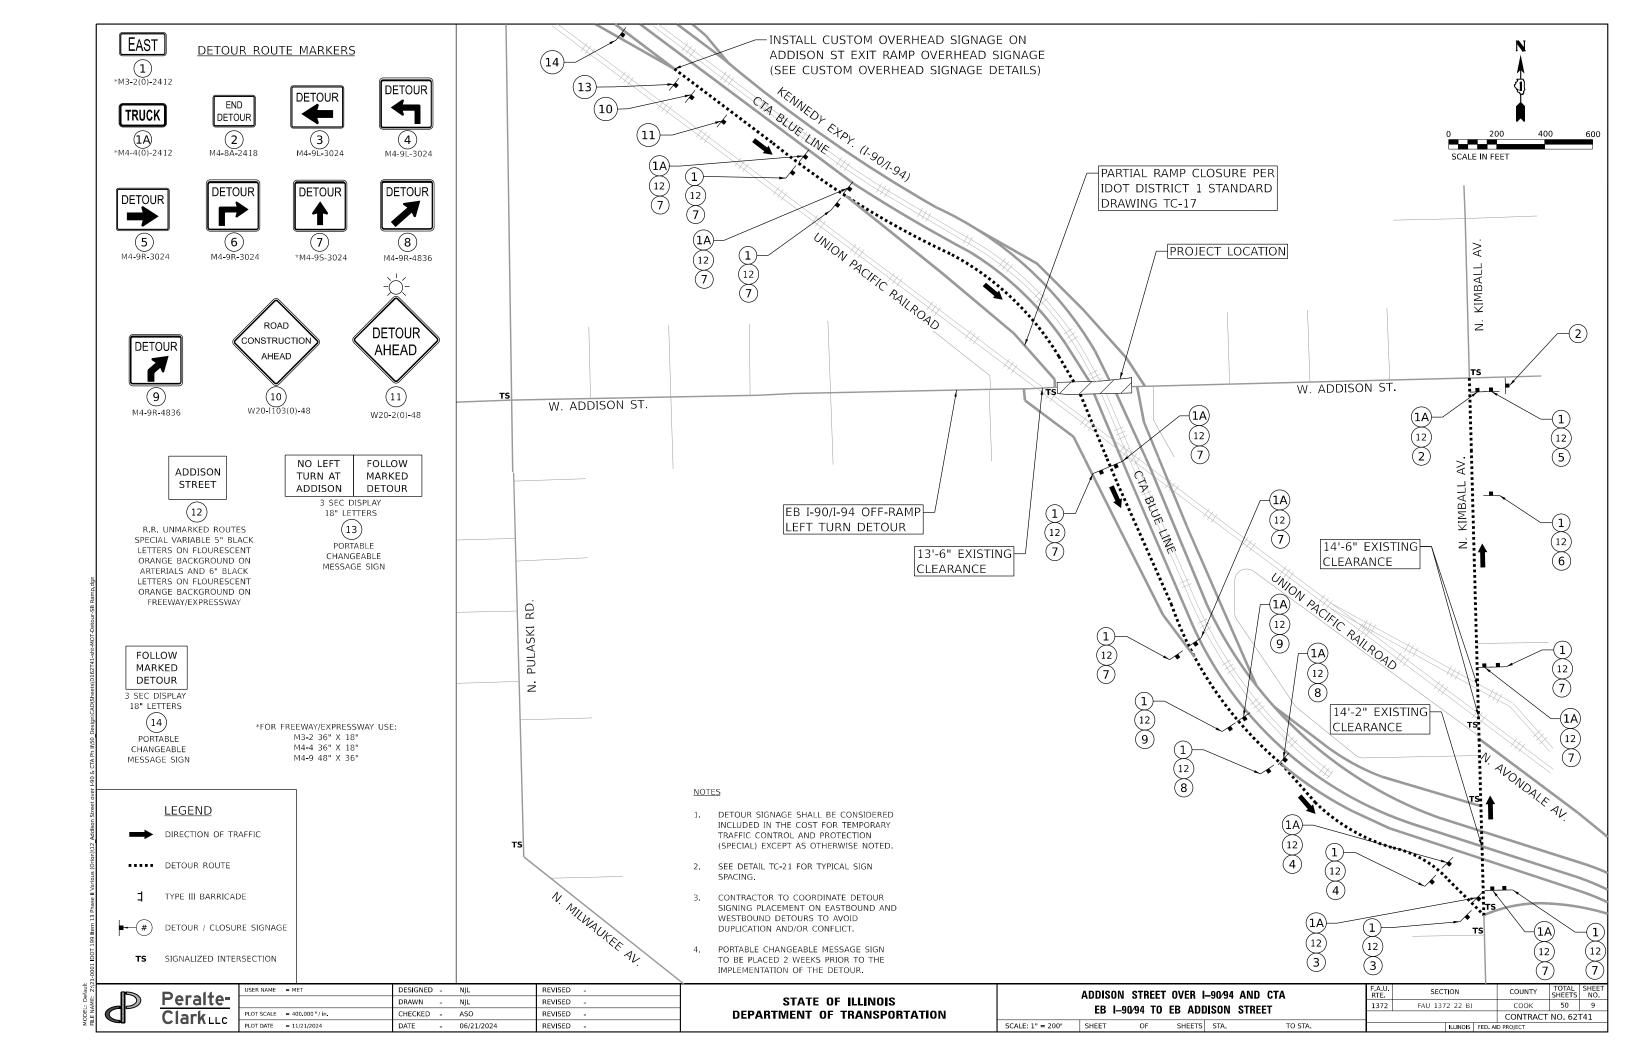

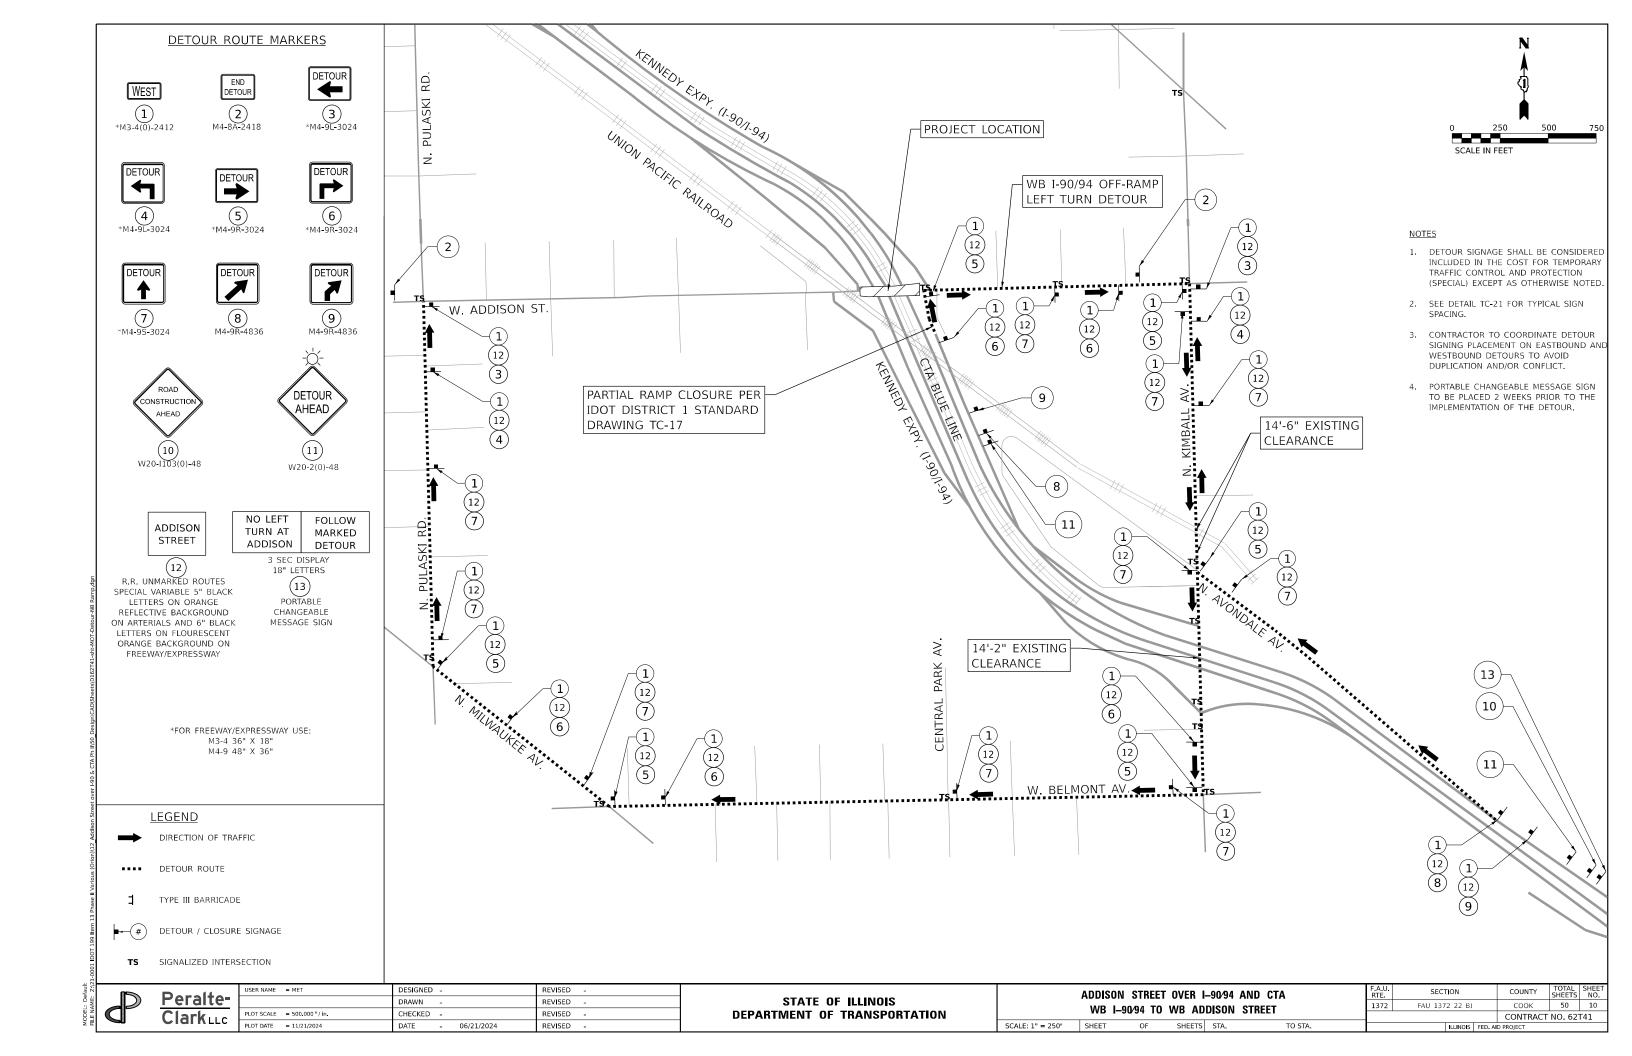


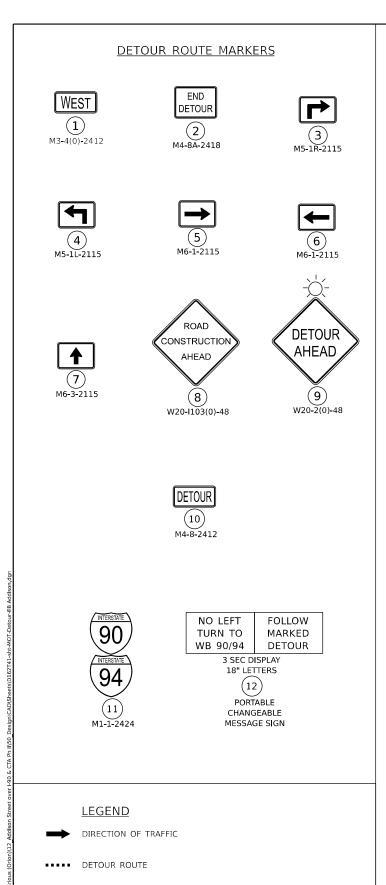


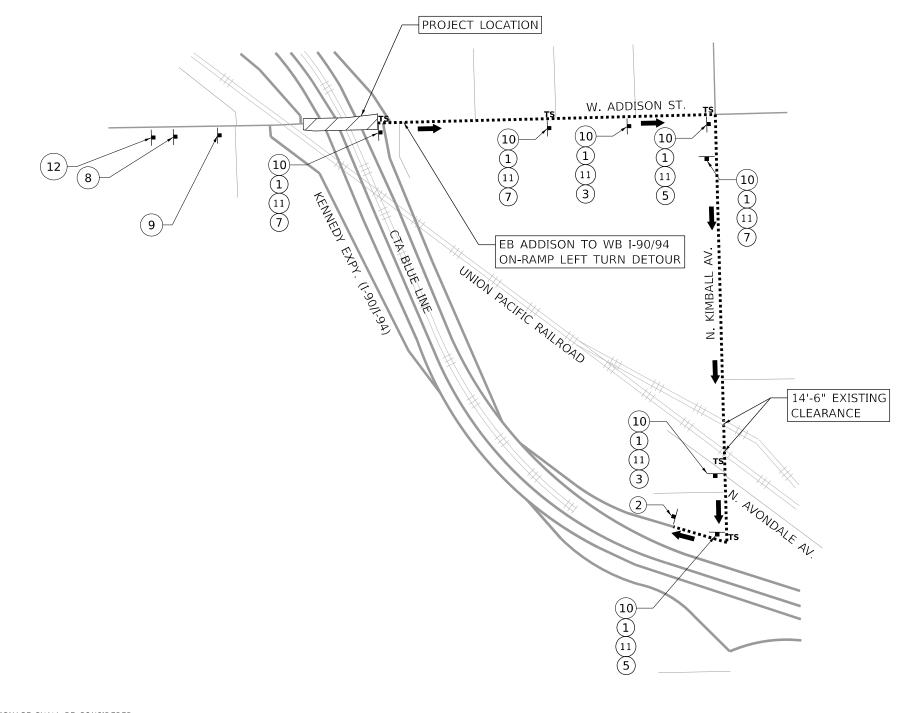

<u>NOTES</u>

- DETOUR SIGNAGE SHALL BE CONSIDERED INCLUDED IN THE COST FOR TEMPORARY TRAFFIC CONTROL AND PROTECTION (SPECIAL) EXCEPT AS OTHERWISE NOTED.
- 2. SEE DETAIL TC-21 FOR TYPICAL SIGN SPACING.
- CONTRACTOR TO COORDINATE DETOUR SIGNING PLACEMENT ON EASTBOUND AND WESTBOUND DETOURS TO AVOID DUPLICATION AND/OR CONFLICT.
- PORTABLE CHANGEABLE MESSAGE SIGN TO BE PLACED 2 WEEKS PRIOR TO THE IMPLEMENTATION OF THE DETOUR.

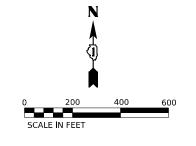

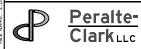

TYPE III BARRICADE


DETOUR / CLOSURE SIGNAGE


SIGNALIZED INTERSECTION


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	DRAWN	-	NJL	REVISED	-
PLOT SCALE = 400.000 / in.	CHECKED	-	ASO	REVISED	-
PLOT DATE = 11/21/2024	DATE	-	06/21/2024	REVISED	-


STATE OF ILLINOIS	
DEPARTMENT OF TRANSPORTATION	N

	ADDISON	STRFF	T OVER I	-90/94	AND CTA		F.A.U. RTE	SEC	TION		COUNTY	TOTAL	SHEET NO.
			STREET T				1372	FAU 137	'2 22 BJ		соок	50	11
	LD AL	D 0014	OTTILLE I	• •••	1 30 31						CONTRAC	T NO. 62	T41
SCALE: 1" = 200'	SHEET	OF	SHEETS	STA.	-	TO STA.			ILLINOIS	FED. AI	D PROJECT		

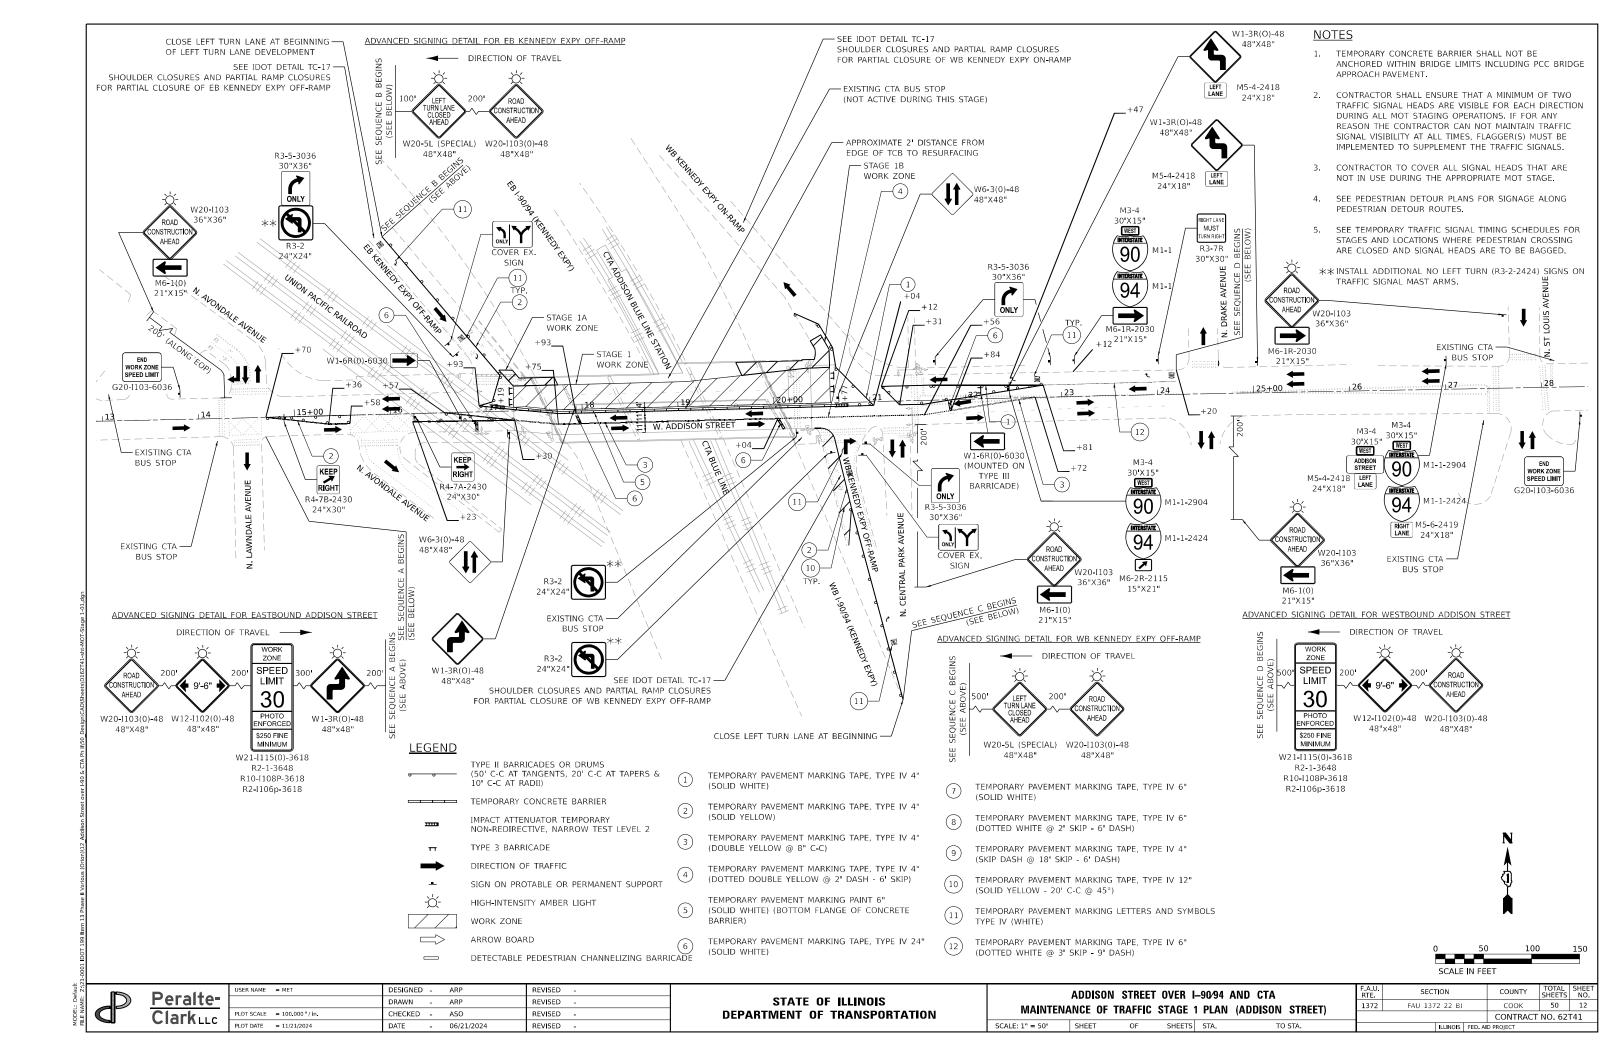

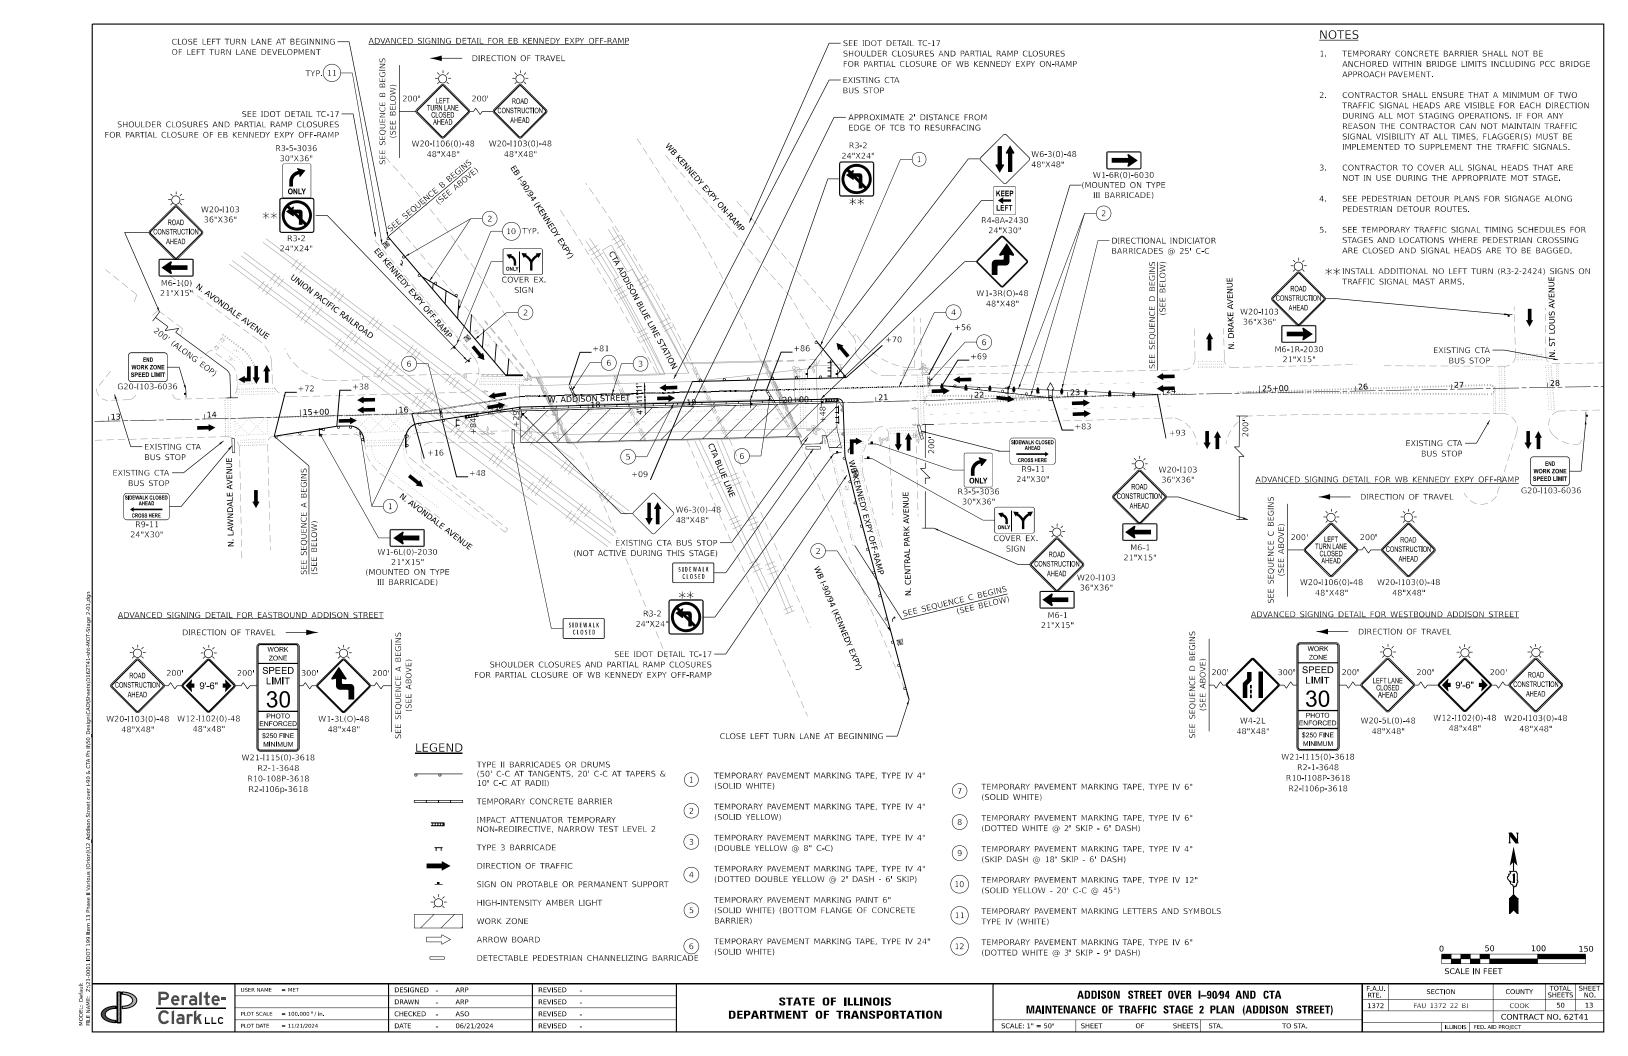

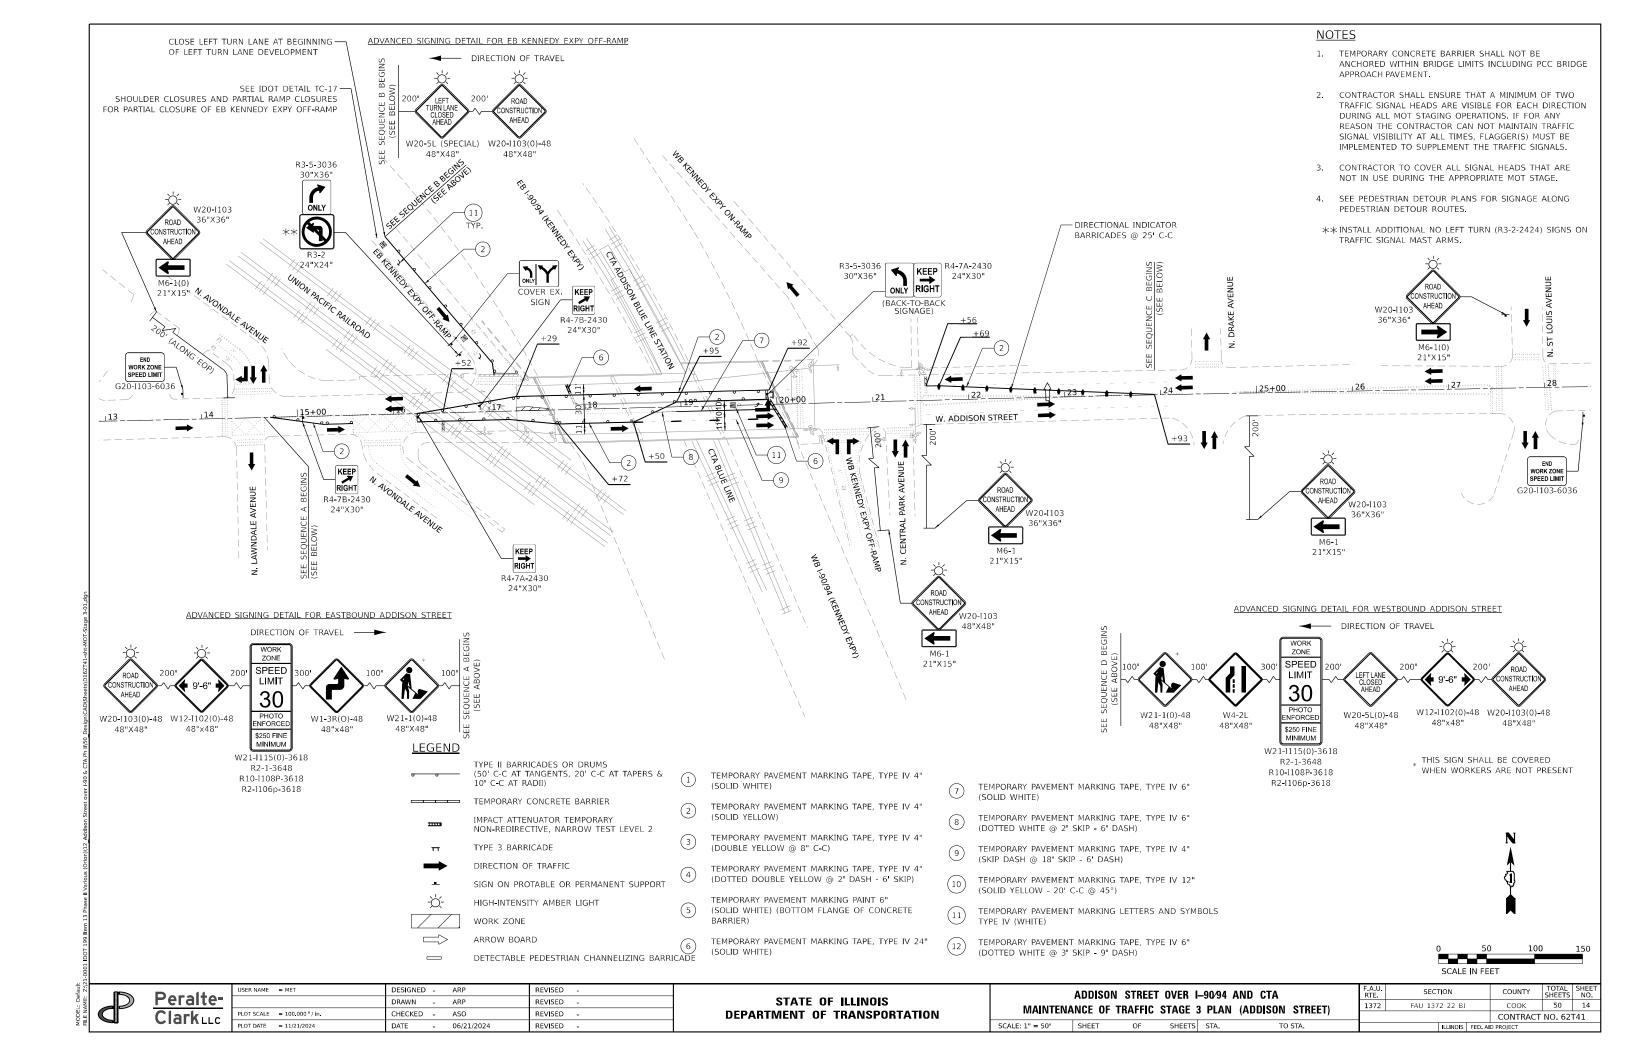

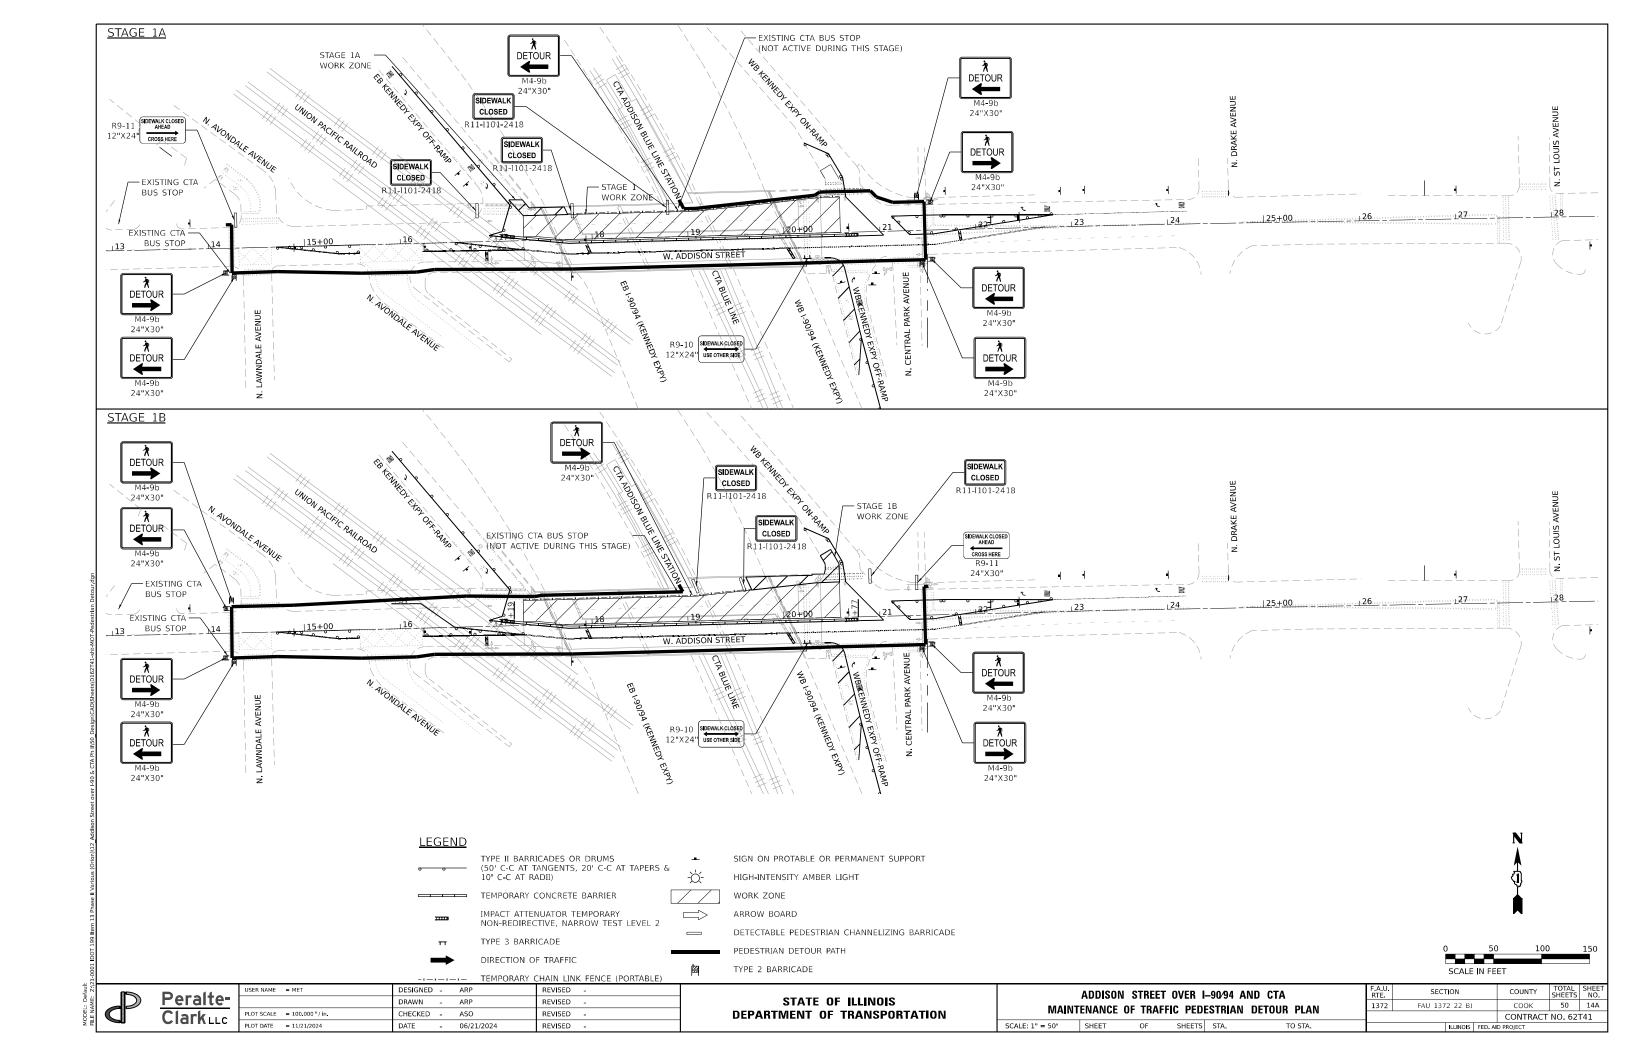



3.0" Radius, 1.0" Border, White on White; "NO TRUCKS" Black, E Mod 2K;

Table of widths and spaces

Table of Wadis and Spaces																
	N		0		Т		R		U		С		K		S	
13.7	8.1	2.4	8.4	10.0	7.4	1.8	8.1	2.1	8.1	2.4	8.1	2.2	8.2	1.3	8.1	13.6

EASTBOUND I-90/94 (KENNEDY EXPY)

ADDISON STREET EXIT RAMP OVERHEAD SIGNAGE APPROX. 6020' FROM ADDISON ST © (~M.P. 44.05)

NO TRUCKS

NO TRUCKS

EXIT 45A

Addison St

1/2 MILE

3.0" Radius, 1.0" Border, White on White; "NO TRUCKS" Black, E Mod 2K;

Table	of	widtl	ns a	nd sp	aces	5										
	N		0		Т		R		U		С		K		S	
13.7	8.1	2.4	8.4	10.0	7.4	1.8	8.1	2.1	8.1	2.4	8.1	2.2	8.2	1.3	8.1	13.6

EASTBOUND I-90/94 (KENNEDY EXPY)

ADDISON STREET EXIT RAMP OVERHEAD SIGNAGE APPROX. 3450' FROM ADDISON ST \mathbb{Q} (~M.P. 44.49)



3.0" Radius, 1.0" Border, White on White; "NO TRUCKS" Black, E Mod 2K;

Table of widths and spaces

	N		0		Т		R		U		С		K		S	
13.7	8.1	2.4	8.4	10.0	7.4	1.8	8.1	2.1	8.1	2.4	8.1	2.2	8.2	1.3	8.1	13

EASTBOUND I-90/94 (KENNEDY EXPY)


ADDISON STREET EXIT RAMP OVERHEAD SIGNAGE APPROX. 1550' FROM ADDISON ST ((~M.P. 44.92)


Peralte-Clark LLC


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	DRAWN -	-	ARP	REVISED -		
OT SCALE = 100.000 ' / in.	CHECKED -	-	ASO	REVISED -		
OT DATE = 11/21/2024	DATE -	-	<u>06/21/</u> 2024	REVISED -		


STATE OF ILLINOIS
DEPARTMENT OF TRANSPORTATION


ADDISON CUSTOM				 	
SHEET	OF	SHEETS	STA.	TO S	ΓA.

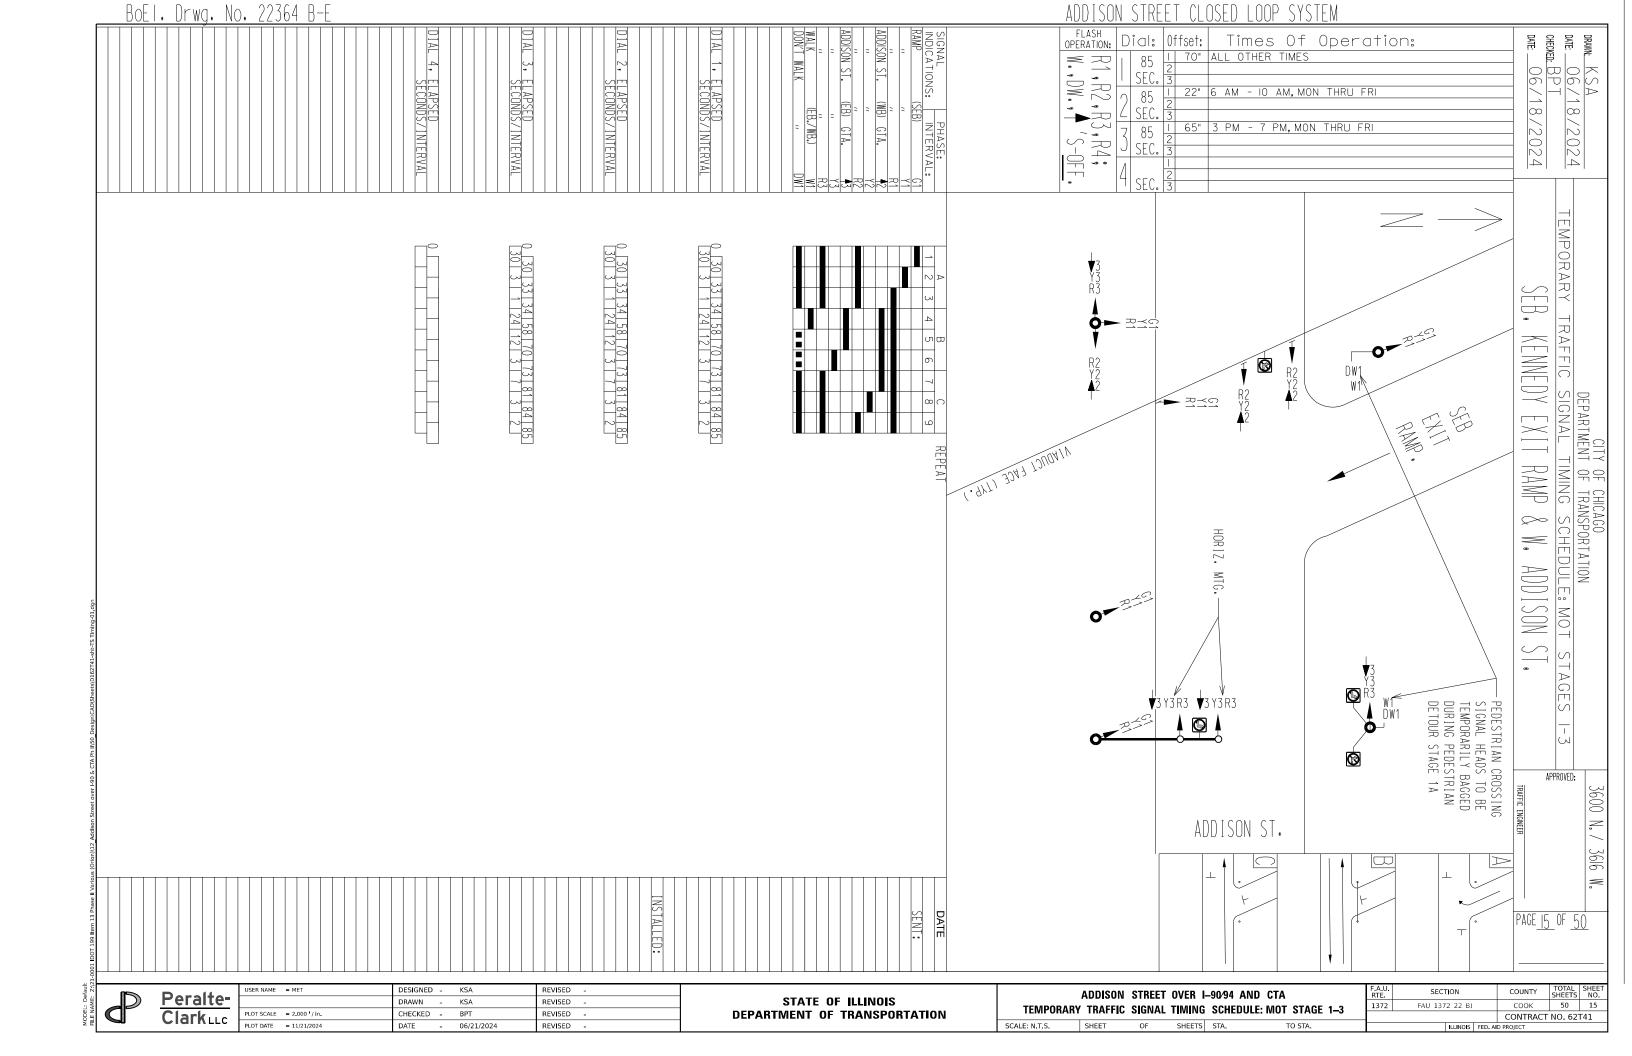


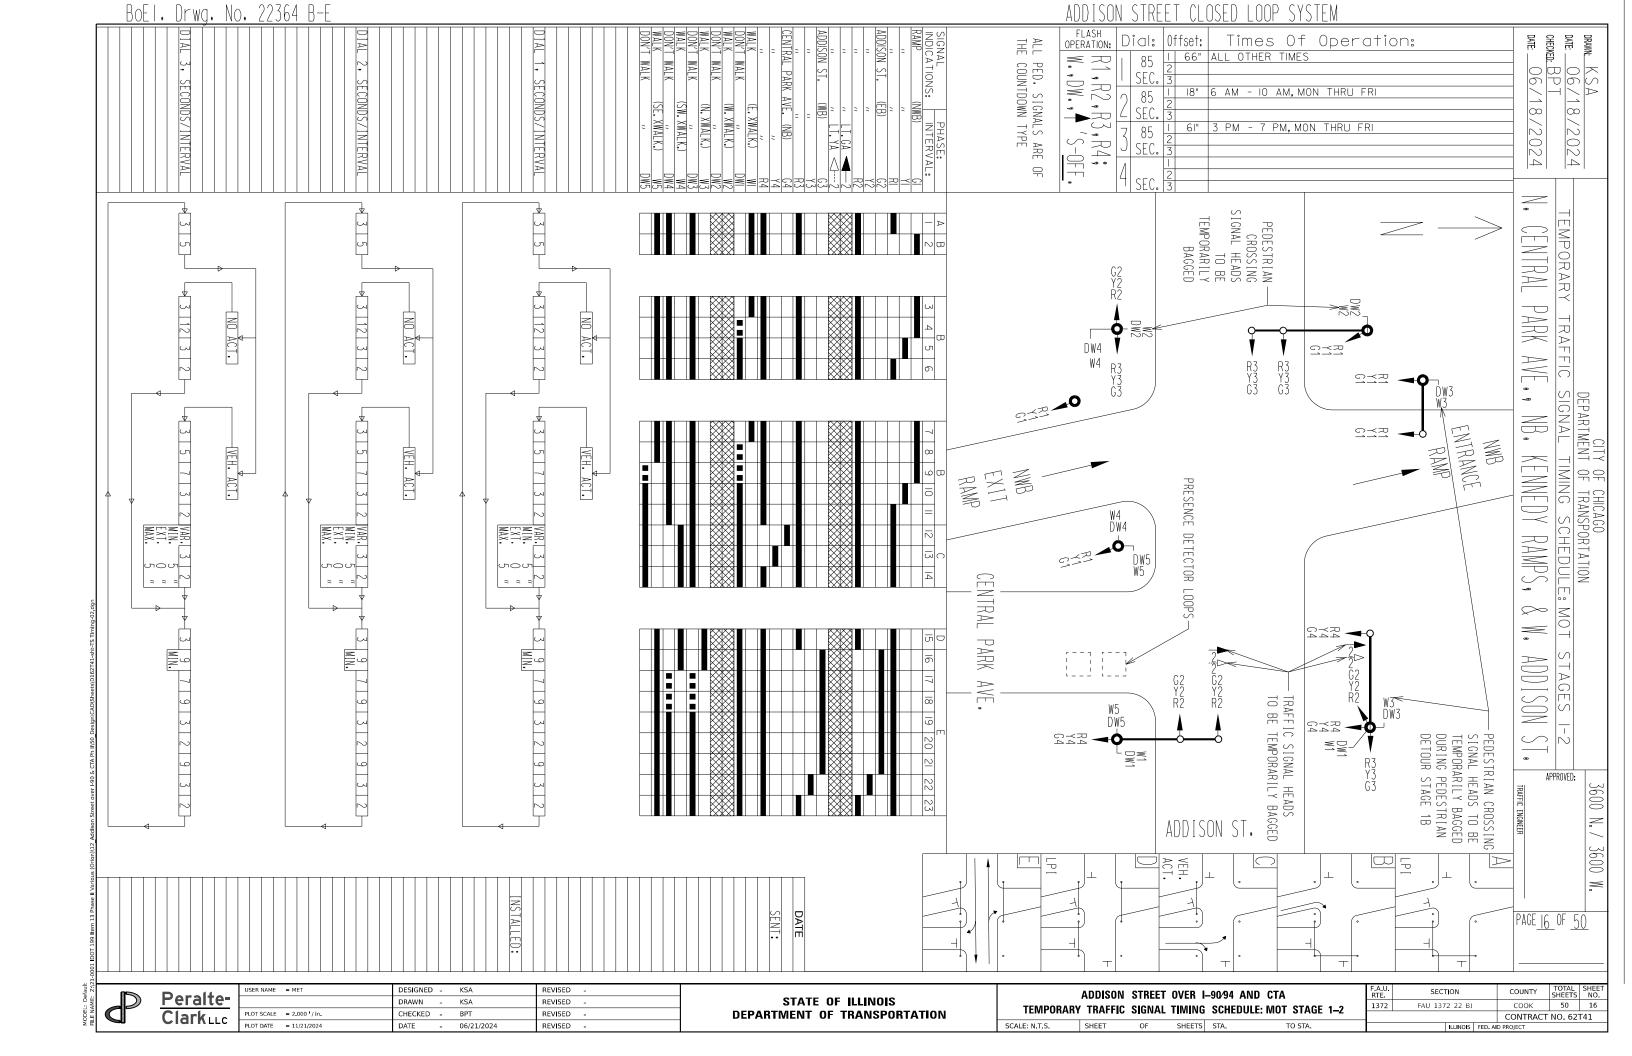


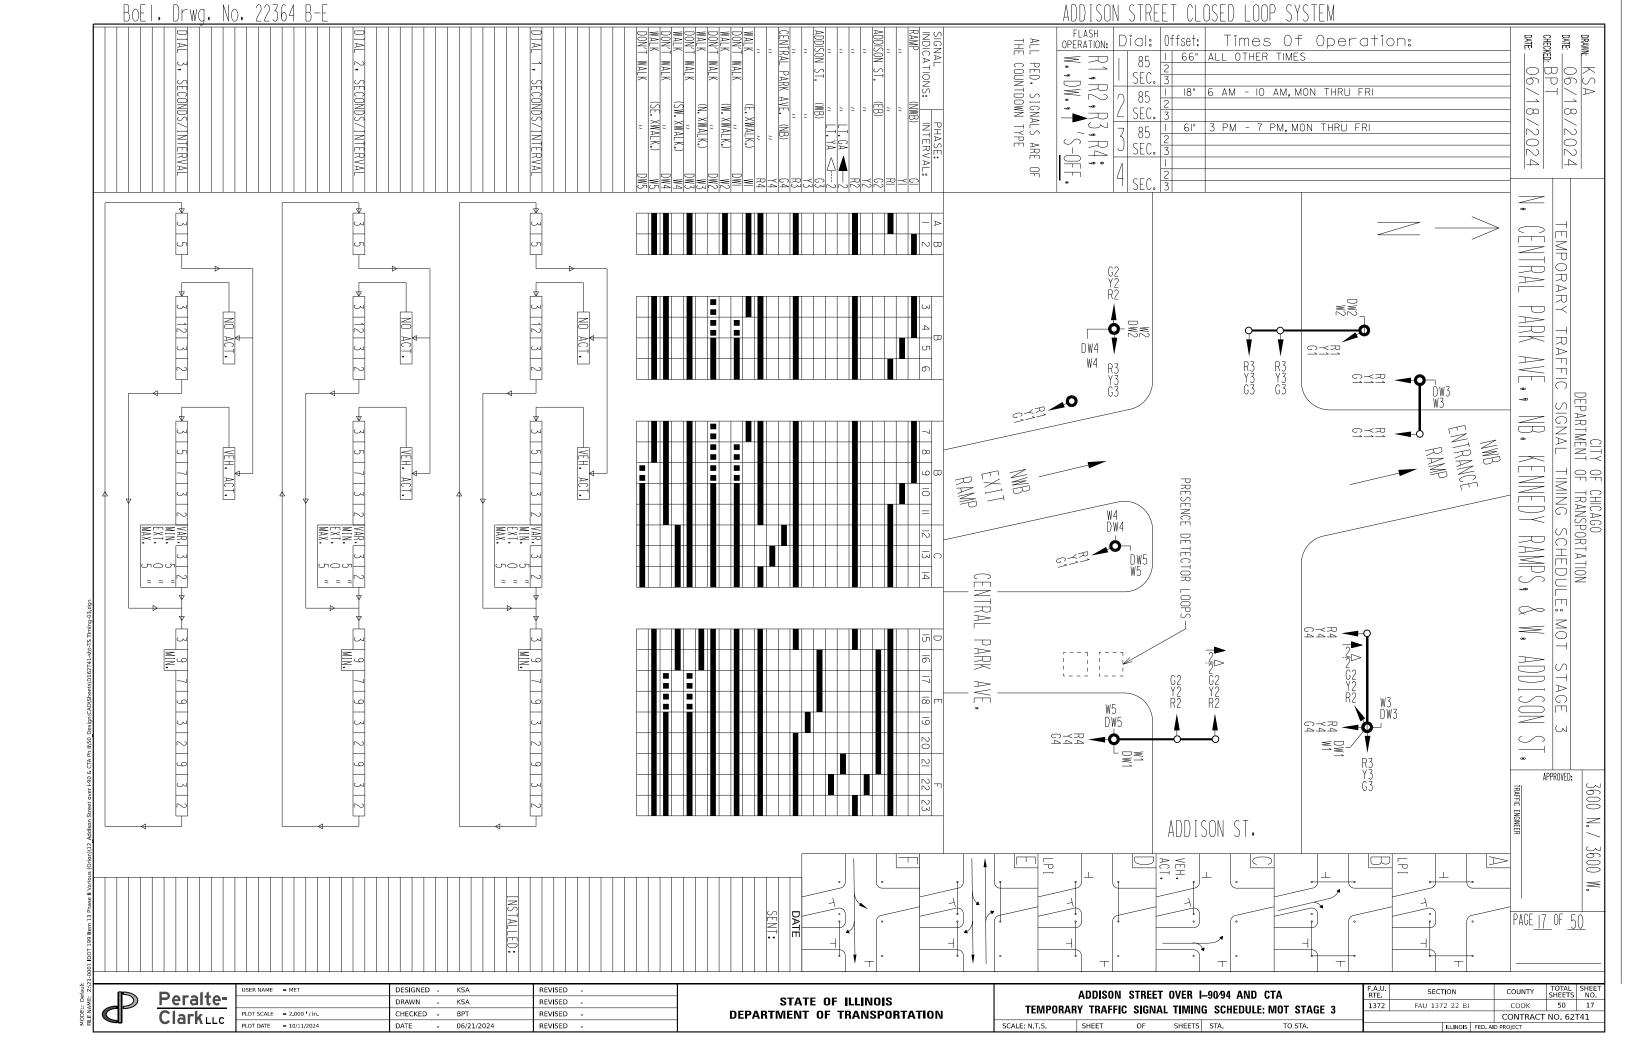


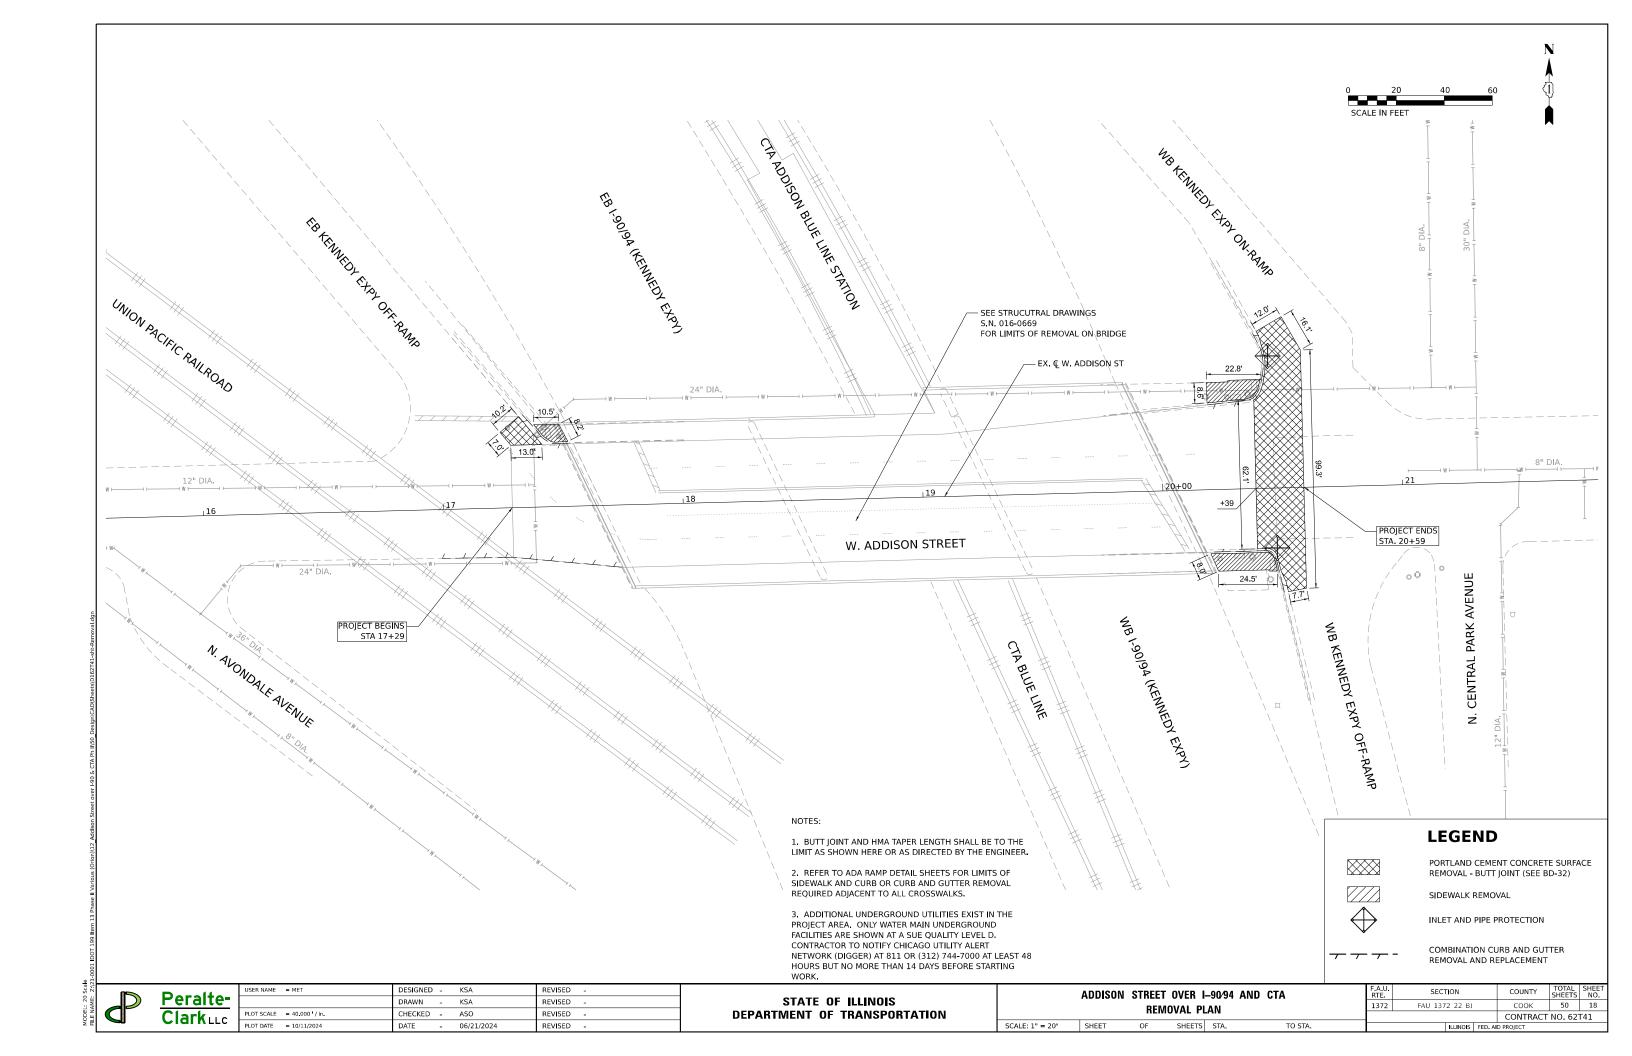

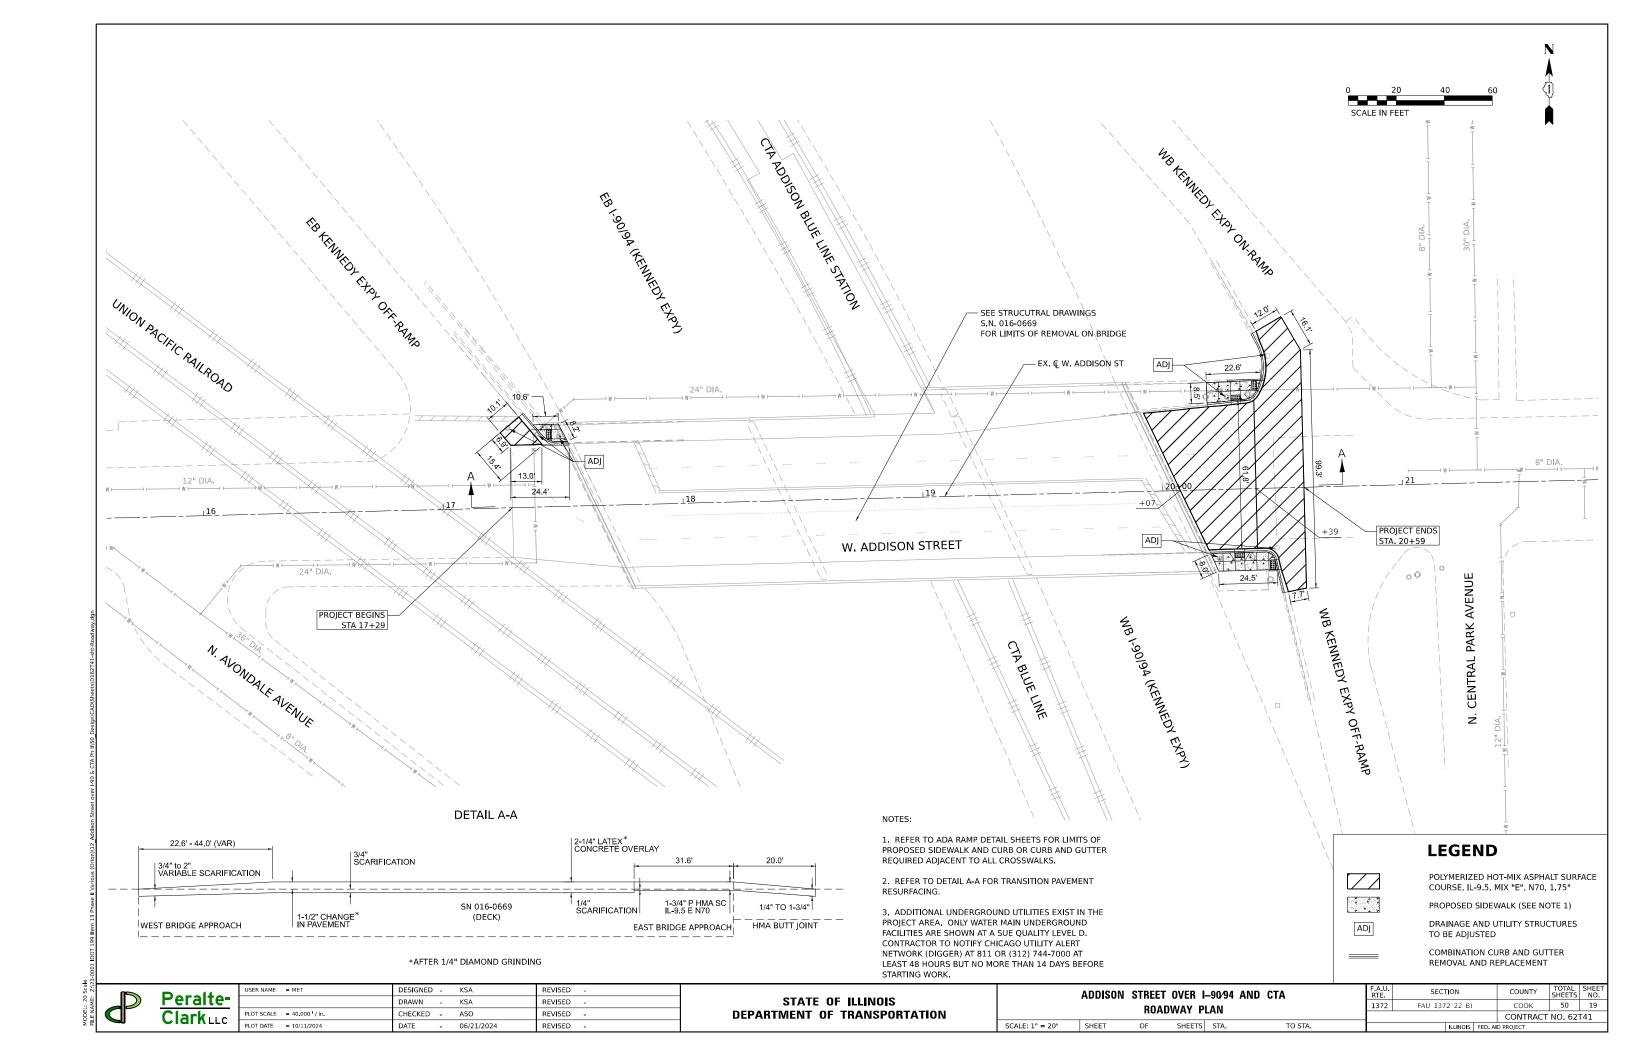

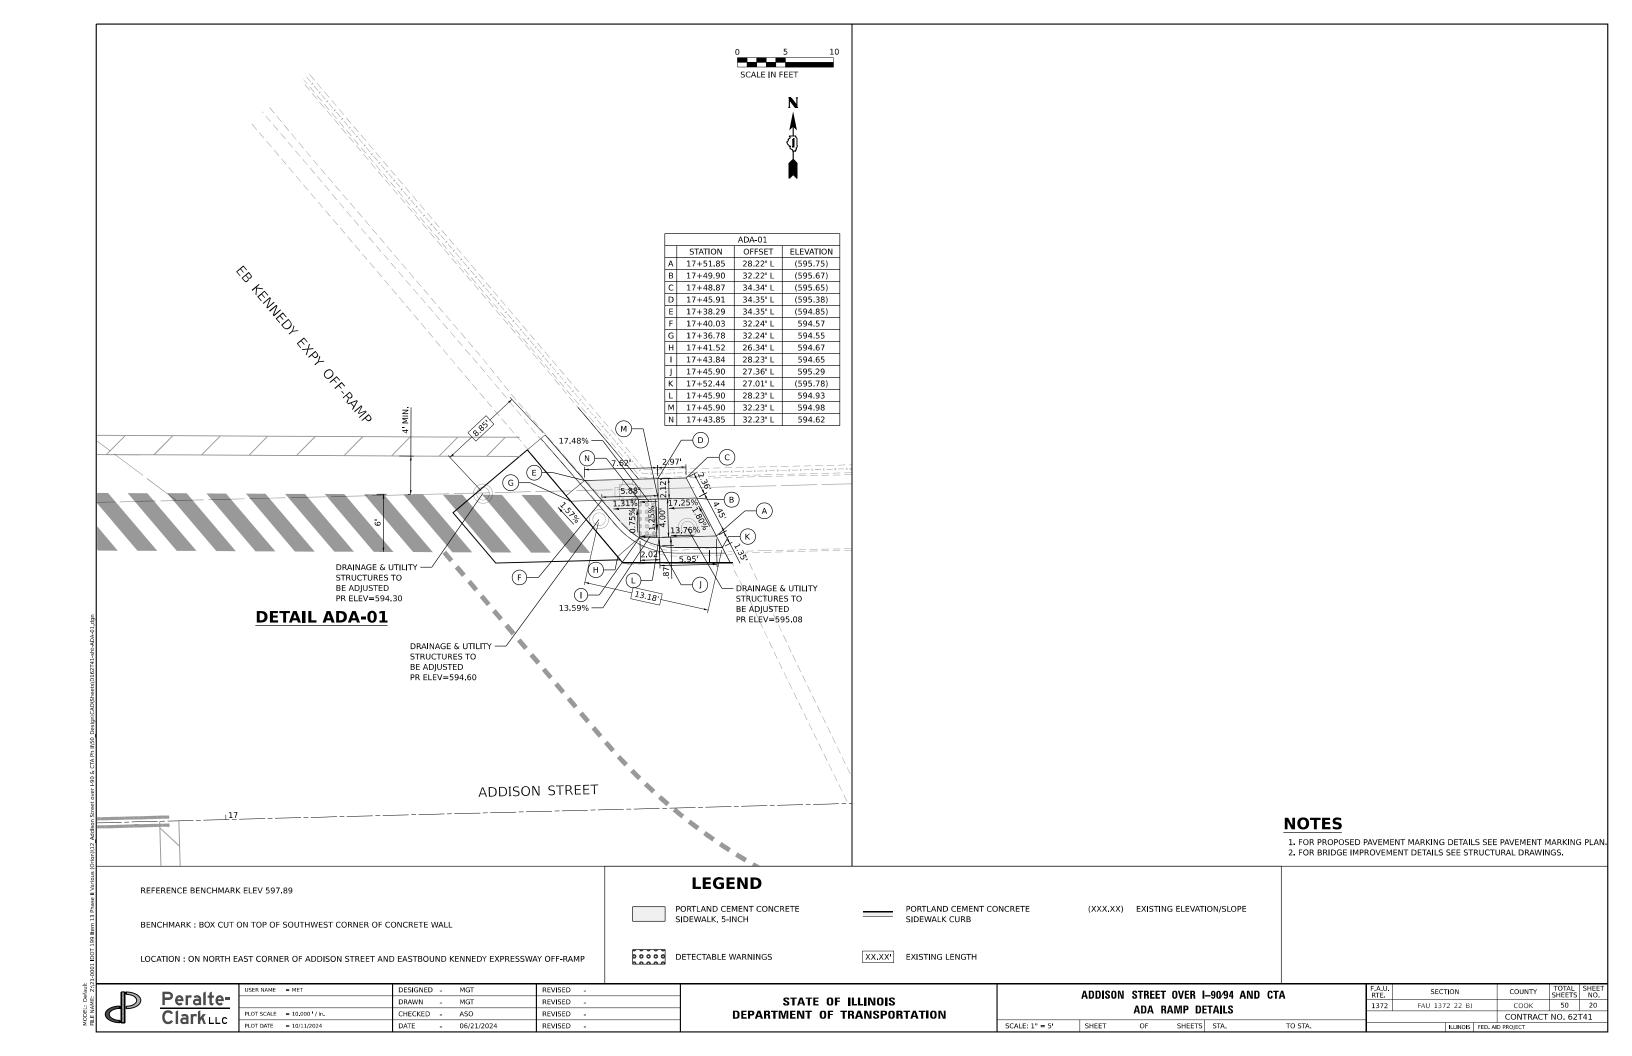

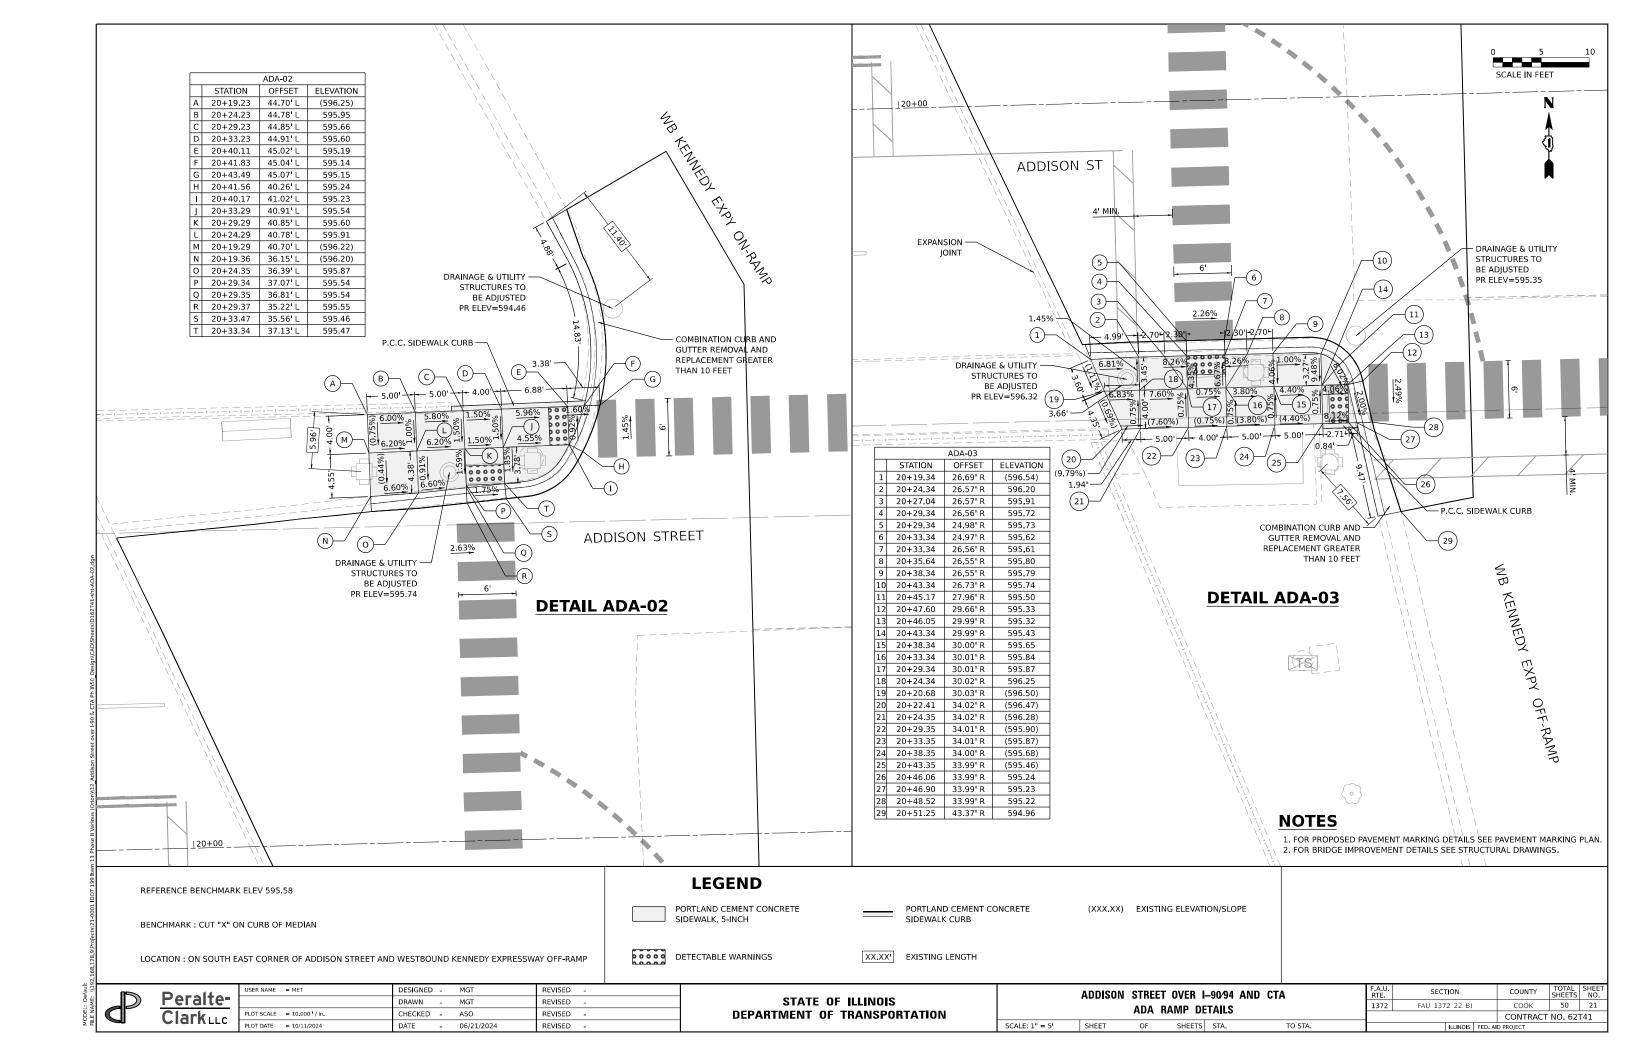


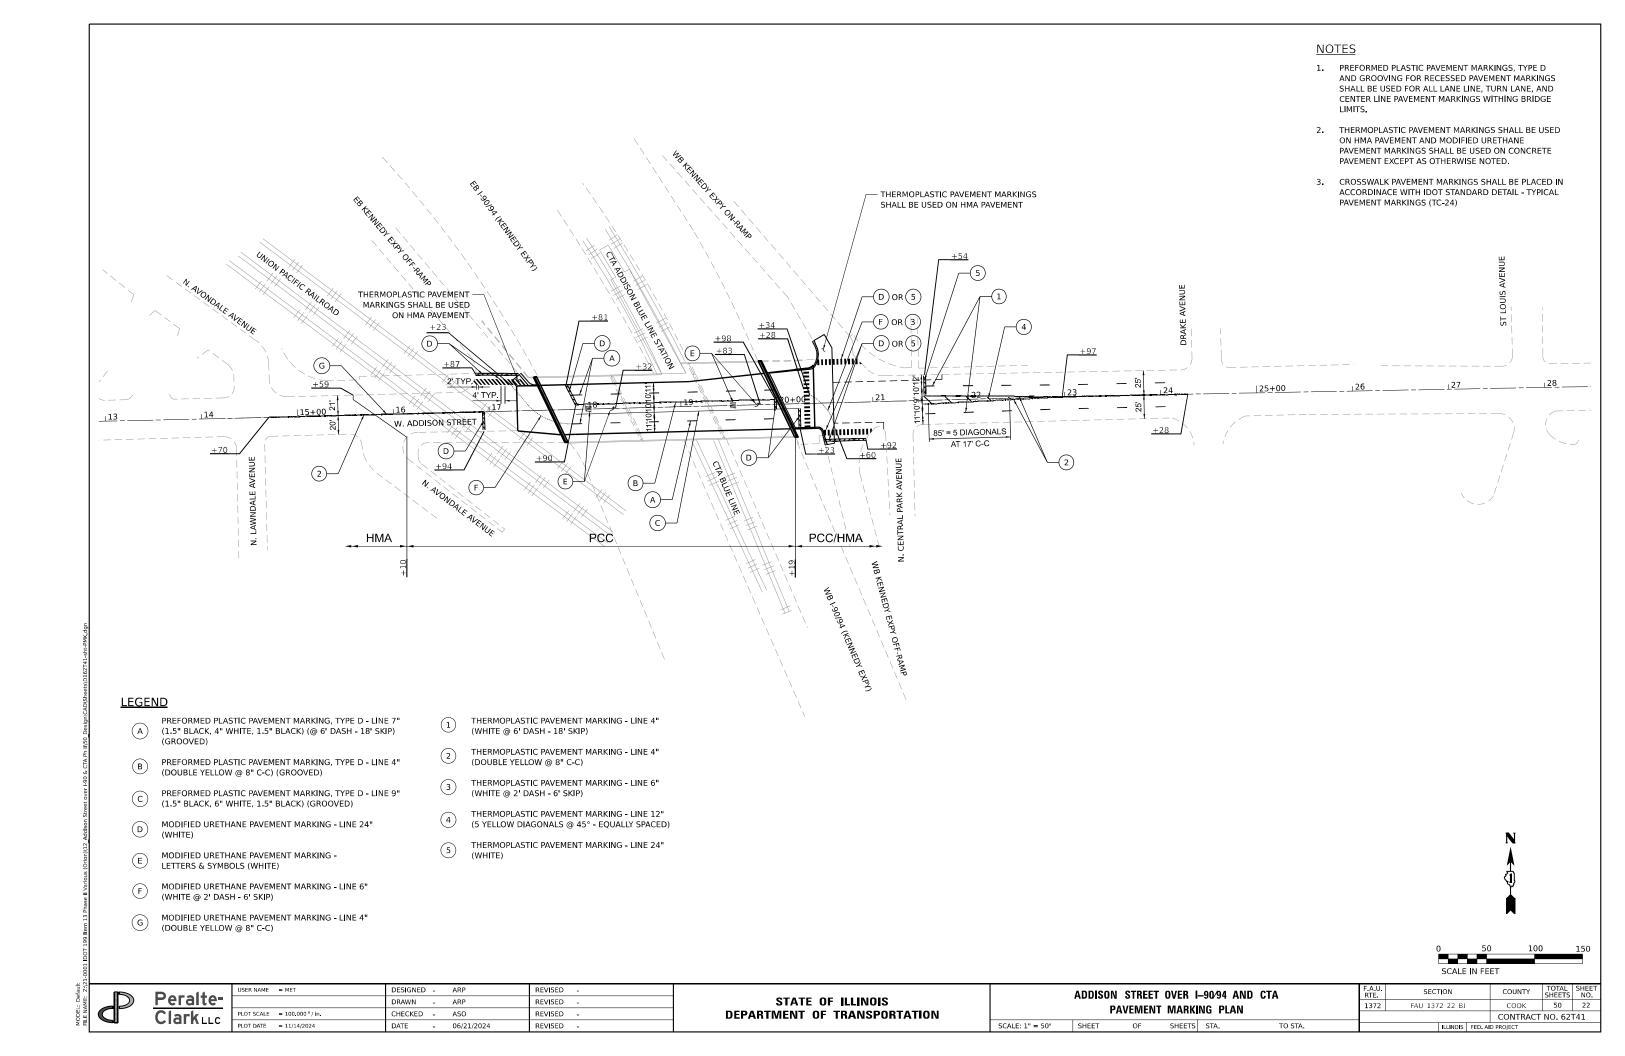

Existing Structure: S.N. 016-0669 was constructed in 1958 and consists of 3-span (78'-6", 85'-8½", 73-10½") non-composite wide flange steel beam bridge. In 1994, the deck was replaced and widened to accommodate a larger sidewalk leading to the CTA Blue Line entrance. Pier 2 and the East Abutment were extended and two additional beams were installed on the north side. The substructure consists of concrete closed wall abutments and concrete multi-column piers all on spread footings. The structure is 243'-9½" from back-to-back abutments on a 24°08' right ahead skew and the overall out-to-out width of the bridge is 69'-10" at the west end and 80'-6" at the east end of the bridge.

Traffic Control:

No Salvage

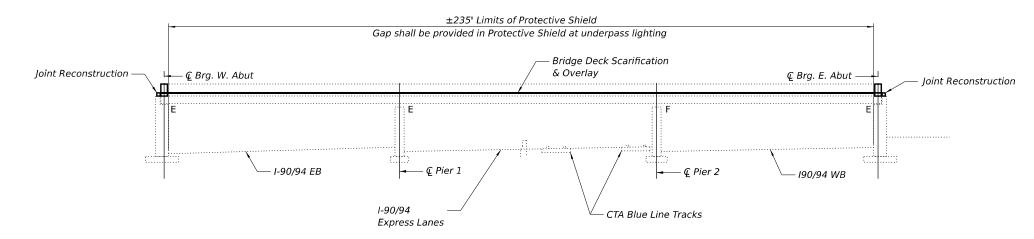

ELEVATION

DESIGN SPECIFICATIONS 2002 AASHTO Standard Specifications for Highway Bridges, 17th Edition

LOADING HS 20-44

No allowance for future wearing surface.

DESIGN STRESSES FIELD UNITS (New Const.)

f'c = 4,000 psi (Supestructure)fy = 60,000 psi (Reinforcement)

FIELD UNITS (1994 Const.)

 $f'c = 3,500 \, psi$

fy = 60,000 psi (Reinforcement) fy = 36,000 psi (M270 Grade 36)

FIELD UNITS (1958 Const.)


fc = 1,400 psi

fs = 20,000 psi (Reinforcement)

fs = 18,000 psi (Structural Steel)

$243'-9\frac{1}{2}$ " Bk. to Bk. Abut. 85'-8¹/₂" 73'-10¹/₂" 78'-6" Span 1 Span 2 Span 3 `\ 24°08'00" € Addison St 119 € Pier 1 € Pier 2 Bk. of West Abut: Sta. 18+43.54 Sta. 19+29.25 - Back of East Abut. Sta. 17+62.19 Sta.20+05.98 Exist. Retaining Wall CTA Blue Line Tracks UPRR Tracks 🗽, PLAN



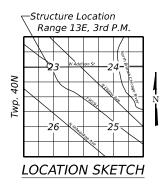

GENERAL PLAN AND ELEVATION ADDISON STREET OVER I-90/94 AND CTA

SEC. F.A.U. 1372 22 BJ **COOK COUNTY** STA. 18+86.39

STRUCTURE NO. 016-0669

,	USER NAME =	DESIGNED -	AB	REVISED -	
		CHECKED -	MVW/AMS	REVISED -	
	PLOT SCALE =	DRAWN -	AB	REVISED -	
	PLOT DATE =	CHECKED -	MVW/AMS	REVISED -	

(Overhead)

STATE OF ILLINOIS **DEPARTMENT OF TRANSPORTATION** **GENERAL PLAN AND ELEVATION** STRUCTURE NO. 016-0669 SHEET S1 OF S12 SHEETS

F.A.U. RTE	SECTION		COUNTY	TOTAL SHEETS	SHEE
1372	FAU 1372 22 BJ		соок	50	23
			CONTRAC	T NO. 6	2T41
	ILLINOIS	FED.	AID PROJECT		

GENERAL DATA

- Plan dimensions and details relative to the existing structure have been taken from existing plans are subject
 to nominal construction variations. The Contactor shall field verify existing dimensions and details affecting
 new construction and make necessary approved adjustments prior to construction or ordering of materials.
 Such variations shall not be cause for additional compensation for a change in scope of the work, however,
 the Contractor will be paid for the quantity actually furnished at the unit price bid for the work.
- 2. Reinforcement bars designated (E) shall be epoxy coated.
- 3. Prior to pouring the new concrete deck, all heavy or loose rust, loose mill scale, and other loose detrimental foreign material shall be removed from the surfaces in contact with concrete (SSPC SP3 standards). Tightly adhered paint may remain unless otherwise noted. Removal shall be accomplished by methods that will not damage the steel and the cost will be paid for according to Article 109.04 of the Standard Specifications.

As directed by the Engineer, existing construction accessories welded to the top flange of beams and girders shall be removed. The weld areas shall be ground flush and inspected for cracks using magnetic particle testing (MT) or dye penetrant testing (PT) by qualified personnel approved by the Engineer. Any cracks that cannot be removed by grinding $\frac{1}{4}$ in. deep shall be identified and reported to the Bureau of Bridges & Structures for further disposition. The cost of removing welded accessories, grinding and inspecting weld areas and grinding cracks will be paid for according to Article 109.04 of the Standard Specifications.

- The removal and reattachment of the existing fence required for repair work (e.g. transverse joint reconstruction, Concrete Superstructure) shall be included in the contract unit price for the work being performed.
- 5. The Contractor shall exercise care during removal of existing joints to ensure that the integrity of the slab, beams, and diaphgrams will not be detrimentally impacted. The Contractor shall repair any damage(s) to the slab, beams, and diaphgrams caused by their operation as directed by the Engineer at no additional cost to the Department. The Contracor shall take all necessary precautions for the for the protection os passing vehicles from falling objects and/or materials until completion of work.
- 6. Existing reinforcement bars extending into the removal area shall be cleaned, straightened, and incorporated into the new construction. Any reinforcement bars that are damaged during concrete removal shall be replaced with an approved bar splicer or anchorage system at the Contractor's expense.
- 7. Joint openings shall be adjusted according to Article 520.04 of the Std. Specs. when the deck is poured at an ambient temperature other than 50° F.

INDEX OF SHEETS

- S1 General Plan And Elevation
- S2 General Data
- S3 Stage Construction Details
- S4 Deck Plan Repairs
- S5 Expansion Joint Reconstruction Plan
- S6 Expansion Joints Details
- S7 Preformed Joint Strip Seal-Sidewalk (1 of 2)
- S8 Preformed Joint Strip Seal-Sidewalk (2 of 2)
- S9 Abutment Repair Details
- S10 Pier 1 Repair Details
- S11 Pier 2 Repair Details
- S12 Bar Splicer Assembly And Mechanical Splicer Details

SCOPE OF WORK

- Install Protective Shield over I-90/94 traffic lanes and Tracks.
- 2. Perform 3/4" Bridge Deck Scarification.
- 3. Perform deck slab and approach repairs as required.
- Perform structural repair of concrete on substructure units.
- Reconstruct bridge deck expansion joints at the West and East Abutments. Install New Preformed Joint Strip Seals
- Apply a 2½" Bridge Deck Latex Concrete Overlay on bridge deck.
- 7. Perform Bridge Deck Grooving and Diamond Grinding.
- Apply Protective Coat to the top and inside faces of parapets, sidewalks, reconstructed transverse expansion joints and surface of the new overlay.


TOTAL BILL OF MATERIAL

ITEM	UNIT	TOTAL
Concrete Removal	Cu Yd	25.9
Concrete Superstructure	Cu Yd	28.8
Protective Coat	Sq Yd	2166
Reinforcement Bars, Epoxy Coated	Pound	3650
Bar Splicers	Each	24
Preformed Joint Strip Seal	Foot	161
Bridge Deck Grooving (Longitudinal)	Sq Yd	1615
Approach Slab Repair (Partial Depth)	Sq Yd	1
Bridge Deck Latex Concrete Overlay, 2 1/2 Inches	Sq Yd	1575
Structural Repair of Concrete		
(Depth Equal to or Less than 5 Inches)	Sq Ft	219
Structural Repair of Concrete		
(Depth Greater than 5 Inches)	Sq Ft	25
Diamond Grinding (Bridge Section)	Sq Yd	1496
Bridge Deck Scarification 3/4"	Sq Yd	1393
Protective Shield	Sq Yd	1910
Portland Cement Concrete Surface Removal 1/4"	Sa Yd	240
Portland Cement Concrete Surface Removal	7	
(Variable Depth)	Sa Yd	183

STAGE I CONSTRUCTION

(Showing Section East of CTA Blue Line Station)

* Prior to 1/4" Diamond Grinding

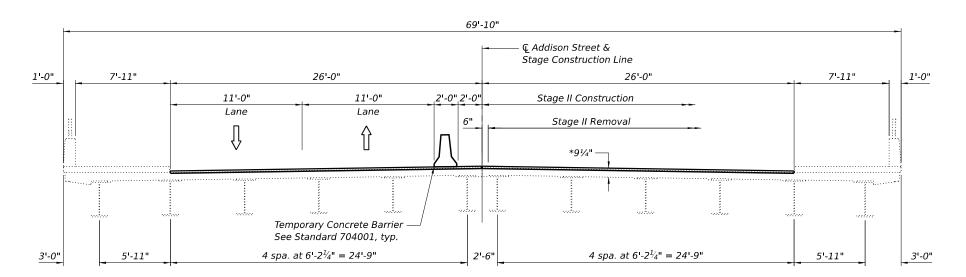

STAGE II CONSTRUCTION

(Showing Section West of CTA Blue Line Station)

Votes.


All Sections looking East.

Access to CTA Addison Blue Line Station to be maintained throughout construction. See Maintenance of Traffic Plans for Stage 1 notes and pedestrian detours.

See Maintenance of Traffic Plans for Stage 3 to construct a portion of the overlay on the West Approach.

ORION ENGINEERS

USER NAME =	DESIGNED -	AB	REVISED	-
	CHECKED -	MVW/AMS	REVISED	-
PLOT SCALE =	DRAWN -	AB	REVISED	-
PLOT DATE =	CHECKED -	MVW/AMS	REVISED	-

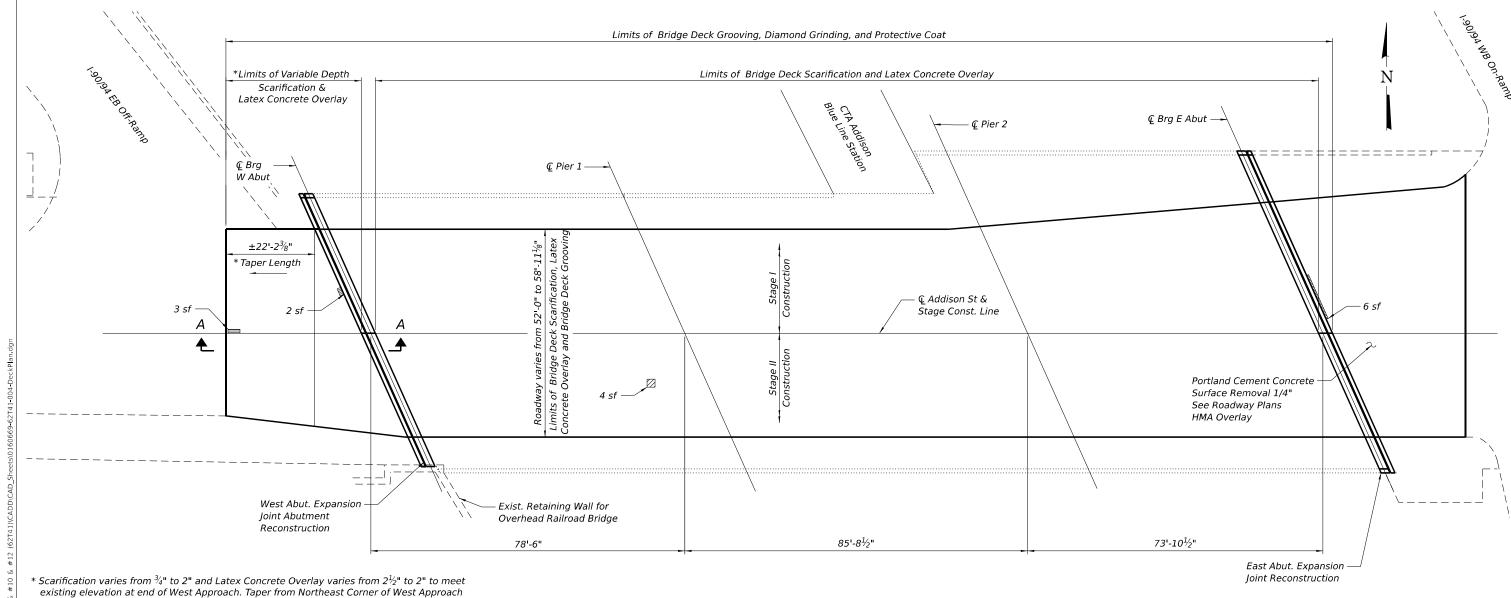

existing elevation at end of West Approach. Taper from Northeast Corner of West Approach at Joint Reconstruction. See Roadway Plans for I-90/94 EB Off Ramp and ADA Ramp Modifications. Per Existing Plans, the Approach Slabs have $3\frac{1}{2}$ " cover to reinforcement. Contractor shall take neccesary precautions to ensure existing reinforcement is not damaged during removal operations. Variable Depth Scarification is paid for as Portland Cement Concrete Surface Removal (Variable Depth).

** See Bridge Deck Latex Concrete Overlay Special Provision

Limits of West Approach Joint Reconstruction Bridge Deck Meet Existing Elev. at End of Approach Top of Exist.

SECTION A-A **LEGEND**

Approach Slab

Approach Slab Repair (Partial)

Approach Slab

Scarification

Deck Slab Repair (Partial)**

DECK PLAN

Notes:

Areas of deck repairs shown are estimated. The Engineer shall show actual locations and size of deck repairs as on As-Built Plans.

For West and East Abutment Expansion Joint removal and reconstruction, see Sheets S5 and S6.

Protective Coat shall be applied to the top surface of the latex overlay and the inside and top faces of the new concrete at the expansion joints.

Diamond Grinding shall be performed for a width that extends to within 2 ft of the curb/sidewalk.

TOTAL BILL OF MATERIAL


	=	
ITEM	UNIT	TOTAL
Protective Coat	Sq. Yd.	2166
Bridge Deck Grooving (Longitudinal)	Sq. Yd.	1615
Approach Slab Repair (Partial)	Sq. Yd.	1
Bridge Deck Latex Concrete Overlay, 2 1/2 Inches	Sq. Yd.	1575
Diamond Grinding	Sq. Yd.	1496
Bridge Deck Scarification, 3/4"	Sq. Yd.	1393
Portland Cement Concrete Surface		
Removal 1/4"	Sq. Yd.	240
Portland Cement Concrete Surface		
Removal (Variable Depth)	Sq. Yd.	183





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	CHECKED -	MVW/AMS	REVISED	-
PLOT SCALE =	DRAWN -	AB	REVISED	-
PLOT DATE =	CHECKED -	MVW/AMS	REVISED	-

STATE OF ILLINOIS **DEPARTMENT OF TRANSPORTATION**

DECK PLAN REPAIRS	F.A.U. RTE	SECTION		COUNTY	TOTAL SHEETS	SHEET NO.
STRUCTURE NO. 016-0669		FAU 1372 22 BJ		соок	50	26
31KUCTUKE NO. 010-0009				CONTRAC	CT NO. 62	2T41
SHEET SA OF S12 SHEETS		ILLINOIS	LEED	AID DDO IECT		

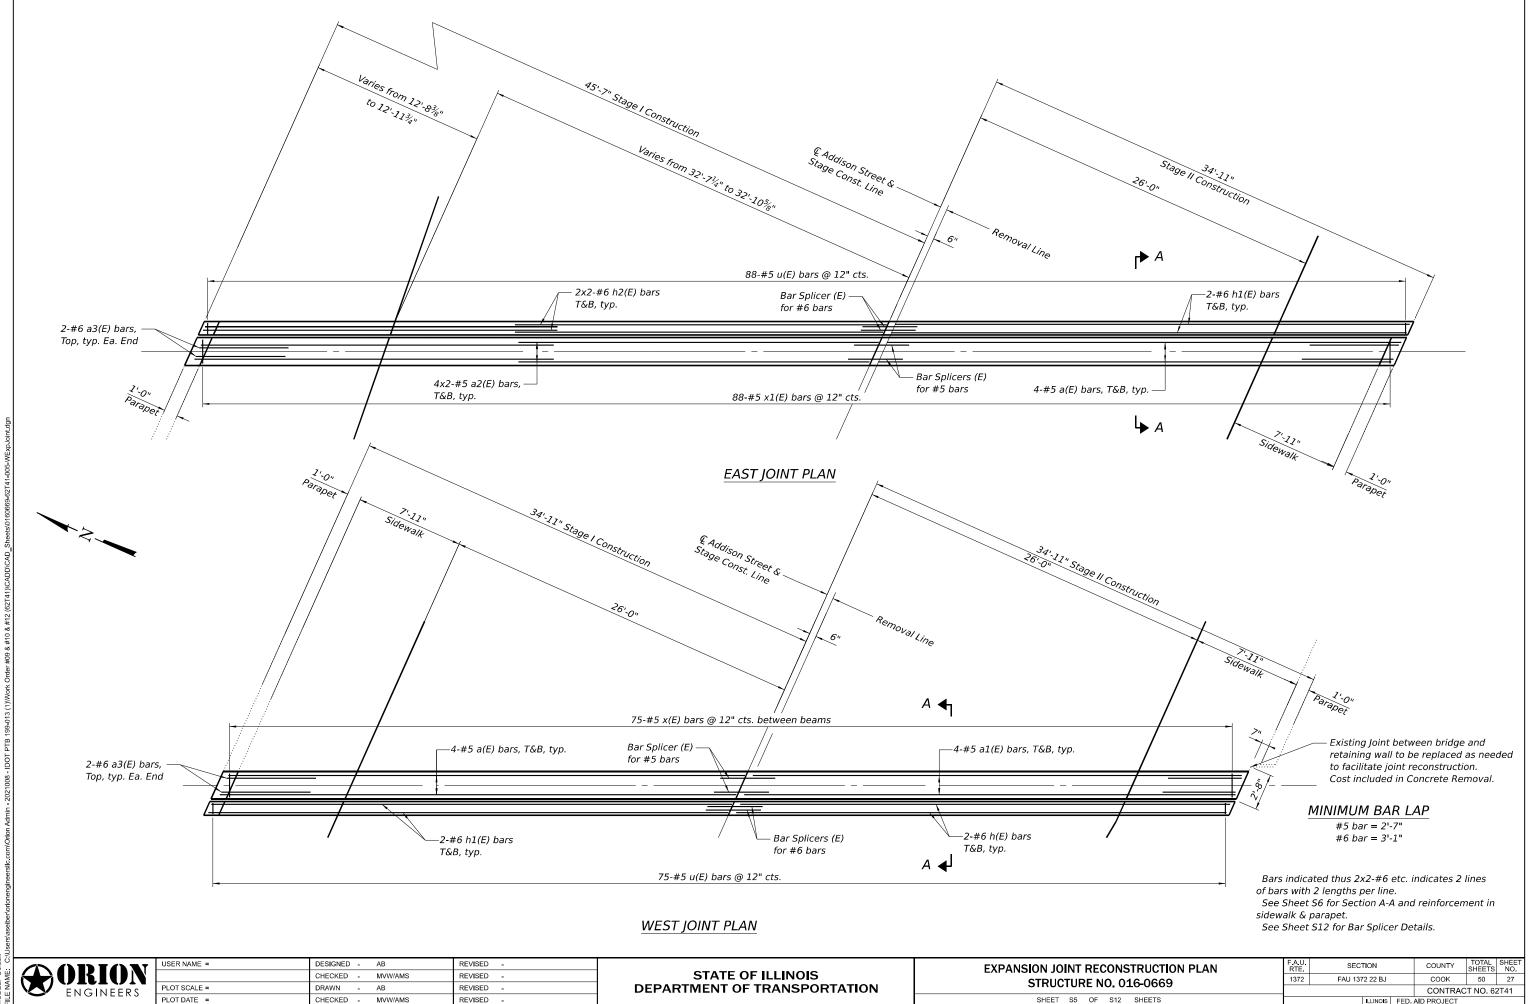

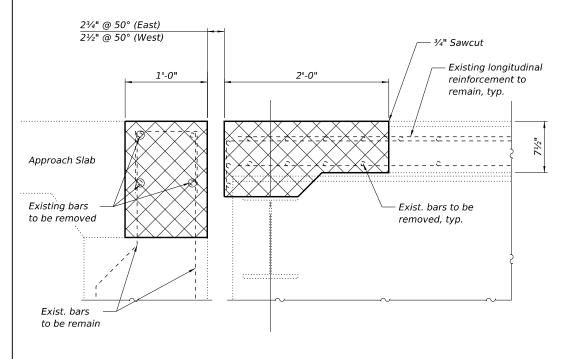

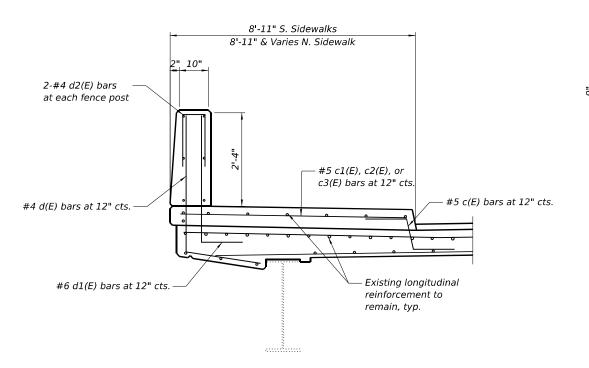

SIDEWALK DETAIL


— 3-#4 d(E) bars

2-#4 d(E) bars -

2-#6 d1(E) bars


2-#5 c1(E) bars (NW & SE) 2-#5 c2(E) bars (NE) 2-#5 c3(E) bars (SW)


BAR d2(E) BAR c(E)

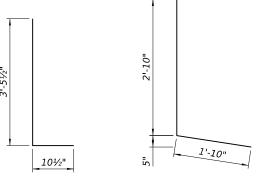

BAR d1(E)

BAR d(E)

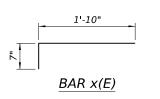


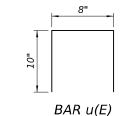

BILL OF MATERIAL

Bar	No.	Size	Length	Shape
a(E)	16	#5	37'-11"	
a1(E)	8	#5	37'-3"	
a2(E)	16	#5	26'-2"	
a3(E)	8	#6	6'-6"	
h(E)	4	#6	37'-3"	
h1(E)	8	#6	37'-11"	
h2(E)	8	#6	26'-5"	
c(E)	20	#5	2'-5"	
c1(E)	10	#5	8'-10"	
c2(E)	5	#5	13'-0"	
c3(E)	5	#5	7'-9"	
d(E)	13	#4	4'-8"	Ĺ
d1(E)	13	#6	4'-4"	_
d2(E)	10	#4	2'-0"	
u (E)	163	#5	2'-4"	
x (E)	163	#5	2'-5"	
Concrete I	Removal		Cu. Yd.	25.9
Concrete S	Superstru	cture	Cu. Yd.	28.8
Reinforcer	nent Bars	i,		
Ероху Соа	ated		Pound	3650

JOINT REMOVAL DETAILS SECTION A-A

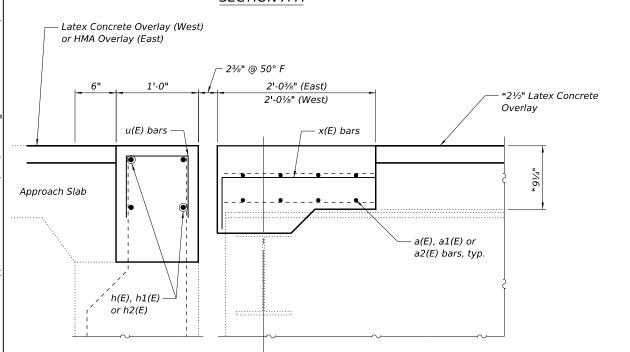

JOINT RECONSTRUCTION DETAILS

SECTION A-A

*Prior to 1/4" Diamond Grinding

NOTES Existing reinforcement shall be cleaned, sti

Existing reinforcement shall be cleaned, straightened and incorporated into the new construction. Cost included with Concrete Removal.

Cost of removal and disposal of existing expansion joint is included in the cost of Concrete Removal.

For details of expansion joint, see Sheet S7 & S8.

3-#5 c1(E) bars (NW & SE) 3-#5 c2(E) bars (NE) 3-#5 c3(E) bars (SW) 2-#5 c(E) bars 3-#5 c(E) bars


SIDEWALK PLAN

(Sidewalk at Northwest Joint Shown, Others Similar, Unless Noted Otherwise. Omit d(E) and d1(E) bars where Parapet is not present.)


- 3-#6 d1(E) bars

ORION

USER NAME =	DESIGNED	-	AB	REVISED	-
	CHECKED	-	MVW/AMS	REVISED	-
PLOT SCALE =	DRAWN	-	AB	REVISED	-
PLOT DATE =	CHECKED	-	MVW/AMS	REVISED	-

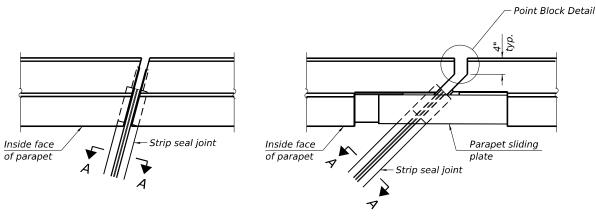


FOR SKEWS > 30° PLAN AT PARAPET

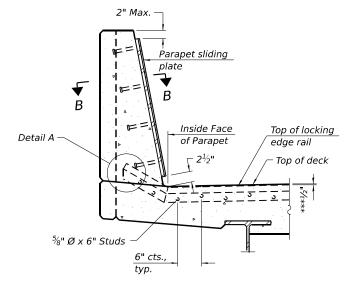


FOR SKEWS ≤ 30°

SECTION AT PARAPET

(Skews > 30° shown. Skews ≤ 30° similar except as shown in plan view.)

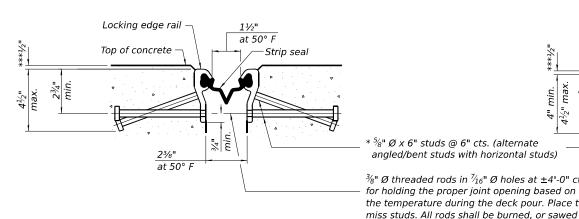

SHOWING ROLLED RAIL JOINT

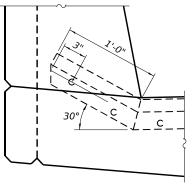

DETAIL A


off flush with the plates after concrete is set.

* Granular or solid flux filled headed studs conforming to Article 1006.32 of the Std. Specs., automatically end welded. ***Prior to 1/4" Diamond Grinding


SECTION A-A

* 3/4" Ø x 6" Studs 1'-0" (8 per side 39" parapet) (10 per side 44" parapet) ្នី ្រី ¾" Embedded plate full depth $\frac{3_{8}"}{\text{full depth}}$ Min. lap <u>6</u>" 1/2" Parapet sliding plate 3/8" Ø Countersunk bolts 1'-0" (10 per side 39" parapet) (12 per side 44" parapet) Direction of traffic

SECTION B-B

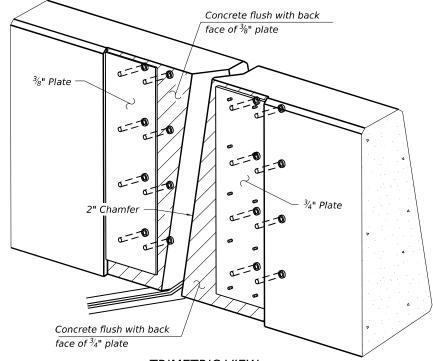

TRIMETRIC VIEW (Showing embedded plates only)

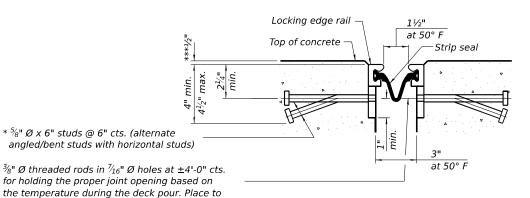

SHOWING WELDED RAIL JOINT

₹₁₆" ROLLED WELDED RAIL (EXTRUDED) RAIL

LOCKING EDGE RAILS

** Back gouge not required if complete joint penetration is verified by mock-up.

Notes:

The strip seal shall be made continuous and shall have a minimum thickness of $\frac{1}{4}$ ". The configuration of the strip seal shall match the configuration of the locking edge rails. Open or "webbed" strip seal gland configurations are not permitted. The gland shall be sized for a maximum rated movement of 4 inches.

The locking edge rails depicted are configured for typical applications and are conceptual only. The actual configuration of the locking edge rails and matching strip seal may vary from manufacturer to manufacturer provided they fit the application and meet the minimum anchorage shown. Flanged edge rails, however, will not be allowed. Locking edge rails may exceed the $4\frac{1}{2}$ " maximum depth provided the anchorage system is revised according to the manufacturer's recommendation.

The manufacturer's recommended installation methods shall be followed.

All steel components shall be galvanized after fabrication according to Article 520.03 of the Standard Specifications.


The Maximum space between locking edge rail segments shall be $\frac{3}{16}$ " and sealed with a suitable sealant; however, any rail joint within 10' measured perpendicular to the face of the curb or parapet shall be welded as shown in the locking edge rail splice detail.

The top surface of sidewalk sliding plates shall have a raised pattern according to ASTM A786.

Cost of parapet sliding plates, sidewalk sliding plates, embedded plates, anchorage studs, and expansion anchors included with Preformed Joint Strip Seal.

39" constant slope barrier shown, 44" constant slope barrier similar as noted.

The concrete opening below the strip seal will vary based on the locking edge rail chosen by the Contractor. Deck and parapet lengths shown elsewhere in the plans are dimensioned to the concrete opening, not the joint opening, and are based on the rolled locking edge rail. If the Contractor elects to use a different locking edge rail, dimensional adjustments may be required. One exception to this would be the strip seal joint at the end of the precast bridge approach slab. For these cases the pavement connector length shall be adjusted, not the length of the bridge approach slab.

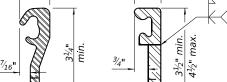

LOCKING EDGE RAIL SPLICE The inside of the locking edge rail

groove shall be free of weld residue. Rolled rail shown, welded rail similar.

flush

BILL OF MATERIAL

Item	Unit	Total
Preformed Joint Strip Seal	Foot	161

EJ-SS-S

ENGINEERS

JSER NAME = DESIGNED - AB REVISED -CHECKED - MVW/AMS REVISED -REVISED PLOT DATE = CHECKED - MVW/AMS REVISED


STATE OF ILLINOIS

(Sheet 1 of 2) PREFORMED JOINT STRIP SEAL - SIDEWALK STRUCTURE NO. 016-0669 SHEET S7 OF S12 SHEETS


F.A.U. RTE	SECTION	COUNTY	TOTAL SHEETS	SHEE NO.
1372	FAU 1372 22 BJ	соок	50	29
		CONTRAC	T NO. 6	2T41
	ILLINOIS EED	AID DPO IECT		


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DEPARTMENT OF TRANSPORTATION

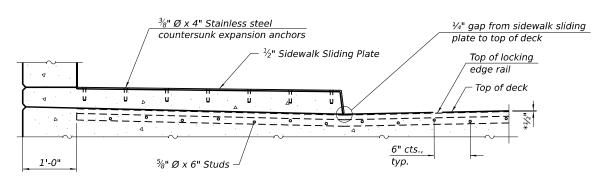


SECTION AT RAISED SIDEWALK




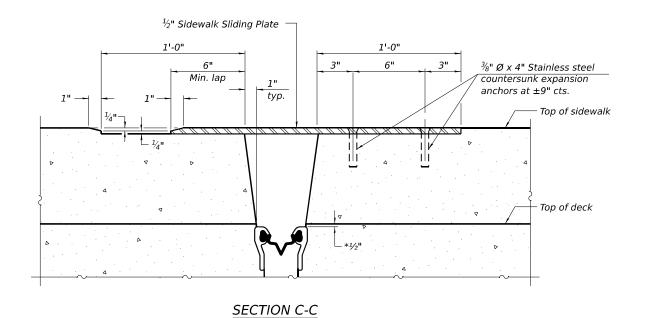

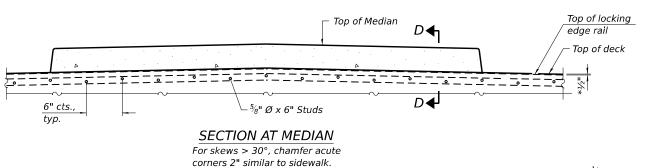*Prior to 1/4"Diamond Grinding

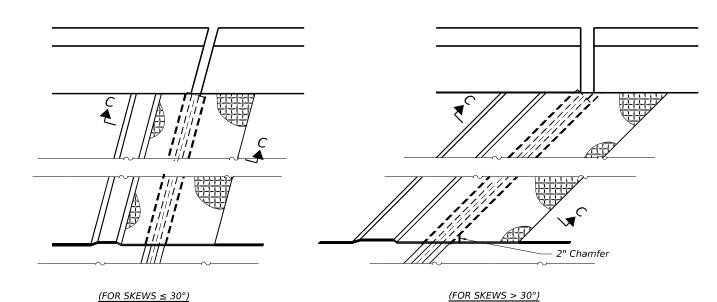

PLAN AT RAISED SIDEWALK

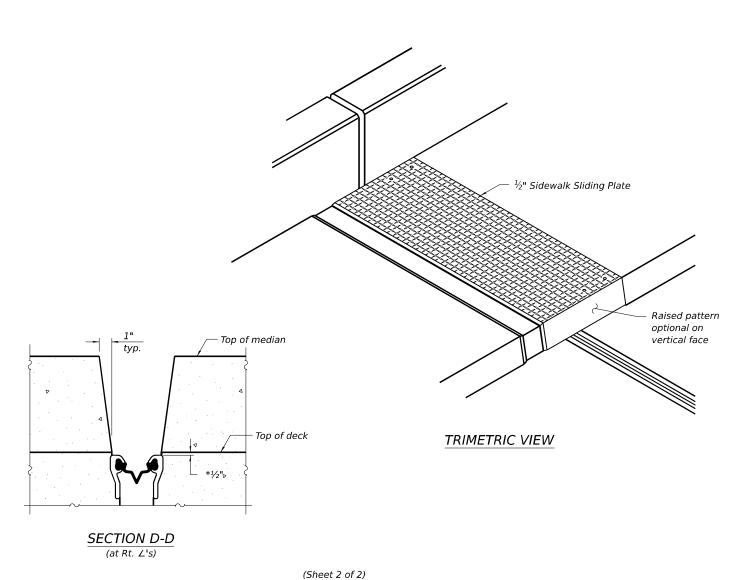

EJ-SS-S


ENGINEERS

USER NAME = DESIGNED - AB REVISED CHECKED - MVW/AMS REVISED -REVISED PLOT DATE = CHECKED - MVW/AMS REVISED

STATE OF ILLINOIS **DEPARTMENT OF TRANSPORTATION**

SECTION PREFORMED JOINT STRIP SEAL - SIDEWALK 1372 FAU 1372 22 BJ STRUCTURE NO. 016-0669 SHEET S8 OF S12 SHEETS

COUNTY соок 50 30 CONTRACT NO. 62T41

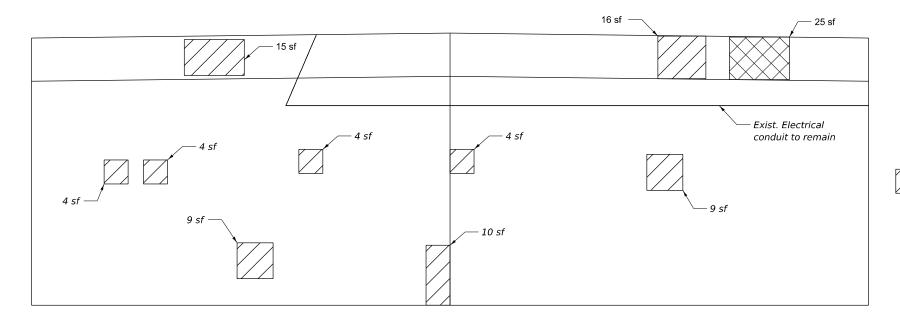




CONDUIT ON WEST ABUTMENT

(Looking Southwest)

WEST ABUTMENT

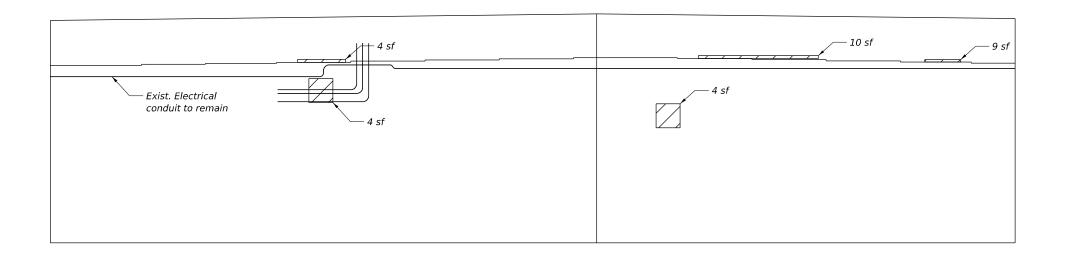



CONDUIT ON EAST ABUTMENT

(Looking Northeast)

BILL OF MATERIAL

ITEM	UNIT	TOTAL
Structural Repair of Concrete		
(Depth Equal To Or Less Than 5 Inches) Structural Repair of Concrete	Sq Ft	114
Structural Repair of Concrete		
(Depth Greater Than 5 Inches)	Sq Ft	25

EAST ABUTMENT



Structural Repair of Concrete (Depth Equal To Or Less Than 5 Inches)



Structural Repair of Concrete (Depth Greater Than 5 Inches)



USER NAME =	DESIGNED - /	AB	REVISED	-
	CHECKED - I	MVW/AMS	REVISED	-
PLOT SCALE =	DRAWN - /	AB	REVISED	-
PLOT DATE =	CHECKED - I	MVW/AMS	REVISED	-


– 8 sf on Wingwall

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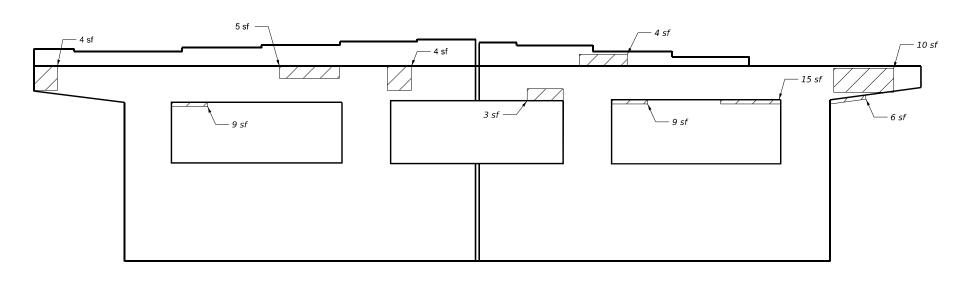
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EL: Default

ODEL: LE NAM



WEST ELEVATION

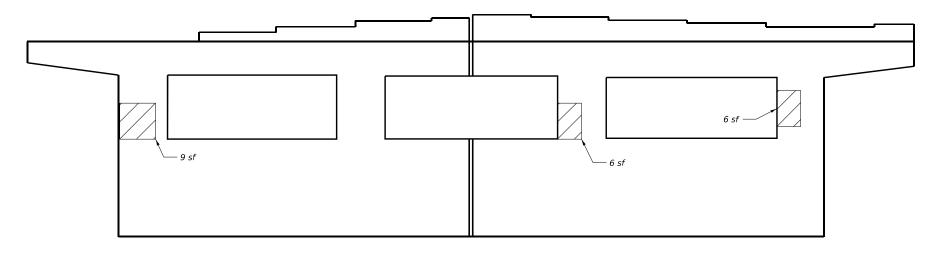

EAST ELEVATION



Structural Repair of Concrete (Depth Equal To Or Less Than 5 Inches)

BILL OF MATERIAL

ITEM	UNIT	TOTAL
Structural Repair of Concrete		
(Depth Equal To Or Less Than 5 Inches)	Sq Ft	90

ORIONENGINEERS

 USER NAME =
 DESIGNED - AB REVISED

 CHECKED - MVW/AMS REVISED


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 DRAWN - AB REVISED

 PLOT DATE =
 CHECKED - MVW/AMS REVISED


STATE OF ILLINOIS
DEPARTMENT OF TRANSPORTATION

PIER 1 REPAIR DETAILS
STRUCTURE NO. 016-0669

SHEET S10 OF S12 SHEETS

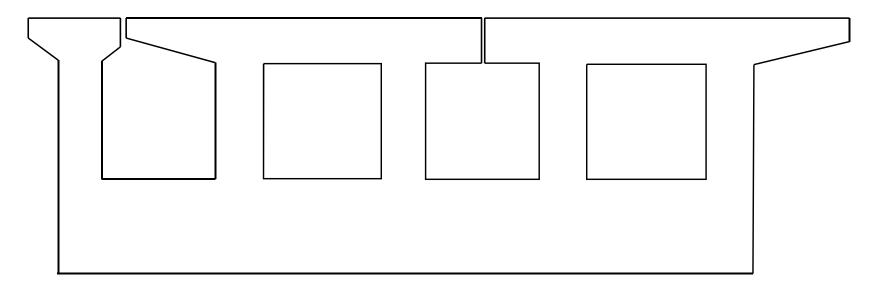

WEST ELEVATION

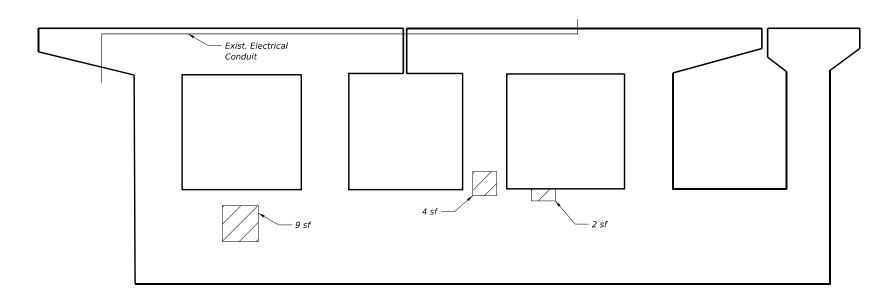

EAST ELEVATION



Structural Repair of Concrete (Depth Equal To Or Less Than 5 Inches)

BILL OF MATERIAL

ITEM	UNIT	TOTAL
Structural Repair of Concrete		
(Depth Equal To Or Less Than 5 Inches)	Sq Ft	15

ORION

 USER NAME =
 DESIGNED - AB REVISED

 CHECKED - MVW/AMS REVISED

 PLOT SCALE =
 DRAWN - AB REVISED

 PLOT DATE =
 CHECKED - MVW/AMS REVISED

STATE OF ILLINOIS DEPARTMENT OF TRANSPORTATION

PIER 2 REPAIR DETAILS STRUCTURE NO. 016-0669

SHEET S11 OF S12 SHEETS


STANDARD BAR SPLICER ASSEMBLY PLAN

Only bar splicer assemblies as presented on the approved QPL list may be used.

Threaded splicer bar length = min. lap length + $1\frac{1}{2}$ " + thread length

* Epoxy not required on Bar Splicer Assembly components used in conjunction with black bars.

Location	Bar	No. assemblies	Minimum
	size	required	lap length
Deck	#5	16	3'-6"
Hatchblock	#6	8	4'-0"

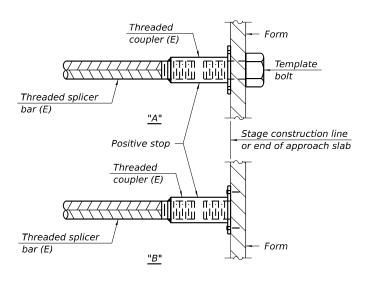


INSTALLATION AND SETTING METHODS

"A": Set bar splicer assembly by means of a template bolt.

"B": Set bar splicer assembly by nailing to wood forms or cementing to steel forms.

(E) : Indicates epoxy coating.

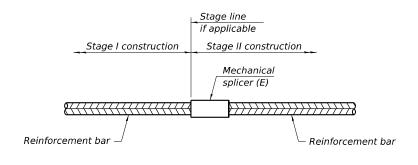

STANDARD MECHANICAL SPLICER

Location	Bar size	No. assemblies required

Notes:

Splicer bars shall be deformed with threaded ends and have a minimum 60 ksi yield strength.

COUNTY

COOK

50 34

All reinforcement shall be lapped and tied to the splicer bars. Bar splicer assemblies shall be epoxy coated according to the requirements

for reinforcement bars. See Section 508 of the Standard Specifications. See approved list of bar splicer assemblies and mechanical splicers for alternatives.

BSD-1



USER NAME =	DESIGNED -	AB	REVISED -
	CHECKED -	MVW/AMS	REVISED -
PLOT SCALE =	DRAWN -	AB	REVISED -
PLOT DATE =	CHECKED -	MVW/AMS	REVISED -

<u>PLAN VIEW</u>

(AS SHOWN ON THE PLANS)

8" (200) P.C.C. -DRIVEWAY PAVEMENT

SECTION B-B

-MEET EXISTING


3/4 " (20) PREFORMED EXPANSION JOINT FILLER

NOTES

- EXPANSION JOINTS SHALL BE CONSTRUCTED AS SHOWN ON THE DETAILS FOR P.C.C. SIDEWALK.
- THE CURB BETWEEN ADJACENT DRIVEWAYS SHALL BE FULL HEIGHT FOR A DISTANCE OF AT LEAST FOUR 4 FEET (1.2 METERS).
- 3. P.C. CONCRETE DRIVEWAYS SHALL BE CONSTRUCTED AT LOCATIONS SHOWN ON THE PLANS OR AS DIRECTED BY THE ENGINEER.


BASIS OF PAVEMENT

- 3/4 " (20) PREFORMED EXPANSION JOINTS WILL NOT BE PAID FOR SEPARATELY BUT SHALL BE INCLUDED IN P.C.C. DRIVEWAY PAVEMENT 8" (200).
- 2. COMBINATION CONC. CURB AND GUTTER SHALL BE MEASURED STRAIGHT ACROSS THE DRIVEWAY. NO ADDITIONAL COMPENSATION WILL BE ALLOWED FOR THE TRANSITION CURB AND GUTTER.

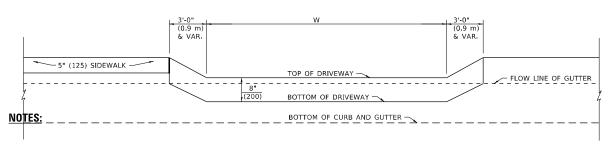

SECTION A-A

P.C.C. DRIVEWAY PAVEMENT DETAIL

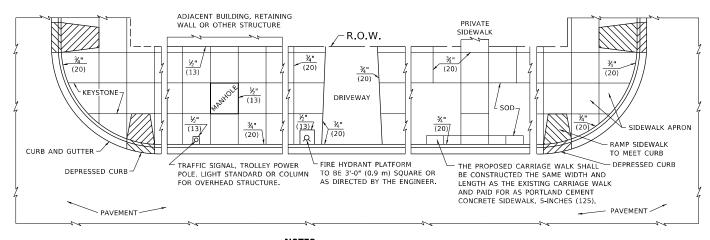

NOTES:

- |- ¾" (20)

1" (25) IN 3'-0" (0.9 m) IN CHICAGO


SLOPE FOR SIDEWALK


PREFORMED EXPANSION

JOINT FILLER

- ONE-HALF INCH THICK EXPANSION JOINTS SHALL BE PLACED BETWEEN THE SIDEWALK AND ALL STRYCTURES SUCH AS LIGHT STANDARDS, TRAFFIC LIGHT STANDARDS, MANHOLES, WHICH EXTEND THROUGH THE SIDEWALK.
- 2. 3/4" (20) THICK EXPANSION JOINTS SHALL BE PLACED AT INTERVALS OF NOT MORE THAN 100 FEET (30 METERS) IN THE SIDEWALK. WHERE THE SIDEWALK IS CONSTRUCTED ADJACENT TO PAVEMENT OR CURB HAVING EXPANSION JOINTS, THE EXPANSION JOINTS IN THE SIDEWALK SHALL BE PLACED OPPOSITE THE EXISTING EXPANSION JOINTS AS NEARLY AS PRACTICABLE. EXPANSION JOINTS SHALL ALSO BE PLACED WHERE THE SIDEWALK ABUTS EXISTING SIDEWALKS. BETWEEN DRIVEWAY PAVEMENT AND SIDEWALK, AND BETWEEN SIDEWALK AND CURBS WHERE THE SIDEWALK ABUTS THE CURB.

PORTLAND CEMENT CONCRETE SIDEWALK DETAILS

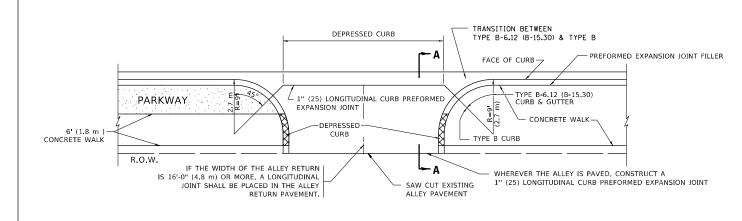

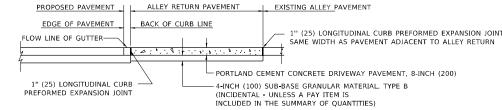

SECTION A-A

BASIS OF PAVEMENT

- SUB-BASE GRANULAR MATERIAL TYPE B SHALL BE PAID FOR SEPERATELY.
- NO EXTRA COMPENSATION SHALL BE ALLOWED FOR THE GUTTER FLARE.

ALLEY RETURN DETAIL

ALL DIMENSIONS ARE IN INCHES (MILLIMETERS) UNLESS OTHERWISE SHOWN

USER NAME = Lawrence, DeManche	DESIGNED	-	M. DE YONG	REVISED	-	K. SMITH 11-18-22
	DRAWN	-		REVISED	-	
PLOT SCALE = 100.0000 / in.	CHECKED	-		REVISED	-	
PLOT DATE = 11/18/2022	DATE	-	06-13-90	REVISED	-	


STATE OF ILLINOIS
DEPARTMENT OF TRANSPORTATION

- CURB AND GUTTER

CITY OF CHICAGO

DETAILS FOR P.C. CONCRETE DRIVEWAY, ALLEY RETURN AND SIDEWALK

SCALE: NONE SHEET 1 OF 1 SHEETS STA. TO STA.

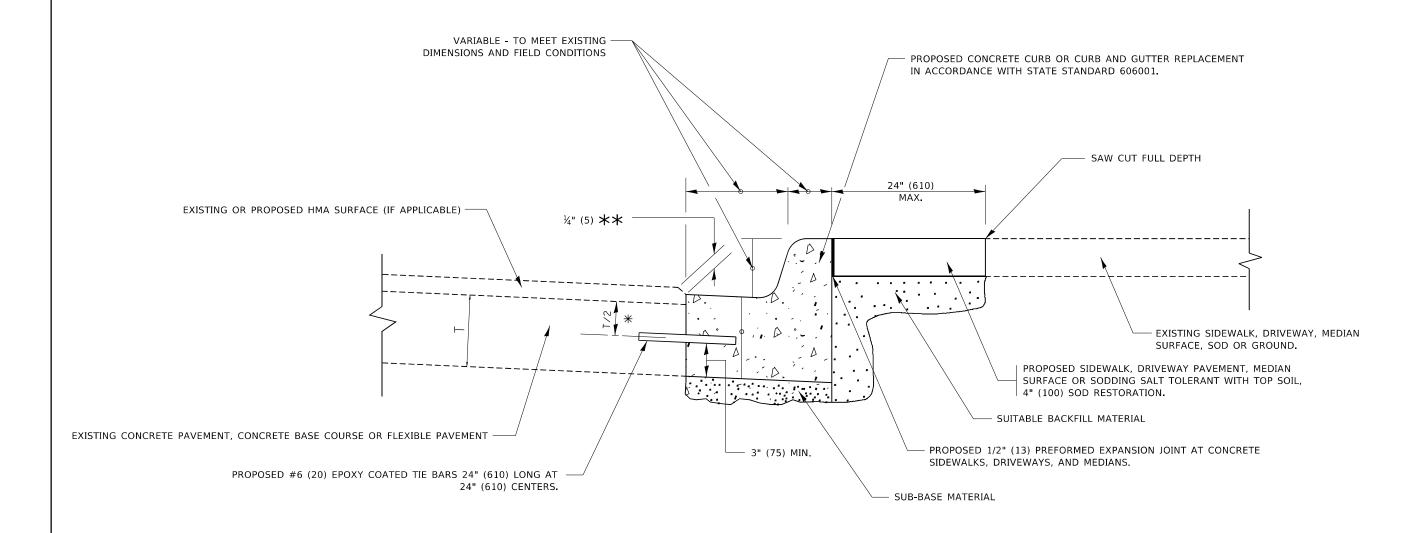


- 💥 3" (75) MINIMUM FROM TOP AND BOTTOM OF THE CONCRETE PAVEMENT OR BASE COURSE.
- $\star\star$ IF THE FINAL SURFACE OF THE PAVEMENT IS CONCRETE, THE GUTTER IS TO BE FLUSH WITH THE PAVEMENT.

CURB OR CURB AND GUTTER REMOVAL AND REPLACEMENT


ALL DIMENSIONS ARE IN INCHES (MILLIMETERS) UNLESS OTHERWISE SHOWN.

USER NAME = footemj	DESIGNED - A. HOUSEH	REVISED - A. ABBAS 03-21-97		CURB OR CURB AND GUTTER	RTF	SECTION	COUNTY	SHEET	S NO	1
	DRAWN -	REVISED - M. GOMEZ 01-22-01	STATE OF ILLINOIS		1372	FAU 1372 22 BJ	соок	50	36	-
PLOT SCALE = 50.0000 / in.	CHECKED -	REVISED - R. BORO 12-15-09	DEPARTMENT OF TRANSPORTATION	REMOVAL AND REPLACEMENT	ВГ	D600-06 (BD-24)	CONTRAC	T NO.		-
PLOT DATE = 7/11/2019	DATE - 03-11-94	REVISED - K. SMITH 07-11-19		SCALE: NONE SHEET 1 OF 1 SHEETS STA. TO STA.		ILLINOIS	FED. AID PROJECT			_

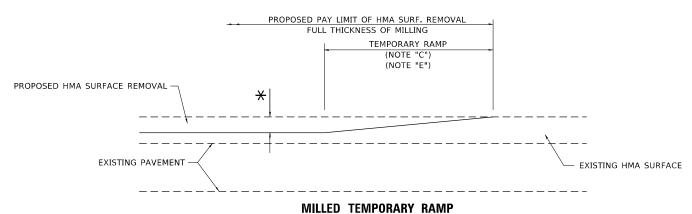

(FOR BUTT JOINT AND HMA TAPER SEE DETAIL BELOW)

OPTION 1

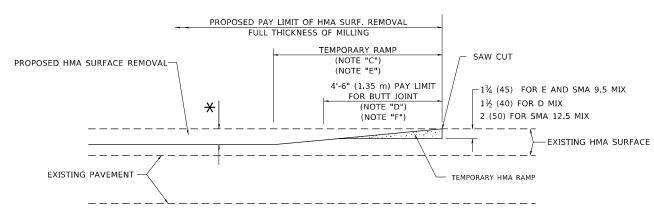


HMA CONSTRUCTED TEMPORARY RAMP

(FOR BUTT JOINT AND HMA TAPER SEE DETAIL BELOW)

OPTION 2

TYPICAL TEMPORARY RAMP

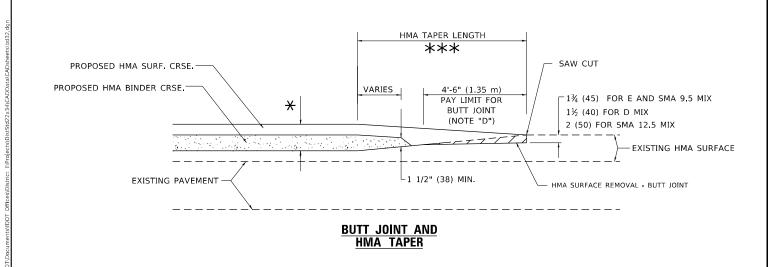


TYPICAL BUTT JOINT AND HMA TAPER FOR MILLING AND RESURFACING

M. DE YONG DESIGNED -DRAWN REVISED - M. GOMEZ 04-06-01 HECKED PLOT DATE = 11/18/2022 K. SMITH 11-18-22 DATE REVISED -

STATE OF ILLINOIS **DEPARTMENT OF TRANSPORTATION**

BUTT JOINT AND HMA TAPER DETAILS

PROPOSED HMA OR PCC SURFACE REMOVAL - BUTT JOINT 30'-0" (9.0 m) (NOTE "A") EXISTING HMA OR PCC SURFACE -SAW CUT 15'-0" (4.5 m) (NOTE "B") (NOTE "D") 40'-0" (12.0M) (NOTE "A1") $-1\frac{3}{4}$ (45) FOR E AND SMA 9.5 MIX 1½ (40) FOR D MIX 2 (50) FOR SMA 12,5 MIX * EXISTING PAVEMENT **BUTT JOINT DETAIL**

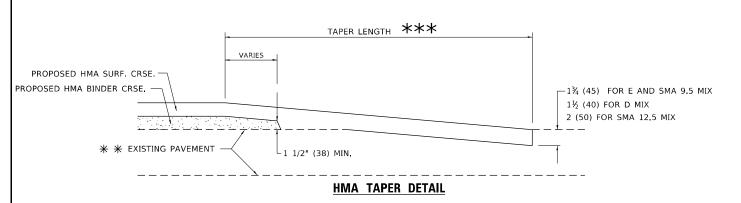

TYPICAL BUTT JOINT AND HMA TAPER FOR RESURFACING ONLY

** PC CONCRETE, HMA OR HMA RESURFACED PAVEMENT.

GENERAL NOTES


- A. MAINLINE ARTERIAL ROADWAYS AND MAJOR SIDE ROADS.
- A1. INTERSTATES
- B. MINOR SIDE ROADS.
- C. THE TEMP, RAMP SHALL BE CONSTRUCTED IMMEDIATELY UPON REMOVAL OF THE EXISTING HMA SURFACE,
- D. THE BUTT JOINT SHALL BE CONSTRUCTED IMMEDIATELY PRIOR TO PLACING THE PROPOSED HMA COURSES.
- E. TAPER THE TEMP. RAMP AT A RATE OF 3' 4" (1.02m) PER 1 INCH (25 mm) OF MILLING THICKNESS.
 - \bigstar SEE TYPICAL SECTIONS FOR MILLING THICKNESS.
- F. SEE ARTICLE 406.08 AND 406.14 OF THE STANDARD SPECIFICATIONS FOR "HMA AND/OR PCC SURFACE REMOVAL, BUTT JOINT".
- *** 20'-0" (6.1 m) PER 1 (25) RESURFACING (NOTE "A") 10'-0" (3.0 m) PER 1 (25) RESURFACING (NOTE "B")

BASIS OF PAYMENT

- THE BUTT JOINT WILL BE PAID FOR AT THE CONTRACT UNIT PRICE PER SQUARE YARD (SQUARE METER) FOR "HOT-MIX ASPHALT SURFACE REMOVAL BUTT JOINT" OR FOR "PORTLAND CEMENT CONCRETE SURFACE REMOVAL- BUTT JOINT"
- THE TEMPORARY RAMP AND SAW CUT SHALL BE INCLUDED IN THE UNIT COST FOR HMA OR PCC SURFACE REMOVAL-BUTT JOINT.

ALL DIMENSIONS ARE IN INCHES (MILLIMETERS) UNLESS OTHERWISE SHOWN.

COUNTY FAU 1372 22 BJ COOK 50 CONTRACT NO. BD400-05 BD-32 OF 1 SHEETS STA. SCALE: NONE SHEET 1 TO STA.

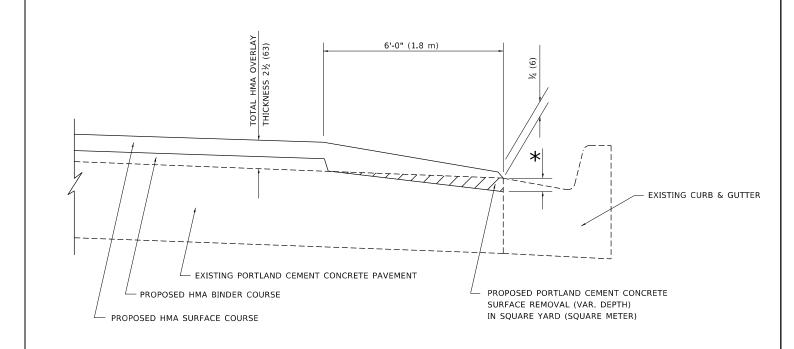

HMA TAPER AT EDGE OF PCC PAVEMENT

HMA SURFACE COURSE		HMA BINDER COURSE	
MIX	THICKNESS	THICKNESS	* MILLING AT GUTTER FLAG
D	1½ (38)	1 (25)	1¼ (33)
E OR SMA 9.5	1¾ (44)	3/4 (19)	1½ (38)


ALL DIMENSIONS ARE IN INCHES (MILLIMETERS) UNLESS OTHERWISE SHOWN.

USER NAME = Shawn.Ley	DESIGNED	-	R. SHAH	REVISED	-	E. GOMEZ 12-21-00
	DRAWN	-	JIS	REVISED	-	R. BORO 01-01-07
PLOT SCALE = 50.0000 / in.	CHECKED	-	A. ABBAS	REVISED	-	JP CHANG 07-08-16
PLOT DATE = 1/23/2023	DATE	-	09-10-94	REVISED	-	K. SMITH 11-18-22


STATE O	F ILLINOIS
DEPARTMENT OF	TRANSPORTATION

		нма	TAPER	AT		F.A.U. RTE	SEC	TION		COUNTY	TOTAL SHEETS	SHEET NO.
	E	DCE OF	D C C D/	AVEMENT		1372	FAU 13	72 22 BJ		COOK	50	38
		DGL OI	1 ,0,0, 1 7	VEIVILIAI		В	D400-06	BD-33	3	CONTRACT	NO.	
SCALE: NONE	SCALE: NONE SHEET 1 OF 1 SHEETS STA. TO STA.							ILLINOIS	FED. AI	D PROJECT		

STRAIGHT DETECTABLE WARNING UNITS

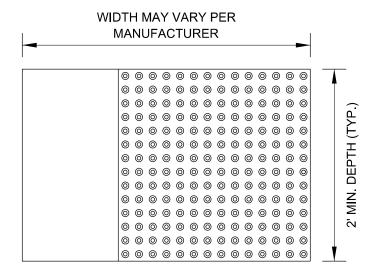

RADIAL DETECTABLE WARNING UNITS

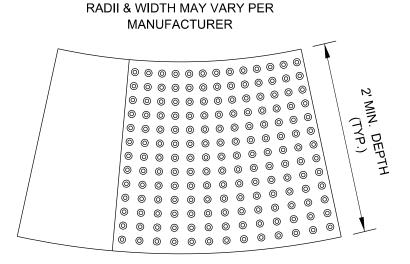


DETECTABLE WARNING UNIT SIZES


- VERIFY ALL DIMENSIONS WITH THE PRODUCT MANUFACTURER.
- IF USING RADIAL UNITS, VERIFY THAT THE CURB RADIUS MATCHES AVAILABLE UNIT RADII WITH THE PRODUCT MANUFACTURER.

GENERAL NOTE:

THE ROWS OF DOMES IN THE DETECTABLE WARNING MATERIAL MUST BE ALIGNED WITH THE PATH OF WHEELCHAIR TRAVEL WHICH IS REQUIRED TO BE PERPENDICULAR TO THE GRADE BREAK AT THE BOTTOM OF THE RAMP TO PERMIT TRACKING BETWEEN DOME ROWS. ON BLENDED TRANSITIONS OR FLUSH TRANSITIONS, WHERE RADIAL UNITS ARE SITUATED ABOUT THE CURB RADIUS, DOME ORIENTATION IS NOT SIGNIFICANT.

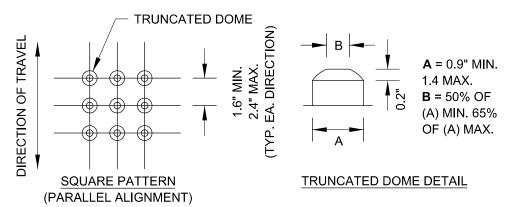


UNIT PATTERN & DOME DETAIL

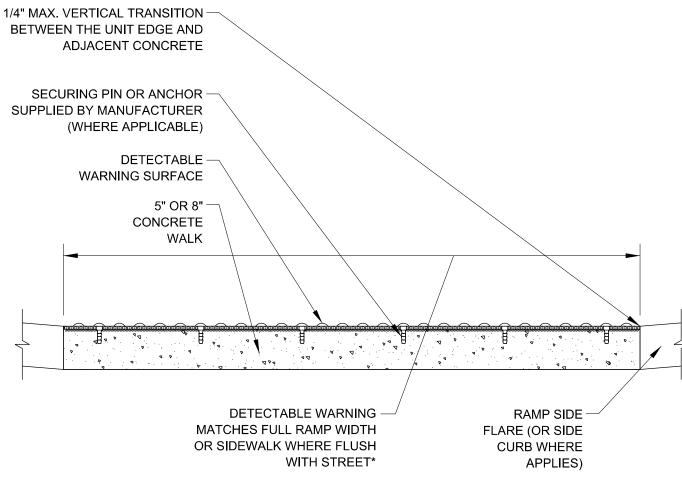


*A BORDER OF 2 INCHES OR LESS AROUND THE DETECTABLE WARNING SURFACE IS
ACCEPTABLE IF REQUIRED FOR PROPER INSTALLATION OF THE DETECTABLE WARNING SURFACE PRODUCT

DETECTABLE WARNING UNIT SECTION


USER NAME = footemj	DESIGNED -	REVISED -				CITY	OF CHIC	ΔGO		F.A.U. RTF	SECTION	COUNTY	TOTAL	SHEET
	DRAWN -	REVISED -	STATE OF ILLINOIS				DETECTABLE WARNINGS		FAU 1372 22 BJ	соок	50	39		
PLOT SCALE = 50.0000 / in.	CHECKED -	REVISED -	DEPARTMENT OF TRANSPORTATION		DETECTABLE WAKNINGS			BD 58	CONTRACT	NO.				
PLOT DATE = 10/8/2019	DATE - 06-20-2017	REVISED -		SCALE: NONE	SHEET 1	OF 1	SHEETS	STA.	TO STA.		ILLINOIS FED. A	ID PROJECT		

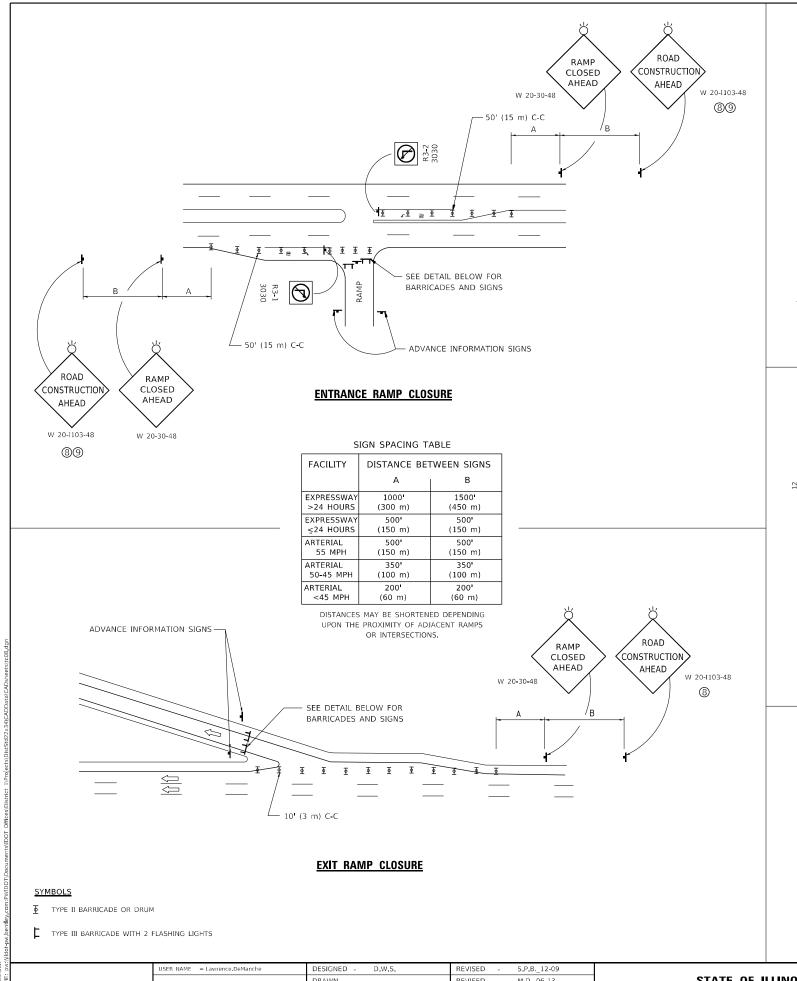

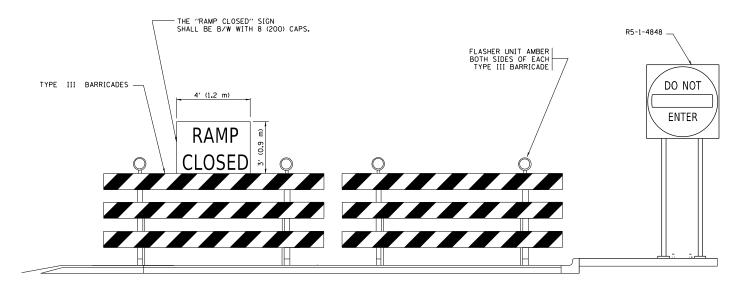

DETAIL FOR REQUIRED BARRICADES & SIGNS

RAMP CLOSURE ADVANCE WARNING SIGN

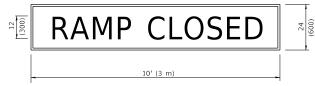

BLACK LEGEND ON ORANGE

CLOSED FOR MORE THAN FOUR (4) CONSECUTIVE DAYS.

BACKGROUND MOUNTED
DIAGONALLY
E MOD FONT
1 (25) BORDER
THESE SIGNS ARE REQUIRED ON ALL THE EXIT
GUIDE SIGNS FOR EXIT RAMPS THAT WILL BE

THIS RAMP 6 (150) 5 (125) BLACK LEGEND ON WHITE BACKGROUND 6 (150) 5 (125) ½ (12) BORDER **CLOSED** 6 (150) E MOD FONT 5 (125) 6 (150) THESE BLANK AREAS SHALL BE FILLED WITH THE DATES AND THE 5 (125) TIME THAT THE RAMP WILL BE 6 (150) (125)

RAMP CLOSURE ADVANCE INFORMATION SIGN

THESE SIGNS ARE REQUIRED ON BOTH SIDES OF THE RAMP, MINIMUM OF 1 WEEK IN ADVANCE OF THE CLOSURE.

THESE SIGNS SHALL BE FABRICATED AND PAID FOR ACCORDING TO THE TEMPORARY INFORMATION SIGNING SPECIAL PROVISION

GENERAL NOTES:

- ONES MAY BE SUBSTITUTED FOR DRUMS OR TYPE II
 BARRICADES DURING DAY OPERATIONS. CONES SHALL BE
 A MINIMUM OF 28 (700) HIGH.
- (2) VERTICAL BARRICADES SHALL NOT BE USED FOR RAMP CLOSURES.
- ③ A FLAGGER SHALL BE POSITIONED AT EACH CLOSED RAMP THAT IS OPEN TO CONSTRUCTION VEHICLES, PRECEEDED BY A W20-7 FLAGGER WARNING SIGN.
- 4 ALL ROUTE MARKERS AND TRAILBLAZER ASSEMBLIES WHICH DIRECT MOTORISTS TO A CLOSED ENTRANCE RAMP SHALL BE COVERED WHEN THE RAMP IS CLOSED FOR MORE THAN FOUR (4) DAYS.
- (3) THE SIGNING AND BARRICADING WHICH IS REQUIRED BY THIS DETAIL SHALL BE INCLUDED IN THE COST OF TRAFFIC CONTROL AND PROTECTION (EXPRESSWAYS).

SCALE: NONE


- 6 AUTHORIZATION FROM THE DISTRICT'S BUREAU OF TRAFFIC IS REQUIRED FOR ALL RAMP CLOSURES.
- THE RAMP CLOSURE ADVANCE INFORMATION SIGNS SHALL BE ERECTED IF THE CLOSURE TIME EXCEEDS TWENTY-FOUR (24) HOURS, ADDITIONAL ADVANCE WARNING SIGNS ON EXIT GUIDE SIGNING WILL BE REQUIRED FOR EXIT RAMP CLOSURES THAT EXCEED FOUR (4) DAYS IN LENGTH
- (8) ROAD CONSTRUCTION AHEAD SIGNS MAY BE OMITTED WHEN THIS DETAIL IS USED IN CONJUNCTION WITH OTHER TRAFFIC CONTROL THAT ALREADY INCLUDES A ROAD CONSTRUCTION AHEAD SIGN.
- ARTERIAL ROAD CONSTRUCTION AHEAD SIGNS SHALL BE INSTALLED ON THE LEFT SIDE OF TRAFFIC IF THE MEDIAN IS MORE THAN 10 FT WIDE.


ALL DIMENSIONS ARE IN INCHES (MILLIMETERS)
UNLESS OTHERWISE SHOWN.

USER NAME = Lawrence, DeManche	DESIGNED - D.W.S.	REVISED	-	S.P.B12-09
	DRAWN -	REVISED	-	M.D06-13
PLOT SCALE = 100.0000 / in.	CHECKED -	REVISED	-	M.D01-18
BLOT DATE _ 5/2/2024	DATE 02.92	DEVICED		D C 05 24

STATE OF ILLINOIS
DEPARTMENT OF TRANSPORTATION

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		CL	- ทยเ	JRE DETA	ΛII S		1372	FAU 1372 22 BJ
		UL		TC-08				
SHEET	1	OF	1	SHEETS	STA.	TO STA.		TLUNOIS

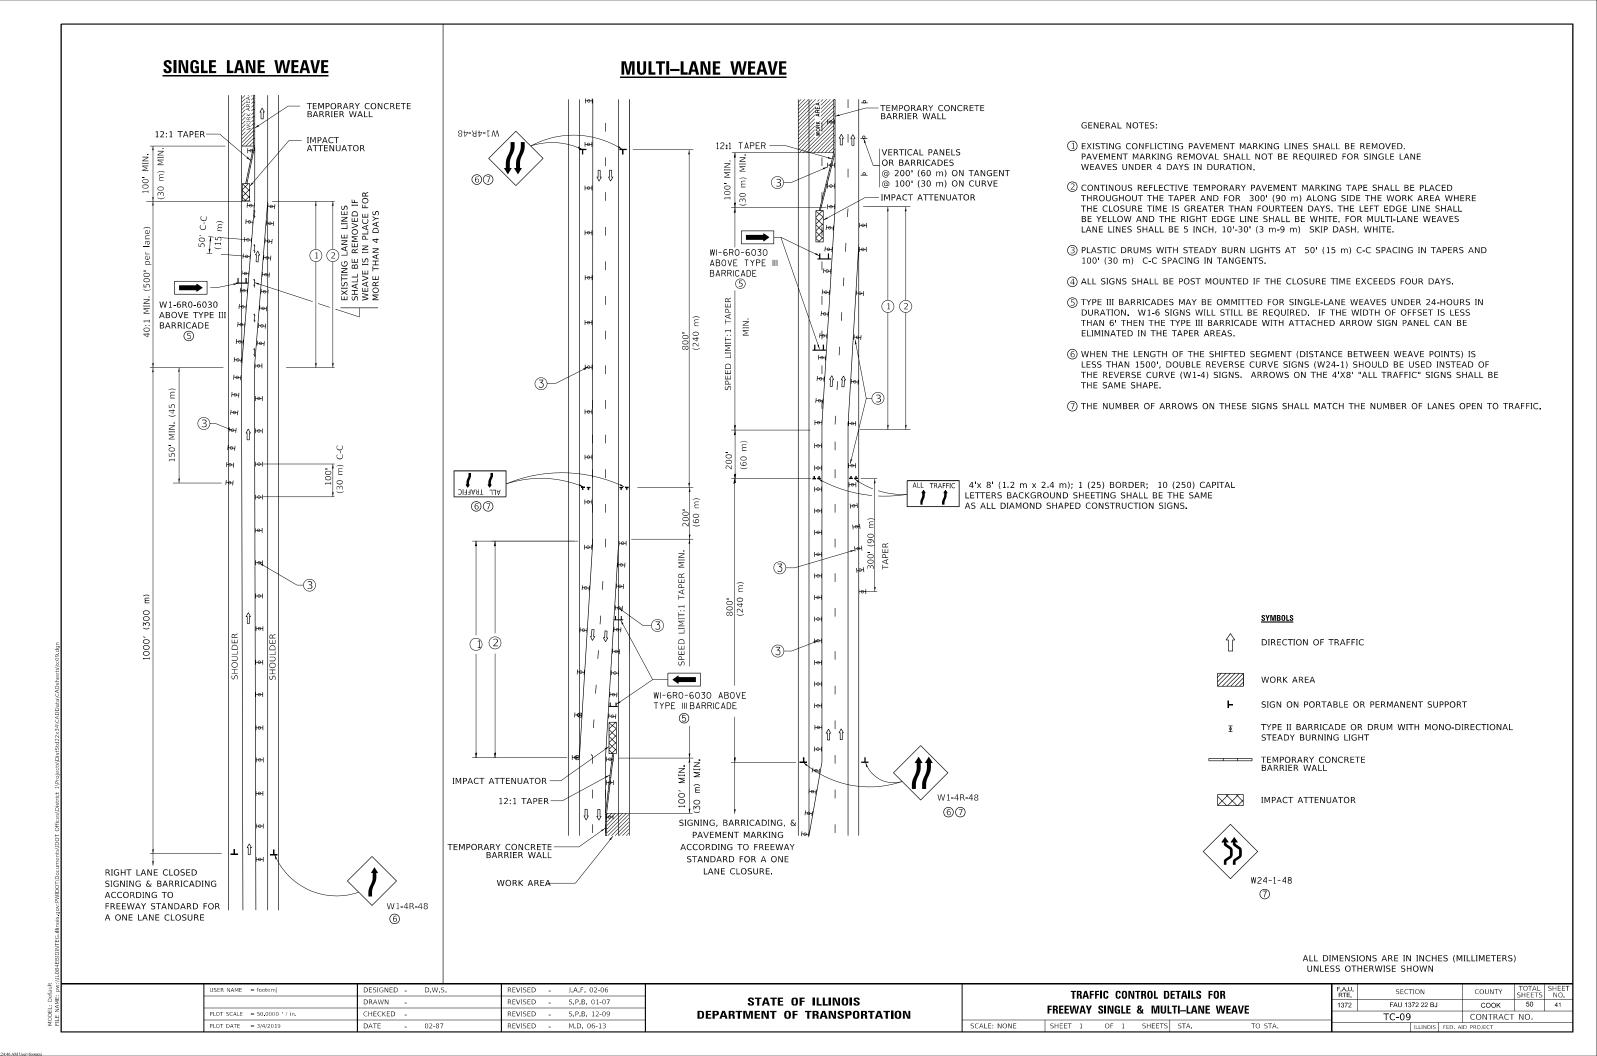

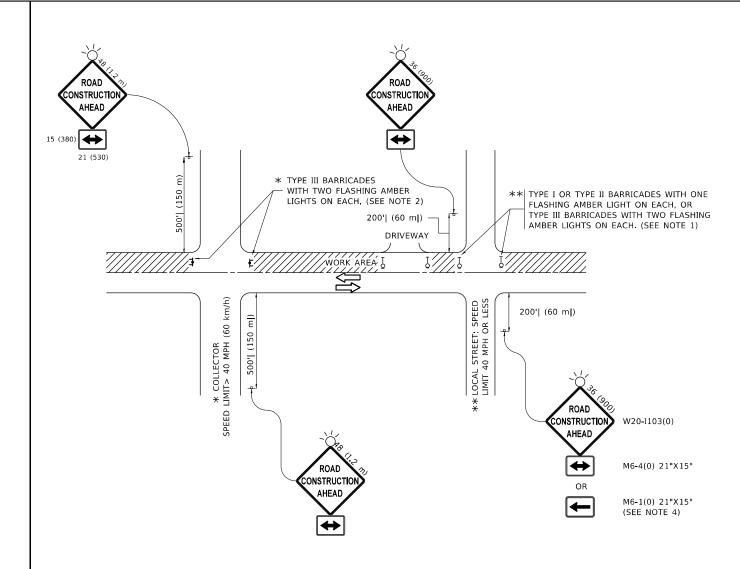

NOTES:

- 1. SIDE ROAD WITH A SPEED LIMIT OF 40 MPH (60 km/h) OR LESS AS SHOWN ON THE DRAWING AND AS DIRECTED BY THE ENGINEER:
- a) ONE "ROAD CONSTRUCTION AHEAD" SIGN 36 x 36 (900x900) WITH A FLASHER MOUNTED ON IT APPROXIMATELY 200' (60 m) IN ADVANCE OF THE MAIN ROUTE.
- b) THE CLOSED PORTION OF THE MAIN ROUTE SHALL BE PROTECTED BY BLOCKING WITH TYPE I, TYPE II OR TYPE III BARRICADES, 1/3 OF THE CROSS SECTION OF THE CLOSED PORTION.
- SIDE ROAD WITH A SPEED LIMIT GREATER THAN 40 MPH (60 km/h) AS SHOWN ON THE DRAWING AND AS DIRECTED BY THE ENGINEER:
- a) ONE "ROAD CONSTRUCTION AHEAD" SIGN 48 x 48 (1.2 m x 1.2 m) WITH A FLASHER MOUNTED ON IT APPROXIMATELY 500' (150 m) IN ADVANCE OF THE MAIN ROUTE,
- THE CLOSED PORTION OF THE MAIN ROUTE SHALL BE PROTECTED BY
 b) BLOCKING WITH TYPE III BARRICADES, 1/2 OF THE CROSS SECTION
 OF THE CLOSED PORTION.
- 3. CONES MAY BE SUBSTITUTED FOR BARRICADES OR DRUMS AT HALF THE SPACING DURING DAY OPERATIONS. CONES SHALL BE A MINIMUM OF 28 (710) IN HEIGHT.

SCALE: NONE

WHEN THE SIDE ROAD LIES BETWEEN THE BEGINNING OF THE MAINLINE
4. SIGNING AND THE WORK ZONE, A SINGLE HEADED ARROW (M6-1) SHALL
BE USED IN LIEU OF THE DOUBLE HEADED ARROW (M6-4).

- 5. WHEN WORK IS BEING PERFORMED ON A SIDE ROAD OR DRIVEWAY, FOLLOW THE APPLICABLE STANDARD(S). THE DIRECTIONAL ARROW (M6-1 OR M6-4) SHALL BE COVERED OR REMOVED WHEN NO LONGER CONSISTENT WITH THE TRAFFIC CONTROL SET-UP.
- 6. ADVANCE WARNING SIGNS ARE TO BE OMITTED ON DRIVEWAYS UNLESS OTHERWISE SPECIFIED IN THE PLANS OR BY THE ENGINEER
- 7. THE TRAFFIC CONTROL AND PROTECTION FOR SIDE ROADS, INTERSECTIONS, AND DRIVEWAYS SHALL BE INCLUDED IN THE COST OF SPECIFIED TRAFFIC CONTROL STANDARDS OR ITEMS.


All dimensions are in inches (millimeters) unless otherwise shown.


USER NAME = Lawrence, DeManche	DESIGNED - L.H.A.	REVISED - T. RAMMACHER 01-06-00
	DRAWN -	REVISED - A. SCHUETZE 07-01-13
PLOT SCALE = 100.0000 / in.	CHECKED -	REVISED - A. SCHUETZE 09-15-16
PLOT DATE = 5/3/2024	DATE - 06-89	REVISED - D. SENDERAK 05-03-24


STATE OF ILLINOIS
DEPARTMENT OF TRANSPORTATION

SI	DE RO	AD	S, INTE	RS	SECTION	IS, AND	TION FOR DRIVEWAYS
	SHEET	1	OF	1	SHEET	S STA.	TO STA.

F.A.U. RTE	SECT	ΠON		COUNTY	TOTAL SHEETS	SHEET NO.
1372	FAU 137	'2 22 BJ	COOK	50	42	
	TC-10		CONTRACT	NO.		
		ILLINOIS	ID PROJECT			

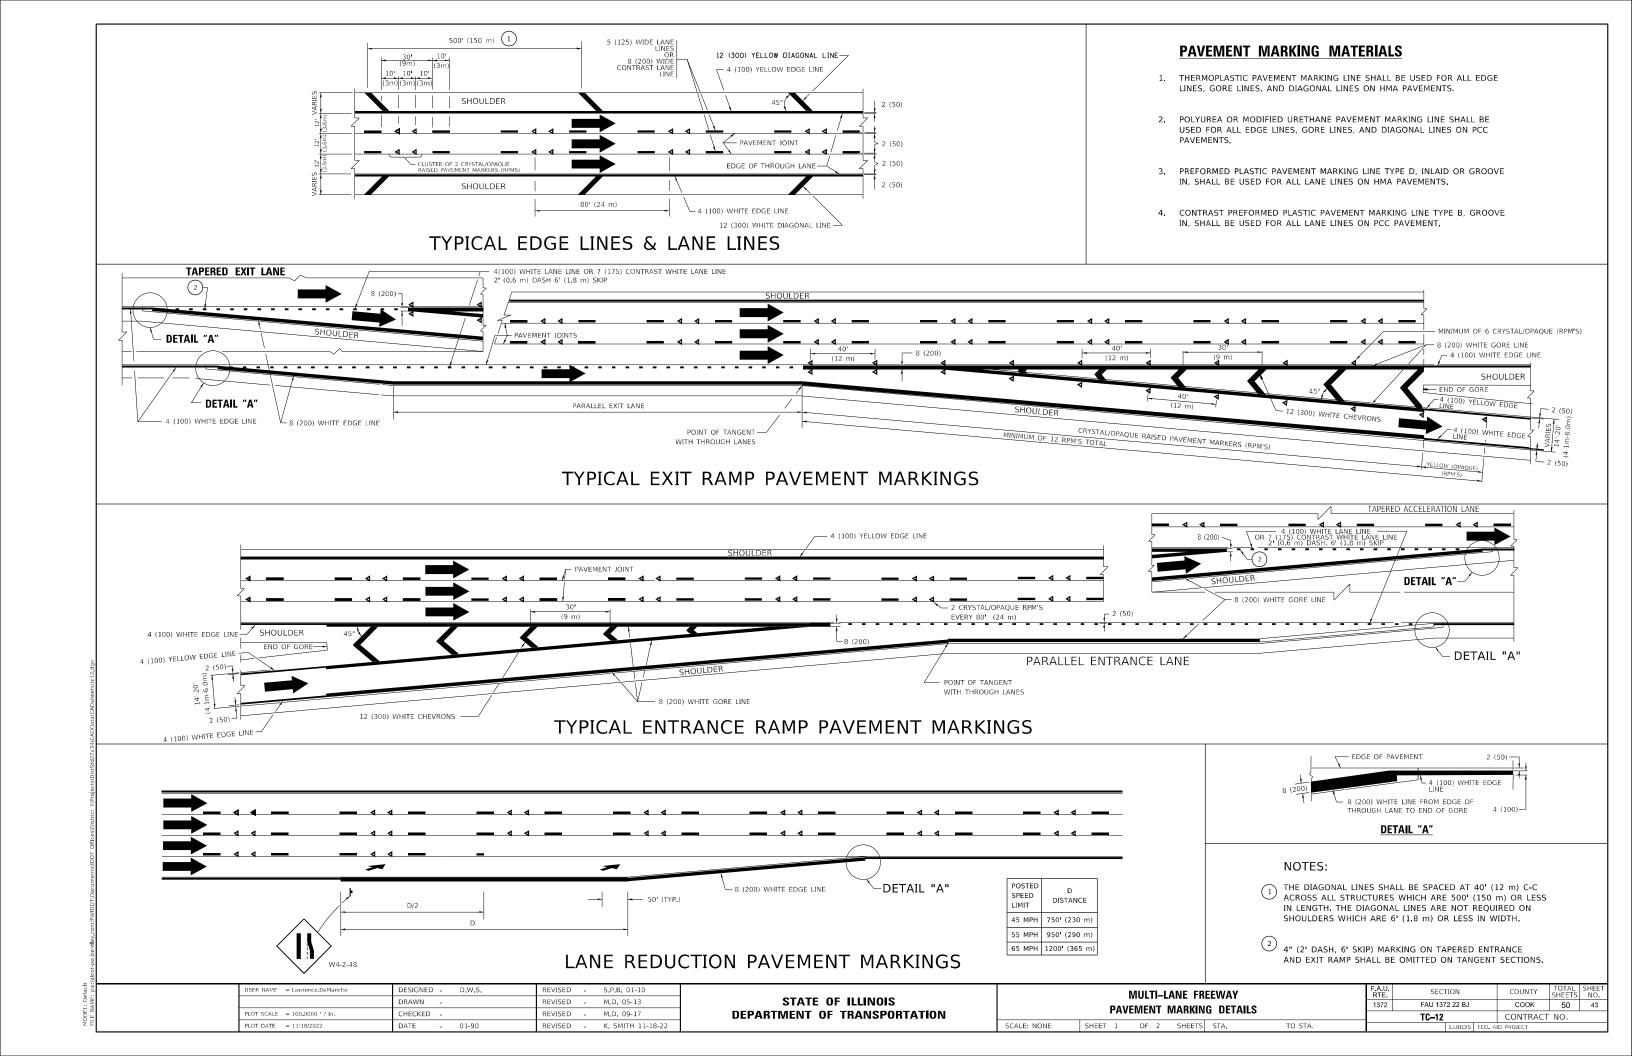


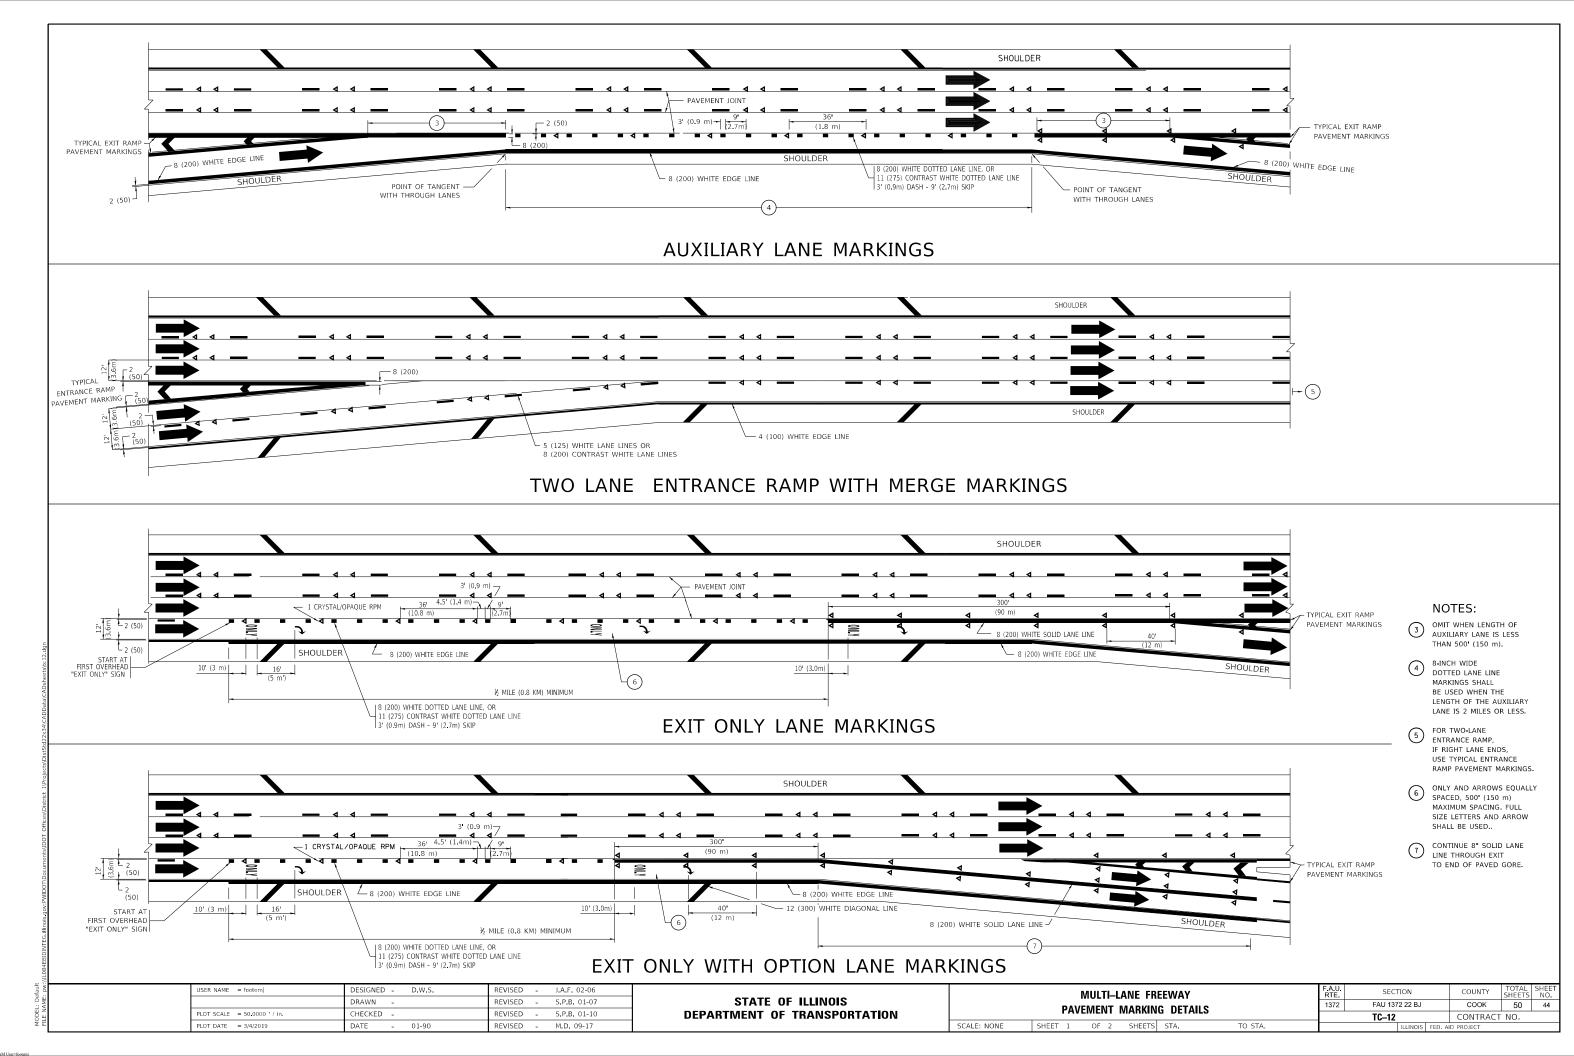

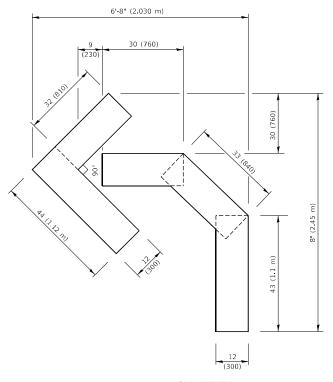

QUANTITY

4 (100) LINE = 45.5 ft. (13.9 m) 15.2 sq. ft. (1.41 sq. m)

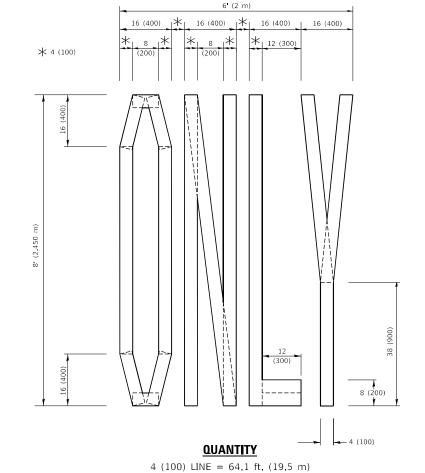


NOTE:

30 (800)

ALL QUANTITIES OF PLACEMENT ARE REPRESENTED IN LINEAR FEET OF 4" LINES TO MATCH THE 4" TEMPORARY TAPE PAY ITEM AND REPRESENTS THE TOTAL QUANTITY OF 4" TAPE REQUIRED.

27.5 sq. ft. (2.53 sq. m)

QUANTITY 4 (100) LINE = 82.5 ft. (25.1 m) 8 (200)

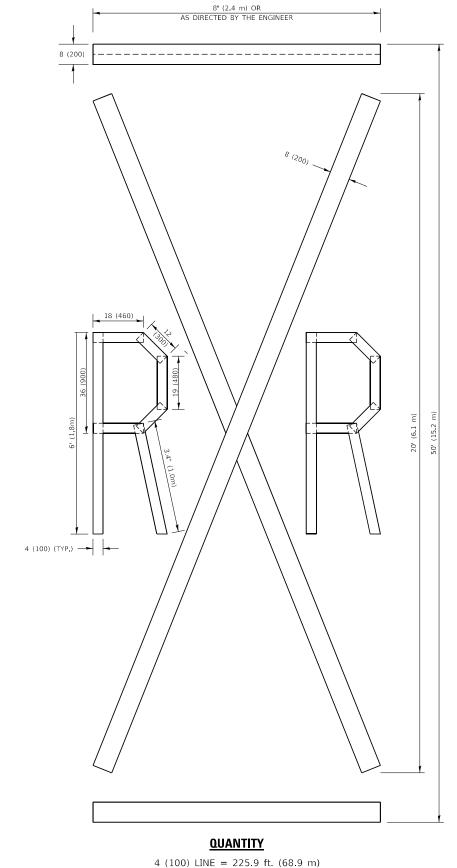

75.3 sq. ft. (6.99 sq. m)

All dimensions are in inches (millimeters) unless otherwise shown.


USER NAME = footemj	DESIGNED -	REVISED	- T. RAMMACHER 03-02-98
	DRAWN -	REVISED	- E. GOMEZ 08-28-00
PLOT SCALE = 50.0068 / in.	CHECKED -	REVISED	- E. GOMEZ 08-28-00
PLOT DATE = 3/4/2019	DATE - 09-18-94	REVISED	- A. SCHUETZE 09-15-16

21.4 sq. ft. (1.99 sq. m)

STATE OF ILLINOIS **DEPARTMENT OF TRANSPORTATION**

	SHORT 1	ΓERM	PA۱	/EMENT	MARKIN	IG LETTERS	AND	SYMBOLS	
ALE:	NONE	SHEET	Т 1	OF 1	SHEET	S STA.		TO STA.	

A.U. RTE	SECT	TION		COUNTY	TOTAL SHEETS	SHEET NO.
1372	FAU 137	2 22 BJ		COOK	50	45
	TC-16			CONTRACT	NO.	
		ILLINOIS	FED. A	ID PROJECT		

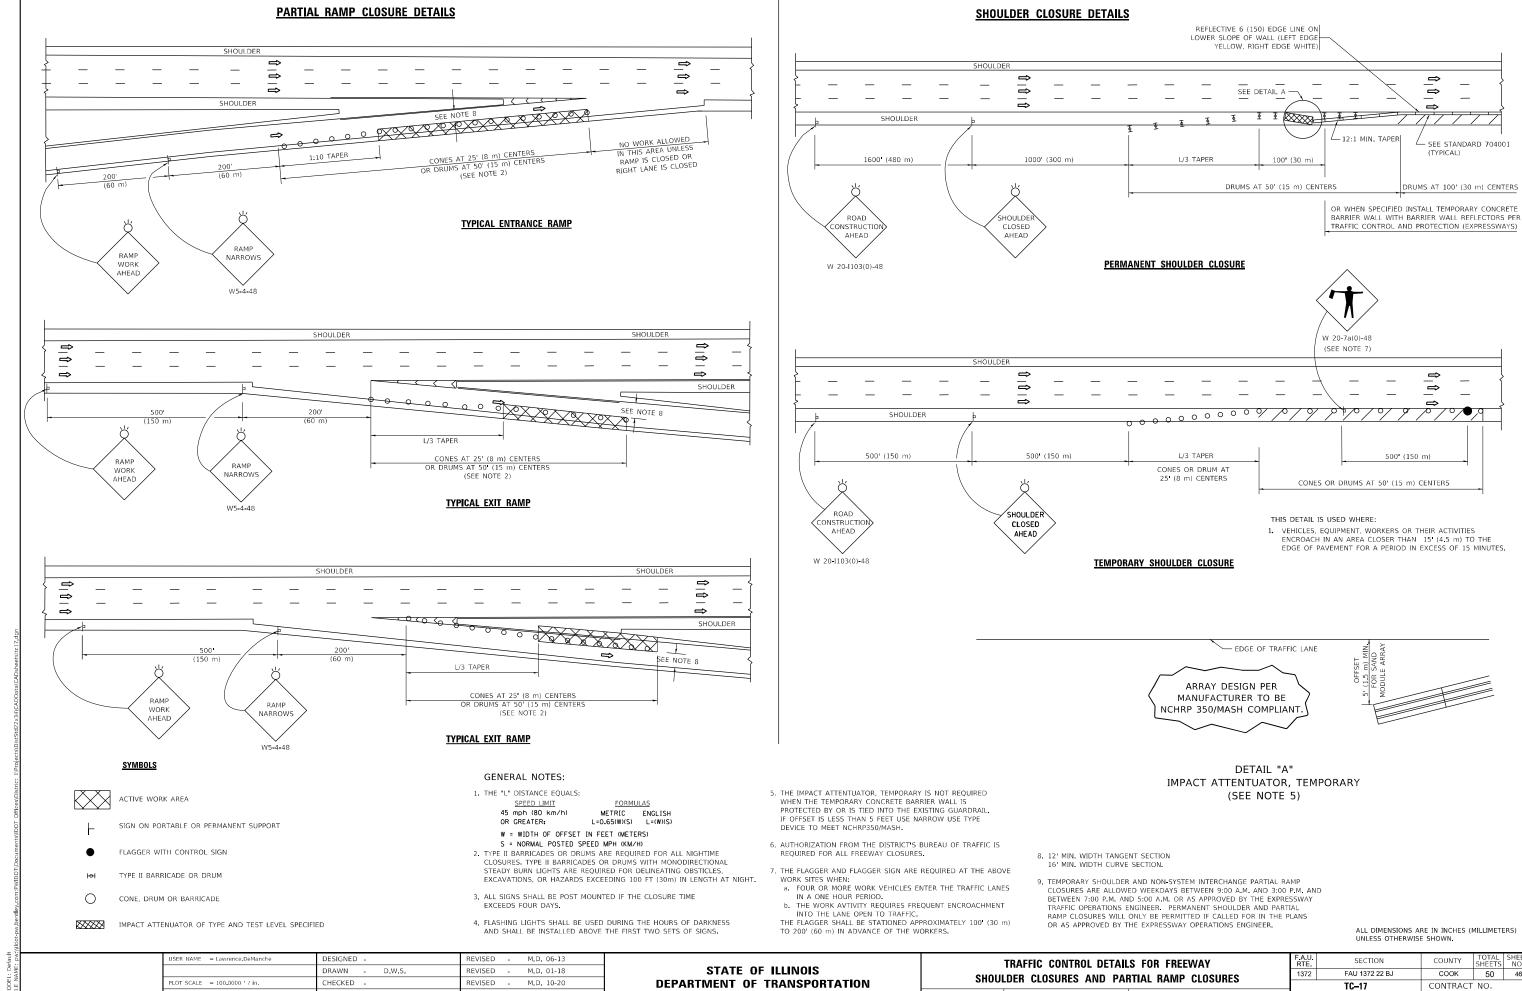


D.S. 05-24


REVISED -

SHEET 1 OF 1 SHEETS STA.

PLOT DATE = 5/3/2024

DATE

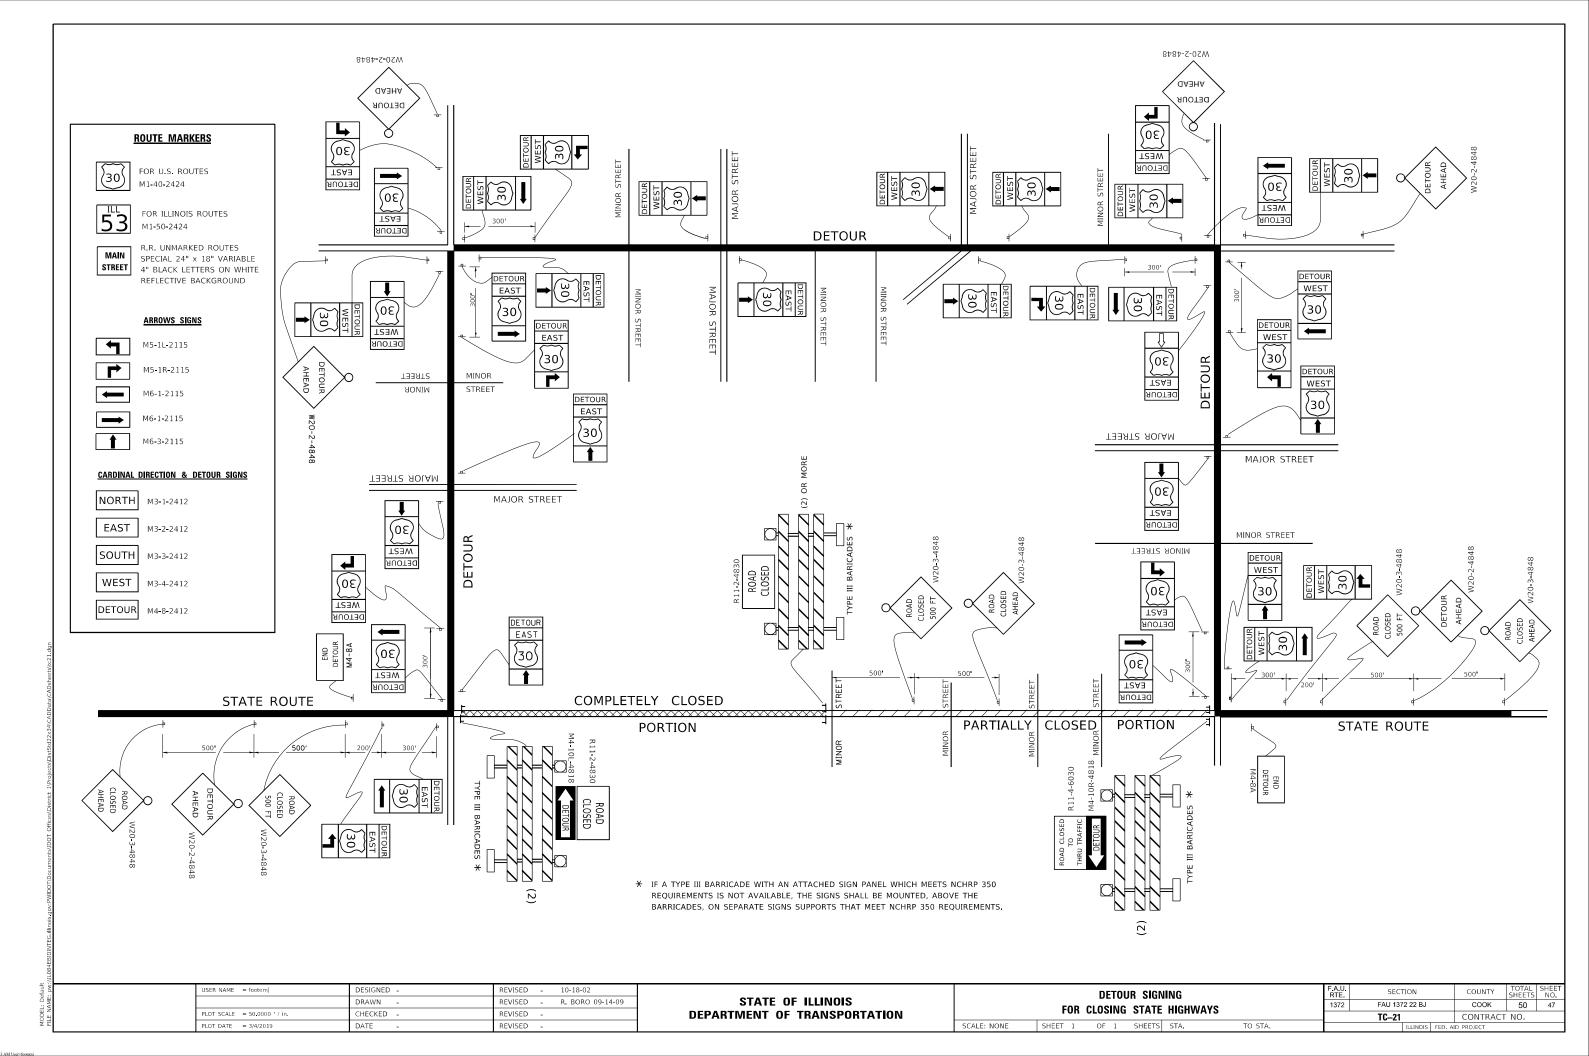

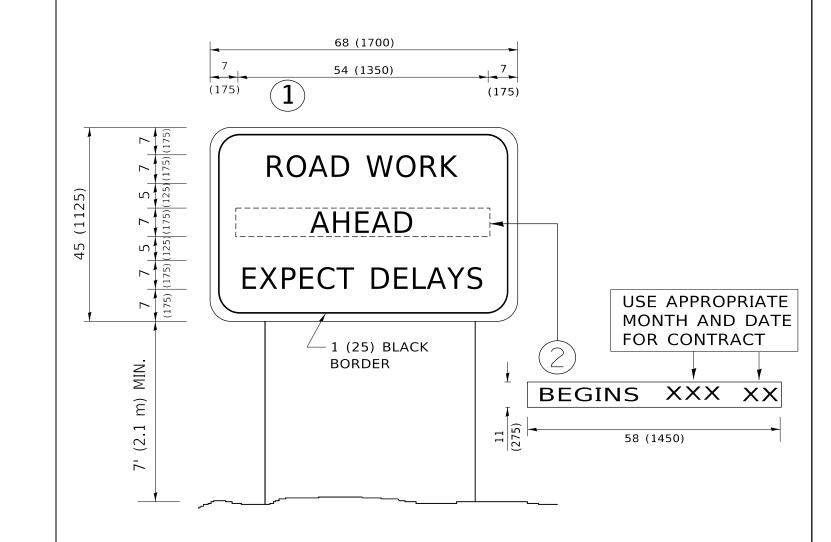



NOTES:

- 1. USE BLACK LETTERING ON ORANGE BACKGROUND.
- 2. ERECT SIGNS IN ADVANCE OF THE LOCATION FOR THE "ROAD CONSTRUCTION AHEAD" SIGN AT LOCATIONS AS DIRECTED BY THE ENGINEER.
- 3. ERECT SIGN 1 WITH INSTALLED PANEL 2 ONE WEEK PRIOR TO THE START OF CONSTRUCTION.
- 4. REMOVE PANEL(2)SOON AFTER THE START OF CONSTRUCTION.
- 5. SEE SPECIAL PROVISION FOR "TEMPORARY INFORMATION SIGNING" FOR ADDITIONAL INFORMATION.
- 6. ONE SIGN ASSEMBLY EQUALS 25.70 SQ. FT. (2.3 SQ. M.)
- 7. SHALL BE PAID FOR AS TEMPORARY INFORMATION SIGNING.

ALL DIMENSIONS ARE IN INCHES (MILLIMETERS) UNLESS OTHERWISE SHOWN.


USER NAME = footemj	DESIGNED -	REVISED - R. MIRS 09-15-97			ARTERIAL RO	ΠΔΠ	F.A.U.	SECTION	COUNTY	TOTAL	SHEET
	DRAWN -	REVISED - R. MIRS 12-11-97	STATE OF ILLINOIS				1372	FAU 1372 22 BJ	соок	50	47A
PLOT SCALE = 50.0000 / in.	CHECKED -	REVISED -T. RAMMACHER 02-02-99	DEPARTMENT OF TRANSPORTATION		INFORMATION	SIGN		TC-22	CONTRACT	NO.	
PLOT DATE = 3/4/2019	DATE -	REVISED - C. JUCIUS 01-31-07		SCALE: NONE	SHEET 1 OF 1 SHEETS	STA. TO STA.		ILLINOIS FED. AII	D PROJECT		

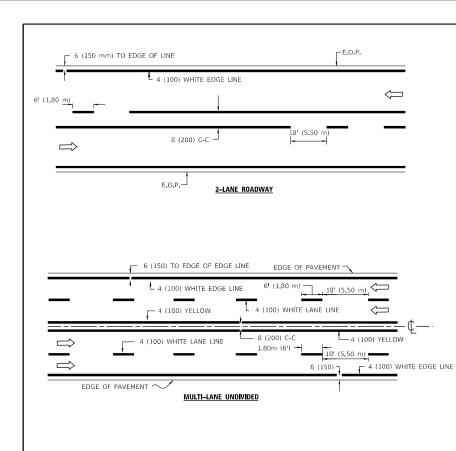


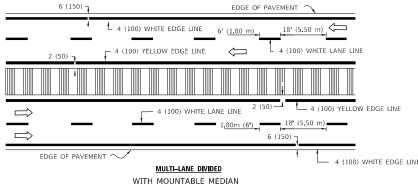

TYPICAL LANE AND EDGE LINE MARKING

NOTE: MEDIANS WITH BARRIER CURB DO NOT REQUIRE AN EDGE LINE

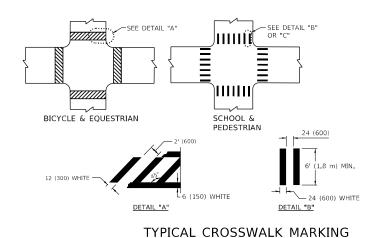


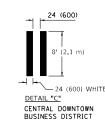


12 (300) DIAGONALS — (MINIMUM 5) 2-4 (100) @ 8 (200) C-C

- * FOR MEDIAN LENGTHS WHERE DIAGONAL SPACING CANNOT BE ATTAINED, USE 5 (FIVE) EQUALLY SPACED
- * DIAGONAL LINE SPACING: 20' (6.1 m) C-C

PAINTED MEDIANS

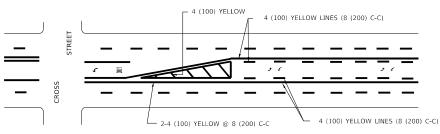


A MINIMUM OF TWO PAIRS OF TURN ARROWS SHALL BE USED, WHITE IN COLOR.

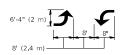

MEDIAN WITH TWO-WAY LEFT TURN LANE

TYPICAL PAINTED MEDIAN MARKING

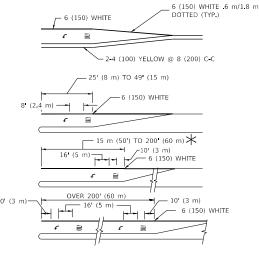


FULL SIZE LETTERS 8' (2.4 m) AND ARROWS SHALL BE USED. \uparrow AREA = 15.8 SQ. FT. (1.47 m²) **QNLY** AREA = 22.9 SQ. FT. (2.13 m²)

 $m{\star}$ Turn lanes in excess of 400' (120 m) in length May have an additional set of arrow - "only" installed midway between the other two sets of ARROW - "ONLY".

TYPICAL LEFT (OR RIGHT) TURN LANE

TYPICAL TURN LANE MARKING

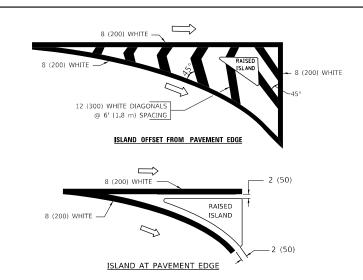

TYPICAL ISLAND MARKING

TYPE OF MARKING	WIDTH OF LINE	PATTERN	COLOR	SPACING / REMARKS
CENTERLINE ON 2 LANE PAVEMENT	4 (100)	SKIP-DASH	YELLOW	6' (1.80 m) LINE WITH 18' (5.50 m) SPACE
CENTERLINE ON MULTI-LANE UNDIVIDED PAVEMENT	2 @ 4 (100)	SOLID	YELLOW	8 (200) C-C
NO PASSING ZONE LINES: FOR ONE DIRECTION FOR BOTH DIRECTIONS	4 (100) 2 @ 4 (100)	SOLID SOLID	YELLOW YELLOW	8 (200) C-C
LANE LINES	4 (100) 5 (125) ON FREEWAYS	SKIP-DASH SKIP-DASH	WHITE WHITE	6' (1.80 m) LINE WITH 18' (5.50 m) SPACE
DOTTED LINES (EXTENSIONS OF CENTER, LANE OR TURN LANE MARKINGS)	SAME AS LINE BEING EXTENDED	SKIP-DASH	SAME AS LINE BEING EXTENDED	2' (600) LINE WITH 6' (1.8) SPACE
EDGE LINES	4 (100)	SOLID	YELLOW-LEFT WHITE-RIGHT	OUTLINE MOUNTABLE MEDIANS IN YELLOW; EDGE LINES ARE NOT USED NEXT TO BARRIER CURB
TURN LANE MARKINGS	6 (150) LINE; FULL SIZE LETTERS & SYMBOLS (8' (2.4 m))	SOLID	WHITE	SEE TYPICAL TURN LANE MARKING DETAIL
TWO WAY LEFT TURN MARKING	2 @ 4 (100) EACH DIRECTION	SKIP-DASH AND SOLID	YELLOW	6' (1.8 m) LINE WITH 18' (5.50 m) SPACE FOR SKIP-DASH; 8 (200) C-C BETWEEN SOLID LINE AND SKIP-DASH LINE
	8' (2.4 m) LEFT ARROW	IN PAIRS	WHITE	SEE TYPICAL TWO-WAY LEFT TURN MARKING DETAIL
CROSSWALK LINES A. DIAGONALS (BIKE & EQUESTRIAN) B. LONGITUDINAL BARS (SCHOOL & PEDESTRIAN)	12 (300) @ 45° 24 (600) @ 90°	SOLID SOLID	WHITE WHITE	2' (600) APART 2' (600) APART SEE TYPICAL CROSSWALK MARKING DETAILS.
STOP LINES	24 (600)	SOLID	WHITE	PLACE 4* (1.2 m) IN ADVANCE OF AND PARALLEL TO CROSSWALK, IF PRESENT, OTHERWISE, PLACE AT DESIRED STOPPING POINT. PARALLEL TO CROSSROAD CENTERLINE, WHERE POSSIBLE
PAINTED MEDIANS	2 @ 4 (100) WITH 12 (300) DIAGONALS @ 45°	SOLID	YELLOW: TWO WAY TRAFFIC WHITE: ONE WAY TRAFFIC	8 (200) C-C FOR THE DOUBLE LINE SEE TYPICAL PAINTED MEDIAN MARKING.
GORE MARKING AND CHANNELIZING LINES	8 (200) WITH 12 (300) DIAGONALS @ 45°	SOLID	WHITE	DIAGONALS: 20' (6.1 m) (LESS THAN 30 MPH (50 km/h))
RAILROAD CROSSING	24 (600) TRANSVERSE LINES; "RR" IS 6' (1.8 m) LETTERS; 16 (400) LINE FOR "X"	SOLID	WHITE	SEE STATE STANDARD 780001 AREA OF: "R":3.6 SO. FT. (0.33m ²) EACH "X":54.0 SO. FT. (5.0 m ²)

FOR FURTHER DETAILS ON PAVEMENT MARKING REFER TO STREET MARKING STANDARDS, PRINTED BY CITY OF CHICAGO, DEPARTMENT OF TRANSPORTATION, BUREAU OF TRAFFIC.


ALL DIMENSIONS ARE IN INCHES (MILLIMETERS) UNLESS OTHERWISE SHOWN.


JSER NAME = footemj DESIGNED -REVISED -T. RAMMACHER 12-07-00 DRAWN REVISED -K. ENG 02-28-12 CHECKED REVISED PLOT DATE = 3/4/2019 DATE REVISED

STATE OF ILLINOIS **DEPARTMENT OF TRANSPORTATION**

SECTION COUNTY CITY OF CHICAGO COUNTY SHEETS NO.

COOK 50 48 FAU 1372 22 BJ TYPICAL PAVEMENT MARKINGS CONTRACT NO. TC-24 SCALE: NONE SHEET 1 OF 3 SHEETS STA. TO STA.

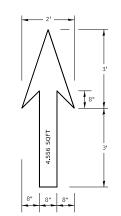


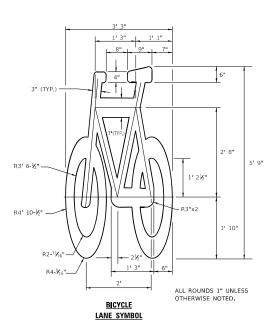

NOTE:

- 1. FOR BIKE LANE SYMBOLS ONLY,
 USE PRE-FORMED THERMOPLASTIC
 WITH A MINIMUM THICKNESS OF 90 MILS,
 MINIMUM SKID RESISTANCE VALUE OF 60 BPN,
 & A MINIMUM INDEX OF REFRACTION OF 1.50.
- 2. THE RESIDENT ENGINEER SHALL CONTACT MR. BEN GOMBERG AT 312-744-8093 AT LEAST ONE CALENDAR WEEK PRIOR TO INSTALLING BIKE LANE SYMBOLS.

TYPICAL BIKE LANE SYMBOLS
DRAWING #28

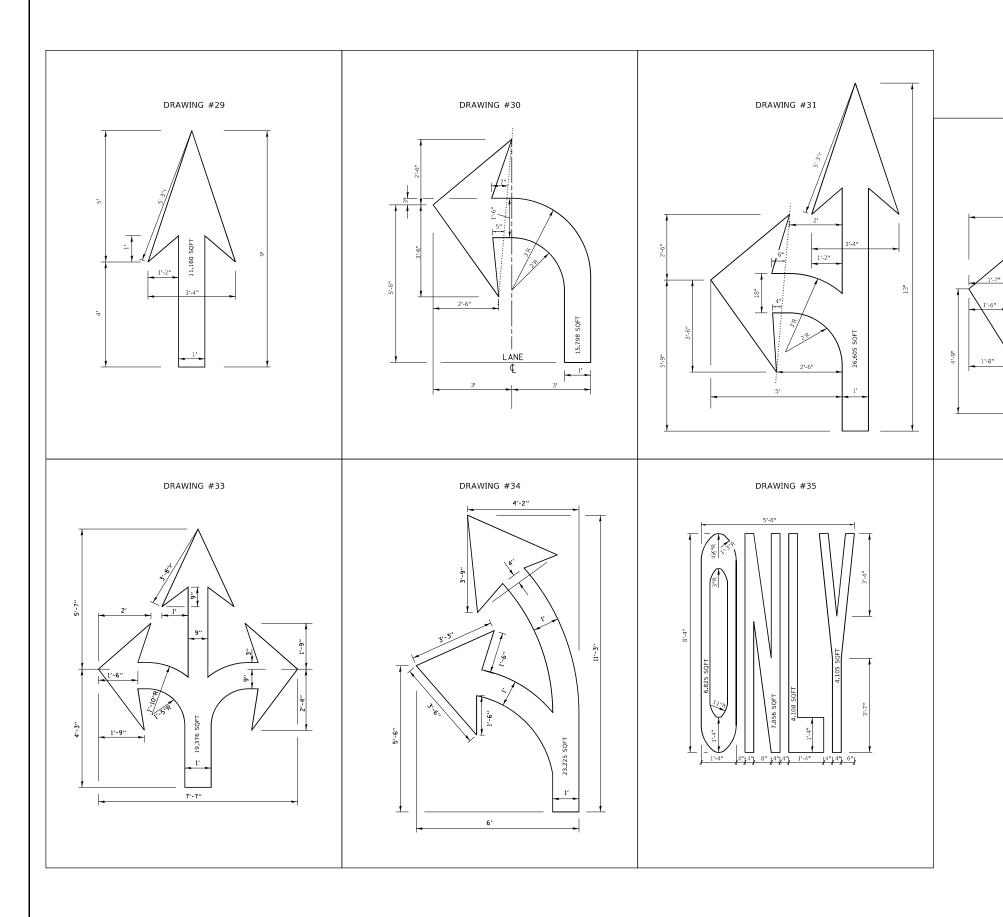

DRAWING #32

NOTE:

ALL MARKINGS SHALL BE SOLID WHITE UNLESS OTHERWISE NOTED IN THE PLANS

MODEL: Default

JSER NAME = footemj DESIGNED -REVISED -T. RAMMACHER 12-07-00 F.A.U. RTE. 1372 SECTION COUNTY CITY OF CHICAGO COOK 50 49 STATE OF ILLINOIS DRAWN REVISED FAU 1372 22 BJ TYPICAL PAVEMENT MARKINGS CHECKED REVISED **DEPARTMENT OF TRANSPORTATION** CONTRACT NO. TC-24 DATE REVISED SCALE: NONE SHEET 2 OF 3 SHEETS STA. TO STA. PLOT DATE = 3/4/2019

