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FOR INDEX OF SHEETS, SEE SHEET NO. 3 FOR SUMMARY OF QUANTITIES, SEE SHEET NO. 5-19

TRAFFIC DATA

I-57 TRAFFIC DATA 2023 ADT = 37.500 2043 ADT = 50,500

TOWNSHIPS

SPRING GARDEN EWING

DESIGN DESIGNATION : 4125(2029) INTERSTATE 62.64 (FD-20)

COORDINATE SYSTEM : ILLINOIS EAST ZONE

POSTED SPEED : 70 MPH

J.U.L.I.E. JOINT UTILITY LOCATION INFORMATION FOR EXCAVATION 1-800-892-0123 OR 811


PROJECT ENGINEER VALERIE ROLLA (618) 351-5214 **PROJECT DESIGNER**

STATE OF ILLINOIS DEPARTMENT OF TRANSPORTATION


PROPOSED **HIGHWAY PLANS**

FAI ROUTE 57 (I–57) SECTION D9 1-57 ADD LANE-5; (28-2)B-2;(28-1)B-2 **PROJECT NHPP-BR-HJK1(554) ADDITIONAL LANE AND BRIDGE REPLACEMENT** FRANKLIN / JEFFERSON COUNTY

C-99-084-21

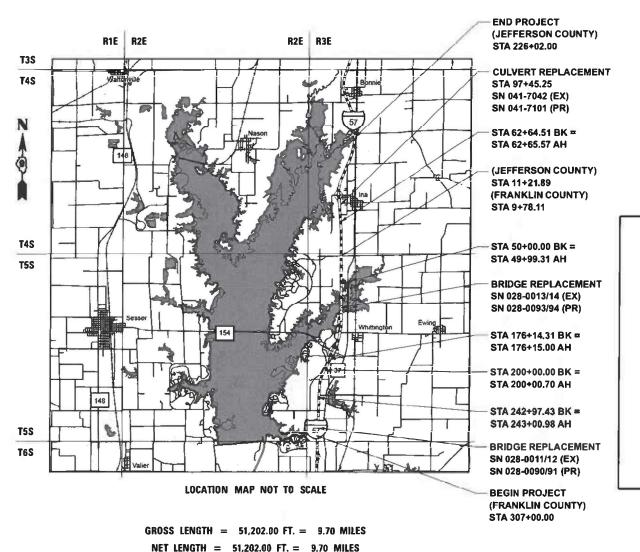

CONTRACT NO. 78884

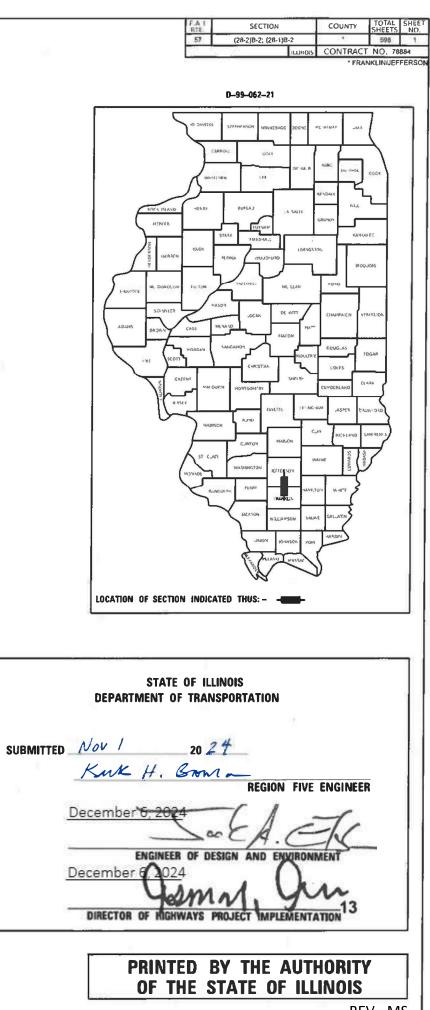

					[
					Pr	epared By	DISTRICT STUDIES & PLANS ENGINE
						amined By:	
							DISTRICT LAND ACQUISITION ENGINEE
							DISTRICT PROGRAM DEVELOPMENT EN
					E×	amined By:	DISTRICT OPERATIONS ENGINEER
					E×	amined By:	DISTRICT PROJECT IMPLEMENTATION ENG
					E×	amined By:	DISTRICT CONSTRUCTION ENGINEER
					E×	amined By:	DISTRICT MATERIALS ENGINEER
	USER NAME = johoos	DESIGNED -	REVISED -		 SIGNA	ATURE SHEET	FA.I SECTION COUNTY TO
HORNER	USER NAME = jahass PLOT SCALE = 0.19999833 '/m.	DESIGNED - DRAWN - CHECKED -	REVISED - REVISED - REVISED -	STATE OF ILLING DEPARTMENT OF TRANS	SIGNA SCALE: NTS SHEET 1 OF	ATURE SHEET	FA.1 RTE SECTION COUNTY TO SHE 57 (28-2)8-2; (28-1)8-2 * 55 CONTRACT NO TO STA.

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390-510	CROSS SECTIONS - FRANKLIN COUNTY
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HIGHWAY STANDARDS

000001-08	STANDARD SYMBOLS, ABBREVIATIONS AND PATTERNS		
001001-02	AREAS OF REINFORCEMENT BARS		
001006	DECIMAL OF AN INCH AND OF A FOOT		
280001-07	TEMPORARY EROSION CONTROL SYSTEMS		
420001 - 10	PAVEMENT JOINTS		
420101-07	24' JOINTED PCC PAVEMENT		
420106-06	36' JOINTED PCC PAVEMENT		
420401 - 13	PAVEMENT CONNECTOR (PCC) FOR BRIDGE APPROACH SLAB		
482001 - 02	HMA SHOULDER ADJACENT TO FLEXIBLE PAVEMENT		
483001-05	PCC SHOULDER		
515001 - 04	NAME PLATE FOR BRIDGES		
542301 - 03	PRECAST REINFORCED CONCRETE FLARED END SECTION		
601001-05	PIPE UNDERDRAINS		
601101-02	CONCRETE HEADWALL FOR PIPE UNDERDRAIN		
602106-02	DRAINAGE STRUCTURES, TYPES 4&5		
602401-07	PRECAST MANHOLE TYPE A 4 FT DIAMETER		
602406 - 11	PRECAST MANHOLE TYPE A 6 FT DIAMETER		
602416 - 09	PRECAST MANHOLE TYPE A 8 FT DIAMETER		
602701 - 02	MANHOLE STEPS		
604001 - 05	FRAME & LIDS TYPE 1		
604081-04	FRAME AND GRATES, TYPE 22		
630001 - 12	STEEL PLATE BEAM GUARDRAIL		
630301 - 09	SHOULDER WIDENING FOR TYPE 1 (SPECIAL) GUARDRAIL TERMINALS	5	
631026-06	TRAFFIC BARRIER TERMINAL, TYPE 5		
631031-17	TRAFFIC BARRIER TERMINAL, TYPE 6		
631033 - 08	TRAFFIC BARRIER TERMINAL, TYPE 6B		
635001 - 02	DELINEATORS		
637006-04	CONCRETE BARRIER DOUBLE FACE, 44 IN HEIGHT		
642001 - 03	SHOULDER RUMBLE STRIPS, 16 IN.		
642006-01	SHOULDER RUMBLE STRIPS, 8 IN.		
701101-05	OFF-ROAD OPERATIONS, MULTILANE, 15' TO 24' FROM PAVEMENT ED	GE	
701106-02	OFF-ROAD OPERATIONS, MULTILANE, MORE THAN 15' AWAY		
701400-09	APPROACH TO LANE CLOSURE, FREEWAY/EXPRESSWAY		
701401-12	LANE CLOSURE, FREEWAY/EXPRESSWAY		
701402-12	LANE CLOSURE, FREEWAY/EXPRESSWAY, WITH BARRIER		
701406-13	LANE CLOSURE, FREEWAY/EXPRESSWAY, DAY OPERATIONS ONLY		
701411-09	LANE CLOSURE, MULTILANE, AT AT ENTRANCE OR EXIT RAMP, FOR S		
701426-09	LANE CLOSURE, MULTILANE, INTERMITTENT OR MOVING OPERATIONS	5, FOR SPEEL	JS ≥ 45 MPH
701428-01 701446-10	TRAFFIC CONTROL, SETUP AND REMOVAL, FREEWAY/EXPRESSWAY		
701446-10	TWO LANE CLOSURE, FREEWAY/EXPRESSWAY		
701456-05	PARTIAL EXIT RAMP CLOSURE FREEWAY/EXPRESSWAY		
704001-08	TRAFFIC CONTROL DEVICES		
720001-01	TEMPORARY CONCRETE BARRIER		
720001-01	SIGN PANEL MOUNTING DETAILS		
720011-01	SIGN PANEL ERECTION DETAILS		
725001-01	METAL POSTS FOR SIGNS, MARKERS AND DELINEATORS		
	OBJECT AND TERMINAL MARKERS	100701.05	
731001-01	BASE FOR TELESCOPING STEEL SIGN SUPPORT	420701-03	PAVEMENT WELDED WIRE REINFORCEN
780001-05	TYPICAL PAVEMENT MARKINGS	442101-09	CLASS B PATCHES
781001-04	TYPICAL APPLICATIONS RAISED REFLECTIVE PAVEMENT MARKERS	728001 - 01	TELESCOPING STEEL SIGN SUPPORT
782006-01	GUARDRAIL AND BARRIER WALL REFLECTOR MOUNTING DETAILS	731001-01	BASE FOR TELESCOPING STEEL SIGN S

1. FACTORS USED FOR ESTIMATING PLAN QUANTITIES ARE AS FOLLOWS AND SHALL NOT BE USED FOR THE BASIS OF FINAL QUANTITIES:

ALL HOT-MIX ASPHALT

ALL AGGREGATE

RIPRAP

- 2. THE ALGEBRAIC DIFFERENCE BETWEEN THE PAVEMENT AND SHOULDER SLOPES SHALL NOT EXCEED 8%. THE SHOULDER ON THE OUTSIDE OF THE SUPERELEVATED CURVES SHALL BE FLATTENED ACCORDINGLY.
- 3. THE QUANTITY OF SHORT TERM PAVEMENT MARKING SHOWN IN THE PLANS IS BASED ON ONE APPLICATION OF THE SURFACE COURSE.
- PAVEMENT BEING CONSTRUCTED.
- 5. WHEN SHOULDER RESURFACING OF 6 FT OR LESS IS ALLOWED TO BE PLACED SIMULTANEOUSLY WITH THE ADJACENT TRAFFIC LANE, THE MAINLINE QUALITY MANAGEMENT PROGRAM WILL BE ENFORCED FOR THE MAINLINE AND SHOULDERS.
- 7. LONGITUDINAL JOINT SEALANT SHALL BE PLACED UNDER THE HMA SURFACE COURSE

(http://rend.uslakes.info/Level/) OR (http://www.mvs-wc.usace.army.mil)

COMMITMENTS

1. TREE REMOVAL WILL BE ALLOWED BETWEEN NOVEMBER 1ST AND MARCH 31ST

MTD CROSSING RESTRICTION TABLE

TYPE 6B FACE, 44 IN HEIGHT 16 IN.			SN & CENTERLINE STATION ROUTE (I-57)	EXISTING FILL HEIGHT OVER BOX CULVERT	MAXIMUM GROSS WEIGTH RESTRICTIONS	MTD CROSSING RESTRICTIONS
3 IN.				FOOT	TONS	
ILANE, 15' TO 24' FROM PAVEMENT E	DGE		FRANKLIN COUNTY			
ILANE, MORE THAN 15' AWAY			SN 028-7113 (STA. 51+36)	7'	40	MTD UNLOADED *
, FREEWAY/EXPRESSWAY			SN - (STA. 93+20)	10'	40	MTD UNLOADED *
PRESSWAY			SN 028-0013 (STA. 102+50)	BRIDGE - N/A	40	MTD UNLOADED *
PRESSWAY, WITH BARRIER			SN 028-0014 (STA. 102+50)	BRIDGE - N/A	40	MTD UNLOADED *
PRESSWAY, DAY OPERATIONS ONLY	CDEEDC . 45	MOL	SN 028-7112 (STA. 131+10)	10'	40	MTD UNLOADED *
AT AT ENTRANCE OR EXIT RAMP, FOR NTERMITTENT OR MOVING OPERATION			SN 028-2006 (STA. 151+60)	11'	40	MTD UNLOADED *
D REMOVAL, FREEWAY/EXPRESSWAY	IS, FUR SPEEL		SN 028-7116 (STA. 172+20) (IL 154 RAMP A)	18'	40	MTD UNLOADED *
FREEWAY/EXPRESSWAY			SN 028-0011 (STA. 304+25)	BRIDGE - N/A	40	MTD UNLOADED *
Theeway extress war			SN 028-0012 (STA. 305+25)	BRIDGE - N/A	40	MTD UNLOADED *
IER						
LS C			JEFFERSON COUNTY	4.5'	40	MTD UNLOADED *
-> RKERS AND DELINEATORS			SN 041-7021 (STA. 21+85)	2.5	40	MTD UNLOADED *
ERS			SN 041-7022 (STA. 50+87) SN 041-7023 (STA. 76+35)	4.5	40	MTD UNLOADED *
L SIGN SUPPORT	420701-03	PAVEMENT WELDED WIRE REINFORCEMENT	SN 041-7023 (STA. 76+53) SN 041-7024 (STA. 97+45)	2.5	40	MTD UNLOADED *
5	442101-09	CLASS B PATCHES	SN 041-7024 (STA: 97+43) SN 041-7026 (STA: 169+00)	4'	40	MTD UNLOADED *
D REFLECTIVE PAVEMENT MARKERS	728001-01	TELESCOPING STEEL SIGN SUPPORT	SN 041-7026 (STA: 169+00) SN 041-7027 (STA: 209+94)	8'	0	MTD UNLOADED *
LL REFLECTOR MOUNTING DETAILS	731001-01	BASE FOR TELESCOPING STEEL SIGN SUPPORT	SN 041-7027 (STA. 209+94)	8.	0	MID UNLOADED *

//PW01									
	USER NAME = bctimmermann	DESIGNED -	REVISED -			INDEX OF SHEETS, GENERAL NO			
		DRAWN -	REVISED -	STATE OF ILLINOIS					
	PLOT SCALE = 0.16666633 ' / in.	CHECKED -	REVISED -	DEPARTMENT OF TRANSPORTATION	MIDC	ROSSING T	ABLE (2 HIC	
žΞ	WWW. HORNERSHIFRIN .COM	PLOT DATE = 11/18/2024	DATE -	REVISED -		SCALE: NTS	SHEET 1 C)F 1 S	HEETS

2.016 TONS/CU. YD.

2.05 TONS/CU. YD.

1.50 TONS/ CU. YD.

4. AT ALL LOCATIONS WHERE THE PROPOSED HOT-MIX ASPHALT OR CONCRETE PAVEMENT JOINS AN EXISTING HOT-MIX ASPHALT OR CONCRETE PAVEMENT, A FULL DEPTH SAWED JOINT SHALL BE CONSTRUCTED. THE COST OF THIS JOINT WILL BE INCLUDED IN THE COST OF THE TYPE OF DAVEMENT REMOTE CONSTRUCTED.

6. EXISTING PIPE UNDERDRAIN OUTLETS IN THE FORESLOPES SHALL BE PRESERVED AND PROTECTED DURING CONSTRUCTION. ANY DAMAGE TO AN UNDERDRAIN OUTLET RESULTING FROM CONSTRUCTION ACTIVITY SHALL BE REPAIRED AT THE CONTRACTOR'S EXPENSE.

8. CONNECTING OF NEW OR EXISTING STORM SEWER TO NEW OR EXISTING INLETS OR MANHOLES SHALL BE MADE IN A MANNER WHICH RESULTS IN A NEAT AND WATERTIGHT JOINT. WHEN PLACED THROUGH THE WALL OF AN INLET OR MANHOLE, STORM SEWER PIPE SHALL BE PLACED OR CUT FLUSH WITH THE FACE OF THE WALL AND DRESSED WITH MORTAR TO PROVIDE A SMOOTH ROUNDED OR BEVELED EDGE. THIS WORK WILL NOT BE PAID FOR SEPARATELY, BUT SHALL BE CONSIDERED AS INCLUDED IN THE CONTRACT UNIT PRICES OF THE STORM SEWERS OR STRUCTURES INVOLVED.

THE CONTRACTOR SHALL CHECK THE CURRENT REND LAKE WATER ELEVATION BEFORE ANY DRAINAGE STRUCTURE INSTALLATIONS AND EXISTING CULVERT CONNECTIONS. CURRENT REND LAKE WATER ELEVATIONS CAN BE FOUND AT THE FOLLOWING WEBSITES:

NOTES, COMMITTMENTS,	F.A.I RTE	SECTION	COUNTY	TOTAL SHEETS	SHEET NO.
IGHWAY STANDARDS		(28-2)B-2; (28-1)B-2	*	598	3
			CONTRACT	NO. 788	84
TS STA. TO STA.		ILLINOIS FED. A	ID PROJECT		

MIXTURE REQUIREMENTS


LOCATIONS	HOT MIX ASPHALT SURFACE COURSE / HOT MIX ASPHALT FULL-DEPTH PAVEMENT 14 1/4" AND 16 3/4" (TOP LIFT), RAMPS
MIXTURE USES(S):	POLYMERIZED STONE MATRIX ASPHALT, SURFACE, MIX E, N80
AC/PG:	SBS PG 76-22
ABR% (MAX):	SEE SPECIAL PROVISION
DESIGN AIR VOIDS:	4.0%, 80 GYRATION DESIGN
MIXTURE COMPOSITION: (GRADATION MIXTURE)	IL-12.5 MM SMA
FRICTION AGGREGATE	MIX E
MIXTURE WEIGHT:	112 LBS/ SQ YD/ IN
QUALITY MANAGEMENT PROGRAM:	PFP - ALL PAY ITEMS
SUBLOT SIZE:	1,000 TONS
MATERIAL TRANSFER DEVICE (REQUIRED?):	YES

LOCATIONS	HOT-MIX ASPHALT SHOULDERS 10" (TOP LIFT) / HOT-MIX ASPHALT SHOULDERS (RAMPS) / HOT-MIX ASPHALT SHOULDER REPAIR
MIXTURE USES(S):	HOT-MIX ASPHALT SURFACE COURSE, MIX C, N70
AC/PG:	PG 64-22
ABR% (MAX):	SEE SPECIAL PROVISION
DESIGN AIR VOIDS:	4.0%, 70 GYRATION DESIGN
MIXTURE COMPOSITION: (GRADATION MIXTURE)	IL-9.5 MM
FRICTION AGGREGATE	C SURFACE
MIXTURE WEIGHT:	112 LBS/ SQ YD/ IN
QUALITY MANAGEMENT PROGRAM:	PFP - MAINLINE SHOULDERS QC/QA - HMA SHOULDES (RAMPS) & HMA SHOULDER REPAIR
SUBLOT SIZE:	PFP - 1,000 TONS QC/QA - 3,000 TONS
MATERIAL TRANSFER DEVICE (REQUIRED?):	YES - MAINLINE NO - HMA SHOULDES (RAMPS) & HMA SHOULDER REPAIR


LOCATIONS	HOT-MIX ASPHALT EDGELINE REPAIR / EXISTING LANE REPAIR / HOT-MIX ASPHALT SHOULDERS 10" (TOP LIFT PRE-STAGE) / HOT-MIX ASPHALT SHOULDERS (PRE-STAGE)
MIXTURE USES(S):	POLYMERIZED HOT-MIX ASPHALT SURFACE COURSE, MIX E, N90
AC/PG:	PG 76-22
ABR% (MAX):	SEE SPECIAL PROVISION
DESIGN AIR VOIDS:	4.0%, 90 GYRATION DESIGN
MIXTURE COMPOSITION: (GRADATION MIXTURE)	IL-9.5 MM
FRICTION AGGREGATE	E SURFACE
MIXTURE WEIGHT:	112 LBS/ SQ YD/ IN
QUALITY MANAGEMENT PROGRAM:	QC/QA
SUBLOT SIZE:	3,000 - TONS
MATERIAL TRANSFER DEVICE (REQUIRED?):	NO

LOCATIONS	HOT MIX ASPHA BINDER) / HOT
MIXTURE USES(S):	POLYMERIZED A
AC/PG:	SBS PG 76-22
ABR% (MAX):	SEE SPECIAL PR
DESIGN AIR VOIDS:	4.0%, 90 GYRAT
MIXTURE COMPOSITION: (GRADATION MIXTURE)	IL-19.0 MM
FRICTION AGGREGATE	NONE
MIXTURE WEIGHT:	112 LBS/ SQ YD
QUALITY MANAGEMENT PROGRAM:	PFP - HOT MIX A QC/QA - HOT M
SUBLOT SIZE:	PFP - 1,000 TON QC/QA - 3,000 T
MATERIAL TRANSFER DEVICE (REQUIRED?):	YES - HOT MIX A

LOCATIONS	HOT MIX ASPHA SHOULDERS 10"
MIXTURE USES(S):	HOT-MIX ASPHAI
AC/PG:	PG 64-22
ABR% (MAX):	SEE SPECIAL PRO
DESIGN AIR VOIDS:	4.0%, 90 GYRATI
MIXTURE COMPOSITION: (GRADATION MIXTURE)	IL-19.0 MM
FRICTION AGGREGATE	NONE
MIXTURE WEIGHT:	112 LBS/ SQ YD/
QUALITY MANAGEMENT PROGRAM:	PFP - HOT MIX A QCP - HOT MIX A QC/QA - HOT MI
SUBLOT SIZE:	PFP / QCP - 1,00 QC/QA - 3,000 T
MATERIAL TRANSFER DEVICE (REQUIRED?):	YES - HOT MIX A NO - HOT MIX A NO - HOT MIX A

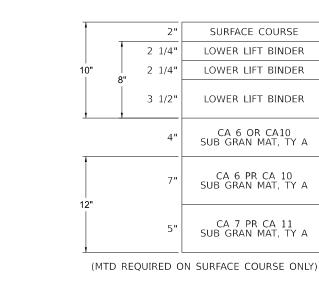

HMA INSIDE SHOULDER, 10"

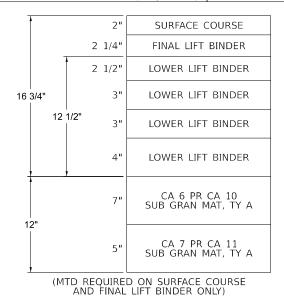

HMA PAVEMENT FULL DEPTH 16 3/4"

(MTD REQUIRED ON ALL LIFTS)

2"

2 1/4'

2 3/4'

3 1/4'

4"

5'

10 "

14 1/4"

SURFACE COURSE

FINAL LIFT BINDER

LOWER LIFT BINDER

LOWER LIFT BINDER

LOWER LIFT BINDER

CA 6 PR CA 10 SUB GRAN MAT, TY A

CA 7 PR CA 11 SUB GRAN MAT, TY A

DESIGNED -REVISED JSER NAME = jahaas HORNER HORNEF STATE OF ILLINOIS DRAWN REVISED DEPARTMENT OF TRANSPORTATION LOT SCALE = 0.16666633 '/ in. CHECKED -REVISED SCALE: NTS SHEET 1 OF 1 SHEETS STA. LOT DATE = 12/12/2024 DATE REVISED

ALT FULL-DEPTH PAVEMENT 14 1/4" AND 16 3/4" (FINAL LIFT OF	
MIX ASPHALT BINDER COURSE	
ASPHALT BINDER COURSE, N90, IL-19.0	

ROVISION FION DESIGN

D/ IN

ASPHALT FULL-DEPTH PAVEMENT 14 1/4" /IX ASPHALT FULL-DEPTH PAVEMENT 16 3/4"

NS TONS

ASPHALT FULL-DEPTH PAVEMENT 14 1/4" ASPHALT FULL-DEPTH PAVEMENT 16 3/4"


ALT FULL-DEPTH PAVEMENT 14 1/4" AND 16 3/4" / HOT MIX ASPHALT)" (LOWER LIFTS) AND STABILIZED SUBBASE 4" ALT BINDER, N90, IL-19.0

ROVISION TION DESIGN

D/ IN ASPHALT FULL-DEPTH PAVEMENT 14 1/4" & STABILZED SUBBASE 4" (ASPHALT SHOULDERS 10" 4IX ASPHALT FULL DEPTH PAVEMENT 16 3/4" 200 TONS TONS ASPHALT FULL-DEPTH PAVEMENT 14 1/4" & STABILZED SUBBASE 4" ASPHALT FULL-DEPTH PAVEMENT 16 3/4" ASPHALT SHOULDERS 10"



4 1/4" MILL AND OVERLAY

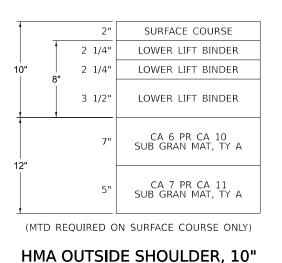

 MIXTURE REQUIREMENTS
 F.A. I RTE.
 SECTION
 COUNTY
 TOTAL SHEETS
 SHEETS NO.

 57
 (28-2)B-2; (28-1)B-2
 *
 348
 4

 ET 1
 OF 1
 SHEETS
 STA.
 TO STA.
 ILLINOIS
 FED. AID PROJECT

	SUMMARY OF QUANTITIES		80% 20% S	FED TATE			FRANKLIN COUNT FAI 57	CONSTRUC	CTION CODE	J	EFFERSON COUNT FAI 57	Y
CODE NO	ІТЕМ	UNIT	TOTAL QTY 1, 2, 3, 4 &	TOTAL QTY 1, 2, 3, 4 &	ROADWAY (1)	ROADWAY ALTERNATE A	INTERSTATE ROADWAY ALTERNATE B	BRIDGE (2) SN 028-0090/91	BRIDGE (3) SN 028-0093/94	ROADWAY (4)	INTERSTATE 'ROADWAY ALTERNATE A	ROADWAY ALTERNATE B
			ALT A	ALT B	0001	0001	0001	0010	0010	0001	0001	0001
20100110	TREE REMOVAL (6 TO 15 UNITS DIAMETER)	UNIT	6	6	6							
20100210	TREE REMOVAL (OVER 15 UNITS DIAMETER)	UNIT	18	18	18							
20100500	TREE REMOVAL, ACRES	ACRE	4.25	4.25	2.75					1.5		
20200100	EARTH EXCAVATION	CUYD	86090	86090	54120					31970		
20201200	REMOVAL AND DISPOSAL OF UNSUITABLE MATERIAL	CUYD	296	296						296		
20700220	POROUS GRANULAR EMBANKMENT	CUYD	1010	1010						1010		
20700220			1010	1010						1010		
20900110	POROUS GRANULAR BACKFILL	CUYD	10437	10437	5240					5197		
25000310	SEEDING, CLASS 4	ACRE	5	5	5							
20000010		AGRE										
25000350	SEEDING, CLASS 7	ACRE	5	5	5							
05000400			449	449	449							
25000400	NITROGEN FERTILIZER NUTRIENT	POUND	449	449	449							
25000500	PHOSPHORUS FERTILIZER NUTRIENT	POUND	449	449	449							
25000600	POTASSIUM FERTILIZER NUTRIENT	POUND	449	449	449							
25000700	AGRICULTURAL GROUND LIMESTONE	TON	10	10	10							
25100115	MULCH, METHOD 2	ACRE	5	5	5							

JSER NAME = jahaas DESIGNED -REVISED -SUMMARY OF QU STATE OF ILLINOIS DEPARTMENT OF TRANSPORTATION DRAWN -REVISED -PLOT SCALE = 0.16666633 '/ in. CHECKED -REVISED -PLOT DATE = 10/16/2024 DATE REVISED -SCALE: NTS SHEET 1 OF 15 SHEETS -

UANTITIES			F.A. I RTE.	SECTION		COUNTY	TOTAL SHEETS	SHEET NO.	
				57	(28-2)B-2; (28-1)B-2	*	598	5
							CONTRACT	NO. 788	84
TS	STA.	TO STA.			ILLING	DIS FED. A	D PROJECT		

	SUMMARY OF QUAN	TITIES	80% 20% S	FED STATE			FRANKLIN COUNT FAI 57	CONST Y
CODE NO	ITEM	UNIT	TOTAL QTY	TOTAL QTY	ROADWAY (1)	ROADWAY	INTERSTATE ROADWAY	BRIDGE (2)
CODE NO		UNIT	1, 2, 3, 4 & ALT A	1, 2, 3, 4 & ALT B	0001	ALTERNATE A 0001	ALTERNATE B 0001	SN 028-0090/9
28000250	TEMPORARY EROSION CONTROL SEEDING	POUND	498	498	498			
28000400	PERIMETER EROSION BARRIER	FOOT	1876	1876	1876			
28000500	INLET AND PIPE PROTECTION	EACH	148	148	83			
28100107	STONE RIPRAP, CLASS A4	SQ YD	7994	7994				3123
28100109	STONE RIPRAP, CLASS A5	SQ YD	128	128				
20100103			120	120				
28200200	FILTER FABRIC	SQ YD	8122	8122				3123
31100300	SUBBASE GRANULAR MATERIAL, TYPE A 4"	SQ YD	225399			129939		
31100910	SUBBASE GRANULAR MATERIAL, TYPE A 12"	SQ YD	401216	401216	237575			
31200100	STABILIZED SUBBASE 4"	SQ YD		381750			223215	
40600275	BITUMINOUS MATERIALS (PRIME COAT)	POUND	875328			513188		
40600372	LONGITUDINAL JOINT SEALANT, HALF-WIDTH	FOOT	218029	187960		127760	106396	
40603240	POLYMERIZED HOT-MIX ASPHALT BINDER COURSE, IL-19.0, N90	TON	32624	32624	18221			
40604174	POLYMERIZED HOT-MIX ASPHALT BINDER COURSE, IL-9.5, MIX "E", N90	TON	6341	6341	5040			
	I SETWERKED TO THIR ACTIVET DINDER COURSE, IE-3.3, MIX E, 1930				5049			

	USER NAME = jahaas	DESIGNED -	REVISED -			SUMMARY OF QUANTITIES		F.A. I RTE	SECTION	COUNTY	TOTAL	SHEET
A HURNER		DRAWN -	REVISED -	STATE OF ILLINOIS				57	(28-2)B-2; (28-1)B-2	*	598	6
	PLOT SCALE = 0.16666633 ' / in.	CHECKED -	REVISED -	DEPARTMENT OF TRANSPORTATION					()(()	CONTRAC		4
WWW. HORNERSHIFRIN .COM	PLOT DATE = 10/16/2024	DATE -	REVISED -		SCALE: NTS	SHEET 2 OF 15 SHEETS STA.	TO STA.		ILLINOIS FED. A	AID PROJECT		

₩ FICE W

TRUC	TION CODE			
		J	EFFERSON COUNT FAI 57	Υ
			INTERSTATE	
(2)	BRIDGE (3)	ROADWAY (4)	'ROADWAY	ROADWAY
0/91	SN 028-0093/94		ALTERNATE A	ALTERNATE B
	0010	0001	0001	0001
		65		
	4871			
		128		
	4871	128		
			95460	
		163641		
				158535
			362140	
			90269	81564
		14403		
		1292		

	SUMMARY OF QUANTITIES	5	80% 20% S	FED TATE			FRANKLIN COUNT FAI 57	CONSTI Y
			TOTAL QTY	TOTAL QTY			INTERSTATE	
CODE NO	ІТЕМ	UNIT	1, 2, 3, 4 & ALT A	1, 2, 3, 4 & ALT B	ROADWAY (1)	ROADWAY ALTERNATE A 0001	ROADWAY ALTERNATE B 0001	BRIDGE (2) SN 028-0090/9 0010
40605034	POLYMERIZED HOT-MIX ASPHALT SURFACE COURSE, STONE MATRIX ASPHALT, 12.5, MIX "E", N80	TON	31308	31308	18000			
40600290	BITUMINOUS MATERIALS (TACK COAT)	POUND	305907	264678		177928	156939	
40701966	HOT-MIX ASPHALT PAVEMENT (FULL-DEPTH), 14 1/4"	SQ YD	135240			77964		
40702016	HOT-MIX ASPHALT PAVEMENT (FULL-DEPTH), 16 3/4"	SQ YD	20089			14289		
42000060	WELDED WIRE REINFORCEMENT	SQ YD	1279	1279	1279			
42000080	PAVEMENT CONNECTOR (PCC) FOR BRIDGE APPROACH SLAB	SQ YD	1395	1395	1395			
42000511	PORTLAND CEMENT CONCRETE PAVEMENT 10 1/2" (JOINTED)	SQ YD		135240			77964	
42000531	PORTLAND CEMENT CONCRETE PAVEMENT 11 1/2" (JOINTED)	SQ YD	215	20089			14289	
42001300	PROTECTIVE COAT	SQ YD	61190	389038		37569	228085	
42400200	PORTLAND CEMENT CONCRETE SIDEWALK 5 INCH	SQ FT	5052	5052	5052			
44000100	PAVEMENT REMOVAL	SQ YD	21836	21836	15585			
44000157	HOT-MIX ASPHALT SURFACE REMOVAL, 2"	SQ YD	186952	186952	122712			
44000166	HOT-MIX ASPHALT SURFACE REMOVAL, 4 1/4"	SQ YD	258698	258698	144604			
44000600		80 FT	2444	0444	2444			
44000600	SIDEWALK REMOVAL	SQ FT	3441	3441	3441			

	USER NAME = jahaas	DESIGNED -	REVISED -			SUMMARY	OF QUA	NTITIES		F.A. I RTF	SECTION	COUNTY	TOTAL	SHEET S NO.
		DRAWN -	REVISED -	STATE OF ILLINOIS						57	(28-2)B-2; (28-1)B-2	*	598	7
♥SHIFRIN	PLOT SCALE = 0.16666633 ' / in.	CHECKED -	REVISED -	DEPARTMENT OF TRANSPORTATION								CONTRAC	CT NO. 788	884
WWW. HORNERSHIFRIN .COM	PLOT DATE = 10/16/2024	DATE -	REVISED -		SCALE: NTS	SHEET 3 OF 15	SHEETS	STA.	TO STA.		ILLINOIS FEE	AID PROJECT		

TRUC	TION CODE			
		J	EFFERSON COUNT FAI 57	Y
(2)	BRIDGE (3)	ROADWAY (4)	INTERSTATE 'ROADWAY	ROADWAY
0/91	SN 028-0093/94	ROADWAT (4)	ALTERNATE A	ALTERNATE B
0.01	0010	0001	0001	0001
		10000		
		13308		
			127979	107739
			127373	101700
			57276	
			5800	
				57276
			215	5800
			23621	160953
			23021	100900
		6251		
		64240		
		07240		
		114094		

	SUMMARY OF QUANTITIES)	80% 20% S	FED TATE			FRANKLIN COUNT FAI 57		CTION CODE	JI	EFFERSON COUNTY FAI 57	[
CODE NO	ІТЕМ	UNIT	TOTAL QTY 1, 2, 3, 4 &	TOTAL QTY 1, 2, 3, 4 &	ROADWAY (1)	ROADWAY	INTERSTATE ROADWAY	BRIDGE (2)	BRIDGE (3)	ROADWAY (4)	INTERSTATE 'ROADWAY	ROADWAY
		•••••	ALT A	ALT B	0001	ALTERNATE A 0001	ALTERNATE B 0001	SN 028-0090/91 0010	SN 028-0093/94 0010	0001	ALTERNATE A 0001	ALTERNATE B 0001
44001980	CONCRETE BARRIER REMOVAL	FOOT	169	169	169							
44004250	PAVED SHOULDER REMOVAL	SQ YD	72198	72198	45444					26754		
44200000			10	10	10							
44200966	CLASS B PATCHES, TYPE I, 10 INCH	SQ YD	19	19	19							
44200970	CLASS B PATCHES, TYPE II, 10 INCH	SQ YD	1149	1149	1149							
44200974	CLASS B PATCHES, TYPE III, 10 INCH	SQ YD	111	111	111							
44200976	CLASS B PATCHES, TYPE IV, 10 INCH	SQ YD	407	407	407							
44201299	DOWEL BARS 11/2"	EACH	3081	3081	3081							
44213200	SAW CUTS	FOOT	7742	7742	7742							
44213204	TIE BARS 3/4"	EACH	109	109	109							
48101500	AGGREGATE SHOULDERS, TYPE B 6"	SQ YD	3726	3726	2862					864		
48203037	HOT-MIX ASPHALT SHOULDERS, 10"	SQ YD	233708	8510		135832	6091				97876	2419
48203100	HOT-MIX ASPHALT SHOULDERS	TON	12942	12942	7533					5409		
48300500	PORTLAND CEMENT CONCRETE SHOULDERS 10"	SQ YD	8911	8911	6997					1914		
48300510	PORTLAND CEMENT CONCRETE SHOULDERS 10 1/2"	SQ YD		225399			129939					95460
48300610	PORTLAND CEMENT CONCRETE SHOULDERS 111/2"	SQ YD	90	8310			5893				90	2417

	USER NAME = jahaas	DESIGNED -	REVISED -			SUMMARY OF QUANTITIES	F.A. I RTE	SECTION	COUNTY	TOTAL S	HEET
4 TURNER		DRAWN -	REVISED -	STATE OF ILLINOIS			57	(28-2)B-2; (28-1)B-2	*	598	8
♥SHIFRIN	PLOT SCALE = 0.16666633 ' / in.	CHECKED -	REVISED -	DEPARTMENT OF TRANSPORTATION					CONTRACT	NO. 78884	
WWW. HORNERSHIFRIN .COM	PLOT DATE = 10/16/2024	DATE -	REVISED -		SCALE: NTS	SHEET 4 OF 15 SHEETS STA. TO STA.		ILLINOIS FED. A	ID PROJECT	-	

	SUMMARY OF QUANTITIES	S	80% 20% S	FED			FRANKLIN COUNT FAI 57		CTION CODE	J	EFFERSON COUNT FAI 57	Y
			1	1								
CODE NO	ITEM	UNIT	TOTAL QTY 1, 2, 3, 4 &	TOTAL QTY 1, 2, 3, 4 &	ROADWAY (1)	ROADWAY	INTERSTATE ROADWAY	BRIDGE (2)	BRIDGE (3)	ROADWAY (4)	INTERSTATE 'ROADWAY	ROADWAY
CODENO			ALT A	ALT B	0001	ALTERNATE A 0001	ALTERNATE B 0001	SN 028-0090/91 0010	SN 028-0093/94 0010	0001	ALTERNATE A 0001	ALTERNATE B 0001
50100300	REMOVAL OF EXISTING STRUCTURES NO. 1	EACH	1	1				1				
50100400	REMOVAL OF EXISTING STRUCTURES NO. 2	EACH	1	1				1				
50100500	REMOVAL OF EXISTING STRUCTURES NO. 3	EACH	1	1					1			
50100600	REMOVAL OF EXISTING STRUCTURES NO. 4	EACH	1	1					1			
50100700	REMOVAL OF EXISTING STRUCTURES NO. 5	EACH	1	1						1		
50104400	CONCRETE HEADWALL REMOVAL	EACH	18	18	18							
50105220	PIPE CULVERT REMOVAL	FOOT	52	52	52							
E01E7200		SQ YD	1027	1837				435	1400			
50157300	PROTECTIVE SHIELD	SQYD	1837	1637				435	1402			
50200100	STRUCTURE EXCAVATION	CUYD	388	388				232	156			
50200300	COFFERDAM EXCAVATION	CUYD	672	672				390	282			
50201121	COFFERDAM (TYPE 2) (LOCATION - 1)	EACH	1	1				1				
50201122	COFFERDAM (TYPE 2) (LOCATION - 2)	EACH	1	1				1				
50201123	COFFERDAM (TYPE 2) (LOCATION - 3)	EACH	1	1				1				
50201124	COFFERDAM (TYPE 2) (LOCATION 4)	EACH	1	1					1			
50201125	COFFERDAM (TYPE 2) (LOCATION 5)	EACH	1	1					1			
50201126	COFFERDAM (TYPE 2) (LOCATION 6)	EACH	1	1					1			
50300100	FLOOR DRAINS	EACH	56	56				24	32			
50300225	CONCRETE STRUCTURES	CUYD	1221.2	1221.2				600.2	621.0			
				122 112								
50300255	CONCRETE SUPERSTRUCTURE	CUYD	1327.2	1327.2				626.1	701.1			

	USER NAME = jahaas	DESIGNED -	REVISED -			SUMMARY OF QUANTITIES	F.A. I RTF	SECTION	COUNTY	TOTAL SHEET SHEETS NO.
		DRAWN -	REVISED -	STATE OF ILLINOIS			57	(28-2)B-2; (28-1)B-2	*	598 9
	PLOT SCALE = 0.16666633 ' / in.	CHECKED -	REVISED -	DEPARTMENT OF TRANSPORTATION					CONTRAC	
E WWW. HORNERSHIFRIN .COM	PLOT DATE = 10/16/2024	DATE -	REVISED -		SCALE: NTS	SHEET 5 OF 15 SHEETS STA. TO STA.		ILLINOIS FED. A		

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	SUMMARY OF QU	ANTITIES	80% 20% S	FED TATE			FRANKLIN COUNT FAI 57		TION CODE	J	EFFERSON COUNT FAI 57	Ŷ
CODE NO	ITEM	UNIT	TOTAL QTY 1, 2, 3, 4 &	TOTAL QTY 1, 2, 3, 4 &	ROADWAY (1)	ROADWAY ALTERNATE A	INTERSTATE ROADWAY ALTERNATE B	BRIDGE (2) SN 028-0090/91	BRIDGE (3) SN 028-0093/94	ROADWAY (4)	INTERSTATE 'ROADWAY ALTERNATE A	ROADWA
			ALT A	ALT B	0001	0001	0001	0010	0010	0001	0001	0001
50300265	SEAL COAT CONCRETE	CUYD	364.1	364.1				194.8	169.3			
50300300	PROTECTIVE COAT	SQYD	6292	6292				2890	3402			
50301350	CONCRETE SUPERSTRUCTURE (APPROACH SLAB)	CUYD	763.9	763.9				385.8	378.1			
50500105	FURNISHING AND ERECTING STRUCTURAL STEEL	L SUM	1	1				0.37	0.63			
50500505	STUD SHEAR CONNECTORS	EACH	25536	25536				11712	13824			
50800105	REINFORCEMENT BARS	POUND	61150	61150						61150		
50800205	REINFORCEMENT BARS, EPOXY COATED	POUND	744740	744740				357020	387720			
50800515	BAR SPLICERS	EACH	3648	3648				1594	1914	140		
51201900	FURNISHING STEEL PILES HP14X89	FOOT	3882	3882				3882				
51202000	FURNISHING STEEL PILES HP14X102	FOOT	4176	4176					4176			
51202305	DRIVING PILES	FOOT	8058	8058				3882	4176			
51203900	TEST PILE STEEL HP14X89	EACH	6	6				6				
51204000	TEST PILE STEEL HP 14X102	EACH	6	6					6			
51204650	PILE SHOES	EACH	160	160				82	78			
51500100	NAME PLATES	EACH	5	5				2	2	1		
51604000	DRILLED SHAFT IN ROCK	CUYD	6	6	6							

/PW01											
	USER NAME = jahaas	DESIGNED -	REVISED -			SUMMARY OF QUANTITIES	F. R	A.I S	ECTION	COUNTY TOTAL	SHEET
	i	DRAWN -	REVISED -	STATE OF ILLINOIS				57 (28-2)E	3-2; (28-1)B-2	* 598	10
	PLOT SCALE = 0.16666633 '/ in.	CHECKED -	REVISED -	DEPARTMENT OF TRANSPORTATION						CONTRACT NO. 78	1884
≌ 륜 WWW. HORNERSHIFRIN .COM	PLOT DATE = 10/16/2024	DATE -	REVISED -		SCALE: NTS	SHEET 6 OF 15 SHEETS STA. TO ST	A.		ILLINOIS FED. AID	PROJECT	

	SUMMARY OF QUANTITIES	5	80% 20% \$	FED			FRANKLIN COUNT FAI 57		CTION CODE	J	EFFERSON COUNT FAI 57	Y
		-	TOTAL QTY	TOTAL QTY			INTERSTATE				INTERSTATE	
CODE NO	ІТЕМ	UNIT	1, 2, 3, 4 &	1, 2, 3, 4 &	ROADWAY (1)	ROADWAY ALTERNATE A	ROADWAY ALTERNATE B	BRIDGE (2) SN 028-0090/91	BRIDGE (3) SN 028-0093/94	ROADWAY (4)	'ROADWAY ALTERNATE A	ROADWAY ALTERNATE B
			ALT A	ALT B	0001	0001	0001	0010	0010	0001	0001	0001
52100520	ANCHOR BOLTS, 1"	EACH	192	192				96	96			
52200010	TEMPORARY SHEET PILING	SQ FT	485	485				237	248			
52200020	TEMPORARY SOIL RETENTION SYSTEM	SQ FT	267	267						267		
54003000	CONCRETE BOX CULVERTS	CUYD	298.9	298.9						298.9		
54213669	PRECAST REINFORCED CONCRETE FLARED END SECTIONS 24"	EACH	14	14	7					7		
54213672	PRECAST REINFORCED CONCRETE FLARED END SECTIONS 27"	EACH	5	5	4					1		
54213675	PRECAST REINFORCED CONCRETE FLARED END SECTIONS 30"	EACH	3	3	2					1		
54213687	PRECAST REINFORCED CONCRETE FLARED END SECTIONS 42"	EACH	1	1	1							
54248510	CONCRETE COLLAR	CUYD	3.96	3.96	2.64					1.32		
550A0120	STORM SEWERS, CLASS A, TYPE 1 24"	FOOT	3413	3413	2408					1005		
550A0130	STORM SEWERS, CLASS A, TYPE 1 27"	FOOT	322	322						322		
550A0410	STORM SEWERS, CLASS A, TYPE 2 24"	FOOT	22038	22038	12723					9315		
	STORM SEWERS, CLASS A, TYPE 2 27"											
550A0420	STORINI SENVERS, GLASSA, ITPEZ ZI	FOOT	2096	2096	688					1408		
550A0430	STORM SEWERS, CLASS A, TYPE 2 30"	FOOT	1926	1926	725					1201		

F.A. I RTE. SECTION COUNTY TOTAL SHEETS SHEET NO. 57 (28-2)B-2; (28-1)B-2 * 598 11 CONTRACT NO. 78884 TS STA. Interview								
CONTRACT NO. 78884	ĮU,	ANTITIES		F.A. I RTE.	SECTION	COUNTY		
				57	(28-2)B-2; (28-1)B-2	*	598	11
TS STA. TO STA.						CONTRACT	NO. 788	84
	TS	STA.	TO STA.		ILLINOIS FED. A	D PROJECT		

	SUMMARY OF QUANTITIES)	80% 20% S	FED			FRANKLIN COUNTY FAI 57		CTION CODE	J	EFFERSON COUNT FAI 57	 Y
CODE NO	ІТЕМ	UNIT	TOTAL QTY 1, 2, 3, 4 &	TOTAL QTY 1, 2, 3, 4 &	ROADWAY (1)	ROADWAY ALTERNATE A	INTERSTATE ROADWAY ALTERNATE B	BRIDGE (2) SN 028-0090/91	BRIDGE (3) SN 028-0093/94	ROADWAY (4)	INTERSTATE 'ROADWAY ALTERNATE A	ROADWAY ALTERNATE B
			ALT A	ALT B	0001	0001	0001	0010	0010	0001	0001	0001
550A0450	STORM SEWERS, CLASS A, TYPE 2 36"	FOOT	1213	1213	681					532		
550A0470	STORM SEWERS, CLASS A, TYPE 2 42"	FOOT	313	313	313							
55100900	STORM SEWER REMOVAL 18"	FOOT	398.0	398.0	355					43		
55101200	STORM SEWER REMOVAL 24"	FOOT	666	666	312					354		
55200900	STORM SEWERS JACKED IN PLACE, 24"	FOOT	1348	1348	694					654		
55201000	STORM SEWERS JACKED IN PLACE, 27"	FOOT	263	263	177					86		
55201100	STORM SEWERS JACKED IN PLACE, 30"	FOOT	487	487	393					94		
55201500	STORM SEWERS JACKED IN PLACE, 42"	FOOT	104	104	104							
58600101	GRANULAR BACKFILL FOR STRUCTURES	CUYD	781	781				438	343			
		0010	701	701					545			
59100100	GEOCOMPOSITE WALL DRAIN	SQ YD	775	775				237	198	340		
59300100	CONTROLLED LOW-STRENGTH MATERIAL	CUYD	136	136	114					22		
60100060	CONCRETE HEADWALLS FOR PIPE DRAINS	EACH	51	51	39					12		
60108100	PIPE UNDERDRAINS 4" (SPECIAL)	FOOT	5010	5010	3060					1950		
60400004		FOOT	116040	110010	70040					46205		
60108204	PIPE UNDERDRAINS, TYPE 2, 4"	FOOT	116318	116318	70013					46305		

	USER NAME = jahaas	DESIGNED -	REVISED -		SUMMARY OF QUANTITIES	F.A. I RTE	SECTION	COUNTY TOT	TAL SHEET
		DRAWN -	REVISED -	STATE OF ILLINOIS		57	(28-2)B-2; (28-1)B-2	* 59	98 12
	PLOT SCALE = 0.16666633 ' / in.	CHECKED -	REVISED -	DEPARTMENT OF TRANSPORTATION				CONTRACT NO.	. 78884
WWW. HORNERSHIFRIN .COM	PLOT DATE = 10/16/2024	DATE -	REVISED -		SCALE: NTS SHEET 8 OF 15 SHEETS STA. TO STA.		ILLINOIS FED. AI	D PROJECT	

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		-	80%	EED			FRANKLIN COUNT		CTION CODE		EFFERSON COUN	ту
	SUMMARY OF QUANTITIE	:5	20% 5	STATE			FAI 57	<u> </u>		5	FAI 57	. 1
			TOTAL QTY	TOTAL QTY	ROADWAY (1)	ROADWAY	INTERSTATE ROADWAY	BRIDGE (2)	BRIDGE (3)	ROADWAY (4)	INTERSTATE 'ROADWAY	ROADWAY
CODE NO		UNIT	1, 2, 3, 4 & ALT A	1, 2, 3, 4 & ALT B	0001	ALTERNATE A		SN 028-0090/91 0010	SN 028-0093/94 0010	0001	ALTERNATE A	ALTERNATE B
60146304	PIPE UNDERDRAINS FOR STRUCTURES 4"	FOOT	710	710				377	333			
60218400	MANHOLES, TYPE A, 4'-DIAMETER, TYPE 1 FRAME, CLOSED LID	EACH	1	1	1							
60223800	MANHOLES, TYPE A, 6'-DIAMETER, TYPE 1 FRAME, CLOSED LID	EACH	2	2	2							
60224459	MANHOLES, TYPE A, 8'-DIAMETER, TYPE 1 FRAME, CLOSED LID	EACH	1	1						1		
60266600	VALVE BOXES TO BE ADJUSTED	EACH	1	1	1							
60270055	DRAINAGE STRUCTURES, TYPE 5 WITH TWO TYPE 22 FRAME AND GRATES	EACH	129	129	70					59		
60500060	REMOVING INLETS	EACH	41	41	18					23		
63000001	STEEL PLATE BEAM GUARDRAIL, TYPE A, 6 FOOT POSTS	FOOT	3499	3499	3261					238		
63100070	TRAFFIC BARRIER TERMINAL, TYPE 5	EACH	4	4	4							
63100085	TRAFFIC BARRIER TERMINAL, TYPE 6	EACH	4	4	4							
63100089	TRAFFIC BARRIER TERMINAL, TYPE 6B	EACH	8	8	7					1		
63100167	TRAFFIC BARRIER TERMINAL, TYPE 1 (SPECIAL) TANGENT	EACH	8	8	7					1		
63200310	GUARDRAIL REMOVAL	FOOT	6954	6954	6610					344		
63500105	DELINEATORS	EACH	310	310	170					140		

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RTE	A.I SECTIO	TION	COUNTY	TOTAL S	SHEET
57	7 (28-2)B-2; (28	(28-1)B-2	*	598	13
		. ,	CONTRACT	NO. 7888	4
	ILL		PROJECT		
	5	RIE.	57 (28-2)B-2; (28-1)B-2	57 (28-2)B-2; (28-1)B-2 * CONTRACT ILLINOIS FED. AID PROJECT	K1E. Sheers 57 (28-2)B-2; (28-1)B-2 * 598 CONTRACT NO. 76884

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* FRANKLIN/JEFFERSON

			TIES 80% FED 20% STATE			CONSTRUCTION CODE FRANKLIN COUNTY				CTION CODE	E JEFFERSON COUNTY		
		SUMMARY OF QUANTITIES	S	80% 20% S	FED STATE			FRANKLIN COUNT FAI 57	Y		J	EFFERSON COUNT FAI 57	۲
				TOTAL QTY	TOTAL QTY			INTERSTATE				INTERSTATE	
c	ODE NO	ITEM	UNIT	1, 2, 3, 4 &	1, 2, 3, 4 &	ROADWAY (1)	ROADWAY ALTERNATE A	ROADWAY ALTERNATE B	BRIDGE (2) SN 028-0090/91	BRIDGE (3) SN 028-0093/94	ROADWAY (4)	'ROADWAY ALTERNATE A	ROADWAY ALTERNATE B
				ÁLT A	ALT B	0001	0001	0001	0010	0010	0001	0001	0001
	63700280	CONCRETE BARRIER, DOUBLE FACE, 44 INCH HEIGHT	FOOT	44044	44044	25733					18311		
	63700380	CONCRETE BARRIER, VARIABLE CROSS SECTION 44 INCH HEIGHT	FOOT	5900	5900	2950					2950		
	63700805	CONCRETE BARRIER TRANSITION	FOOT	161	161	120					41		
	64200108	SHOULDER RUMBLE STRIPS, 8 INCH	FOOT	10165	10165	5010					5155		
	64200108		FOOT	10105	10105	5010					5155		
	64200116	SHOULDER RUMBLE STRIPS, 16 INCH	FOOT	194769	194769	112312					82457		
_	64300260	IMPACT ATTENUATORS (FULLY REDIRECTIVE, NARROW), TEST LEVEL 3	EACH	8	8	6					2		
*	66900200	NON-SPECIAL WASTE DISPOSAL	CUYD	687	687	296					391		
*	66900530	SOIL DISPOSAL ANALYSIS	EACH	6	6	3					3		
*	66901001	REGULATED SUBSTANCES PRE-CONSTRUCTION PLAN	LSUM	1	1	0.5					0.5		
*	66901003	REGULATED SUBSTANCES FINAL CONSTRUCTION REPORT	LSUM	1	1	0.5					0.5		
ĸ	66901006	REGULATED SUBSTANCES MONITORING	CAL DA	46	46	20					26		
	67000400	ENGINEER'S FIELD OFFICE, TYPE A	CAL MO	45	45	27					18		
	67000600	ENGINEER'S FIELD LABORATORY	CAL MO	45	45	27					18		
	67100100	MOBILIZATION	LSUM	1	1	0.6					0.4		

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	USER NAME = jahaas	DESIGNED -	REVISED -			SUMMARY OF QUANTITIES	F.A. I BTE	SECTION	COUNTY TOTAL SHEET
		DRAWN -	REVISED -	STATE OF ILLINOIS			57	(28-2)B-2; (28-1)B-2	* 598 14
∄♥SHIFRIN	PLOT SCALE = 0.16666633 ' / in.	CHECKED -	REVISED -	DEPARTMENT OF TRANSPORTATION					CONTRACT NO. 78884
E WWW. HORNERSHIFRIN .COM	PLOT DATE = 10/16/2024	DATE -	REVISED -		SCALE: NTS	SHEET 10 OF 15 SHEETS STA. TO STA.		ILLINOIS FED A	ID PROJECT

Γ										CTION CODE			
		SUMMARY OF QUANTITIES	5	80% 20% S	FED STATE			FRANKLIN COUNT FAI 57	Y		J	EFFERSON COUNT FAI 57	Ŷ
-				TOTAL QTY	TOTAL QTY			INTERSTATE				INTERSTATE	
	CODE NO	ITEM	UNIT	1, 2, 3, 4 &	1, 2, 3, 4 &	ROADWAY (1)	ROADWAY ALTERNATE A	ROADWAY ALTERNATE B	BRIDGE (2) SN 028-0090/91	BRIDGE (3) SN 028-0093/94	ROADWAY (4)	'ROADWAY ALTERNATE A	ROADWAY ALTERNATE B
				ALT A	ALT B	0001	0001	0001	0010	0010	0001	0001	0001
	70107025	CHANGEABLE MESSAGE SIGN	CAL DA	84	84	42					42		
-	70200100	NIGHTTIME WORK ZONE LIGHTING	L SUM	1	1						1		
-													
	70300100	SHORT TERM PAVEMENT MARKING	FOOT	24423	24423	14095					10328		
_	70300150	SHORT TERM PAVEMENT MARKING REMOVAL	SQ FT	8126	8126	4690					3436		
_	70400100	TEMPORARY CONCRETE BARRIER	FOOT	5088	5088	4113					975		
	70400125	PINNING TEMPORARY CONCRETE BARRIER	EACH	404	404	322					82		
	70400200	RELOCATE TEMPORARY CONCRETE BARRIER	FOOT	1875	1875	1375					500		
-	70600250	IMPACT ATTENUATORS, TEMPORARY (NON- REDIRECTIVE), TEST LEVEL 3	EACH	6	6	4					2		
	70600350	IMPACT ATTENUATORS, RELOCATE (NON- REDIRECTIVE), TEST LEVEL 3	EACH	6	6	4					2		
*	72000100	SIGN PANEL - TYPE 1	SQ FT	783	783	461					322		
π	12000100		Juli	100	100	+01							
*	72000200	SIGN PANEL - TYPE 2	SQ FT	332	332	214					118		
*	72000300	SIGN PANEL - TYPE 3	SQFT	1209	1209	672					537		
-1-	. 2000000				1203								
*	72400100	REMOVE SIGN PANEL ASSEMBLY - TYPE A	EACH	21	21	11					10		
.	72400200	REMOVE SIGN PANEL ASSEMBLY - TYPE B	EACH	7	7	5					2		
*	12400200		EAUT			5					2		

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24										
- Ma		USER NAME = jahaas	DESIGNED -	REVISED -		SUMMARY OF QUANTITIES	F.A.I RTE	SECTION	COUNTY	TOTAL SHEET
Ś Ü	4 HURINER[DRAWN -	REVISED -	STATE OF ILLINOIS		57	(28-2)B-2; (28-1)B-2	*	598 15
ц Z		PLOT SCALE = 0.16666633 ' / in.	CHECKED -	REVISED -	DEPARTMENT OF TRANSPORTATION				CONTRA	CT NO. 78884
έĒ	WWW. HORNERSHIFRIN .COM	PLOT DATE = 10/16/2024	DATE -	REVISED -		SCALE: NTS SHEET 11 OF 15 SHEETS STA. TO STA.		ILLINOIS FED. #	AID PROJECT	

		SUMMARY OF QUAN	NTITIES	80% 20% 5	6 FED STATE			FRANKLIN COUNT FAI 57		CTION CODE	J	EFFERSON COUN FAI 57	ТҮ
-	CODE NO	ІТЕМ	UNIT	TOTAL QTY 1, 2, 3, 4 & ALT A	TOTAL QTY 1, 2, 3, 4 & ALT B	ROADWAY (1)	ROADWAY ALTERNATE A 0001	INTERSTATE ROADWAY ALTERNATE B 0001	BRIDGE (2) SN 028-0090/91 0010	BRIDGE (3) SN 028-0093/94 0010	ROADWAY (4)	INTERSTATE 'ROADWAY ALTERNATE A 0001	ROADWAY ALTERNATE E 0001
*	72400320	REMOVE SIGN PANEL - TYPE 2	SQ FT	60	60	20					40		
*	72400330	REMOVE SIGN PANEL - TYPE 3	SQ FT	1165	1165	622					543		
*	72501000	TERMINAL MARKER - DIRECT APPLIED	EACH	8	8	7					1		
*	72800100	TELESCOPING STEEL SIGN SUPPORT	FOOT	33	33	11					22		
*	73100100	BASE FOR TELESCOPING STEEL SIGN SUPPORT	EACH	3	3	1					2		
*	73300100	OVERHEAD SIGN STRUCTURE - SPAN, TYPE I-A (4'-0" X 4'-6")	FOOT	95	95	95							
*	73301810	OVERHEAD SIGN STRUCTURE WALKWAY, TYPE A	FOOT	36	36	36							
*	73304000	OVERHEAD SIGN STRUCTURE - BRIDGE MOUNTED	FOOT	40	40	28					12		
*	73400200	DRILLED SHAFT CONCRETE FOUNDATIONS	CU YD	30	30	30							
*	73600100	REMOVE OVERHEAD SIGN STRUCTURE - SPAN	EACH	1	1	1							
-	73700300	REMOVE CONCRETE FOUNDATION - OVERHEAD	EACH	2	2	2							
*	78008300	POLYUREA PAVEMENT MARKING TYPE II - LETTERS AND SYMBOLS	SQ FT	794	794	420					374		
-													
*	78008330	POLYUREA PAVEMENT MARKING TYPE II - LINE 6"	FOOT	289374	289374	168583					120791		
*	78008340	POLYUREA PAVEMENT MARKING TYPE II - LINE 8"	FOOT	9488	9488	6153					3335		

2 [Shee										
	USER NAME = jahaas	DESIGNED -	REVISED -			SUMMARY OF QUANTITIES	F.A. I BTE	SECTION	COUNTY	TOTAL SHEET SHEETS NO
	í	DRAWN -	REVISED -	STATE OF ILLINOIS			57	(28-2)B-2; (28-1)B-2	*	598 16
	PLOT SCALE = 0.16666633 '/ in.	CHECKED -	REVISED -	DEPARTMENT OF TRANSPORTATION					CONTRAC	T NO. 78884
≚ ≣ WWW. HORNERSHIFRIN .COM	PLOT DATE = 10/16/2024	DATE -	REVISED -		SCALE: NTS	SHEET 12 OF 15 SHEETS STA. TO STA.		ILLINOIS FED.	AID PROJECT	

	SUMMARY OF QUANTI	TIES	80% 20% S	FED STATE			FRANKLIN COUNT FAI 57	CONSTF Y
CODE NO	Ітем	UNIT	TOTAL QTY 1, 2, 3, 4 & ALT A	TOTAL QTY 1, 2, 3, 4 & ALT B	ROADWAY (1)	ROADWAY ALTERNATE A	INTERSTATE ROADWAY ALTERNATE B	BRIDGE (2) SN 028-0090/9
					0001	0001	0001	0010
78008370	POLYUREA PAVEMENT MARKING TYPE II - LINE 24"	FOOT	93	93	93			
78011000	GROOVING FOR RECESSED PAVEMENT MARKING, LETTERS AND SYMBOLS	SQFT	1082	1082	630			
78011000			1002	1002				
78011035	GROOVING FOR RECESSED PAVEMENT MARKING 7"	FOOT	289374	289374	168583			
78011045	GROOVING FOR RECESSED PAVEMENT MARKING 9"	FOOT	9488	9488	6153			
78011125	GROOVING FOR RECESSED PAVEMENT MARKING 25"	FOOT	93	93	93			
78100100	RAISED REFLECTIVE PAVEMENT MARKER	EACH	5781	5781	3323			
78200005	GUARDRAIL REFLECTORS, TYPE A	EACH	81	81	75			
78200011	BARRIER WALL REFLECTORS, TYPE C	EACH	632	632	422			
78300200	RAISED REFLECTIVE PAVEMENT MARKER REMOVAL	EACH	2749	2749	1587			
78300201	PAVEMENT MARKING REMOVAL - GRINDING	SQ FT	70546	70546	40617			
X2020501	EARTH EXCAVATION (UNSUITABLE MATERIAL)	CUYD	15393	15393	11043			
X0321158	PARK BENCHES	EACH	6	6	6			
X0321690	BRICK WALL REMOVAL	FOOT	217	217	217			
X0322278	RODENT SHIELDS	EACH	116	116	45			

04/0										
	USER NAME = jahaas	DESIGNED -	REVISED -			SUMMARY OF QUANTITIES	F.A.I	SECTION	COUNTY	TOTAL SHEET
		DRAWN -	REVISED -	STATE OF ILLINOIS			57	(28-2)B-2; (28-1)B-2	*	598 17
	PLOT SCALE = 0.16666633 ' / in.	CHECKED -	REVISED -	DEPARTMENT OF TRANSPORTATION					CONTRAC	CT NO. 78884
E WWW. HORNERSHIFRIN .COM	PLOT DATE = 10/16/2024	DATE -	REVISED -		SCALE: NTS	SHEET 13 OF 15 SHEETS STA. TO STA.		ILLINOIS F	ED. AID PROJECT	
										ANIZE INVECTOR

NSTRUC	TION CODE			
		J	EFFERSON COUNT FAI 57	Y
SE (2)	BRIDGE (3)	ROADWAY (4)	INTERSTATE 'ROADWAY	ROADWAY
0090/91	SN 028-0093/94		ALTERNATE A	ALTERNATE B
10	0010	0001	0001	0001
		452		
		102		
		120791		
		3335		
		2458		
		6		
		210		
		210		
		1162		
		29929		
		4350		
		71		
		1		

	SUMMARY OF QUANTITIES	5	80% 20% S	FED			FRANKLIN COUNT		CTION CODE	J	EFFERSON COUNT FAI 57	Υ
CODE NO		UNIT	TOTAL QTY 1, 2, 3, 4 &	TOTAL QTY 1, 2, 3, 4 &	ROADWAY (1)	ROADWAY ALTERNATE A	INTERSTATE ROADWAY ALTERNATE B	BRIDGE (2) SN 028-0090/91	BRIDGE (3) SN 028-0093/94	ROADWAY (4)	INTERSTATE 'ROADWAY ALTERNATE A	ROADWAY ALTERNATE B
			ALT A	ALT B	0001	0001	0001	0010	0010	0001	0001	0001
X5427602	REMOVE EXISTING FLARED END SECTION	EACH	6	6	2					4		
X0323256	REMOVE AND RELOCATE FLAGPOLE	EACH	1	1	1							
X2810842	REMOVE EXISTING RIPRAP	SQ YD	36	36						36		
X6420112	CENTER LINE - RUMBLE STRIP - 8"	FOOT	203370	203370	117456					85914		
X2600011	REMOVE AND RELOCATE SIGN	EACH	1	1	1							
X5810103	MEMBRANE WATERPROOFING SYSTEM FOR BURIED STRUCTURES	SQ YD	340	340						340		
X2503100	MOWING	UNIT	4096	4096	2363					1733		
X3552128	HOT-MIX ASPHALT EDGE LINE REPAIR, 2"	SQ YD	22772	22772	13225					9547		
X3552129	HOT-MIX ASPHALT SHOULDER REPAIR, 2"	SQ YD	4500	4500	2600			1000	4000	1900		
X5030250	BRIDGE DECK GROOVING (LONGITUDINAL)	SQ YD	3082	3082				1390	1692			
X5080530	BAR TERMINATORS	EACH	4344	4344				2272	2072			
X6013700	PIPE UNDERDRAIN REMOVAL (SPECIAL)	FOOT	117060	117060	70699					46361		
X6027005	DRAINAGE STRUCTURES, TYPE 5 WITH TWO TYPE 22 FRAME AND GRATES (SPECIAL)	EACH	19	19	13					6		
X6350120	DELINEATOR REMOVAL	EACH	310	310	170					140		
X6430120	REMOVE IMPACT ATTENUATORS, NO SALVAGE	EACH	1	1						1		


ĮŪ,	ANTITIES		F.A. I RTE.	SECTION	COUNTY	TOTAL SHEETS	SHEET NO.
			57	(28-2)B-2; (28-1)B-2	*	598	18
					CONTRACT	NO. 788	84
тs	STA.	TO STA.		ILLINOIS FED.	AID PROJECT		

BRIDGE (3) ROADWAY (4) N 028-0093/94 0001 0010 0001 3 3 1 21 0.4 2845	FAI 57 INTERSTATE 4) 'ROADWAY R(ALTERNATE A ALT 0001
N 028-0093/94 0001 0010 0001 3 1 21 0.4	4) 'ROADWAY RO ALTERNATE A ALT
0010 0001 3 3 1 21 0.4 0.4	ALTERNATE A ALT 0001
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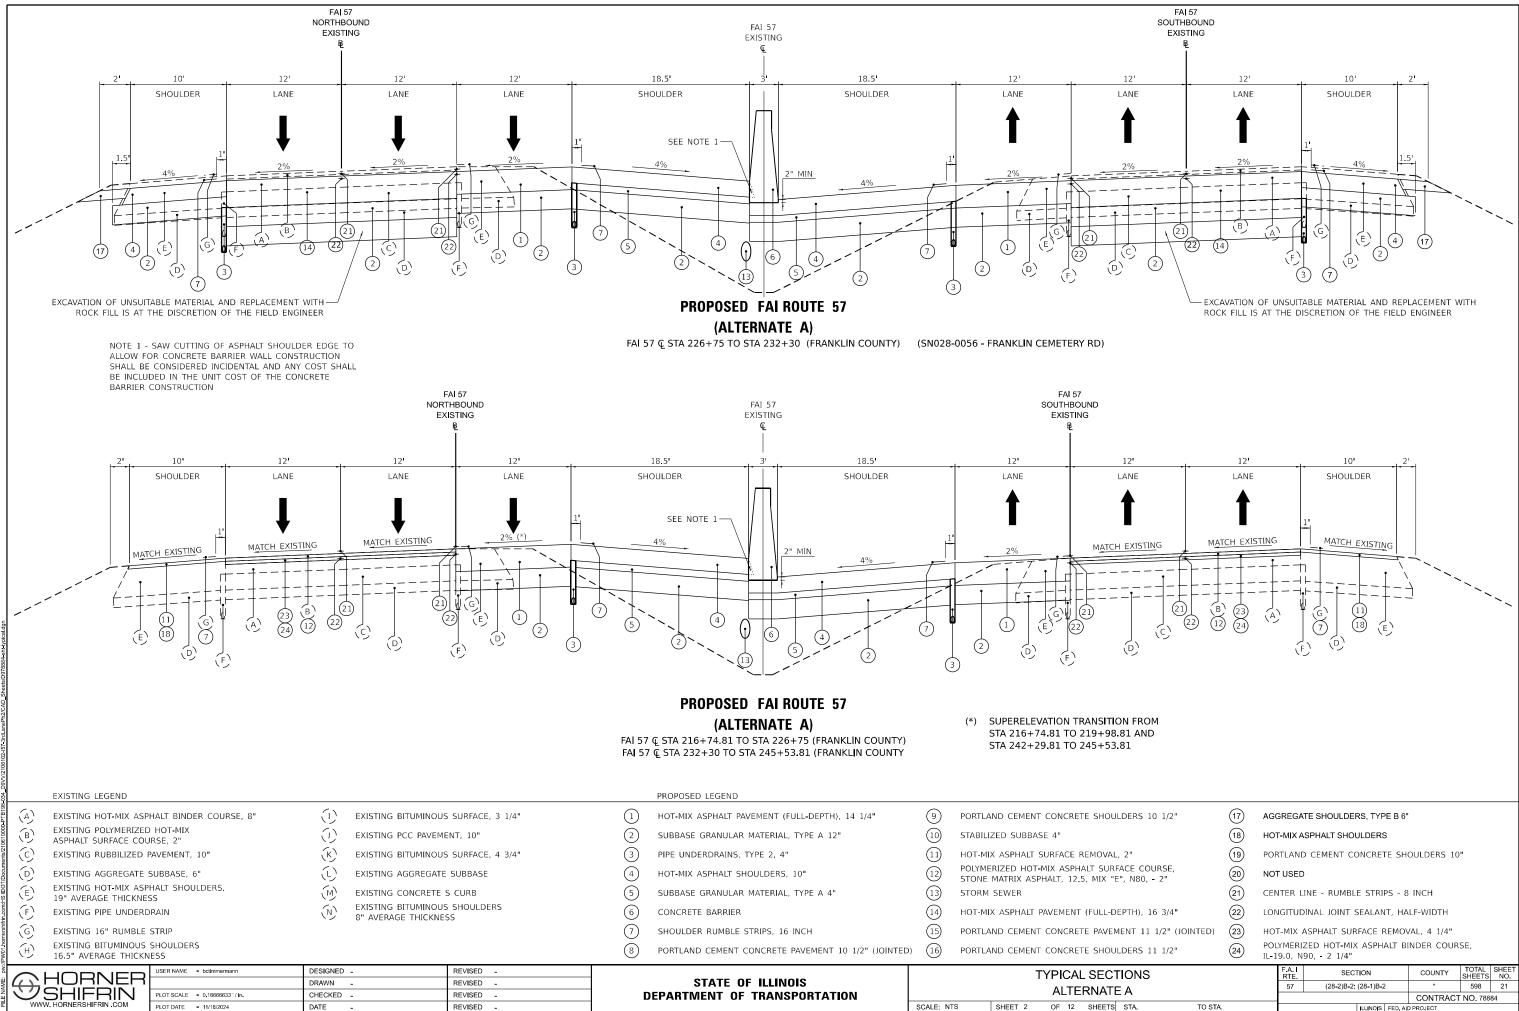
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р О т.м.		DESIGNED -	REVISED -		SUMMARY OF QUANTITIES	F.A. I RTE	SECTION	COUNTY	TOTAL SHE	ET
AME: SC		DRAWN -	REVISED -	STATE OF ILLINOIS		57	(28-2)B-2; (28-1)B-2	*	598 19	9
N E	SHIFRIN PLOT SCALE = 0.166666633 '	in. CHECKED -	REVISED -	DEPARTMENT OF TRANSPORTATION				CONTRACT	NO. 78884	
йĒ	WWW. HORNERSHIFRIN .COM PLOT DATE = 10/16/2024	DATE -	REVISED -		SCALE: NTS SHEET 15 OF 15 SHEETS STA. TO STA.		ILLINOIS FEE	AID PROJECT		
								* ED \\	IKI N/ IEEEDS	SUN



SPHALT BINDER COURSE, COUNTY TOTAL SHEET NO. 1)B-2 * 598 20									
SPHALT BINDER COURSE,									
CE REMOVAL, 4 1/4"									
LANT, HALF-WIDTH									
CENTER LINE - RUMBLE STRIPS - 8 INCH									
CRETE SHOULDERS 10"									
HOT-MIX ASPHALT SHOULDERS									
TYPE B 6"									

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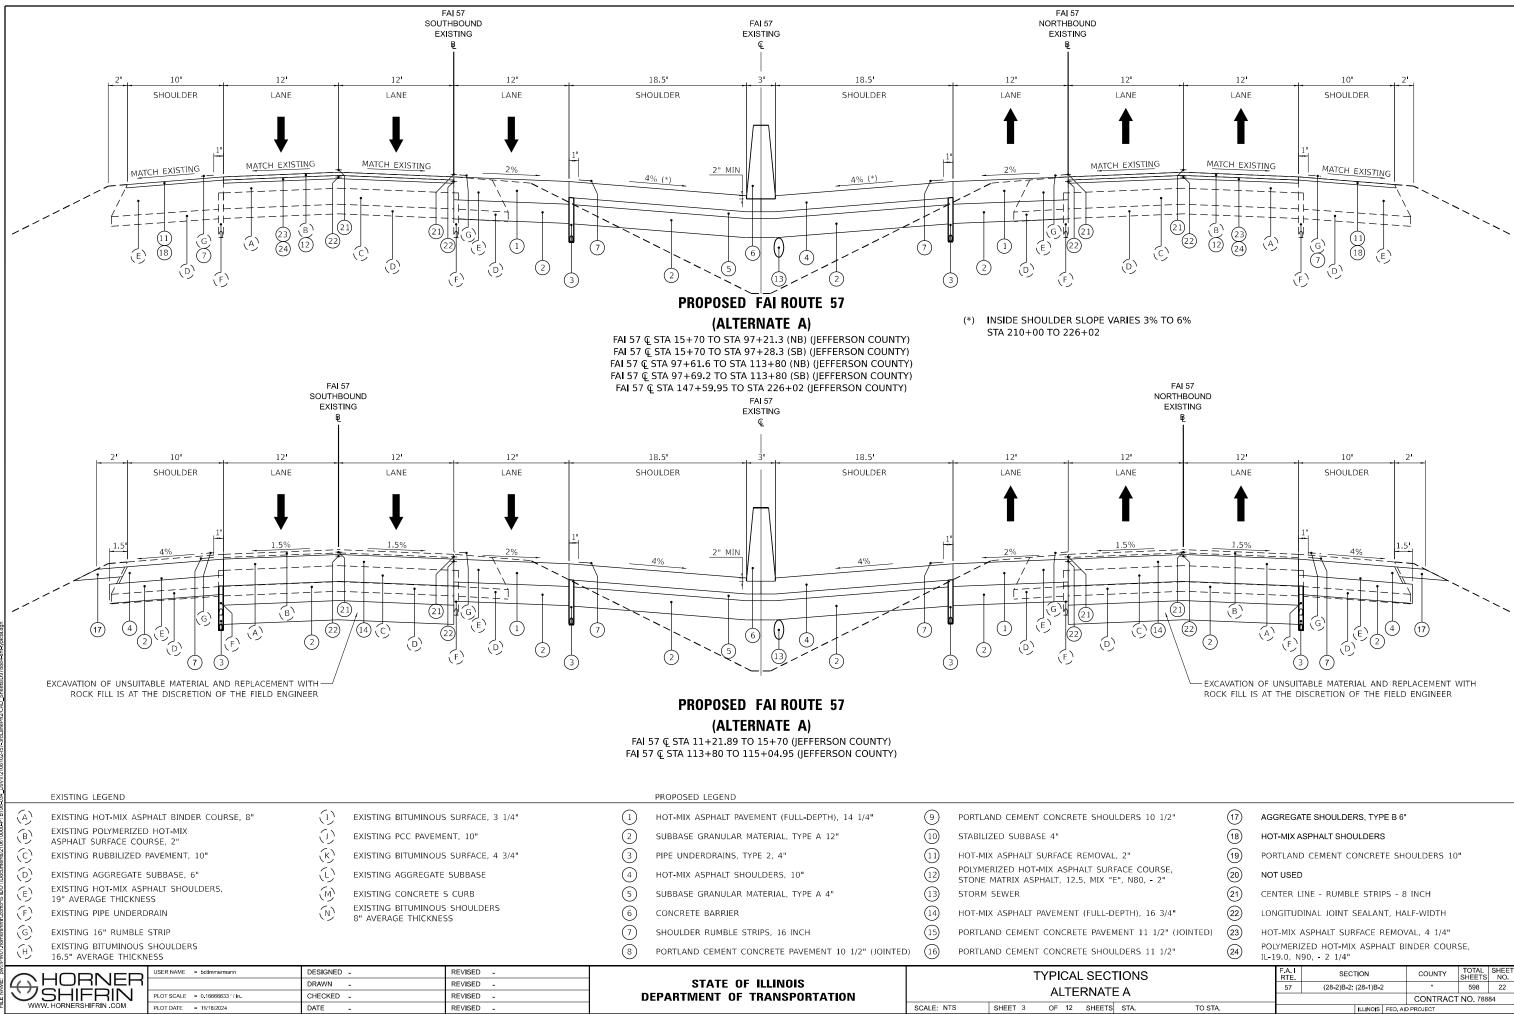
LOT DATE = 11/18/2024

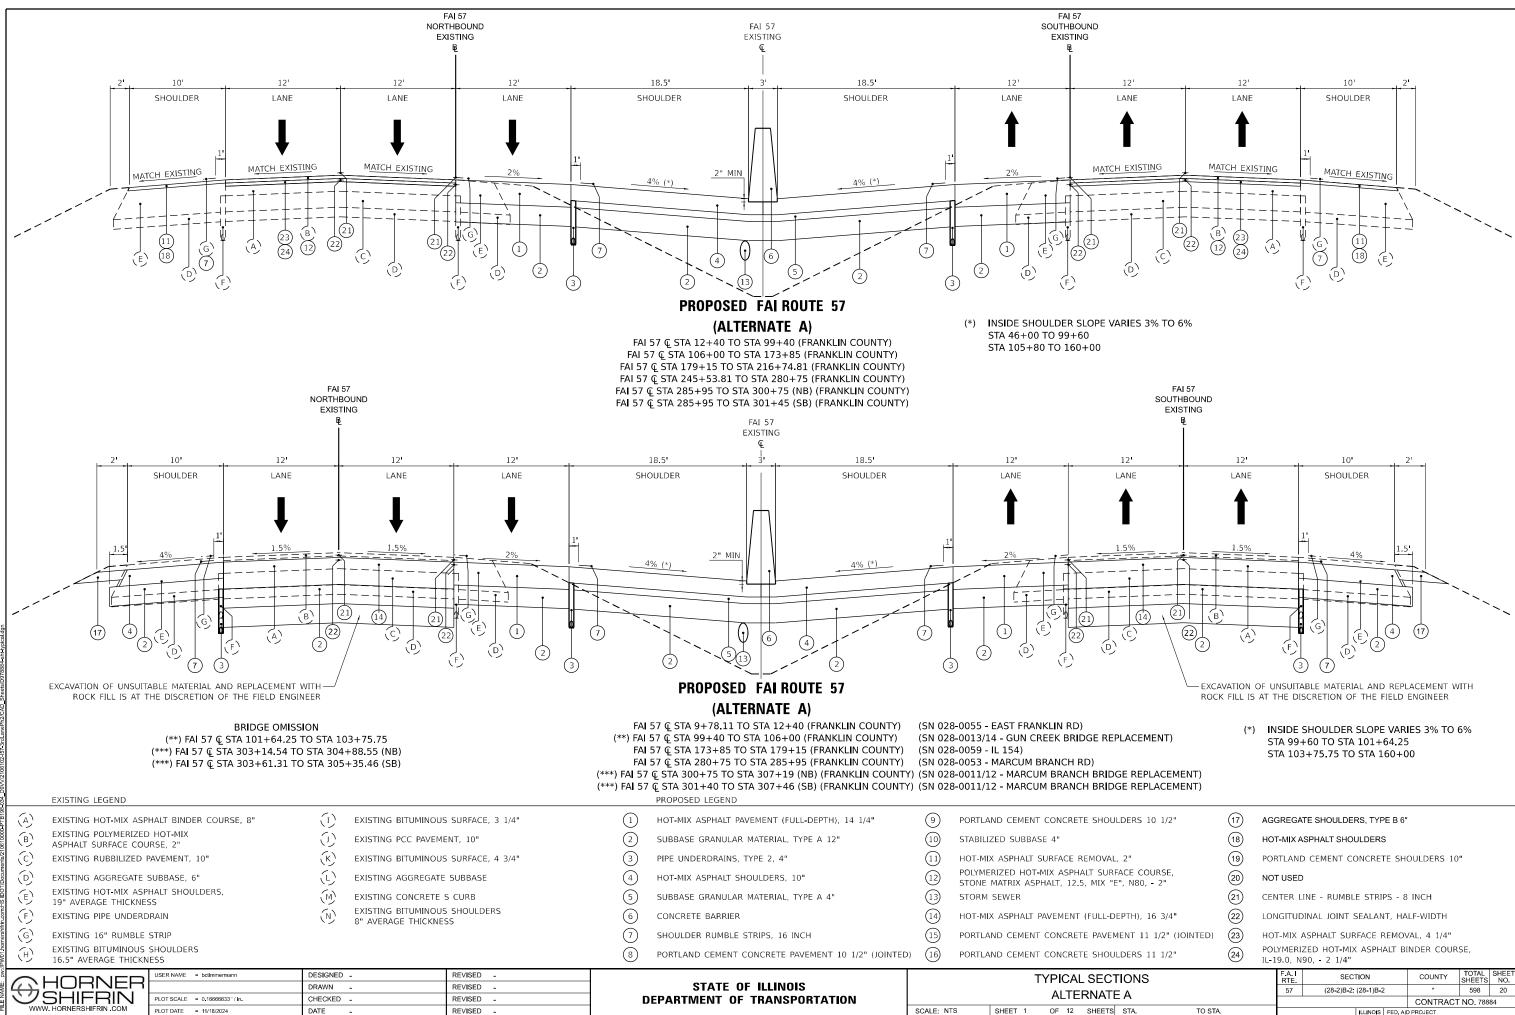DATE


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OULDERS 10 1/2"	(17)	AGC	GREGA	TE SHOULDERS, TYPE B 6"					
	(18)	нот	Г-МІХ А	SPHALT SHOULDERS					
/AL, 2"	(19)	PORTLAND CEMENT CONCRETE SHOULDERS 10"							
JRFACE COURSE, : "E", N80, - 2"	20	NOT USED							
	(21)	CENTER LINE - RUMBLE STRIPS - 8 INCH							
-DEPTH), 16 3/4"	22	LON	IGITUD	INAL JOINT SEALANT, HA	LF-WIDTH				
/EMENT 11 1/2" (JOINTED)	23	НОТ	t-MIX A	SPHALT SURFACE REMO	/AL, 4 1/4"				
OULDERS 11 1/2"	24)	POLYMERIZED HOT-MIX ASPHALT BINDER COURSE, IL-19.0, N90, - 2 1/4"							
CTIONS			F.A.I RTE	SECTION	COUNTY	TOTAL SHEETS	SHEET NO.		
TE A			57	(28-2)B-2; (28-1)B-2	*	598	21		
					CONTRACT	NO. 788	84		

ILLINOIS FED AID PROJECT FRANKLIN/JEFFERSO



OULDERS 10 1/2"	(17)	AGG	GREGA	TE SHOULDERS, TYPE B 6"			
	(18)	нот	-MIX A	SPHALT SHOULDERS			
VAL, 2"	(19)	POR	TLAND	CEMENT CONCRETE SH	OULDERS 10		
URFACE COURSE, ("E", N80, - 2"	20	NOT	USED				
	(21)	CENTER LINE - RUMBLE STRIPS - 8 INCH					
L-DEPTH), 16 3/4"	22	LON	GITUD	INAL JOINT SEALANT, HA	LF-WIDTH		
VEMENT 11 1/2" (JOINTED)	23	нот	-MIX A	ASPHALT SURFACE REMO	/AL, 4 1/4"		
OULDERS 11 1/2"	24	POLYMERIZED HOT-MIX ASPHALT BINDER COURSE					
CTIONS			F.A. I RTE	SECTION	COUNTY	TOTAL SHEETS	SHEET NO.
ATE A			57	(28-2)B-2; (28-1)B-2	*	598	22
					CONTRACT	NO. 788	84

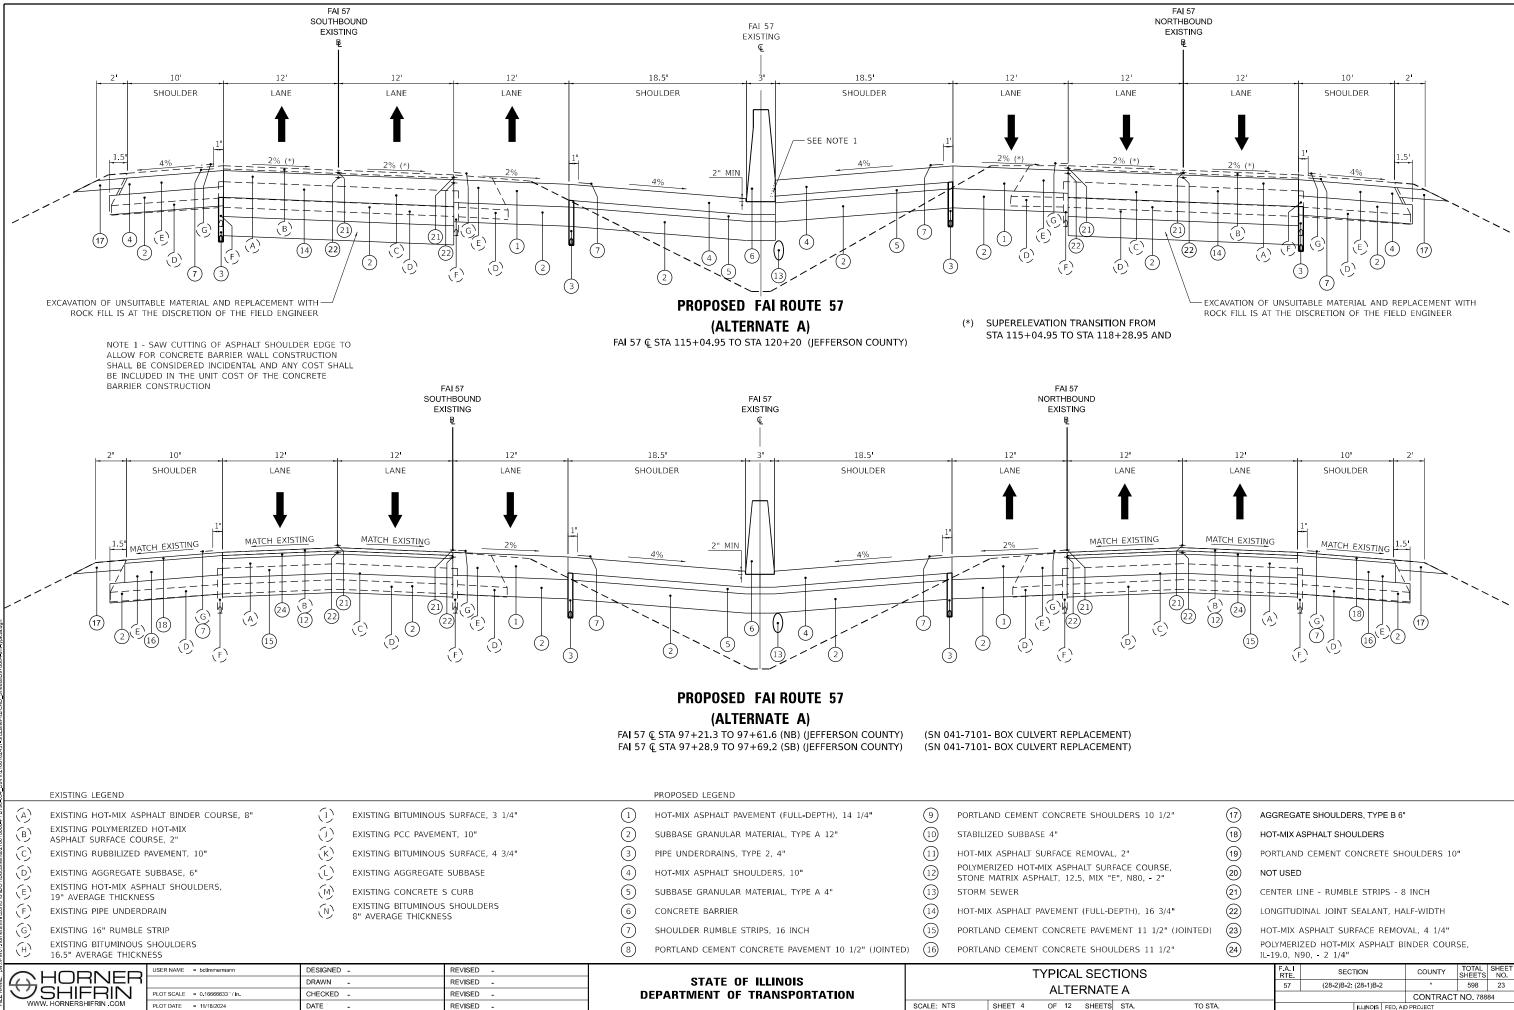


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DATE

REVISED

DULDERS 10 1/2" (17) AGGREGATE SHOULDERS, TYPE B 6"							
(18) HOT-MIX ASPHALT SHOULDERS							
AL, 2" (19) PORTLAND CEMENT CONCRETE SHOULDERS 10"							
IRFACE COURSE, 20 NOT USED	NOT USED						
(21) CENTER LINE - RUMBLE STRIPS - 8 INCH							
-DEPTH), 16 3/4" (22) LONGITUDINAL JOINT SEALANT, HALF-WIDTH	LONGITUDINAL JOINT SEALANT, HALF-WIDTH						
EMENT 11 1/2" (JOINTED) (23) HOT-MIX ASPHALT SURFACE REMOVAL, 4 1/4"	HOT-MIX ASPHALT SURFACE REMOVAL, 4 1/4"						
DULDERS 11 1/2" POLYMERIZED HOT-MIX ASPHALT BINDER COURSE, IL-19.0, N90, - 2 1/4"							
CTIONS	SHEET NO.						
57 (28-2)B-2; (28-1)B-2 * 598	23						
CONTRACT NO. 7888	4						
TS STA. TO STA. ILLINOIS FED. AID PROJECT							

* FRANKLIN/JEFFERSOI

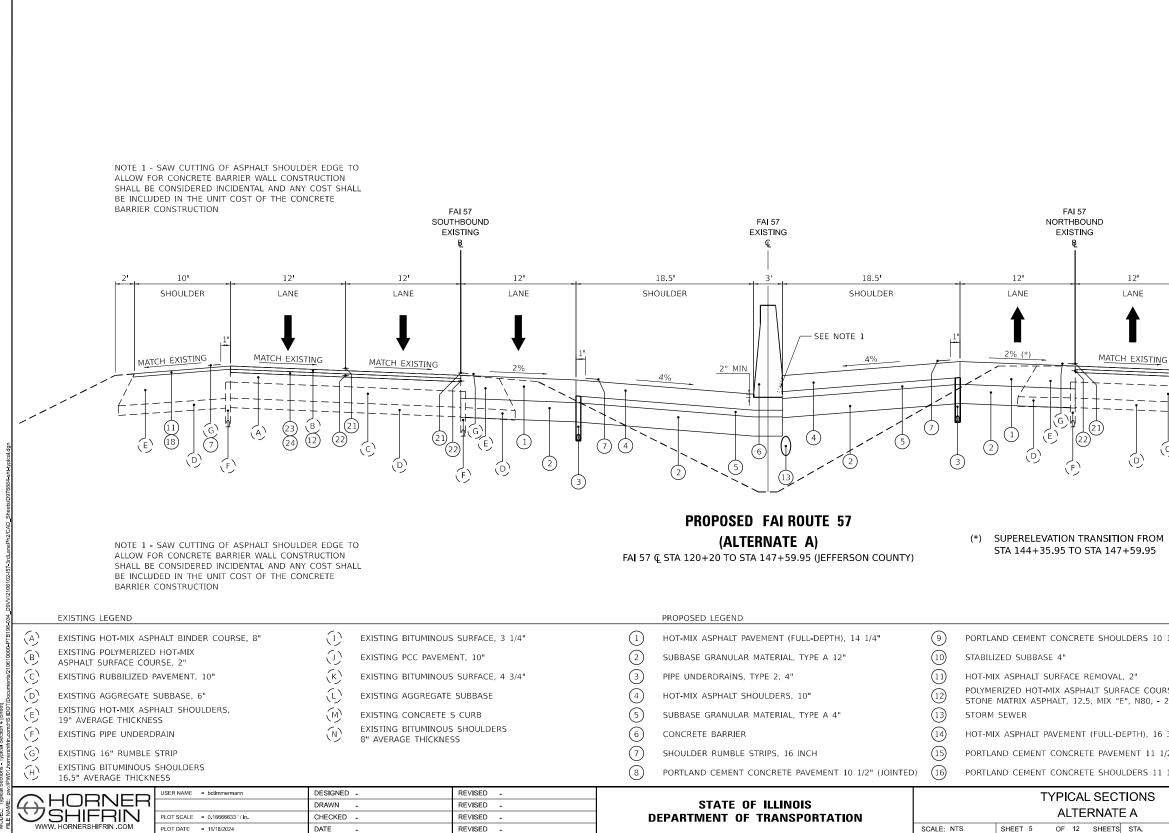

47+59.95								
OULDERS 10 1/2"	(17)	AG	GREGAT	TE SHOULDER	S, TYPE B 6"			
	(18)	HO	Г-MIX AS	SPHALT SHOU	ILDERS			
/AL, 2"	(19)	POF	RTLAND	CEMENT CO	NCRETE SH	OULDERS 10		
JRFACE COURSE, : "E", N80, - 2"	20	NO	T USED					
	(21)	CEN	ITER LI	NE - RUMBLE	E STRIPS - 8	INCH		
DEPTH), 16 3/4"	22	LON	IGITUD	INAL JOINT S	EALANT, HA	LF-WIDTH		
/EMENT 11 1/2" (JOINTED)	23	HO	T-MIX A	SPHALT SURI	FACE REMO	/AL, 4 1/4"		
OULDERS 11 1/2"	24			ZED HOT-MIX 90, - 2 1/4"	ASPHALT BI	NDER COUR	SE,	
CTIONS			F.A. I RTE	SECT	ION	COUNTY	TOTAL SHEETS	SHEET NO.
TE A			57	(28-2)B-2; (28-1)B-2		598	24
TS STA. TO STA.					LLINOIS FED. AI		NU. 788	54

12'

12'

LANE

MATCH EXISTING

(23) (24)

(A)

1 .

(B) (12)

(21)

(c)

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(22)

10'

SHOULDER

MATCH EXISTING

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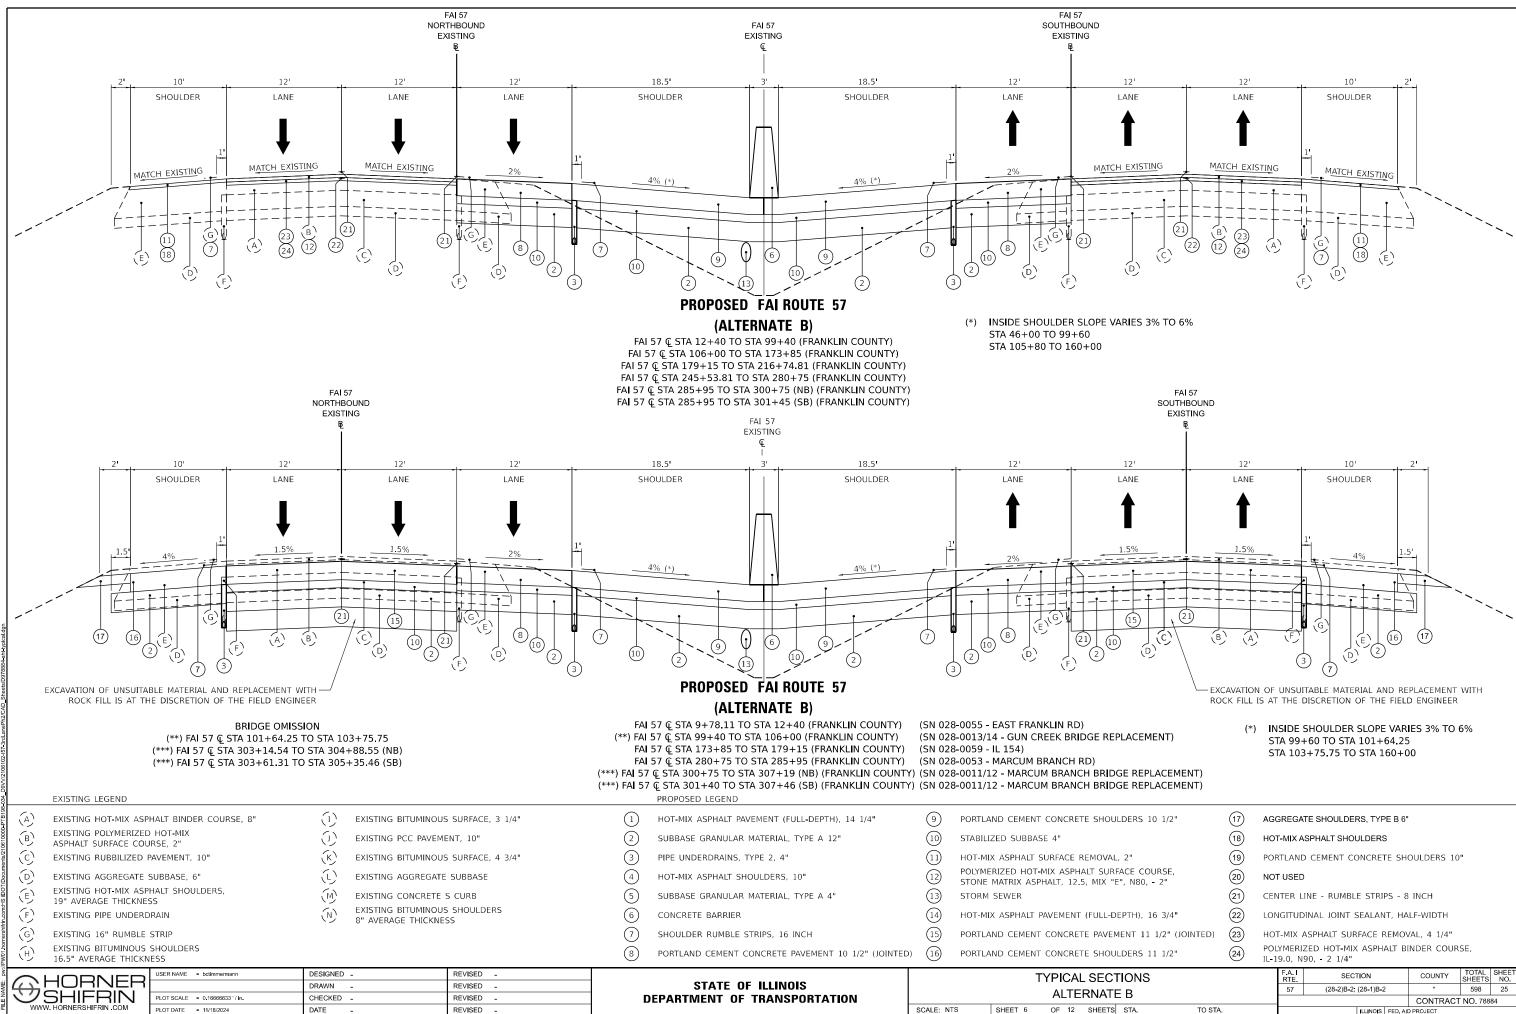
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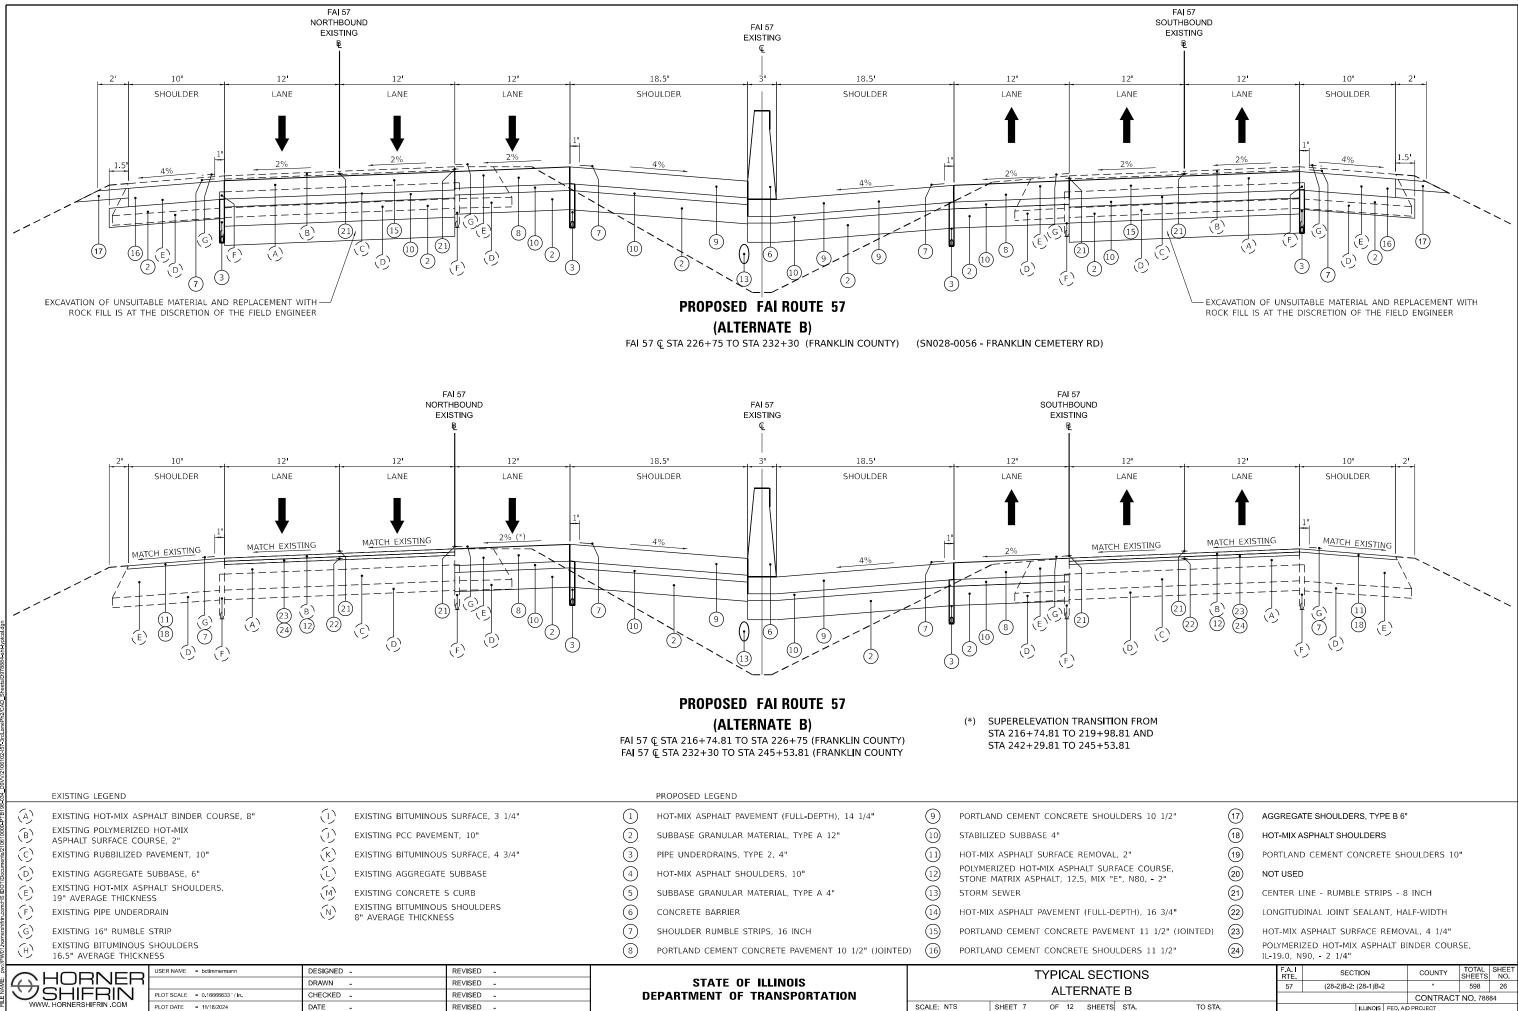
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DGE	REPLACEMENT)

TE B		57 (28-2)B-2; (28-1)B-2 * 598 25					
CTIONS		F.A. I SECTION COUNTY TOTAL SHEET NO.					
OULDERS 11 1/2"	24)	POLYMERIZED HOT-MIX ASPHALT BINDER COURSE, IL-19.0, N90, - 2 1/4"					
/EMENT 11 1/2" (JOINTED)	23	HOT-MIX ASPHALT SURFACE REMOVAL, 4 1/4"					
DEPTH), 16 3/4"	22	LONGITUDINAL JOINT SEALANT, HALF-WIDTH					
	(21)	CENTER LINE - RUMBLE STRIPS - 8 INCH					
JRFACE COURSE, ("E", N80, - 2"	20	NOT USED					
/AL, 2"	(19)	PORTLAND CEMENT CONCRETE SHOULDERS 10"					
	(18)	HOT-MIX ASPHALT SHOULDERS					
OULDERS 10 1/2"	(17)	AGGREGATE SHOULDERS, TYPE B 6"					



LOT DATE = 11/18/2024

DATE

REVISED


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SCALE: NTS

SHEET 7

OULDERS 10 1/2"	(17)	AGGREGATE SHOULDERS, TYPE B 6"						
	(18)	HOT-MIX ASPHALT SHOULDERS						
/AL, 2"	(19)	PORTLAND CEMENT CONCRETE SHOULDERS 10"						
JRFACE COURSE, : "E", N80, - 2"	20	NOT USED						
	(21)	CENTER LINE - RUMBLE STRIPS - 8 INCH						
-DEPTH), 16 3/4"	22	LONGITUDINAL JOINT SEALANT, HALF-WIDTH						
/EMENT 11 1/2" (JOINTED)	23	HOT-MIX ASPHALT SURFACE REMOVAL, 4 1/4"						
OULDERS 11 1/2"	24)	POLYMERIZED HOT-MIX ASPHALT BINDER COURSE, IL-19.0, N90, - 2 1/4"						
CTIONS			F.A.I RTE	SECTION	COUNTY	TOTAL SHEETS	SHEET NO.	
TE B			57	(28-2)B-2; (28-1)B-2	*	598	26	
					CONTRACT	NO. 788	84	

ILLINOIS FED. AID PROJECT FRANKLIN/JEFFERSO

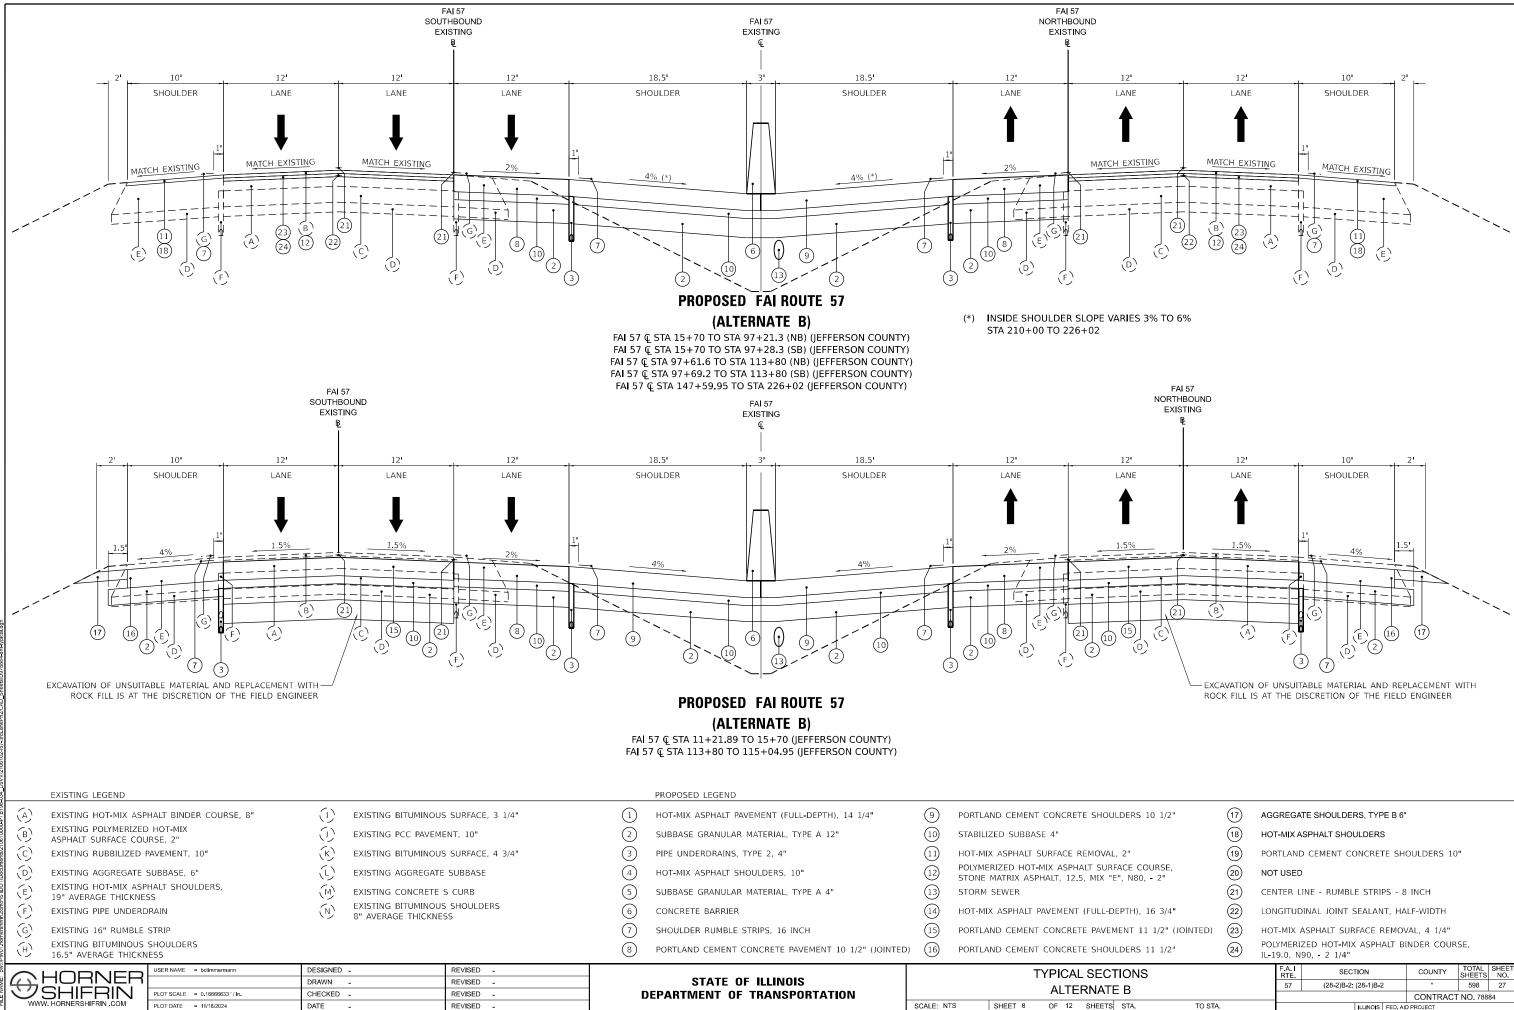


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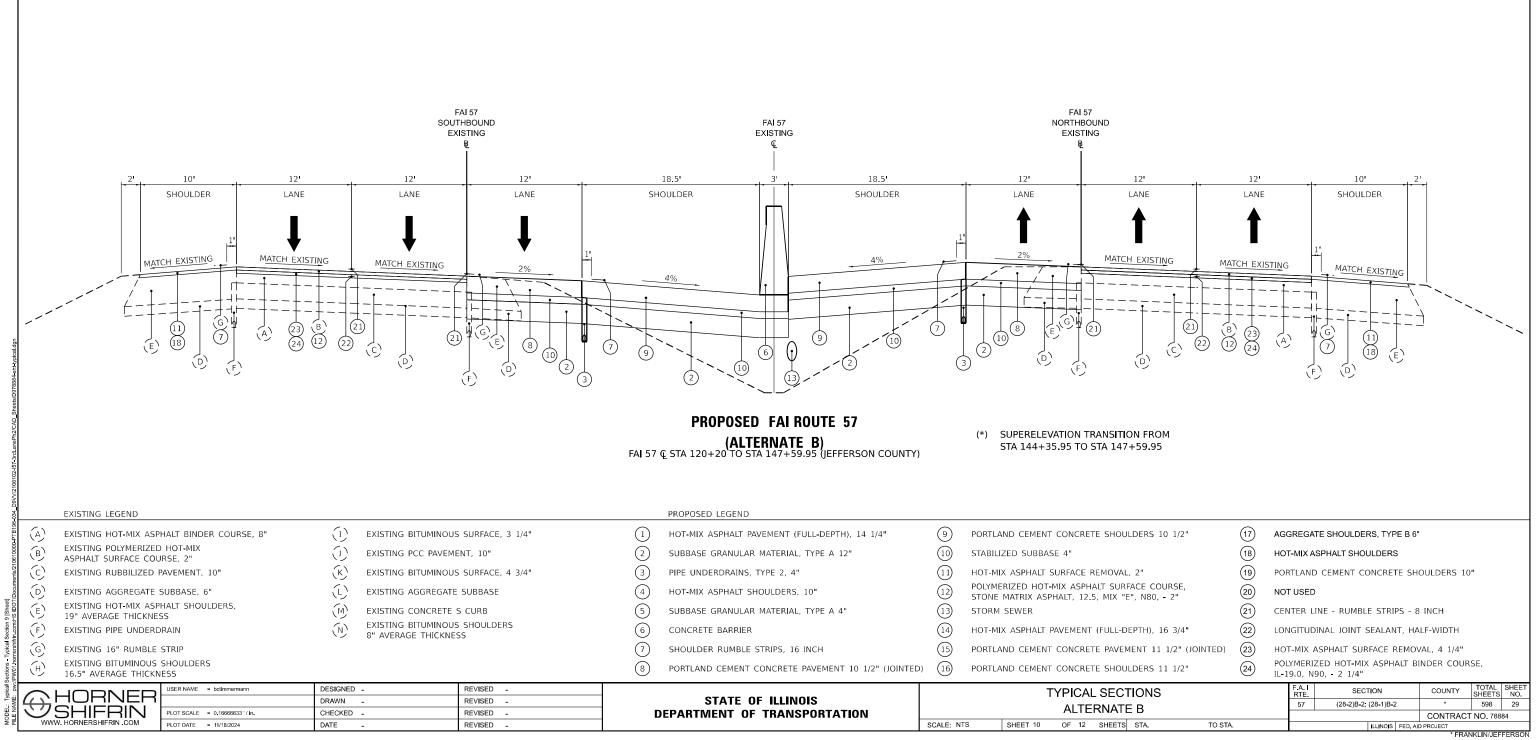
TS STA. TO STA.			ILLINOIS FED. AI	D PROJECT				
				CONTRACT	NO. 788	84		
ATE B		57	(28-2)B-2; (28-1)B-2	*	598	27		
CTIONS		F.A.I RTE	SECTION	COUNTY	TOTAL SHEETS	SHEET NO.		
OULDERS 11 1/2"	(24)		ZED HOT-MIX ASPHALT BI 90, - 2 1/4"	INDER COUR	SE,			
VEMENT 11 1/2" (JOINTED)	23	HOT-MIX ASPHALT SURFACE REMOVAL, 4 1/4"						
L-DEPTH), 16 3/4"	22	LONGITUDINAL JOINT SEALANT, HALF-WIDTH						
	21	CENTER LINE - RUMBLE STRIPS - 8 INCH						
URFACE COURSE, ("E", N80, - 2"	20	NOT USED						
VAL, 2"	(19)	PORTLANE	CEMENT CONCRETE SH	OULDERS 10				
	(18)	HOT-MIX A	SPHALT SHOULDERS					
OULDERS 10 1/2"	(17)	AGGREGATE SHOULDERS, TYPE B 6"						

* FRANKLIN/JEFEERSON




OULDERS 10 1/2"	(17)	AGGREGATE SHOULDERS, TYPE B 6"							
	(18)	HOT-M	MIX A	SPHALT SHOULDERS					
/AL, 2"	(19)	PORTI	LAND	CEMENT CONCRETE SH	OULDERS 10				
JRFACE COURSE, : "E", N80, - 2"	20	NOT L	JSED						
	(21)	CENT	CENTER LINE - RUMBLE STRIPS - 8 INCH						
-DEPTH), 16 3/4"	22	LONG	LONGITUDINAL JOINT SEALANT, HALF-WIDTH						
/EMENT 11 1/2" (JOINTED)	23	HOT-I	MIX A	SPHALT SURFACE REMO	/AL, 4 1/4"				
OULDERS 11 1/2"	24)			ZED HOT-MIX ASPHALT BI 90, - 2 1/4"	NDER COUR	SE,			
CTIONS			.A. I RTE	SECTION	COUNTY	TOTAL SHEETS	SHEET NO.		
TE B			57	(28-2)B-2; (28-1)B-2	*	598	28		
					CONTRACT	NO. 788	84		


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SOUTHBOUND REND LAKE REST AREA RAMPS FAI 57 Ç STA 112+38.4 TO STA 116+94.2 (RAMP "A")

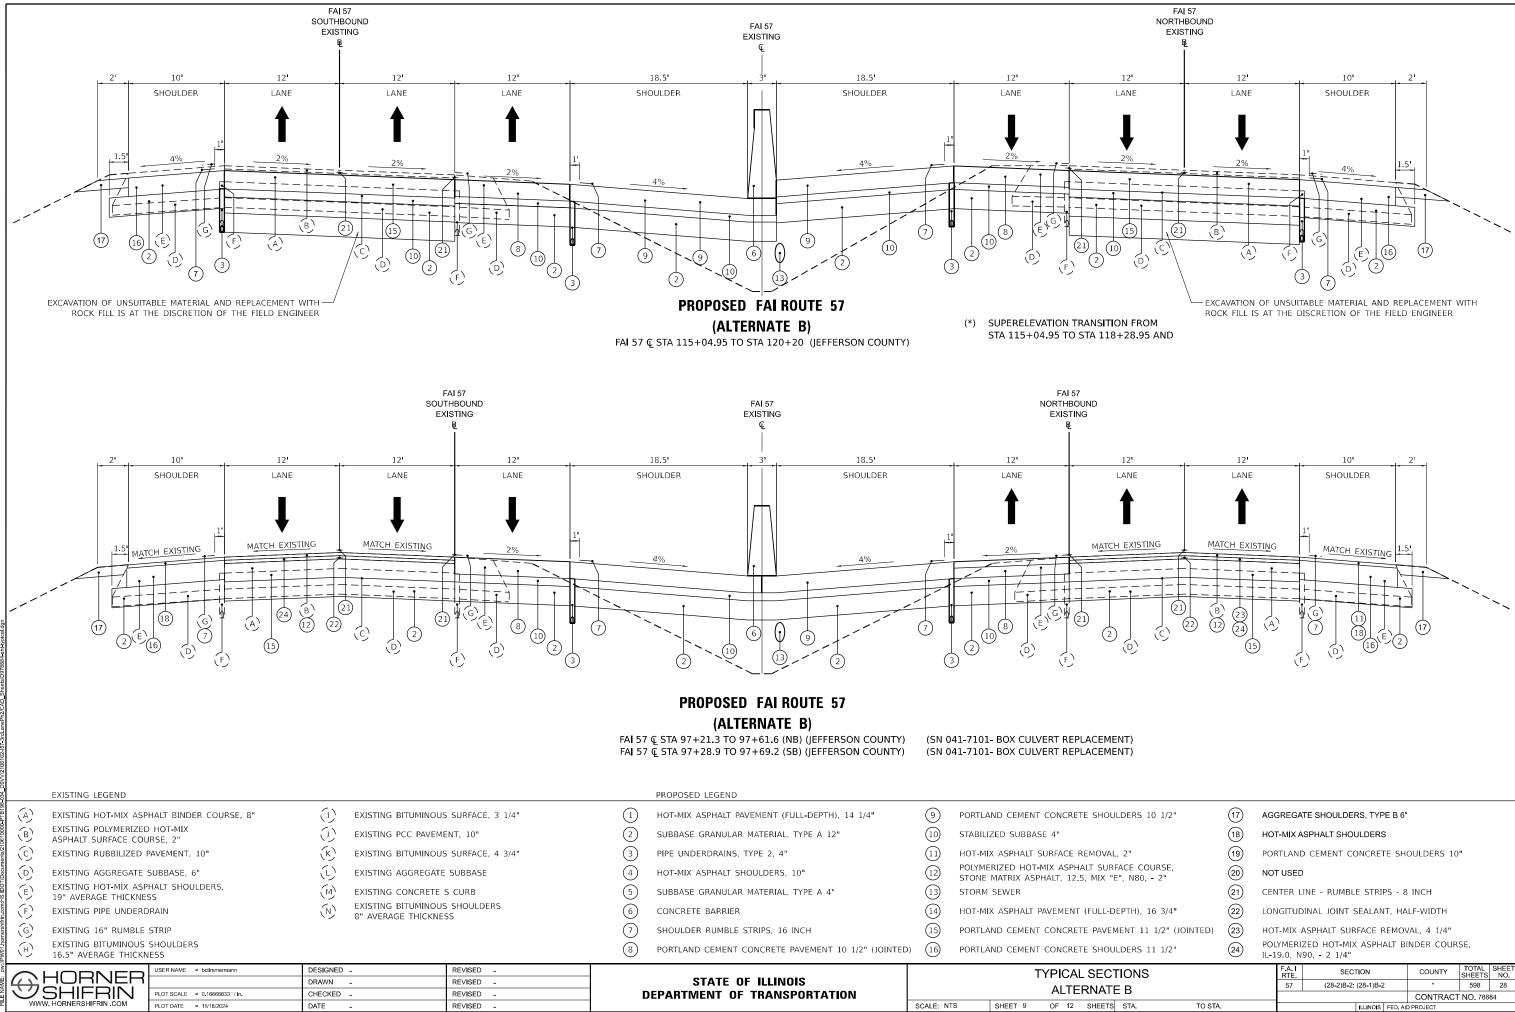


16' 10' 10' (LOOKING IN DIRECTION OF TRAVEL) 4' MATCH EXISTING (11)(12) (\mathbf{I}) (\bigcirc) (17) \odot 2

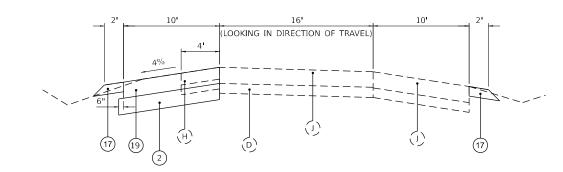SOUTHBOUND REND LAKE REST AREA RAMPS

FAI 57 & STA 111+71.2 TO STA 112+38.4 (RAMP "A")

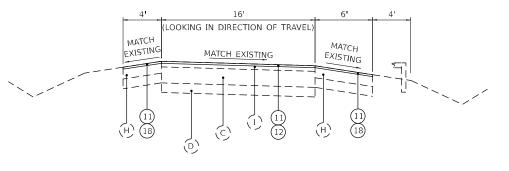PLOT DATE = 11/18/2024

DATE

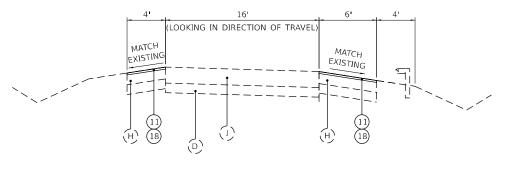

	EXISTING LEGEND				PROPOSED LEGEND		
COCOCOCOCOCOCOCOCOCOCOCOCOCOCOCOCOCOCO	EXISTING HOT-MIX ASPHALT BINDER COURSE, 8" EXISTING POLYMERIZED HOT-MIX ASPHALT SURFACE COURSE, 2" EXISTING RUBBILIZED PAVEMENT, 10" EXISTING AGGREGATE SUBBASE, 6" EXISTING HOT-MIX ASPHALT SHOULDERS, 19" AVERAGE THICKNESS EXISTING PIPE UNDERDRAIN EXISTING 16" RUMBLE STRIP EXISTING BITUMINOUS SHOULDERS 16.5" AVERAGE THICKNESS	 EXISTING BITUMINOUS EXISTING PCC PAVEMINOUS EXISTING BITUMINOUS EXISTING AGGREGATE EXISTING CONCRETE EXISTING BITUMINOUS 8" AVERAGE THICKNE 	ENT, 10" 5 SURFACE, 4 3/4" 5 SUBBASE 5 CURB 5 SHOULDERS	1 2 3 4 5 6 7 8	HOT-MIX ASPHALT PAVEMENT (FULL-DEPTH), 14 1/4" SUBBASE GRANULAR MATERIAL, TYPE A 12" PIPE UNDERDRAINS, TYPE 2, 4" HOT-MIX ASPHALT SHOULDERS, 10" SUBBASE GRANULAR MATERIAL, TYPE A 4" CONCRETE BARRIER SHOULDER RUMBLE STRIPS, 16 INCH PORTLAND CEMENT CONCRETE PAVEMENT 10 1/2" (JOINTED)	10 STA 11 HOT 12 POL STO 3 13 STO 14 HOT 15 POR	TLAND CEMENT CONCRETE SHOULD BILIZED SUBBASE 4" MIX ASPHALT SURFACE REMOVAL, 3 YMERIZED HOT-MIX ASPHALT SURFA INE MATRIX ASPHALT, 12.5, MIX "E", RM SEWER MIX ASPHALT PAVEMENT (FULL-DEF TLAND CEMENT CONCRETE PAVEME TLAND CEMENT CONCRETE SHOULD
\heartsuit	USER NAME = bclimmermann USER NAME = bclimmermann PLOT SCALE = 0.16666633 '/in. PLOT DATE = 11/18/2024	DESIGNED - DRAWN - CHECKED - DATE	REVISED - REVISED - REVISED -		STATE OF ILLINOIS DEPARTMENT OF TRANSPORTATION	SCALE: NTS	TYPICAL RAMP SE ALTERNATE A

REVISED -

SOUTHBOUND REND LAKE REST AREA RAMPS


FAI 57 & STA 130+10.6 TO STA 131+00.5 (RAMP "B")

SOUTHBOUND REND LAKE REST AREA RAMPS

FAI 57 © STA 127+46.7 TO STA 130+10.6 (RAMP "B")


	SCALE: NT	"S SHEET 11 OF 12 SHEETS STA. TO STA		ILLINOIS FED. AID PROJECT
L				CONTRACT NO. 78884
		ALTERNATE A & B		57 (28-2)B-2; (28-1)B-2 * 598 30
Ι		TYPICAL RAMP SECTIONS		F.A. I SECTION COUNTY TOTAL SHEET NO.
D)	(16)	PORTLAND CEMENT CONCRETE SHOULDERS 11 1/2"	24	POLYMERIZED HOT-MIX ASPHALT BINDER COURSE, IL-19.0, N90, - 2 1/4"
	(15)	PORTLAND CEMENT CONCRETE PAVEMENT 11 1/2" (JOINTED)	23	HOT-MIX ASPHALT SURFACE REMOVAL, 4 1/4"
	(14)	HOT-MIX ASPHALT PAVEMENT (FULL-DEPTH), 16 3/4"	22	LONGITUDINAL JOINT SEALANT, HALF-WIDTH
	13	STORM SEWER	(21)	CENTER LINE - RUMBLE STRIPS - 8 INCH
	12	POLYMERIZED HOT-MIX ASPHALT SURFACE COURSE, STONE MATRIX ASPHALT, 12.5, MIX "E", N80, - 2"	20	NOT USED
	(11)	HOT-MIX ASPHALT SURFACE REMOVAL, 2"	(19)	PORTLAND CEMENT CONCRETE SHOULDERS 10"
	(10)	STABILIZED SUBBASE 4"	(18)	HOT-MIX ASPHALT SHOULDERS
	9	PORTLAND CEMENT CONCRETE SHOULDERS 10 1/2"	(17)	AGGREGATE SHOULDERS, TYPE B 6"

* FRANKLIN/JEFFERSON

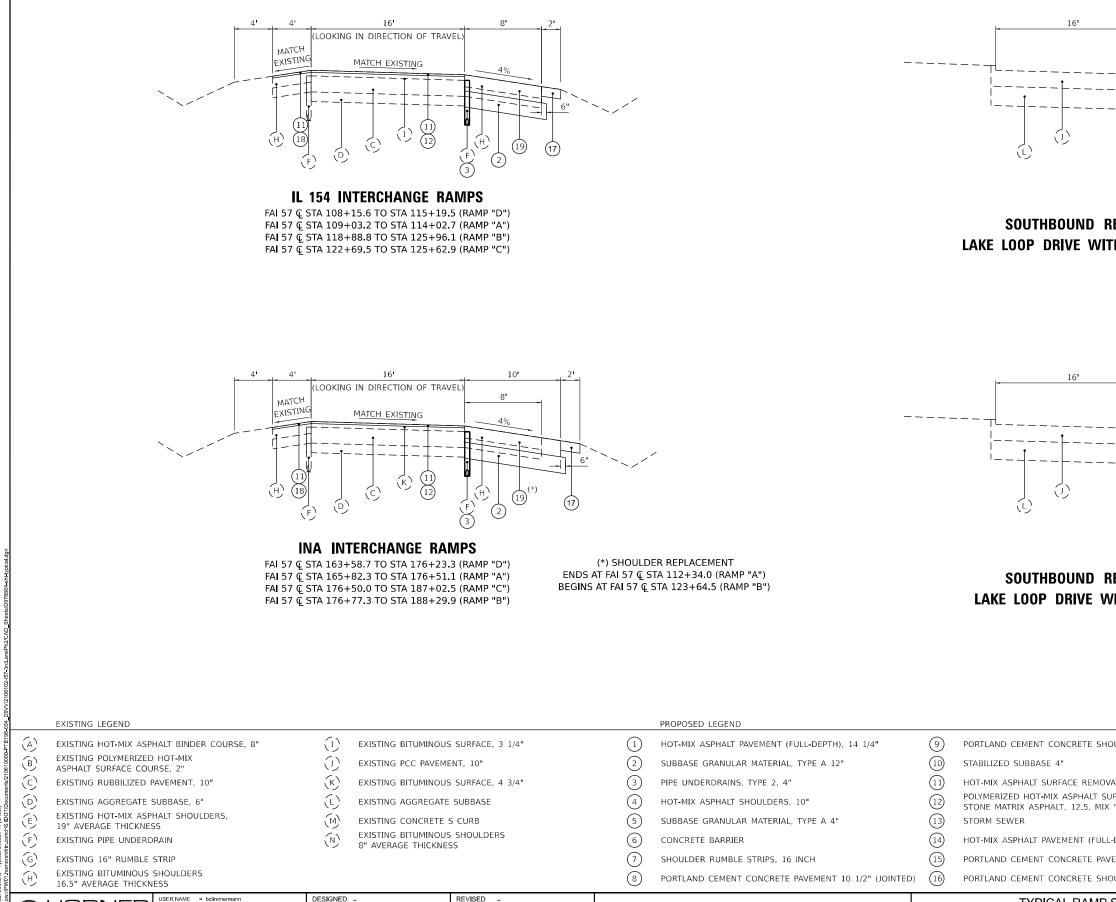

	USER NAME = bctimmermann	DESIGNED -	REVISED -	
TURNER		DRAWN -	REVISED -	
シSHIFRIN	PLOT SCALE = 0.16666633 ' / in.	CHECKED -	REVISED -	DEI
WWW. HORNERSHIFRIN .COM	PLOT DATE = 11/18/2024	DATE -	REVISED -	


TYPICAL RAMP STATE OF ILLINOIS ALTERNATE PARTMENT OF TRANSPORTATION SHEET 12 OF 12 SHEETS STA. SCALE: NTS

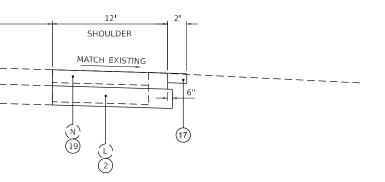

SOUTHBOUND REND LAKE REST AREA LAKE LOOP DRIVE WITHOUT EX CONCRETE S-CURB

16'

16'

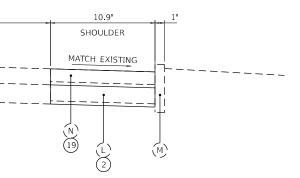

SOUTHBOUND REND LAKE REST AREA LAKE LOOP DRIVE WITH EX CONCRETE S-CURB

OULDERS 10 1/2"	(17)	AGGREGATE SHOULDERS, TYPE B 6"							
	(18)	HOT-MIX ASPHALT SHOULDERS							
/AL, 2"	(19)	PORTL	AND	CEMENT CO	DNCRETE SH	OULDERS 10			
JRFACE COURSE, 	20	NOT U	NOT USED						
	(21)	CENTER LINE - RUMBLE STRIPS - 8 INCH							
-DEPTH), 16 3/4"	(22)	LONGITUDINAL JOINT SEALANT, HALF-WIDTH							
/EMENT 11 1/2" (JOINTED)	23	НОТ-№	A XII	SPHALT SUR	FACE REMO	/AL, 4 1/4"			
OULDERS 11 1/2"	24			ED HOT-MIX 90, 2 1/4"	asphalt bi	NDER COUR	SE,		
SECTIONS			A.I TE.	SECT	FION	COUNTY	TOTAL SHEETS	SHEET NO.	
EA&B			57	(28-2)B-2;	(28-1)B-2	*	598	31	
						CONTRACT	NO. 788	84	
TS STA. TO STA.					ILLINOIS FED. AI	D PROJECT			

* FRANKLIN/JEFFERSON

FRANKLIN COUNTY 9+78.11 TO 50+00.00 TO 101+64.00 TO 103+75.50 TO	STATION 50+00.00 101+64.00	EARTH EXCAVATION CU YD	AVERAGE SHR I NKAGE FACTOR %	EARTH EXCAVATION (ADJUSTED)	EMBANKMENT	EARTHWORK EXCAVATION REQUIRED TO	EXCESS	REMARKS
STATION TO FRANKLIN COUNTY 9+78.11 TO 50+00.00 TO 101+64.00 TO 103+75.50 TO TO 103+75.50	50+00.00	EXCAVATION	SHR I NKAGE FACTOR	EXCAVATION	EMBANKMENT		EVCESS	REMARK S
FRANKLIN COUNTY 9+78.11 TO 50+00.00 TO 101+64.00 TO 103+75.50 TO	50+00.00	CU YD	%			COMPLETE	EXCAVATION	
FRANKLIN COUNTY 9+78.11 TO 50+00.00 TO 101+64.00 TO 103+75.50 TO				CU YD	CU YD	CU YD	CU YD	
50+00.00 TO 101+64.00 TO 103+75.50 TO								
50+00.00 TO 101+64.00 TO 103+75.50 TO		6709	0.90	6038	3018	0	3020	EXCESS EXCAVATION TO BE USED AS FILL IN JEFFERSON COUNTY
103+75.50 TO		7109	0.90	6398	6045	0	353	EXCESS EXCAVATION TO BE USED AS FILL IN JEFFERSON COUNTY
	103+75.50			BRIDGE OMISSI	ON (GUN CREEK)	1		
150,00 00 TO	150+00.00	6894	0.90	6204	4177	0	2027	EXCESS EXCAVATION TO BE USED AS FILL IN FRANKLIN COUNTY
	200+00.70	6627	0.90	5964	4832	0	1132	EXCESS EXCAVATION TO BE USED AS FILL IN JEFFERSON COUNTY
200+00.70 TO	250+00.00	5925	0.90	5333	6411	-1078	0	USE EXCAVATION FROM FRANKLIN COUNTY
250+00.00 TO	303+38.06	8294	0.90	7464	3080	0	4385	EXCESS EXCAVATION TO BE USED AS FILL IN JEFFERSON COUNTY
303+38.06 TO	305+11.94			BRIDGE OMISSION	(MARCUM BRANCH	1)		
305+11.94 TO	307+46.00	456	0.90	410	6	0	405	EXCESS EXCAVATION TO BE USED AS FILL IN JEFFERSON COUNTY
REST AREA RAMPS & LO	OOP ROAD	744	0.90	669	0	0	669	
IL-154 INTERCHANGE	E RAMPS	1588	0.90	1430	0	0	1430	
MOT STAGE 2		677	0.90	609	0	0	609	
MOT STAGE 5 &	ε 6	7895	0.90	7106	0	0	7106	
FRANKLIN CC	OUNTY TOTAL	52920						
JEFFERSON COUNTY								
	50+00.00	5791	0.90	5212	5834	-623	0	USE EXCAVATION FROM FRANKLIN COUNTY
50+00.00 TO	100+00.00	6268	0.90	5641	8091	-2450	0	USE EXCAVATION FROM FRANKLIN COUNTY
	150+00.00	7686	0.90	6917	9582	-2664	0	USE EXCAVATION FROM FRANKLIN COUNTY
150+00.00 TO	200+00.00	6395	0.90	5755	8060	-2305	0	USE EXCAVATION FROM FRANKLIN COUNTY
200+00.00 TO	226+02.50	3688	0.90	3319	3110	0	210	EXCESS EXCAVATION TO BE USED AS FILL IN JEFFERSON COUNTY
INA INTERCHANGE	RAMPS	638	0.90	574	0	0	574	
MOT STAGE 2		269	0.90	242	0	0	242	+
MOT STAGE 5 &		3694	0.90	3325	0	0	3325	-
JEFFERSON CC	OUNTY TOTAL	34430						
	OJECT TOTAL	87350						

	USER NAME = bctimmermann	DESIGNED -	REVISED -				SCHEDULE		F.A. I RTF	SECTION	COUNTY	TOTAL SHEET SHEETS NO.
CHURNER		DRAWN -	REVISED -	STATE OF ILLINOIS					57	(28-2)B-2; (28-1)B-2	*	598 32
SHIFHIN	PLOT SCALE = 0.16666633 ' / in.	CHECKED -	REVISED -	DEPARTMENT OF TRANSPORTATION						. , ,	CONTRAC	T NO. 78884
WWW. HORNERSHIFRIN .COM	PLOT DATE = 11/18/2024	DATE -	REVISED -	SCAI	SCALE: NTS	SHEET 1	OF 37 SHEETS STA.	TO STA.		ILLINOIS FED. AID) PROJECT	

		TF	REE REMOVALS		
	LOCATIO	۷	TREE REMOVAL , ACRES	TREE REMOVAL (6 TO 15 UNITS DIAMETER)	TREE REMOVAL (OVER 15 UNITS DIAMETER)
STATION	ТО	STATION	ACRES	UNITS	UNITS
FRANKLIN COU					
<u>c</u>	SOUTHBOUN	D			
11+58.00	то	12+30.00	0.009		
15+10.00	то	15+37.00	0.004		
17+64.00	то	18+10.00	0.002		
26+10.00	ТО	26+90.00	0.004		
29+95.00	то	33+34.00	0.022		
34+25.00	то	35+31.00	0.010		
36+13.00	то	43+29.00	0.147		
43+88.00	ТО	47+04.00	0.054		
116+42.00	то	117+04.00	0.006		
117+37.00	то	180+10.00	1.414		
196+50.00	то	197+42.00	0.017		
221+97.00	то	224+28.00	0.048		
249+44.00	то	249+73.00	0.003		
256+56.00	то	260+23.00	0.058		
267+57.00	то	269+18.00	0.013		
276+62.00	то	277+22.00	0.021		
277+48.00	то	279+10.00	0.051		
280+60.00	то	283+14.00	0.046		
283+60.00	то	294+79.00	0.326		
1	ORTHBOUN	D			
197+75.00	то	197+99.00	0.001		
227+83.00	TO	228+53.00	0.004		
239+28.00	то	242+25.00	0.021		
243+00.00	TO	243+38.00	0.003		
251+20.00	то	253+19.00	0.016		
256+79.00	то	261+75.00	0.137		
267+61.00	то	271+76.00	0.108		
282+95.00	TO	283+12.00	0.002		
284+68.00	ТО	287+88.00	0.051		
288+32.00	то	288+64.00	0.002		
289+11.00	то	290+69.00	0.019		
293+82.00	TO	295+37.00	0.057		
SOUTH BOUND				6	
SOUTH BOUND	REST AREA	4			18
	ED 41/// 11		2 75	-	
	FRANKLIN	COUNTY TOTAL	2.75	6	18

NOTE: ALL TREE REMOVAL SHOWN ARE TO BE REMOVED WITHIN 40 FEET FROM SHOULDER EDGE OF PAVEMENT. ACTUAL NEED FOR ADDITIONAL TREE REMOVAL AT LOCATIONS NOT LISTED IN SCHEDULE WILL BE DETERMINED IN FIELD AT TIME OF CONSTRUCTION BY THE ENGINEER. ANY QUANTITY NOT NEEDED FOR TREE REMOVAL AT TIME OF CONSTRUCTION SHALL BE DELETED FROM THE CONTRACT.

STATION DEFFERSON COUL SC S6 58+59.00 76+04.00 77+82.00 84+32.00 99+76.00 1000000000000000000000000000000000000	DUTHBOUN	N STATION	TREE REMOVAL, ACRES	TREE REMOVAL (6 TO 15 UNITS	TREE REMOVA (OVER 15
JEFFERSON COUI 58+59.00 76+04.00 77+82.00 84+32.00 99+76.00		STATION		DIAMETER)	UNITS DIAMETER)
58+59.00 76+04.00 77+82.00 84+32.00 99+76.00	DUTHBOUN		ACRES	UNITS	UNITS
58+59.00 76+04.00 77+82.00 84+32.00 99+76.00					
76+04.00 77+82.00 84+32.00 99+76.00					
77+82.00 84+32.00 99+76.00	то	58+97.00	0.007		
84+32.00 99+76.00	то	76+64.00	0.007		
99+76.00	TO	81+74.00	0.108		
	TO	84+90.00	0.004		
	TO	105+25.00	0.101		
144+82.00 147+05.00	то то	145+07.00 151+51.00	0.001		-
157+41.00	то то	161+68.00	0.103		
170+95.00	то	173+45.00	0.036		
174+45.00	то	174+66.00	0.001		
175+16.00	то	175+53.00	0.004		
176+23.00	TO	176+71.00	0.002		
177+27.00	ТО	177+85.00	0.010		
181+63.00	то	181+97.00	0.002		
183+29.00	то	183+58.00	0.001		
184+15.00	TO	184+67.00	0.003		
200+34.00	ΤO	209+13.00	0.223		
209+31.00	то	211+03.00	0.033		
213+63.00	то	214+14.00	0.008		
214+52.00	ТО	217+75.00	0.042		
		ID			
139+96.00	DRTHBOUN TO	140+22.00	0.001		
140+87.00	TO	140+22.00	0.019		
144+16.00	то	144+65.00	0.005		
145+48.00	то	147+70.00	0.057		
149+41.00	TO	149+98.00	0.008		-
150+74.00	ТО	151+77.00	0.013		
152+28.00	TO	154+67.00	0.064		
155+01.00	ТО	156+17.00	0.035		
158+64.00	TO	159 + 00.00	0.004		
162+05.00	ТО	163+28.00	0.030		
173+77.00	TO	176+81.00	0.076		
177+19.00	TO	177+52.00	0.007		
182+37.00	TO	184+78.00	0.043		
185+41.00	TO	185+90.00	0.002		
188+56.00	TO	188+75.00	0.001		
197+88.00 201+27.00	то то	198+41.00 202+08.00	0.006		
209+47.00	то	202+08.00	0.031		
211+03.00	то	217+29.00	0.166		
219+04.00	то	220+95.00	0.031		
222+29.00	то	223+71.00	0.027		
			0.02.		-
JE	FFERSON	I COUNTY TOTAL	1.50	0	0
				4	1

				SEEDING					
LOCATION	SEEDING, CLASS 4	SEEDING, CLASS 7	MULCH, METHOD 2	TEMPORARY EROSION CONTROL SEEDING	NITROGEN FERTILIZER NUTRIENT	PHOSPHORUS FERTILIZER NUTRIENT		AGR I CULTURAL GROUND L IMESTONE	
STATION TO STATION S	IDE ACRE	ACRE	ACRE	POUND	POUND	POUND	POUND	TON	
FRANKLIN COUNTY									
EXCAVATION WASTE AREA #1									1
SW QUADRANT (IL 154 INTERCHA	NGE) 4.98	4.98	4.98	497.9	448.1	448.1	448.1	9.96	
FRANKLIN COUNTY	TOTAL 5.00	5.00	5.00	498	449	449	449	10.0	
JEFFERSON COUNTY									
JEFFERSON COUNTY	0.00	0.00	0.0	0	0	0	0.0		
PROJECT	TOTAL 5.00	5.00	5.00	498	449	449	449	10.0	

	USER NAME = jahaas	DESIGNED -	REVISED -				SCI	HEDULE		F.A. I BTE	SECTION	COUNTY	TOTAL	SHEET
		DRAWN -	REVISED -	STATE OF ILLINOIS			001			57	(28-2)B-2; (28-1)B-2	*	598	33
	PLOT SCALE = 0.166666633 ' / in.	CHECKED -	REVISED -	DEPARTMENT OF TRANSPORTATION								CONTRACT	NO 7888	,4
WWW. HORNERSHIFRIN .COM	PLOT DATE = 10/15/2024	DATE -	REVISED -		SCALE: NTS	SHEET 2	OF 37	SHEETS STA.	TO STA.		ILLINOIS FED. A	D PROJECT		

RAL IE	PER IMETER EROS I ON BARR I ER
	FOOT
	1876
	1876
	r
	0
	r
	1876

	L	OCATION		PAVEMENT REMOVAL	PAVED SHOULDER	HOT - MIX ASPHALT SURFACE	HOT - MIX ASPHALT SURFACE
				RENO WILL	REMOVAL	REMOVAL, 2"	REMOVAL, 4 1/4"
STATION RANKLIN COUNTY	TO	STATION	SIDE	SQ YD	SQ YD	SQ YD	SQ YD
	50	DUTHBOUND					
9+78.11	TO	12+40.00	INSIDE SHLDR	696.5	103.8		
9+78.11 12+40.00	то то	12+40.00 50+00.00 BK	OUTSIDE SHLDR INSIDE SHLDR		290.2 1,642.1		10,026.7
49+99.31 AH	то	99+40.00 BK	INSIDE SHLDR		2,282.0		13,175.2
99+40.00	TO	101+49.25	OUTSIDE SHLDR	598.0	249.2		
99+40.00	ТО	101+64.25	INSIDE SHLDR		101.8		
BF 103+90.75	TO	SSION (GUN CREEK 106+00.00) OUTSIDE SHLDR	648.3	209.2		
103+75.75	то	106+00.00	INSIDE SHLDR	040.5	93.7		
106+00.00	TO	173+85.00	INSIDE SHLDR		3,218.5		18,039.7
173+85.00	TO	176+14.31 BK	INSIDE SHLDR	609.3	99.5		
176+15.00 AH 173+85.00	то то	179+15.00 176+14.31 BK	INSIDE SHLDR OUTSIDE SHLDR	800.0	136.9 253.5		
176+15.00 AH	то	179+15.00	OUTSIDE SHLDR		333.3		
179+15.00	TO	200+00.00 BK	INSIDE SHLDR		996.5		5,560.0
200+00.70 AH 226+75.00	то то	226+75.00 232+30.00	INSIDE SHLDR INSIDE SHLDR	1.491.3	1,234.1		7,146.7
226+75.00	то	232+30.00	OUTSIDE SHLDR	1,491.3	623.2		
232+30.00	то	242+97.43 BK	INSIDE SHLDR		528.5		2,868.4
243+00.98 AH	то	280+75.00	INSIDE SHLDR	1 200 -	1,795.0		10,064.1
280+75.00 280+75.00	то то	285+95.00 285+95.00	INSIDE SHLDR OUTSIDE SHLDR	1,386.7	244.7 577.8		
285+95.00	то	301+40.00	INSIDE SHLDR		746.9		4,120.0
301+40.00	то	303+22.92	OUTSIDE SHLDR	590.2	255.9		
301+40.00 BB II	TO DGE OMISS	303+37.92 ION (MARCUM BRAN	INSIDE SHLDR		99.2		
305+12.07	TO	307+46.00	OUTSIDE SHLDR	561.4	223.9	<u> </u>	
305+12.07	ТО	307+00.00	INSIDE SHLDR		72.6		
	N	ORTHBOUND					
9+78.11	TO	12+40.00	INSIDE SHLDR	696.5	102.4		
9+78.11 12+40.00	то то	12+40.00 50+00.00 BK	OUTSIDE SHLDR INSIDE SHLDR		290.2 1,538.6		10,026.7
49+99.31 AH	то	99+40.00 BK	INSIDE SHLDR		2,238.1		13,175.2
99+40.00	TO	101+49.25	OUTSIDE SHLDR	598.0	249.2		
99+40.00 BE	TO TO E OMI	101+64.25 SSION (GUN CREEK	INSIDE SHLDR		96.5		
103+90.75	TO	106+00.00	OUTSIDE SHLDR	597.9	248.7		
103+75.75	то	106+00.00	INSIDE SHLDR		98.0		10.10
106+00.00 173+85.00	то то	173+85.00 176+14.31 BK	INSIDE SHLDR INSIDE SHLDR	613.7	3,088.3 116.6		12,424.6
176+15.00 AH		179+15.00	INSIDE SHLDR	800.0	135.6		
173+85.00	TO	176+14.31 BK	OUTSIDE SHLDR		256.1		
176+15.00 AH 179+15.00	TO	179+15.00	OUTSIDE SHLDR		333.3		E 500 0
200+00.70 AH	то то	200+00.00 BK 226+75.00	INSIDE SHLDR INSIDE SHLDR		966.3 1,174.3		5,560.0 7,116.3
226+75.00	то	232+30.00	INSIDE SHLDR	1,468.7	205.2		,
226+75.00	то	232+30.00	OUTSIDE SHLDR		610.1		2
232+30.00 243+00.98 AH	то то	242+97.43 BK 280+75.00	INSIDE SHLDR INSIDE SHLDR		491.5 1,765.0		2,824.6
280+75.00	то	285+95.00	INSIDE SHLDR	1,386.7	228.2		10,004.1
280+75.00	ТО	285+95.00	OUTSIDE SHLDR		577.8		
285+95.00	TO	300+75.00	INSIDE SHLDR		670.2		3,945.9
300+75.00 300+75.00	то то	302+87.84 303+37.92	OUTSIDE SHLDR INSIDE SHLDR	638.2	256.1 101.0		
BRII		ION (MARCUM BRAN	ICH)				
305+12.07 305+12.07	то то	307+19.00 307+00.00	OUTSIDE SHLDR INSIDE SHLDR	614.2	265.9 90.1		
		N CROSSOVERS					
20+00.00				259.2			
76+35.00				266.7			
215+70.00		I		263.0			
B REST AREA LO	DP ROAD	RAMPS			1,435.7		
AMP A - SB REST	AREA	1					
106+00.00 111+69.80	то то	<u>111+71.20</u> <u>112+35.10</u>				116.7	1,411.6
111+71.20	то	112+33.10	LT SHLDR		276.3	110.7	
AMP B - SB REST 127+46.70	TO	131+00.50	LT SHLDR			180.4	

				PAVEMENT AND	SHOULDER REM	OVAL		
MIX IALT FACE VAL, / 4"		Ľ	OCATION		PAVEMENT REMOVAL	PAVED SHOULDER REMOVAL	HOT -M1X ASPHALT SURFACE REMOVAL, 2"	HOT-MIX ASPHALT SURFACE REMOVAL, 4 1/4"
YD	STATION	ТО	STATION	SIDE	SQ YD	SQ YD	SQ YD	SQ YD
	130+10.60	то	131+00.50				162.3	
	131+00.50	то	142+31.60					1,528.0
	RAMP A - IL 154	1	1					1 420 4
26.7	155+94.10 165+82.30	то то	165+82.30 176+53.30				2,425.4	1,429.4
75.2	165+82.30	то	176+53.30	LT SHLDR			602.6	
	165+82.30	то	176+53.30	RT SHLDR		1,172.7		
	RAMP B - IL 154	INTERCHAN	IGE					
	176+77.30	то	188+29.90				2,535.9	
	176+77.30	то	188+29.90	LT SHLDR			622.9	
20.7	176+77.30 188+29.90	TO	188+29.90 194+87.70	RT SHLDR		1,201.1		1 260 9
39.7	RAMP C - IL I54							1,369.8
	176+51.80	TO	187+02.50				2,474.5	
	176+51.80	то	187+02.50	LT SHLDR			570.9	
	176+51.80	ТО	187+02.50	RT SHLDR		1,116.6		
50.0	187+02.50	то	196+84.90					1,395.7
16.7	RAMP D - IL I54							
	157+19.80	то	163+58.70				2 6 6 9 3	1,331.1
<u>18</u> 4	163+58.70	TO	176+23.40				2,669.3	
58.4 64.1	163+58.70 163+58.70	то то	176+23.40 176+23.40	LT SHLDR RT SHLDR		1,272.3	656.7	
	103730./0		1/0723.40	I INT STILUK		1,2/2.3		
			FRANK	LIN COUNTY TOTAL	15,585	39,353	13,274	144,604
20.0			1.137.030		_0,000	,	,_,	
	JEFFERSON COUNT	Y						
			DUTHBOUND					
	11+21.89	то	15+70.00	INSIDE SHLDR	1,193.0	197.9		
	11+21.89	TO	15+70.00	OUTSIDE SHLDR		497.1		12 510 6
	15+70.00 62+65.57 AH	TO TO	62+64.51 Bk 97+28.90	INSIDE SHLDR		2,249.8 1,736.9		12,510.6 9,239.4
	62+65.57 AH 97+28.90	то	97+69.20	INSIDE SHLDR	107.4	20.8		9,239.4
	97+69.20	то	113+80.00	INSIDE SHLDR	107.4	817.6		4,291.7
	113+80.00	то	120+20.00	INSIDE SHLDR	1,711.9	328.3		
26.7	113+80.00	то	120+20.00	OUTSIDE SHLDR		714.2		
75.2	120+20.00	то	226+02.00	INSIDE SHLDR		5,485.7		28,224.1
			DRTHBOUND					
	11+21.89	то	15+70.00	INSIDE SHLDR	1,193.0	186.1		
	<u>11+21.89</u> <u>15+70.00</u>	TO TO	15+70.00 62+64.51 BK	OUTSIDE SHLDR		497.1 2,088.2		12 526 9
24.6	62+65.57 AH		62+64.51 Bk 97+28.90	INSIDE SHLDR		1,472.2		12,526.8 9,211.5
24.0	97+28.90	то	97+69.20	INSIDE SHLDR		17.1		5,211.5
	97+69.20	то	113+80.00	INSIDE SHLDR	107.4	723.0		4,319.6
	113+80.00	то	120+20.00	INSIDE SHLDR	1,701.4	282.6		
	113+80.00	то	120+20.00	OUTSIDE SHLDR		708.1		
50.0	120+20.00	то	226+02.00	INSIDE SHLDR		4,780.2		28,213.2
.6.3								
	150.25.00	MEDIA	N CROSSOVERS		226.2			
24.6	158+35.00				236.3			
64.1			RAMPS					
~	RAMP A - INA IN	TERCHANGE						
	98+59.20	ТО	109+03.20					1,417.1
15.9	109+03.20	то	114+12.20				1,033.7	
	109+03.20	то	114+12.20	LT SHLDR			261.3	
	109+03.20	ТО	114+12.20	RT SHLDR		330.8		ļ
	RAMP B - INA IN		125-06-53	_			1 400 7	
	118+85.00 118+85.00	TO TO	125+96.10 125+96.10	LT SHLDR			1,482.7 375.1	<u> </u>
	123+64.50	то	125+96.10	RT SHLDR		214.0	1.010	
	125+96.10	то	132+35.00			217.0		1,205.2
	RAMP C - INA IN							
	122+60.30	то	125+62.90				557.7	
	122+60.30	то	125+62.90	LT SHLDR			135.5	
	122+60.30	ТО	125+62.90	RT SHLDR		274.0		
	125+62.90	ТО	136+52.80					1,550.4
	RAMP D - INA IN		109:15 00					1 202 0
.1.6	101+20.70 108+15.60	TO TO	108+15.60 115+25.30				1,433.2	1,383.8
U	108+15.60	то	115+25.30	LT SHLDR			384.5	
	108+15.60	то	115+25.30	RT SHLDR		713.5	504.5	
		1.5						
			JEFFEF	SON COUNTY TOTAL	6,251	24,335	5,664	114,094
				PROJECT TOTAL	21,836	63,688	18,938	258,698
				001155111		FA		
STATE OF ILLING	DIS	1		SCHEDULE		F.A. RTE		COUNTY TOTAL
		1				57	(28-2)B-2; (28-1)E	
ARTMENT OF TRANS	PURIAIIUM							CONTRACT NO. 7

JSER NAME = jahaas

PLOT SCALE = 0.16666633 '/ in.

PLOT DATE = 10/15/2024

DESIGNED -

DRAWN -

CHECKED -

DATE -

REVISED -

REVISED -

REVISED -

REVISED -

				MAINTENANCE OF T	RAFFIC PRE-STAGE	- PAVEMENT REMOVA	L AND REPLACEMENT				
	LOCATION	PAVED SHOULDER REMOVAL	HOT-MIX ASPHALT SHOULDERS	HOT-MIX ASPHALT SHOULDERS, 10"	HOT-MIX ASPHALT EDGE LINE REPAIR, 2"	HOT-MIX ASPHALT SURFACE REMOVAL, 2"	POLYMERIZED HOT-MIX ASPHALT SURFACE COURSE, IL-9.5, MIX E, N90	MATERIAL TRANSFER DEVICE	BITUMINOUS MATERIALS (TACK COAT)	SHOULDER RUMBLE STRIPS, 8 INCH	REMARKS
STATION TO	STATION SIDE	SQ YD	TON	SQ YD	SQ YD	SQ YD	TON	TON	POUND	FOOT	
FRANKLIN COUNTY											
9+78.11 TO	SOUTHBOUND 307+46.00 (*)				6,615.1						(*)
9+78.11 TO	12+40.00 OUTSIDE SHLDR	291.0		291.0	,				196.4		BELOW EAST FRANKLIN RD OVERPASS
9+78.11 TO 12+40.00 TO	14+05.00 INSIDE SHLDR 50+00.00 BK OUTSIDE SHLDR		19.3 467.9			172.8		467.9	77.7		
49+99.31 AH TO	99+40.00 OUTSIDE SHLDR		614.8			5,489.7		614.8	2,470.3		
93+00.00 TO	101+64.25 INSIDE SHLDR	240.2	45.4	240.2		405.1			182.3		
99+40.00 TO BRIDGE OM	101+64.25 OUTSIDE SHLDR 11SSION (GUN CREEK)	249.2		249.2					168.2		AT GUN CREEK BRIDGE
103+75.75 TO	106+00.00 OUTSIDE SHLDR	249.2		249.2		100.0			168.2		AT GUN CREEK BRIDGE
103+75.75 TO 111+72.00 TO	107+65.00 INSIDE SHLDR 130+97.70 OUTSIDE SHLDR		19.0 238.9			169.3 2,133.0		238.9	<u>76.2</u> 959.8		
142+31.60 TO	157+19.80 OUTSIDE SHLDR		178.4			1,593.1		178.4	716.9		
163+61.10 TO 167+45.00 TO	173+85.00 OUTSIDE SHLDR 176+14.31 BK INSIDE SHLDR		126.9 43.1			1,132.6 384.5		126.9	509.7 173.0		
176+15.00 AH TO	180+80.00 INSIDE SHEDR		22.4			200.4			90.2		
173+85.00 TO 176+15.00 AH TO	176+14.31 BK OUTSIDE SHLDR 179+15.00 OUTSIDE SHLDR	254.8		254.8 333.3					168.2 225.0		BELOW IL 154 OVERPASS BELOW IL 154 OVERPASS
176+15.00 AH TO 179+15.00 TO	179+15.00 OUTSTDE SHLDR 186+99.20 OUTSTDE SHLDR	333.3	97.1	333.3		867.1		97.1	390.2		DELOW IL 134 UVERPASS
196+84.90 TO	200+00.00 BK OUTSIDE SHLDR		34.4			307.1		34.4	138.2		
200+00.07 AH TO 220+60.00 TO	227+00.00 OUTSIDE SHLDR 233+95.00 INSIDE SHLDR		337.0 61.4			3,009.0 548.3		337.0	1,354.0 246.7		
218+64.94 TO	242+97.43 BK OUTSIDE SHLDR					-				2,458.5	
227+00.00 TO 232+30.00 TO	232+30.00 OUTSIDE SHLDR 242+97.43 BK OUTSIDE SHLDR	588.9	134.3	588.9		1,198.7		134.3	401.3 539.4		BELOW FRANKLIN CEMETARY RD OVERPAS
243+00.98 AH TO	243+67.65 OUTSIDE SHLDR		431.3			1,150.7		131.3	555.1	66.6	
243+00.98 AH TO 274+35.00 TO	280+75.00 OUTSIDE SHLDR 287+60.00 INSIDE SHLDR		469.7 72.1			4,193.4 643.8		469.7	1,887.0 289.7		
280+75.00 TO	285+95.00 OUTSIDE SHLDR	577.8	/2.1	577.8		045.8			390.0		BELOW MARCUM BRANCH RD OVERPASS
285+95.00 TO	301+40.00 OUTSIDE SHLDR		192.3			1,716.7		192.3	772.5		
295+00.00 TO 301+40.00 TO	303+52.67 INSIDE SHLDR 303+37.92 OUTSIDE SHLDR	219.9	44.9	219.9		400.7			180.3 148.4		AT MARCUM BRANCH BRIDGE
BRIDGE OMIS	SION (MARCUM BRANCH)										
305+26.62 TO 305+12.07 TO	307+00.00 INSIDE SHLDR 307+46.00 OUTSIDE SHLDR	259.9	8.1	259.9		72.6			32.7		AT MARCUM BRANCH BRIDGE
505112.07		235.5		233.3					175.4		
9+78.11 TO	NORTHBOUND 307+19.00 (*)				6,609.1						
9+78.11 TO	12+40.00 OUTSIDE SHLDR	291.0		291.0	0,009.1				196.4		(*) BELOW EAST FRANKLIN RD OVERPASS
9+78.11 TO	18+80.00 INSIDE SHLDR		40.2			359.3		467.0	161.7		
12+40.00 TO 49+99.31 AH TO	50+00.00 BK OUTSIDE SHLDR 99+40.00 OUTSIDE SHLDR		467.9			4,177.8 5,489.7		467.9 614.8	1,880.0		
97+75.00 TO	101+64.25 INSIDE SHLDR		18.8			167.7			75.5		
99+40.00 TO BRIDGE ON	101+64.25 OUTSIDE SHLDR NISSION (GUN CREEK)	249.2		249.2					168.2		AT GUN CREEK BRIDGE
103+75.75 TO	106+00.00 OUTSIDE SHLDR	249.2		249.2					168.2		AT GUN CREEK BRIDGE
103+75.75 TO 106+00.00 TO	112+40.00 INSIDE SHLDR 155+94.10 OUTSIDE SHLDR		42.4 638.7			378.9 5,702.3		638.7	170.5		
165+86.20 TO	173+90.00 OUTSIDE SHLDR		99.8			891.0		99.8	400.9		
172+25.00 TO	176+14.31 BK INSIDE SHLDR		21.8			194.7			87.6		
176+15.00 AH TO 173+90.00 TO	185+55.00 INSIDE SHLDR 176+14.31 BK OUTSIDE SHLDR	249.2	48.2	249.2		430.7			193.8 172.0		BELOW IL 154 OVERPASS
176+15.00 AH TO	179+15.00 OUTSIDE SHLDR	333.3	112 7	333.3		1.015.1		112 7	225.0		BELOW IL 154 OVERPASS
179+15.00 TO 218+64.94 TO	188+28.20 OUTSIDE SHLDR 242+97.43 BK INSIDE SHLDR		113.7			1,015.1		113.7	456.8	2,417.4	
194+87.70 TO	200+00.00 BK OUTSIDE SHLDR		65.8			587.9		65.8	264.6		
200+00.07 AH TO 225+10.00 TO	226+75.00 OUTSIDE SHLDR 238+50.00 INSIDE SHLDR		336.4 61.8			3,003.7 552.0		336.4	1,351.7 248.4		
226+75.00 TO	232+10.00 OUTSIDE SHLDR	594.4		594.4					397.5		BELOW FRANKLIN CEMETARY RD OVERPAS
232+10.00 TO 243+00.98 AH TO	242+97.43 BK OUTSIDE SHLDR 280+75.00 OUTSIDE SHLDR		133.9 469.7			1,195.4 4,193.4		133.9 469.7	537.9		
243+00.98 AH TO	243+67.65 INSIDE SHLDR		403.7			+,100.4			1,007.0	66.7	
279+10.00 TO	292+30.00 INSIDE SHLDR	E77 0	66.7	E77 0		595.5			268.0		
280+75.00 TO 285+90.00	285+95.00 OUTSIDE SHLDR 300+75.00 OUTSIDE SHLDR	577.8	184.8	577.8		1,650.0		184.8	390.0 742.5		BELOW MARCUM BRANCH RD OVERPASS
299+10.00 TO	303+23.02 INSIDE SHLDR	202.1	19.3	202.1		172.5			77.6		
300+75.00 TO BRIDGE OMIS	303+37.92 OUTSIDE SHLDR SSION (MARCUM BRANCH)	292.1		292.1					197.2		AT MARCUM BRANCH BRIDGE
304+97.23 TO 305+12.07 TO	307+00.00 INSIDE SHLDR 307+19.00 OUTSIDE SHLDR	229.9	10.1	229.9		90.1			40.5 155.2		AT MARCUM BRANCH BRIDGE
	CATIONS FOR HOT-MIX ASPHALT EDGE ARE APPROXIMATE AND ACTUAL LIMI										
	USER NAME = bctimmermann DESIG		REVISED -								
HORNER SHIFRIN	DRAWN		REVISED -		STATE OF I	LLINOIS		SCHE	EDULE	F.A. I RTE. 57	SECTION COUNTY TOTAL SHEETS (28-2)B-2; (28-1)B-2 * 598
	PLOT SCALE = 0.16666633 '/ in. CHECK PLOT DATE = 11/18/2024 DATE	ED -	REVISED - REVISED -	DI	EPARTMENT OF TH	RANSPORTATION	SCALE: NTS	SHEET 4 OF 37		TO STA.	CONTRACT NO. 7888
											ILLINOIS FED. AID PROJECT

	USER NAME = bctimmermann	DESIGNED -	REVISED -				SCH	IEDUL	F
4 TURNER		DRAWN -	REVISED -	STATE OF ILLINOIS			0011	LDUL	
	PLOT SCALE = 0.16666633 ' / in.	CHECKED -	REVISED -	DEPARTMENT OF TRANSPORTATION					
WWW. HORNERSHIFRIN .COM	PLOT DATE = 11/18/2024	DATE -	REVISED -		SCALE: NTS	SHEET 4	OF 37	SHEETS	STA.

					MAINTENANCE OF TR	RAFFIC PRE-STAGE	- PAVEMENT REMOVA	L AND REPLACEMENT				
	LOCATION		PAVED SHOULDER REMOVAL	HOT - MIX ASPHALT SHOULDERS	HOT-MIX ASPHALT SHOULDERS, 10"	HOT-MIX ASPHALT EDGE LINE REPAIR, 2"	HOT-MIX ASPHALT SURFACE REMOVAL, 2"	POLYMERIZED HOT-MIX ASPHALT SURFACE COURSE, IL-9.5, MIX E, N90	MATERIAL TRANSFER DEVICE	BITUMINOUS MATERIALS (TACK COAT)	SHOULDER RUMBLE STRIPS, 8 INCH	REMARKS
STATION	TO STATION	SIDE	SQ YD	TON	SQ YD	SQ YD	SQ YD	TON	TON	POUND	FOOT	
	RAMPS											
MP A - SB RES												
106+00.00	TO 111+71.20	RT SHLDR		22.1			197.4		22.1	88.8		
AMP B - SB RES				05.0			0.10		05.0	201 6		
131+00.50 AMP A - IL I54	TO 142+31.60	RT SHLDR		95.0			848.0		95.0	381.6		
155+94.10	TO 165+82.30	BT SHLDB		124.9			1,115.3		124.9	501.9	+	
AMP B - IL 154				124.3					124.5	301.3	+ + + + + + + + + + + + + + + + + + + +	
188+29.90	TO 194+87.70	RT SHLDR		81.1			723.8		81.1	325.7		
AMP C - IL 154												
187+02.50	TO 196+84.90	RT SHLDR		122.7			1,095.4		122.7	492.9		
AMP D - IL I54	INTERCHANGE	·										
157+19.80	TO 163+58.70	RT SHLDR		80.6			720.0		80.6	324.0		
12.70.00	SOUTHBOUND EX LANES (*						2 6 6 6 7	200.7		1 200 0		
12+70.00	TO 52+70.00 TO 101+18.00	PASSING LANE 6 DRIVE LANE 12'					2,666.7 533.3	298.7 59.7		1,200.0		
97+18.00 113+02.00	TO 101+18.00 TO 140+02.00	PASSING LANE 6	•				1,800.0	201.6		810.0		
123+58.00	TO 124+58.00	DRIVE LANE 12'					133.3	14.9		60.0		
160+54.00	TO 176+54.00	PASSING LANE 6	•				1,066.7	119.5		480.0		
160+54.00	TO 161+54.00	DRIVE LANE 12'					133.3	14.9		60.0		
165+82.00	TO 166+82.00	DRIVE LANE 12'					133.3	14.9		60.0		
181+66.00	TO 208+66.00	PASSING LANE 6	•				1,800.0	201.6		810.0		
181+66.00	TO 183+66.00	DRIVE LANE 12'					266.7	29.9		120.0		
287+26.00	TO 292+26.00	PASSING LANE 6	1				333.3	37.3		150.0		
		* \										
17+78.00	NORTHBOUND EX LANES (* TO 308+38.00	▶) PASSING LANE 6	1				19,373.3	2,169.8		8,718.0		
17+98.00	TO 107+74.00	DRIVE LANE 12'					11,968.0	1,340.4		5,385.6		
211+90.00	TO 223+90.00	DRIVE LANE 12					1,600.0	179.2		720.0		
228+96.00	TO 234+46.00	DRIVE LANE 12'					733.3	82.1		330.0		
261+14.00	TO 266+14.00	DRIVE LANE 12'					666.7	74.7		300.0		
288+54.00	TO 292+54.00	DRIVE LANE 12'					533.3	59.7	_	240.0		
298+38.00	TO 308+38.00	DRIVE LANE 12'					1,333.3	149.3		600.0		
	FRAI	KLIN COUNTY TOTAL	6,091	7,209	6,091	13,225	109,438	5,049	6,544	53,358	5,010	

(*) ACTUAL NEED AND LOCATIONS FOR HOT-MIX ASPHALT EDGE LINE REPAIR, 2" WILL BE DETERMINED IN FIELD AT TIME OF CONSTRUCTION BY THE ENGINEER. ANY QUANTITY NOT NEEDED AT TIME OF CONSTRUCTION SHALL BE DELETED FROM THE CONTRACT. (**) STATION LOCATIONS ARE APPROXIMATE AND ACTUAL LIMITS WILL BE DETERMINED IN FIELD AT TIME OF CONSTRUCTION BY THE ENGINEER. ANY QUANTITY NOT NEEDED AT TIME OF CONSTRUCTION SHALL BE DELETED FROM THE CONTRACT.

hedu pw:		USER NAME = bctimmermann	DESIGNED -	REVISED -		1			HEDUL	
.: Sc	4 HURNER		DRAWN -	REVISED -	STATE OF ILLINOIS	1		001	LDOL	
DDEL DDEL	♥SHIFRIN	PLOT SCALE = 0.16666633 ' / in.	CHECKED -	REVISED -	DEPARTMENT OF TRANSPORTATION	1				
MC	WWW. HORNERSHIFRIN .COM	PLOT DATE = 11/18/2024	DATE -	REVISED -		SCALE: NTS	SHEET 5	OF 37	SHEETS	S

LE			F.A. I RTE.	SECTION		COUNTY	TOTAL SHEETS	SHEET NO.
			57	(28-2)B-2; (28-1)B-2		*	598	36
						CONTRACT NO. 78884		
s	STA.	TO STA.	ILLINOIS FED. AID PROJECT					

						MAINTENANCE OF TR							
	L	OCATION		PAVED SHOULDER REMOVAL	HOT-MIX ASPHALT SHOULDERS	HOT-MIX ASPHALT SHOULDERS, 10"	HOT-MIX ASPHALT EDGE LINE REPAIR, 2"	HOT-MIX ASPHALT SURFACE REMOVAL, 2"	POLYMERIZED HOT-MIX ASPHALT SURFACE COURSE, IL-9.5, MIX E, N90	MATERIAL TRANSFER DEVICE	BITUMINOUS MATERIALS (TACK COAT)	SHOULDER RUMBLE STRIPS, 8 INCH	REMARKS
STATION	то	STATION	I SIDE	SQ YD	TON	SQ YD	SQ YD	SQ YD	TON	TON	POUND	FOOT	
FERSON COUNTY													
1.21.00		UND SHOULDER					4 772 4						(*)
11+21.89 11+21.89	то то	226+02.00 15+70.00	(*) OUTSIDE SHLDR	497.9		497.9	4,773.4				336.1		(*) BELOW EAST FRANKLIN RD OVERPA
11+21.89	то	22+10.00	INSIDE SHLDR	497.9	56.7	497.9		506.6			227.9		BLEOW LAST TRANKETN RD OVERFA.
15+70.00	то		BK OUTSIDE SHLDR		583.7			5,211.5		583.7	2,345.2		
62+65.57 AH	ТО	97+31.80	OUTSIDE SHLDR		431.4			3,852.0		431.4	1,733.4		
97+31.80	то	97+72.10	OUTSIDE SHLDR		5.0			44.8		5.0	20.1		
97+72.10	то	98+59.20	OUTSIDE SHLDR	-	10.8			96.1		10.8	43.3		
09+07.80	ТО	113+80.00	OUTSIDE SHLDR		58.8			525.3		58.8	236.4		
12+15.00	TO	126+60.00	INSIDE SHLDR		79.5			709.4			319.2		
13+80.00	TO	120+20.00	OUTSIDE SHLDR		70.0	711.1		C 45 0		72.2	480.0		BELOW NORTH AVENUE OVERPASS
20+20.00	TO	125+94.70	OUTSIDE SHLDR		72.2			645.0		72.2	290.3	012.0	
16+95.40	TO	126+00.00	OUTSIDE SHLDR									913.0	
32+00.00	TO TO	145+69.82 226+02.00	OUTSIDE SHLDR		1,164.4			10,396.5		1,164.4	4,678.4	1,384.0	
52155.00	10	220102.00			1,104.4			10,350.5		1,104.4	4,070.4		
	NORTHBO	UND SHOULDER	(S										
11+21.89	ТО	226+02.00	(*)	-			4,773.4						(*)
11+21.89	то	15+70.00	OUTSIDE SHLDR	497.9		497.9					336.1		BELOW EAST FRANKLIN RD OVERPAS
11+21.89	то	22+10.00	INSIDE SHLDR		29.2			260.6			117.3		
15+70.00	то		BK OUTSIDE SHLDR		584.7			5,220.8		584.7	2,349.4		
62+65.57 AH	ТО	97+18.40	OUTSIDE SHLDR		429.6			3,835.9		429.6	1,726.1		
97+18.50	TO	97+58.70	OUTSIDE SHLDR		5.0			44.8		5.0	20.1		
97+58.70	TO	101+20.70	OUTSIDE SHLDR		45.1			402.6		45.1	181.2		
07+40.00	<u>то</u> то	121+85.00 113+80.00	INSIDE SHLDR OUTSIDE SHLDR		71.7 69.9			640.4 624.5		69.9	288.2		
13+80.00	то	120+20.00	OUTSIDE SHLDR		09.9	711.1		024.5		09.9	480.0		BELOW NORTH AVENUE OVERPASS
20+20.00	то	125+58.60	OUTSIDE SHLDR		66.3	,		592.1		66.3	266.4		
16+95.40	то	145+69.82	INSIDE SHLDR									2,857.4	
36+52.80	ТО	226+02.00	OUTSIDE SHLDR		1,115.5			9,959.7		1,115.5	4,481.9		
		RAMPS											
MP A - INA INTE													
98+59.20		109+03.20	RT SHLDR		124.8			1,114.5		124.8	501.5		
MP B - INA INTE 25+96.10		122125 00	RT SHLDR		72.4			646.0		72.4	290.7		
MP C - INA INTE		132+35.00			72.4			040.0		72.4	290.7		
25+62.90	TO	136+52.80	RT SHLDR		114.0			1,018.0		114.0	458.1		
MP D - INA INTE		100101100						.,			10011		
01+20.70	TO	108+15.60	RT SHLDR		77.8			694.9		77.8	312.7		
<u></u>	SOUTHBOUN	ND EX LANES (**)										
12+22	TO	82+22	PASSING LANE 6					4,666.7	522.7		2,100.0		
31+26	TO	45+26	DRIVE LANE 12					1,866.7	209.1		840.0		
44+18	то то	53+18	DRIVE LANE 12' DRIVE LANE 12'					1,200.0	134.4		540.0		
57+38 96+06	то	66+38 98+06	PASSING LANE 6					1,200.0 133.3	134.4 14.9		540.0 60.0		
187+78	то	224+78	PASSING LANE 6					2,466.7	276.3		1,110.0		
107770	10	224770		+				2,400.7	270.3		1,110.0		
		1		+									
		JEF	FERSON COUNTY TOTAL	L 2,419	5,269	2,419	9,547	58,576	1,292	5,032	27,992	5,155	

(*) ACTUAL NEED AND LOCATIONS FOR HOT-MIX ASPHALT EDGE LINE REPAIR, 2" WILL BE DETERMINED IN FIELD AT TIME OF CONSTRUCTION BY THE ENGINEER. ANY QUANTITY NOT NEEDED AT TIME OF CONSTRUCTION SHALL BE DELETED FROM THE CONTRACT. (**) STATION LOCATIONS ARE APPROXIMATE AND ACTUAL LIMITS WILL BE DETERMINED IN FIELD AT TIME OF CONSTRUCTION BY THE ENGINEER. ANY QUANTITY NOT NEEDED AT TIME OF CONSTRUCTION SHALL BE DELETED FROM THE CONTRACT.

	USER NAME = bctimmermann	DESIGNED -	REVISED -				SCF	IEDUL	F		F.A. I RTE	SECTION	COUNTY	TOTAL	SHEET NO.
		DRAWN -	REVISED -	STATE OF ILLINOIS					_		57	(28-2)B-2; (28-1)B-2	*	598	37
	PLOT SCALE = 0.16666633 ' / in.	CHECKED -	REVISED -	DEPARTMENT OF TRANSPORTATION									CONTRAC	T NO. 788	4
울 문 WWW. HORNERSHIFRIN .COM	PLOT DATE = 11/18/2024	DATE -	REVISED -		SCALE: NTS	SHEET 6	OF 37	SHEETS	STA.	TO STA.		ILLINOIS FED. A	AID PROJECT		

				PA	VEMENT - ASPHALT O	VERLAY				
	L	OCATION		POLYMERIZED HOT-MIX ASPHALT SURFACE COURSE, STONE MATRIX, 12.5, MIX "E", N80	POLYMERIZED HOT-MIX ASPHALT BINDER COURSE, IL-19.0, N90	HOT-MIX ASPHALT SHOULDERS	MATERIAL TRANSFER DEVICE	BITUMINOUS MATERIALS (TACK COAT)	LONGITUDINAL JOINT SEALANT, HALF-WIDTH	HOT-MIX ASPHALT SHOULDER REPAIR, 2"
STATION	то	STATION	SIDE	TON	TON	TON	TON	POUND	FOOT	SQ YD
FRANKLIN COUNTY										•
	SC	DUTHBOUND								
9+78.11	ТО	307+46.00								1,300
12+40.00	TO	50+00.00 BK		1,123.0	1,263.4		2,386.3	6,768.0	7,520.0	
49+99.31 AH	ТО	99+40.00		1,475.6	1,660.1		3,135.7	8,893.2	9,881.4	
106+00.00	TO	173+85.00		2,020.4	2,273.0		4,293.4	12,176.8	13,570.0	
179+15.00	TO	200+00.00 BK		622.7	700.6		1,323.3	3,753.0	4,170.0	
200+00.07 AH	TO	226+75.00		800.4	900.5		1,700.9	4,824.0	5,348.6	
232+30.00	TO	242+97.43 BK		321.3	361.4		682.7	1,936.1	2,134.9	
243+00.98 AH	TO	280+75.00		1,127.2	1,268.1		2,395.2	6,793.2	7,548.0	
285+95.00	ТО	301+40.00		461.4	519.1		980.6	2,781.0	3,090.0	
	NC	ORTHBOUND								
9+78.11	TO	307+19.00								1,300
12+40.00	то	50+00.00 BK		1,123.0	1,263.4		2,386.3	6,768.0	7,520.0	
49+99.31 AH	то	99+40.00		1,475.6	1,660.1		3,135.7	8,893.2	9,881.4	
106+00.00	то	173+85.00		2,032.1	1,565.5		2,957.1	8,386.6	13,570.0	
179+15.00	то	200+00.00 BK		622.7	700.6		1,323.3	3,753.0	4,170.0	
200+00.07 AH	ТО	226+75.00		797.0	896.7		1,693.7	4,803.5	5,348.6	
232+30.00	то	242+97.43 BK		316.4	355.9		672.3	1,906.6	2,134.9	
243+00.98 AH	ТО	280+75.00		1,127.2	1,268.1		2,395.2	6,793.2	7,548.0	
285+95.00	TO	300+75.00		441.9	497.2		939.1	2,663.5	2,960.0	
		DAMDC								
RAMP A - SB REST		RAMPS								
106+00.00	TO	111+71.20		158.1	177.9		336.0	952.8		
111+69.80	то	112+35.10		13.1	177.5		550.0	52.5		
RAMP B - SB REST		112133.10		13.1				52.5		
130+10.60	TO	131+00.50		18.2				73.1		
131+00.50	TO	142+31.60		171.1	192.5		363.7	1,031.4		
127+46.70	то	131+00.50	LT SHLDR			20.2		81.2		
127+63.30	TO	131+00.50	RT SHLDR			28.6		115.1		
RAMP A - IL 154										
155+94.10	TO	165+82.30		160.1	180.1		340.2	964.8		
165+82.30	TO	176+53.30	LT SHLDR	271.6		67.5		1,362.6		
RAMP B - IL I54						-				
176+77.30	то	188+29.90	LT SHLDR	284.0		69.8		1,421.4		
188+29.90	то	194+87.70		153.4	172.6		326.0	924.6		
RAMP C - IL I54	INTERCHAN	NGE								
176+51.80	ТО	187+02.50	LT SHLDR	277.1		63.9		1,370.4		
187+02.50	TO	196+84.90		156.3	175.9		332.2	942.1		
RAMP D - IL I54	INTERCHAN	NGE								
157+19.80	TO	163+58.70		149.1	167.7		316.8	898.5		
163+58.70	ТО	176+23.40	LT SHLDR	299.0		73.5		1,496.7		
		EDANIZI	IN COUNTY TOTAL	19 000	18,221	324	24 416	102 591	106,396	2,600
L		FRANKL	TN COUNTY TOTAL	18,000	10,221	524	34,416	103,581	100,390	2,000

USER NAME = bctimmermann	DESIGNED -	REVISED -				SC	HEDU	ЛЕ		F.A. BTE	!	SECTION	COUNTY	TOTAL SHEET SHEETS NO
1	DRAWN -	REVISED -	STATE OF ILLINOIS			00				57	-	(28-2)B-2; (28-1)B-2	*	598 38
PLOT SCALE = 0.16666633 '/ in.	CHECKED -	REVISED -	DEPARTMENT OF TRANSPORTATION										CONTRAC	CT NO. 78884
PLOT DATE = 11/18/2024	DATE -	REVISED -		SCALE: NTS	SHEET 7	OF 37	SHEET	TS STA.	TO STA.			ILLINOIS FED. AID	PROJECT	
	PLOT SCALE = 0.16666633 '/ In.	DRAWN _ PLOT SCALE = 0.16666633 '/ in. CHECKED	DRAWN REVISED REVISED PLOT SCALE = 0.16666633'/in. CHECKED REVISED	DRAWN REVISED STATE OF ILLINOIS PLOT SCALE = 0.100000033 / lin. CHECKED REVISED DEPARTMENT OF TRANSPORTATION	DRAWN REVISED STATE OF ILLINOIS PLOT SCALE = 0.100000033'/in. CHECKED	DRAWN REVISED STATE OF ILLINOIS PLOT SCALE CHECKED REVISED	DRAWN REVISED State PLOT SCALE = 0.166666333 '/in. CHECKED	DRAWN REVISED SCHEDU PLOT SCALE = 0.100000033'/in. CHECKED REVISED	DRAWN REVISED SCHEDULE PLOT SCALE = 0.100000033'/in. CHECKED REVISED	DRAWN DRAWN REVISED State of illinois PLOT SCALE CHECKED REVISED DEPARTMENT OF TRANSPORTATION	DRAWN DRAWN REVISED STATE OF ILLINOIS SCHEDULE RTE PLOT SCALE = 0.166666333 '/in. CHECKED REVISED DEPARTMENT OF TRANSPORTATION 57	DRAWN REVISED REVISED PLOT SCALE CHECKED REVISED REVISED	DRAWN DRAWN REVISED REVISED STATE OF ILLINOIS PLOT SCALE = 0.10000033 '/m. CHECKED REVISED DEPARTMENT OF TRANSPORTATION 57 (28-2)B-2; (28-1)B-2	DRAWN ORAVN REVISED REVISED REVISED OF ACCOUNT REVISED REVISED OF ACCOUNT REVISED REVISE

				PA	VEMENT - ASPHALT O	VERLAY				
	L	OCAT I ON		POLYMERIZED HOT-MIX ASPHALT SURFACE COURSE, STONE MATRIX, 12.5, MIX "E", N80	POLYMERIZED HOT-MIX ASPHALT BINDER COURSE, IL-19.0, N90	HOT-MIX ASPHALT SHOULDERS	MATER I AL TRANSFER DEVICE	BITUMINOUS MATERIALS (TACK COAT)	LONGITUDINAL JOINT SEALANT, HALF-WIDTH	HOT-MIX ASPHALT SHOULDER REPAIR, 2"
STATION	то	STATION	SIDE	TON	TON	TON	TON	POUND	FOOT	SQ YD
JEFFERSON COUNTY	(
	SC	UTHBOUND								
11+21.89	то	226+02.00								950
15+70.00	TO	62+64.51 BK		1,401.2	1,576.3		2,977.5	8,444.7	9,389.0	
62+65.57 AH	TO	97+28.90		1,034.8	1,164.2		2,199.0	6,236.6	6,926.7	
97+28.90	TO	97+69.20		12.0	13.5		25.6	72.5	80.6	
97+31.80	TO	97+72.10	OUTSIDE SHLDR			5.0		20.1		
97+69.20	TO	113+80.00		480.7	540.7		1,021.4	2,896.9	3,221.6	
120+20.00	то	226+02.00		3,161.1	3,556.2		6,717.3	19,051.3	21,164.0	
		DRTHBOUND								
11+21.89	то	226+02.00								950
15+70.00	то	62+64.51 BK		1,403.0	1,578.4		2,981.4	8,455.6	9,389.0	
62+65.57 AH	то	97+21.30		1,031.7	1,160.6		2,192.3	6,217.7	6,926.7	
97+18.40	TO	97+58.70	OUTSIDE SHLDR			5.0		20.1		
97+21.30	то	97+61.60		12.0	13.5		25.6	72.5	80.6	
97+61.60	TO	113+80.00		483.8	544.3		1,028.1	2,915.7	3,221.6	
120+20.00	TO	226+02.00		3,159.9	3,554.9		6,714.7	19,043.9	21,164.0	
		RAMPS	1							
RAMP A - INA INT		100.03.20		150.7	170 5		227.2	056.5		
98+59.20	TO	109+03.20 114+12.20		158.7 115.8	178.5	20.2	337.3	956.5		
109+03.20 RAMP B - INA INT	TO	114+12.20	LT SHLDR	ő. C11		29.3		582.7		
118+85.00	TO	125+96.10	LT SHLDR	166.1		42.0		836.0		
125+96.10	то	132+35.00		135.0	151.9	42.0	286.8	836.0		
RAMP C - INA INT		152755.00		155.0	191.9		200.0			
122+60.30	TO	125+62.90	LT SHLDR	62.5		15.2		311.9		
125+62.90	то	136+52.80		173.6	195.4	1.5.2	369.0	1.046.5		
RAMP D - INA INT		130132.00		175.0	100.7		505.0	1,040.5		
101+20.70	TO	108+15.60		155.0	174.4		329.3	1,107.1		
108+15.60	TO	115+25.30	LT SHLDR	160.5		43.1		645.0		
l		1								
		JEFFER	SON COUNTY TOTAL	. 13,308	14,403	140	27,206	79,747	81,564	1,900
			PROJECT TOTAL	31.308	32.624	464	61,622	183.328	187.960	4.500

a - 8 [Sheet] PW01.home:									
	USER NAME = bctimmermann	DESIGNED -	REVISED -			SCHEDULE		F.A.I SECT	TION COUNTY TOTAL SHEET
		DRAWN -	REVISED -	STATE OF ILLINOIS		CONEDCLE		57 (28-2)B-2;	(28-1)B-2 * 598 39
	PLOT SCALE = 0.166666633 '/ in.	CHECKED -	REVISED -	DEPARTMENT OF TRANSPORTATION					CONTRACT NO. 78884
≚ 문 WWW. HORNERSHIFRIN .COI	M PLOT DATE = 11/18/2024	DATE -	REVISED -		SCALE: NTS SHEET 8	B OF 37 SHEETS STA.	TO STA.		ILLINOIS FED. AID PROJECT

						PAVEMENT					
	LO	CATION		SUBBASE GRANULAR MATERIAL, TYPE A, 12"	AGGREGATE SHOULDERS, TYPE B 6"	PORTLAND CEMENT CONCRETE PAVEMENT 11 1/2" (JOINTED)	PORTLAND CEMENT CONCRETE SHOULDERS 11 1/2"	PORTLAND CEMENT CONCRETE SHOULDERS 10"	PAVEMENT CONNECTOR (PCC) FOR BRIDGE APPROACH SLAB	WELDED WIRE REINFORCEMENT	PROTECT I VE COAT
STATION	ТО	STATION	SIDE	SQ YD	SQ YD	SQ YD	SQ YD	SQ YD	SQ YD	SQ YD	SQ YD
RANKLIN COUNTY											
9+78.11	SOU TO	12+40.00		1,958.8	F.C. 0						
12+40.00	то	50+00.00 BK		13,368.9	56.0						
49+99.31 AH		99+40.00		17,566.9							
99+40.00	то	101+49.25		1,569.4	46.5						
101+49.25	TO	101+64.25		90.0	3.3				110.0	60.0	110.0
103+78.75		SION (GUN CREEK) 103+90.75		90.0	3.3				110.0	60.0	110.0
103+90.75	то	106+00.00		1,579.5	46.5				110.0	00.0	110.0
106+00.00	TO	173+85.00		24,099.9							
173+85.00	TO	176+14.31 BK		1,714.6	50.5						
176+15.00 AH 179+15.00	то то	179+15.00 200+00.00 BK		2,250.0 7,413.3	61.1						
200+00.70 AH		226+75.00		9,516.0							
226+75.00	TO	232+30.00		4,187.0	121.0						
232+30.00 243+00.98 AH	TO	242+97.43 BK 280+75.00		3,805.9							
243+00.98 AH 280+75.00	TO TO	280+75.00		13,418.7 3,900.0	112.0						
285+95.00	то	301+40.00		5,493.3							
301+40.00	TO	303+22.92		1,371.9	40.7						
303+22.92		303+37.92 ON (MARCUM BRANC		221.6	11.2				238.6	140.8	238.6
305+12.07		305+62.16		215.6	3.2				238.6	119.5	238.6
305+62.16	то	307+46.00		1,215.3	40.9						
9+78.11		12+40.00		1,958.8	56.0						
12+40.00	то	50+00.00 BK		13,368.9	50.0						
49+99.31 AH		99+40.00		17,566.9							
99+40.00	TO	101+49.25		1,569.4	46.5				110.0	<u> </u>	110.0
101+49.25 BB I		101+64.25 SION (GUN CREEK)		90.0	3.3				110.0	60.0	110.0
103+78.75	ТО	103+90.75		90.0	3.3				110.0	60.0	110.0
103+90.75	TO	106+00.00		1,569.4	46.5						
106+00.00 173+85.00	TO TO	173+85.00 176+14.31 BK		24,149.0 1,724.2	51.2						
176+15.00 AH		179+15.00		2,250.0	61.1						
179+15.00	TO	200+00.00 BK		7,413.3							
200+00.70 AH		226+75.00		9,501.3							
226+75.00 232+30.00	TO TO	232+30.00 242+97.43 BK		4,138.0 3,784.7	118.1						
243+00.98 AH		280+75.00		13,418.7							
280+75.00	TO	285+95.00		3,900.0	112.0						
285+95.00	TO TO	300+75.00		5,262.2	47.2						
300+75.00 302+87.84	то	302+87.84 303+37.92		1,596.3 215.6	47.3				238.6	119.5	238.6
		ON (MARCUM BRANC	H)								
305+12.07	то	305+27.07		221.6	11.2				238.6	140.8	238.6
305+27.07	ТО	307+19.00		1,371.9	42.6						
		RAMPS									
SB REST AREA LOO			RT SHLDR	1,659.6	181.8			1,614.5			1,614.5
AMP A - SB REST 108+94.70	AREA TO	116+94.20	RT SHLDR		180.0						
111+71.20	то	116+94.20	LT SHLDR	647.3	121.8			616.8			616.8
RAMP B - SB REST	AREA										
0+00.00		0+00.00	RT SHLDR	0.0	0.0			0.0			0.0
AMP A - IL 154 165+82.30		NGE 176+53.30	RT SHLDR	1,245.8	291.8			1,172.7			1,172.7
RAMP B - IL 154											
176+77.30		188+29.90	RT SHLDR	1,275.8	298.2			1,201.1			1,201.1
RAMP C - IL I54 176+51.80		NGE 187+02.50	RT SHLDR	1,186.1	278.0			1,116.6			1,116.6
RAMP D - IL 154				1,100.1	270.0			1,110.0			1,110.0
163+58.70	TO	176+23.40	RT SHLDR	1,353.5	310.9			1,274.7			1,274.7
		ED ANIZE TH	COUNTY TOTAL	227 575	2 063	0	0	6 007	1 205	761	0 202
		FRANKLIN	COUNTY TOTAL	237,575	2,862	U	U U	6,997	1,395	1 101	8,392

	USER NAME = jahaas	DESIGNED -	REVISED -			SCHEDULE		F.A. I RTE	SECTION	COUNTY	TOTAL SHEET
7 UORIVER		DRAWN -	REVISED -	STATE OF ILLINOIS		CONEBOLE		57	(28-2)B-2; (28-1)B-2	*	598 40
7SHIFRIN [PLOT SCALE = 0.16666633 ' / in.	CHECKED -	REVISED -	DEPARTMENT OF TRANSPORTATION						CONTRACT	NO. 78884
	PLOT DATE = 10/15/2024	DATE -	REVISED -		SCALE:	SHEET 9 OF 37 SHEETS S	STA. TO STA.		ILLINOIS FED.	AID PROJECT	

						PAVEMENT					
	LO	CATION		SUBBASE GRANULAR MATERIAL, TYPE A, 12"	AGGREGATE SHOULDERS, TYPE B 6"	PORTLAND CEMENT CONCRETE PAVEMENT 11 1/2" (JOINTED)	PORTLAND CEMENT CONCRETE SHOULDERS 11 1/2"	PORTLAND CEMENT CONCRETE SHOULDERS 10"	PAVEMENT CONNECTOR (PCC) FOR BRIDGE APPROACH SLAB	WELDED WIRE REINFORCEMENT	PROT
STATION	ТО	STATION	SIDE	SQ YD	SQ YD	SQ YD	SQ YD	SQ YD	SQ YD	SQ YD	S
JEFFERSON COUNTY		01111011	0.02				59.5				
		JTHBOUND									_
11+21.89	TO	15+70.00		3,355.4	97.8						
15+70.00	TO	62+64.51 BK		16,687.7							
62+65.57 AH	ТО	97+28.90		12,307.3							
97+28.90	TO	97+69.20		302.1		107.4					
97+31.80	TO	97+72.10	OUTSIDE		9.0		44.8				
97+69.20	TO	113+80.00		5,734.1							
113+80.00	TO	120+20.00		4,811.4	135.4						
120+20.00	TO	226+02.00		37,627.7							
		RTHBOUND									
11+21.89	TO	15+70.00		3,355.4	97.8						
15+70.00	TO	62+64.51 BK		16,695.5	-						
62+65.57 AH	TO	97+21.30		12,293.8							
97+18.40	TO	97+58.70	OUTSIDE		9.0	107.1	44.8				
97+21.30	TO	97+61.60		302.1		107.4					
97+61.60	TO	113+80.00		5,747.6	124 1						
113+80.00	то то	120+20.00 226+02.00		4,788.6	134.1						
120+20.00	10	226+02.00		37,022.5							
		RAMPS									
RAMP A - INA INT											
109+03.20	TO	114+12.20	RT SHLDR	433.5	81.9			413.0			4
RAMP B - INA INT	_		INT STIEDIN	455.5	01.5			415.0			
123+64.50	TO	125+96.10	RT SHLDR	280.3	53.0			267.1			2
RAMP C - INA INT	-		itti oneon	20010				20711			
122+60.30	TO	125+62.90	RT SHLDR	359.0	67.8			342.0			34
RAMP D - INA INT						1					-
108+15.60	ТО	115+25.30	RT SHLDR	936.0	177.9			891.5			89
		JEFFERSON	COUNTY TOTAL	163,641	864	215	90	1,914	0	0	1
			PROJECT TOTAL	401,216	3,726	215	90	8,911	1,395	761	10

[Sheet]

le - 10 [5 //PW01.F											
chedul pw:		USER NAME = jahaas	DESIGNED -	REVISED -			SCHEDULE	F.A. I RTF	SECTION	COUNTY	TOTAL SHEET SHEETS NO.
AME S			DRAWN -	REVISED -	STATE OF ILLINOIS			57	(28-2)B-2; (28-1)B-2	*	598 41
LE N.	SHIFRIN [PLOT SCALE = 0.166666633 ' / in.	CHECKED -	REVISED -	DEPARTMENT OF TRANSPORTATION					CONTRACT	NO. 78884
¥ E	WWW. HORNERSHIFRIN .COM	PLOT DATE = 10/15/2024	DATE -	REVISED -		SCALE: NTS	SHEET 10 OF 37 SHEETS STA. TO STA.		ILLINOIS FED. A	ID PROJECT	

	PROTECT I VE COAT
	SQ YD
_	
-	
_	
_	
_	
-	
	413.0
	267.1
	342.0
	891.5
	1,914
	10,306
_	10,000

					PAVEMENT	- ALTERNATE A					
	L	OCATION		SUBBASE GRANULAR MATERIAL, TYPE A, 4"	HOT-MIX ASPHALT PAVEMENT (FULL DEPTH), 14 1/4"	HOT-MIX ASPHALT PAVEMENT (FULL DEPTH), 16 3/4"	HOT-MIX ASPHALT SHOULDERS, 10"	MATER I AL TRANSFER DEVICE	BITUMINOUS MATERIALS (PRIME COAT)	BITUMINOUS MATERIALS (TACK COAT)	LONGITUDINAL JOINT SEALANT, HALF-WIDTH
STATION	ТО	STATION	SIDE	SQ YD	SQ YD	SQ YD	SQ YD	TON	POUND	POUND	FOOT
FRANKLIN COUNTY											
9+78.11	TO	DUTHBOUND 12+40.00	INSIDE SHLDR	580.4	348.2	696.5	580.4	508.6	3,656.4	1,488.7	1,047.6
9+78.11	то	12+40.00	OUTSIDE SHLDR	500.4	540.2	090.5	290.2	32.5	652.9	195.9	1,047.0
12+40.00	то	50+00.00 BK		8,355.6	5,013.3		8,355.6	4,936.5	30,080.0	10,152.0	7,520.0
49+99.31 AH	то	99+40.00	INSIDE SHLDR	10,979.3	6,587.6		10,979.3	6,486.6	39,525.5	13,339.9	9,881.4
99+40.00 99+40.00	<u>то</u> то	101+49.25 101+49.25	INSIDE SHLDR OUTSIDE SHLDR	465.0	279.0	558.0	465.0 232.5	407.5	2,929.5 523.1	1,192.7 156.9	837.0
		SSION (GUN CREEK					232.5	20.0	525.1	150.9	
103+90.75	то	106+00.00	INSIDE SHLDR	465.0	279.0	608.3	465.0	419.5	3,042.6	1,249.3	837.0
103+90.75	то	106+00.00	OUTSIDE SHLDR				192.3	21.5	432.7	129.8	
106+00.00 173+85.00		173+85.00 176+14.31 BK	INSIDE SHLDR INSIDE SHLDR	15,068.2	9,031.7	600 2	15,068.2 509.2	8,894.9 445.5	54,224.7	18,299.6 1,303.7	13,570.0 917.2
173+85.00 176+15.00 AH	то то	176+14.31 BK 179+15.00	INSIDE SHLDR	509.2 666.7	305.1 400.0	609.3 800.0	666.7	584.3	4,200.0	1,303.7	1,200.0
173+85.00	то	176+14.31 BK					253.5	28.4	570.4	171.1	
200+00.70 AH	то	179+15.00	OUTSIDE SHLDR				333.3	37.3	750.0	225.0	
179+15.00	TO	200+00.00 BK		4,633.3	2,780.0		4,633.3	2,737.4	16,680.0	5,629.5	4,170.0
200+00.70 AH 226+75.00	<u>то</u> то	226+75.00 232+30.00	INSIDE SHLDR INSIDE SHLDR	5,945.8	3,570.2 743.4	1,491.3	5,945.8	3,515.0 1,086.5	21,411.1	7,226.6 3,180.7	5,348.6
226+75.00	то	232+30.00	OUTSIDE SHLDR	1,255.5	,,,,,	1,491.9	623.2	69.8	1,402.3	420.7	2,220.0
232+30.00	то	242+97.43 BK		2,376.2	1,429.7		2,376.2	1,407.0	8,563.3	2,890.7	2,134.9
243+00.98 AH	то	280+75.00	INSIDE SHLDR	8,386.7	5,032.0		8,386.7	4,954.9	30,192.2	10,189.9	7,548.0
280+75.00 280+75.00	<u>то</u> то	285+95.00 285+95.00	INSIDE SHLDR OUTSIDE SHLDR	1,155.6	693.3	1,386.7	1,155.6 577.8	1,012 7	7,280.0	2,964.0 390.0	2,080.0
285+95.00	то	301+40.00	INSIDE SHLDR	3,433.3	2,060.0		3,433.3	2,028.4	12,360.0	4,171.5	3,090.0
301+40.00	то	303+22.92	INSIDE SHLDR	406.5	243.9	487.8	406.5	356.3	2,561.0	1,042.7	3,030.0
301+40.00	то	303+22.92	OUTSIDE SHLDR				203.3	22.8	457.3	137.2	731.7
		ION (MARCUM BRAN									
305+62.16 305+62.16	то то	307+00.00 307+46.00	INSIDE SHLDR OUTSIDE SHLDR	306.3	183.8	490.2	306.3 204.3	181.0 139.6	1,102.7	372.2 689.4	735.4
505+02.10	10	507+40.00	OUTSTDE SHEDR			490.2	204.5	155.0	1,302.7	009.4	
	NC	ORTHBOUND									
9+78.11	то	12+40.00	INSIDE SHLDR	580.4	348.2	696.5	580.4	508.6	3,656.4	1,488.7	1,047.6
9+78.11	TO	12+40.00	OUTSIDE SHLDR	0 255 6	E 012 2		290.2	32.5	652.9	195.9	7 520 0
12+40.00 49+99.31 AH	<u>то</u> то	50+00.00 BK 99+40.00	INSIDE SHLDR INSIDE SHLDR	8,355.6 10,979.3	5,013.3 6.587.6		8,355.6 10,979.3	4,936.5 6,486.6	30,080.0 39,525.5	10,152.0 13,339.9	7,520.0
99+40.00	то	101+49.25	INSIDE SHLDR	465.0	279.0	558.0	465.0	407.5	2,929.5	1,192.7	837.0
99+40.00	то	101+49.25	OUTSIDE SHLDR				232.5	26.0	523.1	156.9	
		SSION (GUN CREEK									
103+90.75 103+90.75	<u>то</u> то	106+00.00 106+00.00	INSIDE SHLDR OUTSIDE SHLDR	465.0	279.0	558.0	465.0	407.5	2,929.5 523.1	1,192.7 156.9	837.0
105+90.75	то	173+85.00	INSIDE SHLDR	15,087.4	9,061.6		15,087.4	8,921.0	54,335.3	18,339.4	13,570.0
173+85.00	то		INSIDE SHLDR	510.0	306.4	613.7	510.0	447.7	3,217.6	1,310.4	917.2
176+15.00 AH	ТО	179+15.00	INSIDE SHLDR	666.7	400.0	800.0	666.7	584.3	4,200.0	1,710.0	1,200.0
173+85.00	TO	176+14.31 BK					256.1	28.7	576.1	172.8	
176+15.00 AH 179+15.00	то то	179+15.00 200+00.00 BK	OUTSIDE SHLDR INSIDE SHLDR	4,633.3	2,780.0		333.3 4,633.3	37.3 2,737.4	750.0	225.0 5,629.5	4,170.0
200+00.70 AH	то	226+75.00	INSIDE SHLDR	5,940.0	3,561.2		5,940.0	3,507.2	21,377.8	7,214.6	5,348.6
226+75.00	то	232+30.00	INSIDE SHLDR	1,231.2	736.6	1,468.7	1,231.2	1,075.3	7,732.2	3,146.3	2,220.0
226+75.00	то	232+30.00	OUTSIDE SHLDR				610.1	68.3	1,372.7	411.8	
232+30.00	то	242+97.43 BK 280+75.00	INSIDE SHLDR INSIDE SHLDR	2,367.9	1,416.8		2,367.9	1,395.8	8,515.6	2,873.5	2,134.9
243+00.98 AH 280+75.00	то то	280+75.00	INSIDE SHLDR	8,386.7 1,155.6	5,032.0 693.3	1,386.7	8,386.7 1,155.6	4,954.9 1,012.7	30,192.2 7,280.0	10,189.9 2,964.0	7,548.0 2,080.0
280+75.00	то	285+95.00	OUTSIDE SHLDR	_,		-,	577.8	64.7	1,300.0	390.0	_,
285+95.00	то	300+75.00	INSIDE SHLDR	3,288.9	1,973.3		3,288.9	1,943.1	11,840.0	3,996.0	2,960.0
300+75.00	то	302+87.84	INSIDE SHLDR	473.0	283.8	567.6	473.0	414.5	2,979.8	1,213.2	851.4
300+75.00		302+87.84 ION (MARCUM BRAN	OUTSIDE SHLDR				236.5	26.5	532.1	159.6	
305+27.07	TO	307+00.00	INSIDE SHLDR	384.3	230.6		384.3	227.0	1,383.4	783.3	767.7
	то	307+19.00	OUTSIDE SHLDR			511.8	213.3	145.7	1,631.4	403.3	
305+27.07	10	307113100									
305+27.07	10		LIN COUNTY TOTAL	129,939	77,964	14,289	135,832	80,829	513,188	177,928	127,760

USER NAME = jahaas	DESIGNED -	REVISED -				SCHEDULE		F.A.I RTE	SECTION	COUNTY	TOTAL SI	HEET
i	DRAWN -	REVISED -	STATE OF ILLINOIS			CONEBOLE		57	(28-2)B-2; (28-1)B-2	*	598	42
PLOT SCALE = 0.16666633 ' / in.	CHECKED -	REVISED -	DEPARTMENT OF TRANSPORTATION							CONTRACT	NO. 78884	+
PLOT DATE = 10/15/2024	DATE -	REVISED -		SCALE: NTS	SHEET 11	OF 37 SHEETS STA.	TO STA.		ILLINOIS FED A	D PROJECT		
	PLOT SCALE = 0.166666633 '/in.	DRAWN - PLOT SCALE = 0.16666633 '/in CHECKED	DRAWN REVISED PLOT SCALE = 0.16666833 // Im. CHECKED REVISED	DRAWN REVISED STATE OF ILLINOIS PLOT SCALE = 0.16666633 '/in CHECKED - REVISED	DRAWN REVISED STATE OF ILLINOIS PLOT SCALE 0.166666833 '/In. CHECKED PLOT SCALE 0.166666833 '/In. CHECKED	DRAWN REVISED STATE OF ILLINOIS PLOT SCALE = 0.166666833 '/im. CHECKED PLOT SCALE = 0.166666833 '/im. CHECKED	DRAWN DRAWN REVISED STATE OF ILLINOIS PLOT SCALE 0.16666633 '/in CHECKED REVISED	DRAWN DRAWN REVISED STATE OF ILLINOIS PLOT SCALE = 0.16666633 //In. CHECKED REVISED	DRAWN DRAWN REVISED STATE OF ILLINOIS PLOT SCALE 0.166666333'/in. CHECKED REVISED 57	Image: Constraint of the second of	DRAWN DRAWN REVISED REVISED	DRAWN DRAWN REVISED REVISED STATE OF ILLINOIS PLOT SCALE 0.1666668333 / in CHECKED REVISED 598 DEPARTMENT OF TRANSPORTATION CONTRACT NO. 78884

					PAVEMENT	- ALTERNATE A					
				SUBBASE GRANULAR MATERIAL, TYPE A, 4"	HOT-MIX ASPHALT PAVEMENT (FULL DEPTH), 14 1/4"	HOT-MIX ASPHALT PAVEMENT (FULL DEPTH), 16 3/4"	HOT - MIX ASPHALT SHOULDERS, 10"	MATER I AL TRANSFER DEVICE	BITUMINOUS MATERIALS (PRIME COAT)	BITUMINOUS MATERIALS (TACK COAT)	LONGITUDINA JOINT SEALANT, HALF-WIDTH
STATION	TO	STATION	SIDE	SQ YD	SQ YD	SQ YD	SQ YD	TON	POUND	POUND	FOOT
EFFERSON COUNTY											
	SC	DUTHBOUND									
11+21.89	то	15+70.00	INSIDE SHLDR	994.2	596.5	1,193.0	994.2	721.0	6,263.5	2,550.1	1,792.4
11+21.89	то	15+70.00	OUTSIDE SHLDR				497.1	55.7	1,118.5	335.5	
15+70.00	то	62+64.51 BK		10,430.7	6,257.0		10,430.7	6,161.3	37,547.3	12,672.0	9,389.0
62+65.57 AH	то	97+28.90	INSIDE SHLDR	7,690.5	4,616.8		7,690.5	4,545.6	27,691.5	9,346.2	6,926.7
97+28.90	то	97+69.20	INSIDE SHLDR	89.5	53.7		89.5	52.9	322.3	108.8	80.6
97+69.20	то	113+80.00	INSIDE SHLDR	3,585.4	2,148.7		3,585.4	2,116.2	12,901.6	4,353.9	3,221.6
113+80.00	то	120+20.00	INSIDE SHLDR	1,423.2	854.9	1,711.9	1,423.2	1,033.3	8,977.6	5,582.0	2,560.0
113+80.00	то	120+20.00	OUTSIDE SHLDR				714.2	80.0	1,606.9	482.1	
120+20.00	то	226+02.00	INSIDE SHLDR	23,516.7	14,111.0		23,516.7	13,894.4	84,662.3	28,573.7	21,164.0
	NIC										
11.21.00			INSIDE SHLDR	004.2	506 F	1 102 0	004.2	701.0	6 262 5	2 550 1	1 702 4
11+21.89	TO	15+70.00 15+70.00		994.2	596.5	1,193.0	994.2	721.0	6,263.5	2,550.1	1,792.4
11+21.89	TO		OUTSIDE SHLDR	10 122 0	6 261 7		497.1	55.7	1,118.5	335.5	0.300.0
15+70.00	TO	62+64.51 BK		10,433.8	6,261.7		10,433.8	6,165.4	37,564.9	12,678.4	9,389.0
62+65.57 AH 97+21.30	то то	97+21.30 97+61.60	INSIDE SHLDR	7,685.2	4,608.6 53.7		7,685.2	4,538.4	27,661.1 322.3	9,335.3 108.8	6,926.7 80.6
			INSIDE SHLDR								
97+61.60 113+80.00	<u>то</u> то	113+80.00 120+20.00	INSIDE SHLDR	3,590.7	2,156.9 851.8	1,701.4	3,590.7 1,421.2	2,123.4	12,932.1 8,942.4	4,364.9 5,554.0	3,221.6
113+80.00	то То	120+20.00	OUTSIDE SHLDR	1,421.2	0.10	1,701.4	708.1	1,029.4	8,942.4	477.9	2,500.0
120+20.00	то то	226+02.00	INSIDE SHLDR	23,514.7	14.107.9		23,514.7	13,891.7	84,650.7	28.569.5	21,164.0
120120.00	10	220102.00	I INSIDE SHEDR	23,314.7	14,107.9		25,514.7	15,091.7	04,000.7	20,009.0	21,104.0
		JEFFER	SON COUNTY TOTAL	95,460	57,276	5,800	97,876	57,318	362,140	127,979	90,269
			PROJECT TOTAL	225,399	135,240	20,089	233,708	138,147	875,328	305,907	218,029

	USER NAME = jahaas	DESIGNED -	REVISED -			SCHEDULE		F.A. I RTE	SECTION	COUNTY	OTAL SHEET
		DRAWN -	REVISED -	STATE OF ILLINOIS				57	(28-2)B-2; (28-1)B-2	* (598 43
	PLOT SCALE = 0.16666633 ' / in.	CHECKED -	REVISED -	DEPARTMENT OF TRANSPORTATION						CONTRACT NO	J. 78884
≊ ≣ WWW. HORNERSHIFRIN .COM	PLOT DATE = 10/15/2024	DATE -	REVISED -		SCALE: NTS	SHEET 12 OF 37 SHEETS STA.	TO STA.		ILLINOIS FED. A	AID PROJECT	

			PA	VEMENT - ALTER	RNATE B			
	LOCATIO	N	STABILIZED SUBBASE, 4"	PORTLAND CEMENT CONCRETE PAVEMENT 10 1/2" (JOINTED)	PORTLAND CEMENT CONCRETE PAVEMENT 11 1/2" (JOINTED)	PORTLAND CEMENT CONCRETE SHOULDERS 10 1/2"	PORTLAND CEMENT CONCRETE SHOULDERS 11 1/2"	PROTECT I VE COAT
STATION	ТО	STATION	SQ YD	SQ YD	SQ YD	SQ YD	SQ YD	SQ YD
RANKLIN COUNTY								
	SOUTHBOUN	T						
9+78.11	TO	12+40.00	1,625.1	348.2	696.5	580.4	290.2	1,915.3
12+40.00 49+99.31 AH	TO TO	50+00.00 BK 99+40.00	13,368.9 17,566.9	5,013.3 6,587.6		8,355.6 10,979.3		13,368.9
99+40.00	то	101+49.25	1,302.0	279.0	558.0	465.0	232.5	1,534.5
101+49.25	то	101+64.25	74.7	279.0	550.0	405.0	232.3	1,334.3
		GUN CREEK)	, ,					
103+75.75	TO	103+90.75	74.7					
103+90.75	ТО	106+00.00	1,352.3	279.0	608.3	465.0	192.3	1,544.6
106+00.00	то	173+85.00	24,099.9	9,031.7		15,068.2		24,099.9
173+85.00	ТО	176+14.31 BK	1,423.6	305.1	609.3	509.2	253.5	1,677.1
176+15.00 AH	TO	179+15.00	1,866.7	400.0	800.0	666.7	333.3	2,200.0
179+15.00	TO	200+00.00 BK	7,413.3	2,780.0		4,633.3		7,413.3
200+00.70 AH	TO	226+75.00	9,516.0	3,570.2		5,945.8	622.2	9,516.0
226+75.00	TO	232+30.00	3,470.2	743.4	1,491.3	1,235.5	623.2	4,093.4
232+30.00 243+00.98 AH	TO TO	242+97.43 BK 280+75.00	3,805.9 13,418.7	1,429.7 5,032.0		2,376.2 8,386.7		3,805.9
280+75.00	то	285+95.00	3,235.6	693.3	1,386.7	1,155.6	577.8	3,813.3
285+95.00	то	301+40.00	5,493.3	2,060.0	1,500.7	3,433.3	577.0	5,493.3
301+40.00	то	303+22.92	1,138.2	243.9	487.8	406.5	203.3	1,341.5
303+22.92	TO	303+37.92	164.8	2.015	10,10	10015	20010	1,0,11,0
BRIDGE OMIS	SION (MAI	RCUM BRANCH)						
305+12.07	ТО	305+62.16	197.9					
305+62.16	TO	307+00.00	490.1	183.8		306.3		
305+62.16	TO	307+46.00	490.2		490.2		204.3	694.5
		T	4 695 4	2.10.2	606 F	500.1	200.2	
9+78.11 12+40.00	то то	12+40.00 50+00.00 BK	1,625.1	348.2 5,013.3	696.5	580.4	290.2	1,915.3
49+99.31 AH	то	50+00.00 BK 99+40.00	13,368.9 17,566.9	6,587.6		8,355.6 10,979.3		13,368.9
99+40.00	то	101+49.25	1,302.0	279.0	558.0	465.0	232.5	1,534.5
101+49.25	то	101+64.25	74.7	275.0	550.0	405.0	252.5	1,354.5
		GUN CREEK)	, ,					
103+75.75	ТО	103+90.75	74.7					
103+90.75	ΤO	106+00.00	1,302.0	279.0	558.0	465.0	232.5	1,534.5
106+00.00	ТО	173+85.00	24,149.0	9,061.6		15,087.4		24,149.0
173+85.00	то	176+14.31 BK	1,430.0	306.4	613.7	510.0	256.1	1,686.1
176+15.00 AH	TO	179+15.00	1,866.7	400.0	800.0	666.7	333.3	2,200.0
179+15.00	TO	200+00.00 BK	7,413.3	2,780.0		4,633.3		7,413.3
200+00.70 AH 226+75.00	TO TO	226+75.00 232+30.00	9,501.3 3,436.5	3,561.2 736.6	1 469 7	5,940.0	610.1	1 046 6
232+30.00	то	232+30.00 242+97.43 BK	3,436.5	1,416.8	1,468.7	1,231.2 2,367.9	010.1	4,046.6
243+00.98 AH	то	280+75.00	13,418.7	5,032.0		8,386.7		13,418.7
280+75.00	то	285+95.00	3,235.6	693.3	1,386.7	1,155.6	577.8	3,813.3
285+95.00	TO	300+75.00	5,262.2	1,973.3	_,,	3,288.9		5,262.2
300+75.00	TO	302+87.84	1,324.3	283.8	567.6	473.0	236.5	1,560.8
302+87.84	ТО	303+37.92	197.9					
	SION (MA	RCUM BRANCH)						
305+12.07	TO	305+27.07	164.8					
305+27.07	TO	307+00.00	614.8	230.6		384.3		614.8
			511.8	1	511.8	1	213.3	725.1
305+27.07	TO	307+19.00	511.0		511.0			

Sheet

			PA	VEMENT - ALTER	RNATE B			
	LOCATION	١	STABILIZED SUBBASE, 4"	PORTLAND CEMENT CONCRETE PAVEMENT 10 1/2" (JOINTED)	PORTLAND CEMENT CONCRETE PAVEMENT 11 1/2" (JOINTED)	PORTLAND CEMENT CONCRETE SHOULDERS 10 1/2"	PORTLAND CEMENT CONCRETE SHOULDERS 11 1/2"	PROTECTIVE COAT
STATION	TO	STATION	SQ YD	SQ YD	SQ YD	SQ YD	SQ YD	SQ YD
JEFFERSON COUNT								
	SOUTHBOUN	-						
11+21.89	TO	15+70.00	2,783.8	596.5	1,193.0	994.2	497.1	3,280.9
15+70.00	TO	62+64.51 BK	16,687.7	6,257.0		10,430.7		16,687.7
62+65.57 AH		97+28.90	12,307.3	4,616.8		7,690.5		12,307.3
97+28.90	TO	97+69.20	143.2	53.7		89.5		143.2
97+69.20	TO	113+80.00	5,734.1	2,148.7		3,585.4		5,734.1
113+80.00	TO	120+20.00	3,990.1	854.9	1,711.9	1,423.2	714.2	4,704.2
120+20.00	TO	226+02.00	37,627.7	14,111.0		23,516.7		37,627.7
	NORTHBOUN	D						
11+21.89	TO	15+70.00	2,783.8	596.5	1,193.0	994.2	497.1	3,280.9
15+70.00	TO	62+64.51 BK	16,695.5	6,261.7		10,433.8		16,695.5
62+65.57 AH	TO	97+21.30	12,293.8	4,608.6		7,685.2		12,293.8
97+21.30	TO	97+61.60	143.2	53.7		89.5		143.2
97+61.60	TO	113+80.00	5,747.6	2,156.9		3,590.7		5,747.6
113+80.00	TO	120+20.00	3,974.4	851.8	1,701.4	1,421.2	708.1	4,682.4
120+20.00	TO	226+02.00	37,622.5	14,107.9		23,514.7		37,622.5
	JEFFER	SON COUNTY TOTAL	158,535	57,276	5,800	95,460	2,417	160,953
		PROJECT TOTAL	381,750	135,240	20,089	225,399	8.310	389,038

e - 13 [5 /PW01.h										
hedul pw:		USER NAME = jahaas	DESIGNED -	REVISED -				SCH	HEDUL	F
.: Sc	4 HURNER		DRAWN -	REVISED -	STATE OF ILLINOIS			0011		
DDEL DDEL	♥SHIFRIN	PLOT SCALE = 0.16666633 '/ in.	CHECKED -	REVISED -	DEPARTMENT OF TRANSPORTATION					
M	WWW. HORNERSHIFRIN .COM	PLOT DATE = 10/15/2024	DATE -	REVISED -		SCALE: NTS	SHEET 13	OF 37	SHEETS	ST

L	.E		F.A. I RTE.	SECT	ON	COUNTY	TOTAL SHEETS	SHEET NO.
			57	(28-2)B-2; (28-1)B-2	*	598	44
_						CONTRACT	NO. 788	84
s	STA.	TO STA.		1	LLINOIS FED.	AID PROJECT		

					CONCRETE BA	ARRIER				
LC	101 ΤΑΟ	I	CONCRETE BARRIER, DOUBLE FACE, 44 INCH HEIGHT	CONCRETE BARRIER, VARIABLE CROSS SECTION, 44 INCH HEIGHT	CONCRETE BARRIER TRANSITION	BARRIER WALL REFLECTORS, TYPE C	PROTECTIVE COAT	IMPACT ATTENUATORS (FULLY DIRECTIVE, NARROW), TEST LEVEL 3	REMOVE IMPACT ATTENUATOR SAND MODULE	REMOVE IMPACT ATTENUATORS, NO SALVAGE
STATION	TO	STATION	FOOT	FOOT	FOOT	EACH	SQ YD	EACH	EACH	EACH
FRANKLIN COUNTY										
9+88									1	
9+88	TO	9+98			10					
9+98	ТО	20+50	1,052			9	1,058.1			
20+50	то	20+75						1		
	N TURNAR	OUND								
21+75	TO	22+00						1		
22+00	TO	50+00.00 BK	2,800.0			21	2,816.2			
49+99.31 AH	ТО	76+50	2,650.7			21	2,666.0			
76+50	то	76+75						1		
	N TURNAR									
77+75	TO	78+00						1		
78+00	TO	79+90	190			3	181.0			
79+90	TO	80+30		40		3	55.8			
80+30	то	82+00	170			3	171.0			
82+00	то	84+20		220		3	245.7			
84+20	TO	91+75	755			6	759.4			
91+75	то	92+65		90		3	100.5			
92+65	TO	97+35	470			6	472.7			
97+35	TO	98+45		110		3	122.9			
98+45		101+64	319			3	321.1			
BRIDGE OMIS	SSION (C	GUN CREEK)								
103+76	то	108+56	480			6	483.0			
108+56	ТО	108+81			25					
OVERHE/	AD SIGN	TRUSS								
108+93	TO	109+18			25					
109+18	TO	176+14.31 BK	6,696.3			51	6,735.0			
176+15.00 AH	ТО	176+29	14.0			3	14.1			
176+29	TO	176+39			10					
176+39									1	
176+64									1	
176+64	TO	176+74			10					
176+74	TO	200+00.00 BK	2,326.0			18	2,339.4			
200+00.70 AH	TO	214+95	1,494.3			12	1,502.9			
214+95	TO	215+20						1		
	N TURNAR									
216+20	TO	216+45						1		
216+45	TO	220+20	375			3	377.2			
220+20	то	229+36		916		9	1,023.1			
229+36	TO	229+46			10					
229+46									1	
229+63									1	
229+63	то	229+73			10					
229+73	TO	242+97.43 BK		1,324.4		12	1,479.2			
243+00.98 AH	TO	244+65		164.0		3	183.2			
244+65	TO	283+19	3,854			30	3,876.3			
283+19	TO	283+29			10					
283+29									1	
283+45									1	
283+45	то	283+55			10				-	
283+55	TO	298+85	1,530			12	1,538.8			
298+85	то	299+70	-,	85		3	94.9			
299+70	TO	303+38	368			3	370.1			
BRIDGE OMISSI										
305+12	TO	307+00	188			3	189.0			
						1 1				

d//:wd		USER NAME = jahaas	DESIGNED -	REVISED -			SCHEDULE		F.A.I	SECTION	COUNTY	TOTAL SHEET SHEETS NO.
ME			DRAWN -	REVISED -	STATE OF ILLINOIS				57	(28-2)B-2; (28-1)B-2	*	598 45
E N	SHIFRIN	PLOT SCALE = 0.16666633 '/ in.	CHECKED -	REVISED -	DEPARTMENT OF TRANSPORTATION					(CONTRAC	T NO. 78884
Ē	WWW. HORNERSHIFRIN .COM	PLOT DATE = 10/15/2024	DATE -	REVISED -		SCALE: NTS	SHEET 14 OF 37 SHEETS STA.	TO STA.		ILLINOIS FED. A	D PROJECT	
										100.000		

8 E

					CONCRETE BA	ARR I ER				
	ERSON COUNTY		CONCRETE BARRIER, DOUBLE FACE, 44 INCH HEIGHT	CONCRETE BARRIER, VARIABLE CROSS SECTION, 44 INCH HEIGHT	CONCRETE BARRIER TRANSITION	BARRIER WALL REFLECTORS, TYPE C	PROTECTIVE COAT	IMPACT ATTENUATORS (FULLY DIRECTIVE, NARROW), TEST LEVEL 3	REMOVE IMPACT ATTENUATOR SAND MODULE	REMOVE IMPACT ATTENUATORS NO SALVAGE
STATION			FOOT	FOOT	FOOT	EACH	SQ YD	EACH	EACH	EACH
EFFERSON COUNT										
11+30									1	
11+30	то	11+40			10					
11+40	ТО	62+64.51 BK	5,124.5			39	5,154.1			
62+65.57 AH	то	115+80	5,314.4			42	5,340.1			
115+80	то	116+85		105		3	124.0			
116+85	то	116+95			10					
116+95									1	
116+95	то	117+25			10.5					
117+25									1	
117+25	то	117+35			10					
117+35	то	145+80		2,845		24	3,090.4			
145+80	то	157+60	1,180			9	1,267.3			
157+60	то	158+85						1		
	AN TURNAF									
158+85	то	159+10						1		
159+10	то	226+02	6,692			51	6,730.7			
226+02										1
	JEFFER	SON COUNTY TOTAL	18,311	2,950	41	168	21,707	2	3	1
		PROJECT TOTAL	44,044	5,900	161	420	50,884	8	10	1

= jahaas	DESIGNED -	REVISED -				SCHED	ULE		F.A. I RTE	SECTION	COUNTY	TOTAL SHEE'
	DRAWN -	REVISED -	STATE OF ILLINOIS			001122			57	(28-2)B-2; (28-1)B-2	*	598 46
= 0.16666633 '/ in.	CHECKED -	REVISED -	DEPARTMENT OF TRANSPORTATION								CONTRAC	T NO. 78884
= 10/15/2024	DATE -	REVISED -		SCALE: NTS	SHEET 15	OF 37 SHEE	ETS STA.	TO STA.		ILLINOIS FED. A	D PROJECT	

					GUAR	DRAIL					
	LOCA	NT I ON	CONCRETE BARRIER REMOVAL	GUARDRA I L REMOVAL	STEEL PLATE BEAM GUARDRAIL TYPE A, 6 FOOT POSTS	TRAFFIC BARRIER TERMINAL, TYPE 1	TRAFFIC BARRIER TERMINAL, TYPE 5	TRAFFIC BARRIER TERMINAL, TYPE 6	TRAFFIC BARRIER TERMINAL, TYPE 6B	TERMINAL MARKIER DIRECT APPLIED	GUARDRAIL REFLECTORS, TYPE A
STATION	ΤO	STATION SIDE	FOOT	FOOT	FOOT	EACH	EACH	EACH	EACH	EACH	EACH
FRANKLIN COUN											
		BOUND									
9+78.11 97+48.00	TO TO	9+86.00 OUTSIDE 101+80.00 INSIDE		8 432							
97+48.00	T0	101+80.00 INSIDE		240							
99+40.00	то	101+81.75 OUTSIDE		240	203.5			1			5
103+59.00	TO	106+00.00 OUTSIDE		241							
103+59.00	TO	109+46.00 INSIDE		587							
103+60.75	TO	106+00.00 OUTSIDE			226.0		1				4
173+67.00	TO	176+16.00 OUTSIDE		249							
173+65.50	TO	176+55.00 OUTSIDE			187.5	1			1	1	5
176+14.11 226+95.00	TO TO	176+39.72 OUTSIDE 229+34.00 OUTSIDE	24.9	239							
226+95.00	T0 T0	229+34.00 OUTSIDE 229+79.00 OUTSIDE		239	187.5	1			1	1	5
229+31.12	то	229+63.80 OUTSIDE	32.7		107.5	1 L			1	1	, ,
279+75.00	то	283+02.00 OUTSIDE		327							
279+70.00	ТО	283+47.00 OUTSIDE			275.0	1			1	1	6
282+99.85	TO	283+31.45 OUTSIDE	31.6								
299+36.00	TO	303+67.00 INSIDE		431							
301+40.00	TO	303+89.00 OUTSIDE		249							
301+40.00	TO	303+92.50 OUTSIDE		100	214.3			1			5
305+07.70 305+33.75	TO TO	306+97.70 INSIDE 307+46.00 OUTSIDE		190	100.0		1				4
305+33.75	T0 T0	307+46.00 OUTSIDE		214	199.0		1				4
505152.00	10	50/140.00 00151DE		214							
	NORTH	IBOUND									
9+78.11	TO	13+14.00 OUTSIDE		336							
9+71.00	ТО	13+10.50 OUTSIDE			237.5	1			1	1	6
99+40.00	ТО	101+80.00 OUTSIDE		240							
99+40.00	TO	101+79.25 OUTSIDE		-	226.0		1				4
103+59.00	TO	106+00.00 OUTSIDE		241							
103+59.00 103+58.25	TO TO	112+00.00 INSIDE 106+00.00 OUTSIDE		841	203.5			1			5
176+48.00	T0	179+37.50 OUTSIDE			187.5	1		1	1	1	5
176+64.64	T0	176+88.88 OUTSIDE	24.2		107.5	1			-		
176+86.00	TO	179+34.00 OUTSIDE		248							
229+45.12	то	229+73.12 OUTSIDE	28.0								
229+71.00	то	232+20.00 OUTSIDE		249							
229+29.00	TO	232+18.50 OUTSIDE			187.5	1			1	1	5
283+27.00	TO	287+04.00 OUTSIDE	26.5		275.0	1				1	6
283+42.46	TO	283+69.40 OUTSIDE	26.9								
283+67.00 300+75.00	TO TO	286+99.00 OUTSIDE 303+18.00 OUTSIDE		332 243							
300+75.00	то	303+16.25 OUTSIDE		243	228.0		1		1		5
304+57.50	то	307+19.00 OUTSIDE			223.3			1			5
304+61.00	TO	307+19.00 OUTSIDE		258							-
304+80.10	TO	306+95.10 INSIDE		215							
		FRANKLIN COUNTY TOTAL	169	6,610	3,261	7	4	4	7	7	75
				1				1	1	1	1
JEFFERSON COUL		IBOUND			+						
11+21.89		14+57.00 OUTSIDE		335							
11+13.00	то	14+52.50 OUTSIDE			237.5	1			1	1	6
	NORTH	IBOUND									
11+21.89	TO	11+30.00 OUTSIDE		8							
				Ť							
		JEFFERSON COUNTY TOTAL	0	344	238	1	0	0	1	1	6
								1	-	-	-
		PROJECT TOTAL	169	6,954	3,499	8	4	4	8	8	81

	4
ILE NAME: pw://PW01.homershiftin.com:HS ID07/Documents/210610000-PTB198-034_D9V//2106102-157-3rdLanePh2/CAD_Sheets/D976	FILE NAME: p
MODEL: Schedule - 16 [Sheet]	MODEL: Sche

Nd/														
:wd		USER NAME = Jahaas	DESIGNED -	REVISED -			SCHE	DULE		F.A.I	SECTION	COUNTY	TOTAL SH	IEET
W L	HORNER		DRAWN -	REVISED -	STATE OF ILLINOIS		00112	DOLL		57	(28-2)B-2; (28-1)B-2	*	598 4	47
х Щ	2SHIFRIN (PLOT SCALE = 0.16666633 ' / in.	CHECKED -	REVISED -	DEPARTMENT OF TRANSPORTATION							CONTRACT		_
Ē	WWW. HORNERSHIFRIN .COM	PLOT DATE = 10/15/2024	DATE -	REVISED -		SCALE: NTS	SHEET 16 OF 37 S	HEETS STA.	TO STA.		ILLINOIS FED. AI	D PROJECT		

	Р	IPE UNDE	RDRAIN REMO	/ALS
		LOCATIO	N	PIPE UNDERDRAIN REMOVAL (SPECIAL)
	STATION	ТО	STATION	FOOT
	65+00			16
-	70+00	TO	75+00	500
-	70+00	то	80+00	<u> </u>
	75+00	10	00+00	16
	80+00	то	85+00	500
	80+00			16
-	85+00	то	90+00	500
	85+00 90+00	то	95+00	<u>16</u> 500
	90+00	10	33100	16
	95+00	TO	101+80	680
			GUN CREEK)	500
-	103+60 95+00	TO	108+60	<u> </u>
	108+60	то	112+50	390
	108+60			16
4	112+50	TO	117+47	497
-	112+50 117+47	то	122+49	<u>16</u> 502
1	117+47	10	122743	16
]	122+49	то	127+49	500
	122+49			16
-	127+49 127+49	то	132+49	500 16
-	132+49 132+49 132+49	TO	137+48	499
	137+48	то	142+49	501
	137+48			16
-	142+49	то	147+50	501
	142+49 147+50	то	152+51	16 501
	147+50		102.001	16
	152+51	ΤO	157+50	499
-	0+00		150.00	16
-	157+50 157+50	TO	159+99	249
	159+99	то	164+46	447
1	159+99			16
-	164+46	то	170+00	554
	164+46 170+00	то	174+98	16 498
	170+00		171130	16
	174+98	то	180+00	502
-	174+98		104-07	16
	180+00	ТО	184+97	497
	184+97	то	189+97	500
]	184+97			16
1	189+97	TO	202+50	1,253
	189+97 202+50	то	207+50	<u>16</u> 500
1	202+50	10	207130	16
1	207+50	то	212+50	500
4	207+50			16
-	217+53 217+53	то	219+32	179 16
1	217+53	TO	224+32	500
]	219+32			16
1	224+32	TO	229+32	500
-	224+32	то	224-22	16
1	229+32 229+32	TO	234+32	<u> </u>
1	234+32	то	239+32	500
]	234+32			16
-	239+32	TO	242+97.43 BK	365.4
	243+00.98 AH 239+32	TO	248+07	506.0 16
1	248+07	то	258+14	1,007
]	248+07			16
1	258+14	TO	263+08	494
4	258+14 263+08	то	273+19	16
	200100	10	213113	
-	263+08			16

	LOCATIC	N	PIPE UNDERDRAIN REMOVAL (SPECIAL)
STATION	то	STATION	FOOT
FRANKLIN COUN			
		DE SHOULDER	
9+78.11 10+69	то	10+69	90.9
10+69	то	14+69	400
14+69			16
14+69 19+61	то	19+61	492
19+61	то	25+09	548
25+09			16
25+09 30+02	то	30+02	493
30+02	то	35+23	521
35+23			16
35+23 40+00	то	40+00	477
40+00	ТО	45+00	500
45+00			16
45+00 49+99.31 AH	то то	50+00.00 BK 54+85.00	500.0 485.7
50+00	10	00.00	485.7
54+85			16
54+85	то	60+18	533
60+18 60+18	то	64+97	<u>16</u> 479
64+97			16
64+97	то	70+00	503
70+00 70+00	то	75+00	16 500
75+00		,,,,,,,,,,,,,,,,,,,,,,,,,,,,,,,,,,,,,,,	16
75+00	ТО	80+00	500
80+00 80+00	то	85+00	<u> </u>
85+00	10	00100	16
85+00	то	90+00	500
90+00 90+00	то	95+00	16 500
95+00	10	55100	16
95+00	ТО	101+80	680
BRIDGE OM 103+60	TO	GUN CREEK) 108+00	440
108+00	10	100100	16
108+00	TO	112+47	447
112+47 112+47	то	117+47	16 500
117+47	10	11/+4/	16
117+47	то	122+42	495
122+42 122+42	то	127+48	16 506
127+48	10	12/740	16
127+48	то	132+50	502
132+50 132+50	то	137+50	16 500
137+50	10	137730	16
137+50	то	142+47	497
142+47 142+47	то	147+47	16 500
142+47	то	14/+4/	16
147+47	то	152+48	501
152+48	TO	157.51	16
152+48 157+51	то	157+51	503 16
157+51	то	160+02	251
160+02	100 × 1	171.05	16
160+02 171+38	то	171+38	1,136 16
171+38	то	175+00	362
175+00	то		16
175+00	TO	176+14.31 BK	114.3
176+15.00 AH 179+99	то	179+99.00	384.0 16
179+99	то	184+99	500
184+99	TO	190-07	16
184+99	то	189+97	498

	LOCATION	J	PIPE UNDERDRAIN REMOVAL (SPECIAL)
STATION	TO	STATION	FOOT
189+97	то	202+49	1,252
202+49			16
202+49	то	207+52	503
207+52	T 0	217.51	16
207+52	то	217+51	999
217+51 217+51	то	222+52	16 501
222+52	10	222192	16
222+52	то	227+50	498
227+50			16
227+50	то	237+48	998
237+48			16
237+48	TO	242+53	505
242+53 242+53	то	247+51	16 498
247+51	10	247131	16
247+51	то	260+03	1,252
260+03			16
260+03	то	265+51	548
265+51			16
265+51	TO	270+51	500
270+51 270+51	то	279+98	16 947
279+98	10	2/9+90	16
279+98	то	284+98	500
284+98			16
284+98	то	289+98	500
289+98			16
289+98	то	294+98	500
294+98 294+98	TO	200.00	16 500
	ТО	299+98	16
1 200-08			10
299+98 299+98	TO	303+65	367
299+98 BRIDGE OMIS 305+10	TO	CUM BRANCH) 307+00	367 190
299+98 BRIDGE OMIS 305+10 SOUTHBOUND	SION (MAF TO - OUTSID	CUM BRANCH) 307+00 E SHOULDER	190
299+98 BRIDGE OMIS 305+10	TO	CUM BRANCH) 307+00	
299+98 BRIDGE OMIS 305+10 SOUTHBOUNE 9+78	SION (MAF TO - OUTSID TO	CUM BRANCH) 307+00 E SHOULDER 12+40	190 261.9
299+98 BR IDGE OMI S 305+10 SOUTHBOUND 9+78 99+40 103+60 173+85	SION (MAR TO O - OUTSID TO TO	CUM BRANCH) 307+00 E SHOULDER 12+40 101+80	190 261.9 240 240 67
299+98 BR I DGE OMI S 305+10 9+78 99+40 103+60 173+85 174+52	SION (MAF TO TO TO TO TO TO	CUM BRANCH) 307+00 E SHOULDER 12+40 101+80 106+00 174+52	190 261.9 240 240 67 16
299+98 BR I DGE OMI S 305+10 9+78 99+40 103+60 173+85 174+52 174+52	SION (MAF TO - OUTSID TO TO TO TO TO	CUM BRANCH) 307+00 E SHOULDER 12+40 101+80 106+00 174+52 176+14.31 BK	190 261.9 240 240 67 16 162.3
299+98 BRIDGE OMIS 305+10 9+78 99+40 103+60 173+85 174+52 174+52 174+52 176+15.00 AH	SION (MAF TO TO TO TO TO TO	CUM BRANCH) 307+00 E SHOULDER 12+40 101+80 106+00 174+52	190 261.9 240 240 67 16 162.3 141.0
299+98 BRIDGE OMIS 305+10 9+78 99+40 103+60 173+85 174+52 174+52 176+15.00 AH 177+56.00	SION (MAF TO TO TO TO TO TO TO TO TO	CUM BRANCH) 307+00 E SHOULDER 12+40 101+80 106+00 174+52 176+14.31 BK 177+56	190 261.9 240 240 67 16 162.3 141.0 16
299+98 BRIDGE OMIS 305+10 9+78 99+40 103+60 173+85 174+52 174+52 174+52 176+15.00 AH	SION (MAF TO - OUTSID TO TO TO TO TO	CUM BRANCH) 307+00 E SHOULDER 12+40 101+80 106+00 174+52 176+14.31 BK	190 261.9 240 240 67 16 162.3 141.0
299+98 BR IDGE OMI S 305+10 9+78 99+40 103+60 173+85 174+52 174+52 176+15.00 AH 177+56.00	SION (MAF TO TO TO TO TO TO TO TO TO	CUM BRANCH) 307+00 E SHOULDER 12+40 101+80 106+00 174+52 176+14.31 BK 177+56 179+15	190 261.9 240 240 67 16 162.3 141.0 16 159
299+98 BRIDGE OMIS 305+10 9+78 99+40 103+60 173+85 174+52 174+52 174+52 174+52 174+52 174+52 176+15.00 AH 177+56.00 177+56.226+75 280+75 285+62	SION (MAF TO TO TO TO TO TO TO TO TO TO TO TO	CUM BRANCH) 307+00 E SHOULDER 12+40 101+80 106+00 174+52 176+14.31 BK 177+56 179+15 232+30 285+62	190 261.9 240 240 67 16 162.3 141.0 16 159 555 487 16
299+98 BRIDGE OMIS 305+10 SOUTHBOUNI 9+78 99+40 103+60 173+85 174+52 174+52 174+52 174+52 174+52 174+52 174+52 174+52 226+75 286+75 286+75 286+75 286+75 286+75 286+75 286+75 286+75 285+62 285+62 285+62	SION (MAF TO TO TO TO TO TO TO TO TO TO TO TO	CUM BRANCH) 307+00 E SHOULDER 12+40 101+80 106+00 174+52 176+14.31 BK 177+56 179+15 232+30 285+62 285+95	190 261.9 240 240 67 16 162.3 141.0 16 159 555 487 16 33
299+98 BRIDGE OMIS 305+10 9+78 99+40 103+60 173+85 174+52 174+52 176+15.00 AH 177+56.00 177+56 226+75 285+62 285+62 285+62 301+40	SION (MAF TO TO TO TO TO TO TO TO TO TO TO TO TO	CUM BRANCH) 307+00 E SHOULDER 12+40 101+80 106+00 174+52 176+14.31 BK 177+56 179+15 232+30 285+62 285+95 303+89	190 261.9 240 67 16 162.3 141.0 16 159 555 487 16 33 249
299+98 BRIDGE OMIS 305+10 SOUTHBOUNI 9+78 99+40 103+60 173+85 174+52 174+52 174+52 174+52 174+52 174+52 174+52 174+52 226+75 286+75 286+75 286+75 286+75 286+75 286+75 286+75 286+75 285+62 285+62 285+62	SION (MAF TO TO TO TO TO TO TO TO TO TO TO TO	CUM BRANCH) 307+00 E SHOULDER 12+40 101+80 106+00 174+52 176+14.31 BK 177+56 179+15 232+30 285+62 285+95	190 261.9 240 240 67 16 162.3 141.0 16 159 555 487 16 33
299+98 BR IDGE OMI S 305+10 SOUTHBOUND 9+78 99+40 103+60 173+85 174+52 174+52 176+15.00 AH 177+56.00 177+56.00 177+56 226+75 280+75 285+62 285+62 285+62 301+40 305+32	SION (MAF TO TO TO TO TO TO TO TO TO TO TO TO TO	CUM BRANCH) 307+00 E SHOULDER 12+40 101+80 106+00 174+52 176+14.31 BK 177+56 179+15 232+30 285+62 285+95 303+89	190 261.9 240 67 16 162.3 141.0 16 159 555 487 16 33 249
299+98 BR IDGE OMI S 305+10 SOUTHBOUND 9+78 99+40 103+60 173+85 174+52 174+52 176+15.00 AH 177+56.00 177+56.00 177+56 226+75 280+75 285+62 285+62 285+62 301+40 305+32	SION (MAF TO TO TO TO TO TO TO TO TO TO TO TO TO	CUM BRANCH) 307+00 E SHOULDER 12+40 101+80 106+00 174+52 176+14.31 BK 177+56 179+15 232+30 285+62 285+95 303+89 307+46	190 261.9 240 67 16 162.3 141.0 16 159 555 487 16 33 249
299+98 BRIDGE OMIS 305+10 9+78 99+40 103+60 173+85 174+52 174+52 176+15.00 AH 177+56 226+75 285+62 285+62 285+62 285+62 301+40 305+32 NORTHBOUN 9+78.11 10+60	SION (MAF TO TO TO TO TO TO TO TO TO TO TO TO TO	CUM BRANCH) 307+00 E SHOULDER 12+40 101+80 106+00 174+52 176+14.31 BK 177+56 179+15 232+30 285+62 285+95 303+89 307+46 SHOULDER	190 261.9 240 240 67 16 162.3 141.0 16 159 555 487 16 33 249 214
299+98 BRIDGE OMIS 305+10 9+78 99+40 103+60 173+85 174+52 176+15.00 AH 177+56 226+75 285+62 285+62 301+40 305+32 NORTHBOUN 9+78.11 10+60 14+49	SION (MAF TO TO TO TO TO TO TO TO TO TO TO TO TO	CUM BRANCH) 307+00 E SHOULDER 12+40 101+80 106+00 174+52 176+14.31 BK 177+56 179+15 232+30 285+62 285+95 303+89 307+46 SHOULDER	190 261.9 240 67 16 162.3 141.0 16 159 555 487 16 33 249 214 470.9 16 513
299+98 BR IDGE OMI S 305+10 9+78 99+40 103+60 173+85 174+52 174+52 176+15.00 AH 177+56 226+75 280+75 280+75 285+62 301+40 305+32 NORTHBOUN 9+78.11 10+60 14+49 14+49	SION (MAF TO TO TO TO TO TO TO TO TO TO TO TO TO	CUM BRANCH) 307+00 E SHOULDER 12+40 101+80 106+00 174+52 176+14.31 BK 177+56 179+15 232+30 285+62 285+95 303+89 307+46 E SHOULDER 14+49 19+62	190 261.9 240 240 67 16 162.3 141.0 16 159 555 487 16 33 249 214 470.9 16 513 16
299+98 BRIDGE OMIS 305+10 SOUTHBOUND 9+78 99+40 103+60 173+85 174+52 174+52 174+52 176+15.00 AH 177+56.00 177+56.00 177+56.2 285+62 285+62 285+62 285+62 285+62 301+40 305+32 NORTHBOUN 9+78.11 10+60 14+49 14+49 19+62	SION (MAF TO TO TO TO TO TO TO TO TO TO TO TO TO	CUM BRANCH) 307+00 E SHOULDER 12+40 101+80 106+00 174+52 176+14.31 BK 177+56 179+15 232+30 285+62 285+95 303+89 307+46 E SHOULDER 14+49	190 261.9 240 240 67 16 162.3 141.0 16 159 555 487 16 33 249 214 470.9 16 513 16 1,040
299+98 BRIDGE OMIS 305+10 SOUTHBOUND 9+78 99+40 103+60 173+85 174+52 174+52 174+52 174+52 174+52 174+52 174+52 174+52 285+62 285+62 285+62 285+62 285+62 285+62 285+62 301+40 305+32 NORTHBOUN 9+78.11 10+60 14+49 19+62 19+62	SION (MAF TO TO TO TO TO TO TO TO TO TO TO TO TO	CUM BRANCH) 307+00 E SHOULDER 12+40 101+80 106+00 174+52 176+14.31 BK 177+56 179+15 232+30 285+62 285+95 303+89 307+46 SHOULDER 14+49 19+62 30+02	190 261.9 240 240 67 16 162.3 141.0 16 159 555 487 16 33 249 214 470.9 16 513 16 1,040 16
299+98 BRIDGE OMIS 305+10 SOUTHBOUND 9+78 99+40 103+60 173+85 174+52 174+52 174+52 176+15.00 AH 177+56.00 177+56.00 177+56.2 285+62 285+62 285+62 285+62 285+62 301+40 305+32 NORTHBOUN 9+78.11 10+60 14+49 14+49 19+62	SION (MAF TO TO TO TO TO TO TO TO TO TO TO TO TO	CUM BRANCH) 307+00 E SHOULDER 12+40 101+80 106+00 174+52 176+14.31 BK 177+56 179+15 232+30 285+62 285+95 303+89 307+46 E SHOULDER 14+49 19+62	190 261.9 240 240 67 16 162.3 141.0 16 159 555 487 16 33 249 214 470.9 16 513 16 1,040
299+98 BRIDGE OMIS 305+10 SOUTHBOUNI 9+78 99+40 103+60 173+85 174+52 174+52 174+52 174+52 174+52 174+52 174+52 174+52 285+62 285+62 285+62 285+62 285+62 285+62 301+40 305+32 NORTHBOUN 9+78.11 10+60 14+49 19+62 30+02	SION (MAF TO TO TO TO TO TO TO TO TO TO TO TO TO	CUM BRANCH) 307+00 E SHOULDER 12+40 101+80 106+00 174+52 176+14.31 BK 177+56 179+15 232+30 285+62 285+95 303+89 307+46 SHOULDER 14+49 19+62 30+02	190 261.9 240 240 67 16 162.3 141.0 16 159 555 487 16 33 249 214 470.9 16 513 16 1,040 16 510
299+98 BRIDGE OMIS 305+10 SOUTHBOUND 9+78 99+40 103+60 173+85 174+52 174+52 174+52 174+52 174+52 174+52 177+56 226+75 285+62 285+62 285+62 285+62 285+62 301+40 305+32 NORTHBOUN 9+78.11 10+60 14+49 14+49 19+62 19+62 30+02 30+02	SION (MAF TO TO TO TO TO TO TO TO TO TO TO TO TO	CUM BRANCH) 307+00 E SHOULDER 12+40 101+80 106+00 174+52 176+14.31 BK 177+56 179+15 232+30 285+62 285+95 303+89 307+46 E SHOULDER 14+49 19+62 30+02 35+12	190 261.9 240 240 67 16 162.3 141.0 16 159 555 487 16 33 249 214 470.9 16 513 16 1,040 16 510 16
299+98 BRIDGE OMIS 305+10 SOUTHBOUND 9+78 99+40 103+60 173+85 174+52 174+52 174+52 174+52 174+52 174+52 174+52 226+75 285+62 285+62 285+62 285+62 285+62 285+62 301+40 305+32 NORTHBOUN 9+78.11 10+60 14+49 19+62 19+62 30+02 30+02 35+12 35+12 40+00	SION (MAF TO TO TO TO TO TO TO TO TO TO TO TO TO	CUM BRANCH) 307+00 E SHOULDER 12+40 101+80 106+00 174+52 176+14.31 BK 177+56 179+15 232+30 285+62 285+95 303+89 307+46 E SHOULDER 14+49 19+62 30+02 35+12	190 261.9 240 240 67 16 162.3 141.0 16 159 555 487 16 33 249 214 470.9 16 513 16 513 16 513 16 513 16 510 16 488 16 500
299+98 BRIDGE OMIS 305+10 SOUTHBOUNI 9+78 99+40 103+60 173+85 174+52 174+52 174+52 174+52 174+52 174+52 174+52 280+75 280+75 280+75 285+62 285+62 301+40 305+32 NORTHBOUN 9+78.11 10+60 14+49 19+62 19+62 30+02 30+02 35+12 35+12 40+00 40+00	SION (MAF TO TO TO TO TO TO TO TO TO TO TO TO TO	CUM BRANCH) 307+00 E SHOULDER 12+40 101+80 106+00 174+52 176+14.31 BK 177+56 179+15 232+30 285+62 285+95 303+89 307+46 E SHOULDER 14+49 19+62 30+02 35+12 40+00 45+00	190 261.9 240 240 67 16 162.3 141.0 16 159 555 487 16 33 249 214 470.9 16 513 16 513 16 1,040 16 510 16 488 16 500 16
299+98 BRIDGE OMIS 305+10 SOUTHBOUNI 9+78 99+40 103+60 173+85 174+52 174+52 174+52 174+52 174+52 174+52 174+52 285+62 285+62 285+62 285+62 285+62 285+62 285+62 285+62 285+62 301+40 305+32 NORTHBOUN 9+78.11 10+60 14+49 14+49 14+49 14+49 14+49 19+62 30+02 30+02 30+02 35+12 40+00 45+00	SION (MAF TO TO TO TO TO TO TO TO TO TO TO TO TO	CUM BRANCH) 307+00 E SHOULDER 12+40 101+80 106+00 174+52 176+14.31 BK 177+56 179+15 232+30 285+62 285+95 303+89 307+46 E SHOULDER 14+49 19+62 30+02 35+12 40+00 50+00.00 BK	190 261.9 240 240 67 16 162.3 141.0 16 159 555 487 16 33 249 214 470.9 16 513 16 1,040 16 510 16 488 16 500 16 500.0
299+98 BRIDGE OMIS 305+10 SOUTHBOUND 9+78 99+40 103+60 173+85 174+52 176+15.00 AH 177+56 226+75 285+62 285+62 285+62 285+62 285+62 301+40 305+32 NORTHBOUN 9+78.11 10+60 14+49 19+62 19+62 19+62 30+02 30+02 30+02 30+02 35+12 35+12 40+00 40+00 45+00	SION (MAF TO TO TO TO TO TO TO TO TO TO TO TO TO	CUM BRANCH) 307+00 E SHOULDER 12+40 101+80 106+00 174+52 176+14.31 BK 177+56 179+15 232+30 285+62 285+95 303+89 307+46 E SHOULDER 14+49 19+62 30+02 35+12 40+00 45+00	190 261.9 240 240 67 16 162.3 141.0 16 159 555 487 16 33 249 214 470.9 16 513 16 1,040 16 510 16 488 16 500 16 500.0 484.7
299+98 BRIDGE OMIS 305+10 SOUTHBOUND 9+78 99+40 103+60 173+85 174+52 174+52 176+15.00 AH 177+56.00 177+56.00 177+56.00 177+56.2 285+62 285+62 285+62 285+62 285+62 301+40 305+32 NORTHBOUN 9+78.11 10+60 14+49 14+49 19+62 19+62 19+62 19+62 19+62 30+02 335+12 305+12 35+12 40+00 40+00 40+00 45+00	SION (MAF TO TO TO TO TO TO TO TO TO TO TO TO TO	CUM BRANCH) 307+00 E SHOULDER 12+40 101+80 106+00 174+52 176+14.31 BK 177+56 179+15 232+30 285+62 285+95 303+89 307+46 E SHOULDER 14+49 19+62 30+02 35+12 40+00 50+00.00 BK	190 261.9 240 240 67 16 162.3 141.0 16 159 555 487 16 33 249 214 470.9 16 513 16 1,040 16 513 16 1,040 16 510 16 488 16 500 16 500.0 484.7 16
299+98 BRIDGE OMIS 305+10 SOUTHBOUND 9+78 99+40 103+60 173+85 174+52 174+52 174+52 174+52 174+52 174+52 174+52 285+62 285+62 285+62 285+62 285+62 285+62 285+62 285+62 301+40 305+32 NORTHBOUN 9+78.11 10+60 14+49 19+62 19+62 30+02 30+02 30+02 35+12 35+12 40+00 40+00 49+99.31 AH 45+00 50+00	SION (MAF TO TO TO TO TO TO TO TO TO TO TO TO TO	CUM BRANCH) 307+00 E SHOULDER 12+40 101+80 106+00 174+52 176+14.31 BK 177+56 179+15 232+30 285+62 285+95 303+89 307+46 SHOULDER 14+49 19+62 30+02 35+12 40+00 50+00.00 BK 54+84	190 261.9 240 240 67 16 162.3 141.0 16 159 555 487 16 33 249 214 470.9 16 513 16 513 16 513 16 513 16 510 16 510 16 500 16 500.0 484.7 16 16 16 16 16 16 16 16 16 16
299+98 BRIDGE OMIS 305+10 SOUTHBOUND 9+78 99+40 103+60 173+85 174+52 174+52 176+15.00 AH 177+56.00 177+56.00 177+56.00 177+56.2 285+62 285+62 285+62 285+62 285+62 301+40 305+32 NORTHBOUN 9+78.11 10+60 14+49 14+49 19+62 19+62 19+62 19+62 19+62 30+02 335+12 305+12 35+12 40+00 40+00 40+00 45+00	SION (MAF TO TO TO TO TO TO TO TO TO TO TO TO TO	CUM BRANCH) 307+00 E SHOULDER 12+40 101+80 106+00 174+52 176+14.31 BK 177+56 179+15 232+30 285+62 285+95 303+89 307+46 E SHOULDER 14+49 19+62 30+02 35+12 40+00 50+00.00 BK	190 261.9 240 240 67 16 162.3 141.0 16 159 555 487 16 33 249 214 470.9 16 513 16 1,040 16 513 16 1,040 16 510 16 488 16 500 16 500.0 484.7 16
299+98 BRIDGE OMIS 305+10 SOUTHBOUND 9+78 99+40 103+60 173+85 174+52 174+52 174+52 174+52 174+52 174+52 174+52 285+62 285+62 285+62 285+62 285+62 285+62 285+62 285+62 301+40 305+32 NORTHBOUN 9+78.11 10+60 14+49 19+62 19+62 30+02 30+02 30+02 35+12 35+12 40+00 49+99.31 AH 45+00 50+00 54+84	SION (MAF TO TO TO TO TO TO TO TO TO TO TO TO TO	CUM BRANCH) 307+00 E SHOULDER 12+40 101+80 106+00 174+52 176+14.31 BK 177+56 179+15 232+30 285+62 285+95 303+89 307+46 SHOULDER 14+49 19+62 30+02 35+12 40+00 50+00.00 BK 54+84	190 261.9 240 240 67 16 162.3 141.0 16 159 555 487 16 33 249 214 470.9 16 513 16 513 16 513 16 510 16 488 16 500 16 500.0 484.7 16 527.0
299+98 BRIDGE OMIS 305+10 SOUTHBOUNI 9+78 99+40 103+60 173+85 174+52 174+52 176+15.00 AH 177+56 226+75 285+62 285+62 285+62 285+62 285+62 285+62 285+62 301+40 305+32 NORTHBOUN 9+78.11 10+60 14+49 19+62 19+62 19+62 30+02 30+02 35+12 40+00 40+00 49+99.31 AH 45+00 50+00 54+84 54+84	SION (MAF TO TO TO TO TO TO TO TO TO TO TO TO TO	CUM BRANCH) 307+00 E SHOULDER 12+40 101+80 106+00 174+52 176+14.31 BK 177+56 179+15 232+30 285+62 285+95 303+89 307+46 E SHOULDER 14+49 19+62 30+02 35+12 40+00 45+00 50+00.00 BK 54+84 60+11	190 261.9 240 240 67 16 162.3 141.0 16 159 555 487 16 33 249 214 470.9 16 513 16 1,040 16 510 16 488 16 500 16 507 0 16 507 16 507 16 507 16 507 16 507 16 507 16 507 16 507 16 507 16 507 16 507 16 507 16 507 16 50 507 16

PIPE UNDERDRAIN REMOVALS

	DESIGNED - DRAWN - CHECKED -	REVISED - REVISED - REVISED -	STATE OF ILLINOIS DEPARTMENT OF TRANSPORTATION			SCH	IEDUI	
WWW. HORNERSHIFRIN .COM PLOT DATE = 10/15/2024	DATE -	REVISED -		SCALE: NTS	SHEET 17	OF 37	SHEETS	st از

Р	IPE UNDE	RDRAIN REMO	VALS
	LOCATION	I	PIPE UNDERDRAIN REMOVAL (SPECIAL)
STATION	ТО	STATION	FOOT
273+19			16
278+20 278+20	то	283+20	500 16
283+20	то	288+20	500
283+20		200120	16
288+20	то	293+20	500
288+20		202.20	16
293+20 293+20	то	298+20	500 16
293+20	то	303+40	520
		CUM BRANCH)	
304+82	то	307+00	218
		5. CHOULD 550	
9+78	- оотъто то	E SHOULDER 12+40	261.9
99+40	то	101+80	240
103+60	то	106+00	240
173+85	то	176+14.31 BK	229.3
76+15.00 AH	то	179+15	300.0
226+75	то	232+30	555
280+75	то	282+58	183
0+00		205:05	16
282+58 300+75	то то	285+95 303+18	337 243
304+61	то	307+19	245
504101	10	507+15	230
REST A	REA - RAM	PALT	
12+65.80	то	116+94.20	428
IL 154 INTE	TO	RAMP A RT 167+10.00	128
0+00.00	10	107110.00	16
67+10.00	то	169+15.00	205
167+10.00			16
169+15.00	то	175+70.00	655
169+15.00			16
175+70.00	ТО	176+55.39	85
11 154 INTE	BCHANGE -	RAMP B RT	
176+80.70	ТО	178+13.00	132
0+00.00			16
178+13.00	то	187+28.00	915
178+13.00			16
187+28.00	ТО	188+30.12	102
IL 154 INTE	BCHANGE	RAMP C RT	
76+60.97	TO	185+46.00	885
0+00.00			16
85+46.00	то	187+02.59	157
IL 154 INTE	ERCHANGE -	RAMP C RT 176+24.20	1,266
		170724.20	1,200
	FRANKLIN	COUNTY TOTAL	70,699
EFFERSON COL			
		SHOULDER	CO / 1
	ТО	18+06	684.1 16
	1	21+20	314
18+06	то		
	то		16
18+06 18+06	то то	25+50	16 430
18+06 18+06 21+20			
18+06 18+06 21+20 21+20 25+50 25+50			430 16 430
18+06 18+06 21+20 21+20 25+50 25+50 29+80	TO TO	25+50 29+80	430 16 430 16
18+06 18+06 21+20 21+20 25+50 25+50 29+80 29+80	ТО	25+50	430 16 430 16 430
18+06 18+06 21+20 25+50 25+50 25+50 29+80 29+80 34+10	TO TO TO	25+50 29+80 34+10	430 16 430 16 430 16
18+06 18+06 21+20 25+50 25+50 29+80 29+80 29+80 34+10 34+10	TO TO	25+50 29+80	430 16 430 16 430 16 427
18+06 18+06 21+20 21+20 25+50 25+50 29+80 29+80 29+80 34+10 34+10 38+37	TO TO TO	25+50 29+80 34+10	430 16 430 16 430 16 16
18+06 18+06 21+20 25+50 25+50 29+80 29+80 29+80 34+10 34+10	то то то то	25+50 29+80 34+10 38+37	430 16 430 16 430 16 427 16
18+06 18+06 21+20 21+20 25+50 29+80 29+80 34+10 38+37 38+37	то то то то	25+50 29+80 34+10 38+37	430 16 430 16 430 16 427 16 937
18+06 21+20 25+50 25+50 29+80 34+10 34+10 38+37 38+37 47+74	Т0 Т0 Т0 Т0 Т0 Т0	25+50 29+80 34+10 38+37 47+74	430 16 430 16 430 16 427 16 937 16
18+06 18+06 21+20 25+50 25+50 29+80 34+10 34+10 38+37 38+37 47+74 47+74	Т0 Т0 Т0 Т0 Т0 Т0	25+50 29+80 34+10 38+37 47+74	430 16 430 16 430 16 427 16 937 16 496

.E		F.A. I RTE.	SEC.	TION		COUNTY	TOTAL SHEETS	SHEET NO.
		57	(28-2)B-2;	(28-1)B-2	2	*	598	48
						CONTRACT	NO. 788	84
STA.	TO STA.			ILLINOIS	FED. AI	D PROJECT		

		ERDRAIN REMO	
l	OCAT I O	N	PIPE UNDERDRAI REMOVAL (SPECIAL
STATION	TO	STATION	FOOT
197+07			16
197+07	то	202+01	494
202+01			16
202+01	то	207+01	500
207+01			16
207+01	TO	212+00	499
212+00			16
212+00	то	216+43	443
216+43			16
216+43	TO	220+87	444
220+87			16
220+87	ТО	226+02	515
NORTHBOUND	- OUTSI	DE SHOULDER	
113+80	00101	114+20	40
114+20			16
114+20		119+21	501
119+21			16
119+21		120+20	99
INA INTER	HANGE -	RAMP D RT	1.0
109+19		115.00	16
109+19	то	115+20	698.0
	EFFERSO	N COUNTY TOTAL	46,361
		PROJECT TOTAL	117,060

LC	DCATION		PIPE UNDERDRAIN REMOVAL (SPECIAL)
STATION	TO	STATION	FOOT
NORTHBOUND			
11+22 18+08	то	18+08	686 16
18+08	то	21+20	312
21+20	10	21120	16
21+20	то	25+50	430
25+50			16
25+50	то	29+80	430
29+80			16
29+80	то	34+08	428
34+08 34+08	то	38+35	<u>16</u> 427
38+35	10	50135	16
38+35	то	47+74	939
47+74			16
47+74	TO	52+70	496
52+70			16
52+70	TO	57+70	500 16
57+70 57+70	то	62+64.51 BK	494.5
62+65.57 AH	то	62+67	1.4
62+67			16
62+67	ТО	67+69	502
67+69			16
67+69	то	72+70	501
72+70	то	77 . 71	16
72+70	то	77+71	<u> </u>
77+71	то	82+70	499
82+70			16
82+70	TO	87+70	500
87+70			16
87+70	TO	92+70	500
92+70 92+70	то	96+28	<u>16</u> 358
96+28	10	50120	16
96+28	ТО	100+25	397
100+25			16
100+25	то	104+17	392
104+17	то	100.22	16
104+17 109+22	то	109+22	505 16
109+22	то	114+20	498
114+20			16
114+20	TO	119+21	501
119+21			16
119+21	то	124+22	501
124+22 124+22	то	129+16	16
129+16	.0	123110	16
129+16	то	139+00	984
139+00			16
139+00	то	143+51	451
143+51 143+51	то	148+03	16 452
148+03	10	140+05	16
148+03	то	152+54	451
152+54			16
152+54	TO	156+70	416
156+70			16
156+70	TO	160+87	417
160+87 160+87	то	165+00	<u>16</u> 413
165+00	10	105100	16
165+00	то	168+87	387
168+87			16
168+87	то	172+95	408
172+95	TO	177:00	16
172+95 177+00	то	177+00	405
177+00	то	181+97	497
181+97	.0	101107	16
181+97	то	191+93	996
191+93			16
191+93	то	197+07	514

PIPE UNDERDRAIN REMOVALS

L	ΟΓΤΑΟ	N	PIPE UNDERDRAIN REMOVAL (SPECIAL)
STATION	ТО	STATION	FOOT
57+70	TO	62+65 BK	494.5
62+65.57 AH 62+67.00	TO	62+67	1.4
62+67	то	67+70	503
67+70			16
67+70	TO	72+71	501
72+71 72+71	то	77+72	16 501
77+72		77172	16
77+72	TO	82+69	497
82+69 82+69	TO	87+70	<u>16</u> 501
87+70	10	0,1,0	16
87+70	TO	92+71	501
92+71 92+71	то	96+28	<u> </u>
96+28	10	50120	16
96+28	TO	100+25	397
100+25 100+25	то	104+20	16 395
100+25	10	104720	16
104+20	TO	109+22	502
109+22 109+22	то	114+21	16 499
114+21			16
114+21	TO	119+20	499
119+20 119+20	то	124+19	<u> </u>
124+19	10	124113	16
124+19	TO	129+20	501
129+20 129+20	TO	139+03	16 983
139+03	10	155+05	16
139+03	ΤO	143+50	447
143+50 143+50	то	148+01	16 451
143+50	10	143+01	16
148+01	ТО	152+50	449
152+50 152+50	то	156+69	16 419
156+69			16
156+69	то	160+87	418
160+87 160+87	то	164+97	410
164+97			16
164+97 168+88	ТО	168+88	391 16
168+88	то	172+98	410
172+98			16
172+98 177+00	то	177+00	402
177+00	TO	182+00	500
182+00		102:00	16
182+00 192+00	ΤO	192+00	1,000
192+00	TO	197+01	501
197+01		202:01	16
197+01 202+01	TO	202+01	500 16
202+01	TO	207+00	499
207+00 207+00	то	212+00	16 500
212+00	10	212+00	16
212+00	TO	216+44	444
216+44 216+44	то	220+88	16
220+88		220100	16
220+88	TO	226+02	514
SOUTHBOUND	- OUTST	DE SHOULDER	
113+80	TO	113+83	3
113+83	TO	110-25	16
113+83 118+25	то	118+25	442
118+25	то	120+20	195

REVISED -SCHEDUL STATE OF ILLINOIS DEPARTMENT OF TRANSPORTATION REVISED -PLOT SCALE = 0.16666633 ' / in. PLOT DATE = 10/15/2024 CHECKED -REVISED -DATE REVISED -SCALE: NTS SHEET 18 OF 37 SHEETS -

JL	.E		F.A. I RTE.	SECT	TION		COUNTY	TOTAL SHEETS	SHEET NO.
			57	(28-2)B-2;	(28-1)B-2	2	*	598	49
_							CONTRACT	NO. 788	84
TS	STA.	TO STA.			ILLINOIS	FED. AI	D PROJECT		

		PI	PE UNDEF	RDRAINS		
	LOC	AT I ON		PIPE UNDERDRAINS TYPE 2,4"	PIPE UNDERDRAINS 4" (SPECIAL)	CONCRETE HEADWALLS FOR PIPE UNDERDRAINS
STATION	ΤO	STATION	SIDE	FOOT	FOOT	EACH
RANKLIN COUNTY						
07011		SHOULDER		105.0		
9+78.11 10+71.00	TO	10+71.00	SB / NB SB / NB	185.8	30	
10+71.00	то	15+50.00	SB / NB	958.0	50	
15+50.00			SB / NB		30	
15+50.00	TO	20+26.00	SB / NB	952.0		
20+26.00 20+26.00	то	25+00.00	SB / NB SB / NB	948.0	30	
25+00.00	10	25+00.00	SB / NB	548.0	30	
25+00.00	TO	30+00.00	SB / NB	1000.0		
30+00.00			SB / NB		30	
30+00.00	TO	34+90.00	SB / NB SB / NB	980.0	20	
34+90.00 34+90.00	то	39+00.00	SB / NB	820.0	30	
39+00.00	10	35100.00	SB / NB	020.0	30	
39+00.00	ТО	44+00.00	SB / NB	1000.0		
44+00.00		40.000.000	SB / NB		30	
44+00.00 48+00.00	TO	48+00.00	SB / NB SB / NB	800.0	60	
48+00.00	то	50+00.00 BK	SB / NB	400.0	00	
49+99.31 AH	то	51+35.00	SB / NB	271.4		
51+35.00			SB / NB		30	
51+35.00 56+00.00	TO	56+00.00	SB / NB	930.0	20	
56+00.00	то	60+00.00	SB / NB SB / NB	800.0	30	
60+00.00		00100100	SB / NB	00010	30	
60+00.00	ΤO	64+00.00	SB / NB	800.0		
64+00.00 64+00.00	то	68+00.00	SB / NB SB / NB	800.0	30	
68+00.00	10	68+00.00	SB / NB	800.0	30	
68+00.00	ТО	72+00.00	SB / NB	800.0		
72+00.00			SB / NB		30	
72+00.00	ТО	76+00.00	SB / NB	800.0	2.0	
76+00.00 76+00.00	то	80+00.00	SB / NB SB / NB	800.0	30	
80+00.00	10	00100.00	SB / NB	000.0	30	
80+00.00	ТО	84+00.00	SB / NB	800.0		
84+00.00			SB / NB		30	
84+00.00 88+00.00	TO	88+00.00	SB / NB SB / NB	800.0	30	
88+00.00	то	92+00.00	SB / NB	800.0	50	
92+00.00			SB / NB		30	
92+00.00	TO	96+00.00	SB / NB	800.0		
96+00.00 96+00.00	то	100+00.00	SB / NB SB / NB	800.0	30	
100+00.00	10	100+00.00	SB / NB	800.0	30	
100+00.00	то	101+64.25	SB / NB	328.5		
		ON (GUN CREEK)				
103+75.75 106+00.00	ТО	106+00.00	SB / NB SB / NB	448.5	60	
106+00.00	то	110+00.00	SB / NB	800.0	00	
110+00.00			SB / NB		30	
110+00.00	TO	114+00.00	SB / NB	800.0		
114+00.00	T.0	110,00,00	SB / NB	000.0	30	
114+00.00 118+00.00	TO	118+00.00	SB / NB SB / NB	800.0	30	
118+00.00	ТО	122+00.00	SB / NB	800.0	30	
122+00.00			SB / NB		30	
122+00.00	TO	126+00.00	SB / NB	800.0	20	
126+00.00 126+00.00	то	130+00.00	SB / NB SB / NB	800.0	30	
130+00.00			SB / NB		30	
130+00.00	TO	134+00.00	SB / NB	800.0		
134+00.00		120100 00	SB / NB	800.0	30	
134+00.00 138+00.00	то	138+00.00	SB / NB SB / NB	800.0	30	
138+00.00	то	142+00.00	SB / NB	800.0		
142+00.00			SB / NB		30	
142+00.00	то	146+00.00	SB / NB	800.0	20	
146+00.00 146+00.00	то	150+00.00	SB / NB SB / NB	800.0	30	
150+00.00			SB / NB	500.0	30	

		PI	PE UNDER	DRAINS		
	LOCA	AT I ON		PIPE UNDERDRAINS TYPE 2,4"	PIPE UNDERDRAINS 4" (SPECIAL)	CONCRETE HEADWALLS FOR PIPE UNDERDRAINS
STATION	TO	STATION	SIDE	FOOT	FOOT	EACH
150+00.00	то	154+00.00	SB / NB	800.0	20	
54+00.00 54+00.00	то	158+00.00	SB / NB SB / NB	800.0	30	
3+00.00	10	150100.00	SB / NB		30	
8+00.00	ТО	161+00.00	SB / NB	600.0		
61+00.00			SB / NB		30	
51+00.00 54+66.00	то	164+66.00	SB / NB SB / NB	732.0	30	
54+66.00	то	169+60.00	SB / NB	988.0	50	
9+60.00			SB / NB		30	
59+60.00	TO	174+60.00	SB / NB	1000.0		
74+60.00	то	176+14.31 BK	SB / NB SB / NB	308.6	30	
76+15.00 AF		177+50.00	SB / NB	270.0		
7+50.00			SB / NB		30	
77+50.00	то	182+00.00	SB / NB	900.0	2.0	
32+00.00 32+00.00	то	186+24.00	SB / NB SB / NB	848.0	30	
36+24.00	10	100124.00	SB / NB		30	
86+24.00	то	191+00.00	SB / NB	952.0		
1+00.00	To	105,00,00	SB / NB		30	
1+00.00 5+00.00	TO TO	195+00.00 199+20.00	SB / NB SB / NB	800.0 840.0		
9+20.00	10	199720.00	SB / NB	040.0	30	
9+20.00	TO	200+00.00 BK	SB / NB	160.0		
00+00.70 AH	н то	203+00.00	SB / NB	598.6	20	
)3+00.00)3+00.00	то	206+70.00	SB / NB SB / NB	740.0	30	
06+70.00	10	200170.00	SB / NB	/40.0	30	
06+70.00	то	211+48.00	SB / NB	956.0		
1+48.00	TO	216-10-00	SB / NB	1000.0	30	
11+48.00 16+48.00	TO	216+48.00	SB / NB SB / NB	1000.0	30	
16+48.00	то	218+86.00	SB / NB	476.0		
18+86.00			SB / NB		30	
18+86.00 22+21.00	TO	222+21.00	SB / NB SB / NB	670.0	60	
22+21.00	то	226+34.00	SB / NB	826.0	00	
26+34.00			SB / NB		30	
26+34.00 29+80.00	то	229+80.00	SB / NB SB / NB	692.0	30	
29+80.00	то	234+68.00	SB / NB	976.0	50	
34+68.00			SB / NB	0,010	30	
34+68.00	TO	239+50.00	SB / NB	964.0		
39+50.00 39+50.00	то	242107 42 84	SB / NB	604.0	30	
9+50.00 3+00.98 AF	то 1 то	242+97.43 BK 244+45.00	SB / NB SB / NB	694.9 288.0		
4+45.00			SB / NB		30	
4+45.00	TO	249+00.00	SB / NB	910.0		
9+00.00 9+00.00	то	253+50.00	SB / NB SB / NB	900.0	30	
3+50.00	ТО	258+00.00	SB / NB	900.0		
8+00.00			SB / NB		30	
8+00.00	TO	263+00.00	SB / NB	1000.0	20	
3+00.00 3+00.00	то	268+00.00	SB / NB SB / NB	1000.0	30	
8+00.00			SB / NB		30	
8+00.00	TO	272+73.00	SB / NB	946.0		
2+73.00	то	275+00.00	SB / NB SB / NB	454.0	30	
72+73.00 75+00.00	10	2/3700.00	SB / NB SB / NB	434.0	30	
75+00.00	то	278+00.00	SB / NB	600.0		
/8+00.00			SB / NB		30	
78+00.00 30+50.00	ТО	280+50.00	SB / NB SB / NB	500.0	30	
30+50.00 30+50.00	то	284+00.00	SB / NB SB / NB	700.0	30	
84+00.00			SB / NB		30	
84+00.00	TO	288+00.00	SB / NB	800.0		
8+00.00 8+00.00	то	292+17.00	SB / NB SB / NB	834.0	30	
2+17.00		2.52:17.00	SB / NB	0.54.0	30	
2+17.00	то	296+42.00	SB / NB	850.0		
96+42.00			SB / NB		30	
1					I	F.A.I SECTIO
		· · · ·	SCHEDUL	- E	F	RTE. SECTION 57 (28-2)B-2; (2

	USER NAME = jahaas	DESIGNED -	REVISED -			SCHEDULE		F.A. I RTE.	SECTION	C	COUNTY S	TOTAL SHEET SHEETS NO.
		DRAWN -	REVISED -	STATE OF ILLINOIS				57	(28-2)B-2; (28-1)	3-2	*	598 50
SHIFHIN	PLOT SCALE = 0.16666633 '/ in.	CHECKED -	REVISED -	DEPARTMENT OF TRANSPORTATION						C		NO. 78884
WWW. HORNERSHIFRIN .COM	PLOT DATE = 10/15/2024	DATE -	REVISED -		SCALE: NTS SHEET 19 OF 37 SHEETS STA. TO STA.			ILLINC	IS FED. AID PRO			
											* EDANK	(LIN/JEEEEBSON

		PI	PE UNDEF	RDRAINS		
	LOCA	TION		PIPE UNDERDRAINS TYPE 2,4"	PIPE UNDERDRAINS 4" (SPECIAL)	CONCRETE HEADWALLS FOR PIPE UNDERDRAINS
STATION	ТО	STATION	SIDE	FOOT	FOOT	EACH
296+42.00	TO	299+00.00	SB / NB	516.0		
299+00.00			SB / NB		30	
299+00.00	TO	301+80.00	SB / NB	560.0		
301+80.00			SB / NB		60	
301+80.00	TO	303+27.64	NB	147.6		
301+80.00	TO	303+48.47	SB	168.5		
		(MARCUM BRANCH)				
305+01.53	TO	306+00.00	NB	98.5		
305+12.07	TO	306+00.00	SB CD (ND	87.9	60	
306+00.00 306+00.00	то	307+00.00	SB / NB SB / NB	200.0	00	
300+00.00	10	307+00.00	3D / ND	200.0		
	OUTSIDE	SHOULDER				
9+78.11	TO	12+40.00	SB / NB	523.8		
12+40.00		-	SB / NB	-	40	2
99+40.00			SB / NB		40	2
99+40.00		101+64.25	SB / NB	448.5		
		ON (GUN CREEK)				
103+75.75	TO	106+00.00 ##	SB / NB	448.5		
106+00.00			SB / NB		40	2
173+85.00			SB / NB		40	2
173+85.00	ТО	175+00.00	SB / NB	230.0		-
175+00.00	TO	176-14 21 51	SB / NB	220.5	40	2
175+00.00	TO	176+14.31 BK	SB / NB	228.6		
176+15.00 AH 202+03.00 ##	то то	179+15.00 0+00.00 ##	SB / NB SB / NB	600.0		
179+15.00 ##	10	0700.00 ##	SB / NB SB / NB		40	2
0+00.00 ##	то	0+00.00 ##	SB / NB			۷.
226+75.00		0,00,00 ##	SB / NB		40	2
226+75.00	ТО	228+50.00	SB	175.0		
228+50.00		-	SB		20	1
228+50.00	TO	232+30.00	SB	380.0		
226+75.00	TO	230+50.00	NB	375.0		
230+50.00			NB		20	1
230+50.00	TO	232+30.00	NB	180.0		
232+30.00			SB / NB		40	2
0+00.00 ##	TO	0+00.00	SB			
67+70.00 ##	TO	0+00.00	NB CB (NB		4.0	2
280+75.00 280+75.00	то	285+95.00	SB / NB SB / NB	1040.0	40	2
280+75.00	10	203793.00	SB / NB	1040.0	40	2
300+75.00			NB		20	1
300+75.00	то	303+08.00	NB	233.0	20	-
301+40.00			SB		20	1
301+40.00	то	303+68.00	SB	228.0		
		(MARCUM BRANCH)				
304+82.00	TO	307+19.00	NB	237.0		
304+82.00			NB		20	1
305+48.00	TO	307+46.00	SB	198.0		
305+48.00			SB		20	1
25+50.00	TO	0+00.00	SB			
77+72.00	TO	0+00.00	NB			
	D 41	MPS				
+00.00	ΠAI	· · · · ·				
112+65.80			LT		20	1
112+65.80	TO	116+94.20	LT	464.2		-
AMP A - 154 INT						
165+81.54	TO	167+10.00	RT	136.1		
167+10.00			RT		20	1
167+10.00	TO	170+81.00	RT	503.0		
170+81.00	Ŧa	175.52.00	RT	542.5	20	1
170+81.00	TO	175+53.00	RT	542.1	20	1
175+53.00	TO	176,55,20	RT	120.1	20	1
175+53.00		176+55.39	RT	138.4		
AMP B - 154 INT 176+80.70	TO	178+35.00	RT	188.5		
178+35.00	10	10100.00	RT	100.0	20	1
178+35.00	TO	183+09.00	RT	551.8		
183+09.00	. 9		RT		20	1
183+09.00	то	187+26.00	RT	500.9		
187+26.00			RT		20	1

		Р	IPE UNDEF	RDRAINS		
	LOCA	AT I ON		PIPE UNDERDRAINS TYPE 2, 4"	PIPE UNDERDRAINS 4" (SPECIAL)	CONCRETE HEADWALLS FOR PIPE UNDERDRAINS
STATION	TO	STATION	SIDE	FOOT	FOOT	EACH
RAMP C - 154 I 176+60.97	TO	177+85.00	RT	169.2		
177+85.00			RT		20	1
177+85.00 181+68.00	то	181+68.00	RT RT	431.5	20	1
181+68.00	то	185+46.00	RT	497.8	20	1
185+46.00			RT		20	1
185+46.00 RAMP D - 154 I		187+02.59	RT	163.4		
163+58.70	TO	165+06.00	RT	148.4		
165+06.00			RT		20	1
165+06.00 169+25.00	то	169+25.00	RT RT	497.5	20	1
169+25.00	то	174+13.00	RT	538.1	20	1
174+13.00			RT		20	1
174+13.00	то	176+24.20	RT	236.9		
		FRANKLIN CO	UNTY TOTAL	. 70013	3060	39
EFFERSON COU	NTY					
		SHOULDER				
11+21.89 14+00.00	то	14+00.00 17+00.00	SB / NB SB / NB	556.2 600		
17+00.00		1,100.00	SB / NB		30	
17+00.00	ТО	22+00.00	SB / NB	1000		
22+00.00	то	26+26.00	SB / NB SB / NB	852	60	
26+26.00	10	20+20.00	SB / NB	0.52	30	
26+26.00	то	30+68.00	SB / NB	884		
30+68.00 30+68.00	то	35+00.00	SB / NB SB / NB	864	30	
35+00.00	10	35+00.00	SB / NB	304	30	
35+00.00	то	39+00.00	SB / NB	800		
39+00.00 39+00.00	то	44+00.00	SB / NB SB / NB	1000	30	
44+00.00	то	47+00.00	SB / NB	600		
47+00.00			SB / NB		30	
47+00.00	ТО	50+70.00	SB / NB SB / NB	740	30	
50+70.00	то	53+65.00	SB / NB	590	50	
53+65.00			SB / NB		30	
53+65.00 57+76.00	то	57+76.00	SB / NB SB / NB	822	30	
57+76.00	то	62+00.00	SB / NB	848	50	
62+00.00			SB / NB		30	
62+00.00 62+65.57	то АН ТО	62+64.51 BK 66+00.00	SB / NB SB / NB	129.0 668.9		
66+00.00		00+00.00	SB / NB	000.9	30	
66+00.00	то	70+12.00	SB / NB	824		
70+12.00	то	73+00.00	SB / NB SB / NB	576	30	
73+00.00		,,,,,,,,,,,,,,,,,,,,,,,,,,,,,,,,,,,,,,,	SB / NB	570	30	
73+00.00	TO	76+20.00	SB / NB	640	20	
76+20.00	то	78+56.00	SB / NB SB / NB	472	30	
78+56.00		,,,,,,,,,,,,,,,,,,,,,,,,,,,,,,,,,,,,,,,	SB / NB		30	
78+56.00	то	81+97.00	SB / NB	682	20	
81+97.00 81+97.00	то	85+00.00	SB / NB SB / NB	606	30	
85+00.00			SB / NB		30	
85+00.00	то	88+00.00	SB / NB	600		
88+00.00 88+00.00	то	92+40.00	SB / NB SB / NB	880	30	
92+40.00			SB / NB		30	
92+40.00	ТО	96+55.00	SB / NB	830		
96+55.00 96+55.00	то	98+45.00	SB / NB SB / NB	380	60	
98+45.00		55145100	SB / NB		30	
98+45.00	ТО	103+40.00	SB / NB	990		
103+40.00	то	108+35.00	SB / NB SB / NB	990	30	
103+40.00		100755.00	SB / NB	330	30	
108+35.00	то	113+30.00	SB / NB	990		
			00000000	F	In	F.A.I SECTI
			SCHEDUI	_ C		RTE. SECT 57 (28-2)B-2; (2

HORNER SHIFRIN WWW. HORNERSHIFRIN.COM

	USER NAME = jahaas	DESIGNED -	REVISED -				SCH	IEDUL	F
:H		DRAWN -	REVISED -	STATE OF ILLINOIS			001		
	PLOT SCALE = 0.16666633 ' / in.	CHECKED -	REVISED -	DEPARTMENT OF TRANSPORTATION					
1	PLOT DATE = 10/15/2024	DATE -	REVISED -		SCALE: NTS	SHEET 20	OF 37	SHEETS	S

	E		F.A. I RTE.	SECT	TION		COUNTY	TOTAL SHEETS	SHEET NO.
			57	(28-2)B-2;	(28-1)B-2		*	598	51
_							CONTRACT	NO. 788	84
s	STA.	TO STA.			ILLINOIS	FED. AI	D PROJECT		

	LOC	AT I ON		PIPE UNDERDRAINS TYPE 2,4"	PIPE UNDERDRAINS 4" (SPECIAL)	CONCRETE HEADWALLS FOR PIPE UNDERDRAINS
STATION	TO	STATION	SIDE	FOOT	FOOT	EACH
113+30.00 113+30.00	то	117+30.00	SB / NB SB / NB	800	30	
117+30.00		11,,,50,100	SB / NB		30	
117+30.00	TO	120+00.00	SB / NB	540	2.0	
120+00.00 120+00.00	то	123+40.00	SB / NB SB / NB	680	30	
123+40.00		125110100	SB / NB		30	
123+40.00	TO	126+37.00	SB / NB	594	2.0	
126+37.00 126+37.00	то	130+89.00	SB / NB SB / NB	904	30	
130+89.00			SB / NB		30	
130+89.00	TO	133+00.00	SB / NB	422	2.0	
133+00.00 133+00.00	то	137+34.00	SB / NB SB / NB	868	30	
137+34.00			SB / NB		30	
137+34.00	то	141+36.00	SB / NB	804	30	
141+36.00 141+36.00	то	145+36.00	SB / NB SB / NB	800	50	
145+36.00			SB / NB		30	
145+36.00	то	149+75.00	SB / NB	878	20	
149+75.00 149+75.00	то	154+70.00	SB / NB SB / NB	990	30	
154+70.00			SB / NB		30	
154+70.00	TO	158+30.00	SB / NB	720	20	
158+30.00 158+30.00	то	161+00.00	SB / NB SB / NB	540	30	
161+00.00			SB / NB		30	
161+00.00	TO	165+00.00	SB / NB SB / NB	800	60	
165+00.00 165+00.00	то	168+75.00	SB / NB	750	60	
168+75.00			SB / NB		30	
168+75.00	TO	173+00.00	SB / NB SB / NB	850	30	
173+00.00 173+00.00	то	177+00.00	SB / NB	800	50	
177+00.00			SB / NB		30	
177+00.00 181+00.00	TO	181+00.00	SB / NB SB / NB	800	30	
181+00.00	то	184+90.00	SB / NB	780	50	
184+90.00		100.00	SB / NB	62.0	30	
184+90.00 188+00.00	TO TO	188+00.00 191+60.00	SB / NB SB / NB	620 720		
191+60.00			SB / NB		30	
191+60.00	TO	196+10.00	SB / NB	900	20	
196+10.00 196+10.00	то	200+00.00	SB / NB SB / NB	780	30	
200+00.00			SB / NB		30	
200+00.00 203+40.00	то	203+40.00	SB / NB SB / NB	680	30	
203+40.00	то	208+00.00	SB / NB	920		
208+00.00		212 22 23	SB / NB		60	
208+00.00 212+00.00	то	212+00.00	SB / NB SB / NB	800	30	
212+00.00	то	216+00.00	SB / NB	800		
216+00.00	TO	220:00 00	SB / NB		30	
216+00.00 220+00.00	то	220+00.00	SB / NB SB / NB	800	30	
220+00.00	TO	224+00.00	SB / NB	800		
224+00.00	то	226+02-00	SB / NB	404	30	
224+00.00	ТО	226+02.00	SB / NB	404		
		SHOULDER				
11+21.89 13+05.00	то	13+05.00	SB / NB SB / NB	366.2	40	2
13+05.00	ТО	15+70.00	SB / NB	530	0+	<u>ک</u>
15+70.00			SB / NB		40	2
97+18.40 97+31.80	то то	97+58.70 97+72.10	NB SB	40.3		
113+80.00		5			40	2
113+80.00	ТО	118+20.00	SB / NB	440	4.2	
118+20.00 118+20.00	то	120+20.00	SB / NB	200	40	2
120+20.00	1			200	40	2

		P	IPE UNDER	DRAINS		
	LOCA	TION		PIPE UNDERDRAINS TYPE 2,4"	PIPE UNDERDRAINS 4" (SPECIAL)	CONCRETE HEADWALLS FOR PIPE UNDERDRAINS
STATION	ТО	STATION	SIDE	FOOT	FOOT	EACH
	RAN	4PS				
RAMP A - INA INT	FERCHANGE					
109+03.20	TO	114+12.20	RT	373.9		
RAMP B - INA INT	ERCHANGE					
123+64.50	ТО	125+96.10	RT	241.9		
RAMP C - INA INT	ERCHANGE					
122+60.30	TO	125+62.90	RT	309.8		
RAMP D - INA INT	ERCHANGE					
108+15.60	TO	109+22.00	RT	107.3		
109+22.00		113+46.00	RT	492.1	20	1
109+22.00	TO					
113+46.00		115+25.30	RT	204.4	20	1
113+46.00	TO					
		JEFFERSON CO	UNTY TOTAL	46305	1950	12
		PRO	JECT TOTAL	116318	5010	51

pw2/PW01.homershiftin.com:HS IDOT/Documents/210610000-PTB198-034_D9VV/2

	USER NAME = jahaas	DESIGNED - DRAWN -	REVISED - REVISED -	STATE OF ILLINOIS			SCF	HEDUL	E
♥SHIFRIN	PLOT SCALE = 0.16666633 ' / in.	CHECKED -	REVISED -	DEPARTMENT OF TRANSPORTATION		-			
WWW. HORNERSHIFRIN .COM	PLOT DATE = 10/15/2024	DATE -	REVISED -		SCALE: NTS	SHEET 21	OF 37	SHEETS	STA ز

LE	F.A. I RTE.	SECTION		COUNTY	TOTAL SHEETS	SHEET NO.
	57	(28-2)B-2; (28-1)B-2		*	598	52
				CONTRACT	NO. 788	34
IS STA. TO STA.		ILLINOIS	FED. AI	PROJECT		

				P	ATCHING									P <i>A</i>	ATCHING				
			CLASS B	PATCHES	1								CLASS B	PATCHES					
LOCA	TION	TYPE I, 10 INCH	TYPE II, 10 INCH	TYPE III, 10 INCH	TYPE IV, 10 INCH	DOWEL BARS 1 1/2"	TIE BARS 3/4"	WELDED WIRE REINFORCEMENT	SAW CUTS	LOCA	Γ I ON	TYPE I, 10 INCH	TYPE II, 10 INCH	TYPE III, 10 INCH	TYPE IV, 10 INCH	DOWEL BARS 1 1/2"	TIE BARS 3/4"	WELDED WIRE REINFORCEMENT	SAW CUTS
WIDTH	LENGTH	SQ YD	SQ YD	SQ YD	SQ YD	EACH	EACH	SQ YD	FOOT	LENGTH	WIDTH	SQ YD	SQ YD	SQ YD	SQ YD	EACH	EACH	SQ YD	FOOT
6.0	REST AREA 6.0	4.0				8			30.0	11.0 11.0	6.0		7.3			18 18			45.0
7.0	6.0	4.7				10			33.0	11.0	6.0		7.3			18			45.0
11.0 11.0	4.0	4.9				18 18			41.0	11.0 11.0	6.0		7.3			18			45.0
16.0	6.0	4.9	10.7			28			60.0	11.0	6.0		7.3			18			45.0
16.0	6.0		10.7			28			60.0	11.0	6.0		7.3			18			45.0
16.0	6.0		10.7			28			60.0	11.0	6.0		7.3			18			45.0
16.0 16.0	6.0 6.0		10.7			28 28			60.0 60.0	11.0 11.0	6.0		7.3			18 18			45.0
16.0	6.0		10.7			28			60.0	11.0	6.0		7.3			18			45.0
16.0	6.0		10.7			28			60.0	11.0	6.0		7.3			18			45.0
11.0 11.0	6.0 6.0		7.3			18 18			45.0	11.0 11.0	12.0		14.7			18 18			57.0
11.0	6.0		7.3			18			45.0	11.0	12.0		14.7			18			57.0
11.0	11.0		13.4			18			55.0	11.0	12.0		14.7			18			57.0
11.0	6.0		7.3			18			45.0	11.0	6.0		7.3			18			45.0
11.0 11.0	6.0 6.0	+	7.3			18 18			45.0	11.0 11.0	6.0		7.3			18 18			45.0
11.0	6.0	1	7.3			18			45.0	11.0	6.0		7.3			18			45.0
11.0	6.0		7.3			18			45.0	14.0	8.0		12.4			24			58.0
11.0 11.0	6.0 6.0		7.3			18 18			45.0	14.0 16.0	8.0		12.4 10.7			24 28			58.0 60.0
11.0	6.0	1	7.3			18			45.0	16.0	6.0		10.7			28			60.0
11.0	6.0		7.3			18			45.0	16.0	6.0		10.7			28			60.0
11.0	6.0		7.3			18			45.0	16.0	6.0		10.7			28			60.0
11.0 11.0	6.0 6.0		7.3			18 18			45.0	16.0 16.0	6.0		10.7			28 28			60.0 60.0
11.0	6.0		7.3			18			45.0	16.0	6.0		10.7			28			60.0
11.0	6.0		7.3			18			45.0	16.0	6.0		10.7			28			60.0
11.0	6.0		7.3			18			45.0	16.0	6.0		10.7			28			60.0
11.0 11.0	6.0 6.0		7.3			18 18			45.0 45.0	16.0 16.0	6.0 6.0		10.7			28 28			60.0 60.0
11.0	6.0		7.3			18			45.0	16.0	6.0		10.7			28			60.0
11.0	6.0		7.3			18			45.0	16.0	6.0		10.7			28			60.0
8.0	13.0		11.6 5.0			12			50.0 34.5	16.0 16.0	6.0		10.7 10.7			28 28			60.0 60.0
11.0	10.0		12.2			18			53.0	16.0	6.0		10.7			28			60.0
6.0	8.0		5.3			8			34.0	16.0	6.0		10.7			28			60.0
16.0	6.0		10.7			28			60.0	16.0	6.0		10.7			28			60.0
11.0 11.0	6.0 6.0		7.3			18 18			45.0	<u>11.0</u> 9.0	6.0		7.3			18 14			45.0
11.0	6.0		7.3			18			45.0	9.0	6.0		6.0			14			39.0
11.0	6.0		7.3			18			45.0	11.0	6.0		7.3			18			45.0
11.0	6.0 6.0		7.3			18 18			45.0	<u>11.0</u> 14.0	6.0		7.3			18 24			45.0
11.0 11.0	6.0		7.3			18			45.0	19.0	6.0		9.3 12.7			34			69.0
11.0	6.0		7.3			18			45.0	17.0	6.0		11.3			30			63.0
11.0	6.0		7.3			18			45.0	17.0	6.0		11.3			30			63.0
11.0 11.0	6.0 6.0	+	7.3			18 18			45.0	17.0	6.0		11.3 8.0			30 20			63.0 48.0
11.0	6.0		7.3			18			45.0	15.0	6.0		10.0			26			57.0
11.0	6.0		7.3			18			45.0	11.0	6.0		7.3			18			45.0
11.0 11.0	12.0		14.7 12.2			18 18			57.0	<u>11.0</u> 19.0	6.0		7.3			18 34			45.0
11.0	6.0		7.3			18			45.0	19.0	6.0		12.7			28			60.0
11.0	6.0		7.3			18			45.0	16.0	6.0		10.7			28			60.0
20.0	6.0		13.3			36			72.0	17.0	6.0		11.3	10.0		30		10.0	63.0
16.0 16.0	6.0 6.0		10.7	+		28 28			60.0 60.0	8.0	22.0			19.6 20.8		12	11	19.6 20.8	68.0 67.0
16.0	6.0		10.7			28			60.0	11.0	20.0			24.4		18		24.4	73.0
16.0	6.0		10.7			28			60.0	11.0	20.0			24.4		18		24.4	73.0
16.0	6.0		10.7			28			60.0	32.0	6.0			21.3	04.2	60	77	21.3	108.0
16.0 11.0	6.0 11.0	-	10.7 13.4			28 18			60.0 55.0	16.0 16.0	53.0 25.0				94.2	28 28	27	94.2	154.0 98.0
11.0	6.0		7.3			18			45.0	16.0	25.0				44.4	28	13	44.4	98.0
11.0	6.0		7.3			18			45.0	25.0	56.0				155.6	46	28	155.6	187.0
11.0	6.0		7.3			18			45.0	11.0	33.0				40.3	18	17	40.3	99.0
11.0 11.0	6.0 6.0		7.3			18 18			45.0	18.0	14.0	I	1		28.0	32		28.0	82.0
11.0	6.0		7.3			18			45.0	P	ROJECT TOTAL	. 19	1,149	111	407	3,081	109	518	7,742
11.0	6.0		7.3			18			45.0										
11.0 11.0	6.0 6.0		7.3			18 18			45.0	NOTE: ACTUAL	NEED FOR AD	DITIONAL PAT	CHING AT LOCA	TIONS NOT LI	STED IN SCH	EDULE WILL BE	DETERMINED	IN FIELD AT TIME O BE DELETED FROM T)F
	0.0	1	C.1	1	1	10		I		CONSTRUCTION	BY THE ENGI	NEER. ANY QU	ANTITY NOT N	EEDED FOR PAT	CHING AT TI	ME OF CONSTRU	CTION SHALL	BE DELETED FROM T	HE CONTRACT
				DEGIOUSE							r						E A 1	1	TOT
		NAME = jahaas		DESIGNED -		REVISED -		1						SCHEDUL	F		F.A. I RTE.	SECTION	COUNTY TOT

STATE OF ILLINOIS DEPARTMENT OF TRANSPORTATION DRAWN REVISED - \leftarrow PLOT SCALE = 0.16666633 '/ in. CHECKED -REVISED -SCALE: NTS _____SHEET 22 OF 37 SHEET PLOT DATE = 10/15/2024 DATE -REVISED -

UL	E		RTE.	320	ION		COON		SHEETS	NO.	
			57	(28-2)B-2;	(28-1)B-2	2	*		598	53	
							CONTF	RACT	NO. 788	34	1
ETS	STA.	TO STA.			ILLINOIS	FED, All	D PROJECT				
							*	FRAM	IKLIN/JEF	FERSON	ī.

			RUI	MBLE	STRIPS		
		LO	CATION			CENTER LINE RUMBLE STRIP - 8 INCH	SHOULDER RUMBLE STRIPS, 1 INCH
STATION		ТО	STATION		SIDE	FOOT	FOOT
RANKLIN COU	NTY						
			THBOUND				
9+78.11		TO	50+00.00	BK	INSIDE	4,021.2	4,021.2
9+78.11 49+99.31	АН	<u>то</u> то	50+00.00 101+64.25	BK	OUTSIDE	4,021.2 5,164.9	4,021.2 5,165.0
49+99.31	AH	<u>то</u>	101+64.25		INSIDE OUTSIDE	5,164.9	5,165.0
49499.51			SION (GUN CRE	EK)	OUTSIDE	5,104.5	5,105.0
103+75.75		TO	176+14.31	BK	INSIDE	7,224.1	7,230.2
103+75.75		ТО	176+14.31	BK	OUTSIDE	7,218.7	.,
103+75.75		ТО	104+74.75		OUTSIDE	. ,	99.0
111+72.03		TO	130+97.73		OUTSIDE		1,920.9
142+18.23		TO	157+16.68		OUTSIDE		1,491 4
163+61.01		TO	176+14.31		OUTSIDE		1,247.4
176+15.00	AH	ТО	200+00.00	ΒK	INSIDE	2,385.0	2,385.0
176+15.00	AH	TO	200+00.00	ΒK	OUTSIDE	2,385.0	
176+15.00	AH	то	186+99.16		OUTSIDE		1,084.2
196+31.00		то	200+00.00	BK	OUTSIDE		369.0
200+00.70	AH	то	242+97.43	BK	INSIDE	4,310.0	4,304.4
200+00.70	AH	то	242+97.43	ΒK	OUTSIDE	4,314.9	4,320.5
243+00.98	AH	TO	303+47.76		INSIDE		6,046.8
243+00.98	AH	TO	303+68.49		OUTSIDE	6 051 0	6,067.5
243+00.98 243+00.98	AH	TO	303+54.94 303+61.45		INSIDE OUTSIDE	6,054.0	
			DN (MARCUM BF			0,000.5	
305+21.91		TO	307+00.00	ANCI	INSIDE		178.1
305+28.96		то	307+46.00		INSIDE	217.0	1/0.1
305+35.34		TO	307+46.00		OUTSIDE	210.7	
305+42.64		TO	307+46.00		OUTSIDE		203.4
		NOR	THBOUND				
9+78.11		TO	50+00.00	ΒK	INSIDE	4,021.2	4,021.2
9+78.11		TO	50+00.00	ΒK	OUTSIDE	4,021.2	4,021.2
49+99.31	AH	то	101+64.25		INSIDE	5,164.9	5,165.0
49+99.31	AH	TO	101+64.25		OUTSIDE	5,164.9	5,165.0
102.75.75	BRI		SION (GUN CRE		INCLOS	7 252 0	7 246 0
103+75.75		то то	176+14.31	BK		7,253.0	7,246.9
103+75.75 103+75.75		то	176+14.31 155+49.42	BK	OUTSIDE OUTSIDE	7,258.4	5,189.9
165+86.20		то	176+14.31	ВК	OUTSIDE		1,032.9
176+15.00	АН	то	200+00.00	BK	INSIDE	2,385.0	2,385.0
176+15.00	AH	то	200+00.00	BK	OUTSIDE	2,385.0	2,303.0
176+15.00	AH	TO	188+28.39		OUTSIDE	,	1,213.4
194+79.69		TO	200+00.00	ВK	OUTSIDE		520.3
200+00.70	AH	TO	242+97.43	ΒK	INSIDE	4,283.5	4,289.1
200+00.70	AH	то	242+97.43	ΒK	OUTSIDE	4,278.6	4,273.0
243+00.98	AH	то	303+28.09		INSIDE		6,027.1
243+00.98	AH	ТО	303+07.36		OUTSIDE		6,006.4
243+00.98	AH		303+20.92		INSIDE	6,019.9	
243+00.98	AH		303+14.66		OUTSIDE	6,013.7	
	RIDG		ON (MARCUM BE	RANCH			
304+81.51		TO	307+19.00		OUTSIDE	222.5	237.5
304+88.55		TO	307+19.00		OUTSIDE	230.5	
204:01 02		то	307+19.00		INSIDE	224.1	
304+94.93 305+02.24		то	307+00.00		INSIDE		197.8

			RU	MBLE	STRIPS		
		LOC	CATION			CENTER LINE RUMBLE STRIP - 8 INCH	SHOULDER RUMBLE STRIPS, 16 INCH
STATION		ТО	STAT I ON		SIDE	FOOT	FOOT
JEFFERSON CO	UNTY	,					
		SOU	THBOUND				
11+21.89		то	62+64.51	ΒK	INSIDE	5,139.7	5,140.6
11+21.89		то	62+64.51	ΒK	OUTSIDE	5,138.9	5,137.9
62+65.57	AH	то	226+02.00		INSIDE	16,339.4	16,338.2
62+65.57	AH	TO	226+02.00		OUTSIDE	16,340.5	
62+65.57	AH	TO	98+69.59		OUTSIDE		3,604.0
109+07.60		то	125+94.33		OUTSIDE		1,695.1
132+35.02		TO	226+02.00		OUTSIDE		9,357.4
			THBOUND				
11+21.89		то	62+64.51	ΒK	INSIDE	5,144.1	5,143.2
11+21.89		то	62+64.51	ΒK	OUTSIDE	5,144.9	5,145.9
62+65.57	AH	TO	226+02.00		INSIDE	16,333.6	16,334.8
62+65.57	AH	то	226+02.00		OUTSIDE	16,332.5	
62+65.57	AH		101+24.09		OUTSIDE		3,858.5
108+18.11		то	125+58.55		OUTSIDE		1,732.4
136+47.72		ТО	226+02.00		OUTSIDE		8,968.1
			JEFFER	SON	COUNTY TOTAL	85,914	82,457
				F	ROJECT TOTAL	203,370	194,769

			SOUTH	BOUND RES	T AREA MISC	ELLANEOUS	
LOCATION	SIDEWALK REMOVAL	PORTLAND CEMENT CONCRETE SIDEWALK 5 INCH	RELOCATE	REMOVE AND RELOCATE SIGN (SPECIAL)	BRICK WALL REMOVAL	VALVE BOXES TO BE AD JUSTED	
	SQ FT	SQ FT	EACH	EACH	LF	EACH	
SOUTH BOUND REST AREA							
	3440.2	5051.2	1		128.9	1	
					87.7		Τ
				1			Γ
PROJECT TOTAL	3441	5052	1	1	217	1	

NOTE: PARK BENCH PLACEMENT WILL BE DETERMINED IN FIELD AT TIME OF CONSTRUCTION BY THE ENGINEER.

	USER NAME = jahaas	DESIGNED -	REVISED -				SCF	IEDULE		F.A. I BTE	SECTION	COUNTY	TOTAL S	SHEET
		DRAWN -	REVISED -	STATE OF ILLINOIS						57	(28-2)B-2; (28-1)B-2	*	598	54
	PLOT SCALE = 0.16666633 ' / in.	CHECKED -	REVISED -	DEPARTMENT OF TRANSPORTATION								CONTRAC	CT NO. 78884	+
E WWW. HORNERSHIFRIN .COM	PLOT DATE = 10/15/2024	DATE -	REVISED -		SCALE: NTS	SHEET 23	OF 37	SHEETS STA.	TO STA.		ILLINOIS FED. A	AID PROJECT		

PARK BENCHES

EACH

6

6

REMARKS

SIGN & BASE "BLUE STAR MEMORIAL HIGHWAY"

* FRANKLIN/JEFFERSON

RC	DENT SHIELDS	1
LOCAT	ION	RODENT SHIELDS
STATION	SIDE	EACH
FRANKLIN COUNTY		
SOUTHBOUND -OUTS	SIDE SHOULDER	
16+89.00		1
21+98		1
26+80		1
31+97		1
36+75		1
42+13		1
125+25		1
132+66		1
137+48		1
165+94		1
205+20		1
210+25 290+20		1
290+20		1
NORTHBOUND - OUT	SIDE SHOULDER	
16+87		1
22+08		1
26+76		1
32+05		1
36+86		1
42+04		1
47+03		1
57+03		1
61+95		1
107+50		1
113+51		1
122+50		1
127+49		1
132+51		1
137+49		1
147+50		1
172+15		1
209+83		1
219+55		1
237+48		1
258+34 263+11		1
268+27		1
288+25		1
200120		-
REST AREA -	RAMP B	
129+65.00	LT SHLDR	1
· · · · · ·		
IL 154 INTERCHA	NGE - RAMP A	
171+29.00	LT SHLDR	1
173+73.00	LT SHLDR	1
176+01.00	LT SHLDR	1
	NCE DAMD D	
IL 154 INTERCHA		1
<u>177+47.00</u> 179+98.00	LT SHLDR LT SHLDR	1
1/9+96.00	LI SHLUK	1
IL 154 INTERCHAI	NGE - RAMP C	
177+29.00		1
		-
	KLIN COUNTY TOTAL	45

	RODENT SHIELDS	1
LOCA	AT I ON	RODENT SHIELDS
STATION	SIDE	EACH
JEFFERSON COUNTY		
	UTSIDE SHOULDER	
21+19		1
25+50 29+80		1
34+08		1
38+38		1
47+76		1
52+71		1
57+72		1
62+70		1
67+68 72+71		1
77+74		1 1
82+72		1
87+70		1
92+72		1
96+28		1
100+27		1
110+35		1
130+51 139+01		1
143+52		1
152+48		1
156+66		1
172+96		1
176+99		1
182+03		1
192+04		1
196+99		1
202+03		1
NORTHBOUND - O	UTSIDE SHOULDER	
21+19		1
25+50		1
29+79		1
34+08		1
38+37		1
47+74		1
52+70 57+70		1
62+69		1
67+70		1
72+70		1
77+72		1
82+70		1
87+70		1
92+71 96+27		1
100+24		1
124+20		1
129+50		1
143+51		1
152+54		1
156+69		1
160+85		1
168+83 173+30		1 1
173+30		1
181+96		1
191+91		1
197+06		1
202+01		1
212+04		1
216+43		1
220+88 225+35		1
223733	1	I I

ODENT SHIELDS	
ODENT SHIELDS	
TION	RODENT SHIELDS
SIDE	EACH
NGE – RAMP A	
LT SHOULDER	1
LT SHOULDER	1
NGE - RAMP B	
LT SHOULDER	1
LT SHOULDER	1
NGE - RAMP C	
LT SHOULDER	1
RT SHOULDER	1
LT SHOULDER	1
NGE - RAMP D	
LT SHOULDER	1
ERSON COUNTY TOTAL	71
PROJECT TOTAL	116
	SIDE NGE - RAMP A LT SHOULDER LT SHOULDER NGE - RAMP B LT SHOULDER LT SHOULDER NGE - RAMP C LT SHOULDER RT SHOULDER LT SHOULDER NGE - RAMP D LT SHOULDER ERSON COUNTY TOTAL

		UNDERCUT		
	LOCATIO	N	EARTH EXCAVATION (UNSUITABLE MATERIAL)	ROCK FILL
STATION	ТО	STATION	CU YD	TON
RANKLIN COUNTY	/			
	SOUTHBOUN	D		
9+78.11	TO	12+40.00	522.3	1,070.8
99+40.00	TO	101+64.25	448.5	919.4
103+78.75	TO	106+00.00	473.6	971.0
175+15.00	TO	176+14.31 BK	457.2	937.2
176+15.00 AH		178+45.00	600.0	1,230.0
227+90.00	то	230+50.00	1,117.3	2,290.5
281+40.00	то	285+50.00	1,040.0	2,132.0
301+40.00	ТО	303+37.92	436.5	894.9
305+12.07	TO	307+46.00	397.1	814.0
	NORTHBOUN	D		
9+78.11	ТО	11+60.00	522.3	1,070.8
99+40.00	то	101+64.25	448.5	919.4
103+78.75	то	106+00.00	448.5	919.4
175+15.00	то	176+14.31 BK	460.0	943.1
176+15.00 AH	і то	178+45.00	600.0	1,230.0
227+90.00	TO	230+50.00	1,102.7	2,260.5
281+40.00	TO	285+50.00	1,040.0	2,132.0
300+75.00	TO	303+37.92	485.7	995.7
305+12.07	TO	307+19.00	441.9	905.8
	FRANK	LIN COUNTY TOTAL	11,043	22,637
EFFERSON COUN	ΓY			
	SOUTHBOUN	D		
11+21.89	ТО	13+05.00	894.8	1,834.3
113+80.00	TO	120+20.00	1,283.4	2,631.0
	NORTHROUM	D		1 0 2 4 2
11.21.90	NORTHBOUN	13+05.00	001 0	1,834.3
11+21.89 113+80.00	TO	120+20.00	894.8 1,276.6	2,617.0
		1	1,2,0.0	2,017.0
	JEFFEF	SON COUNTY TOTAL	4,350	8,917
		PROJECT TOTAL	15.393	31,554

		UNDERCUT		
L	ος ατιον	١	EARTH EXCAVATION (UNSUITABLE MATERIAL)	ROCK FILL
	ТО	STATION	CU YD	TON
VTY .				
SC	DUTHBOUN	D		
	TO	12+40.00	522.3	1,070.8
	TO	101+64.25	448.5	919.4
	TO	106+00.00	473.6	971.0
	TO	176+14.31 BK	457.2	937.2
AH	TO	178+45.00	600.0	1,230.0
	ΤO	230+50.00	1,117.3	2,290.5
	то	285+50.00	1,040.0	2,132.0
	TO	303+37.92	436.5	894.9
	TO	307+46.00	397.1	814.0
NC	ORTHBOUN	-		
	TO	11+60.00	522.3	1,070.8
	TO	101+64.25	448.5	919.4
	TO	106+00.00	448.5	919.4
	то	176+14.31 BK	460.0	943.1
AH	то	178+45.00	600.0	1,230.0
	TO	230+50.00	1,102.7	2,260.5
	TO	285+50.00	1,040.0	2,132.0
	TO	303+37.92	485.7	995.7
	TO	307+19.00	441.9	905.8
	FRANK	LIN COUNTY TOTAL	11,043	22,637
ЛИТА				
SC	OUTHBOUN	D		
	TO	13+05.00	894.8	1,834.3
	то	120+20.00	1,283.4	2,631.0
			.,	2,002.0
NC		D		1,834.3
	ТО	13+05.00	894.8	
	TO	120+20.00	1,276.6	2,617.0
	JEFFER	SON COUNTY TOTAL	4,350	8,917
		PROJECT TOTAL	15,393	31,554

			UNDERC	UT		
		LOCATIO	EARTH EXCAVATION (UNSUITABLE MATERIAL)	ROCK FILL		
STATION		то	STATION		CU YD	TON
RANKLIN COUN	JΤΥ					
	5	SOUTHBOUN	ID			
9+78.11		TO	12+40.00		522.3	1,070.8
99+40.00		то	101+64.25		448.5	919.4
103+78.75		то	106+00.00		473.6	971.0
175+15.00		TO	176+14.31	ΒK	457.2	937.2
176+15.00	AH	то	178+45.00		600.0	1,230.0
227+90.00		то	230+50.00		1,117.3	2,290.5
281+40.00		то	285+50.00		1,040.0	2,132.0
301+40.00		то	303+37.92		436.5	894.9
305+12.07		TO	307+46.00		397.1	814.0
	1	ORTHBOUN	D			
9+78.11		ТО	11+60.00		522.3	1,070.8
99+40.00		то	101+64.25		448.5	919.4
103+78.75		то	106+00.00		448.5	919.4
175+15.00		то	176+14.31	ΒК	460.0	943.1
176+15.00	AH	то	178+45.00		600.0	1,230.0
227+90.00		то	230+50.00		1,102.7	2,260.5
281+40.00		ТО	285+50.00		1,040.0	2,132.0
300+75.00		то	303+37.92		485.7	995.7
305+12.07		ТО	307+19.00		441.9	905.8
		FRAN	LIN COUNTY T	OTAL	11,043	22,637
EFFERSON COL	JNTY	/				
			-			
11.21.00			-		001.0	1.024.2
11+21.89		TO	13+05.00		894.8	1,834.3
113+80.00		TO	120+20.00		1,283.4	2,631.0
	r	ORTHBOUN	D			1,834.3
11+21.89		ТО	13+05.00		894.8	
113+80.00		TO	120+20.00		1,276.6	2,617.0
		JEFFEF	SON COUNTY T	OTAL	4,350	8,917
			PROJECT T	OTAL	15,393	31,554

	USER NAME = jahaas	DESIGNED -	REVISED -				SCHEDULE		F.A. I RTE	SECTION	COUNTY	TOTAL	HEET
		DRAWN -	REVISED -	STATE OF ILLINOIS DEPARTMENT OF TRANSPORTATION SCALE: NTS			CONEDOLL		57	(28-2)B-2; (28-1)B-2	*	598	55
	PLOT SCALE = 0.16666633 '/ in.	CHECKED -	REVISED -								CONTRAC		4
	PLOT DATE = 10/15/2024	DATE -	REVISED -		SCALE: NTS	SHEET 24	OF 37 SHEETS STA.	TO STA.		ILLINOIS FED. AI	ID PROJECT		

			DRAINAGE		DRAINAGE STR						
LOC	ATION	DRAINAGE STRUCTURES, TYPE 5 WITH TWO TYPE 22 FRAME AND GRATE	STRUCTURES,	REINFORCED CONCRETE FLARED END	CONCRETE	CONCRETE FLARED END SECTIONS 30"	CONCRETE FLARED END		CLOSED LID	MANHOLES, TYPE A, 8'- DIAMETER, TYPE 1 FRAME, CLOSED LID	INLET AND PIPE PROTECTION
STATION JEFFERSON COUNTY	LOCATION	EACH	EACH	EACH	EACH	EACH	EACH	EACH	EACH	EACH	EACH
12+11.45	CL	1									1
17+00.00	CL	1									1
20+10.00	CL	1									1
21+04.37 22+00.00	CL	1									<u> </u>
26+26.00	CL	1									1
30+68.00	CL	1									1
35+00.00 39+00.00	CL CL	1									1
47+00.00	CL	1									1
50+70.00 53+65.00	CL	1	1	1							1
57+76.00	CL	1									1
62+00.00	CL	1									1
66+00.00 70+12.00	CL CL	1				1					1
73+00.00	CL	1									1
76+20.00	CL	1		_							1
78+56 00 81+98.00	CI CL	1				<u> </u>					1 1
85+00.00	CL	1									1
88+00.00 92+40.00	CL	1	1								1 1
96+55.00	CL	1									1
97+60.00	CL	1									1
98+45.00 103+40.00	CL	1									1
108+35.00	CL	1									1
113+36.00	CL	1	1								1
117+30.00 120+00.00	CL		1								1
123+27.00	CL	1			1						1
123+40.25 126+37.00	CL CL	1									1 1
129+35.00	CL	1									1
130+89.00	CL	1		1							1
133+00.00 137+34.00	CL	1		1							1 1
141+36.00	CL	1									1
145+36.00 149+75.00	CL	1		1							1
151+00.00	CL	1		•				· · · · · · · · · · · · · · · · · · ·			1
154+70.00	CL	1									1
158+30.00 158+43.90	CL	1		1						1	1
161+00.00	CL	1									1
164+04.37 165+00.00	CL	1									1
165+95 63	CL	1									1
168+75.00	CL	1									1
173+00.00 177+00.00	CL CL	1						<u> </u>			1 1
181+00.00	CL	1									1
184+90.00 191+60.00	CL	1	1								1
196+10.00	CL		1	1							1
200+00.00	CL	1									1
203+40.00 207+00.00	CL	1									1
208+05.00	CL	1									1
209+00.00	CL	1									1
209+94.00 212+00.00	CL	1									1
216+00.00	CL	1									1
220+00.00	CL	1		1							1
224+00.00	CL	1				<u> </u>		<u> </u>		<u> </u>	1
JEFFE	ERSON COUNTY TOTA	AL 59	6	7	1	1	0	0	0	1	65
DESIGNED -		REVISED -			отате ое •				:	SCHEDULE	
DRAWN -	DRAWN - REVISED -			STATE OF ILLINOIS DEPARTMENT OF TRANSPORTATION							
CHECKED -		REVISED -		DFPART	IMENT OF TH	RANSPORTAT	ION I				

					DRAINAGE STR	UCTURES					
	LOCATION	DRAINAGE STRUCTURES, TYPE 5 WITH TWO TYPE 22 FRAME AND GRATE	DRAINAGE STRUCTURES, TYPE 5 WITH TWO TYPE 22 FRAME AND GRATE (SPECIAL)	PRECAST REINFORCED CONCRETE FLARED END SECTIONS 24"	PRECAST REINFORCED CONCRETE FLARED END SECTIONS 27"	PRECAST REINFORCED CONCRETE FLARED END SECTIONS 30"	PRECAST REINFORCED CONCRETE FLARED END SECTIONS 42"	MANHOLES, TYPE A, 4'- DIAMETER, TYPE 1 FRAME, CLOSED LID	MANHOLES, TYPE A, 6'- DIAMETER, TYPE 1 FRAME, CLOSED LID	MANHOLES, TYPE A, 8'- DIAMETER, TYPE 1 FRAME, CLOSED LID	INLET AND PIP PROTECTION
STATION	LOCATION	EACH	EACH	EACH	EACH	EACH	EACH	EACH	EACH	EACH	EACH
FRANKLIN COUN								<u> </u>			
10+07.00		1									1
10+71.25		1									1
15+50.00	CL		1							_	1
20+26.00		1									1
25+01.00 30+00.00		1									1
34+90.00		1		1	-						1
39+00.00		1									1
44+00.00		1		1							1
45+00.00		1						+			1
48+00.00 51+35.25		1									1
52+00.00		1									1
56+00.00	CL	1								-	1
60+00.00		1									1
64+00.00 68+00.00		1		1							1
72+00.00		1					<u></u>				1
76+00.00		1		1							1
80+00.00		1									1
84+00.00 85+98.00		1									1
88+00.00		1						-			1
92+00.00		1									1
96+00.00		1									1
100+00.00		1									1
108+44.50		1									1
110+00.00		1				1				_	1
114+00.00		1									1
118+00.00		1									1
126+00.00		1			-			-			1
130+00.00	CL	1						-			1
131+10.00		1									1
134+00.00		1									1
142+00.00		1									1
146+00.00		1				1					1
150+00.00		1									1
154+00.00		1			1			-			1
161+00.00		1			· · ·			·			1
164+66.00		1		1							1
165+54.63		4							1		4
169+60.00 174+60.00		1						+		L	1
177+50.00	CL		1							=	1
182+00.00		1									1
186+24.00 191+00.00		1	1		1						1
191+00.00		1									1
199+20.00		1									1
203+00.00		1									1
206+70.00			1	1							1
211+48.00 215+49.21								1	1		
216+48.00		1						-	, , , , , , , , , , , , , , , , , , ,	L	1
218+86.00	CL	1									1
221+25.00		1									1
222+21.00 223+16.00		1						-			1
223+16.00		1					1	-			1
229+16.00		· ·	1								1
229+80.00		1									1
234+68.00		1	 					.			1
	SIGNED -	REVISED -			STATE OF				S	CHEDULE	
				DEPA		TRANSPORTA					
rin. CH											

					DRAINAGE STR	UCTURES					
LOCA	TION	DRAINAGE STRUCTURES, TYPE 5 WITH TWO TYPE 22 FRAME AND GRATE	DRAINAGE STRUCTURES, TYPE 5 WITH TWO TYPE 22 FRAME AND GRATE (SPECIAL)	PRECAST REINFORCED CONCRETE FLARED END SECTIONS 24"	PRECAST REINFORCED CONCRETE FLARED END SECTIONS 27"	PRECAST REINFORCED CONCRETE FLARED END SECTIONS 30"	PRECAST REINFORCED CONCRETE FLARED END SECTIONS 42"	MANHOLES, TYPE A, 4'- DIAMETER, TYPE 1 FRAME, CLOSED LID	MANHOLES, TYPE A, 6'- DIAMETER, TYPE 1 FRAME, CLOSED LID	MANHOLES, TYPE A, 8'- DIAMETER, TYPE 1 FRAME, CLOSED LID	INLET AND PIPE PROTECTION
STATION	LOCATION	EACH	EACH	EACII	EACII	EACH	EACH	EACII	EACII	EACH	EACH
FRANKLIN COUNTY					-						
239+50.00	CL	1			-			1			1
244+45.00	CL	1			1						1
249+00.00	CL		1								1
258+00.00	CL		1		-						1
263+00.00	CL		1		1						1
268+00.00	CL	1									1
272+72.78	CL	1									1
275+01.77	CL	1						1			1
278+00.00	CL	1									1
280+50.00	CL	1		1							1
284+00.00	CL	1									1
288+00.00	CL	1									1
292+16.85	CL	1									1
296+41.80	CL	1			-						1
299+00.00	CL	1									1
301+80.00	CL		1								1
303+50.00	CL		1								1
305+15.00	CL		1								1
306+00.00	CL		1								1
306+76.00	CL		1								1
FRA	NKLIN COUNTY TOTAL	70	13	7	4	2	1	1	2	0	83
	PROJECT TOTAL	129	19	14	5	3	1	1	2	1	148

	USER NAME = hjones	DESIGNED -	REVISED -			SCHEDULE	F.A. I RTE	SECTION	COUNTY TOTAL SHEET
		DRAWN -	REVISED -	STATE OF ILLINOIS		001122022	57	(28-2)B-2; (28-1)B-2	598 58
USAN CROUP, LL	PLOT SCALE = 0.08333317 ' / in.	CHECKED -	REVISED -	DEPARTMENT OF TRANSPORTATION					CONTRACT NO. 78884
~	PLOT DATE = 9/26/2024	DATE -	REVISED -		SCALE: NTS	SHEET 27 OF 37 SHEETS STA TO STA		ILLINOIS FED. AI	D PROJECT

							STOR	M SEWER							
L	DCATION		STORM SEWERS, CLASS A, TYPE 1, 24"	STORM SEWER CLASS A, TYPE 27"	S, STORM SEWERS, 1, CLASS A, TYPE 2, 24"	STORM SEWERS, CLASS A, TYPE 2, 27"	STORM SEWERS, CLASS A, TYPE 2, 30"	STORM SEWERS, CLASS A, TYPE 2, 36"	STORM SEWERS, CLASS A, TYPE 2, 42"	STORM SEWERS JACKED IN PLACE, 24"	STORM SEWERS JACKED IN PLACE, 27"	STORM SEWERS JACKED IN PLACE, 30"	STORM SEWERS JACKED IN PLACE, 42"	CONCRETE COLLAR	POROUS GRANULAR BACKFILL
STATION TO	STATION	SIDE	FOOT	FOOT	FOOT	FOOT	FOOT	FOOT	FOOT	FOOT	FOOT	FOOT	FOOT	CU YD	CU YD
FFERSON COUNTY	20+07.50				205								F		
17+02.50 TO 20+12.50 TO	20+07.50	CL			<u>305</u> 89										47
21+06.87 TO	21+80.90	CL			74				-						45
21+88.15 TO 22+02.50 TO	21+97.50 26+23.50	CL						9 421							7 274
26+28.50 TO	30+65.50	CL					437	721							233
30+70.50 TO	34+97.50	CL				427									182
35+02.50 TO 47+02.50 TO	38+97.50 50+67.50	CL			<u> </u>										114 100
50+70.00		LT								95					
50+90.36 TO	53+62.50	CL			272										68
57+78.50 TO 62+02.50 TO	61+97.50 65+97.50	CL			419 395										124 148
66+02.50 TO	70+09.50	CL				407									210
70+12.00 73+02.50 TO	76+17.50	LT CL			315							94	<u> </u>		139
76+22.50 TO	76+30.09	CL			8								<u>† </u>		5
76+40.45 TO	78+53.50	CL			213								L		97
81+98.00 82+00.50 TO	84+97.50	LT CL			5 297								├	0.4	2 92
85+02.50 TO	87+97.50	CL	295												48
92+42.50 TO	96+52.50	CL			410	84									130
96+57.50 TO 97+49.20 TO	<u>97+41.15</u> 97+57.50	CL				84		8							38
97+62.50 TO	98+42.50	CL						80							68
98+47.50 TO	103+37.50	CL				400	490								359 268
103+42.50TO108+37.50TO	108+32.50 113+27.50	CL			490	490									160
117+32.50 TO	119+97.50	CL	265												36
120+02.50 TO 123+27.00	123+24.50	LT CL		322							86				112
123+27.00 123+42.75 TO	126+34.50	CL			292						80				111
129+37.50 TO	130+86.50	CL			149										43
133+00.00 133+02.50 TO	137+31.50	CL			429					94					133
141+38.50 TO	145+33.50	CL			395										102
145+36.00 149+75.00		LT								92					
149+77.50 TO	150+97.50	CL			120					90					34
154+72.50 TO	158+47.90	CL			375										93
158+30.00 158+46.50 TO	160+97.50	LT CL			251					93					81
164+06.87 TO	164+97.50	CL			91								<u> </u> †		24
165+02.50 TO	165+93.13	CL			91										32
165+98.13TO168+77.50TO	168+72.50 168+91.08	CL	<u> </u>	+			274	14					├		167 12
169+08.50 TO	172+97.50	CL			389										194
173+02.50 IO 177+02.50 TO	176+97.50 180+97.50	CL			<u> </u>								├ ──────────		162 106
177+02.50TO191+62.50TO	180+97.50	CL	445		292										106
196+10.00		LT								77			[]		
196+20.48 200+02.50 TO	203+37.50	CL		-	31 335		<u> </u>						├	0.9	0 84
200+02.50 TO	205+37.50	CL			355								<u> </u>		123
208+07.50 TO	208+97.50	CL			90										23
209+02.50 TO 209+96.50 TO	209+91.50 211+97.50	CL CL											<u> </u>		23 65
216+02.50 TO	219+97.50	CL			395										120
220+00.00	200.07.50	LT			205					113			┨──────┤		120
220+02.50 TO	223+97.50	CL			395										136
	JEFFERSON	COUNTY TOTAL	1005	322	9315	1408	1201	532	0	654	86	94	0	1.3	5197
	USER NAME = hjones		DESIGNED -	RE	VISED -				1		SCHEDULE		F.A. I RTE.	SECTION	COUNTY TOTAI SHEET
			DRAWN -	RE	VISED -		STATE OF				SUILDULE		RTE. 57	(28-2)B-2; (28-1)B-2	598
-9088 DESIGN GROUP, L	PLOT SCALE = 0.0833331	7 ' / in.	CHECKED -	RE	VISED -	I DE	PARTMENT OF	TRANSPORTATIO	DINI İ						CONTRACT NO.

								STOR	M SEWER							
	LOC	ATION		STORM SEWERS, CLASS A, TYPE 1, 24"	STORM SEWERS, CLASS A, TYPE 1, 27"	STORM SEWERS, CLASS A, TYPE 2, 24"	STORM SEWERS, CLASS A, TYPE 2, 27"	STORM SEWERS, CLASS A, TYPE 2, 30"	STORM SEWERS, CLASS A, TYPE 2, 36"	STORM SEWERS, CLASS A, TYPE 2, 42"	STORM SEWERS JACKED IN PLACE, 24"	STORM SEWERS JACKED IN PLACE, 27"	STORM SEWERS JACKED IN PLACE, 30"	STORM SEWERS JACKED IN PLACE, 42"	CONCRETE COLLAR	POROUS GRANULAR BACKFILL
STATION	то	STATION	SIDE	FOOT FOOT	FOOT	FOOT	CU YD	CU YD								
FRANKLIN COUNTY																
10+02.50	TO	10+68.75	CL			66		<u> </u>								18
10+73.75	TO	15+47.50	CL			474								<u> </u>		140
20+28.50	ТО	24+98.50	CL			470										117
25+01.00	=0		CL			20									0.9	5
30+02.50	то	34+87.50	CL			435					100					123
34+90.00		10.07.50	LT			405					100					100
39+02.50	TO	43+97.50	CL			495					110					123
44+00.00	10	47107.50	LT			205					110					81
45+02.50 48+02.50	то ТО	47+97.50 51+32.75	CL CL			295		330								139
	то			<u> </u>			59									30
51+37.75 52+02.50	то	51+97.00 55+97.50	CL			395	59									130
60+00.00	10	55+97.50	CL			395								-	0.4	2
64+02.50	то	67+97.50	CL	<u> </u>		395									0.4	119
68+00.00	10	07+97.50	LT			595					102					115
68+02.50	то	71+97.50	CL			395					102					122
76+00.00	10	11.37.50	RT			090					97			-		122
76+02.50	то	79+97.50	CL			395					51					124
84+02.50	то	85+95.50	CL			193										62
86+00.50	то	87+97.50	CL			197										86
88+02.50	TO	91+97.50	CL			395		<u> </u>								120
96+02.50	TO	99+97.50	CL			395										120
106+02.50	то	108+42.00	CL	<u> </u>		240		<u> </u>								86
110+00.00			RT										111			
110+02.50	то	113+97.50	CL			395										119
118+02.50	то	121+97.50	CL			395										120
122+02.50	ТО	125+97.50	CL		1			395								184
126+02.50	то	129+97.50	CL						395							234
130+02.50	то	131+07.50	CL						105							75
131+12.50	то	133+97.50	CL			235										89
138+02.50	TO	141+97.50	CL			395										131
142+02.50	TO	145+97.50	CL				395									232
146+00.00			RT										97			
150+02.50	TO	151+55.39	CL			153										39
151+65.09	то	153+97.50	CL			232										59
158+00.00			RT									102				
158+02.50	TO	160+97.50	CL			295										87
164+66.00			RT								127					
164+68.50	то	169+57.50	CL			439										121

	USER NAME = hjones	DESIGNED -	REVISED -				SCH	EDULI	F
		DRAWN -	REVISED -	STATE OF ILLINOIS			0011		-
	PLOT SCALE = 0.08333317 ' / in.	CHECKED -	REVISED -	DEPARTMENT OF TRANSPORTATION					
DESIGN CHOUP, LLC	PLOT DATE = 9/26/2024	DATE -	REVISED -		SCALE: NTS	SHEET 29	OF 37	SHEETS	, S

E	F.A. I RTE	SECTION		COUNTY	TOTAL SHEETS	SHEET NO.
	57	(28-2)B-2; (28-1)B-2			598	60
				CONTRACT	NO. 78	884
TS STA TO STA		ILLINOIS F	ED. AL	PROJECT		

								STOR	M SEWER							
	LOC	ATION			STORM SEWERS, CLASS A, TYPE 1, 27"							STORM SEWERS JACKED IN PLACE, 27"	STORM SEWERS JACKED IN PLACE, 30"	STORM SEWERS JACKED IN PLACE, 42"	CONCRETE COLLAR	POROUS GRANULAR BACKFILL
STATION	то	STATION	SIDE	FOOT	FOOT	FOOT	FOOT	FOOT	FOOT	FOOT	FOOT	FOOT	FOOT	FOOT	CU YD	CU YD
FRANKLIN COUNTY	,															
169+62.50	то	174+57.50	CL			495										123
177+50.00			LT	11										_	0.4	3
177+52.50	TO	181+97.50	CL	445												78
186+24.00			LT									75		-		
186+26.50	TO	190+97.50	CL	471										_		142
195+02.50	TO	199+17.50	CL			415										199
203+02.50	TO	206+67.50	CL	365												64
206+70.00			RT								77					
211+50.00	TO	215+47.21	CL			397										96
216+50.50	то	218+83.50	CL			233										58
218+88.50	то	221+22.50	CL				234									63
221+27.50	то	222+18.50	CL						91							22
222+23.50	то	223+13.50	CL						90							31
223+18.50	то	226+31.50	CL							313						179
226+34.00			RT											104		
226+36.50	TO	229+13.50	CL			277										79
229+82.50	ТО	234+65.50	CL			483										120
234+70.50	TO	239+47.50	CL			477				<u> </u>						118
244+45.00			RT										87			
244+47.50	TO	248+97.50	CL			450										117
258+02.50	TO	262+97.50	CL	495												72
263+00.00			LT										98			
268+02.50	то	272+70.28	CL			468										116
278+02.50	то	280+47.50	CL			245										61
280+50.00	10	200-11.00	LT								81					
280+61.34			CL			24									0.9	6
280+01.54	то	287+97.50	CL			395									0.0	98
288+02.50	то	292+14.35	CL			412										102
299+02.50	то	301+77.50	CL	275		716										46
301+82.50	то	303+22.50	CL	140												
303+27.50	то	303+60.93	CL	33	+											0
303+27.50	то	305+12.50	CL	22										_		0
305+17.50	то	305+97.50	CL	80				<u> </u>								0
306+02.50	то	306+73.50	CL	71												0
				0.100		40700		705		010		477	000	46.1		
		FRANKLIN CO		2408	0	12723	688	725	681	313	694	177	393	104	2.6	5240
		DD	JECT TOTAL	L 3413	322	22038	2096	1926	1213	313	1348	263	487	104	4.0	10437

Gi2		USER NAME = hjones	DESIGNED -	REVISED -					EDUL	
S ⊒ 23 ¥ SU			DRAWN -	REVISED -	STATE OF ILLINOIS			0011	2002	
	12 CLEVILLE, IL 62220	PLOT SCALE = 0.08333317 ' / in.	CHECKED -	REVISED -	DEPARTMENT OF TRANSPORTATION					
ŇĒ		PLOT DATE = 9/26/2024	DATE -	REVISED -		SCALE: NTS	SHEET 30	OF 37	SHEETS	s s

E	F.A. I RTE	SECT	ION		COUNTY	TOTAL SHEETS	SHEET NO.
	57	(28-2)B-2;	(28-1)B-2	2		598	61
					CONTRACT	NO. 78	884
TO STA TO STA			ILLINOIS	FED. AL	O PROJECT		

					PIPE CUI		RREMOVALS				
	LOC	ATION		STORM SEWER REMOVAL		PIPE CULVERT REMOVAL	CONCRETE HEADWALL REMOVAL	REMOVING INLETS	REMOVE EXISTING FLARED END SECTION	CONTROLLED LOW-STRENGTH MATERIAL	REMOVE EXISTING RIPRAP
	1			18"	24"						
STATION	ТО	STATION	SIDE	FOOT	FOOT	FOOT	EACH	EACH	EACH	CUYD	SQ YD
JEFFERSON COUI											
12+13.21	то	12+25.34	CL		12				_		
12+30.69			CL					1			
21+69.87			CL					1			
21+74.55	то	21+95.68	CL	21							
22+00.43			CL					1			
50+67.61			CL					1			
50+73.54	TO	51+01.25	CL		28						
51+05.64			CL					1			
69+99.16			CL					1	1	10	
81+97.46			LT						1		
97+29.78			CL					1			
97+34.54	то	97+56.25	CL	22				<u> </u>			
97+61.09			CL					1			
115+49.71	то	115+97.68	CL		48						
116+21.76	то	116+40.83	CL		19						
123+29.88	то	123+51.01	CL		21			-			
130+78.40	то	131+01.07	CL		23						
148+89.48	10	101101.01	CL		20						18
149+24.92	то	149+59.54	CL		35						10
149+24.92	10	149+39.34	CL								18
149+70.25	то	158+95.88	CL		110					<u> </u>	10
168+83.23	то	169+15.16	CL		32						
	то										
184+77.08	10	185+03.39	CL		26						
115+37.64			CL					1			
123+24.28			CL					1			
123+56.68			CL					1			
130+73.37			CL					1			
131+06.13			CL					1			
149+19.86			CI					1			
149+64.66			CL					1			
157+74.00			CL					11			
159+07.58			CL					11			
168+78.68			CL					1		<u> </u>	
169+20.04			CL					1			
184+72.00			CL					1			
185+08.18			CL					1			
196+21.27			CL						2		
207+00.52			CL					1			
219+00.00			CL					1		11	
								L			
		JEFFERSON CO	DUNTY TOTAL	43	354	0	0	23	4	22	36

	USER NAME = hjones	DESIGNED -	REVISED -			SCHEDULE	F.A. I RTE	SECTION	COUNTY TOTAL SHEET
		DRAWN -	REVISED -	STATE OF ILLINOIS		00	57	(28-2)B-2; (28-1)B-2	598 62
G = (618) 641-9088 DESIGN CROUP, LI	PLOT SCALE = 0.08333317 ' / in.	CHECKED -	REVISED -	DEPARTMENT OF TRANSPORTATION					CONTRACT NO. 78884
	PLOT DATE = 9/26/2024	DATE -	REVISED -		SCALE: NTS	SHEET 31 OF 37 SHEETS STA TO STA		ILLINOIS FED. A	AID PROJECT

					PIPE CUI	LVERT / STORM SEWE	RREMOVALS				
	LOC	ATION	_	STORM SEWER REMOVAL		PIPE CULVERT REMOVAL	CONCRETE HEADWALL REMOVAL	REMOVING INLETS	REMOVE EXISTING FLARED END SECTION	CONTROLLED LOW-STRENGTH MATERIAL	REMOVE EXISTING RIPRA
				18"	24"						
STATION	TO	STATION	SIDE	FOOT	FOOT	FOOT	EACH	EACH	EACH	CU YD	SQ YD
FRANKLIN COUN	TY							<u> </u>	-		
19+66.63		00.01.00	CL						1		
19+72.55	TO	20+24.82	CL			52			-		
20+30.32			CL LT/RT				0		1		
25+00.00 35+00.00							2			9	
43+00.00			LT LT				2			10	
51+36.13			CL				2	1		10	
60+00.00			LT				1	1			
68+41.90			LT				1			10	
85+98.73			CL					1		10	
100+00.00			CL					1	-		
108+44.69			CL					1			
108+45.16	то	111+08.34	CL		263						
111+16.39			CL					1			
131+10.00			CL					1			
145+50.00			RT				1	1	-	11	
156+50.00			CL					1		11	
166+35.00			RT					1		36	
177+50.00			LT				1				
186+25.51			LT				1				
186+80.98			LT				1				
186+81.00			LT							9	
199+20.72			CL					1			
199+22.29	то	199+29.21	CL		7						
206+00.00			RT							10	
206+13.70			RT				1				
206+72.81			RT				1				
215+38.59			CL					1			
215+40.09	то	215+45.95	CL		6						
226+50.00			CL					1			
229+81.95	то	230+18.26	CL		36						
230+27.87			CL					1			
246+00.00			RT				2			8	<u> </u>
275+01.76		<u> </u>	CL				0	1			
280+61.60 292+16.76			LT/RT CL				2	1			
292+16.76			CL					1			<u> </u>
301+77.63	+		CL		+			1			
301+82.33	то	303+60.43	CL	178							<u> </u>
304+90.91	то	306+67.53	CL	178							
306+72.47		300107.33	CL	111				1			<u> </u>
555172.47		<u> </u>									
		FRANKLIN CO	DUNTY TOTAL	355	312	52	18	18	2	114	0
		PR	DJECT TOTAL	398	666	52	18	41	6	136	36

	USER NAME = hjones	DESIGNED -	REVISED -			SCHEDULE	F.A. I RTF	SECTION	COUNTY TOTAL SHEET
		DRAWN -	REVISED -	STATE OF ILLINOIS			57	(28-2)B-2; (28-1)B-2	598 63
(618) 641-9088 DESIGN GROUP, LL	PLOT SCALE = 0.08333317 ' / in.	CHECKED -	REVISED -	DEPARTMENT OF TRANSPORTATION					CONTRACT NO. 78884
	PLOT DATE = 9/26/2024	DATE -	REVISED -		SCALE: NTS	SHEET 32 OF 37 SHEETS STA TO STA		ILLINOIS FED. AI	D PROJECT

<u> </u>	TYPE 1	PANEL - TYPE 2	TYPE 2	SIGN PANEL - TYPE 3	SIGN PANEL - TYPE 3	STEEL SIGN SUPPORT	TELESCOPING STEEL SIGN SUPPORT	SIGN PANEL ASSEMBLY TYPE A	SIGN PANEL ASSEMBLY TYPE B	SIGN STRUCTURE - BRIDGE MOUNTED	DELINEATORS	DELINEATOR REMOVAL	SIGN SUPPORT SPECIAL	OVERHEAD SIGN STRUCTURE - SPAN	COMMENTS
	SQ FT		SQ FT		SQ FT	FOOT	EACH	EACH	EACH	FOOT	EACH	EACH	EACH	EACH	
					1				FRANKLI	N				1	
STA 104+66.24 NB I-57 R8-3a	5	·				11	1	1							NO PARKING SIGN
STA 108+73 SB I-57		·	960 mg/d	160.5	126									1	OVERHEAD SIGNS
STA 20+17.24 CL I-57 R3-4		·'	18						1				1		NO U-TURN (ABOVE EXCEPT AUTHORIZED VEHICLES)-DOUBLE SIDED
STA 201 17.24 CL I-57 R3-I101	12	!							1				1		EXCEPT AUTHORIZED VEHICLES (BELOW NO U-TURN)-DOUBLE SIDED
STA 76+50.85 CL I-57 R3-4	10	!	18						1				1		NO U TURN (ABOVE EXCEPT AUTHORIZED VEHICLES)-DOUBLE SIDED
STA 76+50.85 CL I-57 R3-I101	12														EXCEPT AUTHORIZED VEHICLES (BELOW NO U-TURN)-DOUBLE SIDED
STA 89+97.42 SB I-57		20	20	55	55										REST AREA NEXT RIGHT, VENDING MACHINE
STA 96+20.15 SB I-57				136.5	136.5										REST AREA SIGN
STA 253+82.02 NB I-57				135	90										FOOD AND LODGING EXIT SIGNS
STA 262+10.91 NB I-57 STA 9+96.11 RT R4-I100			20	135	90					4					GAS & CAMPING EXIT SIGNS
STA 108+58 SB			20		114										SN 028-0055 TR 3 (E. FRANKLIN RD) OVER FAI RTE 57 - TRUCK USE 2 RIGHT LANE
STA 108+58 SB, D5-2	1				61										OVERHEAD SIGN STRUCTURE-SPAN
STA 106+36 SB, D5-2			20		01					4					OVERHEAD SIGN STRUCTURE-SPAN
STA 176+70.9 LT R4-1100			20							4					SN 028-0059 IL 154 OVER FAIRTE 57 - TRUCK USE 2 RIGHT LANES
									1	4			1		
STA 215+88.93 CL I-57 R3-4	10		18						1				~1		NO U-TURN (ABOVE EXCEPT AUTHORIZED VEHICLES)-DOUBLE SIDED
STA 215+88.93 CL I-57 R3-I101 STA 229+50.4 RT R4-I100	12		20							4					EXCEPT AUTHORIZED VEHICLES (BELOW NO U-TURN)-DOUBLE SIDED
STA 229+58.3 LT R4-1100	1		20							4					SN 028-0056 TR 75 (FRANKLIN CEM) OVER FAI RTE 57 - TRUCK USE 2 RIGHT LANE
STA 283+23 9 RT R4-1100			20							4					SN 028-0056 TR 75 (FRANKLIN CFM) OVER FAIRTE 57 - TRUCK USE 2 RIGHT I ANE
STA 283+50.3 LT R4-1100			20							4					SN 028-0053 CH 19 (MARCUM BR) OVER FAIRTE 57 - TRUCK USE 2 RIGHT LANES
STA 283+50.5 LT R4-1100 STA 327+50 CL W4-2L			20						1	4					SN 028-0053 CH 19 (MARCUM BR) OVER FAIRTE 57 - TRUCK USE 2 RIGHT LANES
STA 327+50 CL W4-2L STA 339+50 CL W9-1L		!							1						REMOVE LEFT LANE ENDS SIGNS FROM CONTRACT CN 78656
CL D10-5	420							10	1				28		REMOVE LEFT LANE ENDS SIGNS FROM CONTRACT CN 78656
NB	420							10			85	85	20		ENHANCED INTERMEDIATE REFERENCE LOCATION - 28 SIGNS
SB		!									85	85			
UBTOTAL	461	20	214	622	672	11	1	11	5	28	170	170	31	1	
	401		214	ULL	012				JEFFERSC	2862/56c7	110	110			
STA 37+11.00 NB I-57				90	90										FOOD EXIT SIGN
STA 46+98.00 NB I-57		/		90	90										GAS EXIT SIGN
STA 55+00.00 NB I-57				72.3	76										GROUND MOUNTED GUIDE SIGN
STA 72+77.90 NB I-57				91	91										GROUND MOUNTED GUIDE SIGN
STA 72+77.90 NB I-57		/		97	76										GROUND MOUNTED GUIDE SIGN
STA 101+08.52 NB I-57				72.3	80.8										GROUND MOUNTED GUIDE SIGN
STA 108+35.88 NB I-57 R8-3a	5			12.3	00.0	11	1	1							NO PARKING SIGN
STA 106+19.22 NB I-57 W13-3	5	20	20				1	010							ADVISORY RAMP SPEED SIGN
	1	20	20	30	32.5										EXIT GORE SIGN
STA 108+75.91 NB +57 E5-1 TA 128+00.00 SB I-57 R8-3a & W13-3	5	20	20		JZ.J	11	1	1							ADVISORY RAMP SPEED SIGN & NO PARKING SIGN
STA 158+08.47 CL I-57 R3-4	5		18				<u>.</u>	35					1		NO U-TURN (ABOVE EXCEPT AUTHORIZED VEHICLES)-DOUBLE SIDED
STA 158+08.47 CL I-57 R3-4 STA 158+08.47 CL I-57 R3-I101	12	ł	10										,		EXCEPT AUTHORIZED VEHICLES (BELOW NO U-TURN)-DOUBLE SIDED
STA 232+90 CL (SB) W4-2L	١Z	/							1						REMOVE LEFT LANE ENDS SIGNS FROM CONTRACT ON 78885
STA 244+90.83 CL (SB) W9-1L		/	1						1						REMOVE LEFT LANE ENDS SIGNS FROM CONTRACT ON 78885
STA 11+38 6 I T R4-I100		/	20							4					SIGNS FROM CONTRACT ON 78885 SN 028-0055 TR 3 (E. FRANKLIN RD) OVER FAI RTE 57 - TRUCK USE 2 RIGHT LANE
STA 116+92.75 RT R4-I100		!	20							4					SN 023-0033 TR 3 (E. FRANKLIN KD) OVER FAIRTE 57 - TRUCK USE 2 RIGHT LAND SN 041-0113 NORTH ST. (CH 42) OVER FAIRTE 57 - TRUCK USE 2 RIGHT LANES
STA 110192.75 101 100		/	20							4					SN 041-0113 NORTH ST. (CH 42) OVER FAIRTE 57 - TRUCK USE 2 RIGHT LANES SN 041-0113 NORTH ST. (CH 42) OVER FAIRTE 57 - TRUCK USE 2 RIGHT LANES
CL D10-5	300	!	20					8					20		ENHANCED INTERMEDIATE REFERENCE LOCATION - 20 SIGNS
NB	500	/						, ŭ			70	70	20		
SB											70	70			
		/									10	10			
SUBTOTAL	322	40	118	543	537	22	2	10	2	12	140	140	21		
TOTAL	783	60	332	1165	1209	33	3	21	7	40	310	310	52	1	
													27 177	10	I

USER NAME = muddin	DESIGNED - HH	REVISED -				
	DRAWN – IG	REVISED -	STATE OF ILLINOIS		SIGNING SCHEDU	LE OF Q
PLOT SCALE = 0.16666633 ' / in.	CHECKED - HH	REVISED -	DEPARTMENT OF TRANSPORTATION			
PLOT DATE = 10/15/2024	DATE -	REVISED -		SCALE: NTS	SHEET 33 OF 37 S	SHEETS ST/


~ -			F.A. I RTE	SECT	TION		COUNTY	TOTAL SHEETS	SHEET NO.
U	F QUANTITIES		57	(28-2)B-2; (28	-1)B-2		VARIOUS	598	64
							CONTRACT	NO. 78	884
s	STA.	TO STA.			ILLINOIS	FED. AI	D PROJECT		

							PAVEMENT MARKIN	SALAT ME CONVERTING SALATION		T
		PO			MARKING		GROOVING FOR		GROOVING FOR	
LOCATION	I STA TO STA		so			SKIP DASH	RECESSED	RECESSED	RECESSED	
		LINE-8"	LINE-24"	LIN	E-6"	LINE-6"	PAVEMENT	PAVEMENT	PAVEMENT	COMMENTS
			WHITE		YELLOW	WHITE	MARKING -7"	MARKING -9"	MARKING -25"	
FROM	то	FOOT	FOOT	FOOT	FOOT	FOOT	FOOT	FOOT	FOOT	
				i	FRA	NKLIN			. <u></u>	
ORTHBOU	ND									
9+78.11	92+24			8246	8246	4123	20615			
92+24	131+55			3931	3931	1966	9828			
31+55	155+96			2441	2441	1221	6103			
55+96	162+53			662	657	329	1648			IL 154 ENTRANCE RAMP
162+53	166+34	762		386	381	191	958	762		IL 151 ENTRANCE RAMP
166+34	187+31			2097	2097	1049	5243			1-57 MAINLINE
166+34	187+31		46	2526	2484		5010		46	RAMPSONLY
187+31	192+10	959		480	479	240	1199	959		IL 154 EXIT RAMP
192+10	194+83			274	273	137	684			IL 154 EXIT RAMP
194+83	293+77			9894	9894	4947	24735			
293+77	327+00			3323	3323	1662	8308			
SOUTHBOU	ND									
9+78.11	73+84			6416	6416	3208	16040			
73+84	104+80			3086	3086	1543	7715			
104+80	107+59			281	279	140	700			REND LAKE REST AREA EXIT RAMP
107+59	112+52	989		496	493	247	1236	989		REND LAKE REST AREA EXIT RAMP
112+52	130+11			1759	1759	880	4398			
130+11	135+75	1127		563	564	282	1109	1127		REND LAKE REST AREA ENTRANCE RAM
135+75	142+33			658	658	329	1645			REND LAKE REST AREA ENTRANCE RAM
142+33	157+20			1487	1487	744	3718			
157+20	159+82			262	262	131	655			IL 154 EXIT RAMP
159+82	164+71	978		489	489	245	1223	978		IL 154 EXIT RAMP
164+71	186+31			2160	2160	1080	5400			I-57 MAINLINE
164+71	186+31		47	2483	2462	1000	4945		47	RAMPSONLY
186+31	191+75	1338		546	544	272	1362	1338		IL 154 ENTRANCE RAMP
191+75	197+29			554	554	277	1385			IL 154 ENTRANCE RAMP
197+29	275+73			7844	7844	3922	19610			
275+73	314+72			3899	3899	1950	9748			
314+72	327+00			1228	1228	614	3070			
	TOTAL	6153	93	68471	68390	31722	168583	6153	93	
					JEFF	ERSON				~
NORTHBOU	ND									
11+21.9	101+24			9002	9002	4501	22505			
101+24	104+71			348	347	174	869			INA ROAD EXIT RAMP
104+71	109+17	894		447	446	223	1116	894		
109+17	125+05			1588	1588	794	3970			1-57 MAINLINE
109+17	125+05			953	968		1921			RAMPS ONLY
125+05	127+85	558		280	280	140	700	558		INA ROAD ENTRANCE RAMP
127+85	136+46			851	858	429	2138			INA ROAD ENTRANCE RAMP
136+46	223+50			8704	8704	4352	21760			
223+50	245+00			2150	2150	538	4838			
				2100	2.00		0			
11+21.9	98+62			8740	8740	4370	21850			
98+62	104+73			611	611	306	1528			INA ROAD ENTRANCE RAMP
0.02	109+75	1007		505	502	251	1258	1007		
04+73	124+90			1515	1515	758	3788	1001		I-57 MAINLINE
	124+90			1248	1261		2509			RAMPSONLY
104+73 109+75 109+75		876		440	434	217	1091	876		
109+75 109+75		010		312	310	155	777	010		
109+75 109+75 124+90	129+22			1 312	510	100			<u> </u>	
109+75 109+75 124+90 129+22	129+22 132+31				10060	5035	25172			
109+75 109+75 124+90 129+22 132+31	129+22 132+31 233+00			10069	10069	5035 600	25173			
109+75 109+75	129+22 132+31				10069 1200	5035 600	25173 3000			
109+75 109+75 124+90 129+22 132+31 233+00	129+22 132+31 233+00	3335		10069		the fill soll.	international internationa	3335		

				CONCRETE F	ARRIER SCHEDULE		
LOCATION	N STA TO STA	TEMPORARY CONCRETE BARRIER	PINNING TEMPORARY CONCRETE BARRIER	RELOCATE TEMPORARY CONCRETE BARRIER	IMPACT ATENUATORS, TEMPORARY (NON- REDIRECTIVE, NARROW), TEST LEVEL 3	IMPACT ATENUATORS, RELOCATE (NON- REDIRECTIVE, NARROW), TEST LEVEL 3	BARRIER WALL REFLECTORS, TYPE C
FROM	то	FOOT	EACH	FOOT	EACH	EACH	EACH
				F	RANKLIN		
TAGE 2							
01+34	104+95	362.5	28				15
04+95					1		
00+44	104+05	362.5	28				15
00+44					1		
02+39	305+63	325.0	25				14
802+39					1		
802+86	306+13	325.0	26				14
306+13					1		
STAGE 3							
5+85						1	
5 85	102+63	687.5	54				28
02+63	106+25			362.5			
9+15	102+78			362.5			
02+78	109+55	687.5	54				28
09+55						1	
97+85	304+46	662.5	52				27
304+46	307+71			325.0			
97+85						1	
300+50	303+75			325.0			
803+75	310+74	700.0	55				29
310+74						1	
SUE	BTOTAL	4113	322	1375	4	4	170
				JE	FFERSON		
STAGE 2							
6+65	99+15	250.0	21				11
9+15					1		
5+75	98+25	250.0	21				11
5+75					1		
STAGE 3							
3+35						1	
3+35	96+65	237.5	20				10
6+65	98+25			250.0			
6+65	98+25			250.0			
8+25	101+55	237.5	20				10
01+55						1	
	BTOTAL	975	82	500	2	2	42
т	OTAL	5088	404	1875	6	6	212

RAISED	O REFLECTIVE	PAVEMENT MARKE	R SCHEDU
LOCATION	STA TO STA	RAISED REFLECTIVE PAVEMENT MARKER	RAIS REFLE PAVEM MARI REMO
FROM	то	EACH	EAG
	•	FRANKLIN	
NORTHBOUN	ND		
9+78.11	315+00	1000	76
315+00	327+00	1636	30
SOUTHBOUN	ID		
9+78.11	327+00	1686	79
SUBT	OTAL	3323	158
		JEFFERSON	
NORTHBOUN	۱D		
11+21.89	223+55	1186	58
223+55	243+50	75	30
SOUTHBOUN	ID		
11+21.89	237+50	1181	58
237+50	243+50	15	30
SUB	TOTAL	2458	110
то	TAL	5781	274

DDEL: Schedul E NAME: 143	ABBNAR DESKUNFIRM REG. 184.002117 FBU: T745 McClintock Drive Suite 210 Burr Midge, IL 60527 Ph: 773-283-3728	USER NAME = muddin PLOT SCALE = 0.16666633 ' / in.	DESIGNED - HH DRAWN - IG CHECKED - HH	REVISED - REVISED - REVISED -	STATE OF ILLINOIS DEPARTMENT OF TRANSPORTATION	PERMANENT F	PAVEMENT S	MARKIN		
¥ I		PLOT DATE = 10/15/2024	DATE -	REVISED -		SCALE: NTS	SHEET 34	OF 37	SHEETS	3

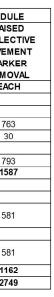

SCHEDULE OF QUANTATIES 57 (28-2)B-2; (28-1)B-2 VARIOUS 598 65 CONTRACT NO. 78884 CONTRACT NO. 78884	ENT	MA	RKIN	G & TE	MPORARY	CONCRETE BARRIER	F.A. I RTE. SECTION			COUNTY	TOTAL SHEETS	SHEET NO.	
	S	SCHEDULE OF QUANTATIES					57	(28-2)B-2; (28	-1)B-2		VARIOUS	598	65
CONTRACTING. 78804		JOILE	OLL	0 00							CONTRACT	NO. 78	884
34 OF 37 SHEETS STA. TO STA. ILLINOIS FED. AID PROJECT	34	OF	37	SHEETS	STA.	TO STA.			ILLINOIS	FED. AI	PROJECT		

LOCATIO	N STA TO STA	SHORT TERM PAVEMENT MARKING	SHORT TERM PAVEMENT REMOVAL	COMMENTS
FROM	то	FOOT	SQ FT	
		FRANKLIN		
NORTHBOU	JND			
9+78.11	92+24	1807	602	
92+24	131+55	861	287	
131+55	155+96	535	178	
155+96	162+53	145	48	IL 154 ENTRANCE RAMP
162+53	166+34	81	28	IL 151 ENTRANCE RAMP
166+34	187+31	459	153	I-57 MAINLINE
166+34	187+31	99	33	RAMPS ONLY
187+31	192+10	105	35	IL 154 EXIT RAMP
192+10	194+83	60	20	IL 154 EXIT RAMP
194+83	293+77	2168	722	
293+77	327+00	728	242	
SOUTIBOU	JND			
9+78.11	73+84	1406	468	
73+84	104+80	676	225	
104+80	107+59	61	20	REND LAKE REST AREA EXIT RAMP
107+59	112+52	108	36	REND LAKE REST AREA EXIT RAMP
112+52	130+11	385	128	
130+11	135+75	123	41	REND LAKE REST AREA ENT. RAMP
135+75	142+33	144	48	REND LAKE REST AREA ENT. RAMP
142+33	157+20	325	108	
157+20	159+82	57	19	IL 154 EXIT RAMP
159+82	164+71	107	35	IL 154 EXIT RAMP
164+71	186+31	473	157	1-57 MAINLINE
164+71	186+31	97	32	RAMPS ONLY
186+31	191+75	119	39	IL 154 ENTRANCE RAMP
191+75	197+29	121	40	IL 154 ENTRANCE RAMP
197+29	275+73	1719	573	
275+73	314+72	854	284	
314+72	327+00	269	89	
	BTOTAL	14095	4690	
				4
		EFFERSON		
NORTHBOL	JND			
11+21.9	101+24	1973	657	
101+24	104+71	76	25	INA ROAD EXIT RAMP
104+71	109+17	97	32	INA ROAD EXIT RAMP
109+17	125+05	348	116	1-57 MAINLINE
109+17	125+05	37	12	RAMPS ONLY
125+05	127+85	61	20	INA ROAD ENTRANCE RAMP
127+85	136+46	186	62	INA ROAD ENTRANCE RAMP
136+46	223+50	1907	635	
223+50	245+00	471	157	
SOUTHBOL				
11+21.9	98+62	1915	638	
98+62	104+73	133	44	INA ROAD ENTRANCE RAMP
104+73	109+75	110	36	INA ROAD ENTRANCE RAMP
109+75	124+90	332	110	I-57 MAINLINE
109+75	121+90	48	16	RAMPS ONLY
124+90	129+22	96	32	INA ROAD EXIT RAMP
129+22	132+31	68	22	INA ROAD EXIT RAMP
	233+00	2207	735	
132+31				
132+31	245+00	263	87	
	245+00	263	87	
132+31 233+00	245+00 BTOTAL	263 10328	87 3436	

ABNA 745 McClintock Drive besides HFinw Res. 184.002117 State 378 Part Mege IL 80527 Phys. 773-681-4788 Part Mege IL 80527 Phys. 773-681-4788 Part Mege IL 80527 Phys. 773-681-4788	USER NAME = muddin	DESIGNED - HH	REVISED -			F.A. I SECTION	COUNTY TOTAL SHEET
		DRAWN – IG	REVISED -	STATE OF ILLINOIS	SHORT TERM PAVEMENT MARKING SCHEDULE OF QUANTITIES	57 (28-2)B-2; (28-1)B-2	VARIOUS 598 66
	PLOT SCALE = 0.16666633 ' / in.	CHECKED - HH	REVISED -	DEPARTMENT OF TRANSPORTATION			CONTRACT NO. 78884
	PLOT DATE = 10/11/2024	DATE -	REVISED -		SCALE:NTS SHEET 35 OF 37 SHEETS STA. TO STA.	ILLINOIS FED. AI	D PROJECT

DRAINAGE MARKERS SCHEDULE					DRAINAG	EMARKERS	SCHEDULE (CONTINUED)	DR	DRAINAGE MARKERS SCHEDULE (CONTINUED)							
LOCATION ST	TA TO STA	POLYUREA PAVEMENT MARKING LETTERS & SYMBOLS	PAVEMENT MARKING, LETTERS AND	COMMENTS	LOCATION STA TO STA	POLYUREA PAVEMENT MARKING	GROOVING FOR RECESSED PAVEMENT MARKING, LETTERS AND SYMBOLS (25" X 25")	LOCATION ST.		POLYUREA PAVEMENT MARKING LETTERS & SYMBOLS		COMMENTS	LOCATION STA TO STA	POLYUREA PAVEMENT MARKING LETTERS & SYMBOLS		
FROM	то	SQ FT	SQ FT		FROM	SQ FT	SQ FT	FROM	то	SQ FT	SQ FT		FROM	SQ FT	SQ FT	1
		FRANKLIN				FR	ANKLIN			JEFFERSON				JEF	FERSON	
NORTHBOUND					81+98.00	2	CL	NORTHBOUND					138+00.00	2		CL
9+78.11	50+00.00 BK	18	39.1	OUTSIDE SHLDR	85+00.00	2	CL	11+21.89	62+65.57 BK	22	47.7	OUTSIDE SHLDR	142+00.00	2		CL
49+99.31 AH	101+49.25	22	47.7	OUTSIDE SHLDR	88+00.00	2	CL	62+64.51 AH	226+02.00	66	143.2	OUTSIDE SHLDR	146+00.00	2		CL
101+61.25	103+75.75			BRIDGE OMMISSION	92+40.00	2	CL	SOUTHBOUND					150+00.00	2		CL
103+90.75	176+14.31 BK	30	65.1	OUTSIDE SHLDR	96+55.00	2	CL	11+21.89	62+65.57 BK	22	47.7	OUTSIDE SHLDR	154+00.00	2		CL
176+15.00 AH	200+00.00 BK	10	21.7	OUTSIDE SHLDR	97+60.00	2	CL	62+64.51 AH	226+02.00	66	143.2	OUTSIDE SHLDR	158+00.00	2		CL
200+00.70 AH	242+97.43 BK	18	39.1	OUTSIDE SHLDR	98+45.00	2	CL						161+00.00	2		CL
243+00.98 AH	302+87.84	24	52.1	OUTSIDE SHLDR	103+40.00	2	CL	RAMP A -NORTH AVEN	JE INT.	8	17.4	BOTH	164+66.00	2		CL
303+37.92	305+12.07			BRIDGE OMMISSION	108+35.00	2	CL	RAMP B - NORTH AVEN	IUE INT.	8	17.4	BOTH	169+60.00	2		CL
305+27.07	307+00.00	2	4.3	OUTSIDE SHLDR	113+36.00	2	CL	RAMP C - NORTH AVEN	IUE INT.	8	17.4	вотн	174+60.00	2		CL
					117+30.00	2	CL	RAMP D - NORTH AVEN		8	17.4	вотн	177+50.00	2		CL
SOUTHBOUND	42				120+00.00	2	CL	10+00.00		2		CL	182+00.00	2		CL
9+78.11	50+00.00 BK	18	39.1	OUTSIDE SHLDR	123+27.00	2	CI	10+71.25		2		CL	186+24.00	2		CL
49+99.31 AH	101+49.25	22	47.7	OUTSIDE SHLDR	123+40.25	2	CL	15+50.00		2		CL	191+00.00	2		CL
101+61.25	103+75.75	22	41.1	BRIDGE OMMISSION	126+37.00	2	CL	20+26.00		2		CL	195+00.00	2		CL
103+90.75	176+14.31 BK	30	65.1	OUTSIDE SHLDR	129+35.00	2	CL	25+01.00		2		CL	199+20.00	2		CL
176+15 AH	200+00.00 BK	10	21.7	OUTSIDE SHLDR	130+89.00	2	CL	30+00.00		2		CL	203+00.00	2		CL
							CL									
200+00.70 AH	242+97.43 V	18	39.1	OUTSIDE SHLDR	133+00.00	2		34+90.00		2		CL	206+70.00	2		CL
243+00.98 AH	303+22.92	26	56.4		137+34.00	2	CL	39+00.00		2		CL	216+48.00	2		CL
303+37.92	305+12.07		10	BRIDGE OMMISSION	141+36.00	2	CL	44+00.00		2		CL	218+86.00	2		CL
305+62.16	307+00.00	2	4.3	OUTSIDE SHLDR	145+36.00	2	CL	45:00.00		2		CL	221 • 25.00	2		CL
					149+75.00	2	CL	48+00.00		2		CL	222+21.00	2		CL
RAMP A - SB REST AR		4	8.7	BOTH	151+00.00	2	CL	51+35.25		2		CL	223+16.00	2		CL
RAMP B - SB REST AR	REA	4	8.7	BOTH	154+70.00	2	CL	52+00.00		2		CL	226+34.00	2		CL
RAMP A - IL 154 INT.		8	17.4	BOTH	158+30.00	2	CL	56+00.00		2		CL	229+16.00	2		CL
RAMP B - IL 154 INT.		8	17.4	BOTH	161+00.00	2	CL	60+00.00		2		CL	229+80.00	2		CL
RAMP C - IL 154 INT.		8	17.4	BOTH	164+04.37	2	CL	64+00.00		2		CL	234+68.00	2		CL
RAMP D - IL 154 INT.		8	17.4	BOTH	165+00.00	2	CL	68+00.00		2		CL	239+50.00	2		CL
12+11.45		2		CL	165+95.63	2	CL	72+00.00		2		CL	244+45.00	2		CL
17+00.00		2		CL	168+75.00	2	CL	76+00.00		2		CL	249+00.00	2		CL
20+10 00		2		CI	173+00 00	2	CL	80+00.00		2		CL	258+00.00	2		CL
21+04.37		2		CL	177+00.00	2	CL	84+00.00		2		CL	263+00.00	2		CL
22+00.00		2	1	CL	181+00.00	2	CL	85+98.00		2		CL	268+00.00	2		CL
26+26.00		2		CL	184+90.00	2	CL	88+00.00		2		CL	272+72.78	2		CL
30+68.00		2		CL	191+60.00	2	CL	92+00.00		2		CL	275+01.77	2		CL
35+00.00		2	1	CL	196+10.00	2		96+00.00		2		CL	2/8+00.00	2		CL
39+00.00		2	-	CL	200+00.00	2	CL	100+00.00	-	2		CL	280+50.00	2		CL
47+00.00		2			203+40.00	2	CL	106+00.00		2		CL	284+00.00	2		CL
50+70.00		2		02	207+00.00	2	CL		-	2				2		
				CL				108+44.50	-			CL	288+00.00			CL
53+65.00		2		CL	208+05.00	2	CL	110+00.00		2		CL	292+16.85	2		CL
57+76.00		2		CL	209+00.00	2	CL	114+00.00		2		CL	296+41.80	2		CL
62+00.00	-	2	-	CL	209+94.00	2	CL	118+00.00	_	2		CL	299+00.00	2		CL
66+00.00		2		CL	212+00.00	2	CL	122+00.00		2		CL	301+80.00	2		CL
70+12.00		2	-	CL	216+00.00	2	CL	126+00.00		2		CL	303+50.00	2		CL
73+00.00		2		CL	220+00.00	2	CL	130+00.00		2		CL	305+15.00	2		CL
76+20.00		2		CL	224+00.00	2	CL	131+10.00		2		CL	306+00.00	2		CL
78+56.00		2		CL				134+00.00		2		CL	306+76.00	2		CL
SUBTO	TAL	328	630		SUBTOTAL	92	0	SUBTO	TAL	280	452		SUBTOTAL	94	0	

TOTAL	POLYUREA PAVEMENT MARKING LETTERS & SYMBOLS	794
IOIAL	GROOMING FOR RECESSED PAVEMENT MARKING, LETTERS AND SYMBOLS (25" X 25")	1082


				SECTION			COUNTY	TOTAL SHEETS	SHEET NO.
EDULE OF QUANTITIES			57	(28-2)B-2; (28	-1)B-2		VARIOUS	598	67
							CONTRACT	NO. 78	884
TS	STA.	TO STA.			ILLINOIS	FED. AI	D PROJECT		


		PAINT PAVEMENT MARKING	
LOCATION STATO STA		PAVEMEMNT MARKING REMOVAL - GRINDING	COMMENTS
FROM	то	SQ FT	
	FR	ANKLIN	
NORTHBOL	IND		
9+78.11	311+63	18866	
321+63	330+00	105	
307+00	327+00	2061	INSIDE LANE - TAPER LANE AND DIAGONALS
318+25.00		41.5	LANE DROP ARROW
327+25.00		41.5	LANE DROP ARROW
SOUTHBOU	ND		
9+78.11	308+63	18678	
307+00	315+00	824	INSIDE LANE - TAPER LANE AND DIAGONALS
SUE	BTOTAL	40617	
	JEF	FERSON	
NORTHBOL	IND		
11+21.89	238+83	14226	
105+10	107+15	26	SKIP DASH AT RAMP EXIT
SOUTHBOU	ND		
11+21.89	241+85	14414	
127+05	129+50	31	SKIP DASH AT RAMP EXIT
226+00	244+90.83	1148	LANE LINE AND DIAGONALS
245+00		41.5	LANE DROP ARROW
250+00		41.5	LANE DROP ARROW
SUE	BTOTAL	29928	
T	OTAL	70545	

	STATION	PROPOSE D MILE MARKER	REMOVE SIGN PANEL ASSEMBLY - TYPE A	SIGN PANEL - TYPE 1	SIGN SUPPOR SPECIAL
297+44 75.2 15.0 1 286+88 75.4 15.0 1 276+32 75.6 15.0 1 265+76 75.8 15.0 1 255+50 76.0 2 15.0 1 244+91 76.2 15.0 1 234+35 76.4 15.0 1 234+35 76.6 15.0 1 234+35 76.6 15.0 1 202+67 77.0 2 15.0 1 192+11 77.2 15.0 1 1 181+55 77.4 15.0 1 1 160+43 77.8 15.0 1 1 179+99 77.6 15.0 1 1 189+7 78.0 2 15.0 1 170+99 77.6 15.0 1 1 189+7 78.0 2 15.0 1 128+7 79.0 2				SQ FT	EACH
286+88 75.4 15.0 1 276+32 75.6 15.0 1 265+76 75.8 15.0 1 255+50 76.0 2 15.0 1 234+35 76.4 15.0 1 234+35 76.4 15.0 1 234+79 76.6 15.0 1 223+79 76.6 15.0 1 223+79 76.6 15.0 1 202+67 77.0 2 15.0 1 192+11 77.2 15.0 1 1 181+55 77.4 15.0 1 1 181+55 77.4 15.0 1 1 184+87 78.0 2 15.0 1 18947 78.0 2 15.0 1 189+37 78.4 15.0 1 1 192+75 78.4 15.0 1 1 175+95 79.4 15.0<			FRANKLIN		
276+32 75.6 15.0 1 265+76 75.8 15.0 1 255+50 76.0 2 15.0 1 234+35 76.4 15.0 1 234+35 76.4 15.0 1 234+35 76.4 15.0 1 234+35 76.6 15.0 1 234+35 76.6 15.0 1 234+35 76.6 15.0 1 234+35 76.6 15.0 1 202+67 77.0 2 15.0 1 192+11 77.2 15.0 1 1 192+11 77.6 15.0 1 1 181+55 77.4 15.0 1 1 181+57 78.0 2 15.0 1 139+31 78.2 15.0 1 1 184+70 79.0 2 15.0 1 197+0 79.2 15.0 1<	297+44	75.2		15.0	1
265+76 75.8 15.0 1 255+50 76.0 2 15.0 1 234+35 76.4 15.0 1 234+35 76.4 15.0 1 223+79 76.6 15.0 1 223+79 76.6 15.0 1 223+79 76.6 15.0 1 22467 77.0 2 15.0 1 192+11 77.2 15.0 1 1 181+55 77.4 15.0 1 1 160+43 77.8 15.0 1 1 139+31 78.2 15.0 1 1 18+87 78.0 2 15.0 1 18+97 78.4 15.0 1 1 18+87 79.0 2 15.0 1 18+97 79.0 2 15.0 1 17+67 79.4 15.0 1 1 54+83	286+88	75.4		15.0	1
255+50 76.0 2 15.0 1 244+91 76.2 15.0 1 234+35 76.4 15.0 1 223+79 76.6 15.0 1 223+79 76.8 15.0 1 223+79 76.8 15.0 1 223+79 76.8 15.0 1 202+67 77.0 2 15.0 1 192+11 77.2 15.0 1 1 192+11 77.6 15.0 1 1 181+55 77.4 15.0 1 1 1 160+43 77.8 2 15.0 1 1 139+31 78.2 15.0 1 <td< td=""><td>276+32</td><td>75.6</td><td></td><td>15.0</td><td>1</td></td<>	276+32	75.6		15.0	1
244+91 762 15.0 1 234+35 76.4 15.0 1 223+79 76.6 15.0 1 213+23 76.8 15.0 1 202+67 77.0 2 15.0 1 192+11 77.2 15.0 1 1 192+11 77.2 15.0 1 1 181+55 77.4 15.0 1 1 181+55 77.4 15.0 1 1 160+43 77.8 2 15.0 1 170+99 77.6 2 15.0 1 139+31 78.2 15.0 1 1 128+75 78.4 15.0 1 1 17+63 78.8 15.0 1 1 97+07 79.0 2 15.0 1 165+39 79.6 15.0 1 1 54+83 79.8 15.0 1 1	265+76	75.8		15.0	1
234+35 76.4 15.0 1 223+79 76.6 15.0 1 213+23 76.8 15.0 1 202+67 77.0 2 15.0 1 192+11 77.2 15.0 1 1 192+11 77.2 15.0 1 1 160+43 77.8 15.0 1 1 149+87 78.0 2 15.0 1 139+31 78.2 15.0 1 1 128+75 78.4 15.0 1 1 170+63 78.8 15.0 1 1 1749 78.6 15.0 1 1 107+63 78.8 15.0 1 1 1 97+07 79.0 2 15.0 1 1 65+39 79.6 15.0 1 1 1 54+83 79.8 15.0 1 1 124+2 80.6<	255+50	76.0	2	15.0	1
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145+62 83.2 15.0 1 156+18 83.4 15.0 1 166+74 83.6 15.0 1 177+30 83.8 15.0 1 187+80 84.0 2 15.0 1 198+36 84.2 15.0 1	135+06	83.0	2	15.0	1
166+74 83.6 15.0 1 177+30 83.8 15.0 1 187+80 84.0 2 15.0 1 198+36 84.2 15.0 1	145+62			- ACCONDUCT	1
177+30 83.8 15.0 1 187+80 84.0 2 15.0 1 198+36 84.2 15.0 1	156+18	0000000 000		·	1
187+80 84.0 2 15.0 1 198+36 84.2 15.0 1	166+74	83.6		15.0	1
198+36 84.2 15.0 1	177+30	83.8		15.0	1
	187+80	84.0	2	15.0	1
208+92 84.4 15.0 1	198+36	84.2		15.0	1
	208+92	84.4		15.0	1
219+48 84.6 15.0 1	219+48	84.6		15.0	1

NOTE: MILE POST MARKER SIGN PAY ITEM TOTALS ARE INCLUDED IN THE SIGNING SCHEDULE


ABBINAR Handreicher Handreich	USER NAME = muddin	DESIGNED - HH	REVISED -		PERMANEN	T PAVEMENT MARKIN	G REMOVAL &	F.A. I RTE	SECTION		OTAL SHEET	
		DRAWN – IG	REVISED -	STATE OF ILLINOIS				(28-2)B-2; (28-1)B-2	VARIOUS	598 68		
	PLOT SCALE = 0.16666633 ' / in.	CHECKED - HH	REVISED -	DEPARTMENT OF TRANSPORTATION		SCHEDULE O QUANTITIES					CONTRACT N	0. 78884
	PLOT DATE = 10/11/2024	DATE -	REVISED -		SCALE: NTS	SHEET 37 OF 37	SHEETS STA.	TO STA.	ILLINOIS FED. AID PROJECT			

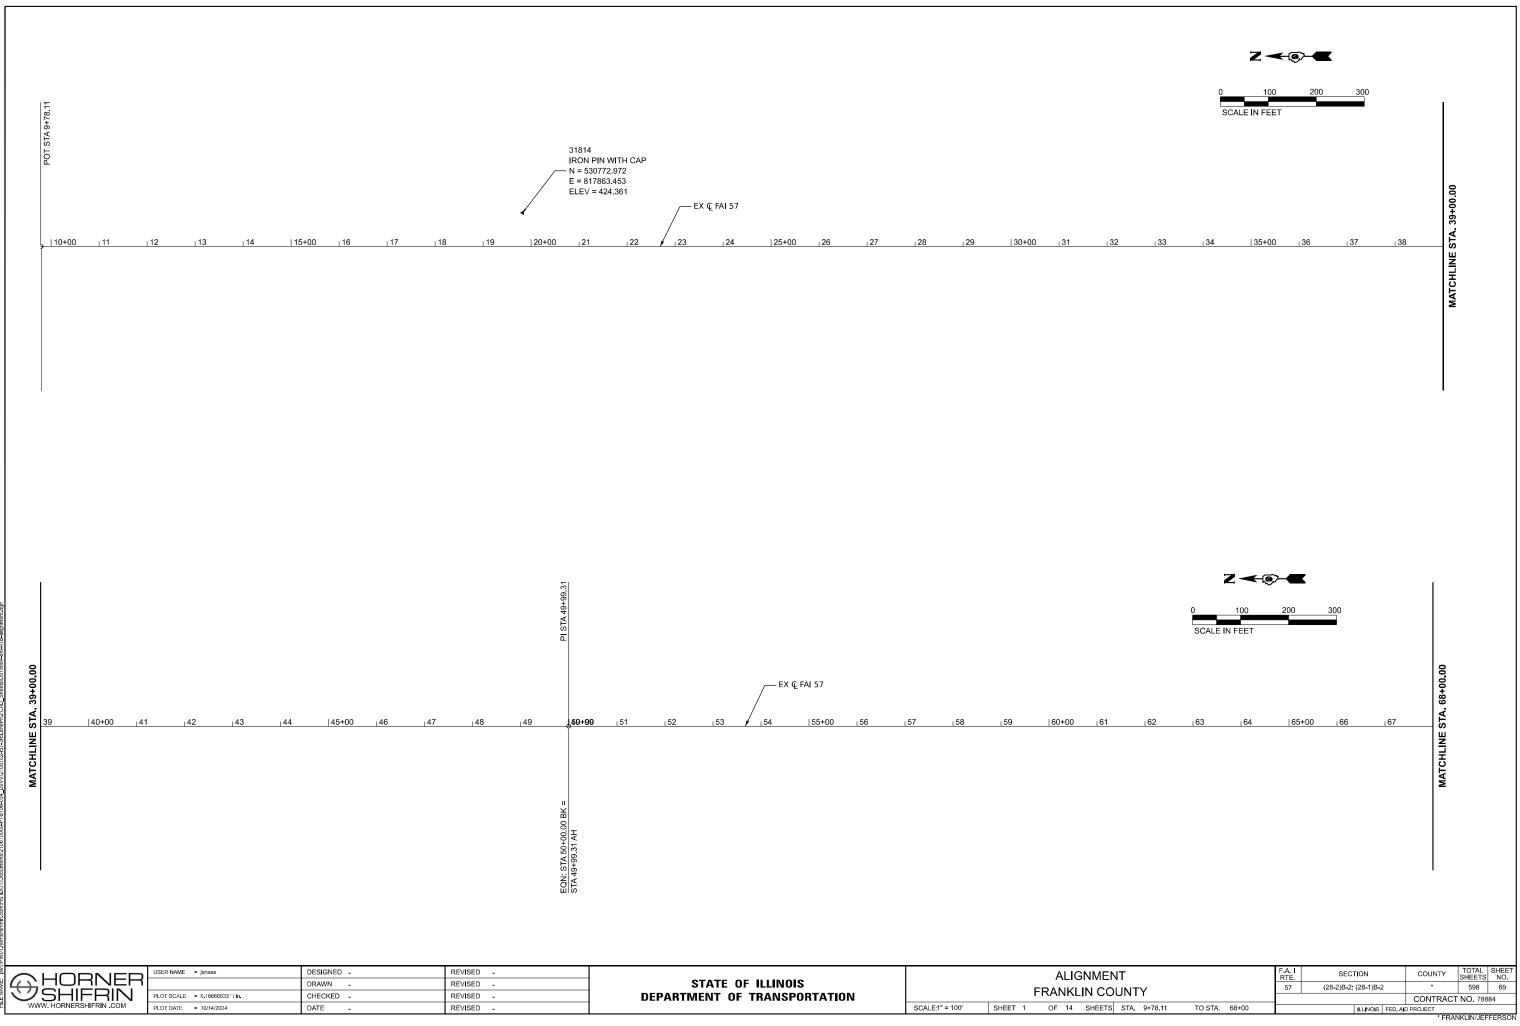

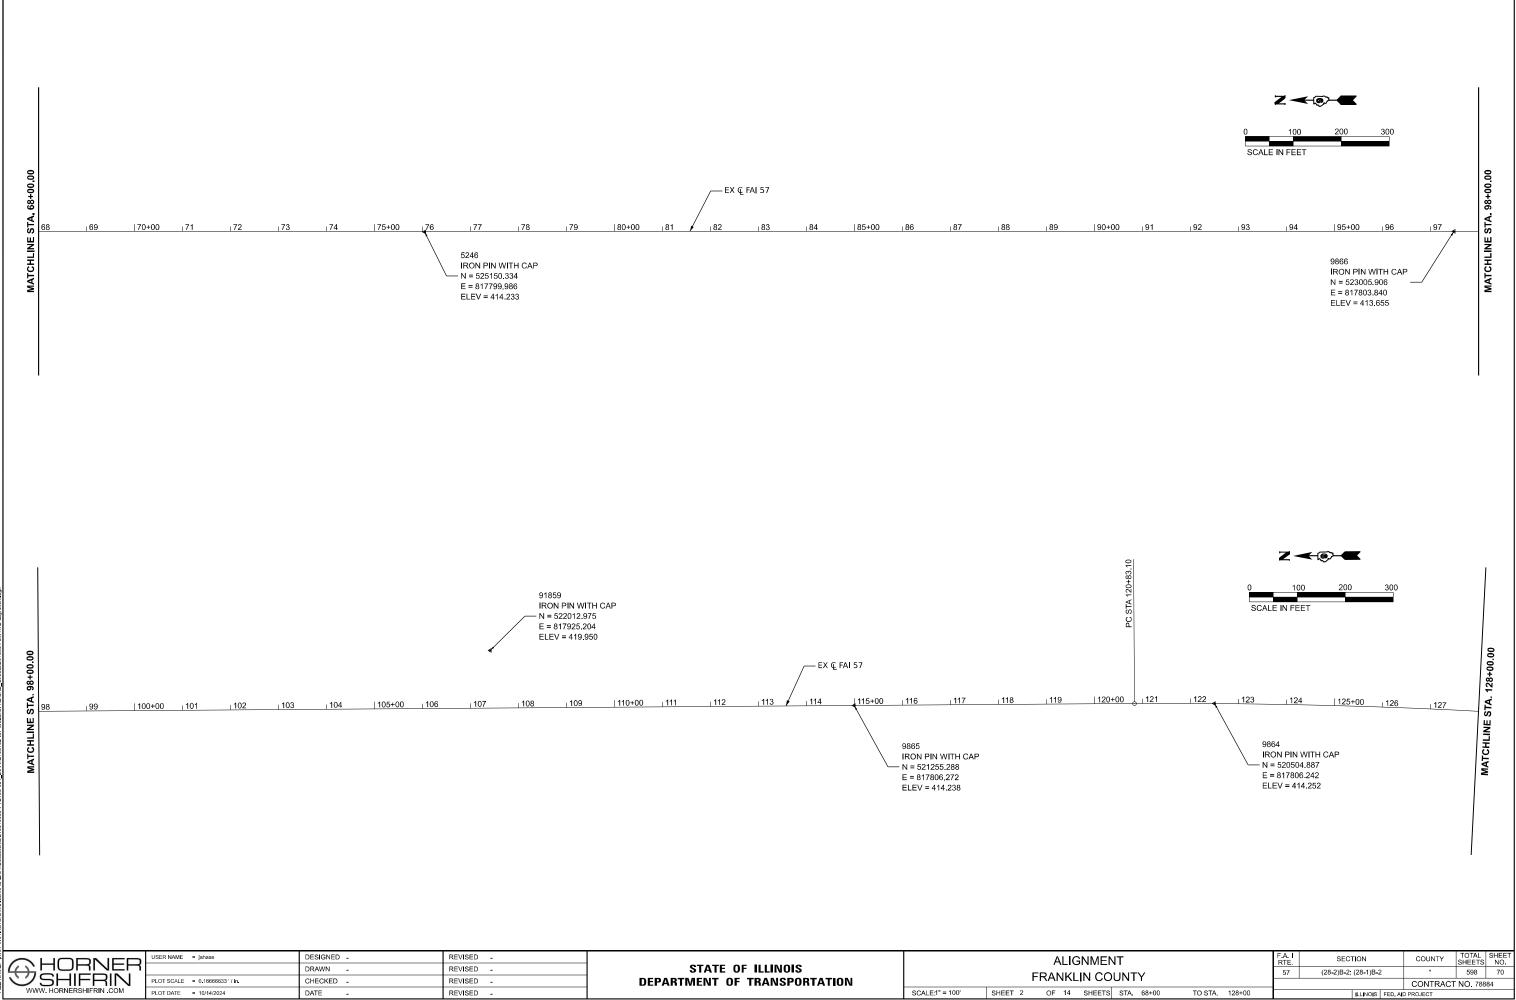



FRANKLIN/JEFFERSON

TTO UNCERTOETTE

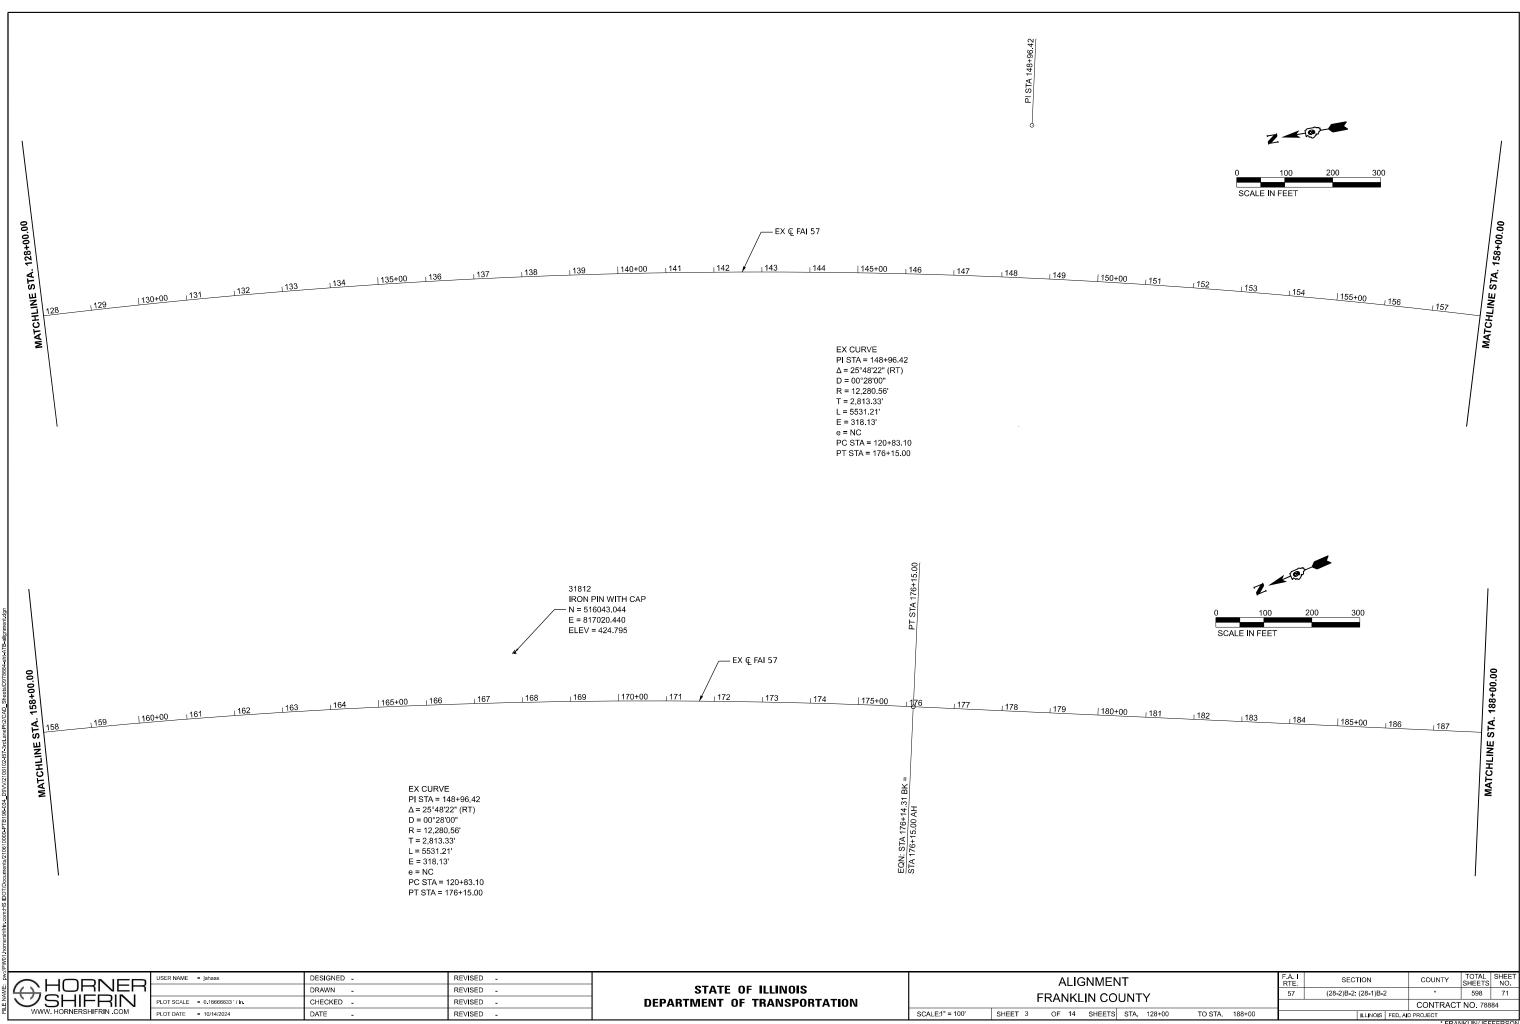


	MATCHLINE STA. 188+00.00	<u>188</u> 189	190+00 ı15	91 192	ı 193 ı 194	195+00 ₁ 196	. 197 .	<u>198 199</u>	EQN: STA 200+00.00 BK = PI STA 200+00.70 STA 200+00.70 AH 000		1203	EX & FAI 57 205+00	1206 1207	1208	1209 210+
RANKLINA - FranklinAlignmenek [Sheel] puri/With Home-shifth.com:HS DOTTOcomments210610000-PTB198-034_DSV/2106102-457-3rdLanePH2ICAD_SheelaD0708084-ehh-ATB-alignment.dgn	WATCHLINE STA, C 218+00	SSTA 210.1	B 1220+00 122	1 1222 1	223 1224	225+00 1226	1227 12:			EX CURVE PI STA = 231+31.6 $\Delta = 23^{*4}0^{+5^{*}}$ (LT) D = 01°00'02" R = 5,726.54' T = 1,200.03' L = 2365.83' E = 124.39' e = 2.0% PC STA = 219+31 PT STA = 243+00. 1231 1232 1231 1232	.60	235+00	236 1237	1238	1239 1240+00
MODEL: I57FRANI		HORNE SHIFRIN W. HORNERSHIFRIN .COM	USER NAME PLOT SCALE PLOT DATE	= 0.16666633 ' / in.	DESIGNED - DRAWN - CHECKED - DATE -		REVISED - REVISED - REVISED - REVISED -		DI	STATE OF EPARTMENT OF		TION	SCALE:1" = 100'	SHEET 4	ALIGNMEN FRANKLIN COU OF 14 SHEETS

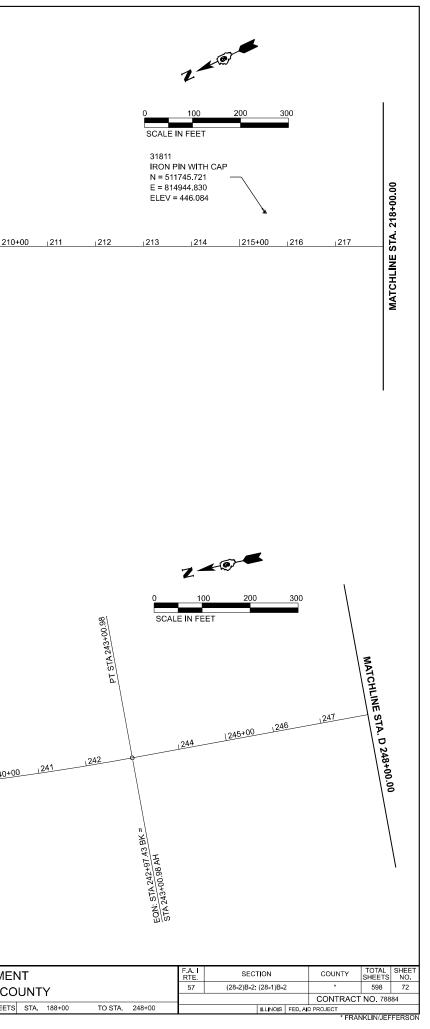


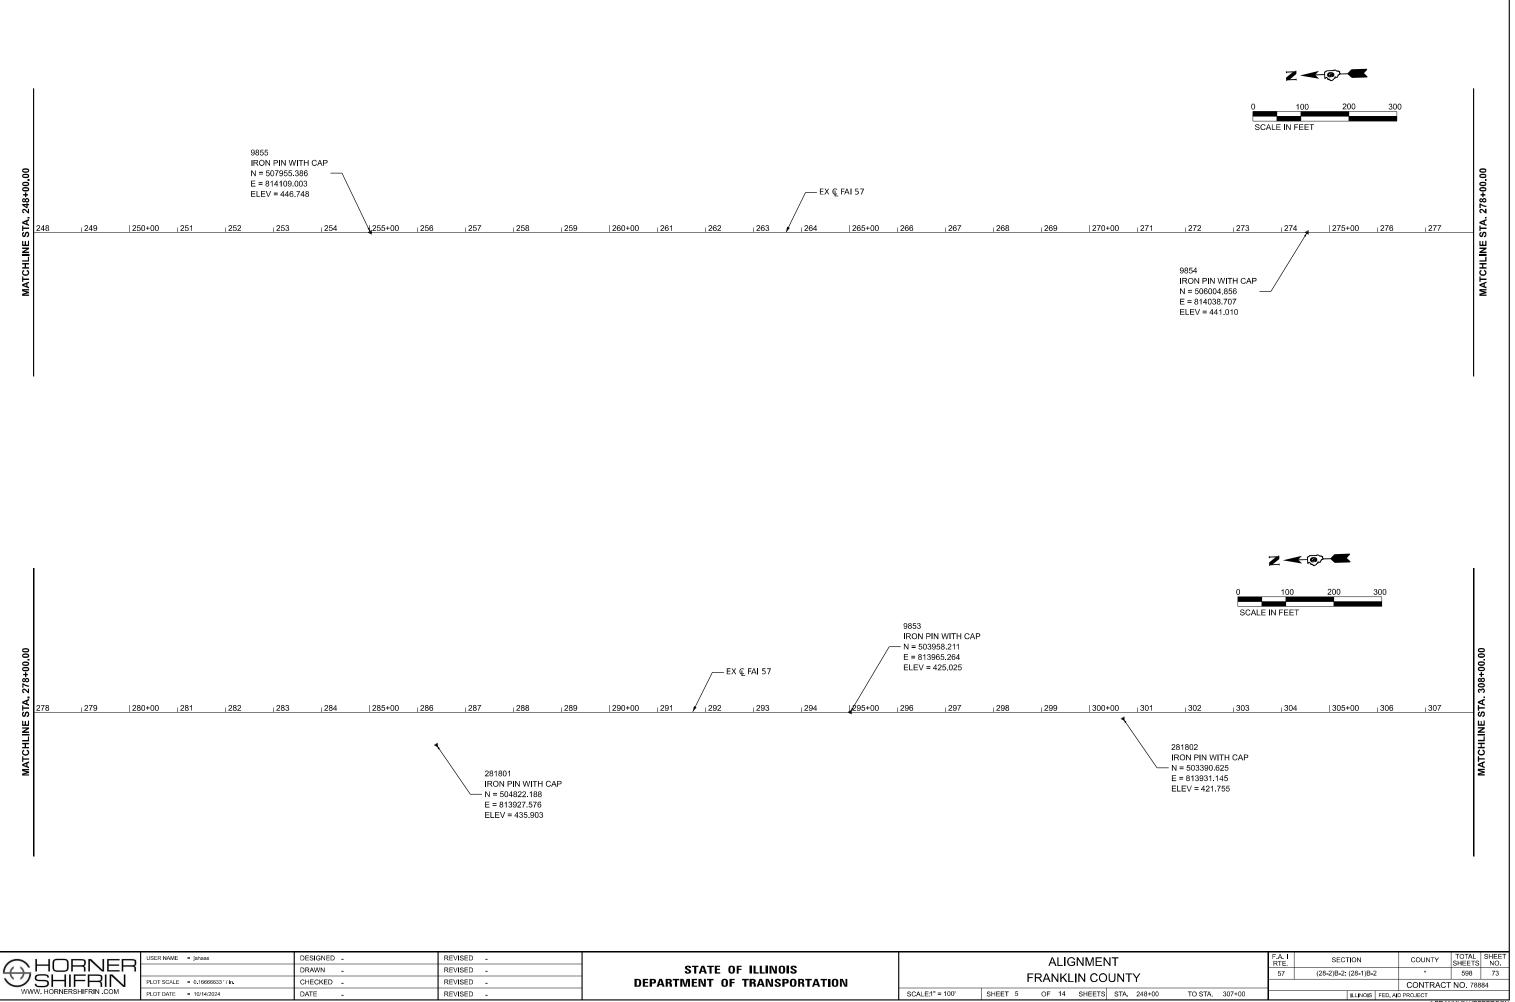

FRANKLIN/JEFFERSON


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	MAI CITLINE SIA, 308+00.00	1309	310+00	<u>1</u> 311	₁ 312	1313	1314	315+00	1316	317	1318	1319	320+00	1 <mark>321</mark>	1322	EX 0	£ FAI 57 _ ₁ 324	325+0	0 ₁ 326	₁ 327	1328	₁ 329	33
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sets/D976884-shl-ATB-alignment.dgn	00.00+												<u>ر</u> — ΕΧ ዊ	FAI 57				PI STA 355+02.96					
V//2106102-457-3rdLanePh2/CAD_She	MAI CITLINE SIA. 338+00.00	1339	340+00	_1341	_ 342	₁ 343	₁ 344	345+00	1346	₁ 347	₁ 348	₁ 349	350+00	₁ 351	₁ 352	₁ 353	<u>∣</u> 354	<u>355+0</u>	3 ₁ 356	357	<u> </u> 358	359	3
uments/210610000-PTB198-034	2																	EQN: STA 355+00.00 BK = STA 355+02.96 AH					
ANKLINA - Franklinklighmener 10 (Sheet) w/PW01 homershiftin.com:HS EDT/Doc									1									EQI STA	1				
MODEL: 157FR FILE NAME: p	7SH	DRNE		ME = jahaas ALE = 0.1666663 TE = 10/14/2024		DR.	SIGNED - AWN - ECKED - TE -		R	REVISED - REVISED - REVISED - REVISED -			DE	S [.] PARTMI	TATE OI ENT OF	F ILLINO TRANSF	IS PORTATI	ON	SCAL	E:1" = 100'	SHEET 6	ALIG FRANKL OF 14	IN C

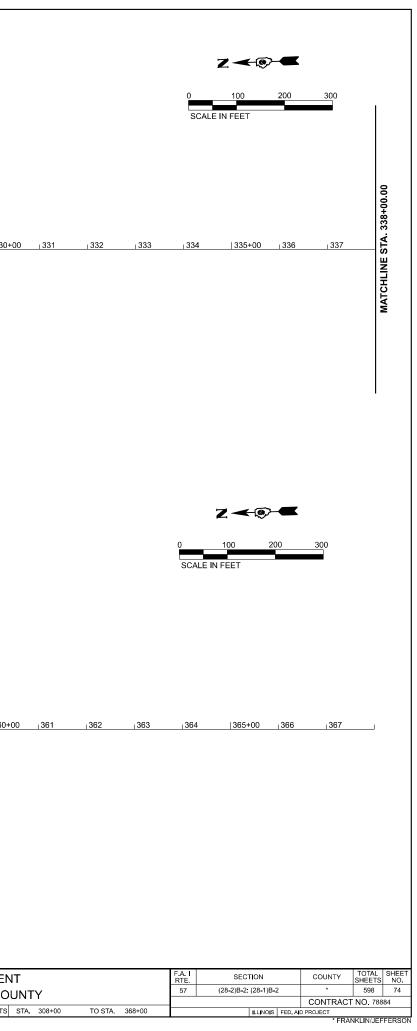

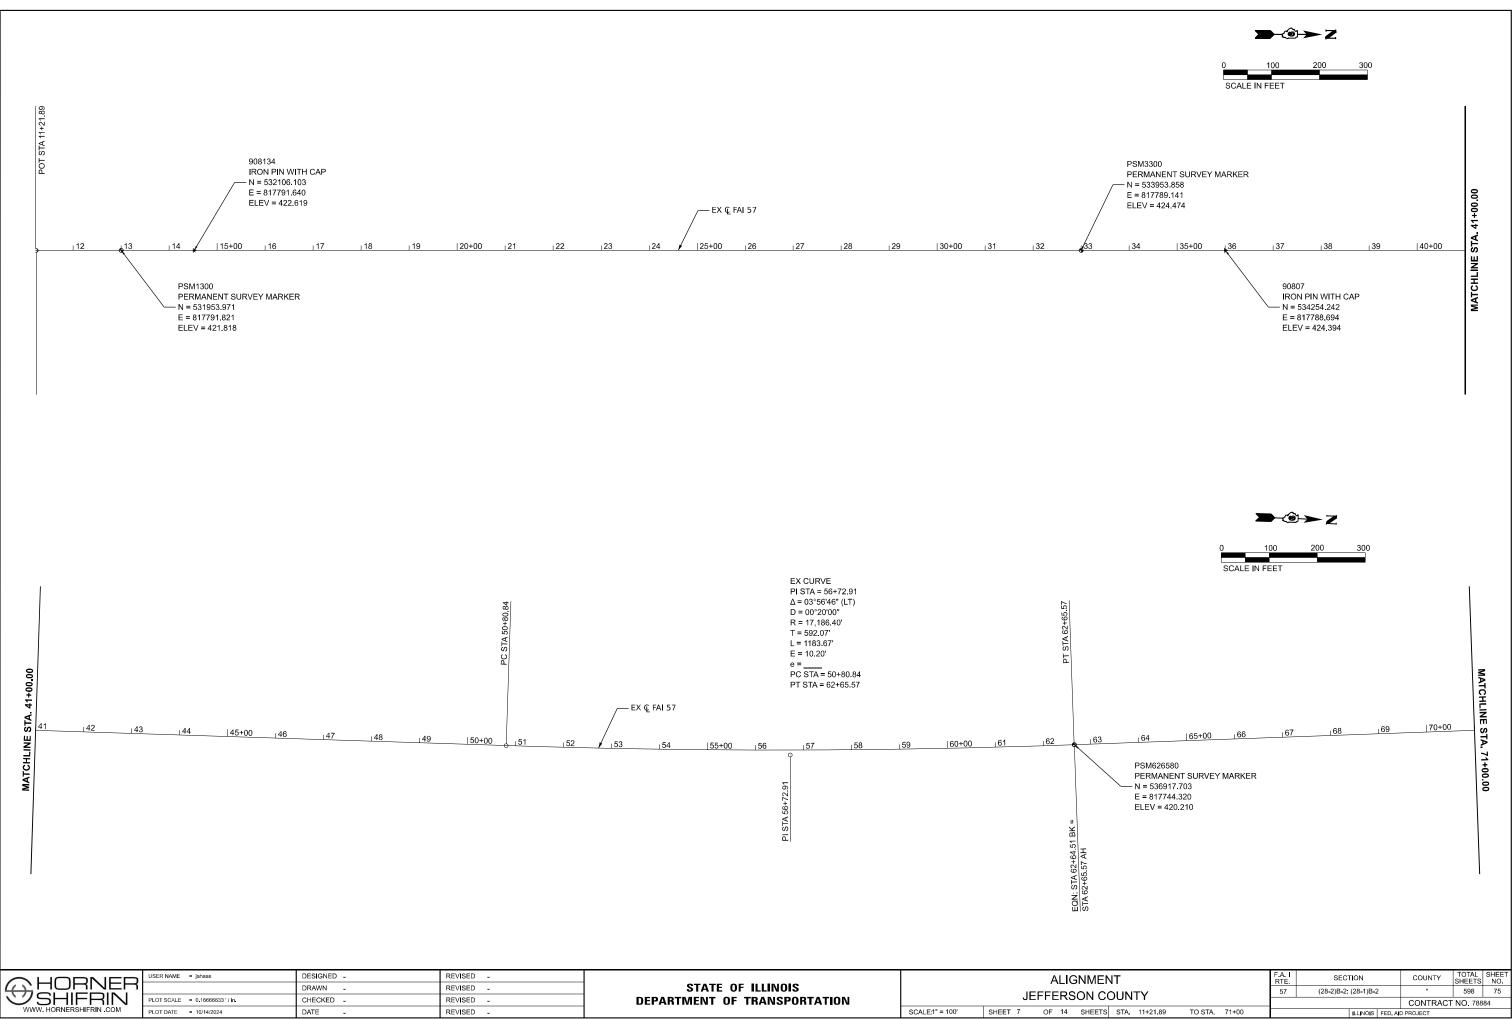


FRANKLIN/JEFFERSON


FRANKLIN/JEFFER

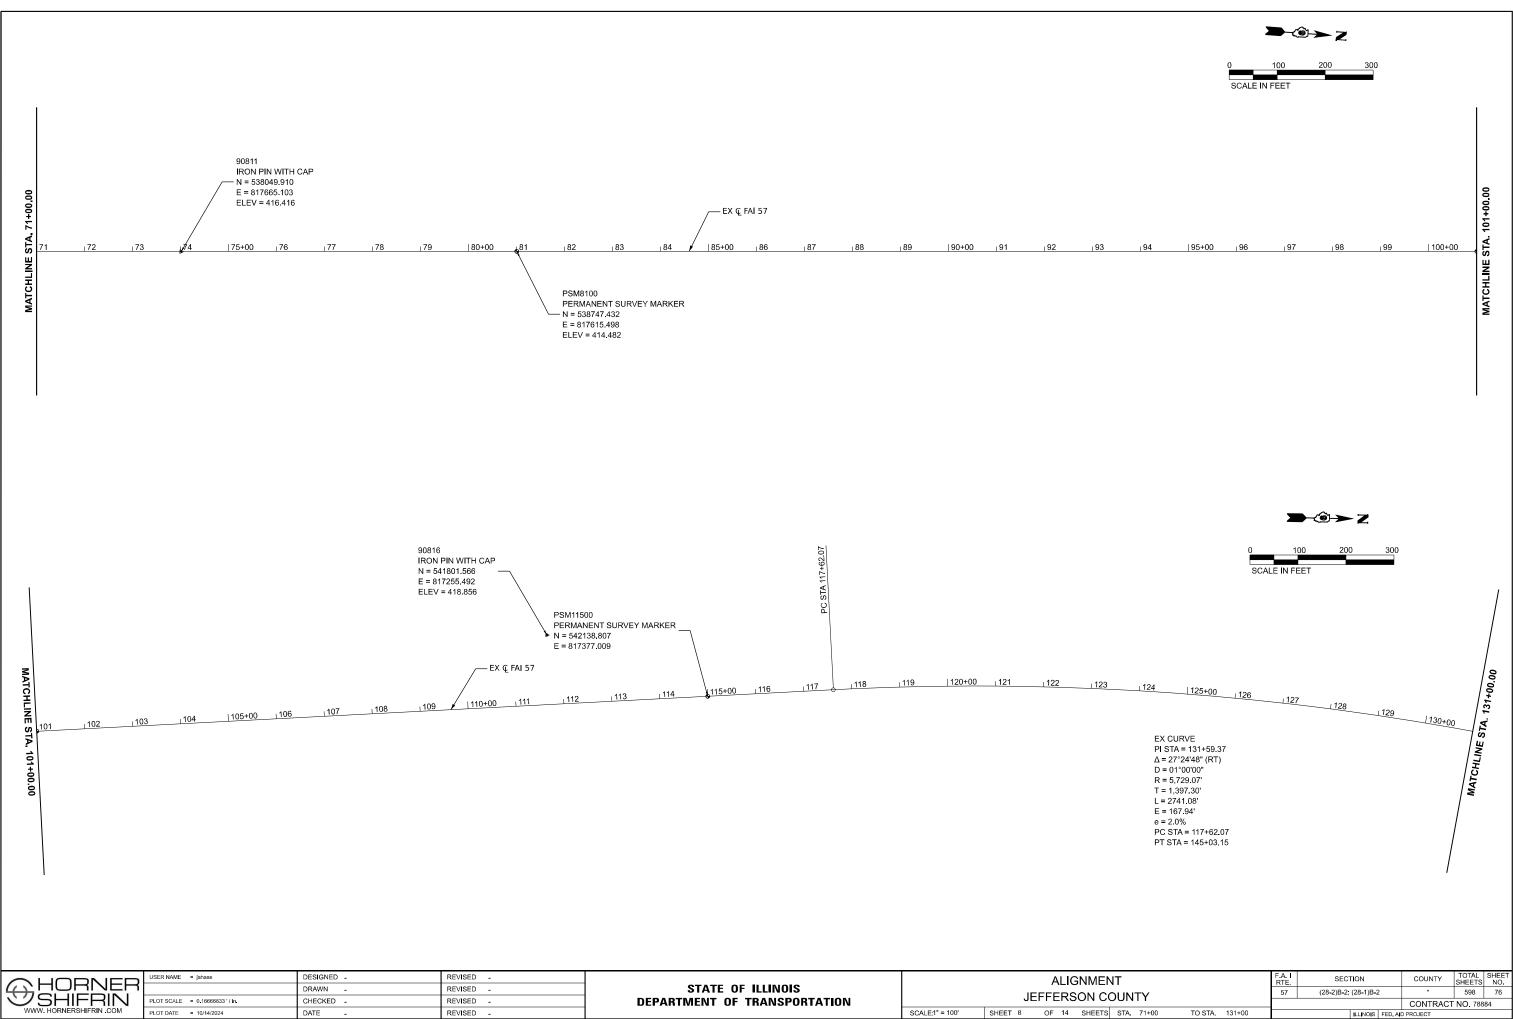


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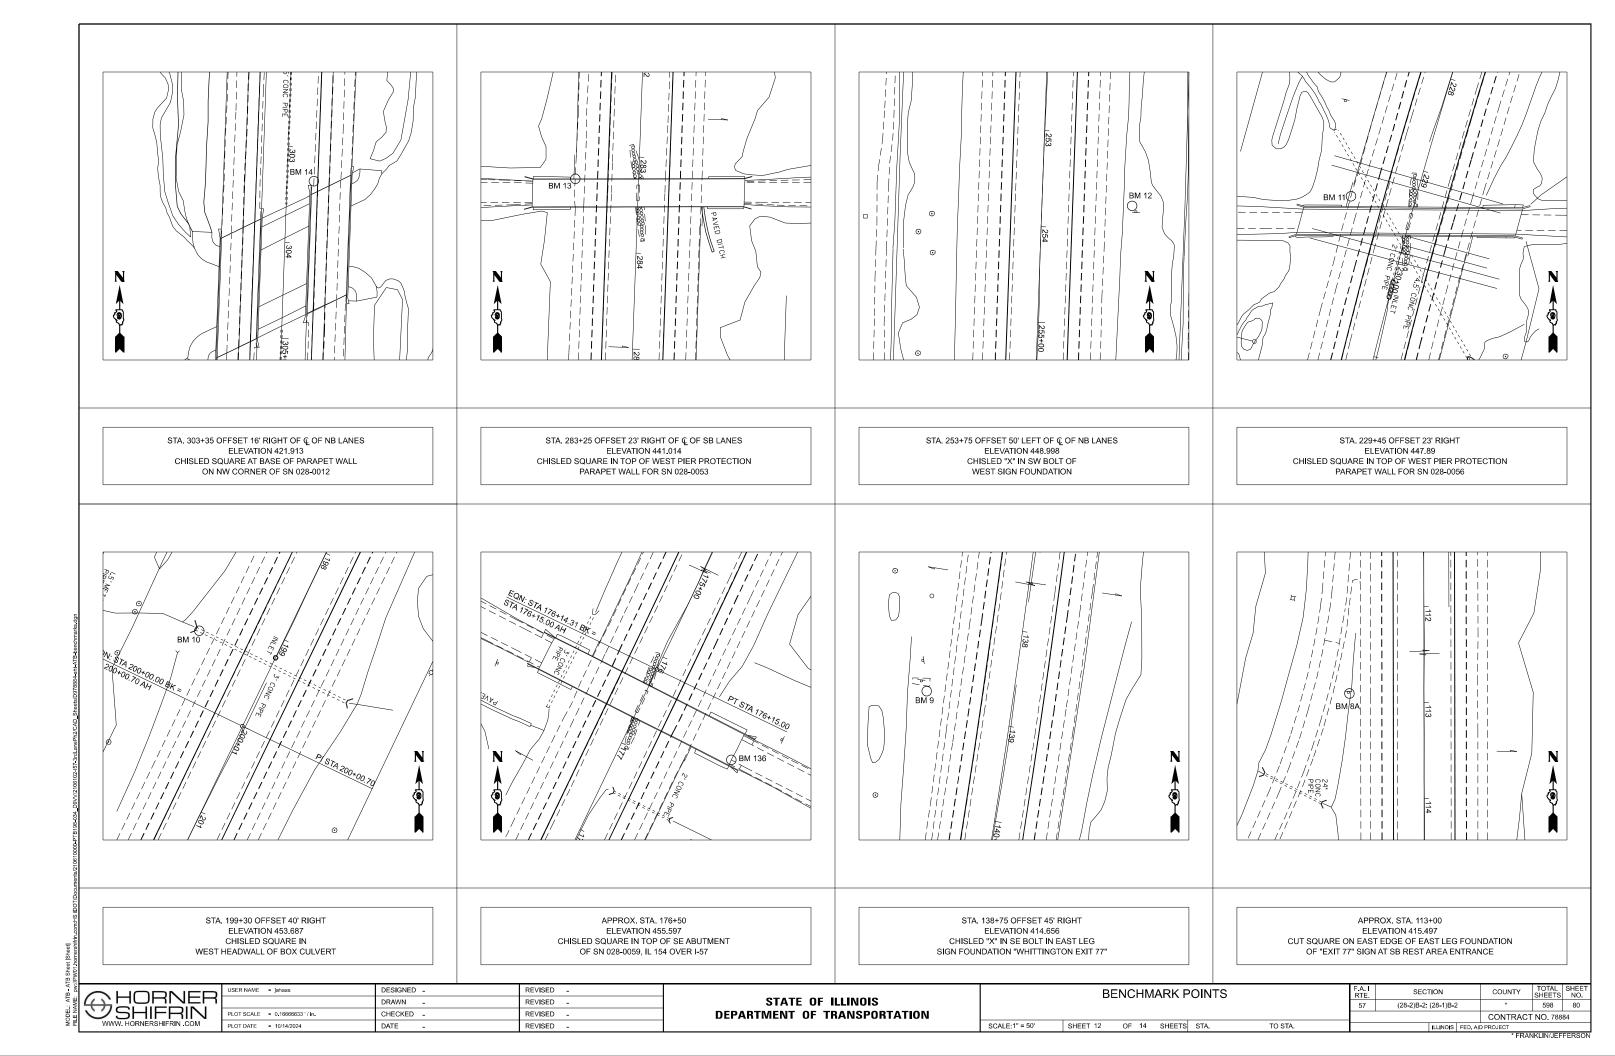
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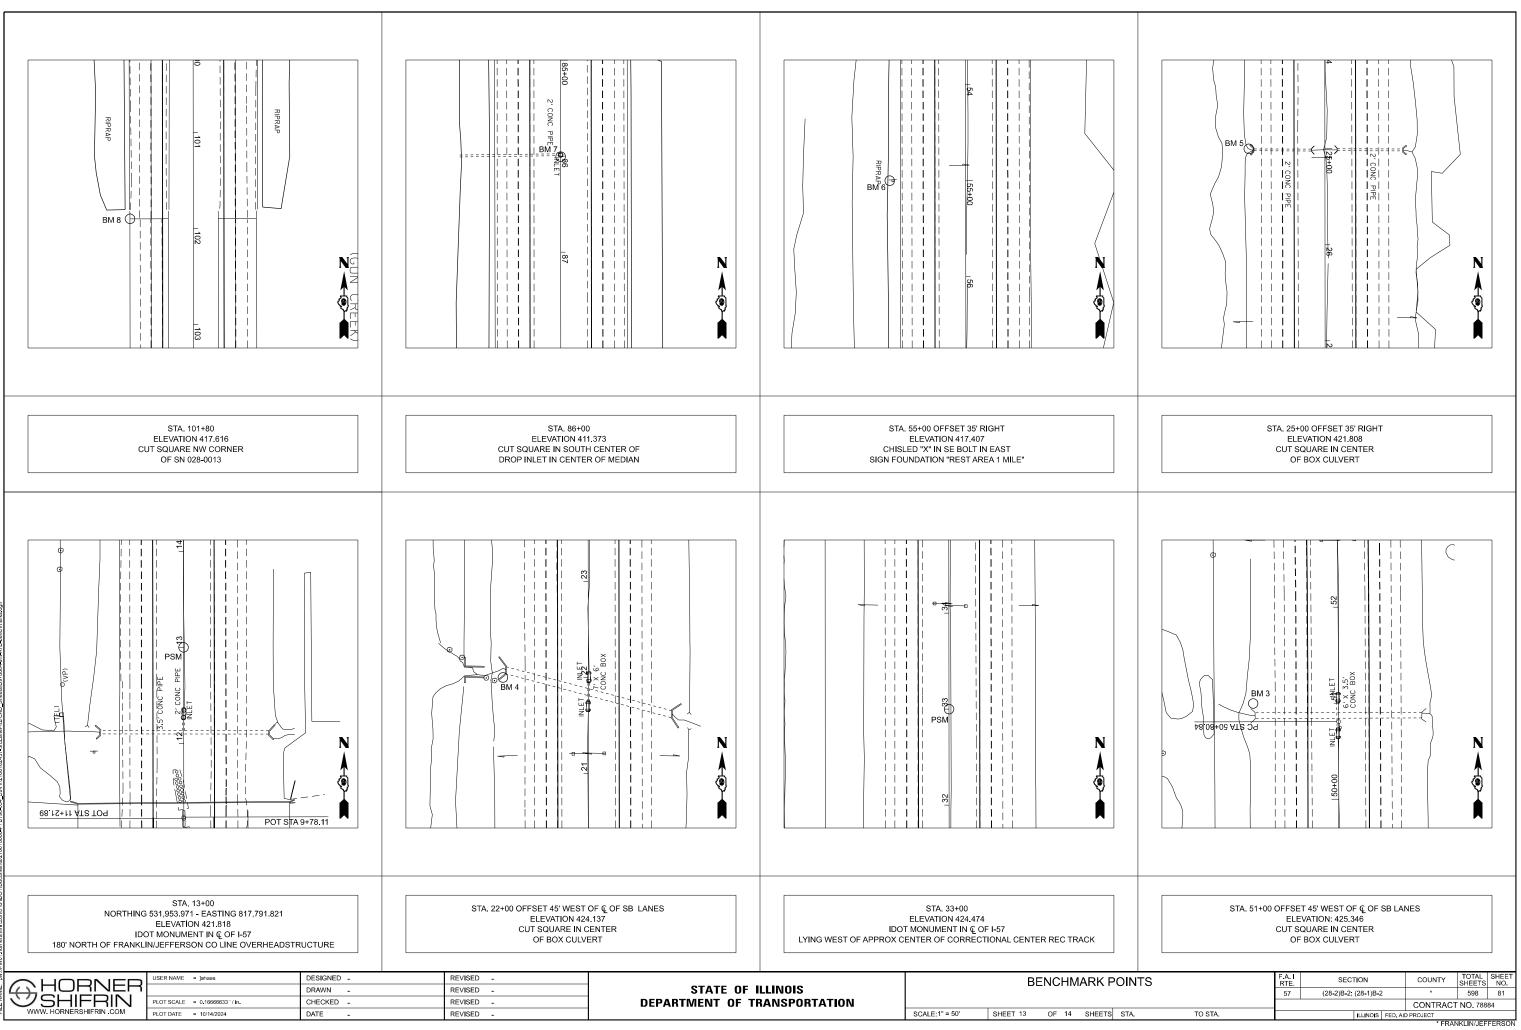


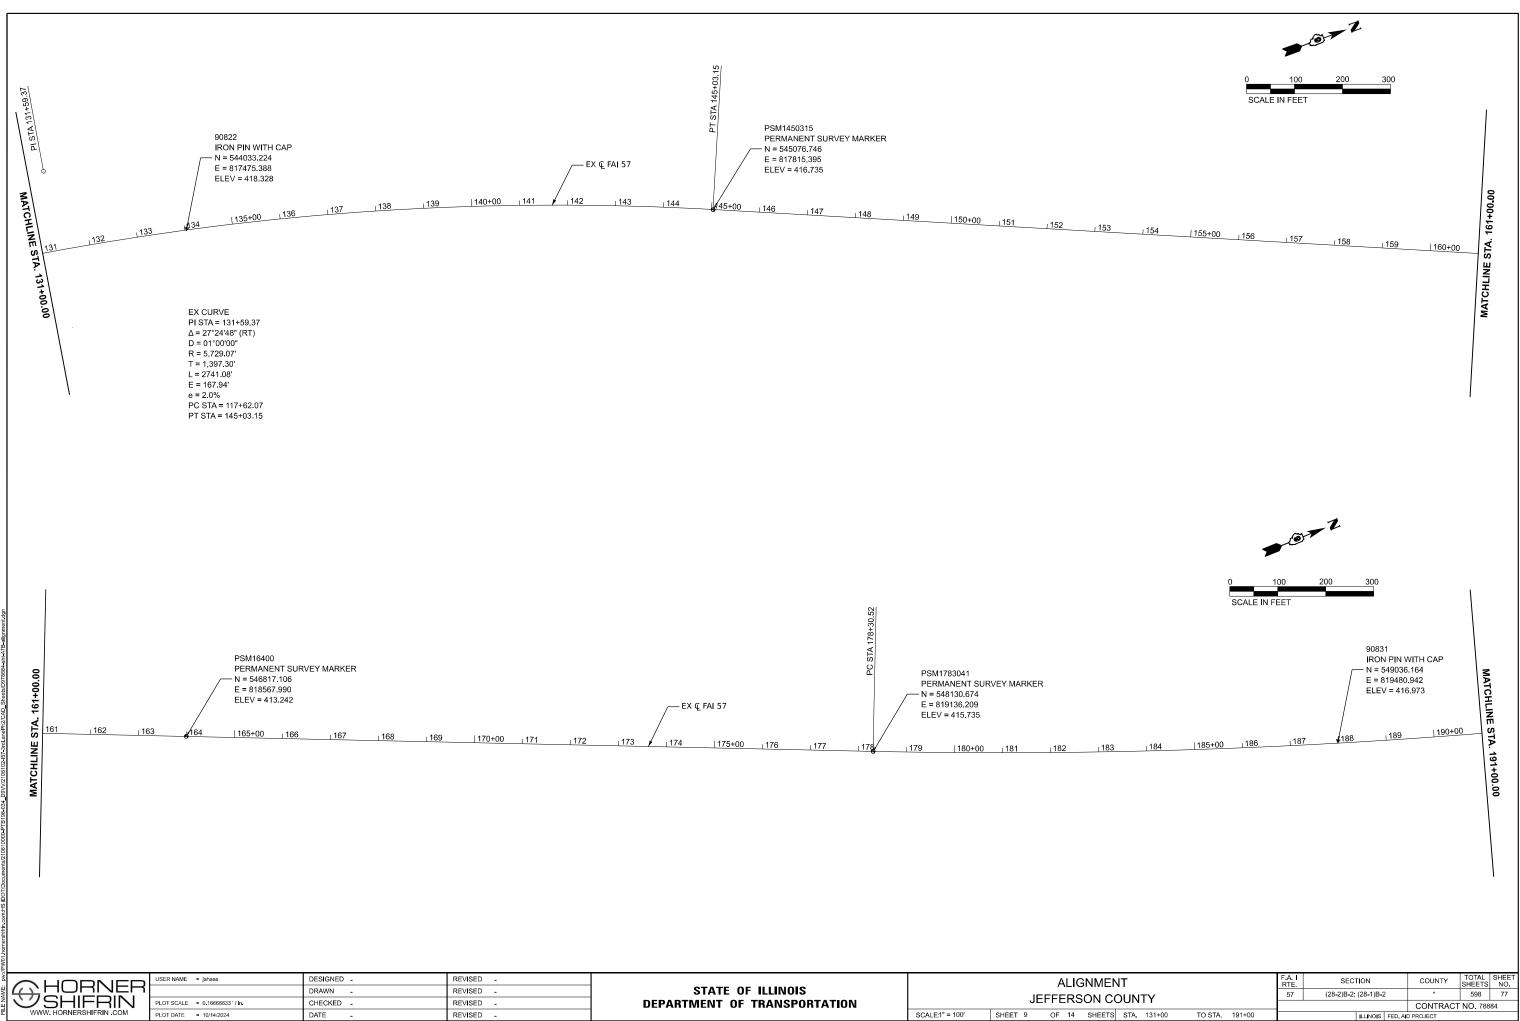FRANKLIN/JEFFERSON

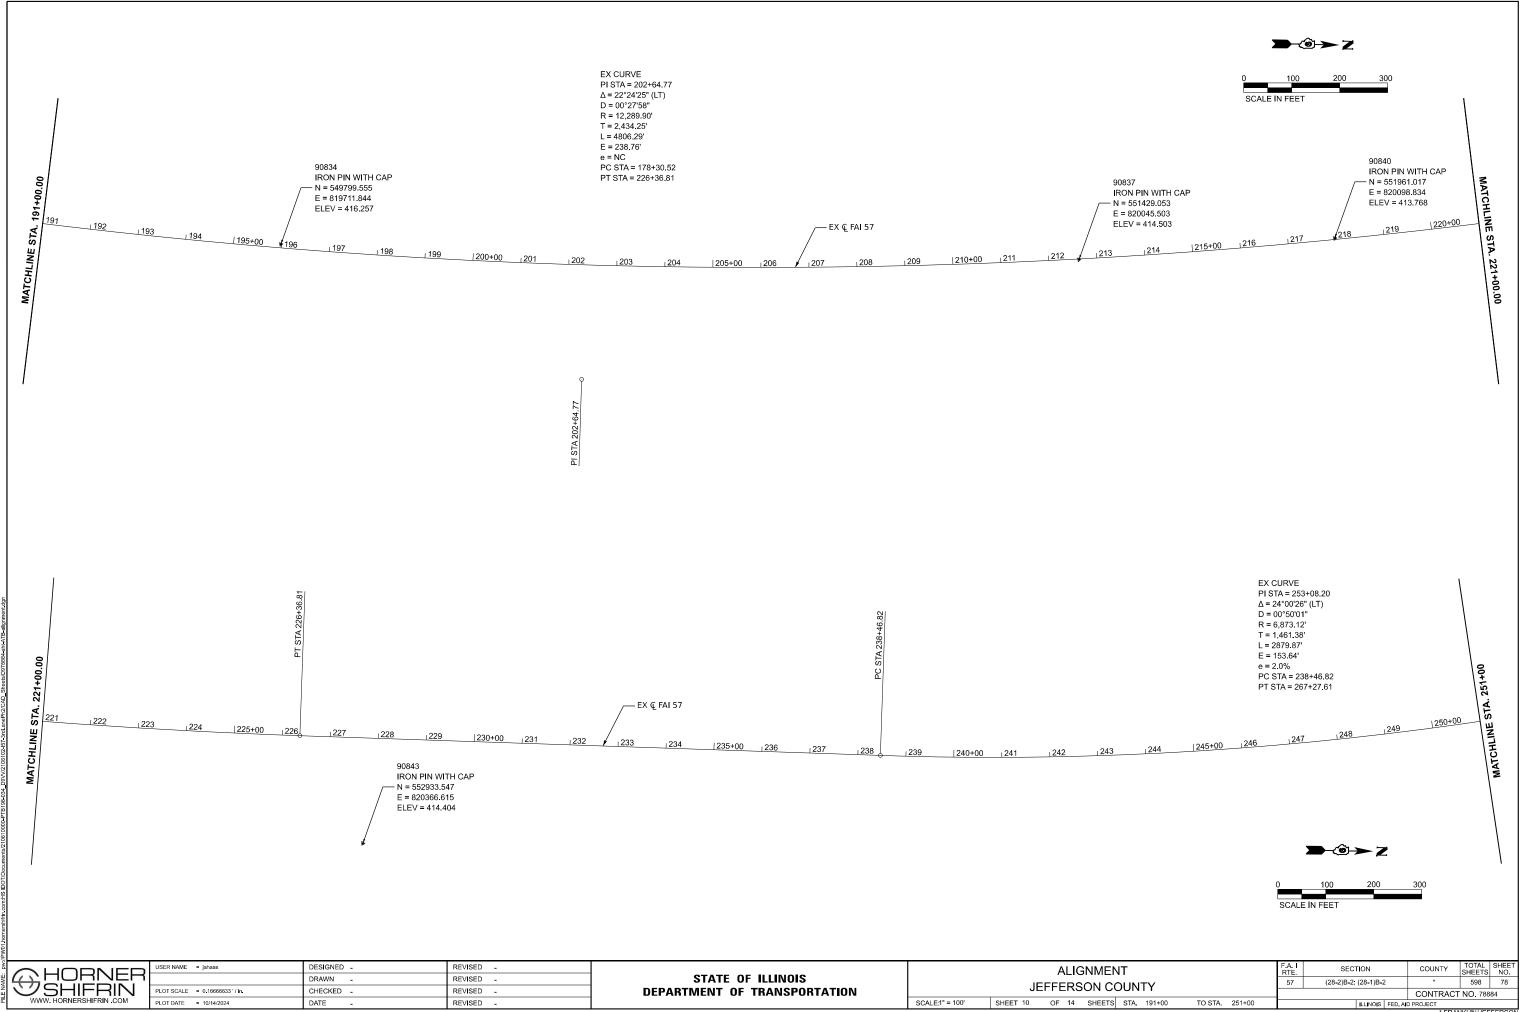



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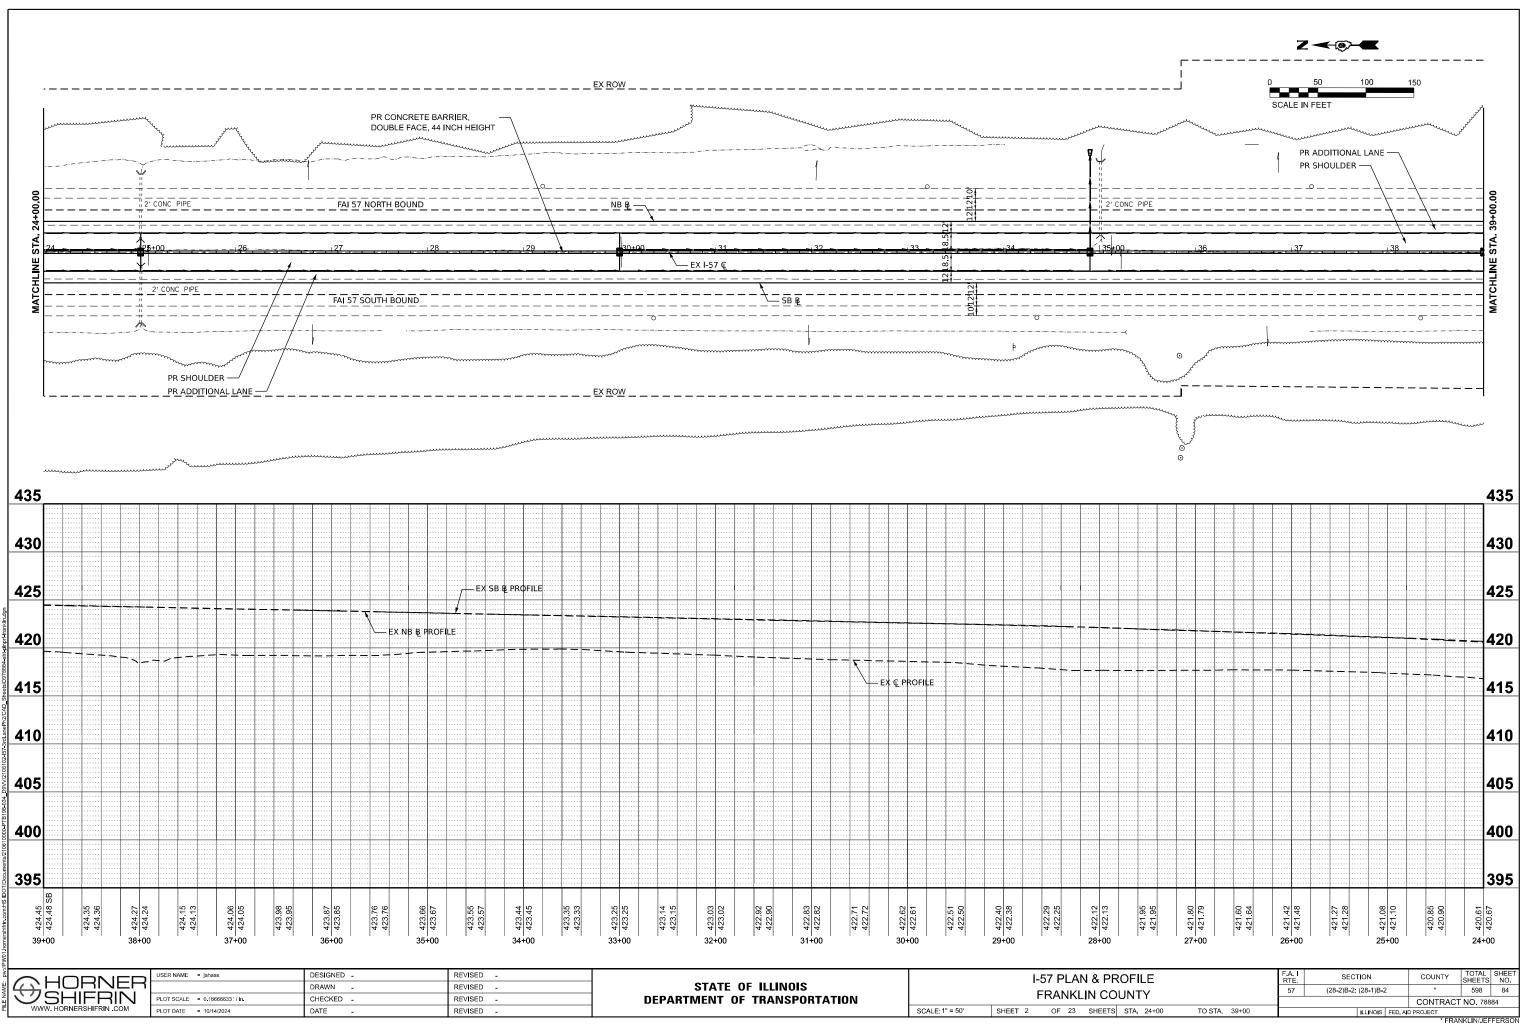


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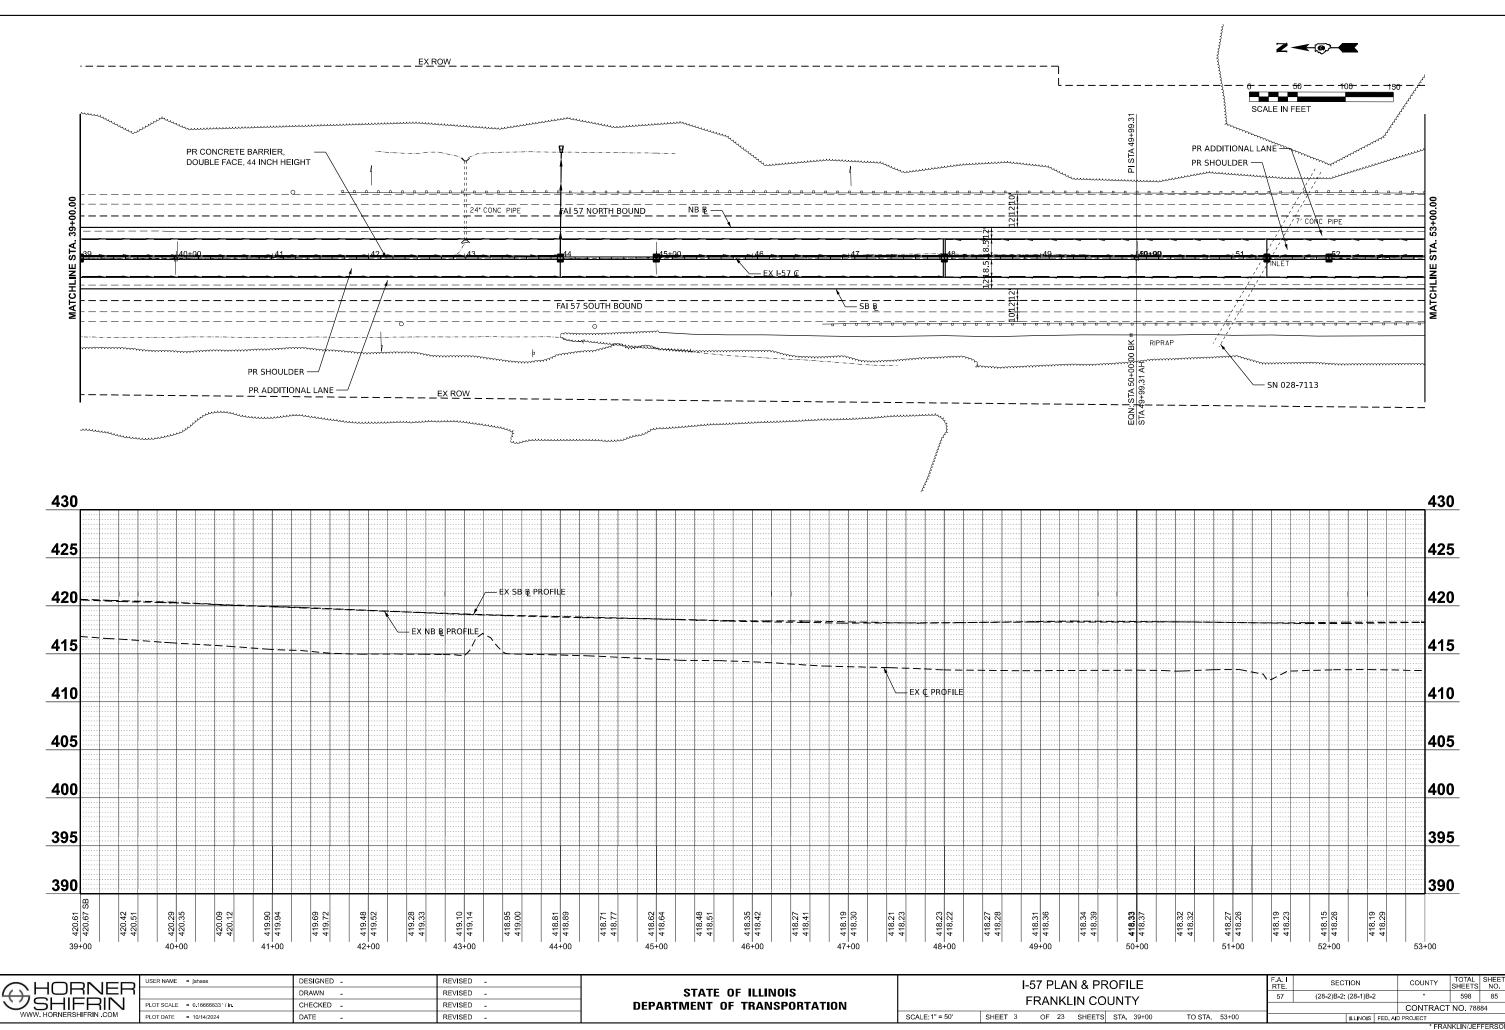


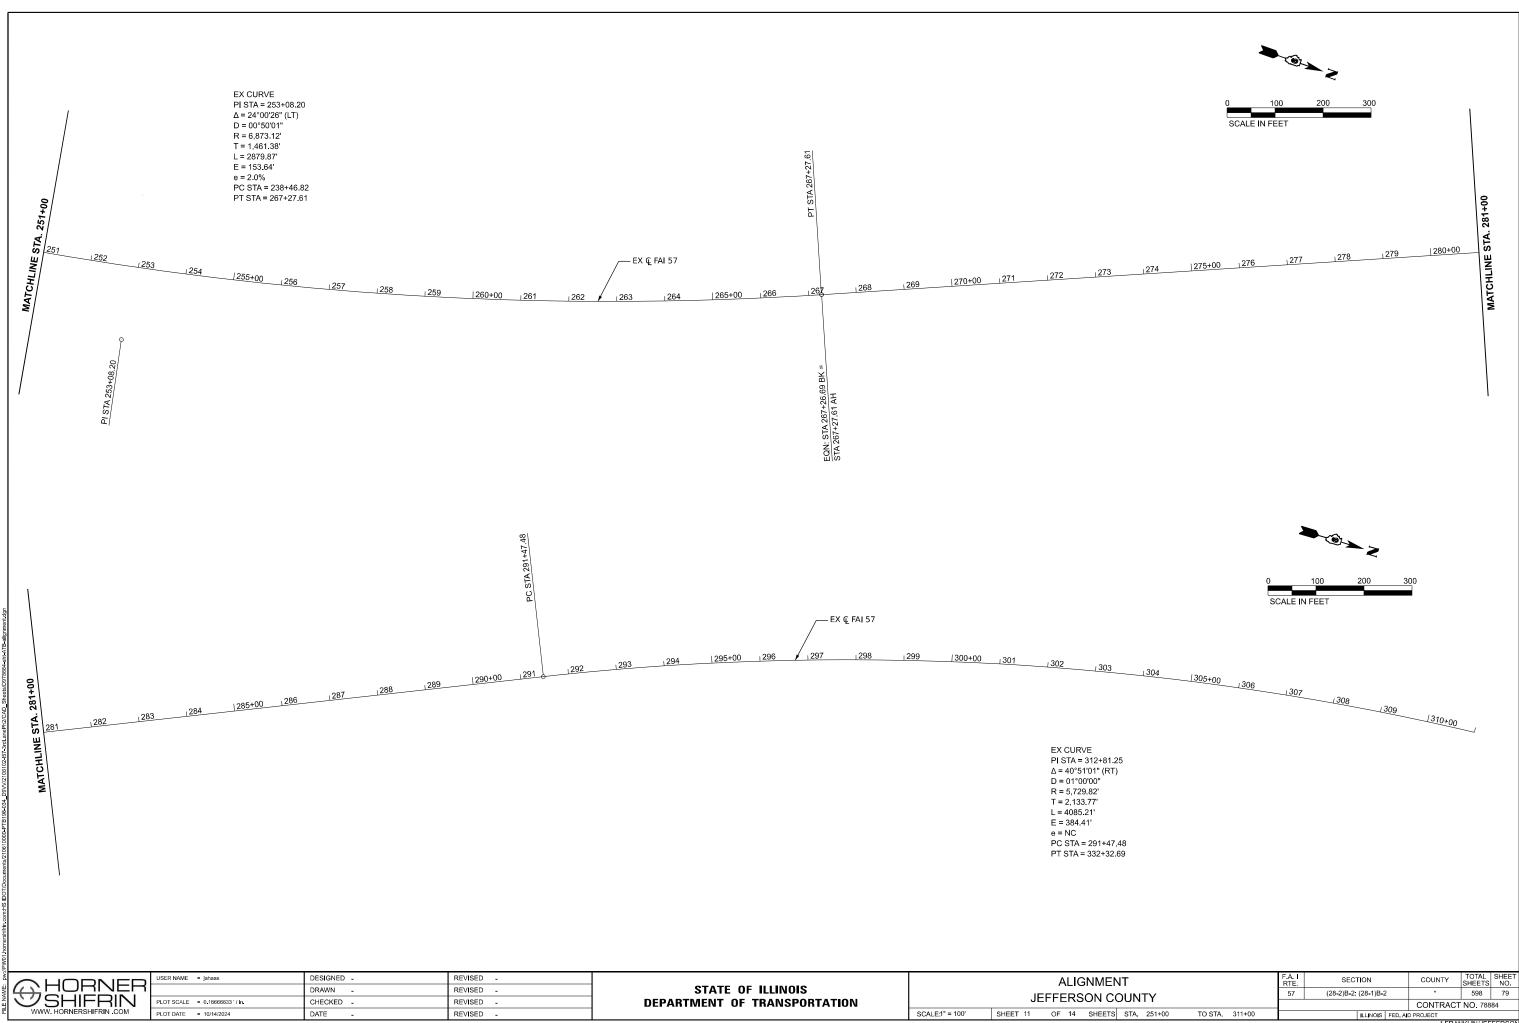



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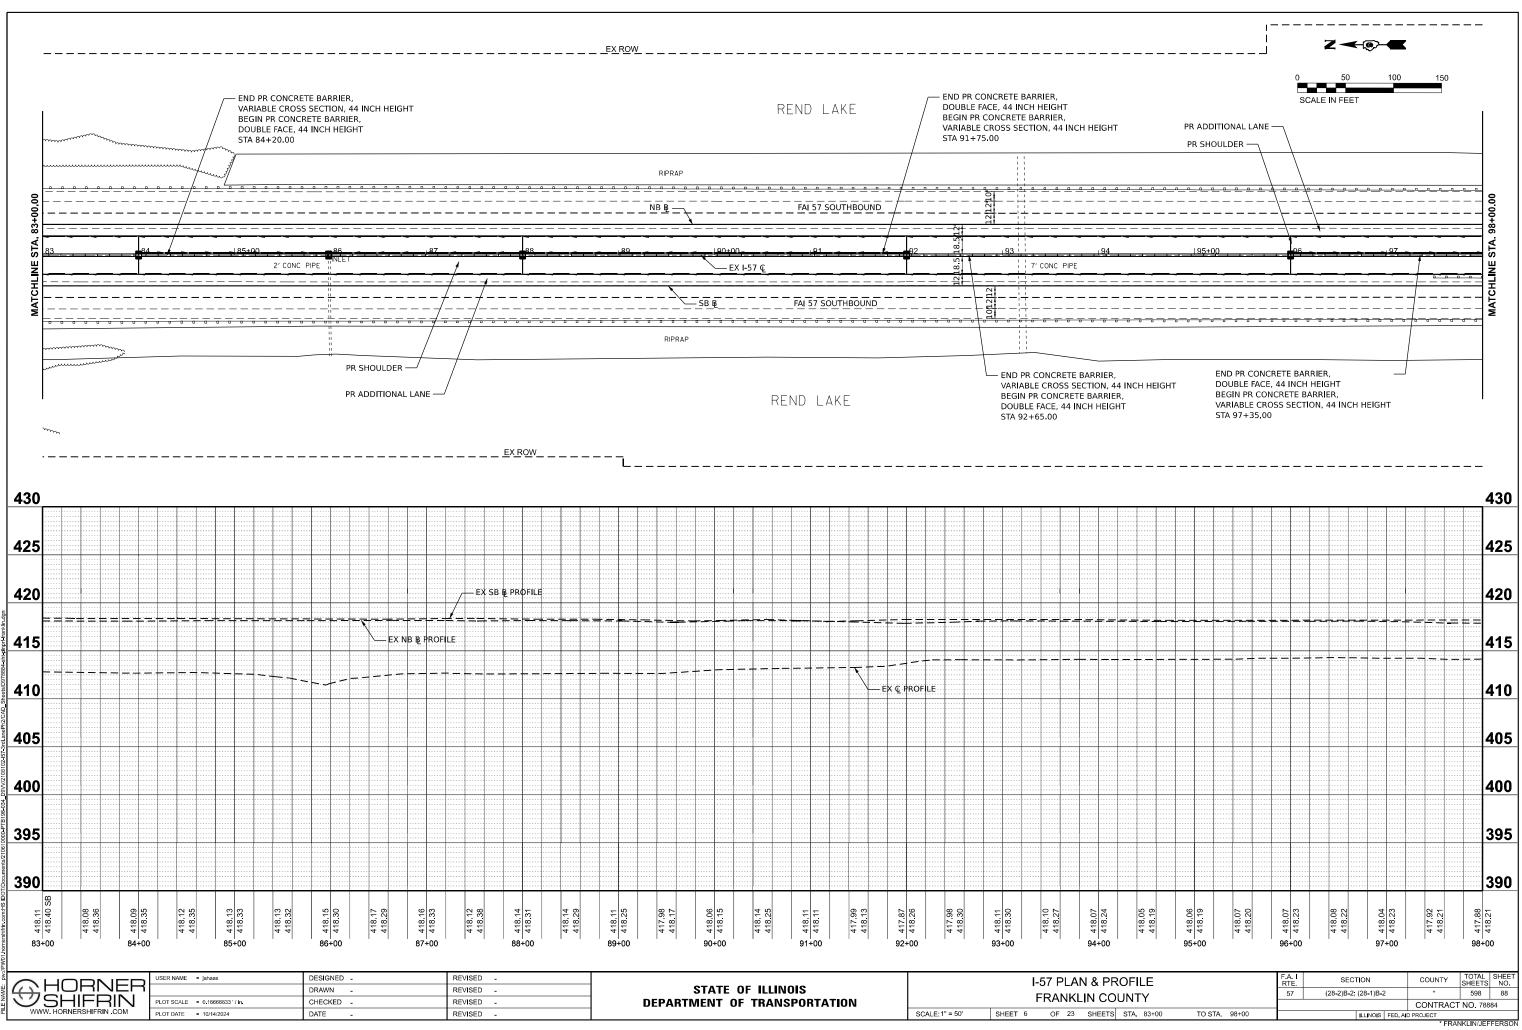
DEL: 157FRANKLINA - 157FRANKLIN-2 (She

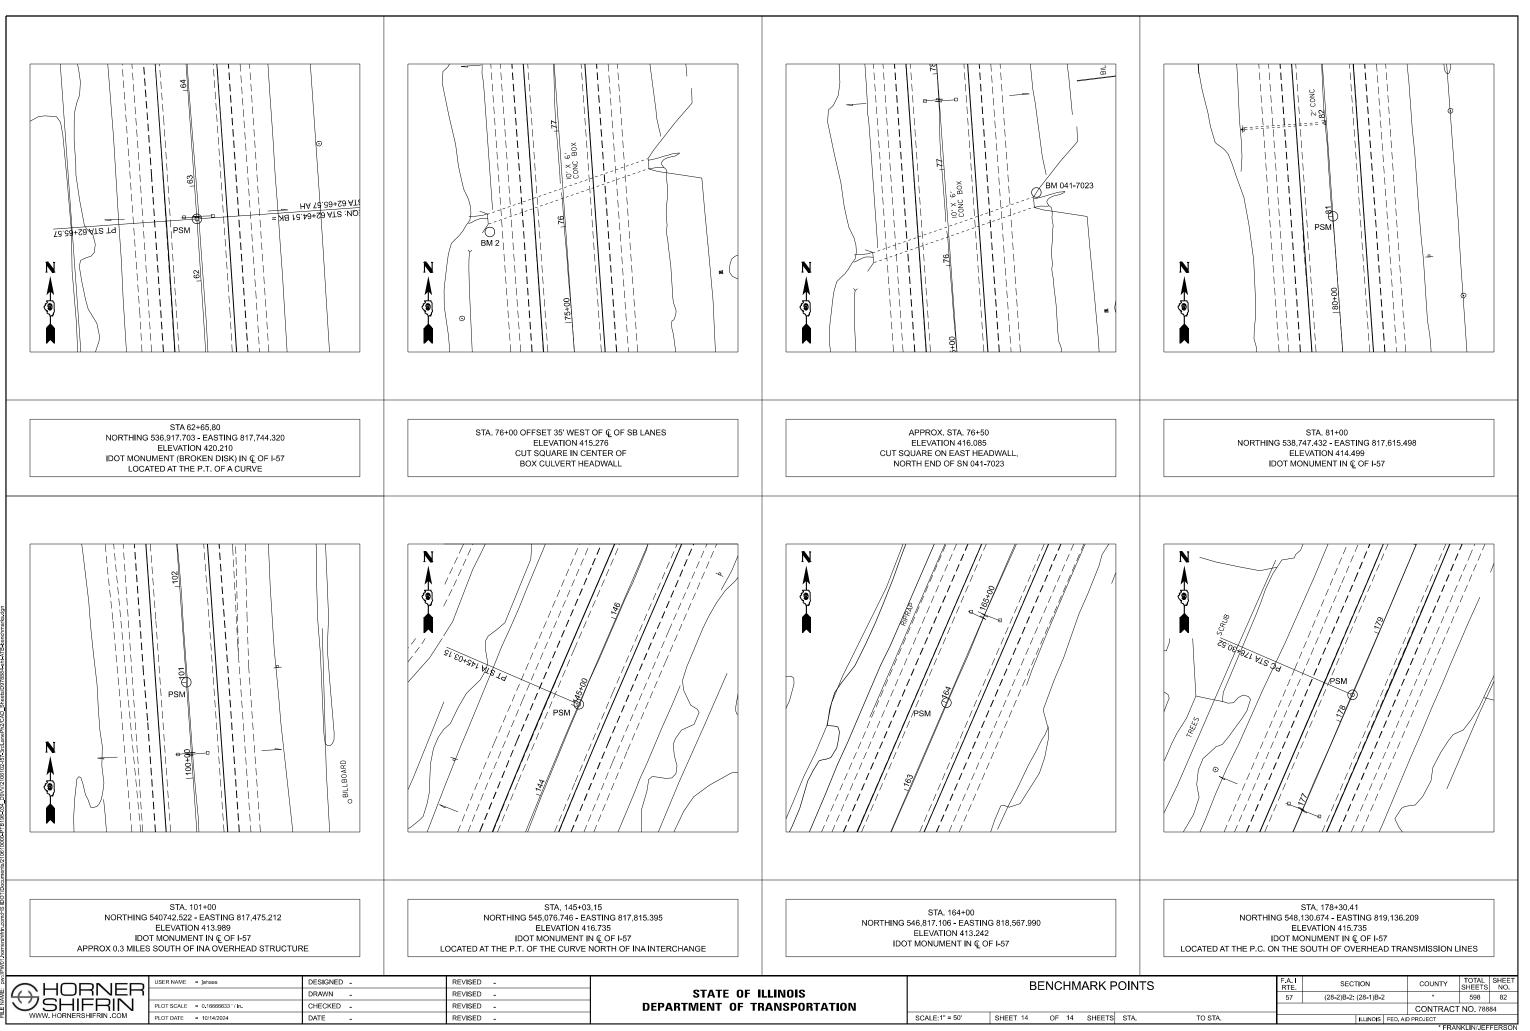

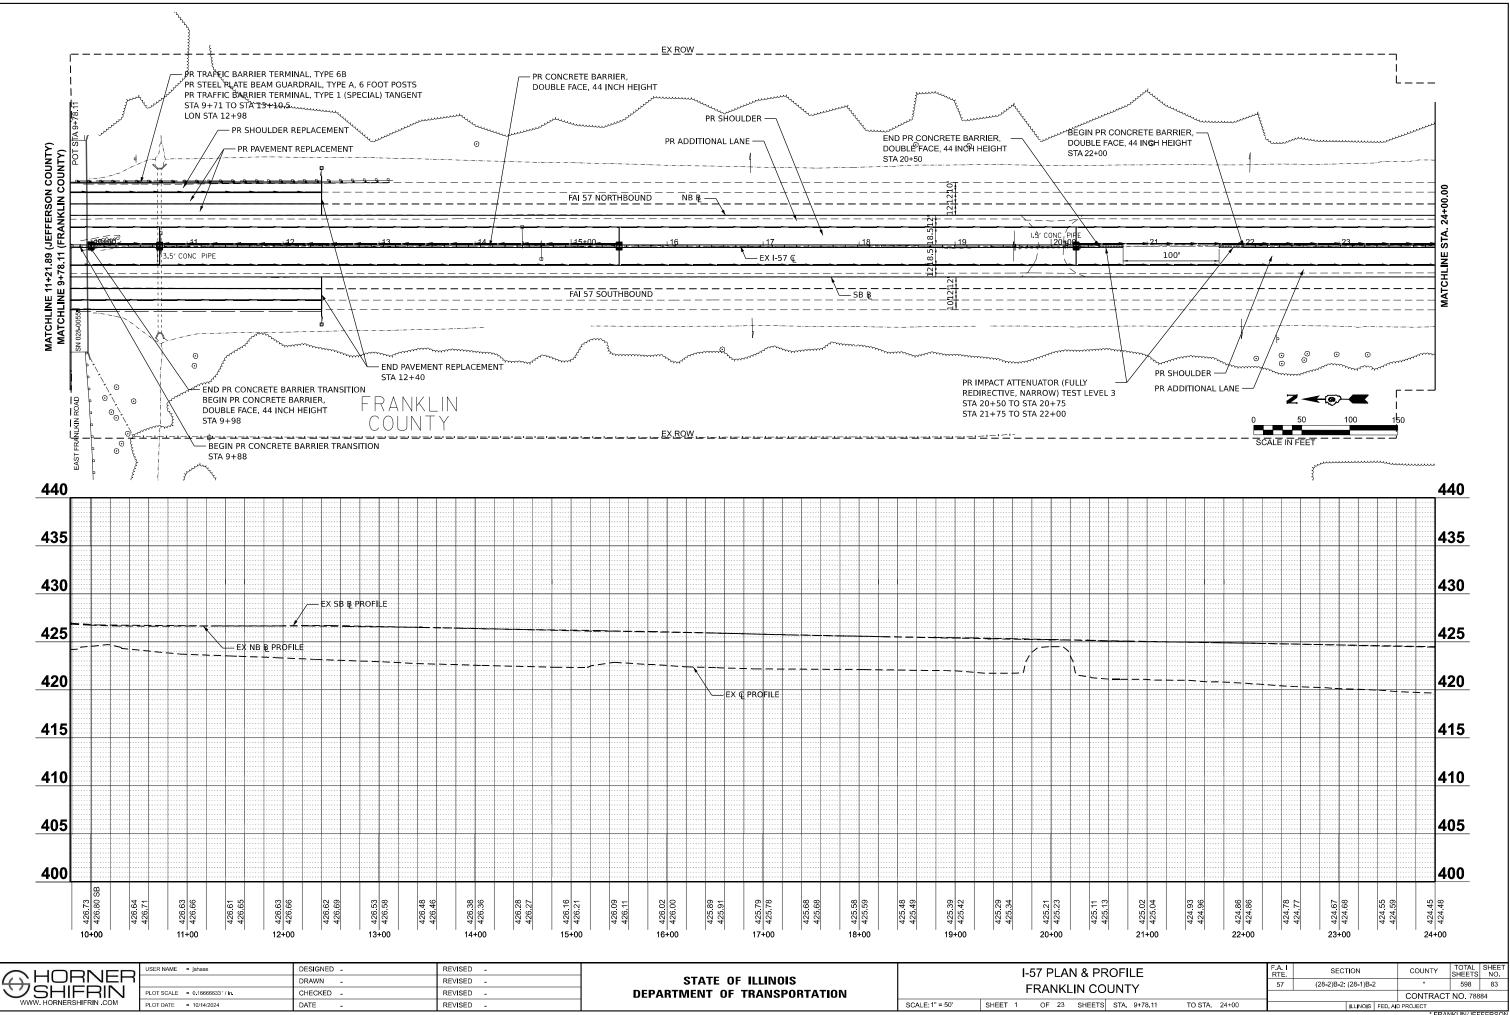


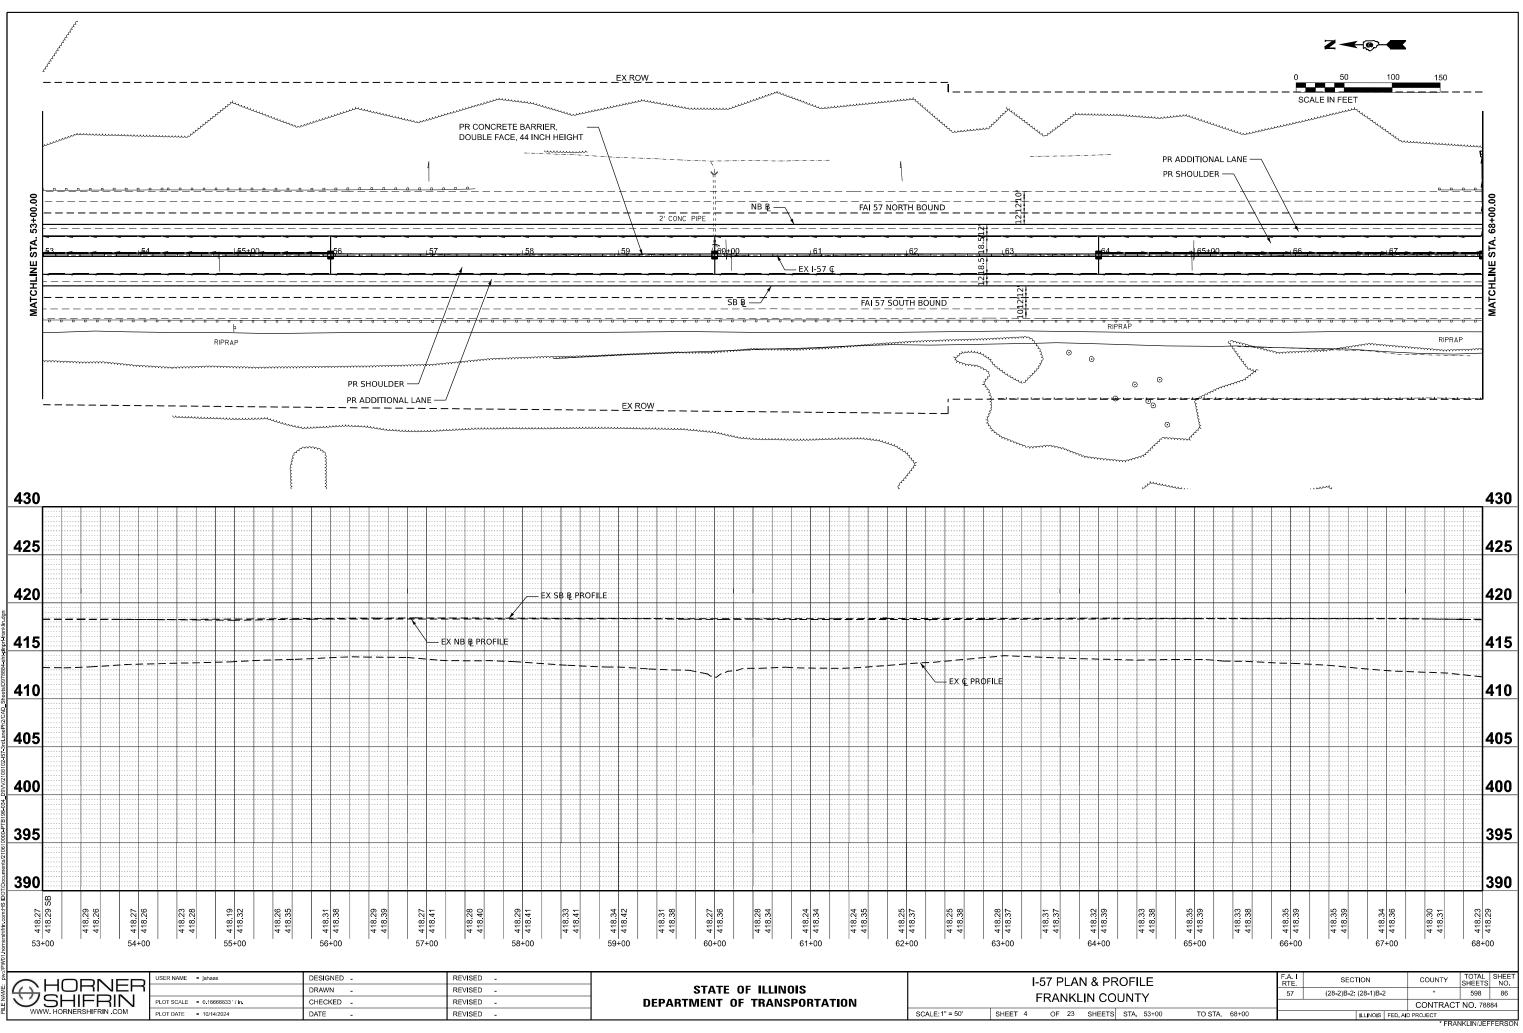


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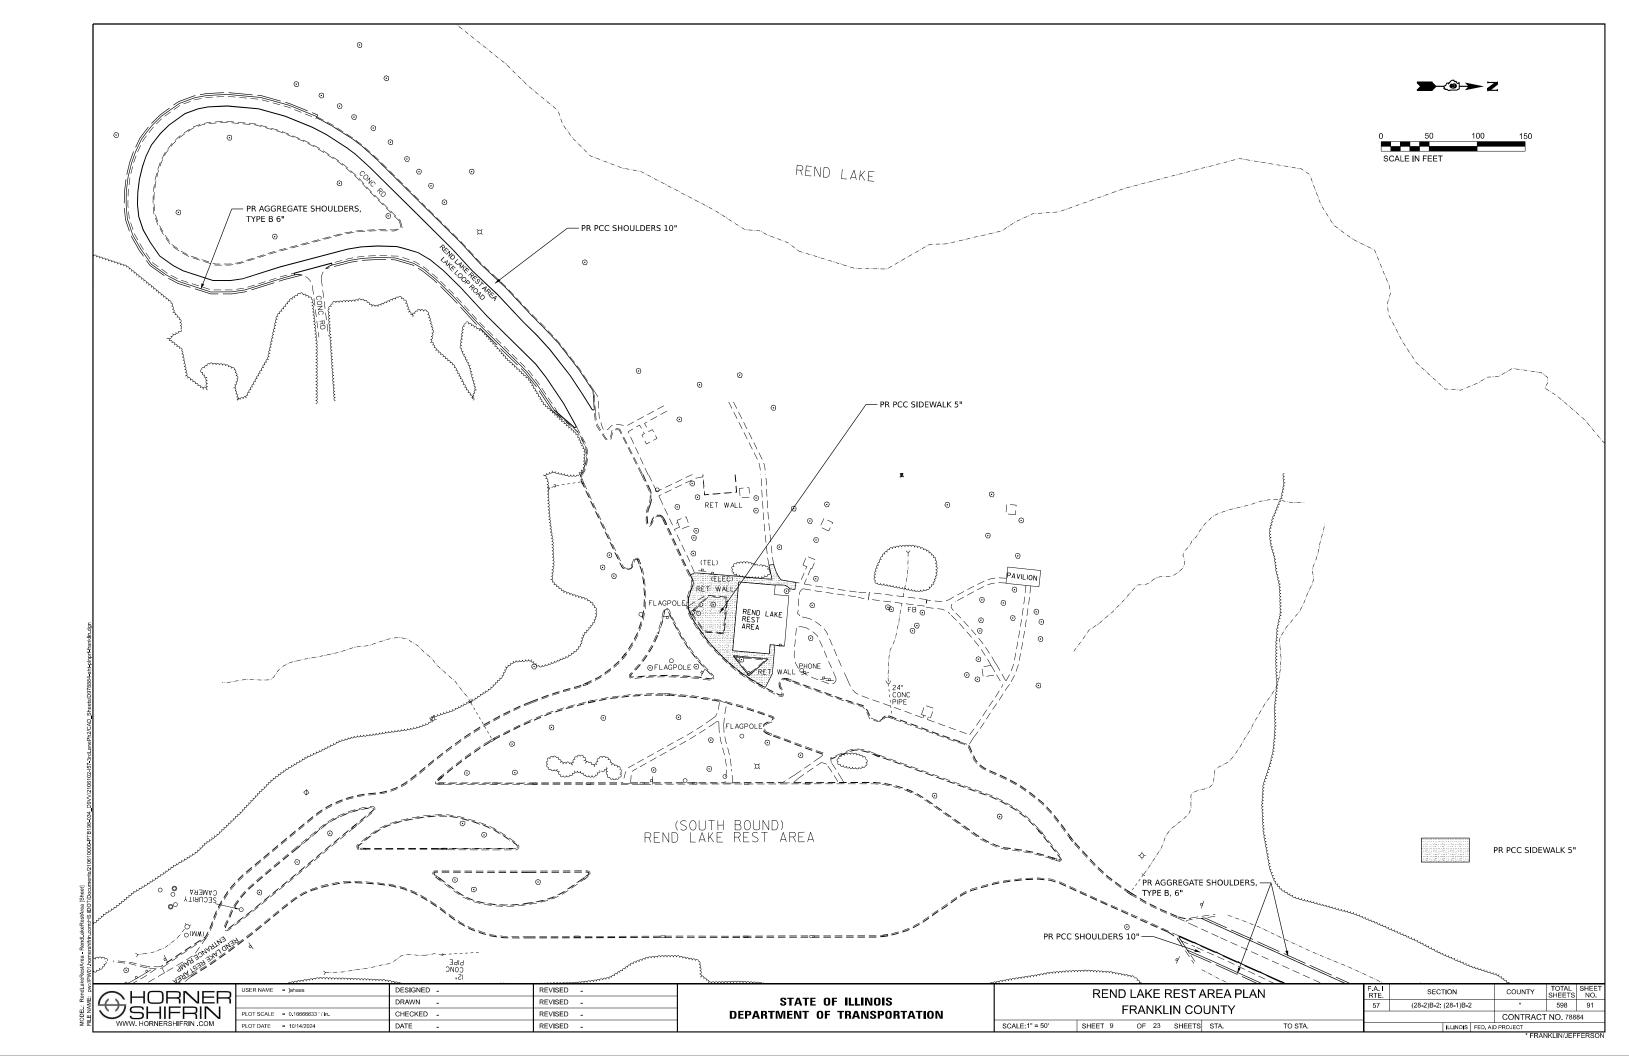


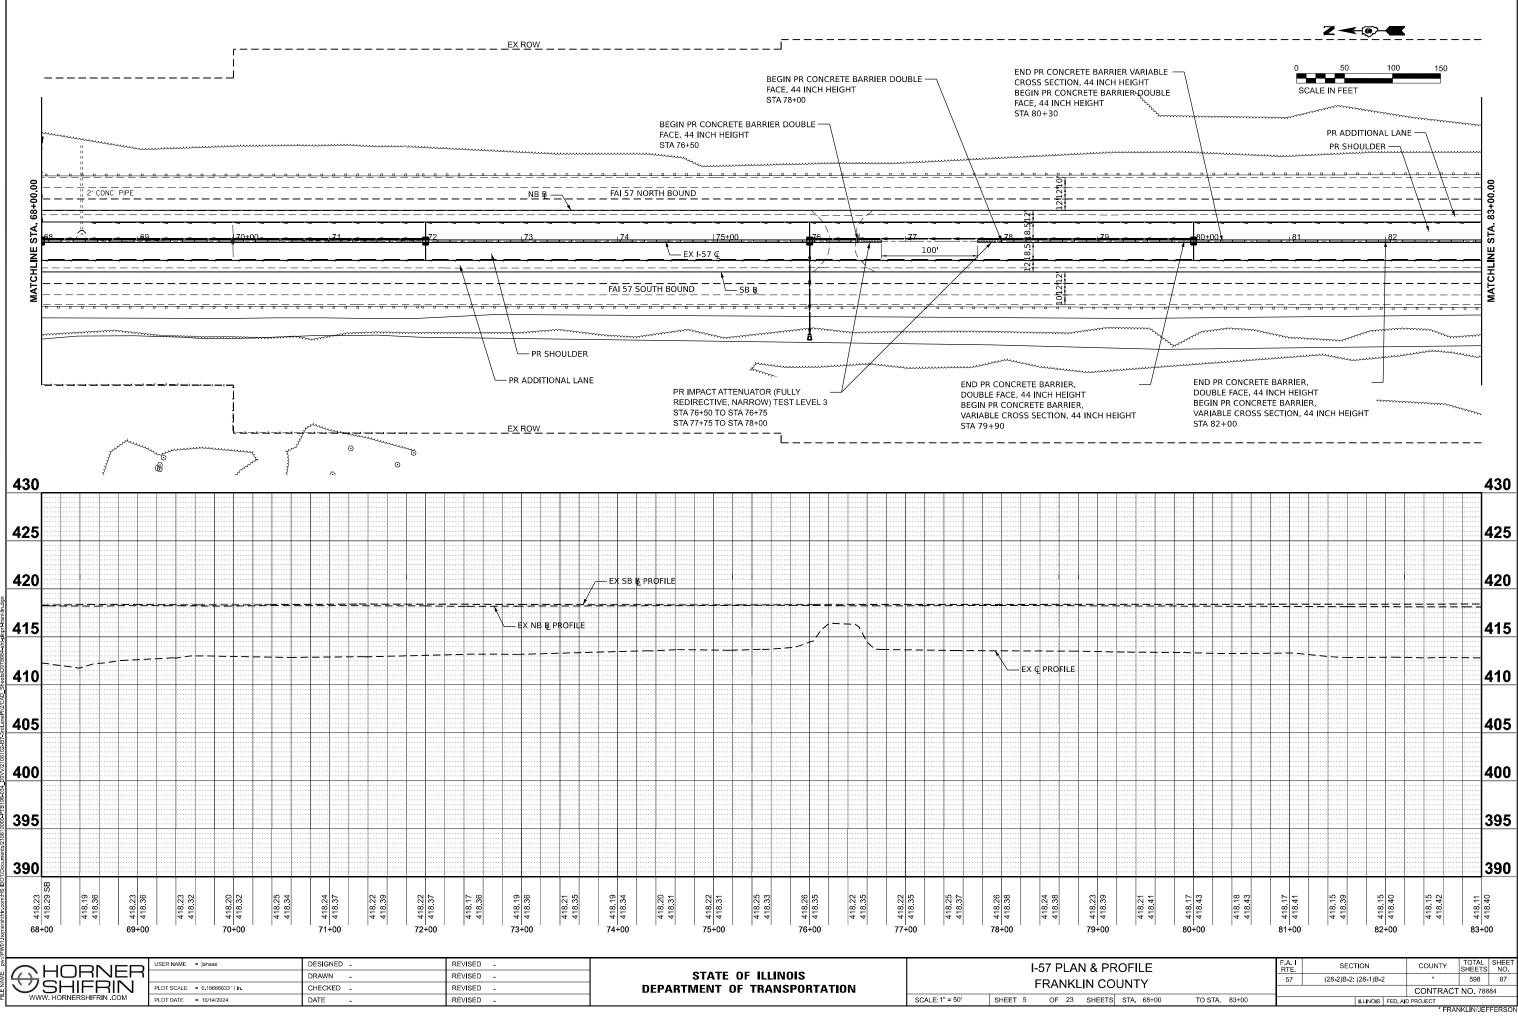
WODEL: I57FRANKLINA - I57FRANKLIN-6 (She



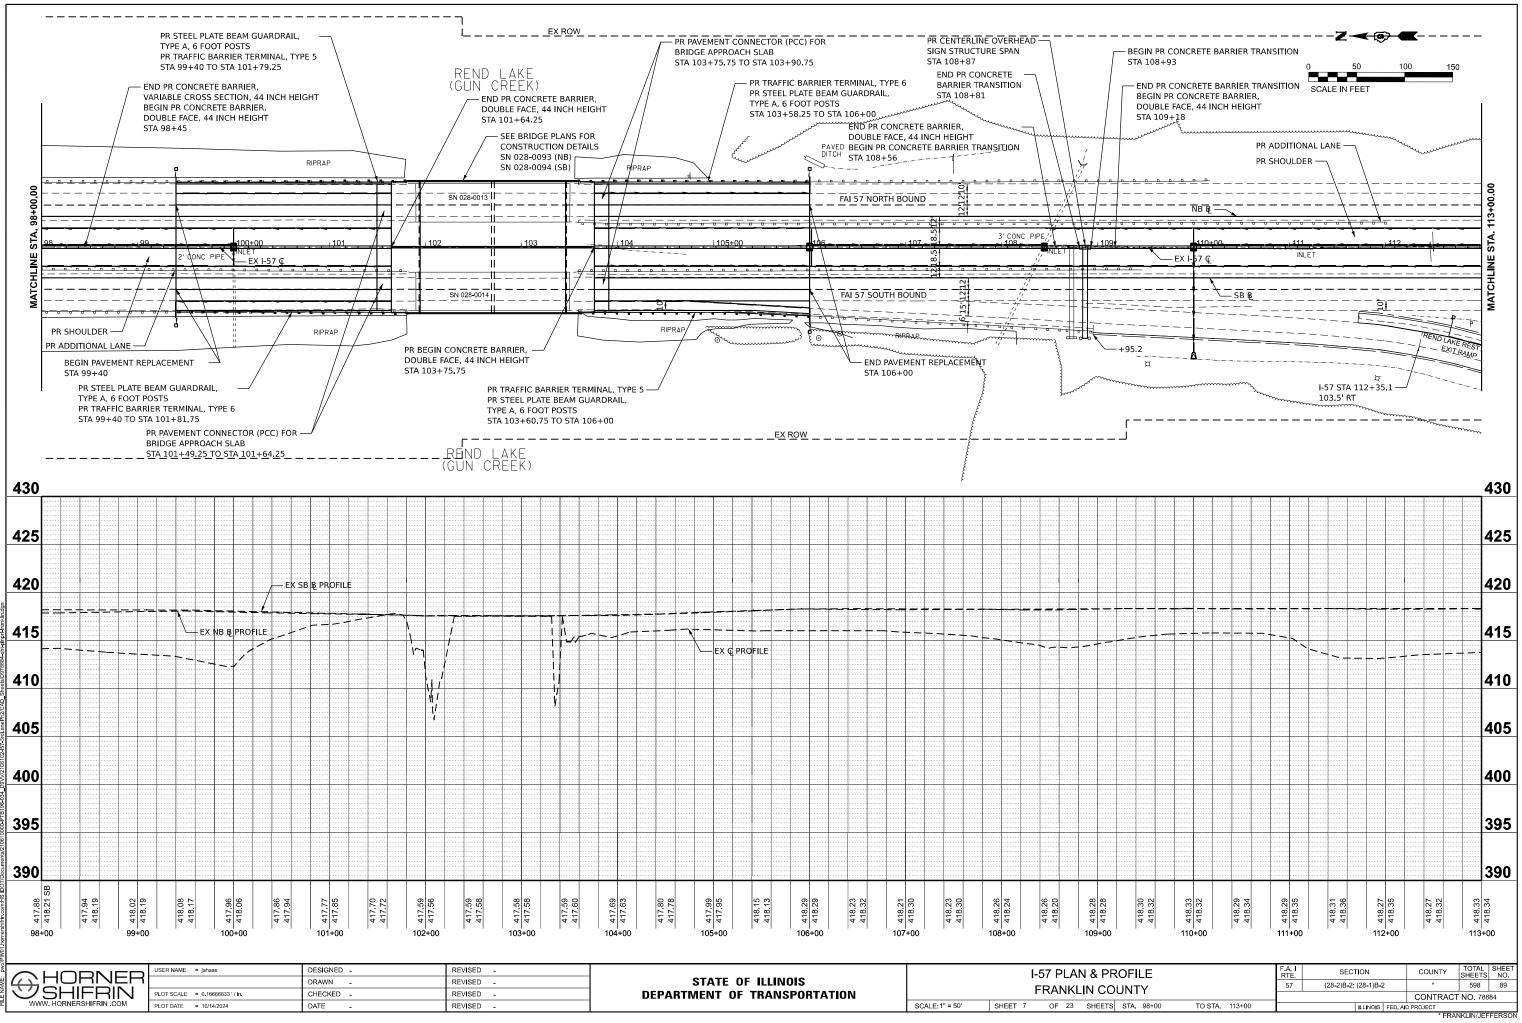


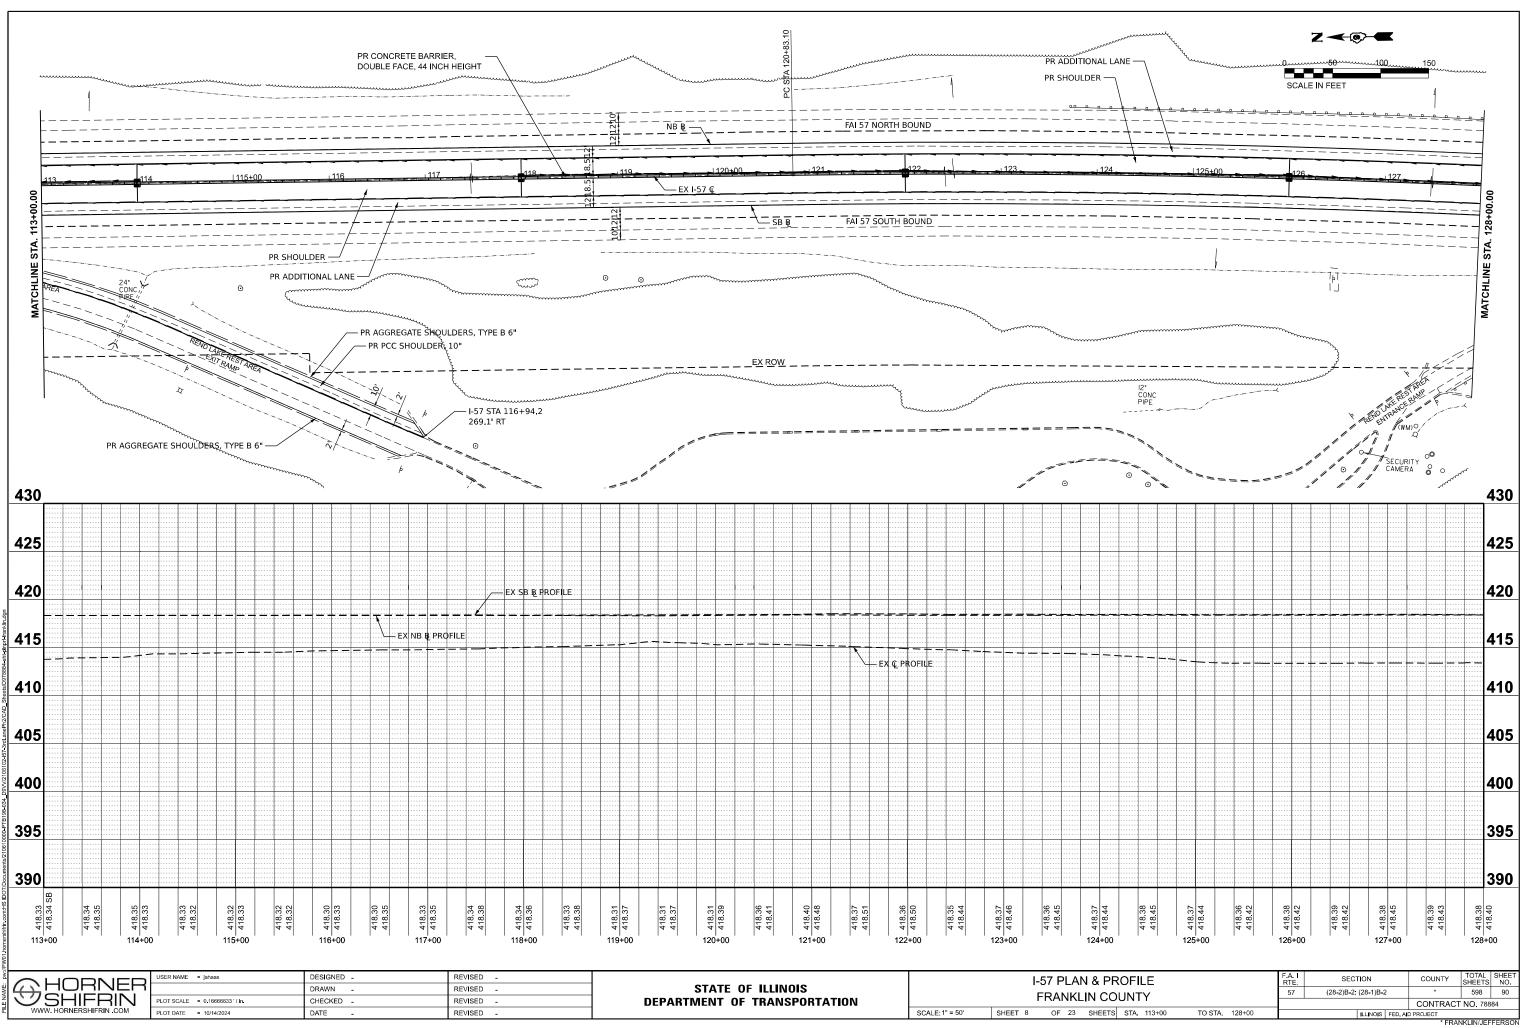
DEL: ISTFRANKLINA - ISTFRANKLIN-8 (



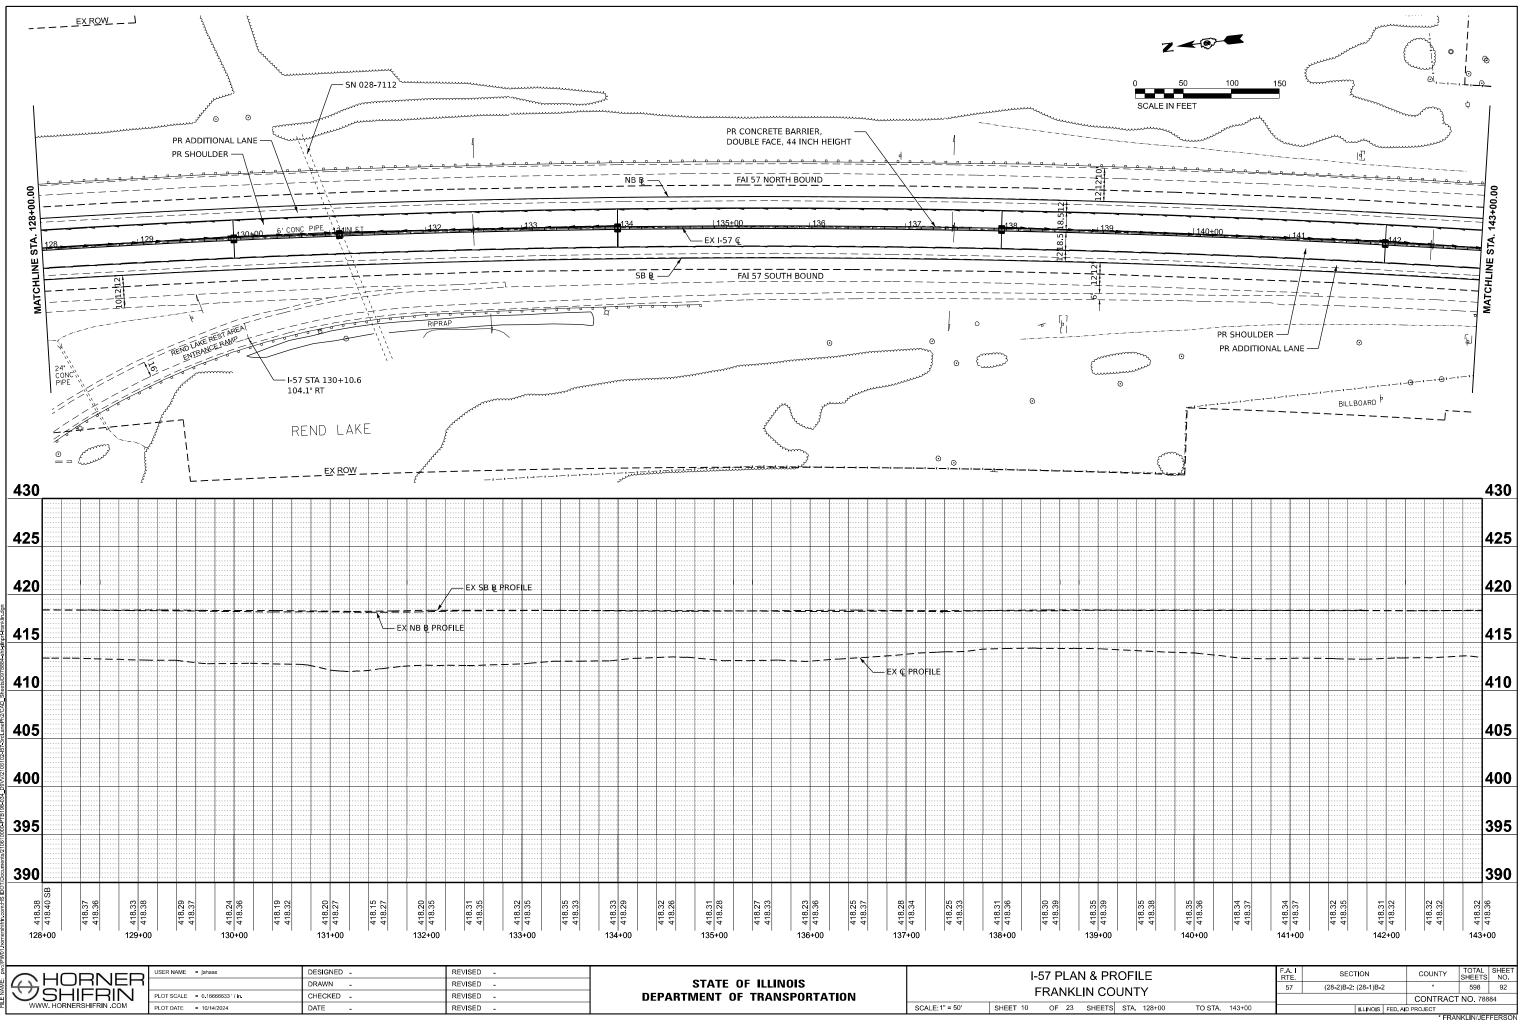



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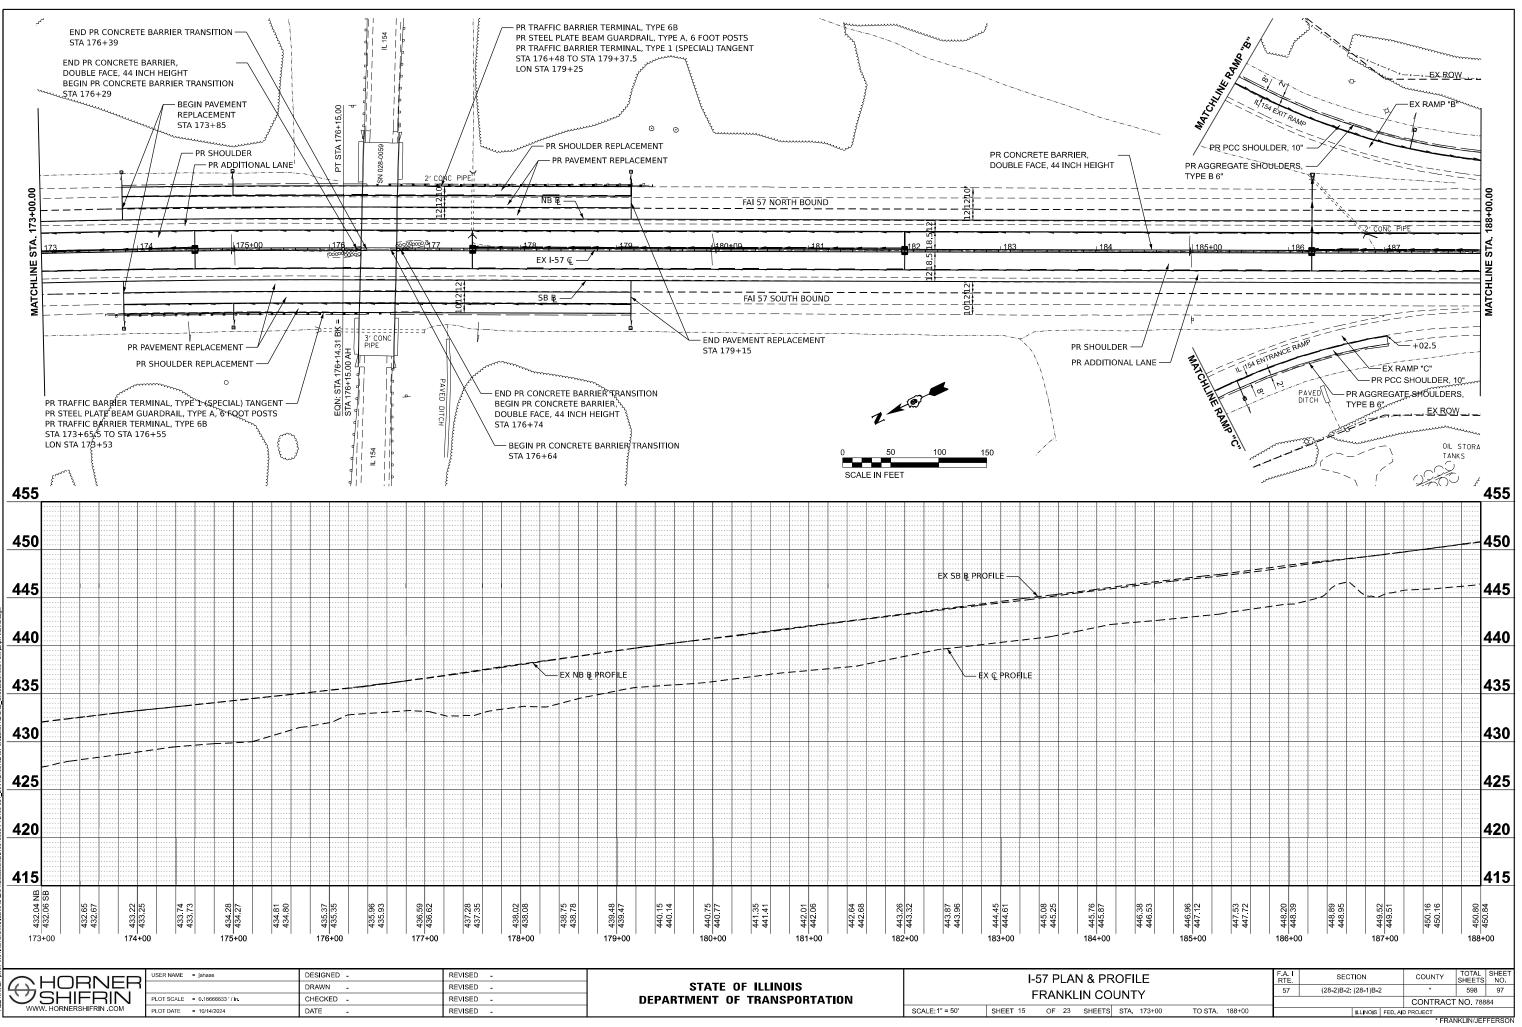


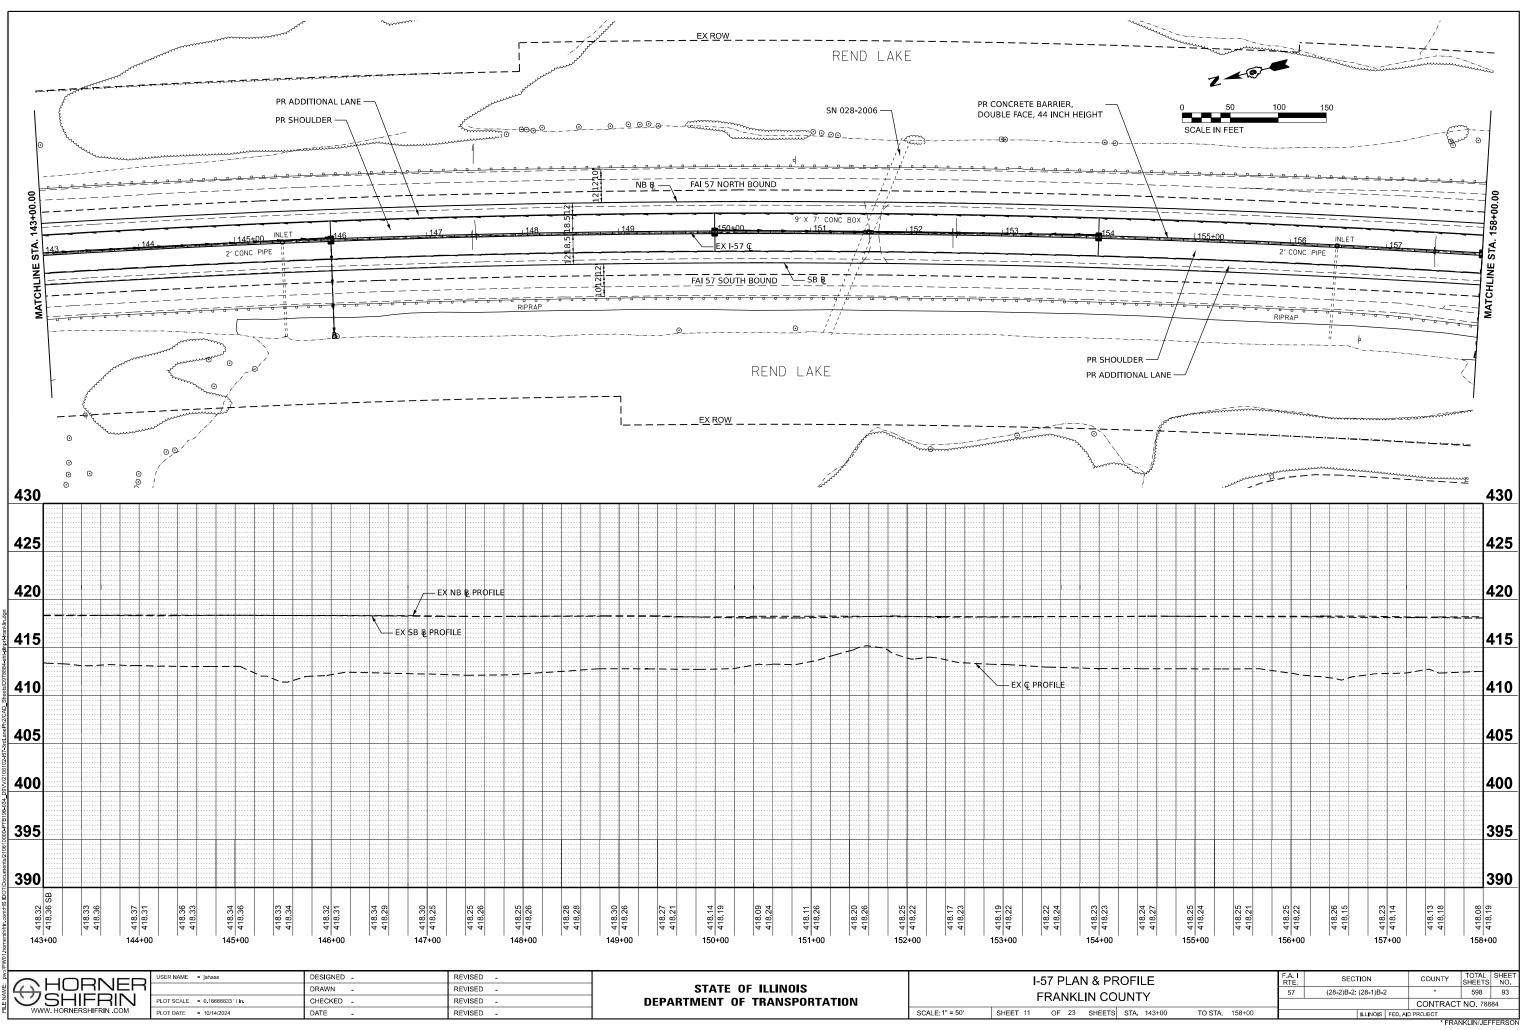

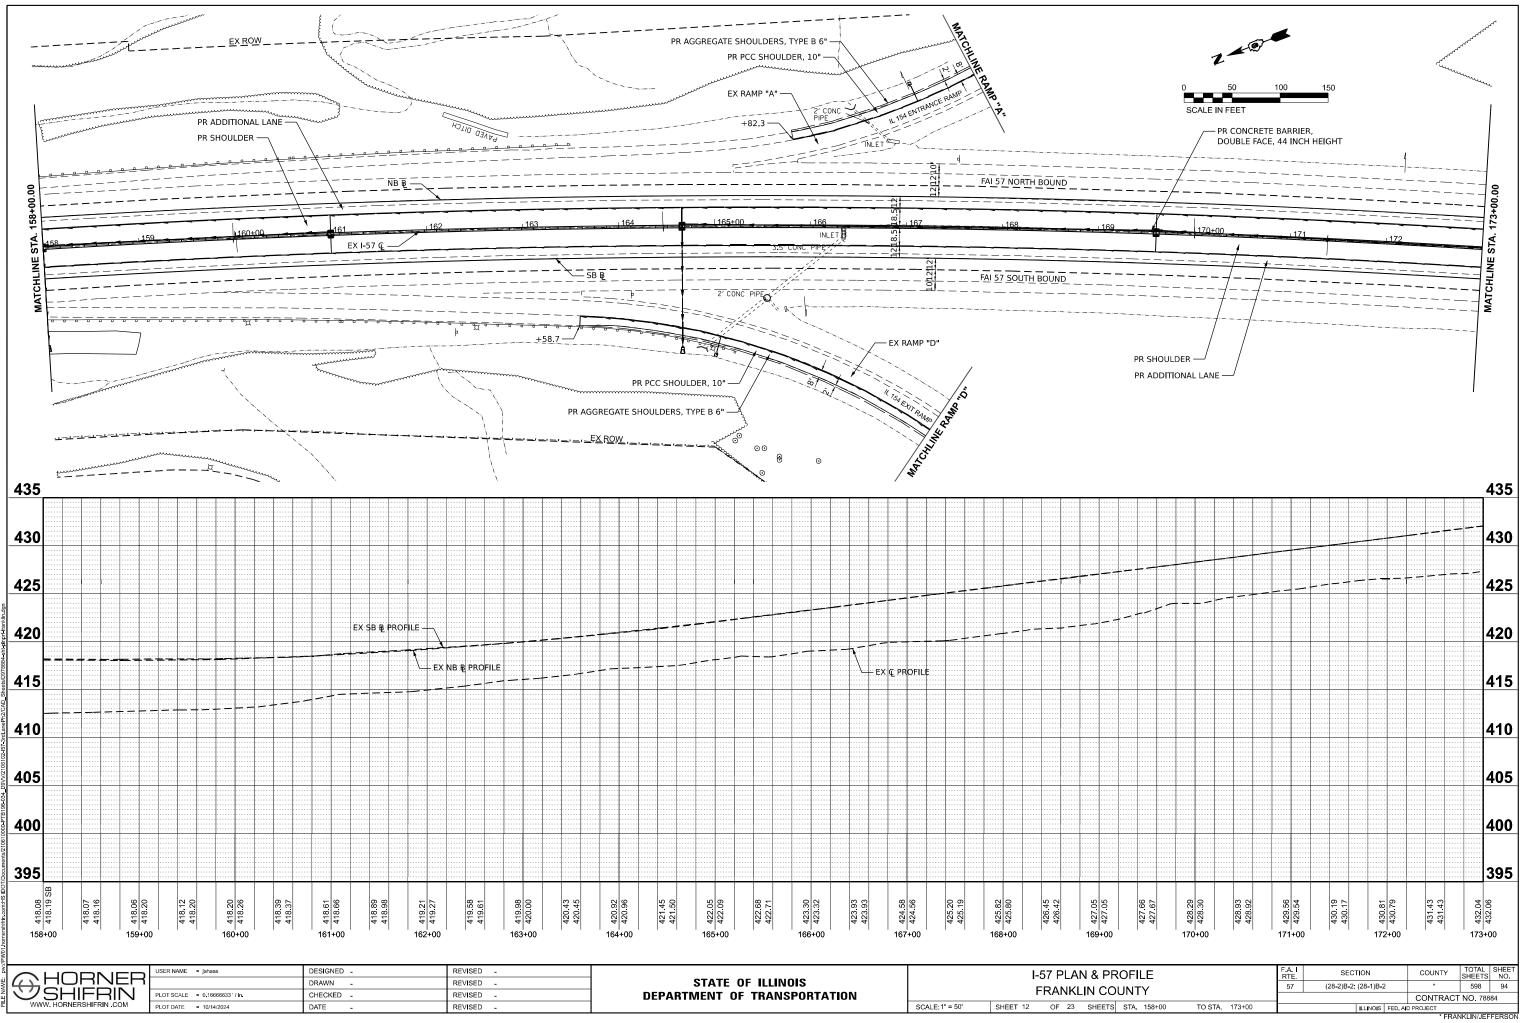
10DEL: 157FRANKLINA - 157FRANKLIN-11 (Sh 11 E NAME: muriipu001 homorphifin com-HS 1



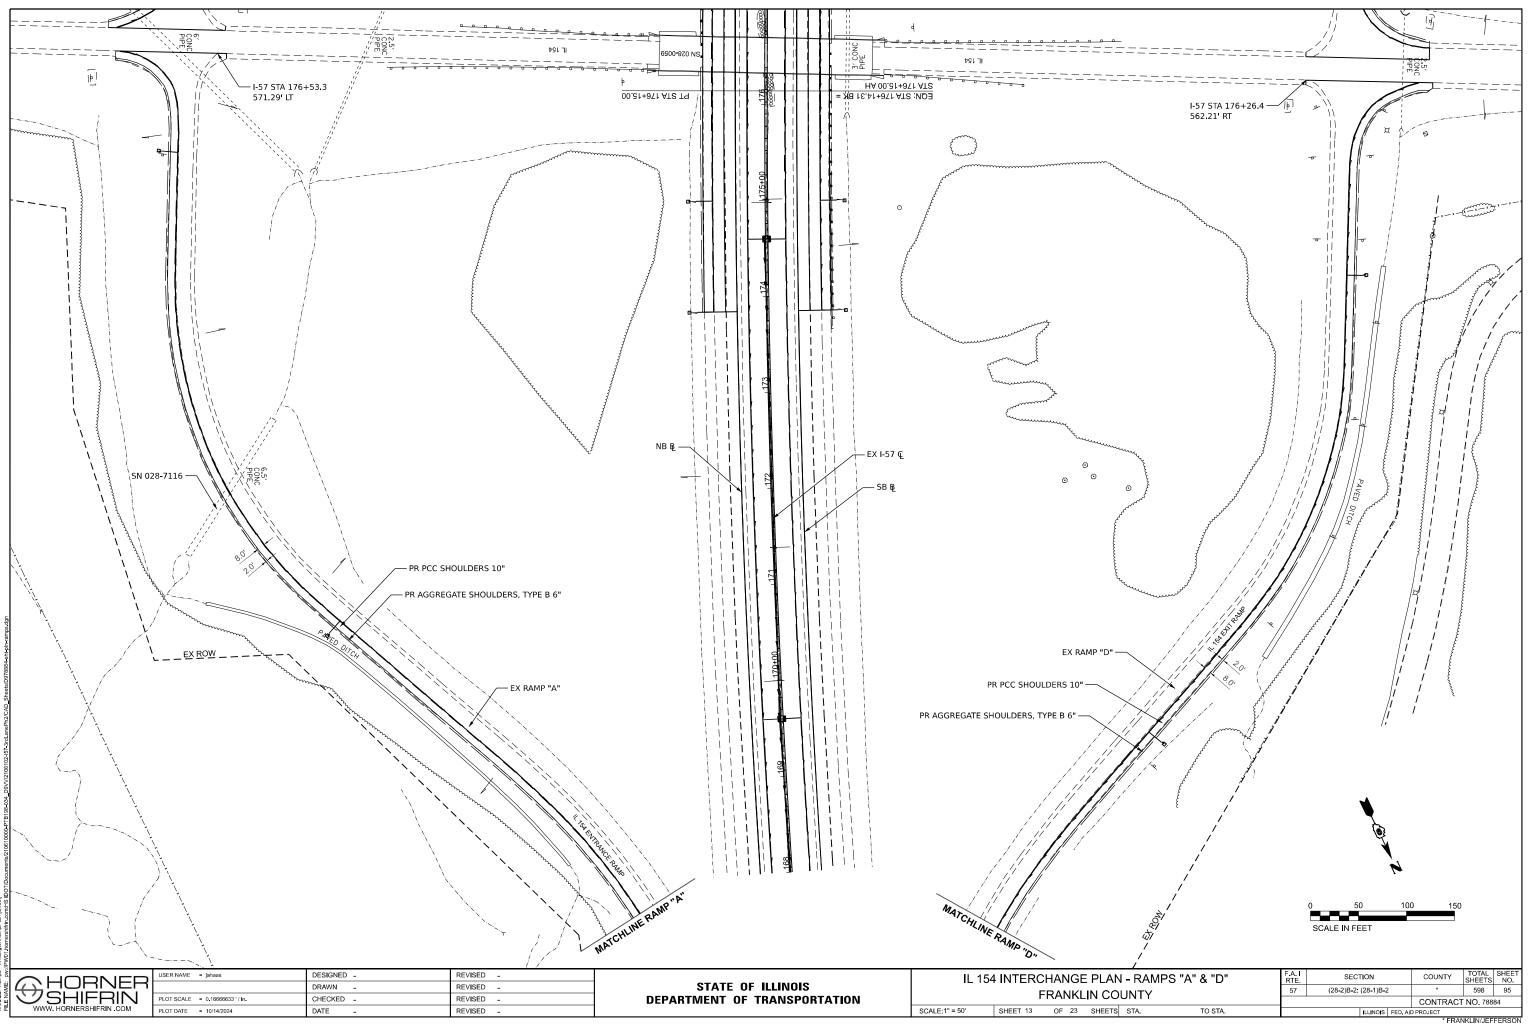


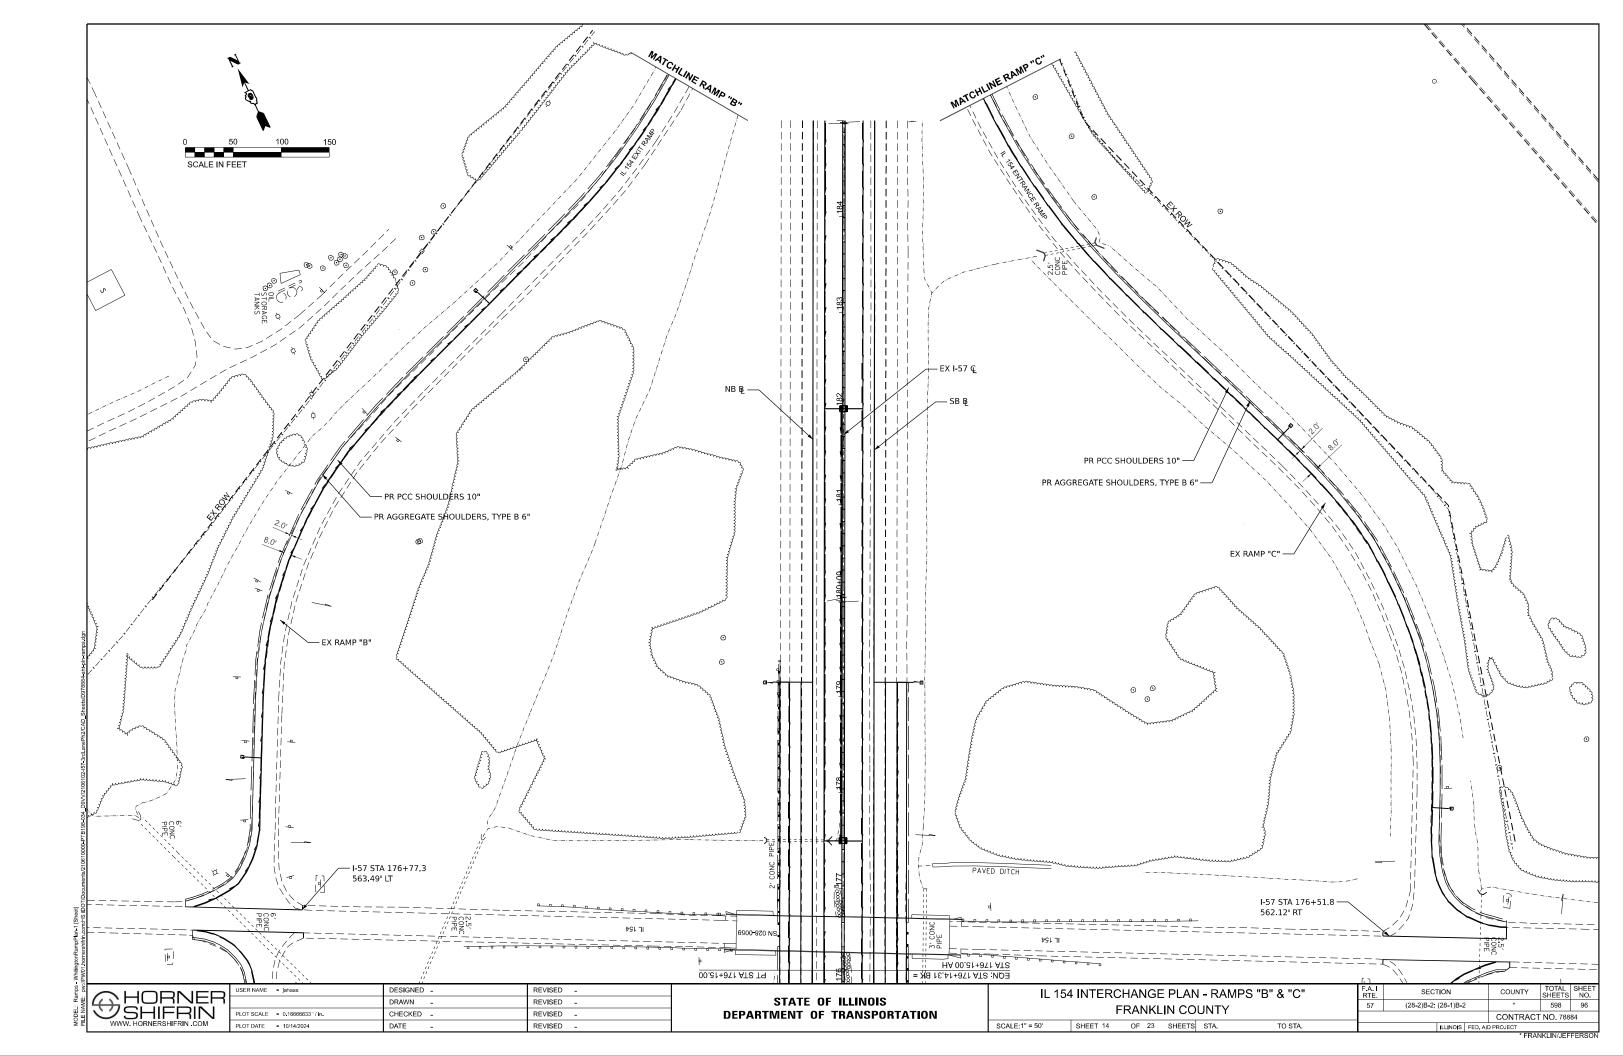


MODEL: 157FRANKLINA - 157FRANKLIN-12 [Sheet] TII F NAME- AW//IPIM01 homeschifter com-HS_IDOT/

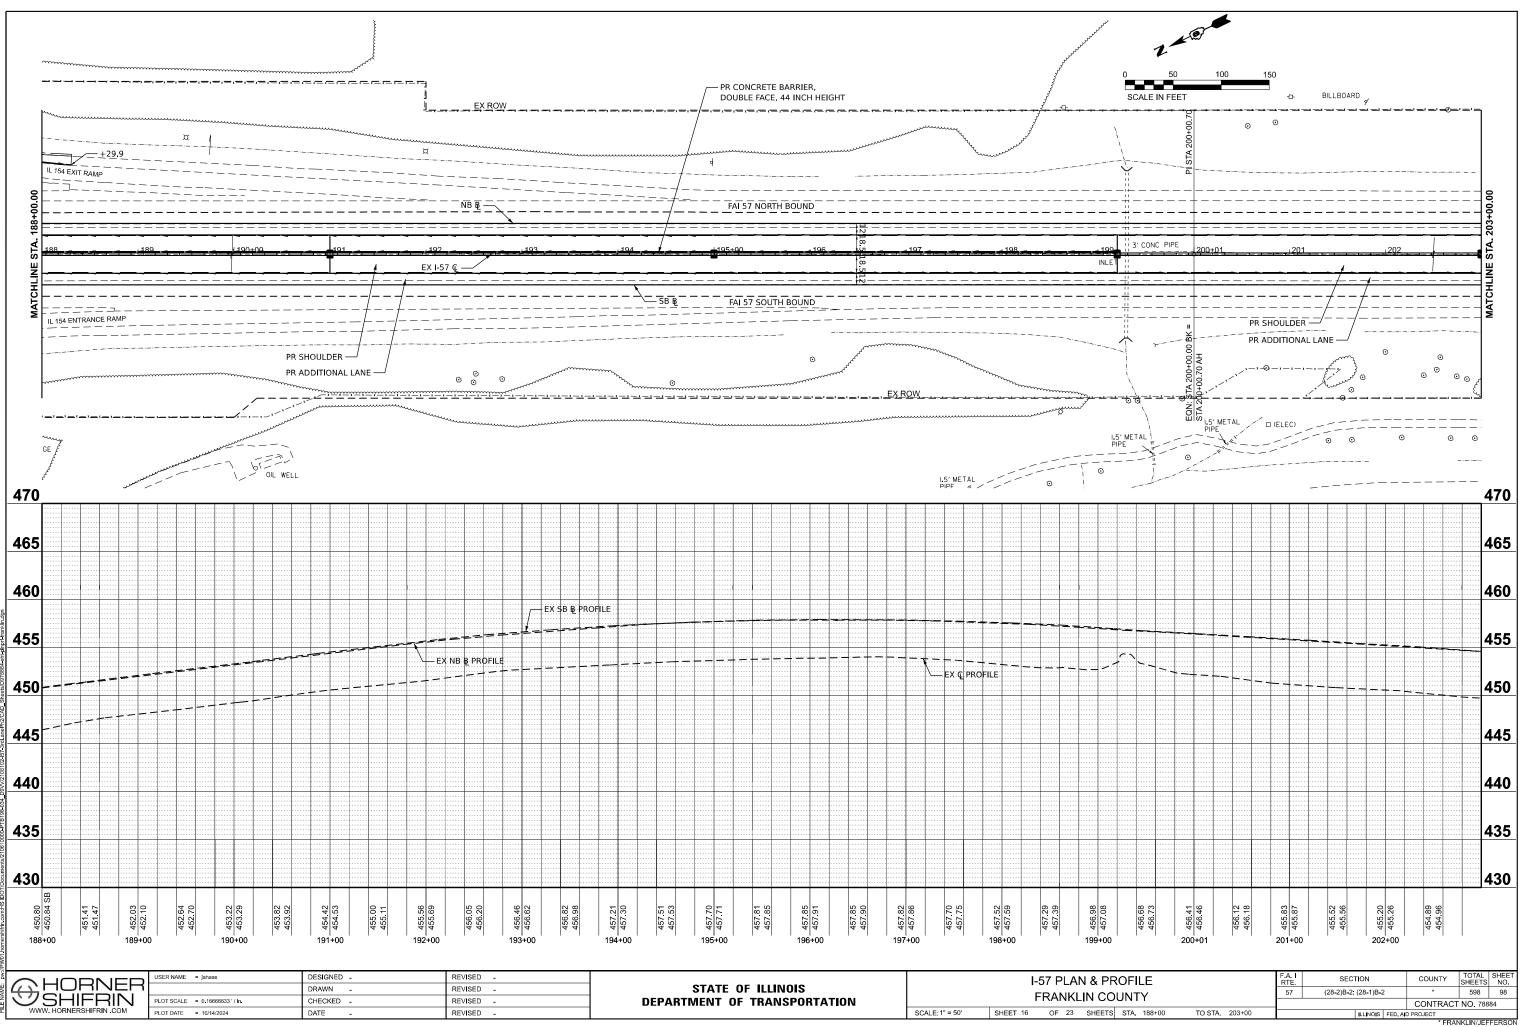

ODEL: 157FRANKLINA - 157FRANKLIN-13 (S

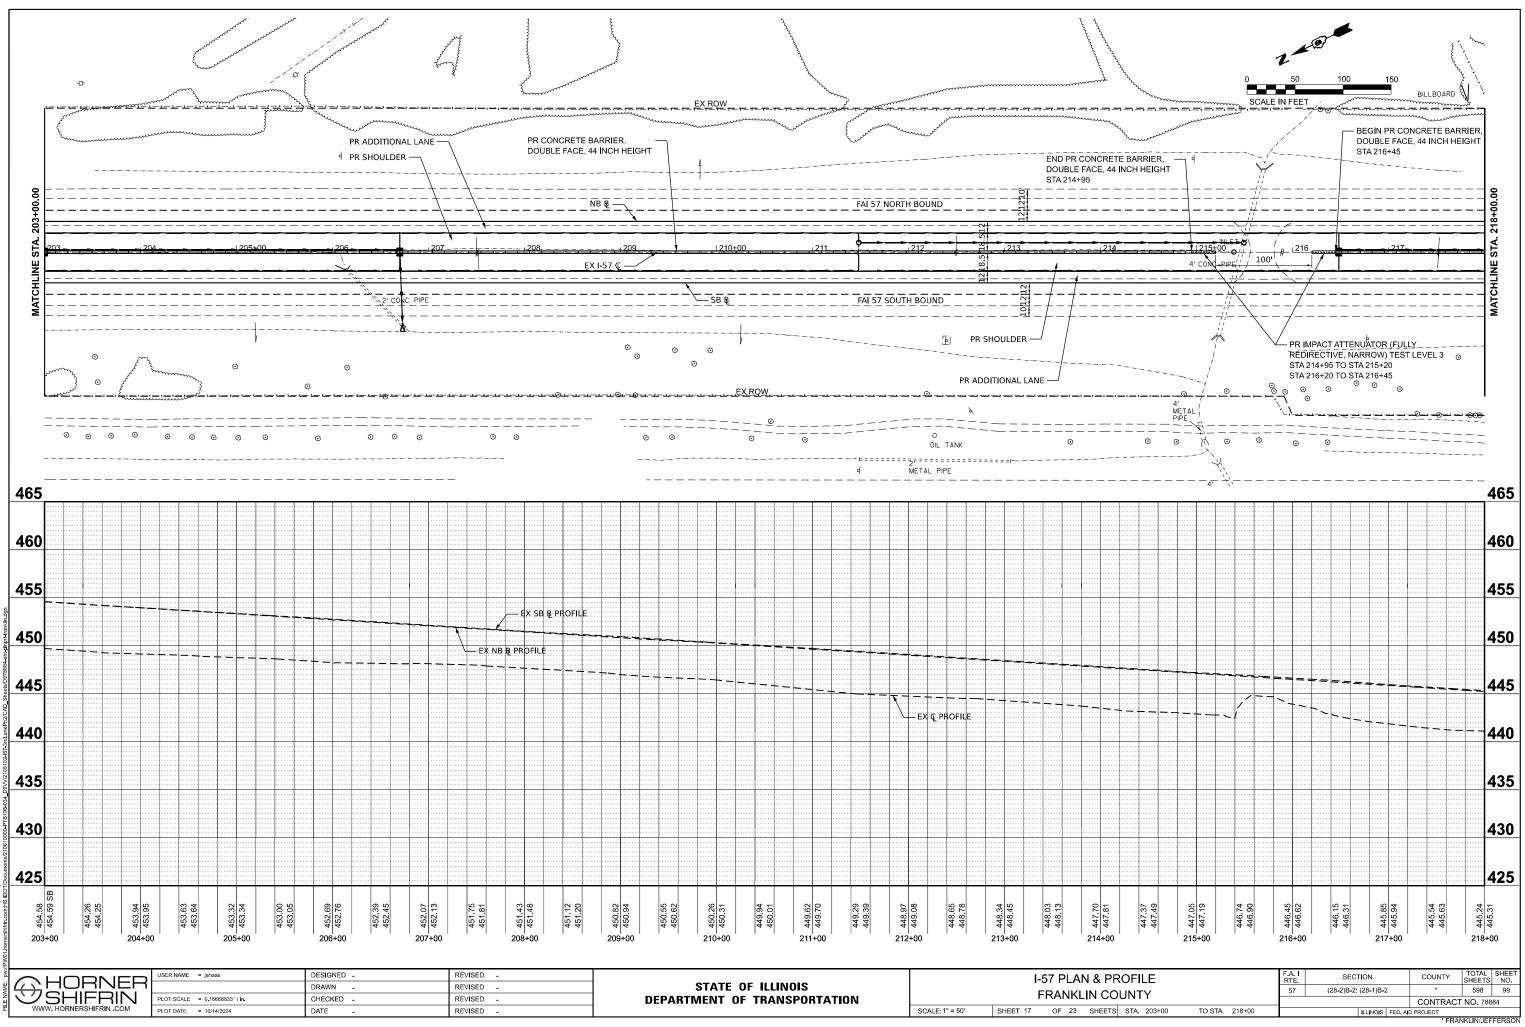

10DEL: 157FRANKLINA - 157FRANKLIN-14 [She

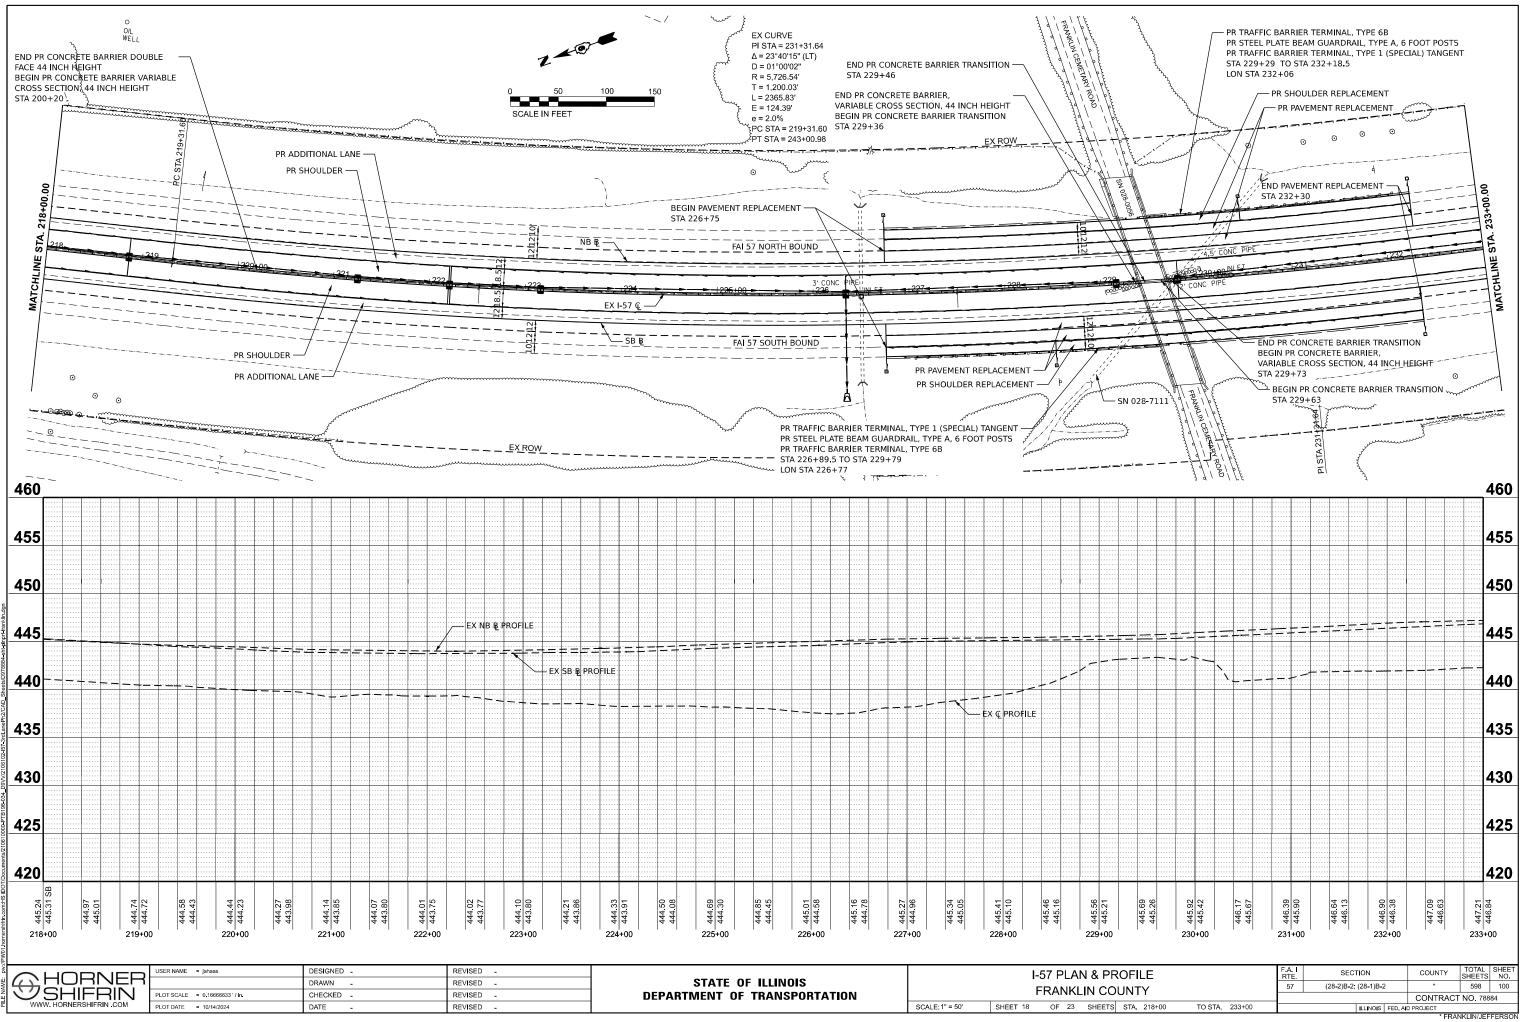

AODEL: 157FRANKLINA - 157FRANKLIN-15 (S