FOR INDEX OF SHEETS SEE SHEET NO. 2

TRAFFIC DATA

DESIGN DESIGNATION: LOCAL STREET

PROJECT LOCATED IN THE VILLAGE OF WESTCHESTER

POSTED SPEED LIMIT: 25 MPH **DESIGN SPEED LIMIT: 30 MPH**

2030 ADT = 500

STATE OF ILLINOIS **DEPARTMENT OF TRANSPORTATION DIVISION OF HIGHWAYS PLANS FOR**

PROPOSED FEDERAL AID PROJECT **BRISTOL AVENUE - CERMAK-FRONTAGE ROAD** TO DICKENS STREET **DOVER STREET - WESTCHESTER BLVD. (FAU 2713)**

TO GARDNER ROAD (FAU 1005) RESURFACING PROJECT

VILLAGE OF WESTCHESTER

SECTION 06-00071-00-FP

PROJECT HPP-2902 (002)

COOK COUNTY



BRISTOL AVENUE LOCATION MAP RANGE 12 EAST, SECTION 21

Know what's below. **Call** before you dig.

FULL SIZE PLANS HAVE BEEN PREPARED USING STANDARD ENGINEERING SCALES. REDUCED SIZED PLANS WILL NOT CONFORM TO STANDARD SCALES. IN MAKING MEASUREMENTS

ON REDUCED PLANS, THE ABOVE SCALES MAY BE USED.

CALL 48 HOURS IN ADVANCE

PROJECT ENDS STATION 27+04 DOVER STREET PROJECT BEGINS STATION 0+90 PROJECT BEGINS STATION 0+89 **BRISTOL AVENUE**

PROVISO TOWNSHIP

MAP SCALE: (NOT TO SCALE)

PROJECT ENDS

STATION 39+68

CONTRACT NO.

- AREA OF IMPROVEMENT GROSS AND NET LENGTH OF PROJECT = 6,493 FT. = 1.23 MI. HPP-2902 (002) 06-00071-00-F



STATE OF ILLINOIS DEPARTMENT OF TRANSPORTATION DIVISION OF HIGHWAYS VILLAGE OF WESTCHESTER, VILLAGE ADMINISTRATO HOD CHRETONER HOLT prione or Keefe / of

(PRINTED BY AUTHORITY OF THE STATE OF ILLINOIS)

EDWIN HANCOCK ENGINEERING COMPANY 9933 ROOSEVELT ROAD PHONE: (708)865-0300 WESTCHESTER, ILLINOIS 60154

E.H.E. NO. 838-06-38501

INDEX OF SHEETS

SHEET NO.	DESCRIPTION		
		124	NORTH BONNET BOLT ON FIRE HYDRAN CORNER OF BRISTOL AVENUE & CERMA
1	TITLE SHEET, LOCATION MAP		
2	INDEX OF SHEETS, LEGEND, BENCHMARKS, & I.D.O.T. STANDARD DRAWINGS	141	EAST-NORTHEAST FLANGE BOLT ON FIF NORTHEAST CORNER OF GARDNER ROA
3	GENERAL NOTES		STREET
4	SUMMARY OF QUANTITIES	173	EAST-NORTHEAST FLANGE BOLT ON FIF
5	TYPICAL CROSS SECTIONS		NORTHEAST CORNER OF BRISTOL AVEN LANE
6	ROADWAY DETAILS	174	EAST-NORTHEAST FLANGE BOLT ON FIR
7-8	DRAINAGE DETAILS	174	SOUTHEAST CORNER OF BRISTOL AVEN
9-13	BRISTOL AVENUE - PLAN & PROFILE		STREET
14-17	DOVER AVENUE - PLAN & PROFILE	175	EAST-NORTHEAST FLANGE BOLT ON FIF
18-20	ASPHALT & LANDSCAPING, PAVEMENT MARKING, & EROSION CONTROL PLAN		SOUTHEAST CORNER OF BRISTOL AVEN STREET
21	DISTRICT ONE TYPICAL PAVEMENT MARKINGS	183	FACT MODIFICACT CLANCE DOLT ON SID
22	BUTT JOINTS AND HOT-MIX ASPHALT TAPER DETAILS	183	EAST-NORTHEAST FLANGE BOLT ON FIR NORTHEAST CORNER OF CANTERBURY S BRISTOL AVENUE

BENCHMARKS

124	NORTH BONNET BOLT ON FIRE HYDRANT AT NORTHEAST CORNER OF BRISTOL AVENUE & CERMAK FRONTAGE ROAD	628.02
141	EAST-NORTHEAST FLANGE BOLT ON FIRE HYDRANT AT NORTHEAST CORNER OF GARDNER ROAD & DOVER STREET	626.73
173	EAST-NORTHEAST FLANGE BOLT ON FIRE HYDRANT AT NORTHEAST CORNER OF BRISTOL AVENUE & DEVONSHIRE LANE	628.34
174	EAST-NORTHEAST FLANGE BOLT ON FIRE HYDRANT AT SOUTHEAST CORNER OF BRISTOL AVENUE & GLADSTONE STREET	626.77
175	EAST-NORTHEAST FLANGE BOLT ON FIRE HYDRANT AT SOUTHEAST CORNER OF BRISTOL AVENUE & KITCHENER STREET	627.07
183	EAST-NORTHEAST FLANGE BOLT ON FIRE HYDRANT AT	

627.93

I.D.O.T. STANDARD DRAWINGS

STANDAR	D NO. TITLE OR DESCRIPTION
000001-05	STANDARD SYMBOLS, ABBREVIATIONS AND PATTERNS
280001-04	TEMPORARY EROSION CONTROL SYSTEM
424001-05	CURB RAMPS FOR SIDEWALKS
442201-0 3	CLASS C AND D PATCHES
602601-01	PRECAST REINFORCED CONCRETE FLAT SLAB TOP
604001-02	FRAMES AND LIDS, TYPE 1
701501-04	URBAN LANE CLOSURE, 2-LANE, 2-WAY, UNDIVIDED
701801-03	LANE CLOSURE, MULTILANE, 1-WAY OR 2-WAY CROSSWALK OR SIDEWALK CLOSURE
701901	TRAFFIC CONTROL DEVICES

LEGEND OF SYMBOLS

(TO BE USE	D IN CONJUNCTION WITH I.D.O.T. STANDARD 000001-04)
STIVIBUL	DESCRIPTION
Ø	EXISTING POWER POLE
Δ	EXISTING GAS VALVE
	EXISTING TRAFFIC SIGNAL HEAD
	EXISTING TRAFFIC HAND HOLE
<u> </u>	EXISTING TRAFFIC SIGNAL MAST ARM
8	EXISTING TRAFFIC SIGNAL POLE W/HEAD
	EXISTING TRAFFIC CONTROL BOX
	EXISTING TRAFFIC CONDIT
	EXISTING TRAFFIC LOOP DETECTOR
ф>o	EXISTING STREET LIGHT
0	EXISTING WATER MAIN BUFFALO BOX
(\$)	EXISTING SPRINKLER
	EXISTING WATER MAIN VALVE VAULT
0	EXISTING BUSH
⊕ \$	EXISTING TREE
W.	EXISTING EVERGREEN TREE
В	EXISTING HOT-MIX ASPHALT AREA
С	EXISTING CONCRETE AREA
G	EXISTING GRASS AREA
S	EXISTING STONE OR GRAVEL AREA
	EXISTING STORM SEWER
——<(EXISTING COMBINATION SEWER
—— E ——	EXISTING ELECTRIC LINE
G	EXISTING GAS LINE
——Т——	
W	
	EXISTING CURB AND GUTTER
	EXISTING RIGHT OF WAY
LUA	EXISTING STRUCTURE TO BE ADJUSTED
REC	EXISTING STRUCTURE TO BE RECONSTRUCTED
[∞] RM	EXISTING STRUCTURE TO BE REMOVED
× _F	EXISTING STRUCTURE TO BE FILLED
· f-f-f-f-f\ f-f-f-f	EXISTING STORM SEWER TO BE ABANDONED
/-/-/ *W -/-/- -	EXISTING WATER MAIN TO BE ABANDONED
	EXISTING CURB AND GUTTER TO BE REMOVED
	HOT-MIX ASPHALT SURFACE TO BE REMOVED
XXX	EXISTING HOT-MIX ASPHALT AREA TO BE REMOVED - BUTT JOINT
// C	EXISTING CONCRETE STREAM TO BE REMOVED
7777777	EXISTING CONCRETE SIDEWALK TO BE REMOVED
——————————————————————————————————————	PROPOSED STORM SEWER
	PROPOSED WATER MAIN PROPOSED DIRECTION OF FLOW
¢	PROPOSED SUMMIT
# 3 P	PROPOSED HOT-MIX ASPHALT AREA
	PROPOSED CONCRETE AREA
G	PROPOSED GRASS AREA
	PROPOSED COMBINATION CONCRETE CURB AND
•	GUTTER, TYPE B-4.12 PROPOSED CATCH BASIN
_	PROPOSED INLET
_	PROPOSED VALVE VAULT
<u>-</u>	PROPOSED FIRE HYDRANT
	THO COLD TINE HIDRANT



9933 Roosevelt Road Westchester, Illinois 60154-2780 Phone: 708/865-0300 Fax: 708/865-1212 HIGH PRIORITY PROJECT HPP-2902 (002) **BRISTOL AVENUE & DOVER STREET VILLAGE OF WESTCHESTER, ILLINOIS**

INDEX OF SHEETS, LEGEND, BENCHMARKS, & I.D.O.T. STANDARD DRAWINGS

	SCALE:	NONE	SHEET
	DRAWN BY:	ECW/LEV	2
	BOOK NO.:	1541	
	DATE:	10-2-07	
ion:	E.H.E. NO.;	838-06-38501	OF

ACCESS

THE CONTRACTOR WILL BE REQUIRED TO MAINTAIN ACCESS FOR EMERGENCY VEHICLES TO INGRESS AND EGRESS ONTO PRIVATE 8 COMMERCIAL PROPERTY DURING THE CONSTRUCTION PERIOD. ALSO DURING CONSTRUCTION, GARBAGE TRUCKS MUST BE PERMITTED ACCESS TO THE WORK ZONE IN ORDER TO PICK UP RESIDENTIAL AND COMMERCIAL GARBAGE FOR THOSE PROPERTIES FRONTING THE WORK ZONE.

STANDARDS

ANY REFERENCE TO STANDARDS THROUGHOUT THE PLANS OR SPECIAL PROVISIONS SHALL BE INTERPRETED TO BE THE LATEST STANDARD OF THE DEPARTMENT AS SHOWN ON THE INDEX OF SHEETS IN THE PLANS.

UNDERGROUND UTILITIES

THE LOCATIONS OF THE UNDERGROUND UTILITIES AS SHOWN ON THE PLANS HAVE BEEN OBTAINED BY FIELD SURVEYS AND SEARCHES OF AVAILABLE RECORDS. IT IS BELIEVED THAT THE DATA IS ESSENTIALLY CORRECT, BUT THE VILLAGE OF WESTCHESTER, OR OTHER OFFICES, AND AGENCIES ASSOCIATED WITH THE DEVELOPMENT OF THESE PLANS DO NOT GUARANTEE THEIR ACCURACY OR COMPLETENESS. THE CONTRACTOR WILL BE REQUIRED TO VERIFY THE EXACT LOCATION OF EACH FACILITY WITH THE UTILITY COMPANY, AND SHALL TAKE DUE CARE IN ALL PHASES OF THE CONSTRUCTION TO PROTECT ANY SUCH FACILITIES WHICH MAY BE AFFECTED BY THE WORK. ANY DAMAGE TO EXISTING UTILITIES SHALL BE REPAIRED AT THE CONTRACTOR'S

ADJUSTMENTS REQUIRED BY UTILITY COMPANIES WILL BE PERFORMED BY THE COMPANY INVOLVED OR ITS CONTRACTOR.

COORDINATION OF ALL UTILITY WORK INVOLVED IN THE CONSTRUCTION AREA WILL BE DISCUSSED AT A PRE-CONSTRUCTION CONFERENCE.

THE CONTRACTOR SHALL USE EXTREME CAUTION IN THE REMOVAL OF ABANDONED EXISTING GAS LINES SINCE RESIDUAL MATERIALS CONTAINED THEREIN ARE HIGHLY EXPLOSIVE, FLAMMABLE, AND TOXIC. ONCE THE MAINS ARE ABANDONED BY THE OWNER, THE CONTRACTOR SHALL ASSUME ALL RESPONSIBILITY FOR ANY DAMAGE AND/OR INJURY OCCURRING ON THE PROJECT DUE TO HIS OPERATIONS NEXT TO THE MAINS AND/OR THE METHOD OF REMOVAL OF THE ABANDONED MAINS. UNDER NO CIRCUMSTANCE SHALL THE UTILITY COMPANIES BE HELD LIABLE FOR ANY DAMAGE AND/OR INJURY ONCE THEIR MAINS HAVE BEEN RELOCATED AND THE EXISTING MAINS HAVE BEEN ABANDONED.

STORM SEWER

THE VERTICAL AND HORIZONTAL CLEARANCES BETWEEN WATER MAINS AND PROPOSED OR EXISTING STORM SEWERS SHALL CONFORM TO THE REQUIREMENTS OF THE I.E.P.A. AS STATED IN THEIR POLICY STATEMENTS, SECTION 31-1.02A THROUGH

FRAMES AND GRATES

THE TYPE OF FRAMES AND GRATES REQUIRED FOR ALL CATCH BASINS AND MANHOLES LISTED IN THE SUMMARY OF QUANTITIES MAY BE FOUND ON THE PLANS AT THEIR RESPECTIVE LOCATIONS. WHERE LIDS ARE CALLED FOR ON THE PLANS, THEY SHALL BE IN ACCORDANCE WITH ARTICLE 604.01 OF THE STANDARD SPECIFICATIONS AND THE TERM LID IS USED IN LIFTURE GRATE.

ON ALL IMPROVEMENTS. THE FRAMES AND LIDS OF EXISTING CATCH BASINS, INLETS, MANHOLES, AND VALVE VALUES WHICH ARE TO BE ABANDONED DUE TO CONSTRUCTION OF THIS IMPROVEMENT ARE TO REMAIN THE PROPERTY OF THE VILLAGE OF WESTCHESTER AND BE SALVAGED.

THE WORD "WATER", "SANITARY", OR "STORM" SHALL BE CAST INTO THE LID OF EACH RESPECTIVE MANHOLE OR VALVE VAULT.

MAINTENANCE OF SEWER FLOWS

THE CONTRACTOR SHALL CONDUCT HIS OPERATIONS SO AS TO MAINTAIN AT ALL TIMES FLOWS THROUGH EXISTING STORM AND SANITARY SEWER SYSTEMS. HE SHALL ALSO PROVIDE AND MAINTAIN AN EFFICIENT PUMPING PLANT IF NECESSARY AND A TEMPORARY OUTLIET AND BE PREPARED AT ALL TIMES TO DISPOSE OF THE WATER COLLECTED IN A SAFE MANNER WITHOUT DAMAGE OF ANY KIND TO ADJACENT PROPERTIES. THE ENDS OF EXISTING DRAINAGE LINES WHICH ARE NOT TO BE INCORPORATED INTO THE PROJECT ARE TO BE SEALED AS SPECIFIED IN THE SPECIAL PROVISIONS. THE COST OF ALL THE PREVIOUSLY MENTIONED WORK SHALL BE INCLUDED IN THE CONTRACT. ALL ACCUMULATION OF MATERIAL IN THE STRUCTURE DUE TO CONSTRUCTION OPERATIONS AS WELL AS MATERIAL EXISTING BEFORE CONSTRUCTION, SHALL BE REMOVED BY THE CONTRACTOR AT HIS EXPENSE

EXISTING STRUCTURE MODIFICATIONS

ALL KNOWN EXISTING STRUCTURES IN THE PAVEMENT OR ADJACENT AREAS WHICH ARE INVOLVED IN THE CONSTRUCTION HAVE BEEN SHOWN ON THE PLANS AND NOTED AS TO BE REMOVED, FILLED, RECONSTRUCTED, OR ADJUSTED BY THE CONTRACTOR EXCEPT THOSE OF AMERITECH, COMED, AND THE NICOR GAS COMPANY, WHICH ARE TO BE ADJUSTED BY THE APPROPRIATE UTILITY FORCE. WHERE EXISTING STRUCTURES ARE TO REMOVED OR FILLED, OR THE EXISTING CASTING REPLACED, THE CASTINGS REMOVED FROM THE STRUCTURE SHALL BECOME THE PROPERTY OF THE VILLAGE OF WESTCHESTER

SHEETING OR SHORING

IT SHOULD BE NOTED THAT ANY SHEETING OR SHORING REQUIRED FOR THE STORM SEWER INSTALLATION OR OTHER CONSTRUCTION ELEMENTS REQUIRING RELATIVELY DEEP EXCAVATIONS, SHALL BE INCLUDED IN THE PARTICULAR PAYMENT ITEM AND NO ADDITIONAL COMPENSATION WILL BE ALLOWED FOR ANY SUPPLEMENTAL WORK ASSOCIATED WITH THE MAINTENANCE OF TRENCH SIDES OR OTHER EXCAVATED AREAS.

MAINTENANCE OF EXISTING DRAINAGE STRUCTURES

WHEN DURING THE CONSTRUCTION OPERATIONS, ANY LOOSE MATERIAL IS DEPOSITED IN THE FLOW LINE OF ANY GUTTERS OR DRAINAGE STRUCTURE SO THAT THE NATURAL FLOW OF WATER IS OBSTRUCTED, IT SHALL BE REMOVED AT THE CLOSE OF EACH WORKING DAY. AT THE CONCLUSION OF THE CONSTRUCTION OPERATIONS, ALL DRAINAGE FACILITIES SHALL BE CLEAN AND FREE OF ALL OBSTRUCTIONS. THE COST OF THIS WORK SHALL BE INCLUDED IN THE

SAW CUTTING

THE CONTRACTOR SHALL SAW CUT ASPHALT PAVEMENT AND DRIVEWAY PAVEMENT AS INDICATED ON THE PLANS OR AS DIRECTED BY THE ENGINEER, TO SEPARATE THE EXISTING PAVEMENT TO BE REMOVED BY MEANS OF AN APPROVED CONCRETE SAW TO A DEPTH AS DIRECTED BY THE ENGINEER. SUITABLE GUIDELINES OR DEVICES SHALL BE USED TO ASSURE CUTTING A NEAT, STRAIGHT LINE AS SHOWN ON THE PLANS. CARE SHALL BE TAKEN BY THE CONTRACTOR SO AS NOT TO DAMAGE THE REMAINING PAVEMENT DIRECTLY ADJACENT TO THE PAVEMENT TO BE REMOVED. ANY DAMAGE TO THE EXISTING PAVEMENT RESULTING FROM PAVEMENT REMOVAL OPERATIONS SHALL BE REPAIRED AT THE CONTRACTOR'S EXPENSE. THE PRICE OF SAW CUTTING, AS NOTED ABOVE, SHALL BE INCLUDED IN THE PARTICULAR PAY ITEMS.

PRIME COAT

PRIME COAT MUST BE INSTALLED NO EARLIER THAN TWENTY-FOUR (24) HOURS PRIOR TO PLACEMENT OF HOT-MIX

TRAFFIC PROTECTION

CONTRACTOR'S ATTENTION IS DIRECTED TO THE FACT THAT WHEN WORK COMMENCES, THE CONTRACTOR SHALL ASSUME THE MAINTENANCE OF ANY PAVEMENT, SHOULDERS, DRAINAGE FACILITIES, TRAFFIC CONTROL SIGNS. PAVEMENT MARKINGS, AND OTHER APPURTENANCES ON ROADWAYS WITHIN THE LIMITS OF THE CONTRACT WHICH ARE TO BE USED BY THE PUBLIC DURING CONSTRUCTION AND TO RETAIN THIS MAINTENANCE RESPONSIBILITY UNTIL THE VILLAGE ASSUMES THE MAINTENANCE. NEED FOR SNOW AND ICE CONTROL DURING THE CONSTRUCTION PERIOD SHALL BE ACCOMMODATED FOR BY OTHERS. ALL UNBALLASTED TYPE I & TYPE II BARRICADES SHALL HAVE TWO SANDBAGS ONE ACROSS EACH BOTTOM RAIL.

PLUGGING EXISTING SEWER LINES

UNLESS OTHERWISE SPECIFIED, ABANDONED SEWER LINES, AS DESIGNATED BY THE ENGINEER, SHALL BE PLUGGED WITH CLASS "SI" CONCRETE OR BRICK AND SUITABLE MORTAR TO THE SATISFACTION OF THE ENGINEER. THIS WORK SHALL NOT BE PAID FOR SEPARATELY, BUT SHALL BE INCLUDED IN THE PAY ITEMS FOR REMOVING AND/OR FILLING THE VARIOUS TYPES OF STRUCTURES.

REMOVAL OF EXISTING STRUCTURES

AT LOCATIONS DESIGNATED FOR NEW DRAINAGE STRUCTURES WHERE EXISTING STRUCTURES ARE CURRENTLY LOCATED, THE EXISTING STRUCTURE SHALL BE REMOVED AS PART OF THE SITE PREPARATION FOR THE NEW STRUCTURE. THE COST FOR THIS WORK SHALL BE INCLUDED IN THE PARTICULAR PAY ITEMS.

HOT-MIX ASPHALT PAVING OPERATIONS

THE LEVELING BINDER WILL BE PLACED IN TWO PASSES WITH A COLD JOINT LOCATED WITHIN THREE INCHES (3") OF THE CENTER LINE OF THE PAVEMENT. THE HOT-MIX ASPHALT SURFACE COURSE WILL BE PLACED IN TWO PASSES WITH A COLD JOINT LOCATED AT THE CENTER LINE OF THE PAVFMENT. THE CONTRACTOR WILL BE REQUIRED TO SCHEDULE HIS OPERATIONS SO THAT NO SECTIONS OF PAVEMENT ALONG THE CENTER LINE WILL HAVE A COLD JOINT OVERNIGHT

OPEN EXCAVATIONS

THE CONTRACTOR WILL NOT BE ALLOWED TO LEAVE ANY EXCAVATION NECESSARY FOR PAVEMENT PATCHES OR STRUCTURE ADJUSTMENTS OVERNIGHT. THE CONTRACTOR WILL BE RESPONSIBLE FOR COMPLETELY BACKFILLING OR INSTALLING A PLATE OVER ALL EXCAVATIONS AT THE END OF THE DAY.

CONCRETE BREAKERS

WHEN REMOVING PAVEMENT, CURB AND GUTTER, AND/OR ANY STRUCTURES, THE USE OF ANY TYPE OF CONCRETE BREAKERS, SUCH AS DROP HAMMERS, WHICH MIGHT DAMAGE UNDERGROUND PUBLIC OR PRIVATE UTILITIES, WILL. NOT BE PERMITTED. UNDER NO CIRCUMSTANCES WILL THE USE OF A FROST BALL BE PERMITTED.

♦ Municipal Consultants

Westchester, Illinois 60154-2780 Phone: 708/865-0300 Fax: 708/865-1212 **HIGH PRIORITY PROJECT HPP-2902 (002) BRISTOL AVENUE & DOVER STREET VILLAGE OF WESTCHESTER, ILLINOIS**

	SCALE:	NONE	SHEET
	DRAWN BY:	ECW/LEV	3
	BOOK NO.:	1541	" " /
	DATE:	10-2-07	7 /
ISION:	E.H.E. NO.:	838-06-38501	OF

CONTRACT	NO.	83983	

				1000-2A 80% FEDERAL	
CODE	PAY ITEM	UNIT	QUANTITY	20% LOCAL	
20201200	REMOVAL AND DISPOSAL OF UNSUITABLE MATERIAL	CUYD	100	100	
20800150	TRENCH BACKFILL	CUYD	825	825	
21001000	GEOTECHNICAL FABRIC FOR GROUND STABILIZATION	SQYD	700	700	
21101610	TOPSOIL FURNISH AND PLACE, 3"	SQYD	5,850	5,850	
25200100	SODDING	SQYD	5,850	5,850	
25200200	SUPPLEMENTAL WATERING	UNIT	45	45	
28000510	INLET FILTERS	EACH	60	60	
35101800	AGGREGATE BASE COURSE, TYPE B 6"	SQYD	700	700	
35300300	PORTLAND CEMENT CONCRETE BASE COURSE, 8"	SQYD	1,230	1,230	
		3			
40600100	BITUMINOUS MATERIALS (PRIME COAT)	GAL	2,200	2,200	
40600300	AGGREGATE (PRIME COAT)	TON	45	45	
40600625	LEVELING BINDER (MACHINE METHOD), N50	TON	1,350	1,350	
40603080	HOT-MIX ASPHALT BINDER COURSE, IL-19.0, N50	TON	175	175	
40603335	HOT-MIX ASPHALT SURFACE COURSE, MIX "D", N50	TON	2,025	2,025	
42101300	PROTECTIVE COAT	SQYD	7,175	7,175	
42300300	PORTLAND CEMENT CONCRETE DRIVEWAY PAVEMENT, 7 INCH	SQYD	2,700	2,700	
42400200	PORTLAND CEMENT CONCRETE SIDEWALK, 5 INCH	SQFT	12,750	12,750	
42400800	DETECTABLE WARNINGS	SQFT	1,100	1,100	
44000100	PAVEMENT REMOVAL	SQYD	1,400	1,400	
44000198	HOT-MIX ASPHALT SURFACE REMOVAL, VARIABLE DEPTH	SQYD	14,250	14,250	
44000200	DRIVEWAY PAVEMENT REMOVAL	SQYD	2,700	2,700	
44000600	SIDEWALK REMOVAL	SQFT	12,750	12,750	
44001900	COMBINATION CURB AND GUTTER REMOVAL (SPECIAL)	FOOT	13,775	13,775	
60213800	RESTRICTED DEPTH CATCH BASINS, 4' DIAMETER, TYPE 1 FRAME, OPEN LID	EACH	39	39	
60224600	RESTRICTED DEPTH MANHOLES, 4' DIAMETER, TYPE 1 FRAME, CLOSED LID	EACH	3	3	
60234200	INLETS, TYPE A, TYPE 1 FRAME, OPEN LID	EACH	13	13	
60250200	CATCH BASINS TO BE ADJUSTED	EACH	9	9	
60255500	MANHOLES TO BE ADJUSTED	EACH	13	13	
60257900	MANHOLES TO BE RECONSTRUCTED	EACH	24	24	
60265700	VALVE VAULTS TO BE ADJUSTED	EACH	3	3	
60406500	FRAMES AND LIDS, SPECIAL	EACH	30	30	
60500050	REMOVING CATCH BASINS	EACH	6	6	
67100100	MOBILIZATION	LUSM	1	1	

* DENOTES SPECIALTY ITE

CODE	SUMMARY OF QUANTITIES		TOTAL	1000-2A 80% FEDERA
CODE	PAY ITEM	UNIT	QUANTITY	20% LOCAL
70101800	TRAFFIC CONTROL AND PROTECTION (SPECIAL)	L SUM	1	1
78000400	THERMOPLASTIC PAVEMENT MARKING - LINE 6"	FOOT	2,842	2,842
78000650	THERMOPLASTIC PAVEMENT MARKING - LINE 24"	FOOT	375	375
X0323426	SEDIMENT CONTROL, DRAINAGE STRUCTURE INLET FILTER CLEANING	EACH	60	60
X0325207	TELEVISION INSPECTION OF SEWER	FOOT	2,900	2.900
			2,000	2,000
X4420132	CLASS D PATCHES (SPECIAL)	SQYD	5,820	5,820
VV004296	CDECIAL EVOLUTION	0111/10		
XX001286 XX003036	SPECIAL EXCAVTION	CUYD	300	300
XX003036	STORM SEWERS, PVC, SDR 26, 10 INCH	FOOT	1,255	1,255
XX004208	SEWER SERVICE LATERAL REPAIR, 6" POLYVINYL CHLORIDE	FOOT	200	200
XX005565	REMOVE AND RESET BRICK PAVERS	SQFT	150	150
XX005634	12" X 6" PVC SEWER SERVICE CONNECTIONS	EACH	20	20
XX005770	STRUCTURE TO BE ABANDONED	EACH	12	12
XX006452	15" X 6" PVC SEWER SERVICE CONNECTIONS	EACH	10	10
XX006464	DOMESTIC WATER SERVICE BOX TO BE ADJUSTED (SPECIAL)	EACH	10	10
Z0018900	DRILL AND GROUT DOWEL BARS	EACH	685	685
Z0076600	TRAINEES	HOUR	500	500
XX005689	STORM SEWERS, DIP CLASS 52, 10"	FOOT	50	50
XX007154	18" X 6" SEWER SERVICE CONNECTIONS	EACH	3	3
				100-0-0
XX007155	27" X 6" SEWER SERVICE CONENCTIONS	EACH	13	13
XX007156	12" DIAMETER, PVC STORM SEWER PIPE REPLACEMENT (POINT REPAIR)	FOOT	375	3.75
ANUUTISES	The second of th	1001	0.0	3,3
XX007157	15" DIAMETER, PVC STORM SEWER PIPE REPLACEMENT (POINT REPAIR)	FOOT	60	60
XX007158	18" DIAMETER, PVC STORM SEWER PIPE REPLACEMENT (POINT REPAIR)	FOOT	70	70
ANUUIIJO	The state of the s	, , , , ,	70	10.
XX007159	27" DIA. RCP, C-76 W/C-443 JOINTS, CLASS III, STORM SEWER (POINT REPAIR)	FOOT	300	300
 XX00067/	COMBINATION CONCRETE CURB AND GUTTER, TYPE B-4.12	FOOT	13,775	13,775
,	SOME THE DATE OF T		10,770	13,773


* DENOTES SPECIALTY ITEM

D 4080

HIGH PRIORITY PROJECT HPP-2902 (002) **BRISTOL AVENUE & DOVER STREET** VILLAGE OF WESTCHESTER, ILLINOIS


SUMMARY OF QUANTITIES

 SCALE:	NONE	Т
DRAWN BY:	ECW/LEV	٦
B00K NO.:	1541	٦
DATE:	10-2-07	7
E.H.E. NO.:	838-06-38501	1

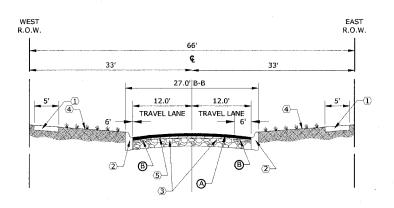

EXISTING TYPICAL CROSS SECTION


BRISTOL AVENUE STATION 0+90 TO STATION 26+43 (FRONTAGE ROAD TO CANTERBURY STREET)

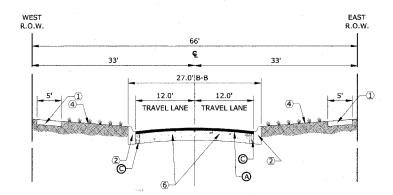

EXISTING TYPICAL CROSS SECTION

BRISTOL AVENUE


STATION 26+43 TO STATION 39+64 (CANTERBURY STREET TO DICKENS STREET)

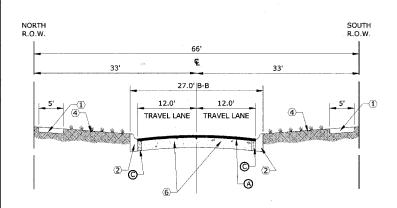

EXISTING TYPICAL CROSS SECTION


DOVER STREET

STATION 0+80 TO STATION 13+87 (WESTCHESTER BOULEVARD TO SUFFOLK AVENUE)

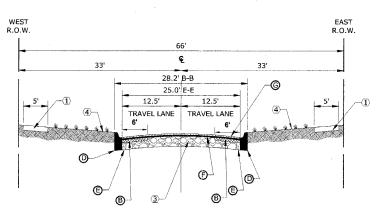

PROPOSED TYPICAL CROSS SECTION


BRISTOL AVENUE STATION 0+90 TO STATION 26+43 (FRONTAGE ROAD TO CANTERBURY STREET)

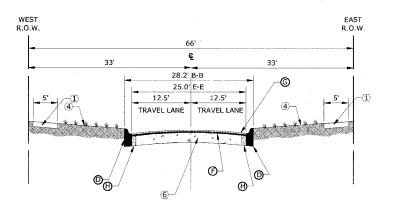

PROPOSED TYPICAL CROSS SECTION

BRISTOL AVENUE


STATION 26+43 TO STATION 39+64 (CANTERBURY STREET TO DICKENS STREET)

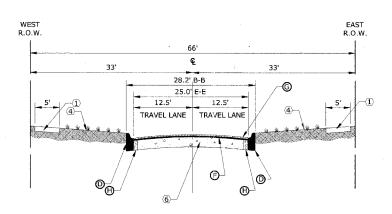

PROPOSED TYPICAL CROSS SECTION

DOVER STREET


STATION 0+80 TO STATION 13+87 (WESTCHESTER BOULEVARD TO SUFFOLK AVENUE)

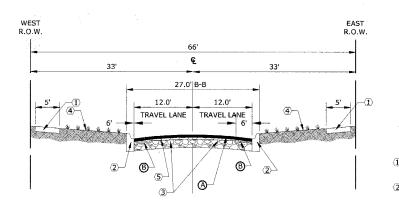

EXISTING TYPICAL CROSS SECTION

DOVER STREET


STATION 13+87 TO STATION 27+00 (SUFFOLK TO GARDNER ROAD)

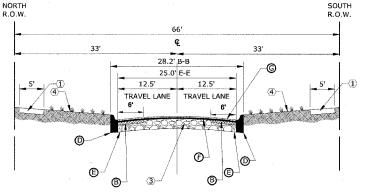

PROPOSED TYPICAL CROSS SECTION

DOVER STREET

STATION 13+87 TO STATION 27+00 (SUFFOLK TO GARDNER ROAD)

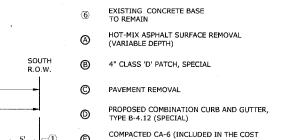

OF THE CURB AND GUTTER)

LEVELING BINDER (MACHINE METHOD), N50 HOT-MIX ASPHALT SURFACE COURSE, MIX D,

PORTLAND CEMENT CONCRETE BASE COURSE, 8"

COOK

HPP 2902 (002)

06-00071-00-FP

LEGEND EXISTING PORTLAND CEMENT CONCRETE

EXISTING AGGREGATE BASE COURSE

EXISTING COMBINATION CURB AND GUTTER,

EXISTING SODDED PARKWAY (SOD WILL BE REPLACED ADJACENT TO NEW CONCRETE)

EXISTING HOT-MIX ASPHALT PAVEMENT

CONTRACT NO. 83983

SIDEWALK, 5 INCH

TYPE B-6.12

NOTE: ALL EXISTING AND PROPOSED CROSS SLOPES VARY BETWEEN 2% - 6%.

HOT-MIX ASPHALT MIXTURE REQUIREMENTS			
MIXTURE TYPE	AC TYPE	AIR VOIDS	
HOT-MIX ASPHALT SURFACE COURSE, MIX "D", N50, 1 ½" (IL - 9.5mm)	PG 64-22	4% @ 50 GYR	
LEVELING BINDER MACHINE METHOD, N50, 1" (IL - 9.5mm)	PG 64-22 *	4% @ 50 GYR	
CLASS D PATCHES, TYPE I, II, III AND IV, 4", (BINDER IL-19 MM)	PG 64-22 *	4% @ 70 GYR	
HOT-MIX ASPHALT BINDER COURSE, IL-19.0, N50, 4" (FOR USE IN RECONSTRUCTS)	PG 64-22 *	4% @ 50 GYR	

THE UNIT WEIGHT USED TO CALCULATE ALL HOT-MIX ASPHALT SURFACE MIXTURE QUANTITIES IS 112 LBS/SQYD/IN.

* WHEN RAP EXCEEDS 20%, THE NEW ASPHALT BINDER IN THE MIX SHALL BE PG 58-22

ANCOCK

† Civil Engineers


† Municipal Consultants

† Established 1911

ester, Illinois 60154-2780 Phone: 708/865-0300 **HIGH PRIORITY PROJECT HPP-2902 (002) BRISTOL AVENUE & DOVER STREET VILLAGE OF WESTCHESTER, ILLINOIS**

TYPICAL CROSS SECTIONS

	SCALE:	NONE	SH
	DRAWN BY:	ECW/LEV	
	BOOK NO::	1541	
	DATE:	10-2-07	
REVISION:	E.H.E. NO.:	838-06-38501	OF

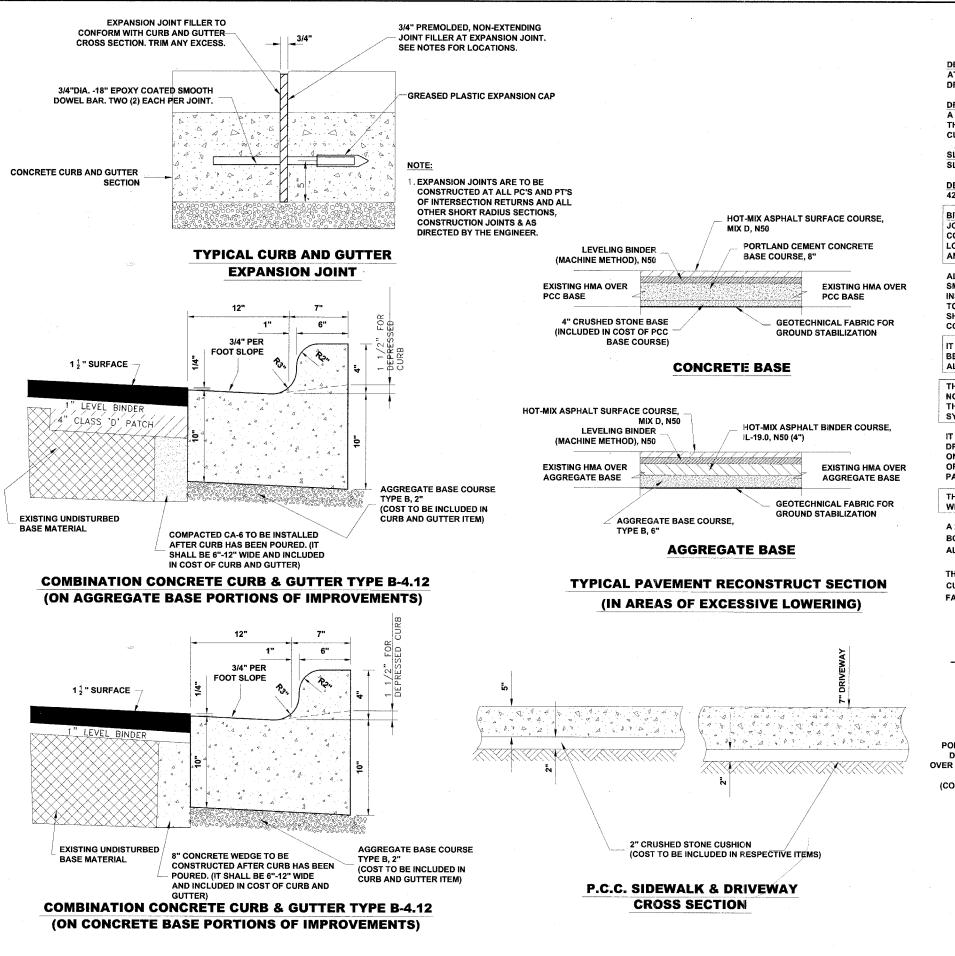

GENERAL NOTES

		соок	22	NO. 6
ILLINOIS PROJECT	HPP 29	02 (002)		
VILLAGE SECTION	06-0007	1-00-FP		

DEPRESSED CURBS - THE TOP OF CURBS SHALL BE DEPRESSED WHERE THE CURB AND GUTTER IS CONSTRUCTED AT HANDICAP ACCESSIBLE SIDEWALK RAMPS AT ALLEY RETURNS AND STREET INTERSECTIONS, AND FOR PRIVATE DRIVES AND AS DIRECTED BY THE ENGINEER

DRAINAGE OPENINGS - AT ALL LOCATIONS WHERE CASTINGS ARE TO BE INCORPORATED IN THE CURB AND GUTTER. A 3/4" EXPANSION JOINT SHALL BE INSTALLED IN THE CURB AND GUTTER A DISTANCE OF 5 FT. FROM EACH SIDE OF THE CASTING. 2-NO. 4 RE-BARS, 9' IN LENGTH, SHALL BE INCORPORATED IN THE CONTINUOUS PORTION OF CONCRETE

SLIPFORM CONSTRUCTION - VERTICAL FACES MAY BE BATTERED AT THE RATE OF 3/4" PER FOOT OF HEIGHT TO AID IN SLIPFORM OPERATIONS

DEPRESSED CURB HEIGHT - THE HEIGHT OF THE DEPRESSED CURB SHALL BE 1-1/2" AT DRIVEWAYS. SEE IDOT STANDARD 424001-04 FOR HEIGHT AT SIDEWALK RAMP.

BITUMINOUS EXPANSION JOINTS - THREE QUARTER INCH (3/4") BITUMINOUS PREMOLDED INORGANIC FIBER EXPANSION JOINTS SHALL BE INSTALLED WHERE NEW SIDEWALK OR CURB AND GUTTER OR DRIVEWAY PAVEMENT ABUTS AN EXISTING CONCRETE WALK, DRIVE, OR CURB WHICH IS TO REMAIN IN PLACE, AND AT NOT LESS THAN NINETY FOOT (90') INTERVALS AY LOCATIONS WHERE CURB REPLACEMENT IS IN EXCESS OF NINETY FEET (96'); AT RADIUS POINTS, AT BOTH SIDES OF FRAMES AND GRATES WHICH FALL IN THE CURB: AND AS DIRECTED BY THE ENGINEER.

ALL EXPANSION JOINTS LOCATED IN THE CURB AND GUTTER SHALL HAVE TWO (2) THREE QUARTER INCH (3/4") DIAMETER, SMOOTH, ROUND, EPOXY COATED DOWEL BARS, EIGHTEEN INCHES (18") IN LENGTH, WITH GREASED PLASTIC ÉND CAPS INSERTED TO ALLOW THE CURB AND GUTTER TO EXPAND AND CONTRACT LATERALLY. CONTRACTION JOINTS SHALL BE TOOLED INTO THE CURB AND GUTTER AT INTERVALS NOT TO EXCEED FIFTEEN FEET (15'). THESE CONTRACTION JOINTS SHALL BE SAW CUT TO A DEPTH OF TWO INCHES (2") WITHIN TWENTY-FOUR (24) HOURS OF CONCRETE PLACEMENT. THE COST OF THE ABOVE WORK SHALL BE INCLUDED INT THE RESPECTIVE ITEMS FOR CONCRETE INSTALLATION.

IT WILL BE THE CONTRACTOR'S RESPONSIBILITY TO PROTECT EXISTING STREET LIGHT CABLES. THE CONTRACTOR WILL BE REQUIRED TO RESTORE WIRES AND CONDUIT IF THEY ARE DAMAGED BY HIS WORK. THE CONTRACTOR WILL NOT BE ALLOWED TO SPLICE ANY WIRES THAT ARE REPAIRED.


THE VILLAGE WILL PASS OUT A LETTER REQUESTING THAT ALL RESIDENTS WITH SPRINKLER SYSTEMS IN THE PARKWAY NOTIFY THE VILLAGE PRIOR TO CONSTRUCTION. THE VILLAGE WILL THEN MARK THE SPRINKLER HEADS ON THESE SYSTEMS. THE CONTRACTOR WILL BE RESPONSIBLE FOR ALL COSTS FOR REPAIRING ANY DAMAGE THAT IS DONE TO EXISTING SPRINKLER SYSTEMS THAT HAVE BEEN LOCATED BY THE VILLAGE PRIOR TO THE DAMAGE BEING DONE

IT SHALL BE THE CONTRACTOR'S RESPONSIBILITY TO TAKE PRECAUTIONS SO AS NOT TO DAMAGE EXISTING SIDEWALKS, DRIVEWAYS, AND PAVEMENTS OUTSIDE THE LIMITS OF RESTORATION. THE GENERAL LIMITS OF RESTORATION ARE SHOWN ON THE PLANS. THE ENGINEER WILL MARK OUT THE EXACT LIMITS OF REMOVAL FOR THESE ITEMS PRIOR TO THE COMMENCEMENT OF WORK. THE CONTRACTOR SHALL BE RESPONSIBLE FOR RESTORING ANY DAMAGE TO SIDEWALKS, DRIVEWAYS, AND PAVEMENTS OUTSIDE OF THESE LIMITS TO THE SATISFACTION OF THE ENGINEER AND THE VILLAGE AT HIS OWN EXPENSE.

THE COSTS FOR REMOVAL OF ANY ASPHALT OVERLAY THAT EXTENDS INTO THE GUTTER PORTION OF THE CURB AND GUTTER WILL BE INCLUDED IN THE PRICE FOR COMBINATION CURB AND GUTTER REMOVAL

A 2" X 6" BOARD WILL BE USED AS A FORM FOR ALL SIDEWALKS TO BE INSTALLED FIVE INCHES (5") IN THICKNESS, A 2" X 8" BOARD WILL BE USED AS A FORM FOR ALL SIDEWALKS AND DRIVEWAYS TO BE INSTALLED SEVEN INCHES (7") IN THICKNESS. ALL FORMS MUST BE A MINIMUM HEIGHT OF THE PROPOSED THICKNESS OF THE RESPECTIVE CONCRETE ITEM TO BE INSTALLED.

THE CONTRACTOR SHALL HAVE WATCHMEN AT THE JOB SITE AFTER CONCRETE HAS BEEN POURED UNTIL THE CONCRETE HAS CURED SUFFICIENTLY SO THAT NO GRAFITTI CAN BE INSCRIBED IN THE NEWLY POURED CONCRETE SURFACES. THE EXPOSED FACES OF CONCRETE OF ANY ITEMS THAT ARE DEFACED SHALL BE REPLACED BY THE CONTRACTOR AT HIS OWN EXPENSE.

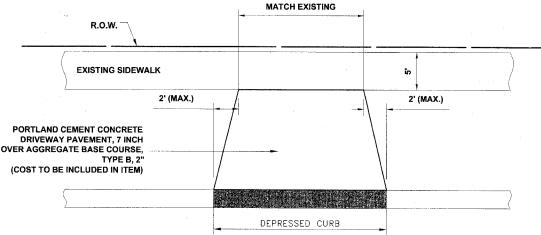


DRIVEWAY DETAIL

Municipal Consultants


Phone: 708/865-0300 Fax: 708/865-1212 **HIGH PRIORITY PROJECT HPP-2902 (002) BRISTOL AVENUE & DOVER STREET VILLAGE OF WESTCHESTER, ILLINOIS**

ROADWAY DETAILS

	SCALE:	NONE	SHE
	DRAWN BY:	ECW/LEV	□ 6
	BOOK NO.:	1541	7
	DATE:	10-2-07	7 /
N:	E.H.E. NO.:	838-06-38501	OF

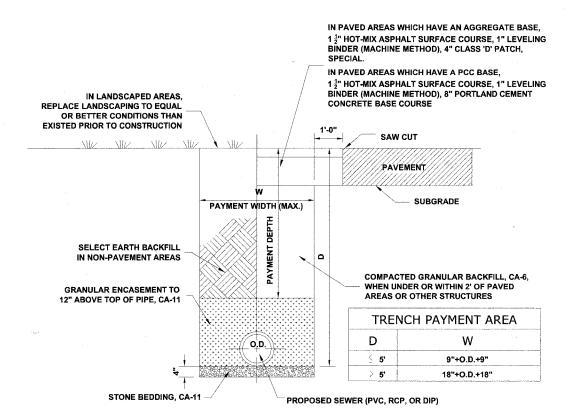

TYPICAL SEWER TRENCH DETAIL

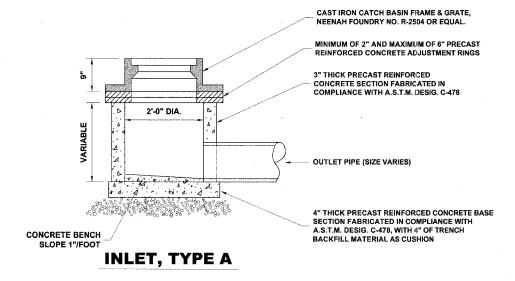

соок HPP 2902 (002) 06-00071-00-FP VILLAGE SECTION CONTRACT NO. 83983

DRAINAGE AND UTILITIES NOTES

THE LOCATIONS OF EXISTING DRAINAGE STRUCTURES, STORM SEWERS, COMBINED SEWERS, TELEPHONE LINES, COMMUNICATION LINES, ELECTRIC LINES, GAS, MAINS, AND WATER SERVICES ARE APPROXIMATE AND THEIR SPECIFIC LOCATIONS ARE TO BE DETERMINED IN THE FIELD AT NO COMPENSATION TO THE CONTRACTOR.

COORDINATION OF ALL UTILITY WORK INVOLVED WITHIN THE CONSTRUCTION AREAS SHALL BE SUBJECT TO DISCUSSION AND CLARIFICATION AT A PRECONSTRUCTION MEETING.

WHEN EXISTING DRAINAGE FACILITIES ARE DISTURBED, THE CONTRACTOR SHALL PROVIDE AND MAINTAIN TEMPORARY OUTLETS AND CONNECTIONS FOR ALL PRIVATE OR PUBLIC DRAINAGE STRUCTURES OR SEWERS UNTIL PERMANENT CONNECTIONS TO SEWERS ARE BUILT AND IN SERVICE. THIS WORK SHALL NOT BE PAID FOR DIRECTLY, BUT SHALL BE CONSIDERED INCIDENTAL TO THE CONTRACT.

WHEN, DURING CONSTRUCTION OPERATIONS, ANY LOOSE MATERIALS ARE DEPOSITED IN THE FLOW LINES OF GUTTERS OR DRAINAGE STRUCTURES SO THAT THE NATURAL FLOW OF WATER IS OBSTRUCTED. THE OBSTRUCTING MATERIALS SHALL BE REMOVED AT THE CLOSE OF EACH WORK DAY. AT THE CONCLUSION OF THE CONSTRUCTION OPERATIONS, ALL DRAINAGE STRUCTURES ARE TO BE FREE OF ALL DIRT, DEBRIS, AND OBSTRUCTING MATERIALS. THE WORK SPECIFIED ABOVE WILL NOT BE PAID FOR SEPARATELY, BUT SHALL BE CONSIDERED AS INCIDENTAL TO THE CONTRACT.

ALL COSTS INVOLVED IN CONNECTING OF PROPOSED STORM SEWERS AND STORM STRUCTURES TO EXISTING STORM SEWERS OR PROPOSED STORM SEWERS SHALL BE INCIDENTAL TO THE COST OF THE CONTRACT.

ALL PROPOSED WATER MAINS SHALL BE INSTALLED IN ACCORDANCE WITH IN THE "STANDARD SPECIFICATIONS FOR WATER AND SEWER MAIN CONSTRUCTION IN ILLINOIS", FIFTH EDITION, DATED 1996, AND ALL REVISIONS

THE CONTRACTOR SHALL VERIFY THE TYPE OF ALL WATER MAIN HARDWARE INCLUDING VALVES, FIRE HYDRANTS, VALVE BOXES, CORPORATION STOPS, CURB STOPS, AND WATER SERVICES BOXES WITH THE UTILITY SUPERINTENDENT PRIOR TO ORDERING SUCH MATERIAL.

ANY COSTS FOR SHEETING OR SHORING REQUIRED FOR THE STORM SEWER INSTALL ATION OR OTHER CONSTRUCTION ELEMENTS REQUIRING RELATIVELY DEEP EXCAVATIONS SHALL BE INCLUDED IN THE PARTICULAR PAYMENT ITEM AND NO ADDITIONAL COMPENSATION WILL BE ALLOWED FOR ANY SUPPLEMENTAL WORK ASSOCIATED WITH THE MAINTENANCE OF TRENCH SIDES OR OTHER EXCAVATED AREAS.

SEWER PIPE INSTALLED ON THIS PROJECT SHALL CONFORM TO THE FOLLOWING STANDARD:

TYPE OF PIPE	MATERIAL STANDARD	JOINT STANDARD

REINFORCED CONCRETE PIPE ASTM C-76, CLASS III ASTM C-443 POLYVINYLCHLORIDE PIPE (6"-12") ASTM D-2241 ASTM D-3139 POLYVINYI CHI ORIDE PIPE (15") ASTM D-3034 ASTM D-3212

FINAL ADJUSTMENT OF ALL STRUCTURES IN THE PAVEMENT, INCLUDING THOSE IN THE PROPOSED BASE COURSE, SHALL NOT BE COMPLETED UNTIL AFTER THE PLACEMENT OF THE HOT-MIX ASPHALT BINDER COURSE.

THE AREA WITHIN THE ROUNDOUT SHALL BE FILLED WITH CONCRETE SET TO THE ELEVATION OF THE TOP OF THE PROPOSED BINDER. COST IS TO BE INCLUDED IN THE RESPECTIVE PAY ITEM FOR THE NEW, ADJUSTED OR RECONSTRUCTED STRUCTURE.

ALL NEW STRUCTURES AND STRUCTURES TO BE RECONSTRUCED SHALL BE BUILT WITH PRECAST REINFORCED CONCRETE SECTIONS FABRICATED IN ACCORDANCE WITH A.S.T.M. DESIGNATION C-478.




♦ Municipal Consultants


9933 Roosevelt Road Westchester, Illinois 60154-2780 Phone: 708/865-0300 Fax: 708/865-1212 **HIGH PRIORITY PROJECT HPP-2902 (002) BRISTOL AVENUE & DOVER STREET VILLAGE OF WESTCHESTER, ILLINOIS**

--- COOK 22 HPP 2902 (002) 06-00071-00-FP


CONTRACT NO. **83983**

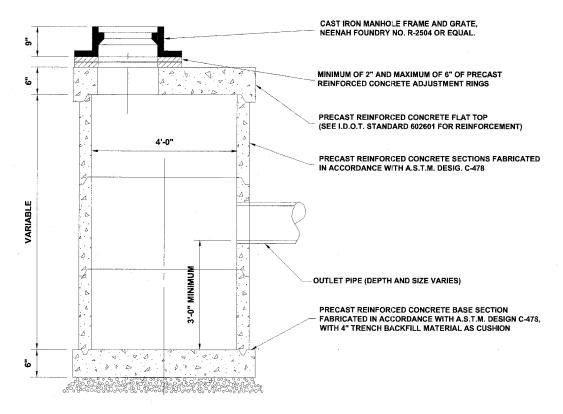

RESTRICTED DEPTH CATCH BASIN

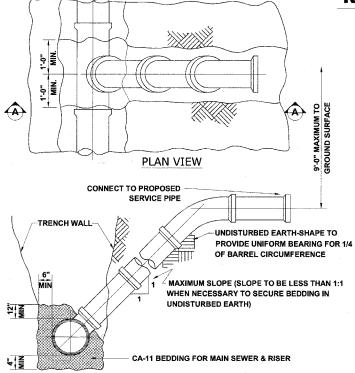

TYPICAL RISER FOR SERVICE LATERAL

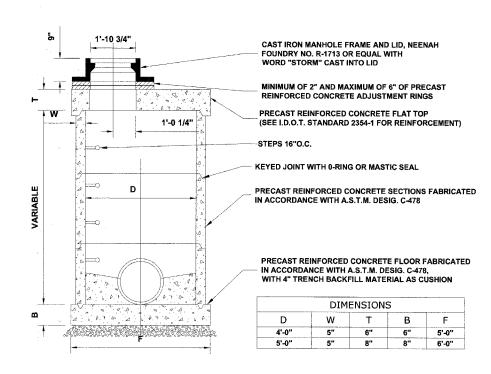


RESTRICTED DEPTH STORM MANHOLE





Westchester, Illinois 60154-2780 Fax: 708/865-1212 **HIGH PRIORITY PROJECT HPP-2902 (002) BRISTOL AVENUE & DOVER STREET VILLAGE OF WESTCHESTER, ILLINOIS**


DRAINAGE DETAILS


	SCALE:	NONE
	DRAWN BY:	ECW/LEV
	BOOK NO.:	1541
	DATE:	10-2-07
ION:	EHE NO:	838-06-38501

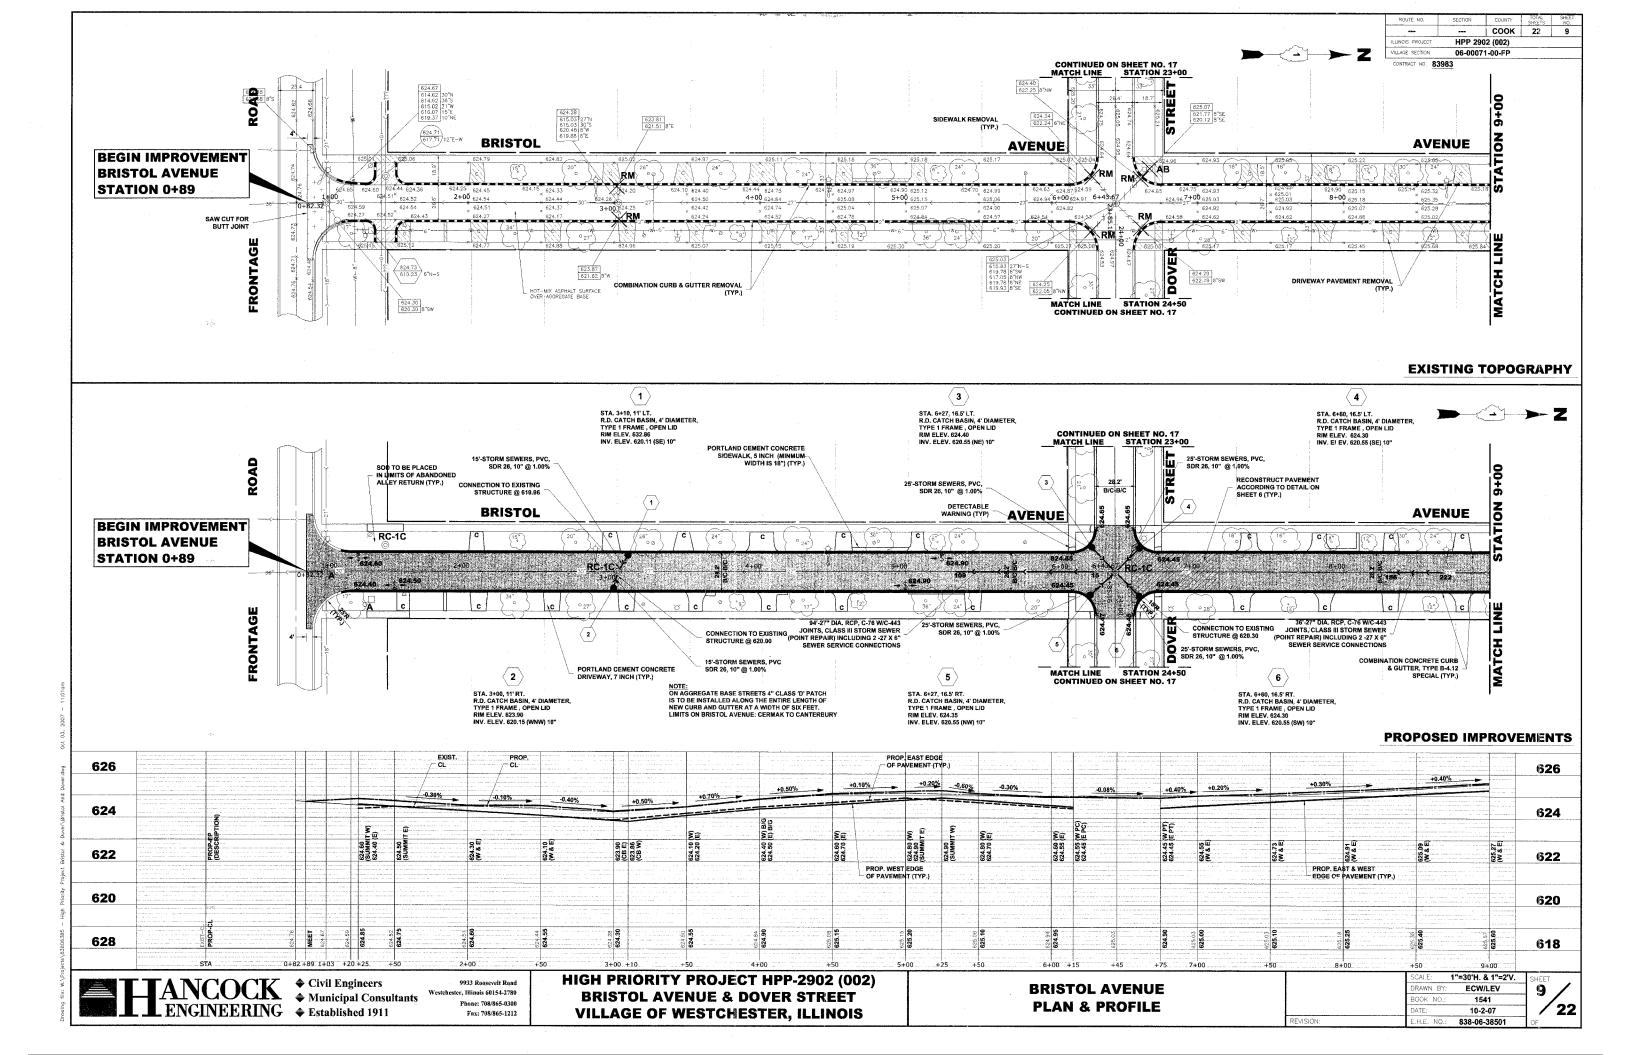


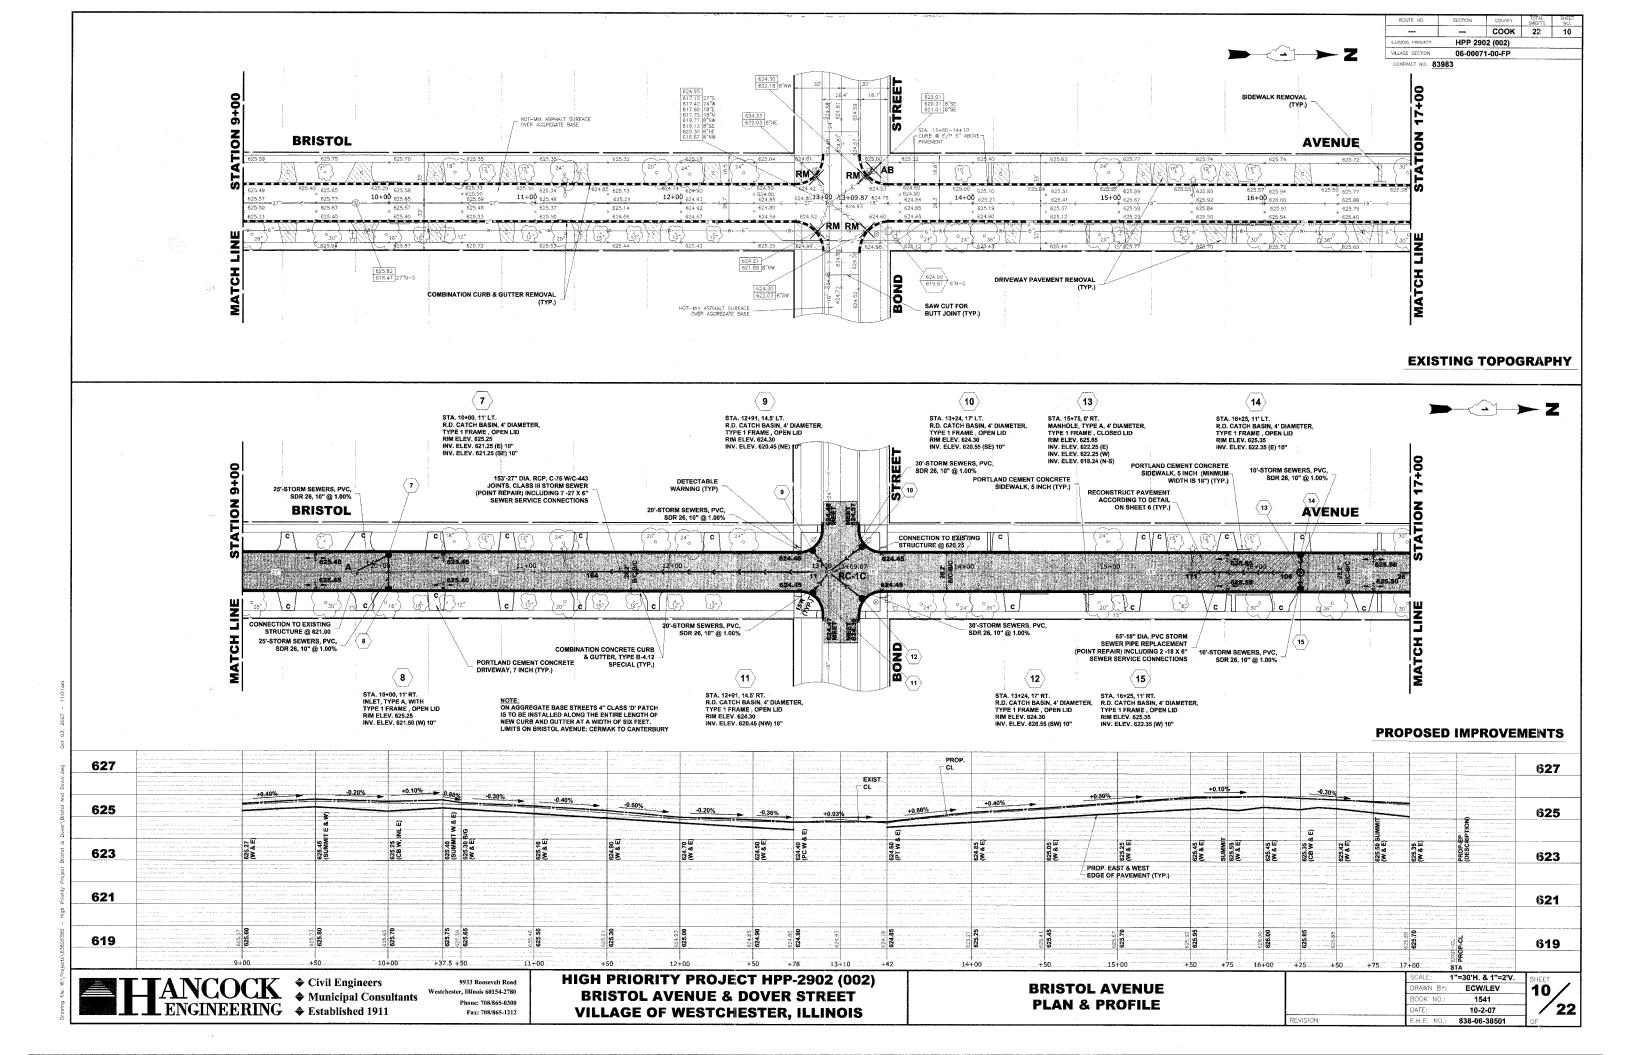


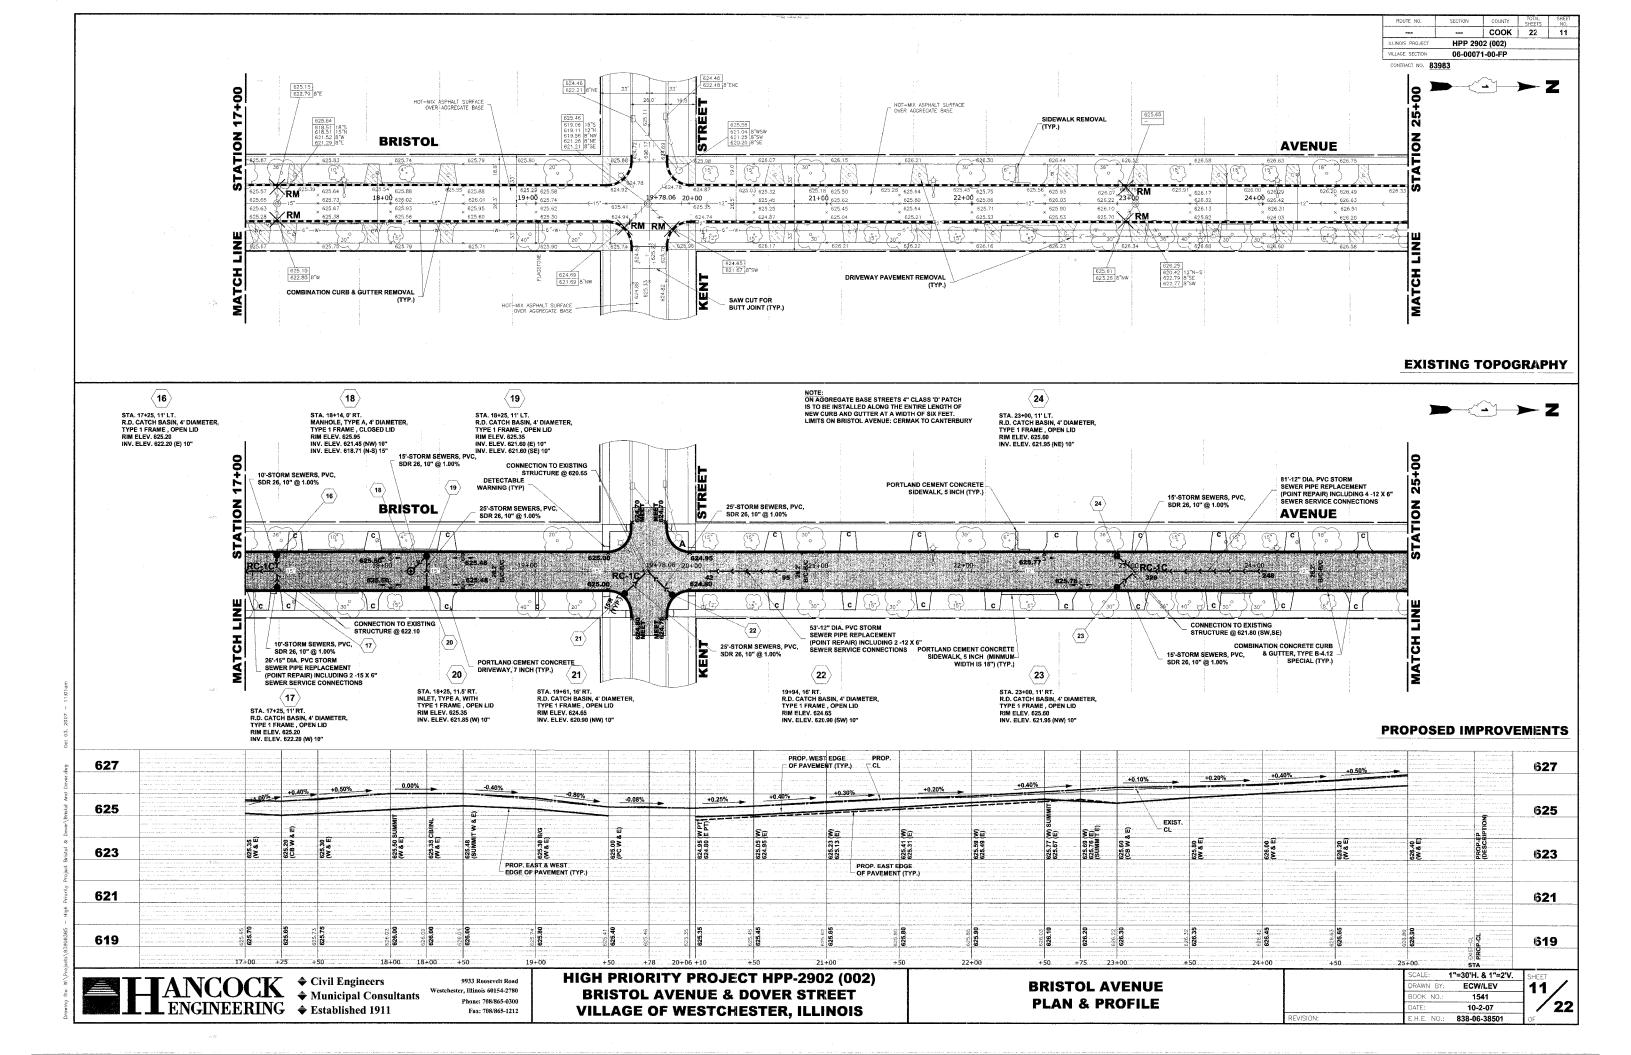


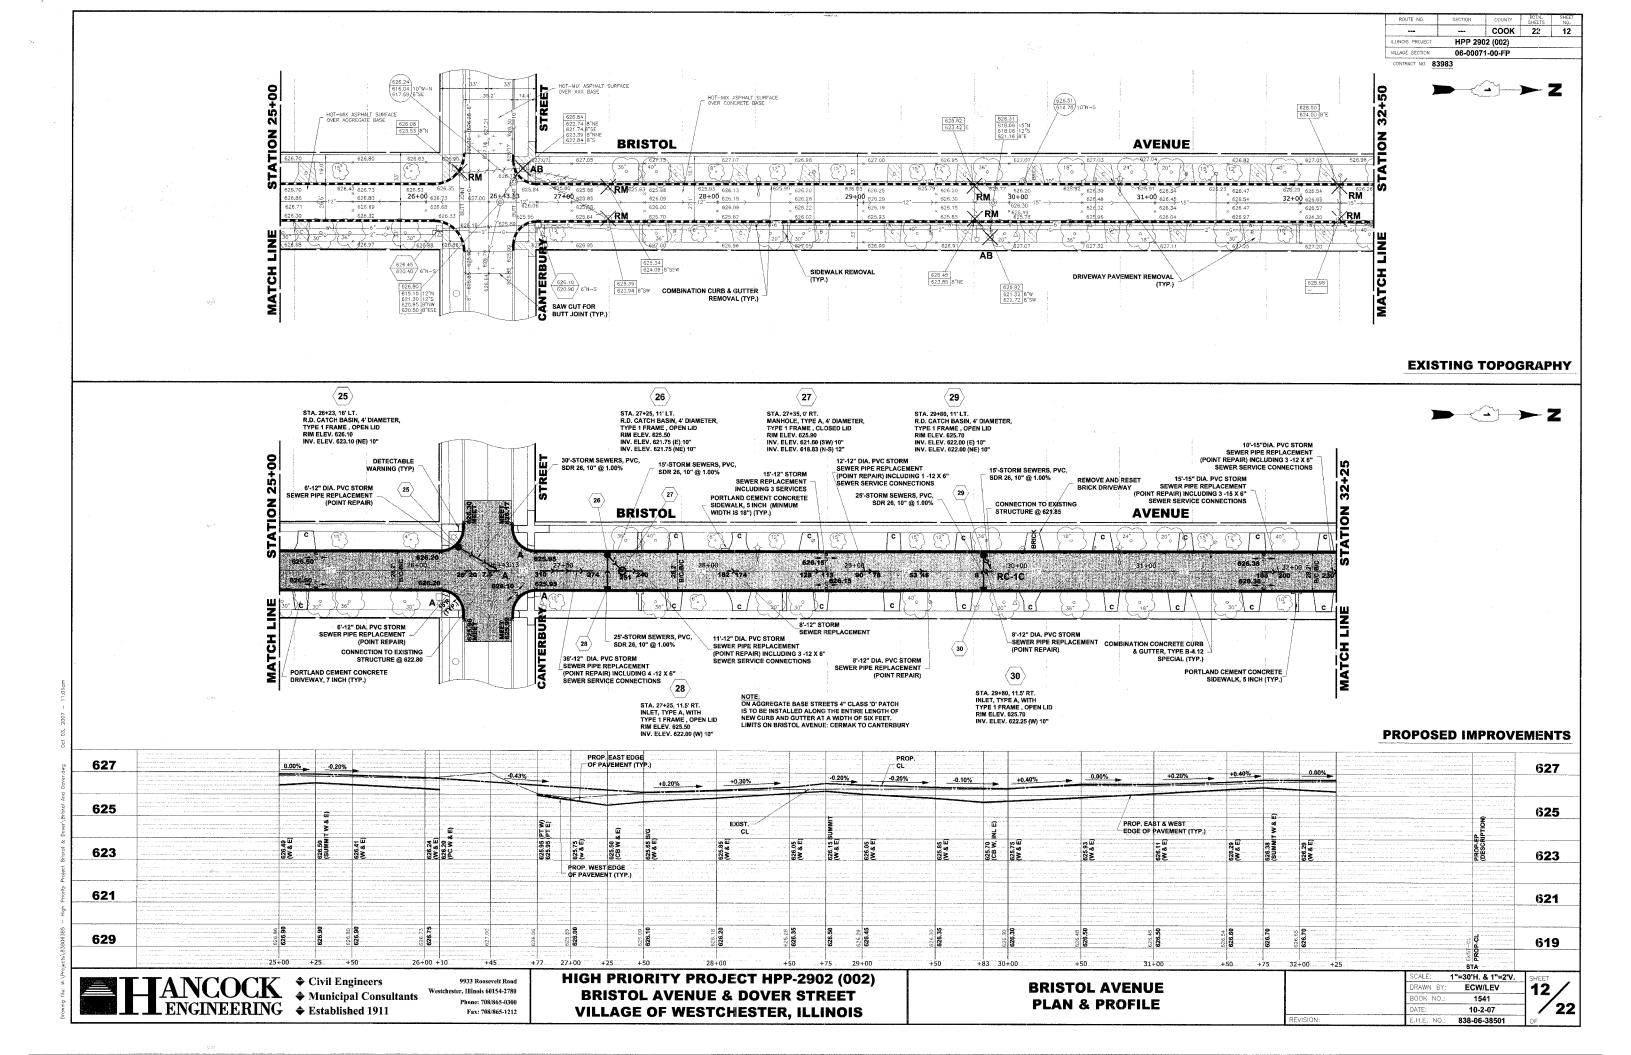


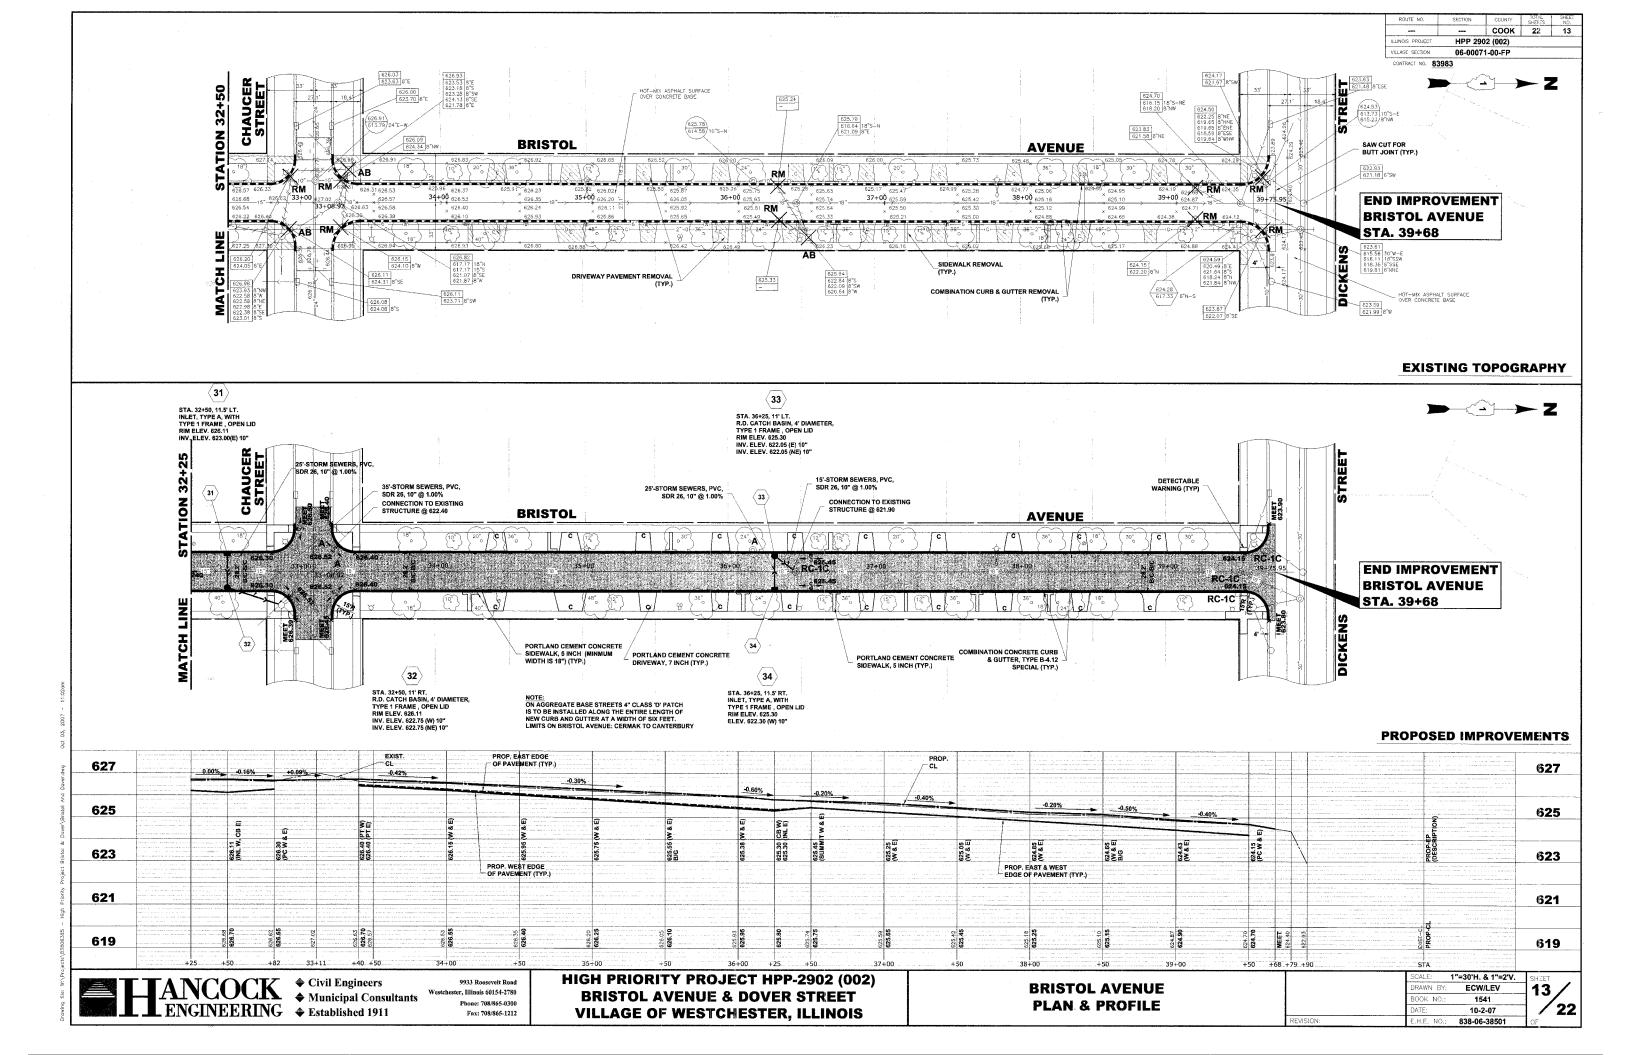


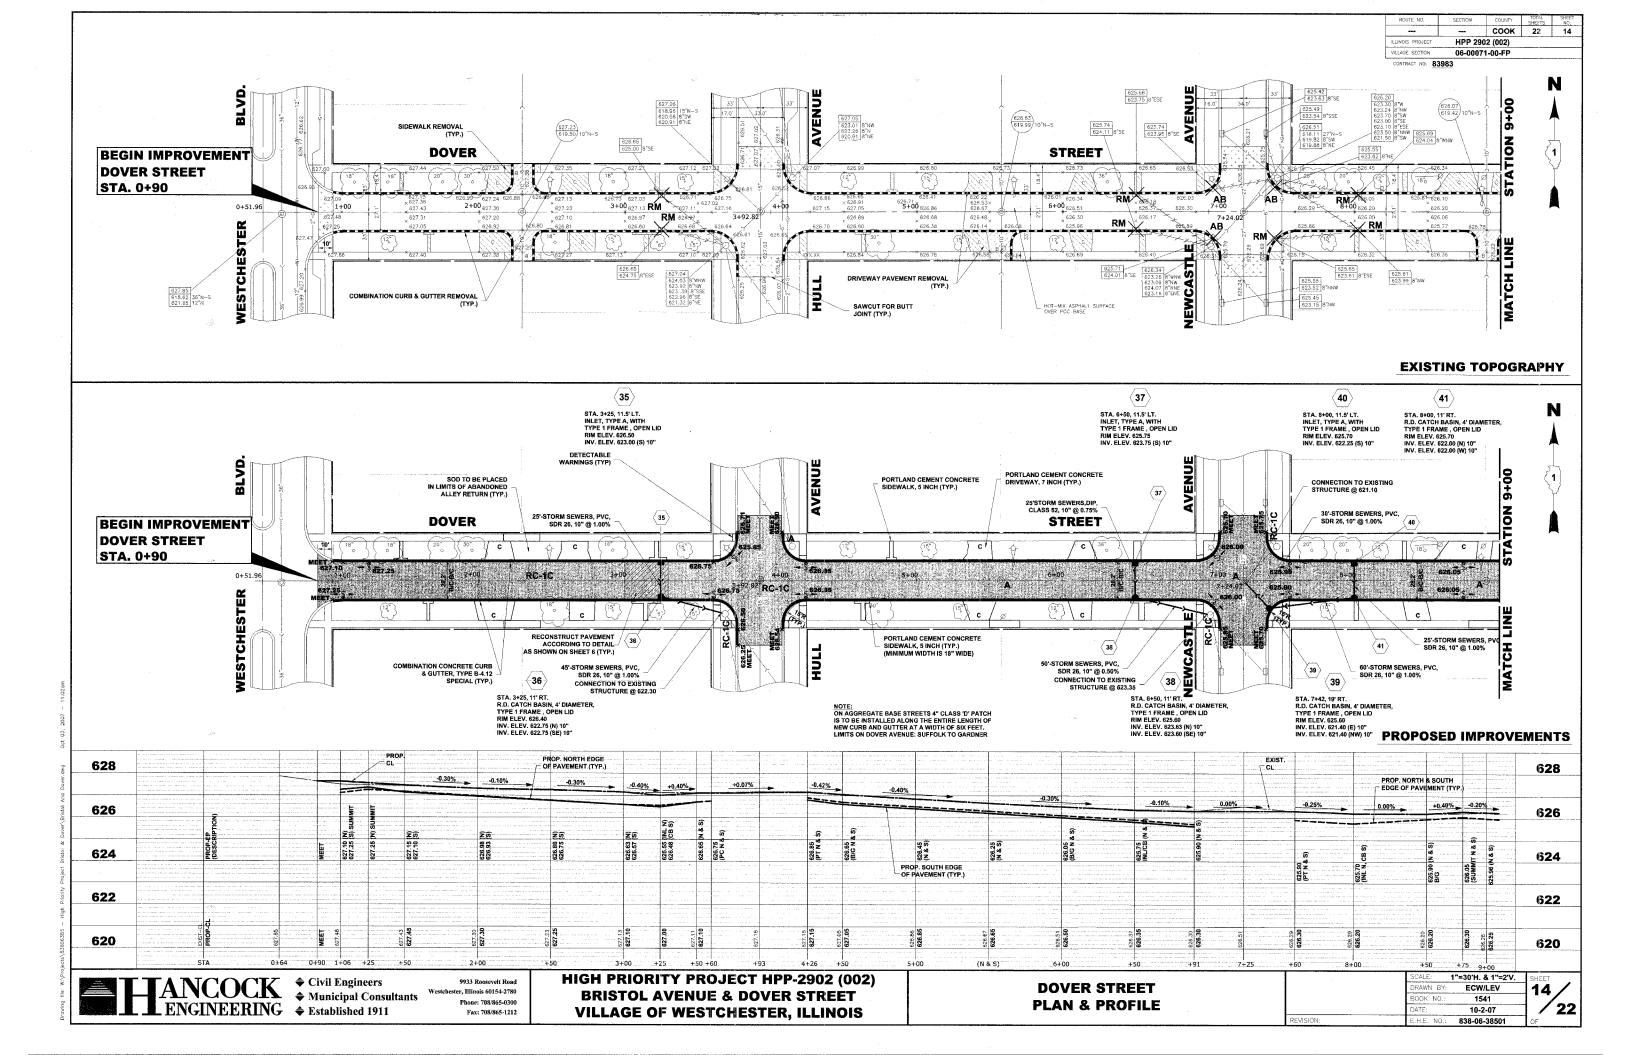


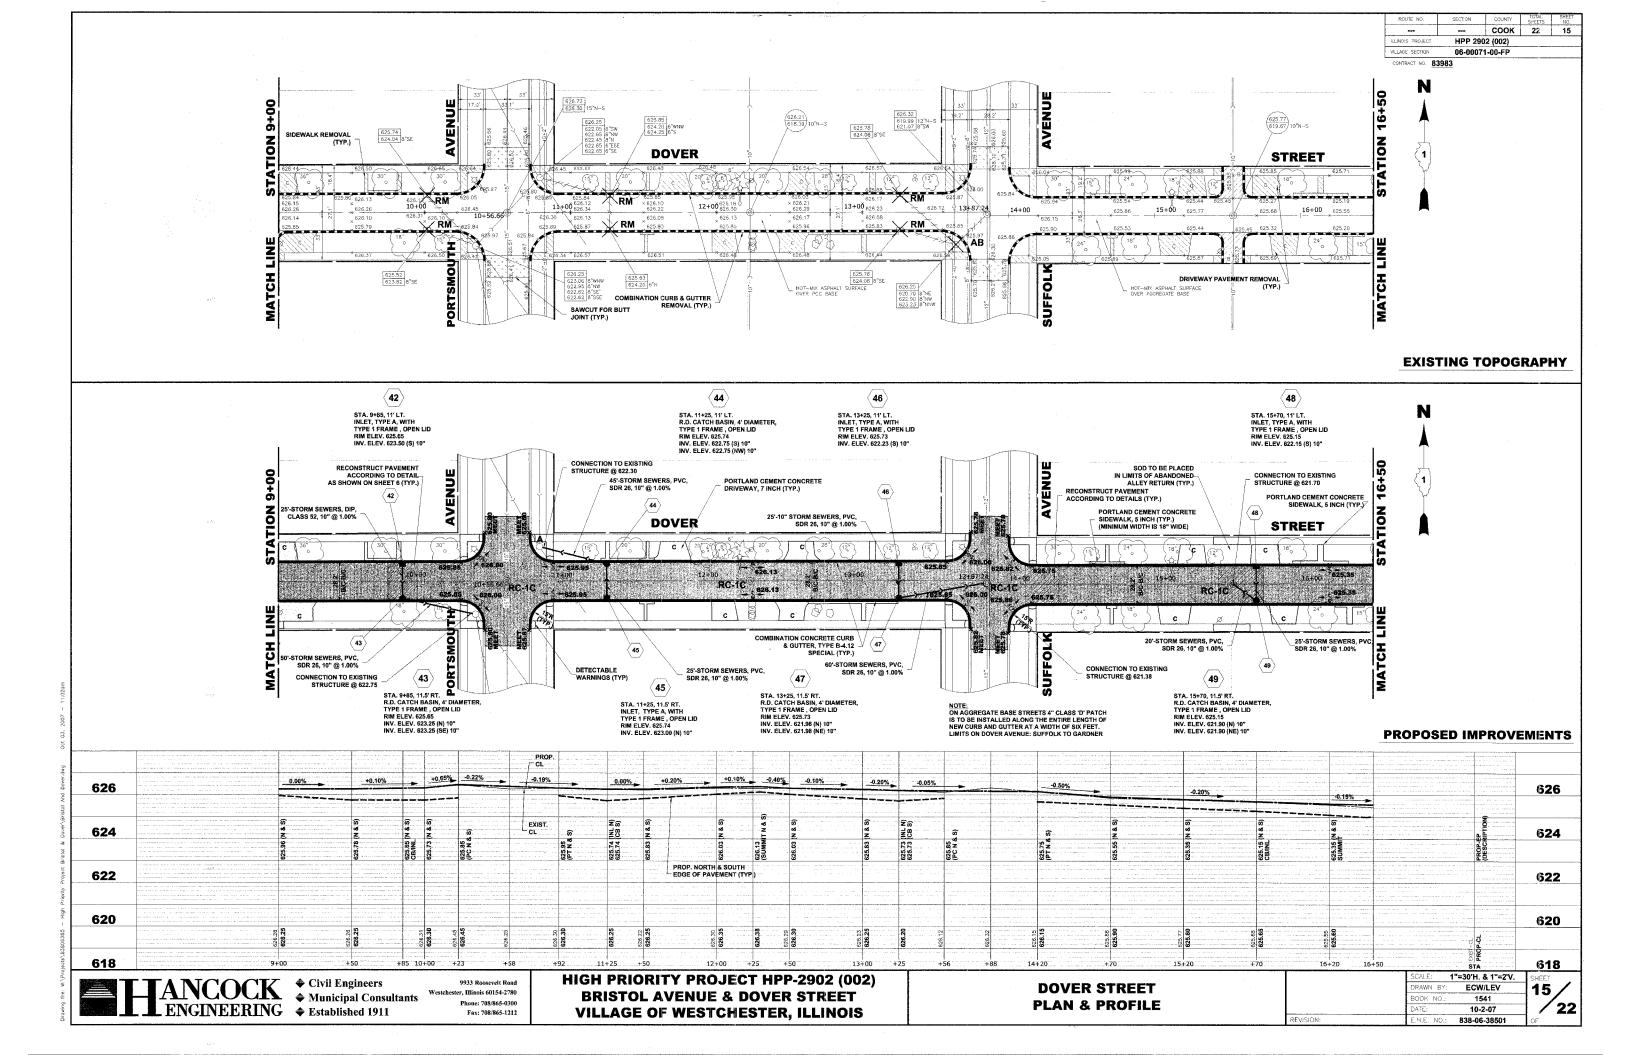

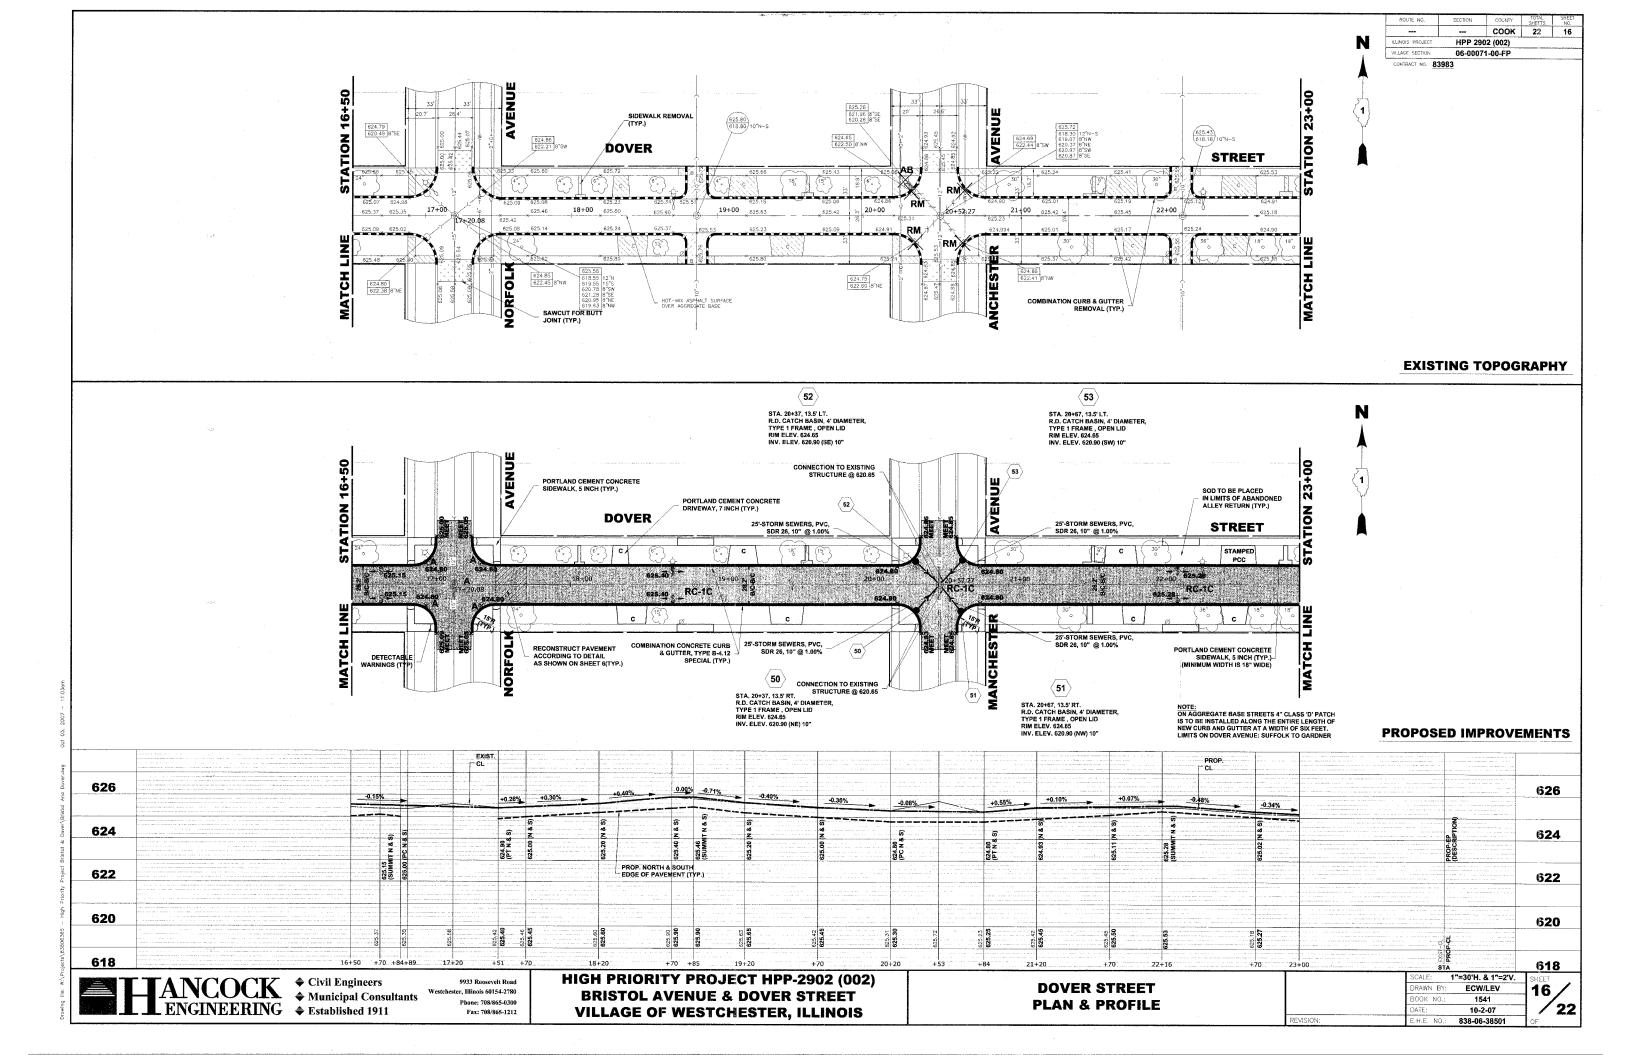

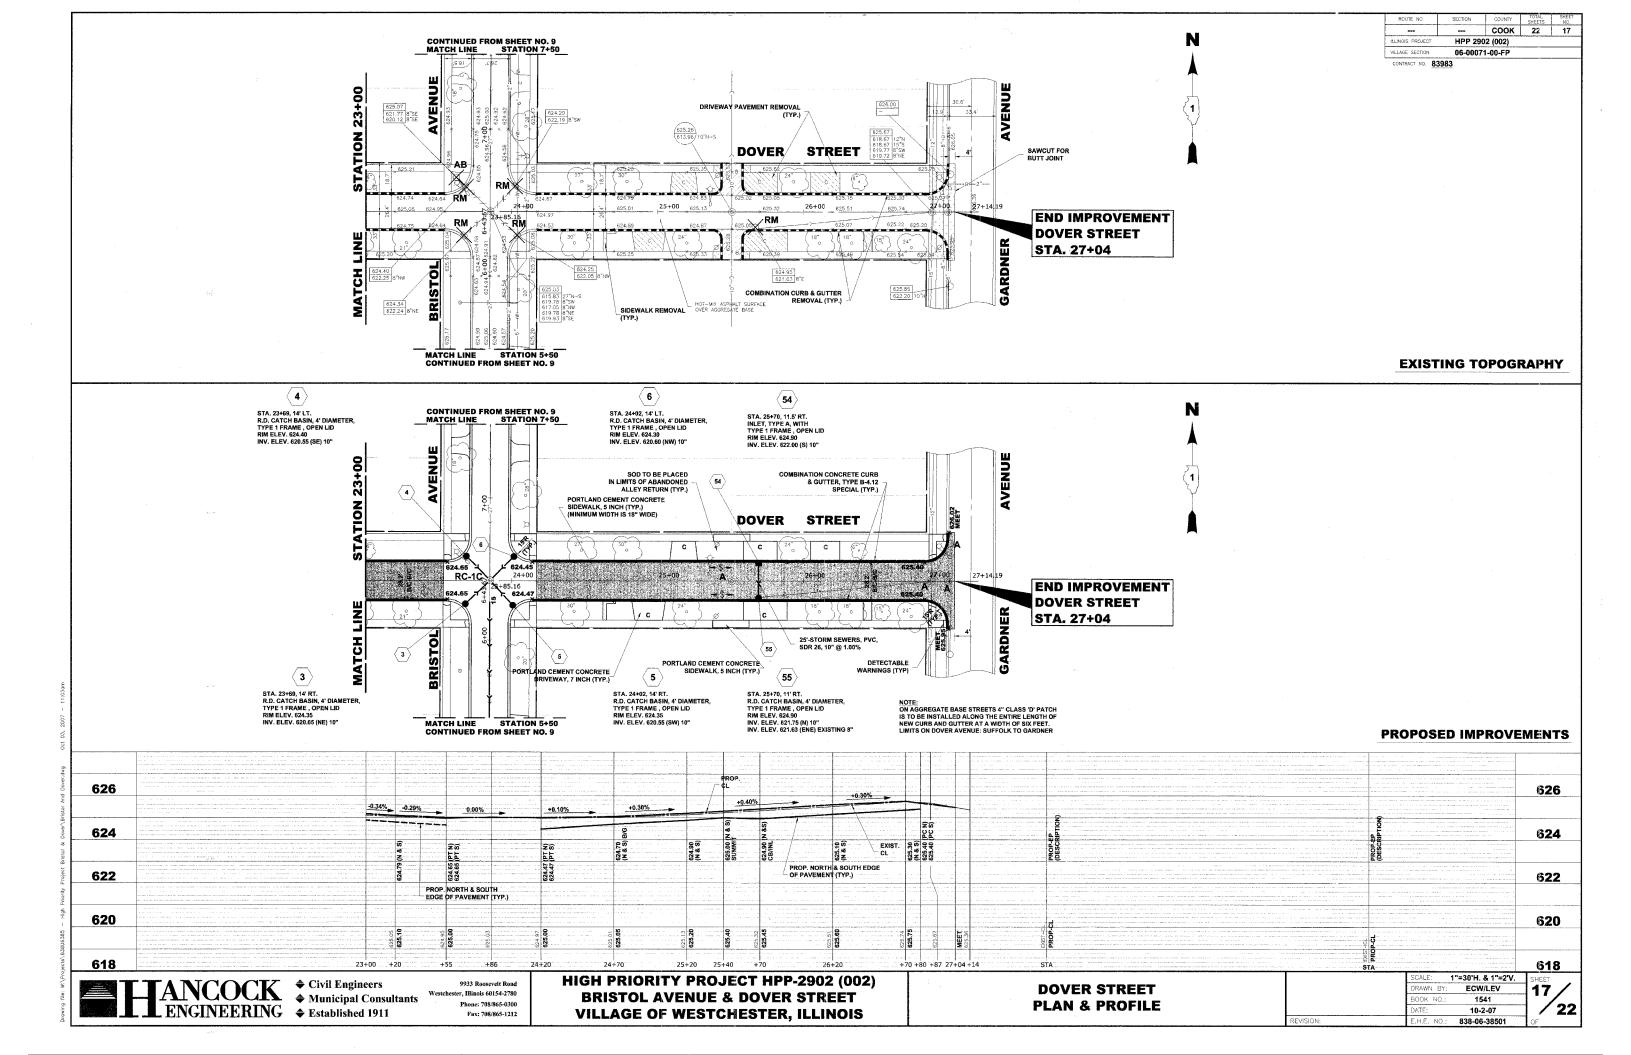

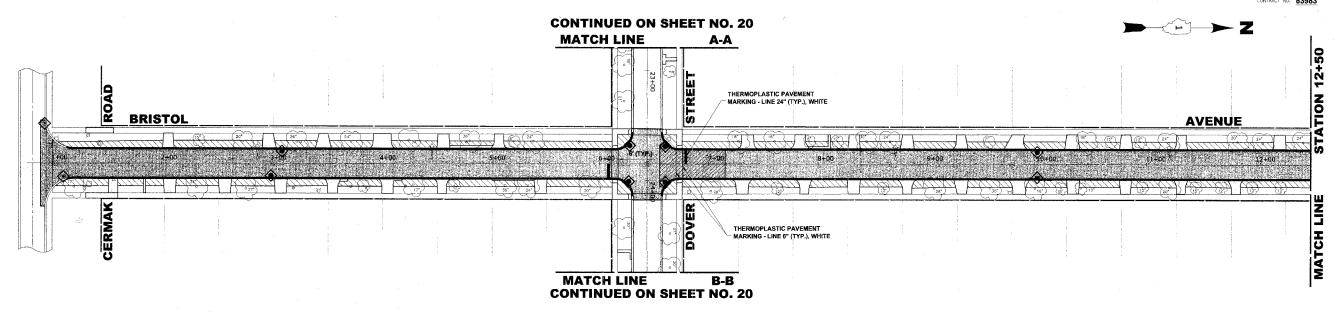

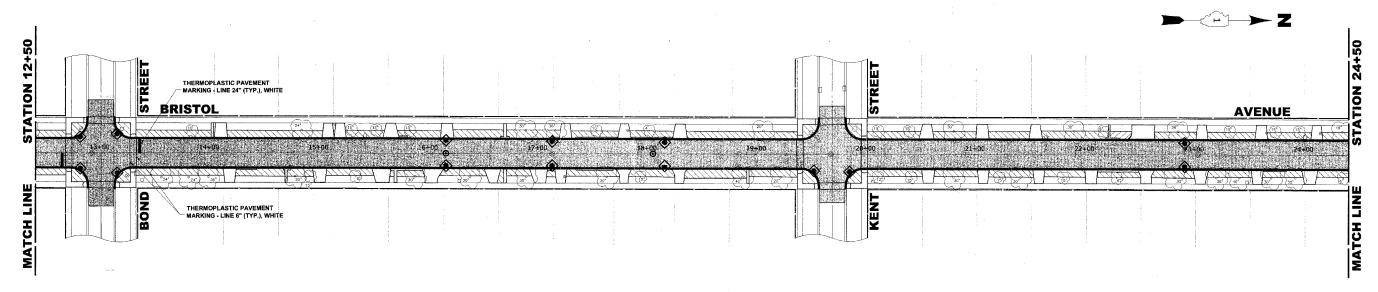

EROSION CONTROL NOTES

- 1. SEE IDOT STANDARD 280001-03 FOR TEMPORARY EROSION CONTROL SYSTEMS.
- 2. THE CONTRACTOR SHALL ENSURE THAT ADJACENT PROPERTIES REMAIN PROTECTED FROM SEDIMENT DEPOSITION
- 3. SOIL STOCKPILES SHALL BE PROTECTED WITH PERIMETER EROSION BARRIER OR OTHER EROSION PROTECTION SPECIFIED BY THE RESIDENT ENGINEER. THE COST SHALL BE INCLUDED IN THE UNIT PRICE FOR THE INDIVIDUAL SOIL MATERIALS.
- 4. WHEREVER CONSTRUCTION VEHICLE ACCESS ROUTES INTERSECT PAVED PUBLIC ROADS, PROVISIONS SHALL BE MADE TO MINIMIZE THE TRANSPORT OF SEDIMENT BY RUNOFF OR VEHICLE TRACKING ONTO THE PAVED SURFACE. THE PROVISIONS MAY INCLUDE SPRAYING VIEHCLE WHEELS TO CLEAR SEDIMENT BEFORE EXITING THE CONSTRUCTION SITE OR OTHER MEASURES APPROVED BY THE ENGINEER.

LANDSCAPING NOTES

SODDING:

ALL DISTURBED AREAS INDICATED ON CROSS SECTION OR LANDSCAPING PLANS TO BE SODDED, INCLUDING SUPPLEMENTAL WATERING WHICH IS TO BE USED AFTER THE INITIAL WATERING (AS SPECIFIED AND AS DIRECTED BY THE ENGINEER) AT THE RATE OF 10 GALLONS PER SQUARE YARD SODDING, SODDED SLOPES WHICH ARE 2:1 OR STEEPER SHALL BE STAKED. (PROVIDE A 3" STRIP AROUND

3" TOP SOIL LAYER:

SOIL SHALL BE SPREAD AS INDICATED ON THE TYPICAL CROSS SECTIONS. A MINIMUM OF GRADING TO BE PERMITTED WITHIN AN APPROXIMATE RADIUS OF 6' FROM ALL TREES TO BE SAVED AS DETERMINED BY THE ENGINEER.

HOT-MIX ASPHALT & LANDSCAPING LEGEND OF SYMBOLS

SYMBOL DESCRIPTION

PROPOSED CONCRETE AREA

PROPOSED HOT-MIX ASPHALT AREA

EROSION CONTROL LEGEND OF SYMBOLS

SYMBOL

SEDIMENT CONTROL, DRAINAGE STRUCTURE, INLET FILTER CLEANING

DESCRIPTION

INLET FILTER

ANCOCK

† Civil Engineers

† Municipal Consultants


† Established 1911

Westchester, Illinois 60154-2780 Phone: 708/865-0300 Fax: 708/865-1212 **HIGH PRIORITY PROJECT HPP-2902 (002) BRISTOL AVENUE & DOVER STREET VILLAGE OF WESTCHESTER, ILLINOIS**

BRISTOL AVENUE ASPHALT & LANDSCAPING, PAVEMENT MARKING, & EROSION CONTROL PLAN

SCALE:	1"≃40'	S
DRAWN BY:	ECW/LEV	٠,
BOOK NO.:	1541	
DATE:	10-2-07	1
E.H.E. NO.:	838-06-38501	C



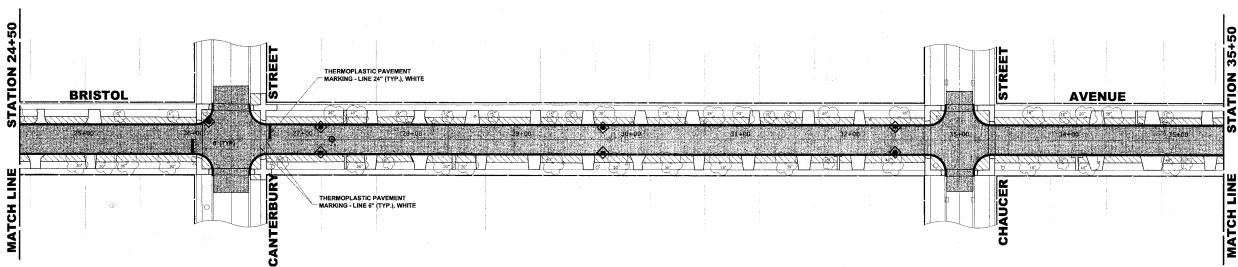

EROSION CONTROL NOTES

- 1. SEE IDOT STANDARD 280001-03 FOR TEMPORARY EROSION CONTROL SYSTEMS
- 3. SOIL STOCKPILES SHALL BE PROTECTED WITH PERIMETER EROSION BARRIER OR OTHER EROSION PROTECTION SPECIFIED BY THE RESIDENT ENGINEER. THE COST SHALL BE INCLUDED IN THE UNIT PRICE FOR THE INDIVIDUAL SOIL MATERIALS.
- 4. WHEREVER CONSTRUCTION VEHICLE ACCESS ROUTES INTERSECT PAVED PUBLIC ROADS, PROVISIONS SHALL BE MADE TO MINIMIZE THE TRANSPORT OF SEDIMENT BY RUNOFF OR VEHICLE TRACKING ONTO THE PAVED SURFACE. THE PROVISIONS MAY INCLUDE SPRAYING VEHICLE WHEELS TO CLEAR SEDIMENT BEFORE EXITING THE CONSTRUC SITE OR OTHER MEASURES APPROVED BY THE ENGINEER.

LANDSCAPING NOTES

SODDING:

ALL DISTURBED AREAS INDICATED ON CROSS SECTION OR LANDSCAPING PLANS TO BE SODDED, INCLUDINGSUPPLEMENTAL WATERING WHICH IS TO BE USED A FTER THE INITIAL WATERING (AS SPECIFIED AND AS DIRECTED BY THE ENGINEER) AT THE RATE OF 10 GALLONS PER SQUARE YARD SODDING. SODDED SLOPES WHICH ARE 21 OR STEEPER SHALL BE STAKED, (PROVIDE A 3" STRIP AROUND CATCH BASINS IN SEEDED AREAS).

3" TOP SOIL LAYER:

SOIL SHALL BE SPREAD AS INDICATED ON THE TYPICAL CROSS SECTIONS.
A MINIMUM OF GRADING TO BE PERMITTED WITHIN AN APPROXIMATE RADIUS OF 6' FROM ALL TREES TO BE SAVED AS DETERMINED BY THE ENGINEER.

STREET BRISTOL **AVENUE** THERMOPLASTIC PAVEMENT MARKING - LINE 24", WHITE DICKENS

EROSION CONTROL LEGEND OF SYMBOLS

SYMBOL

DESCRIPTION

SEDIMENT CONTROL, DRAINAGE STRUCTURE, INLET FILTER CLEANING

INLET FILTER

HOT-MIX ASPHALT & LANDSCAPING LEGEND OF SYMBOLS

SYMBOL

DESCRIPTION

PROPOSED CONCRETE AREA

PROPOSED HOT-MIX ASPHALT AREA

PROPOSED SODDED PARKWAY


PROPOSED STREET RECONSTRUCTION


9933 Roosevelt Road Westchester, Illinois 60154-2780 Phone: 708/865-0300 Fax: 708/865-1212 **HIGH PRIORITY PROJECT HPP-2902 (002) BRISTOL AVENUE & DOVER STREET VILLAGE OF WESTCHESTER, ILLINOIS**

BRISTOL AVENUE ASPHALT & LANDSCAPING, PAVEMENT MARKING, & EROSION CONTROL PLAN

SCALE:	1"=40'	SHEET
DRAWN BY:	ECW/LEV	10
BOOK NO.:	1541	7
DATE:	10-2-07	
E.H.E. NO.:	838-06-38501	OF


22

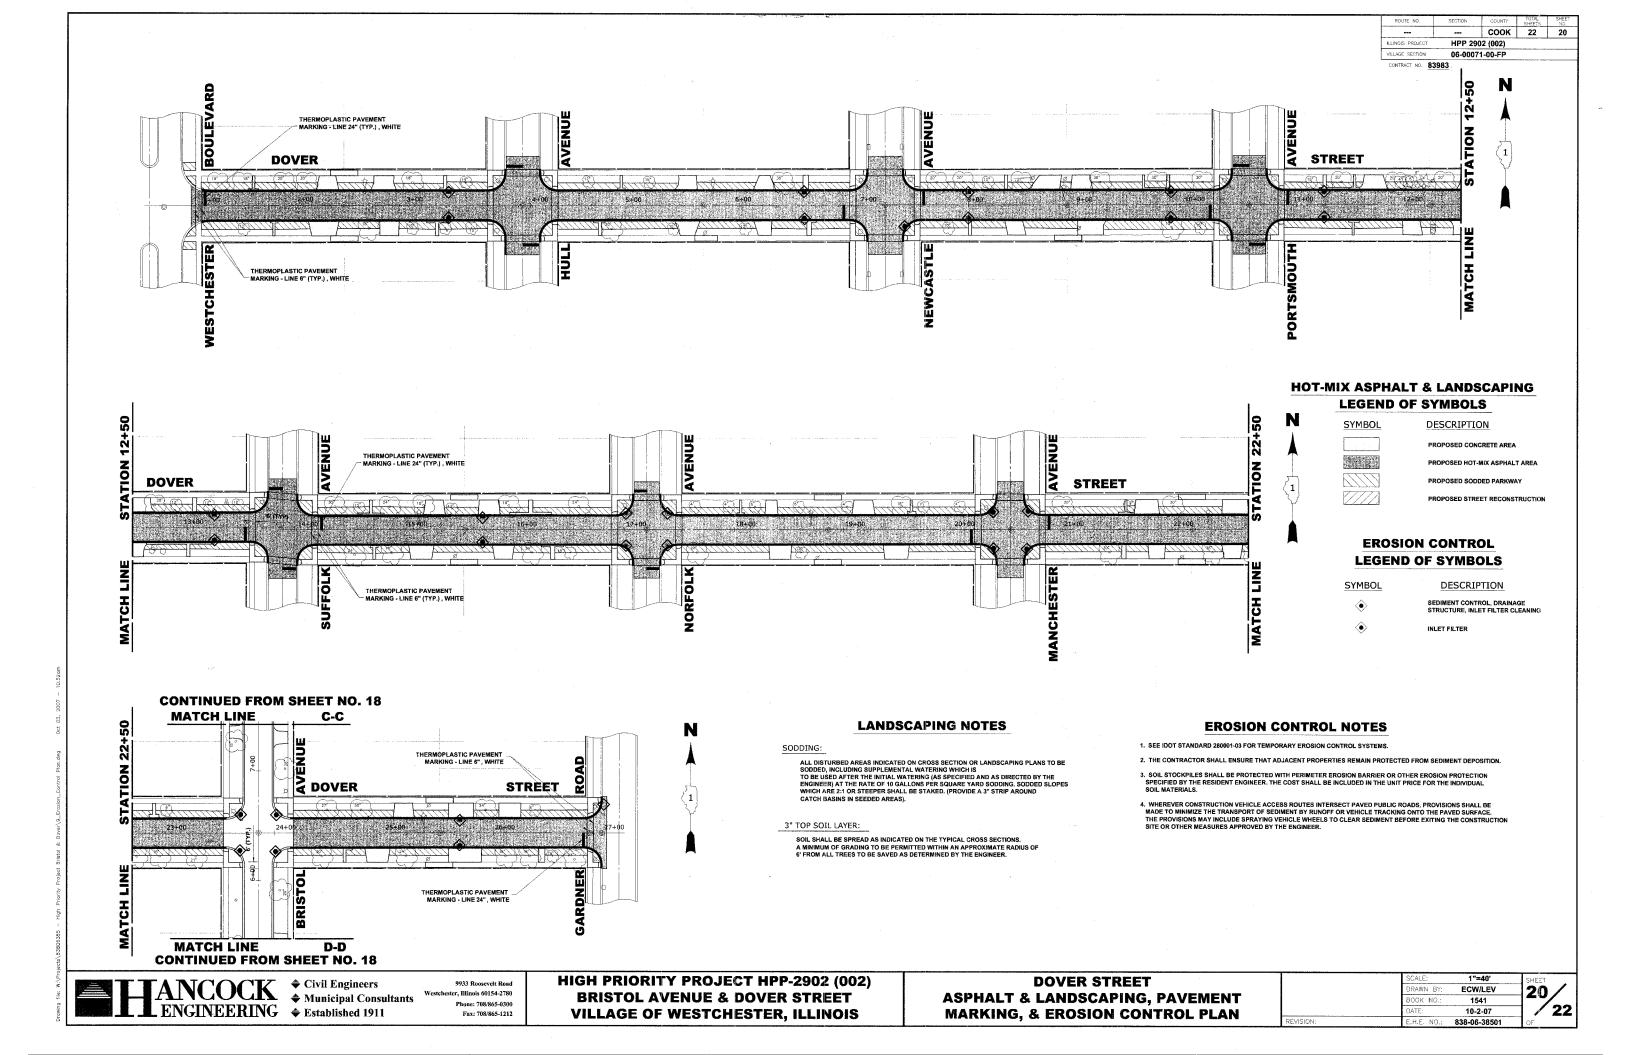

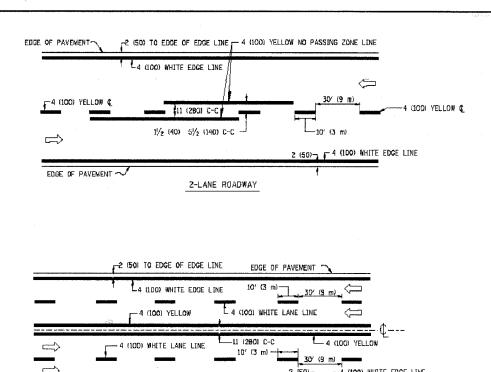


2 (50)-7

-4 (100) WHITE EDGE LINE

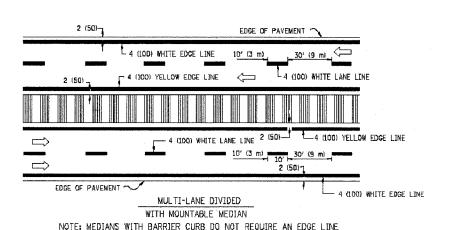


MULTI-LANE UNDIVIDED


TYPICAL LANE AND EDGE LINE MARKING

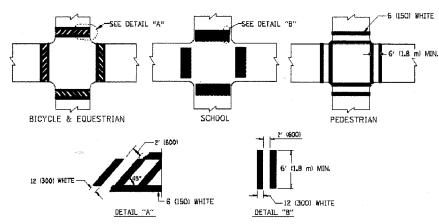

TYPICAL CROSSWALK MARKING

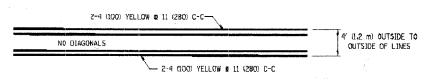


4' (1.2 m) WIDE MEDIANS ONLY

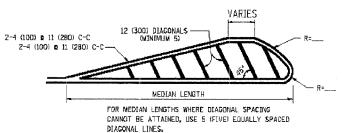


DIACONAL LINE SPACING: 50' (L5 m) C-C (LESS THAN 30MPH (50 km/h)).
75' (25 m) C-C 30MPH (50 km/h) TO 45MPH (70 km/h). 150' (45 m) C-C (MORE THAN 45MPH (70 km/h))

MEDIANS OVER 4' (1.2 m) WIDE

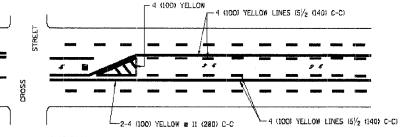


A MINIMUM OF TWO PAIRS OF TURN ARROWS SHALL BE USED, WHITE IN COLOR. ADDITIONAL PAIRS SHALL BE PLACED AT 200' (60 m) TO 300' (90 m) INTERVALS.

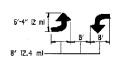

MEDIAN WITH TWO-WAY LEFT TURN LANE

TYPICAL PAINTED MEDIAN MARKING

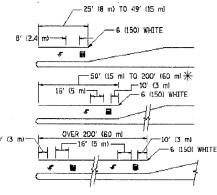


FULL SIZE LETTERS 8' (2.4 m) AND ARROWS SHALL 8E USED. \P AREA = 15.6 SO. FT. (1.5 m 2) [[]] AREA = 20.8 SQ. FT. (1.9 m 2)

* TURN LANES IN EXCESS OF 400' 1120 m) IN LENGTH MAY HAVE AN ADDITIONAL SET OF ARROW - "QNLY" INSTALLED MIDWAY BETWEEN THE OTHER TWO SETS OF ARROW - "ONLY".

TYPICAL LEFT (OR RIGHT) TURN LANE

TYPICAL TURN LANE MARKING

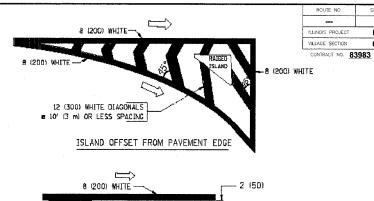

TYPICAL ISLAND MARKING

ISLAND AT PAVEMENT EDGE

8 (200) WHITE-

ISLAND

-2 (50)

	T	I	T	
TYPE OF MARKING	WIDTH OF LINE	PATTERN	COLOR	SPACING / REMARKS
CENTERLINE ON 2 LANE PAVEMENT	4 (100)	SKIP-DASH	YELLOW	10' (3 m) LINE WITH 30' (9 m) SPACE
CENTERLINE ON MULTI-LANE UNDIVEDED PAVEMENT	2 & 4 (100)	20 LID	YELLOW	11 (280) C-C
NO PASSING ZONE LINES: FOR ONE DIRECTION FOR BOTH DIRECTIONS	4 (100) 2 s 4 (100)	SOLID SOLID	YELLOW YELLOW	5½ (140) C-C FROM SKIP-DASH CENTERLINE 11 12BO) C-C OMIT SKIP-DASH CENTERLINE BETWEEN
LANE LINES	4 (100) 5 (125) ON FREEWAYS	SKIP-DASH SKIP-DASH	WHITE WHITE	10' (3 m) LINE WITH 30' (9 m) SPACE
DOTTED LINES (EXTENSIONS OF CENTER, LANE OR TURN LANE MARKINGS)	SAME AS LINE BEING EXTENDED	SKIP-DASH	SAME AS LINE BEING EXTENDED	2' (600) LINE WITH 6' (1.8 m) SPACE
EDGE LINES	4 (100)	20LID	YELLOW-LEFT WHITE-RIGHT	OUTLINE MOUNTABLE MEDIANS IN YELLON; EDGE LINES ARE NOT USED NEXT TO BARRIER CURB
TURN LANE MARKINGS	6 (150) LINE; FULL SIZE LETTERS & SYMBOLS (8' (2,4m))	20FID	WHITE	SEE TYPICAL TURN LANE MARKING DETAIL
TWO WAY LEFT FURN MARKING	2 e 4 (100) EACH DIRECTION	SKIP-DASH AND SOLID	YELLOW	10' (3 m) LINE WITH 30' (9 m) SPACE FOR SKIP-DASH; $9V_2$ [140) C-C BETWEEN SDLID LINE AND SKIP-DASH LINE
	8' (2.4m) LEFT ARROW	IN PAIRS	WHITE	SEE TYPICAL TWO-WAY LEFT TURN MARKING DETAIL
CROSSWALK LINES (PEDESTRIAN) A. DIAGONALS (BIKE & EQUESTRIAN) B. LONGITUDINAL BARS (SCHOOL)	2 & 6 (150) 12 (300) & 45° 12 (300) & 50°	SOLID SOLID	WHITE WHITE WHITE	NOT LESS THAN 6' (1.8 ml APART 2' (GOL) APART 2' (GOL) APART SEE TYPICAL CROSSWALK MARKING DETAILS.
STOP LINES	24 (600)	SOLID	WHITE	PLACE 4' (1.2 ml IN ADVANCE OF AND PARALLEL TO CROSSWALK, IF PRESENT. OTHERWISE, PLACE AT DESIRED STOPPING POINT. PARALLEL TO CROSSROAD CENTERLINE, WHERE FOSSIBLE
PAINTED MEDIANS	2 m 4 (100) WITH 12 (300) DIAGONALS	SOLID	YELLOW: TWO WAY TRAFFIC	11 (280) C-C FOR THE DOUBLE LINE
	no diagonals used for 4' (1.2 m) Wide Medians		WHITE: ONE WAY TRAFFIC	SEE TYPICAL PAINTED MEDIAN MARKING.
GORE MARKING AND CHANNELIZING LINES	8 (200) WITH 12 (300) DIAGONALS & 45°	SOLID	WHITE	DIAGONALS: 15' (4.5 m) C-C (LESS THAN 30MPH (50 km/h)) 20' (6 m) C-C 30MPH (50 km/h) TO 45MPH (70 km/h)) 30' (9 m) C-C (OVER 45MPH (70 km/h))
RAILROAD CROSSING	24 (600) TRANSVERSE LINES; "RR" IS 6' (1.8 m) LETTERS: 16 (400) LINE FOR "X"	SOLID	WHITE	SEE STATE STANDARD 780001 AREA OFB "R":3.6 SD. FT. (0.33 m ²) EACH "X"-54.0 SO. FT. (5.0 m ²)
SHOULDER DIAGONALS	12 (300) a 45°	SOLIO	WHITE - RICHT YELLOW - LEFT	50' (15 m) C-C (LESS THAN 30MPH (50 km/h)) 75' (25 m) C-C (30 MPH (50 km/h) TO 45MPH (70 km/h)) 150' (45 m) C-C (OVER 45MPH (70 km/h))

FOR FURTHER DETAILS ON PAVEMENT MARKING REFER TO STANDARD SPECIFICATIONS FOR ROAD AND BRIDGE CONSTRUCTION AND STATE STANDARD 780001.

All dimensions are in inches (millimeters)

REVISION	VS.	THE INDISED	PARTMENT OF TRANSPORTATION	
NAME	DATE	ILLIIVOID D	LIMITWENT OF IMMOFORTATION	
EVERS	03-19-90			
T. RAMMACHER	10-27-94		DISTRICT ONE	
ALEX HOUSEH	10-09-96			
ALEX HOUSEH	10-17-95	TY	PICAL PAVEMENT	
T. RAMMACHER 01-06-00		MARKINGS		
			MARKINGS	
		SCALE: NONE	DRAWN BY CADD	
			DYWWN G: CMOO	
			CHECKED BY	

COOK 22 21

HPP 2902 (002)

06-00071-00-FP

EDGE OF PAVEMENT ~


E.H.E. PROJECT NO. 838-06-3850:


BUTT JOINT AND

HMA TAPER

TYPICAL BUTT JOINT AND HMA TAPER
FOR MILLING AND RESURFACING

EXIST. PAVEMENT

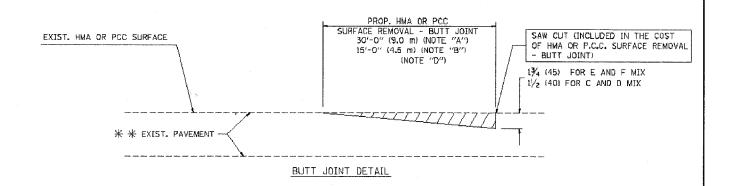

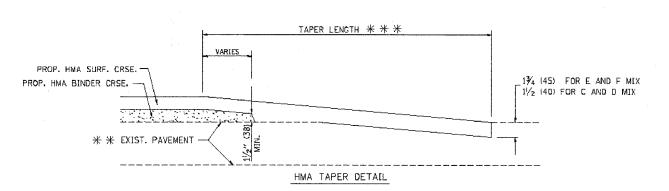

TYPICAL BUTT JOINT AND HMA TAPER FOR RESURFACING ONLY

* * PC CONCRETE, HMA OR HMA RESURFACED PAVEMENT.

NOTES

- A: MAINLINE ROADWAYS AND MAJOR SIDE ROADS.
- B: MINOR SIDE ROADS.
- C: THE TEMP. RAMP SHALL BE CONSTRUCTED IMMEDIATELY UPON REMOVAL OF THE EXISTING HMA SURFACE.
- D: THE BUTT JOINT SHALL BE CONSTRUCTED IMMEDIATELY PRIOR TO PLACING THE PROPOSED HMA COURSES.
- E: TAPER THE TEMP, RAMP, AT A RATE OF 3'-0" (900 mm) PER 1 INCH (25 mm) OF MILLING THICKNESS,
- F: INSTALLATION AND REMOVAL OF THE 4'-6" (1.35 m) TEMP. RAMP IS INCLUDED IN COST OF HMA SURFACE REMOVAL BUTT JOINT
- G: SEE ARTICLE 406.08 AND 406.14 OF THE STANDARD SPECIFICATIONS FOR "HMA AND/OR PCC SURFACE REMOVAL, BUTT JOINT".
- * SEE TYPICAL SECTIONS FOR MILLING THICKNESS.

米米米 20'-0" (6.1 m) PER 1 (25) RESURFACING (NOTE "A") 10'-0" (3.0 m) PER 1 (25) RESURFACING (NOTE "B")

ALL DIMENSIONS ARE IN INCHES (MILLIMETERS) UNLESS OTHERWISE SHOWN.

BASIS OF PAYMENT:

HMA SURF. REMOVAL - BUTT JOINT

THE BUTT JOINT WILL BE PAID FOR AT THE CONTRACT UNIT PRICE PER SOUARE YARD (SOUARE METER) FOR "HOT-MIX ASPHALT SURFACE REMOVAL - BUTT JOINT" OR FOR "PORTLAND CEMENT CONCRETE SURFACE REMOVAL- BUTT JOINT".

NAME	DATE	
M. DE YONG	6-13-90	
M. DE YONG	7-3-90	
M. DE YONG	3-27-92	
R. SHAH	09/09/94	
R. SHAH	10/25/94	
A. ABBAS	03/21/97	
M. GOMEZ	04/06/01	
R. BORO	01/01/07	SCAL
		SUAL

ILLINOIS DEPARTMENT OF TRANSPORTATION

BUTT JOINT AND HMA TAPER DETAILS

SCALE: VERT. NONE

DRAWN BY CHECKED BY

E.H.E. PROJECT NO. 838-06-38501