


PLAN	SURVEYED	BY	DATE
	PLOTTED		
	NOTE BOOK		
	NO.		
	CHECKED		
	FILE NAME		

PROFILE	SURVEYED	BY	DATE
	PLOTTED		
	NOTE BOOK		
	NO.		
	CHECKED		
	FILE NAME		

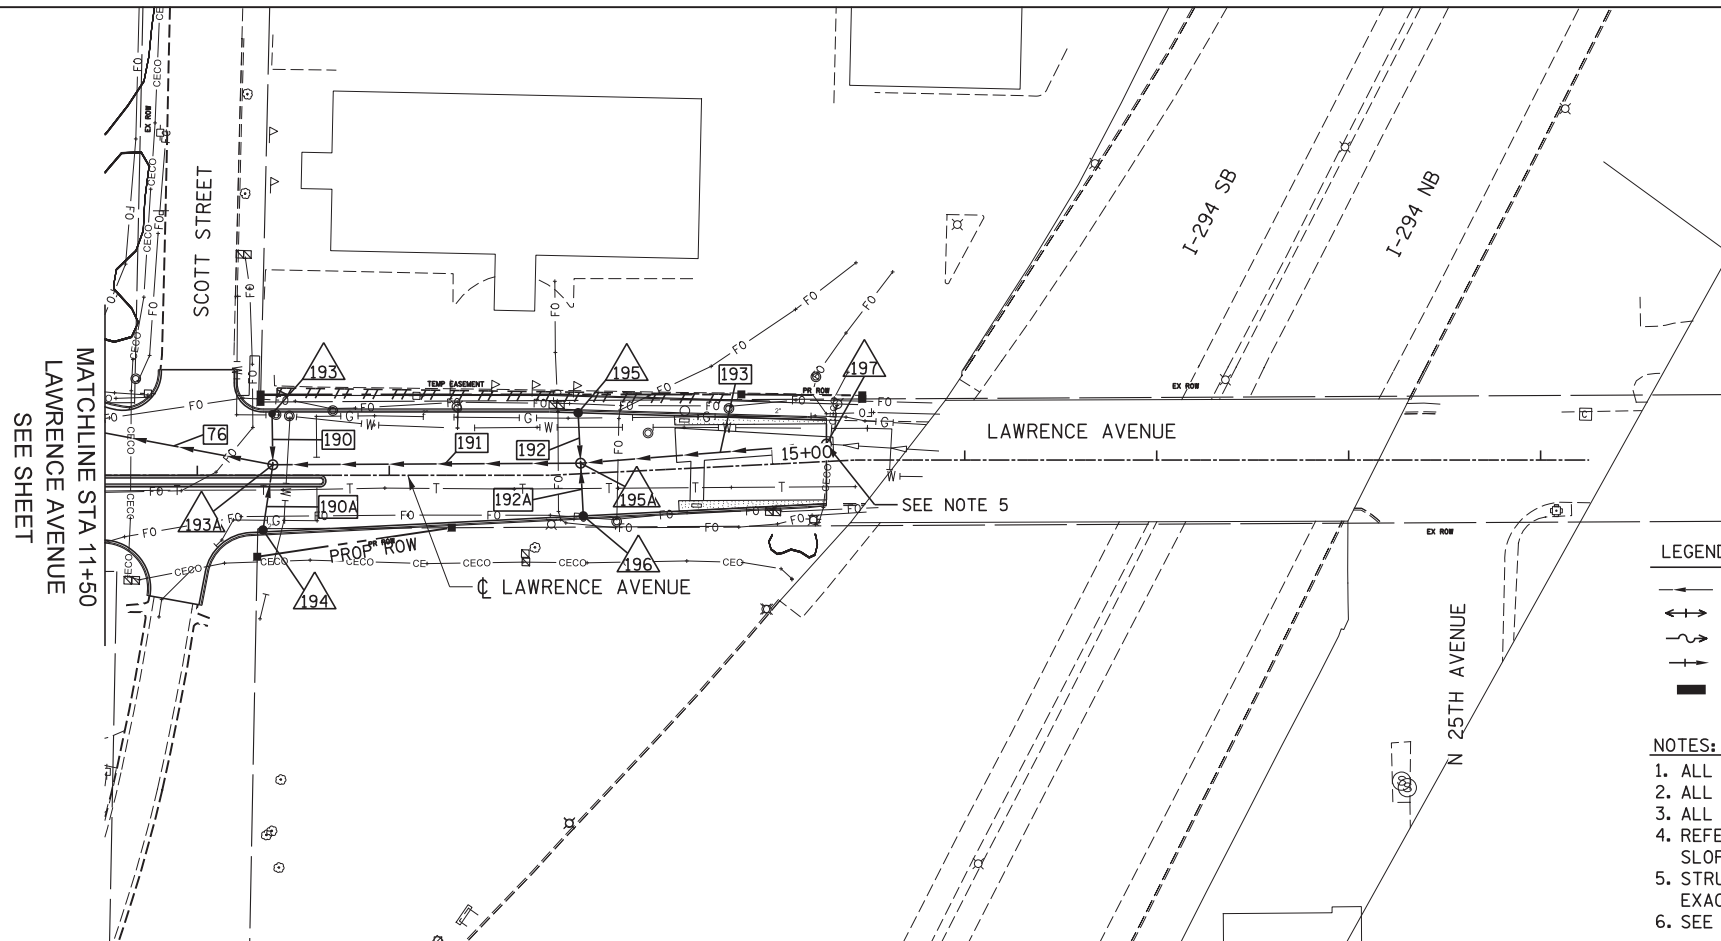


LEGEND

- PROPOSED STORM SEWER
- PROPOSED SUMMIT
- PROPOSED DITCH
- PROPOSED SWALE
- PROPOSED INLET
- PROPOSED CATCH BASIN
- PROPOSED MANHOLE
- MEDIAN DRAINAGE STRUCTURE
- ▲ PRECAST REINFORCED CONC. FLARED END SECTION

NOTES:

1. ALL DIMENSIONS ARE IN FEET UNLESS OTHERWISE NOTED
2. ALL STATIONING AND OFFSET MEASUREMENTS ARE OFF C MANNHEIM RD
3. ALL PIPE DIAMETERS ARE IN INCHES (IN) UNLESS OTHERWISE NOTED
4. REFER TO ROADWAY PROFILE PLANS FOR ALL ROADWAY PROFILE SLOPE AND CURVE GEOMETRY
5. STRUCTURE 197 SHOULD BE CONNECTED TO EXISTING STORM SEWER. EXACT LOCATION TO BE VERIFIED IN FIELD.
6. SEE DR-16 FOR PIPE UNDERDRAIN INSTALLATION LOCATIONS

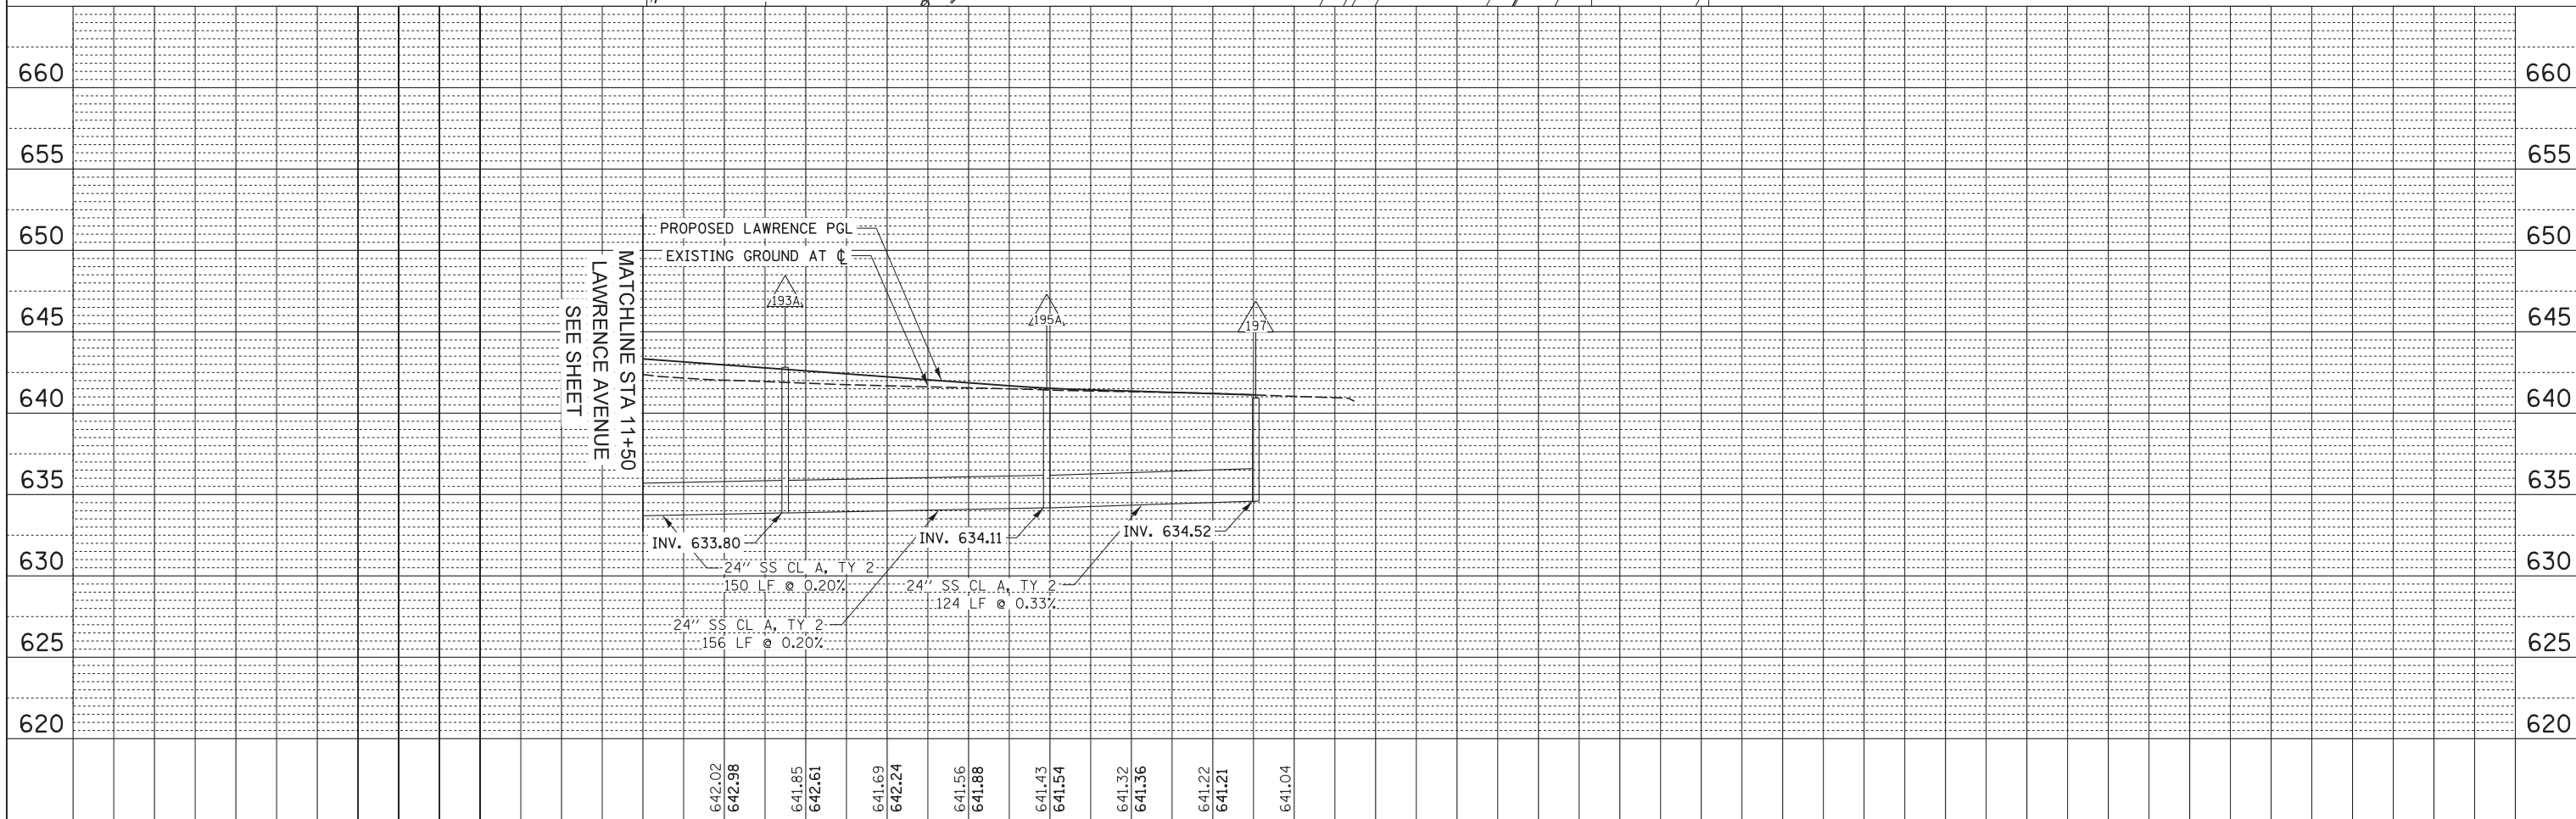

USER NAME = mikosir
 PLOT SCALE = 50:1
 PLOT DATE = 19-OCT-2012

DESIGNED MAM/PMS
 DRAWN PMS
 CHECKED MAM
 DATE 10/19/12

REVISED -
 REVISED -
 REVISED -
 REVISED -

STATE OF ILLINOIS
 DEPARTMENT OF TRANSPORTATION

DRAINAGE PLAN AND PROFILE - LAWRENCE AVENUE

SCALE: 1" = 50' SHEET NO. 8 OF 8 SHEETS STA. BOP TO STA. EOP

F.A.P. RTE.		SECTION	COUNTY	TOTAL SHEETS	SHEET NO.
330		0105 WRS&HB	COOK	605	185
				CONTRACT NO. 60G37	
ILLINOIS FED. AID PROJECT					

DR-08