
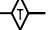
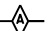


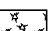


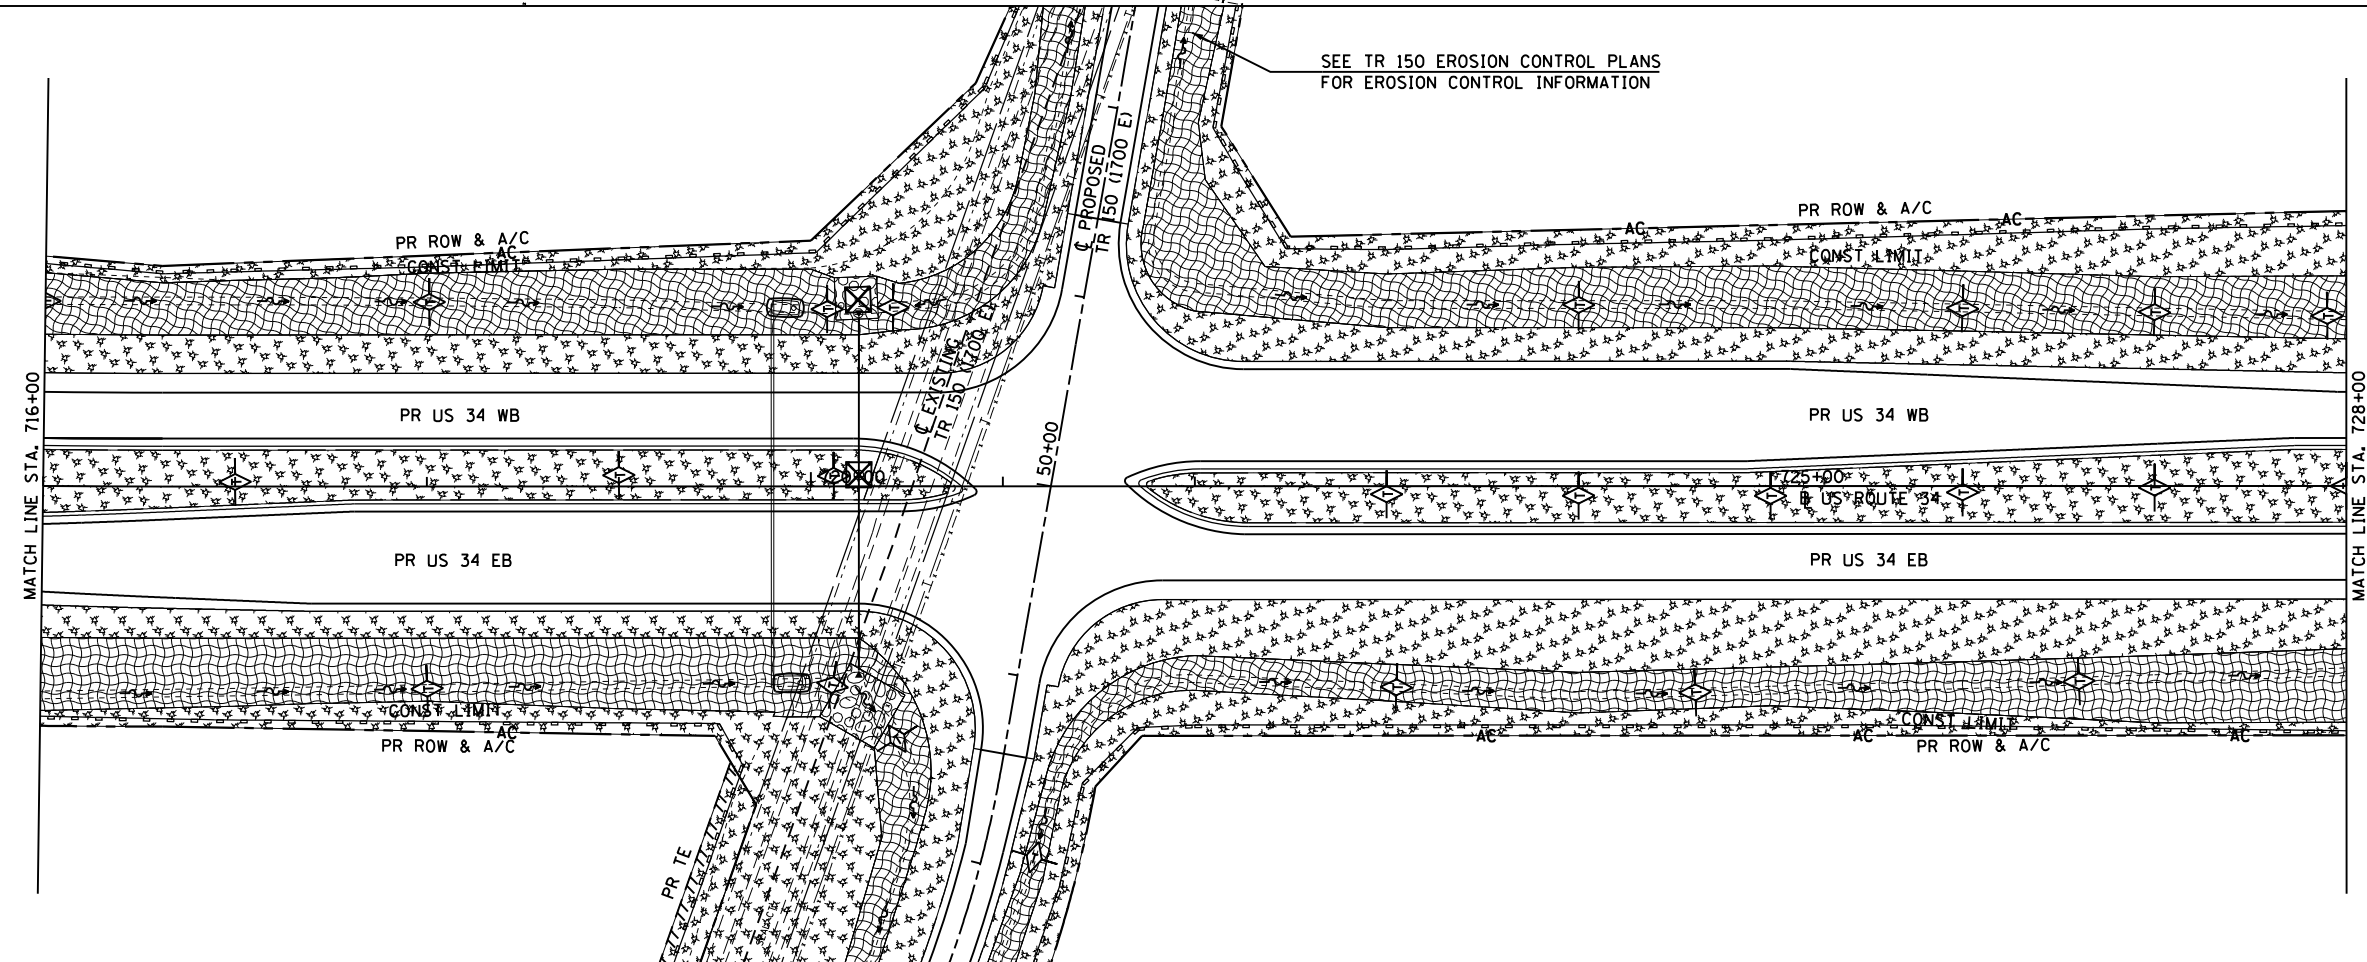
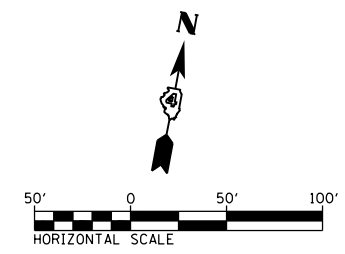
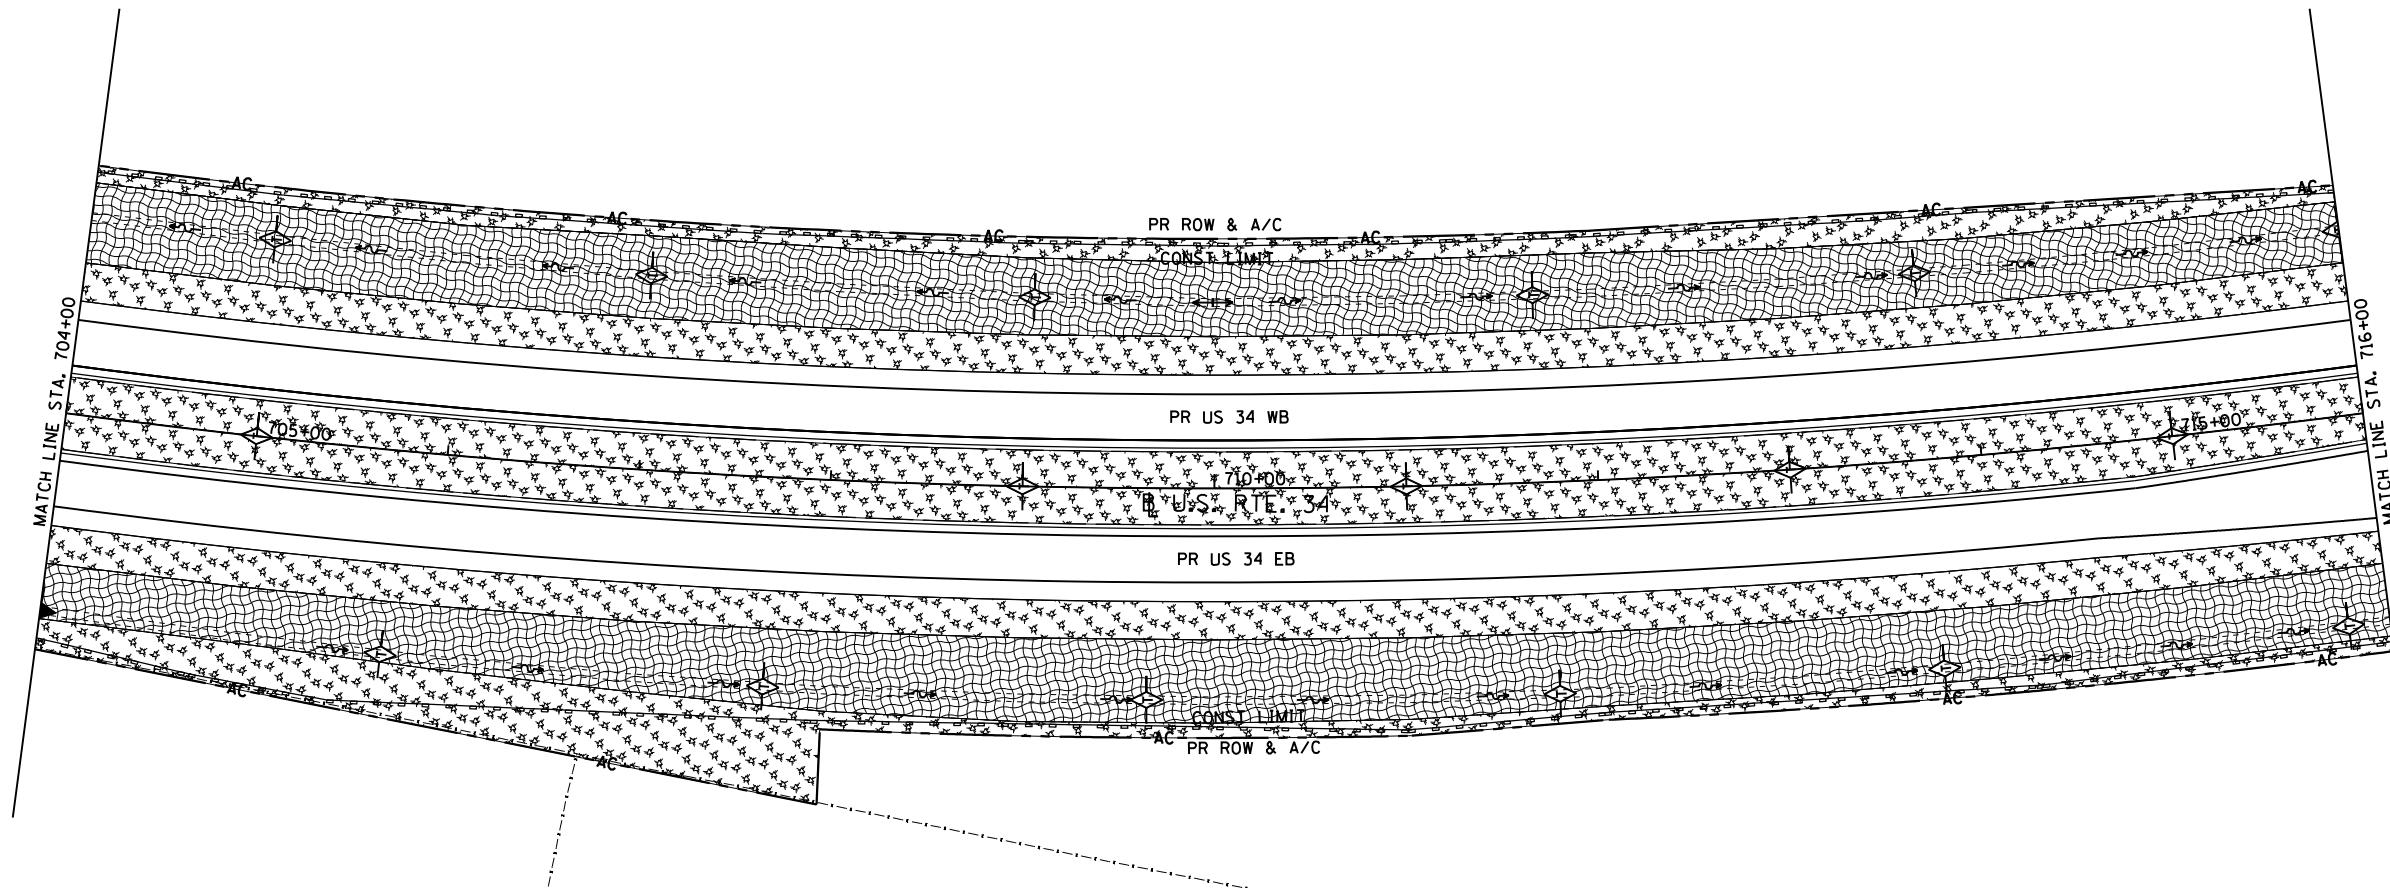


TEMPORARY EROSION CONTROL LEGEND

-  INLET AND PIPE PROTECTION
-  TEMPORARY DITCH CHECK
-  AGGREGATE DITCH CHECK
-  EROSION CONTROL BLANKET
-  HEAVY DUTY EROSION CONTROL BLANKET
-  MULCH METHOD 2
-  PERIMETER EROSION BARRIER
-  TEMPORARY SEDIMENT BASIN



FILE NAME = D468409-SHT-09-EROS-US34.dgn  
 USER NAME = zach1

DESIGNED - DBS  
 DRAWN - PSBA  
 CHECKED - CSB  
 DATE - 10/2012

REVISIONS:  
 REVISION NO. | DATE | BY | DESCRIPTION  
 1 | 10/2012 | DBS | DESIGNED  
 2 | 10/2012 | PSBA | DRAWN  
 3 | 10/2012 | CSB | CHECKED

STATE OF ILLINOIS  
 DEPARTMENT OF TRANSPORTATION

EROSION CONTROL PLANS  
 US ROUTE 34

SCALE: 1" = 50' SHEET NO. 9 OF 34 SHEETS STA. 704+00 TO STA. 728+00

F.A.P. RTE.	SECTION	COUNTY	TOTAL SHEETS	SHEET NO.
313	7-2 ; 6-1	HENDERSON	976	249
CONTRACT NO. 68409				
ILLINOIS FED. AID PROJECT				