01-18-2019 LETTING ITEM 114

STATE OF ILLINOIS DEPARTMENT OF TRANSPORTATION

FOR INDEX OF SHEETS, SEE SHEET NO. 2 FOR HIGHWAY STANDARDS, SEE SHEET NO. 2

END IMPROVEMENT

BEGIN IMPROVEMENT

STA 100 + 44.00


PLANS FOR PROPOSED FEDERAL AID HIGHWAY

TRAFFIC DATA EXISTING ADT = 8,125 (2016)

SPEED LIMIT: 25 MPH (POSTED)

DESIGN DESIGNATION MAJOR COLLECTOR

FAU ROUTE 2659 (WEST AVENUE) ST. CHARLES ROAD TO FIRST STREET /U.P. RAILROAD **RESURFACING** SECTION 18-00194-00-RS PROJECT UBQH(364) CITY OF ELMHURST

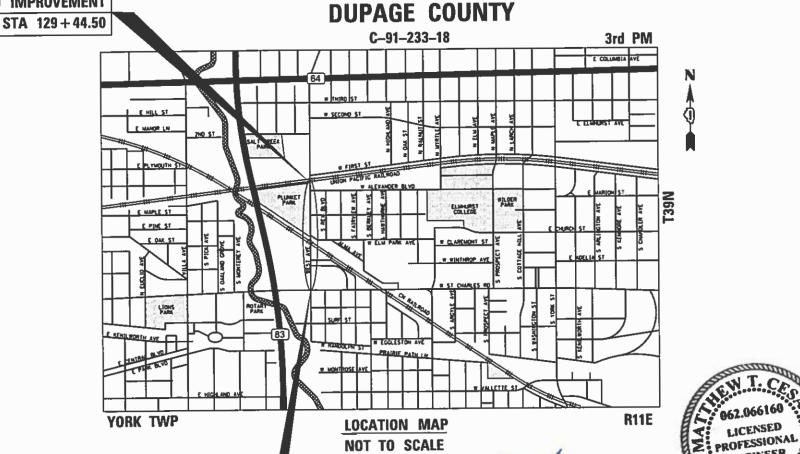


LOCATION OF SECTION INDICATED THUS: - -

SECTION

18-00194-00-RS

2659

DUPAGE 30 1
CONTRACT NO. 61F20

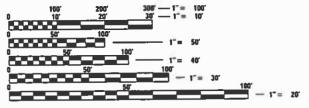

ENGINEERING SCALES. REDUCED SIZED PLANS WILL NOT CONFORM TO STANDARD SCALES. IN MAKING MEASUREMENTS ON REDUCED PLANS, THE ABOVE SCALES MAY BE USED.

JOINT UTILITY LOCATION INFORMATION FOR EXCAVATION 1-800-892-0123 OR 811

BLA, Inc. 333 PIERCE ROAD SUITE 200 ITASCA, IL 60143 P(630) 438 6400 F(630) 438 6444 www.bollingerlach.co GROSS LENGTH = 2,900.50 FT. = 0.55 MILE NET LENGTH = 2,900.50 FT. = 0.55 JOILE MATTHEN CESARIO

LICENSED

ENGINEER

LINO'S REGISTERED PROFESSIONAL ENGINEER NO. 062.066160 MY LICENSE EXPIRES ON 11-30-19.

STATE OF ILLINOIS CITY OF ELMHURST

> PRINTED BY THE AUTHORITY OF THE STATE OF ILLINOIS

CONTRACT NO. 61F20

SCHAUMBURG, RAMOS, P.E. **ENGINEER: CARMEN** PROGRAM

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INDEX OF SHEETS

- 1 COVER SHEET
- 2 INDEX OF SHEETS, HIGHWAY STD, GEN. NOTES & COMMITMENTS
- 3-6 SUMMARY OF QUANTITIES
- 7-8 TYPICAL SECTIONS
- 9 SCHEDULE OF QUANTITIES
- 10 ALIGNMENT, TIES, AND BENCHMARKS
- 11-13 PROPOSED ROADWAY AND PAVEMENT MARKING PLAN
- 14-21 ADA RAMP ELEVATION PLAN
- 22-30 DISTRICT DETAILS

DISTRICT DETAILS

- BD-8 DETAILS FOR FRAMES AND LIDS ADJUSTMENT WITH MILLING
- BD-22 PAVEMENT PATCHING FOR HMA SURFACED PAVEMENT
- BD-32 BUTT JOINT AND HMA TAPER DETAILS
- TC-10 T.C & PROTECTION SIDE ROADS, INTERSECTIONS, & DRIVEWAYS
- TC-13 DISTRICT ONE TYPICAL PAVEMENT MARKINGS
- TC-16 PAVEMENT MARKING LETTERS AND SYMBOLS FOR TRAFFIC STAGING
- TC-22 ARTERIAL ROAD INFORMATION SIGN
- TS-05 DISTRICT ONE STANDARD TRAFFIC SIGNAL DESIGN DETAILS
- TS-07 DIST 1 DET. LOOP INSTALL. DETAILS FOR ROADWAY RESURFACING

HIGHWAY STANDARDS

- 000001-07 STANDARD SYMBOLS, ABBREVIATIONS AND PATTERNS
- 001006 DECIMAL EQUIVALENTS OF AN INCH-FOOT
- 280001-07 TEMPORARY EROSION CONTROL SYSTEMS
- 424001-11 PERPENDICULAR CURB RAMPS FOR SIDEWALKS
- 424016-05 MID-BLOCK CURB RAMPS FOR SIDEWALKS
- 424026-03 ENTRANCE / ALLEY PEDESTRIAN CROSSINGS
- 442201-03 CLASS C AND D PATCHES
- 606001-07 CONCRETE CURB TYPE B COMBINATION CURB AND GUTTER
- 701006-05 OFF-RD OPERATIONS, 2L, 2W, 15' TO 24' FROM EDGE OF PVMT
- 701301-04 LANE CLOSURE, 2L, 2W, SHORT TIME OPERATIONS
- 701311-03 LANE CLOSURE 2L. 2W MOVING OPERATIONS DAY ONLY
- 701501-06 URBAN LANE CLOSURE, 2L, 2W, UNDIVIDED
- 701701-10 URBAN LANE CLOSURE, MULTILANE INTERSECTION
- 701801-06 SIDEWALK, CORNER, OR CROSSWALK CLOSURE
- 701901-08 TRAFFIC CONTROL DEVICES
- 780001-05 TYPICAL PAVEMENT MARKINGS
- 886001-01 DETECTOR LOOP INSTALLATION
- 886006-01 TYPICAL LAYOUTS FOR DETECTION LOOPS

GENERAL NOTES

- 1. ALL CONSTRUCTION SHALL BE DONE IN ACCORDANCE WITH THE STANDARD SPECIFICATIONS FOR ROAD AND BRIDGE CONSTRUCTION ADOPTED APRIL 1, 2016 (HEREIN AFTER REFERRED TO AS THE STANDARD SPECIFICATIONS; THE SUPPLEMENTAL SPECIFICATIONS AND RECURRING SPECIAL PROVISIONS ADOPTED JANUARY 1, 2019; THE LATEST EDITION OF THE ILLINOIS MANUAL ON UNIFORM TRAFFIC CONTROL DEVICES FOR STREETS AND HIGHWAYS; THE STANDARD SPECIFICATIONS FOR WATER & SEWER MAIN CONSTRUCTION IN ILLINOIS, LATEST EDITION; THE DETAILS IN THE PLANS; AND THE SPECIAL PROVISIONS INCLUDED IN THE CONTRACT DOCUMENTS.
- 2. ANY REFERENCE TO STANDARDS THROUGHOUT THE PLANS OR SPECIAL PROVISIONS SHALL BE INTERPRETED AS THE LATEST STANDARD OF THE ILLINOIS DEPARTMENT OF TRANSPORTATION STANDARD SPECIFICATIONS.
- 3. BEFORE STARTING ANY EXCAVATION, THE CONTRACTOR SHALL CALL "J.U.L.I.E." AT (800) 892-0123 OR 811 FOR FIELD LOCATIONS OF BURIED ELECTRIC, TELEPHONE AND GAS UTILITIES. 48 HOURS NOTIFICATION IS REQUIRED.
- 4. THE CONTRACTOR SHALL COORDINATE CONSTRUCTION ACTIVITIES WITH LOCAL EMERGENCY SERVICES AND THE CITY OF ELMHURST USING THE FOLLOWING TELEPHONE NUMBERS:

POLICE DEPARTMENT: (630) 530-3050

FIRE DEPARTMENT: (630) 530-3090

- 5. THE CONTRACTOR SHALL BE RESPONSIBLE FOR CONTACTING THE OWNERS OF ALL UTILITIES PRIOR TO CONSTRUCTION TO DETERMINE THE LOCATION OF ALL EXISTING AND PROPOSED UTILITY EQUIPMENT. THE CONTRACTOR SHALL COOPERATE WITH ALL UTILITY OWNERS, IF UTILITY RELOCATION, ADJUSTMENT, OR PROTECTION IS NECESSARY.
- 6. THE LOCATION OF EXISTING DRAINAGE STRUCTURES, STORM SEWERS, WATER MAINS, SANITARY SEWERS, AND ANY OTHER PUBLIC OR PRIVATE UTILITIES AS SHOWN ON THE PLANS IS APPROXIMATE, AND THEIR EXACT LOCATION IS TO BE DETERMINED IN THE FIELD BY THE CONTRACTOR.
- 7. THE CONTRACTOR SHALL PROTECT AND CAREFULLY PRESERVE ALL SECTION OR SUBSECTION MONUMENTS, PROPERTY CORNERS AND REFERENCE MARKERS UNTIL THE OWNER, OWNER'S REPRESENTATIVE, OR AN AUTHORIZED SURVEYOR HAS WITNESSED OR OTHERWISE REFERENCED THEIR LOCATIONS
- 8. ALL LOOSE MATERIAL DEPOSITED IN THE FLOW LINE OF DRAINAGE STRUCTURES THAT OBSTRUCTS THE NATURAL FLOW OF WATER SHALL BE REMOVED AT THE CLOSE OF EACH WORKING DAY, PRIOR TO ACCEPTANCE OF IMPROVEMENT ALL DRAINAGE STRUCTURES SHALL BE FREE OF DIRT AND DEBRIS.
- 9. THE CONTRACTOR SHALL NOT SET UP A YARD OR FIELD OFFICE ON STATE OR CITY PROPERTY WITHOUT WRITTEN PERMISSION FROM THE DEPARTMENT OR THE CITY.
- 10. THE CONTRACTOR SHALL MAINTAIN EXISTING SIDE STREET ACCESS, EXISTING DRIVEWAY ACCESS AND PEDESTRIAN ACCESS TO ABUTTING PROPERTY AT ALL TIMES DURING CONSTRUCTION OF THE PROJECT UNLESS OTHERWISE NOTED IN THE PLANS OR AS DIRECTED BY THE ENGINEER.
- 11. FERTILIZER NUTRIENTS SHALL BE PLACED OVER SODDING AT THE RATE OF 60 POUNDS EACH PER ACRE.
- 12. SAW CUTTING OF CURB AND GUTTER SHALL BE FULL DEPTH AND SHALL RESULT IN A CLEAN STRAIGHT EDGE ON THE PORTION REMAINING.
- 13. THE THICKNESS OF HOT-MIX ASPHALT MIXTURES SHOWN IN THE PLANS IS NOMINAL. DEVIATIONS MAY OCCUR DUE TO IRREGULARITIES IN THE SURFACES OR BASES ON WHICH THE HOT-MIX ASPHALT MIXTURES ARE TO BE PLACED.
- 14. PROTECTIVE COAT SHALL BE APPLIED TO ALL GUTTER FLAGS, FACE AND TOP OF CURB, SIDEWALKS, PCC PAVEMENT, AND AS DIRECTED BY THE ENGINEER.
- 15. THE CONTRACTOR SHALL BE RESPONSIBLE FOR PROTECTING FRESH CONCRETE FROM DAMAGE AND VANDALISM. ANY DAMAGED OR VANDALIZED CONCRETE SHALL BE REMOVED AND REPLACED.
- 16. WHEN MILLED PAVEMENT IS OPEN TO TRAFFIC THE MAXIMUM GRADE DIFFERENTIAL BETWEEN PASSES OF THE MILLING MATCHING SHALL NOT EXCEED 1-1/2" WHERE THE SPEED LIMIT IS 45 MPH OR LESS AND 1" WHERE THE SPEED LIMIT IS GREATER THAN 45 MPH, WITH WRITTEN APPROVAL FROM THE ENGINEER, A MAXIMUM GRADE DIFFERENTIAL OF 3" MAY BE ALLOWED IF THE EDGE OF THE MILLING IS SLOPED A MINIMUM 1:3 (V:H).
- 17. BUTT JOINT WILL BE INSTALLED AT THE ENDS OF ALL RESURFACING (WHERE RESURFACING MEETS EXISTING PAVEMENT), IN ACCORDANCE WITH THE DISTRICT DETAIL "BUTT JOINT AND BITUMINOUS TAPER DETAILS" SHEET INCLUDED IN THE PLANS, UNLESS OTHERWISE SPECIFIED.
- 18. FOR CLASS D PATCHING, CONTRACTOR SHALL MILL BEFORE PATCHING AS DIRECTED BY THE ENGINEER.
- 19. ALL ELEVATIONS ARE ON THE U.S.G.S. DATUM NAVD 88.
- 20. ALL OFFSET LOCATIONS GIVEN ON THE DETAILED PLANS FOR ADA RAMPS, PAVEMENT MARKINGS, ETC. ARE FROM THE CENTERLINE AS SHOWN ON THE PLANS.
- 21. DO NOT SCALE PLANS FOR CONSTRUCTION DIMENSIONS.
- 22. THE CONTRACTOR WILL BE REQUIRED TO COMPLY WITH ALL STATE REGULATIONS REGARDING AIR, WATER, AND NOISE POLLUTION. THE CONTRACTOR IS PROHIBITED FROM BURNING ANY MATERIAL WITHIN OR ADJACENT TO THE IMPROVEMENT.
- 23. SUPPLEMENTAL WATERING SHALL BE PERFORMED WHEN DIRECTED BY THE ENGINEER AT A RATE OF 10 GAL PER SO YD FOR SODDED AREAS.
- 24. TEMPORARY INFORMATION SIGNING AND CHANGEABLE MESSAGE SIGNS SHALL BE PLACED AT NORTH AND SOUTH PROJECT LIMITS. ADDITIONAL TEMPORARY INFORMATION SIGNING SHALL BE PLACED ON ALL SIDE ROADS OR AS DIRECTED BY THE ENGINEER, PRIOR TO THE COMMENCEMENT OF CONSTRUCTION ACTIVITIES. THE EXACT LOCATION SHALL BE DIRECTED BY THE ENGINEER.
- 25. ANY NECESSARY TRAFFIC CONTROL SIGNAGE SHALL BE COORDINATED WITH THE RAILROAD COMPANIES.

- 26.ACTUAL LOCATION AND SIZE OF BASE PATCHES WILL BE DETERMINED IN THE FIELD. NO COMPENSATION WILL BE ALLOWED FOR UNUSED PATCHING QUANTITIES.
- 27. TREE ROOT PRUNING SHALL BE USED WHERE NECESSARY IN AREAS OF PROPOSED SIDEWALK AS DIRECTED BY THE ENGINEER.
- 28. CONTRACTOR SHALL USE CAUTION WHEN WORKING NEAR AND UNDER OVERHEAD UTILITY FACILITIES.
- 29. WHEN CONSTRUCTING SIDEWALK RAMPS FOR THE HANDICAPPED, STATE STANDARDS LISTED IN THE HIGHWAY STANDARD INDEX SHALL APPLY. THE PROPOSED ELEVATIONS SHALL BE UTILIZED UNLESS FIELD CONDITIONS NECESSITATE DEVIATING FROM THE ELEVATIONS IN ORDER TO MEET ALL SLOPE REQUIREMENTS.
- 30. THE CONTRACTOR SHALL TAKE CARE IN REMOVING OR EXCAVATING NEAR ALL EXISTING ITEMS WHICH WILL REMAIN. DAMAGE DONE TO EXISTING ITEMS BY THE CONTRACTOR SHALL BE REPAIRED OR REPLACED.
- 31. THE CONTRACTOR SHALL OBTAIN ALL NECESSARY PERMITS, AS REQUIRED, PRIOR TO COMMENCING WITH CONSTRUCTION. THIS INCLUDES RIGHT-OF-ENTRY PERMIT FOR EACH RAILROAD.
- 32. NO WORK SHALL COMMENCE UNTIL TRAFFIC CONTROL REQUIREMENTS ARE MET.
- 33. ALL WORK INVOLVING SIGNS SHALL BE GOVERNED BY THE FOLLOWING REQUIREMENTS AND IN ACCORDANCE WITH IDOT SIGNING STANDARDS:
 - a. SIGNS SHALL NOT BE MOVED UNTIL PROGRESS OF WORK NECESSITATES IT.
 - b. EVERY SIGN REMOVED MUST BE RE-ERECTED AT A TEMPORARY LOCATION AND BE VISIBLE TO TRAFFIC FOR WHICH IT IS NEEDED. ALL SUCH SIGNS MUST BE MAINTAINED STRAIGHT AND CLEAN FOR THE DURATION OF THE TEMPORARY SETTING.
 - C. ALL SIGNS SHALL BE RE-ERECTED IN PERMANENT LOCATIONS AS THE ROADWAY IS COMPLETED. HORIZONTAL LOCATION FROM THE EDGE OF PAVEMENT SHALL BE AS DIRECTED BY THE FINGINEFR.
 - d. ALL UNUSED SIGNS WILL BE RETURNED TO THE: THE CITY OF ELMHURST
 - e. LONGER POSTS MAY BE REQUIRED AT SOME TEMPORARY OR PERMANENT SIGN LOCATIONS TO MAINTAIN PROPER SIGN ELEVATIONS.
- 4. ALL OF THE TRAFFIC CONTROL DEVICES SHALL BE IN PLACE BEFORE CONSTRUCTION IS STARTED. BOTH DIRECTIONS OF TRAVEL (I LANE IN EACH DIRECTION) SHALL BE MAINTAINED AT ALL TIMES AS DIRECTED BY THE ENGINEER. ANY LANE CLOSURES OR PARKING RESTRICTIONS MUST BE APPROVED BY THE ENGINEER. ALL SIDE ROADS AND DRIVEWAY ENTRANCES SHALL BE MAINTAINED AT ALL TIMES. NO CLOSURES TO SIDE ROADS OR DRIVEWAYS SHALL OCCUR.
- 35. PROPOSED IMPROVEMENTS SHALL BE COMPLETED UTILIZING TRAFFIC CONTROL IDOT HIGHWAY
- 36.STOP SIGNS AND STOP BARS ARE TO BE MAINTAINED ON ALL ROADS THROUGH THE DURATION OF CONSTRUCTION.
- 37. POSITIVE DRAINAGE WITHIN THE WORK ZONE MUST BE MAINTAINED AT ALL TIMES.
- 38. AT ADA SIDEWALK RAMP IMPROVEMENTS AND AT IMPROVED DRIVEWAY APRONS PVC 2 INCH CONDUIT SHALL BE INSTALLED. INSTALL CONDUIT 1 FOOT BEHIND THE CURB AND BELOW THE PAVEMENT IN EXISTING / PROPOSED STONE. THE CONDUIT SHALL EXTEND 2 FEET PAST SIDEWALK OR DRIVEWAY IMPROVEMENT AND THE END OF THE CONDUIT SHALL BE CAPPED WITH DUCT TAPE.
- 39. IT IS THE CONTRACTOR'S SOLE RESPONSIBILITY TO COORDINATE WITH THE UNION PACIFIC RAILROAD AND CANADIAN NATIONAL RAILROAD WHENEVER CONSTRUCTION ACTIVITY IS WITHIN 25 FEET OF THE RAILROAD ROW. THE CONTRACTOR SHALL RETAIN FLAGMEN EMPLOYED AND DESIGNATED BY THE UNION PACIFIC RAILROAD AND CANADIAN NATIONAL RAILROAD TO MONITOR ON-COMING TRAIN TRAFFIC, AND ADVISE CONTRACTOR PERSONNEL WHEN ITEM WILL BE PAID FOR ACCORDING TO ARTICLE 107.12 AND WILL BE REIMBURSED ACCORDING TO ARTICLE 109.05.
- 40. THE DETECTABLE WARNINGS FOR THE ADA RAMP IMPROVEMENTS SHALL BE SUPPLIED / MANUFACTURER: ADA SOLUTIONS, INC AND SHALL BE THE CAST IN PLACT REPLACEABLE TACTILE PANELS. THE DETECTABLE WARNINGS SHALL BE APPROVED BY THE ENGINEER.
- 41. ANY MATERIAL NECESSARY TO BE REMOVED AS EARTH EXCAVATION DUE TO SIDEWALK IMPROVEMENTS OR CURB AND GUTTER REPLACEMENTS SHALL BE DISPOSED OF ON SITE BEHIND CURB IMPROVEMENTS, SIDEWALK IMPROVEMENTS OR AS DIRECTED BY THE ENGINEER.

COMMITMENTS

CONTRACTOR SHALL OBTAIN RIGHT OF ENTRY PERMITS FROM BOTH RAILROAD COMPANIES



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•	PLOT DATE = 11/1/2018	DATE	-	08/07/2018	REVISED -

				CONSTR. CODE
				ROADWAY
CODE NO.	ITEM	UNIT	TOTAL QUANTITY	0005
140.	I I E.W	TINU	QUANTITI	
20101200	TREE ROOT PRUNING	EACH	10	10
21101625	TOPSOIL FURNISH AND PLACE, 6"	SQ YD	182	182
25000400	NITROGEN FERTILIZER NUTRIENT	POUND	2	2
	·			
25000500	PHOSPHORUS FERTILIZER NUTRIENT	POUND	2	2
25000600	POTASSIUM FERTILIZER NUTRIENT	POUND	2	, 2
25200110	SODDING, SALT TOLERANT	SO YD	182	182
05.000.00	CURRIEMENTAL WATERING		-	· 3
25200200	SUPPLEMENTAL WATERING	UNIT	2	. 2
28000510	INLET FILTERS	EACH	16	16
35101600	AGGREGATE BASE COURSE, TYPE B4"	SQ YD	421	421
40600290	BITUMINOUS MATERIALS (TACK COAT)	- POUND	6507	6507
40600400	MIXTURE FOR CRACKS, JOINTS, AND FLANGEWAYS	TON	3	3
40600827	POLYMERIZED LEVELING BINDER (MACHINE METHOD), 1L-4.75, N50	TON	405	405
40600982	HOT-MIX ASPHALT SURFACE REMOVAL - BUTT JOINT	SQ YD	140	140
40603335	HOT-MIX ASPHALT SURFACE COURSE, MIX "D", N50	TON	804	804

^{*} SPECIALTY ITEMS

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STATE	: 01	F ILLINOIS
DEPARTMENT	OF	TRANSPORTATION

SCALE: N/A

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 	30	J1411VI/	1111	01 407	4141111	ILO					CONTRAC	T NO. 6	1F20
SHEET	1	OF	4	SHEETS	STA.	N/A	TO STA.	N/A		ILLINOIS FED. A	D PROJECT		

				ROADWAY
CODE NO.	ITEM	UNIT	TOTAL QUANTITY	0005
42001300	PROTECTIVE COAT	SQ YD	103	103
42400200	PORTLAND CEMENT CONCRETE SIDEWALK 5 INCH	SQ FT ·	3846	3846
42400800	DETECTABLE WARNINGS	SQ FT	279	279
44000157	HOT-MIX ASPHALT SURFACE REMOVAL, 2"	SO YD	3639	3639
44000500	COMBINATION CURB AND GUTTER REMOVAL	FOOT	564	564
44000600	SIDEWALK REMOVAL	SO FT	4014	4014
44201785	CLASS D PATCHES, TYPE I, 12 INCH	. SO YD	189	189
44201789	CLASS D PATCHES, TYPE II, 12 INCH	SO YD	293	293
44201794	CLASS D PATCHES, TYPE III, 12 INCH	SQ YD	293	293
44201796	CLASS D PATCHES, TYPE IV, 12 INCH	SQ YD	189	189
60234200	INLETS, TYPE A, TYPE 1 FRAME, OPEN LID	EACH	1	1
60236800	INLETS, TYPE A, TYPE 11 FRAME AND GRATE	EACH	1	1
60500060	REMOVING INLETS	EACH	2	2
60603800	COMBINATION CONCRETE CURB AND GUTTER, TYPE B-6.12	FOOT	639	639

^{*} SPECIALTY ITEMS



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			CONTRACT	NO. 6	51F20
	2659	18-00194-00-RS	DUPAGE	30	4
	F.A.U. RTE.	SECTION	COUNTY	TOTAL SHEETS	SHEET NO.

				ROADWA
CODE			TOTAL	0005
NO.	I TEM ·	UNIT	QUANTITY	
67000400	ENGINEER'S FIELD OFFICE, TYPE A	CAL MO	3	3
67100100	MOBILIZATION	L SUM	1	1
70102620	TRAFFIC CONTROL AND PROTECTION, STANDARD 701501	L SUM	1	1
70102635	TRAFFIC CONTROL AND PROTECTION, STANDARD 701701	L SUM	1	1
70102640	TRAFFIC CONTROL AND PROTECTION, STANDARD 701801	L SUM	1	1
70107025	CHANGEABLE MESSAGE SIGN	CAL DA	90	90
70300100	SHORT TERM PAVEMENT MARKING	. гоот	1861	1861
70300150	SHORT TERM PAVEMENT MARKING REMOVAL	SO FT	621	621
78000100	THERMOPLASTIC PAVEMENT MARKING - LETTERS AND SYMBOLS	SQ FT	731	731
78000200	THERMOPLASTIC PAVEMENT MARKING - LINE4"	FOOT	931	931
78000400	THERMOPLASTIC PAVEMENT MARKING - LINE6"	FOOT	646	646
78000600	THERMOPLASTIC PAVEMENT MARKING - LINE 12"	FOOT	114	114
78000650	THERMOPLASTIC PAVEMENT MARKING - LINE 24"	FOOT	125	125
78001100	PAINT PAVEMENT MARKING - LETTERS AND SYMBOLS	SQ FT	40	40



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		WES	ST A	VENU	JE ·	- CITY	OF EL	MHURST			F.A.U. RTÉ.	SECT	LION		COUNTY	TOTAL	SHEE NO.
			SI	10/10/12	۱RV	OF QU	ΔΝΤΙΤ	IFC			2659	18-0019	4-00-RS		DUPAGE	30	5
			30		****										CONTRACT	NO.	61F20
SCALE:	N/A	SHEET	3	OF	4	SHEETS	STA.	N/A	TO STA.	N/A			ILLINOIS FE	D. AID F	PROJECT		

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PLOT DATE = 11/13/2018	DATE - 08/07/2018	REVISED -

CODE

STATE OF ILLINOIS DEPARTMENT OF TRANSPORTATION

WEST AVENUE – CITY OF ELMHURST SUMMARY OF QUANTITIES											
			SI	JMMA	RY	OF QU	ANTITI	IES			
SCALE:	N/A	SHEET	4	0F	4	SHEETS	STA.	N/A	TO STA.	N/A	


CONSTR. CODE

ROADWAY

0005


TOTAL

	NO.	ITEM	UNIT	QUANTITY	0005
	78008250	POLYUREA PAVEMENT MARKING TYPE I - LINE 12"	FOOT	60	60
	81028350	UNDERGROUND CONDUIT, PVC, 2" DIA.	FOOT	800	800
	87301215	ELECTRIC CABLE IN CONDUIT, SIGNAL NO. 142C	FOOT	200	200
	88600600	DETECTOR LOOP REPLACEMENT	FOOT	191	191
	88800100	PEDESTRIAN PUSH-BUTTON	EACH	1	1
	X0320050	CONSTRUCTION LAYOUT (SPECIAL)	L SUM	1	1
-	X0327890	DRIVEWAY REMOVAL AND REPLACEMENT	SO YD	60	60
	X1400031	REMOVE PEDESTRIAN PUSH-BUTTON	EACH	1	1
	X6026050	SANITARY MANHOLES TO BE ADJUSTED	EACH	12	12
	X6030310	FRAMES AND LIDS TO BE ADJUSTED (SPECIAL)	EACH	16	16
	Z0030850	TEMPORARY INFORMATION SIGNING	SQ FT	180	180
	Z0033700	LONGITUDINAL JOINT SEALANT	FOOT	3045	3045
	Z0048665	RAILROAD PROTECTIVE LIABILITY INSURANCE	L SUM	1	1

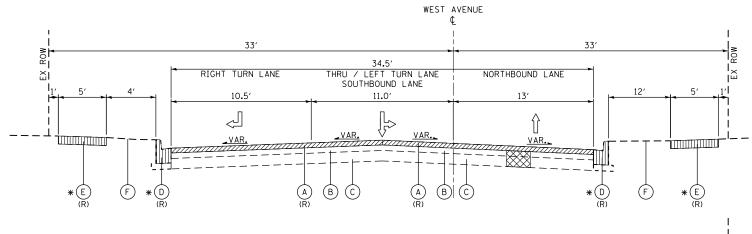


EXISTING TYPICAL SECTION

STA 100+44 TO STA 103+00, WEST AVENUE

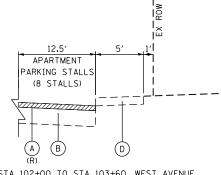


STA 102+00 TO STA 103+60, WEST AVENUE

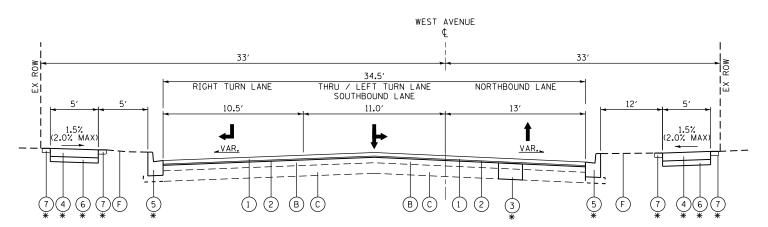

PROPOSED TYPICAL SECTION

STA 100+44 TO STA 103+00, WEST AVENUE

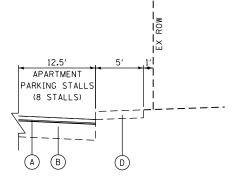

STA 102+00 TO STA 103+60, WEST AVENUE

EXISTING LEGEND

- A) EX. HOT-MIX ASPHALT SURFACE COURSE, 2" (R)
- B EX. HOT-MIX ASPHALT BASE COURSE, 6"
- C EX. AGGREGATE BASE COURSE, 6"
- *(D) EX. COMB. CONCRETE CURB & GUTTER, TY B-6.12
- *(E) EX. P.C.C. SIDEWALK
- EX. TOPSOIL

ITEMS WITH (R) ARE TO BE REMOVED AS SHOWN ON THE TYPICAL SECTIONS AND/OR ON THE PLAN SHEETS.

 $_{\mbox{\scriptsize \#}}$ ITEM TO BE REMOVED AND REPLACED AT LOCATIONS INDICATED IN THE PLANS AND/OR DIRECTED BY THE ENGINEER

HOT-MIX ASPHALT SURFACE REMOVAL, 2"

CLASS D PATCHES (AS DIRECTED BY THE ENGINEER)

COMBINATION CURB AND GUTTER REMOVAL / SIDEWALK REMOVAL (AS SHOWN IN THE PLANS OR DIRECTED BY THE ENGINEER)

PROPOSED LEGEND

- 1) PR. HMA SURFACE COURSE, MIX "D", N50, 1 1/2"
- 2) PR. POLY. LEVELING BINDER (MACHINE METHOD), IL-4.75, 3/4"
- (3) CLASS D PATCHES
- *4 PORTLAND CEMENT CONCRETE SIDEWALK, 5 INCH
- COMBINATION CONCRETE CURB AND GUTTER, TYPE B-6.12
- *(6) AGGREGATE BASE COURSE, TY B 4"
- *(7) TOPSOIL FURNISH & PLACE, 6" WITH SODDING SALT TOLERANT
- \ast ITEM TO BE REMOVED AND REPLACED AT LOCATIONS INDICATED IN THE PLANS AND/OR DIRECTED BY THE ENGINEER

THE CONTRACTOR SHALL MILL ROADWAY DAVEMENT RRIOR TO RAVEMENT RATCHING

THE CONTRACTOR SHALL MILL ROADWAY PAVEMENT PRIOR TO PAVEMENT PATCHING.								
HOT-MIX ASPHALT MIXTURE REQUIREMENTS								
MIXTURE TYPE AIR VOID @ Ndes								
PAVEMENT RESURFACING								
HOT-MIX ASPHALT SURFACE COURSE, MIX "D", N50 (IL 9.5 mm); 1 1/2"	4% @ 50 GYR							
POLYERMIZED LEVELING BINDER (MACHINE METHOD), IL-4.75, N50 (IL 9.5 mm), 3/4" 3.5% @ 50 (
PAVEMENT PATCHING								
CLASS D PATCHES, HOT-MIX ASPHALT BINDER (IL 19 mm), N70; 12"	4% @ 70 GYR							

THE UNIT WEIGHT USED TO CALCULATE ALL HOT-MIX ASPHALT SURFACE MIXTURES IS 112 LBS/SQ YD/IN.

THE "AC TYPE" FOR POLYMERIZED HMA MIXES SHALL BE "SBS/SBR PG 76-22" AND FOR NON-POLYMERIZED HMA THE "AC TYPE" SHALL BE "PG 64-22" UNLESS MODIFIED BY DISTRICT ONE SPECIAL PROVISIONS.

FOR USE OF RECYCLED MATERIALS SEE DISTRICT ONE SPECIAL PROVISIONS.


THE LONGITUDINAL JOINT SEALANT SHALL BE PLACED UNDER THE SURFACE LIFT, PER BDE SPECIAL PROVISION

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D	
BI.A. Inc.	7
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	USER NAME = cesario	DESIGNED	-	DM	REVISED -
		DRAWN	-	DM	REVISED -
	PLOT SCALE = 100.0000 ' / in.	CHECKED	-	MC	REVISED -
۰	PLOT DATE = 10/1/2018	DATE	-	08/07/2018	REVISED -


STATE OF ILLINOIS **DEPARTMENT OF TRANSPORTATION**

		WEST A	AVEN	UE	– CITY	OF ELI	WHURST			F.A.U. RTE.	SECTION	COUNTY	TOTAL SHEETS	SHEE NO.
			TVI	DIC/	L SECT	IUNIC				2659	18-00194-00-RS	DUPAGE	30	7
				1 107	IL SEUT	IUIVO						CONTRAC	T NO. (61F20
SCALE:	N/A	SHEET 1	OF	2	SHEETS	STA.	N/A	TO STA.	N/A		TILL INDIS FED. A	ID PROJECT		

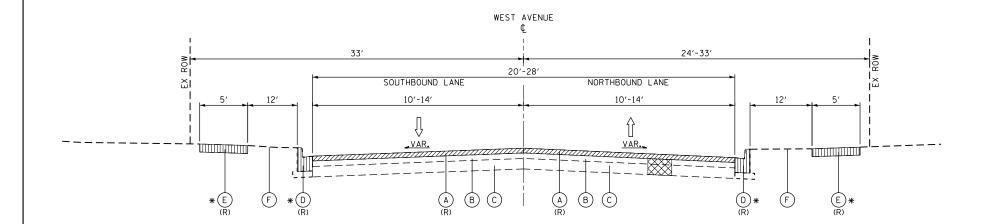

EXISTING TYPICAL SECTION

STA 103+00 TO STA 129+44.50, WEST AVENUE RAILROAD OMISSION STA 113+97.72 TO STA 114+21.42, WEST AVENUE

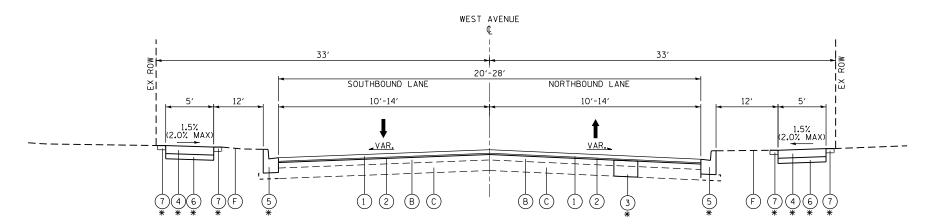

PROPOSED TYPICAL SECTION

STA 103+00 TO STA 129+44.50, WEST AVENUE RAILROAD OMISSION STA 113+97.72 TO STA 114+21.42, WEST AVENUE

EXISTING LEGEND

- (A) EX. HOT-MIX ASPHALT SURFACE COURSE, 2" (R)
- (B) EX. HOT-MIX ASPHALT BASE COURSE, 6"
- C EX. AGGREGATE BASE COURSE, 6"
- *(D) EX. COMB. CONCRETE CURB & GUTTER, TY B-6.12
- * E EX. P.C.C. SIDEWALK
- F EX. TOPSOIL

ITEMS WITH (R) ARE TO BE REMOVED AS SHOWN ON THE TYPICAL SECTIONS AND/OR ON THE PLAN SHEETS.

 $_{\mbox{\scriptsize H}}$ ITEM TO BE REMOVED AND REPLACED AT LOCATIONS INDICATED IN THE PLANS AND/OR DIRECTED BY THE ENGINEER

HOT-MIX ASPHALT SURFACE REMOVAL, 2"

CLASS D PATCHES (AS DIRECTED BY THE ENGINEER)

COMBINATION CURB AND GUTTER REMOVAL / SIDEWALK REMOVAL (AS SHOWN IN THE PLANS OR DIRECTED BY THE ENGINEER)

PROPOSED LEGEND

- (1) PR. HMA SURFACE COURSE, MIX "D", N50, 1 1/2"
- 2) PR. POLY. LEVELING BINDER (MACHINE METHOD), IL-4.75, 3/4"
- (3) CLASS D PATCHES
- *(4) PORTLAND CEMENT CONCRETE SIDEWALK, 5 INCH
- * 5 COMBINATION CONCRETE CURB AND GUTTER, TYPE B-6.12
- *(6) AGGREGATE BASE COURSE, TY B 4"
- *(7) TOPSOIL FURNISH & PLACE, 6" WITH SODDING SALT TOLERANT
- ITEM TO BE REMOVED AND REPLACED AT LOCATIONS INDICATED IN THE PLANS AND/OR DIRECTED BY THE ENGINEER

BLA, Inc.

USER NAME = cesario	DESIGNED	-	DM	REVISED -
	DRAWN	-	DM	REVISED -
PLOT SCALE = 100.0000 ' / in.	CHECKED	-	MC	REVISED -
PLOT DATE = 10/1/2018	DATE	-	08/07/2018	REVISED -

		WE	ST #	VENU	JE -	- CITY	OF ELI	MHURST	
				TYF	PICA	L SECT	IONS		
SCALE:	N/A	SHEET	2	OF	2	SHEETS	STA.	N/A	TO ST

	ILLINOIS FE	ED. AIC	PROJECT		
			CONTRACT	NO. 6	51F2C
2659	18-00194-00-RS		DUPAGE	30	8
F.A.U. RTE.	SECTION		COUNTY	TOTAL SHEETS	SHEE NO.

STATION -	- STATION	OFFSET	HMA SURFACE REMOVAL, 2" (SQ YD)	HMA SURFACE REMOVAL BUTT JOINT (SQ YD)	SIDEWALK REMOVAL (SQ FT)	CURB AND GUTTER REMOVAL (FT)
100+00	104+50	LT / RT	1,693	19	329	22
104+50	110+00	LT / RT	1,934	34	975	166
110+00	115+50	LT / RT	1,778	42	1,108	128
115+50	121+00	LT / RT	1,782	24	988	106
121+00	126+00	LT / RT	1,556		350	20
126+00	131+00	LT / RT	896	21	264	122
		TOTAL	9,639	140	4,014	564

STATION -	- STATION	OFFSET (LT / RT)	HMA SURFACE COURSE MIX "D" N50 (TON)	POLYMERIZED LEVELING BINDER (MACHINE METHOD) IL-4.75, N50 (TON)	BITUMINOUS MATERIALS (TACK COAT) (POUND)
100+00	104+50	LT / RT	141	71	1143
104+50	110+00	LT / RT	160	81	1306
110+00	115+50	LT / RT	149	75	1200
115+50	121+00	LT / RT	149	75	1203
121+00	126+00	LT / RT	131	65	1050
126+00	131+00	LT / RT	74	38	605
		TOTAL	804	405	6,507

STATION -	- STATION	OFFSET (LT / RT)	PORTLAND CEMENT CONCRETE SIDEWALK, 5 INCH (SO FT)	COMBINATION CURB AND GUTTER TYPE-B.12 (FOOT)	AGGREGATE BASE COURSE TYPE B, 4 INCH (SO YD)
100+00	104+50	LT / RT	329	97	38
104+50	110+00	LT / RT	975	166	109
110+00	115+50	LT / RT	1,029	128	106
115+50	121+00	LT / RT	973	106	108
121+00	126+00	RT	350	20	39
126+00	131+00	RT	190	122	21
		TOTAL	3,846	639	421

DETECTABLE WARNINGS				
INTERSECTION	OFFSET	QUADRANT	AREA	
INTERSECTION	(LT / RT)	(NW, SW, NE, SE)	(SQ FT)	
KOHL'S	LT	NW	10	
KURL 3	LT	SW	10	
SUNNYSIDE AVE	RT	NE	9	
SUNNISIDE AVE	RT	SE	10	
FELLOW'S CT	RT	NE	10	
FELLOW 3 CT	RT	SE	10	
ALLEY	RT	NE	10	
ALLET	RT	SE	10	
	LT	NW	10	
WHOLE FOODS	LT	SW	23	
	RT	SE	10	
WHOLE FOODS	LT	NW	10	
WHOLE FOODS	LT	SW	10	
RAILROAD	LT	W	10	
RAILROAD	RT	Ε	10	
FIM PARK AVE	RT	NE	9	
ELM FARR AVE	RT	SE	10	
	LT	NW	20	
UTLEY RD	LT	SW	20	
UILEI KU	RT	NE	20	
	RT	SE	19	
ALEXANDER BLVD	RT	NE	9	
ALEXANDER DLVD	RT	SE	10	
		TOTAL	279	

INLET FILTERS				
CTATION	OFFSET	QUANTITY		
STATION	(LT / RT)	(EA)		
103+34.07	19.85′ RT	1		
104+22.79	12.82′ RT	1		
105+04.21	13.35′ RT	1		
105+32.66	12.70′ RT	1		
107+17.09	19 . 62′ RT	1		
108+36.77	19 . 67′ RT	1		
108+61.31	18.22' RT	1		
108+94.40	16.09' LT	1		
115+27.50	15.05′ LT	1		
115+56.06	14.73′ RT	1		
119+90.61	17.75′ RT	1		
120+25.80	18.31' RT	1		
120+41.02	13.62' LT	1		
123+53.51	14.58' LT	1		
123+79.03	14.99′ RT	1		
124+27.33	14.59′ LT	1		
	TOTAL	16		

CTATION	OFFSET	QUANTITY
STATION	(LT / RT)	(EA)
100+72.49	3.32′ RT	1
100+72.58	11.15' RT	1
102+00.00	11.04' LT	1
103+34.07	19.85' RT	1
105+04.21	13.35' RT	1
105+32.66	12.70' RT	1
106+75.37	30.63' RT	1
106+97.12	38.46′ RT	1
107+17.09	19.62' RT	1
115+23.11	8.41' RT	1
118+35.75	10.19' LT	1
119+45.26	12.48' LT	1
119+66.92	10.57' LT	1
123+53.51	14.58' LT	1
124+27.33	14.59' LT	1
126+62.63	25.27' RT	1

	OFFSET	QUANTITY
STATION		
	(LT / RT)	(EA)
103+84.66	13 . 06′ LT	1
106+26.67	14.69' LT	1
106+83.52	14.43′ LT	1
107+09.29	14.43′ LT	1
110+93.13	15.51′ LT	1
115+56.06	14.73′ RT	1
117+53.44	11.71' RT	1
119+92.46	4.49' LT	1
119+93.48	10 . 12′ RT	1
120+06.89	10.71' LT	1
123+28.61	0.15' LT	1
126+58.30	3.39' LT	1
	TOTAL	12

REMOVING INLETS				
STATION	OFFSET	QUANTITY		
STATION	(LT / RT)	(EA)		
104+72.79	12.82' RT	1		
120+41.02	13.62' LT	1		
TOTAL 2				

INLETS, TYPE	A, TYPE 11 FRA	ME AND GRATE
STATION	OFFSET	QUANTITY
STATION	(LT / RT)	(EA)
104+72.79	12.82′ RT	1
	TOTAL	1

INLETS, TYPE	A, TYPE 1 FRA	ME, OPEN LID
STATION	OFFSET	QUANTITY
STATION	(LT / RT)	(EA)
120+41.02	13.62' LT	1
	1	


THERMOPLASTIC PAVEMENT MARKING								PAINT PAVEMENT MARKING	POLYURA PAVEMENT MARKING
STATION	- STATION	OFFSET	4 INCH	6 INCH	12 INCH	24 INCH	LETTERS & SYMBOLS	LETTERS & SYMBOLS	12 INCH
From	То	(LT / RT)	(FT)	(FT)	(FT)	(FT)	(SQ FT)	(SQ FT)	(FT)
100+00	104+50	LT / RT	931	285		24	53	40	
104+50	110+00	LT / RT		63		15			
110+00	115+50	LT / RT		84	66	12	226		12
115+50	121+00	LT / RT		162	48	39	226		48
121+00	126+00	LT / RT							
126+00	131+00	LT / RT		52		35	226		
		TOTAL	931	646	114	125	731	40	60

BLA,	Inc.
BLA,	Inc.

USER NAME = cesario	DESIGNED	-	DM	REVISED -
	DRAWN	-	DM	REVISED -
PLOT SCALE = 100.0000 ' / in.	CHECKED	-	MC	REVISED -
PLOT DATE = 11/1/2018	DATE	-	08/07/2018	REVISED -

STATE OF ILLINOIS							
DEPARTMENT OF TRANSPORTATION							

_	WEST AVENUE – CITY OF ELMHURST								F.A.U. RTE. SECTION		COUNTY TOTAL SHEETS		SHEET NO.				
				S.C	HEDI	II F	OF OIL	ANTITI	FC			2659	18-00194-00-	RS	DUPAGE	30	9
	SCHEDULE OF QUANTITIES												CONTRACT	NO. 6	61F20		
	SCALE:	N/A	SHEET	1	OF	1	SHEETS	STA.	N/A	TO STA.	N/A		ILLING	DIS FED. A	ID PROJECT		

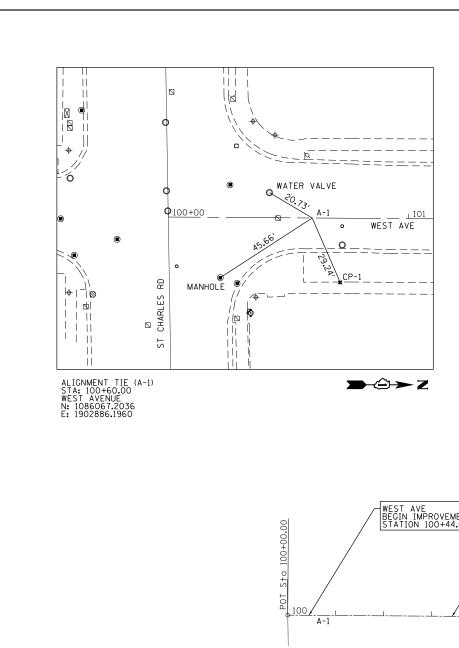

USER NAME = cesario

PLOT SCALE = 200.0000 '/ in.

DRAWN - DM

CHECKED - MC

- 08/07/2018


DATE

REVISED

REVISED

REVISED

BLA, Inc.

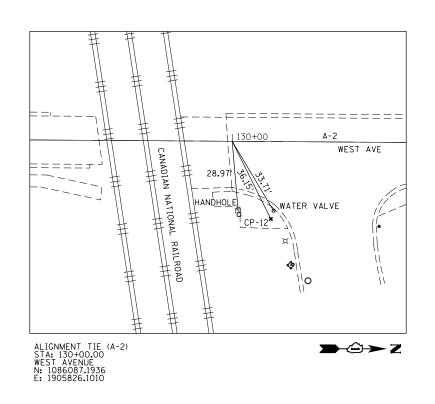

COORDINATE DATA TABLE									
STATION	OFFSET	ELEMENT TYPE	NORTHING	EASTING	ELEVATION				
100+71.82	26.75′ RT	CUT CROSS	1086094.0300	1902897.8100	670.98				
103+52.71	31.21' RT	CUT CROSS	1086100.4000	1903178.6600	670.03				
105+31.15	26.91′ RT	CUT CROSS	1086097.3191	1903357.1220	669.64				
107+19.65	37.31′ RT	CUT CROSS	1086109.0000	1903545.5500	669.71				
108+63.17	26.53′ RT	CUT CROSS	1086099.1994	1903689.1459	670.44				
111+59.13	30.34′ LT	CUT CROSS	1086044.3400	1903985.4800	673.95				
113+60.31	30.38′ RT	CUT CROSS	1086106.4300	1904186.2400	675.47				
114+38.84	32.47′ RT	CUT CROSS	1086109.0488	1904264.7574	674.20				
119+69.69	25.82′ RT	CUT CROSS	1086106.0100	1904795.6400	672.50				
120+32.17	34.04′ LT	CUT CROSS	1086046.5723	1904858.5289	671.53				
123+00.30	25.88′ RT	CUT CROSS	1086108.3200	1905126.2400	672.73				
130+16.32	32.26′ RT	CUT CROSS	1086119.5600	1905842.2000	686.08				

COUNTY TOTAL SHEET NO.

194-00-RS DUPAGE 30 10

CONTRACT NO. 61F20

ILLINOIS FED. AID PROJECT

SECTION


18-00194-00-RS

2659

WEST AVENUE - CITY OF ELMHURST


ALIGNMENT, TIES AND BENCHMARKS


SCALE: 1"=100" SHEET 1 OF 1 SHEETS STA. 100+00 TO STA. 130+00

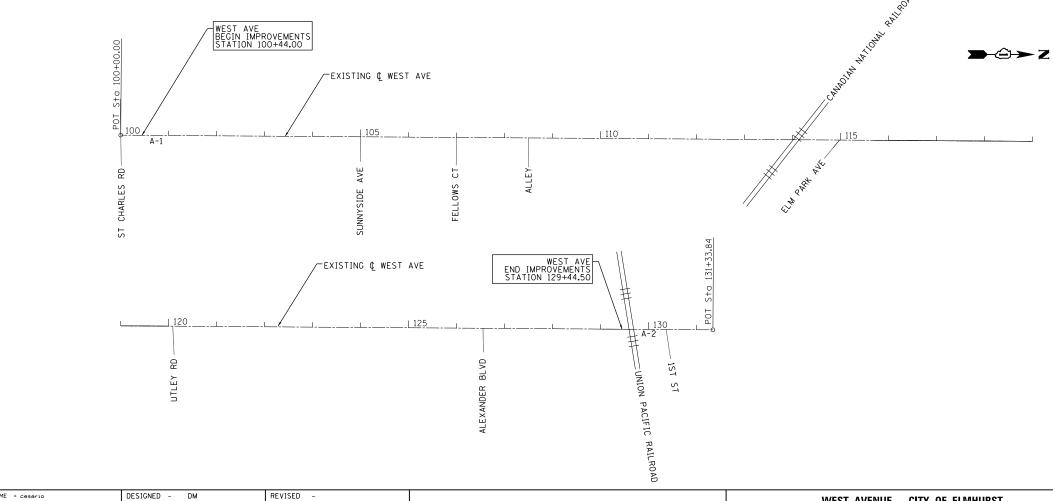


STATE OF ILLINOIS

DEPARTMENT OF TRANSPORTATION

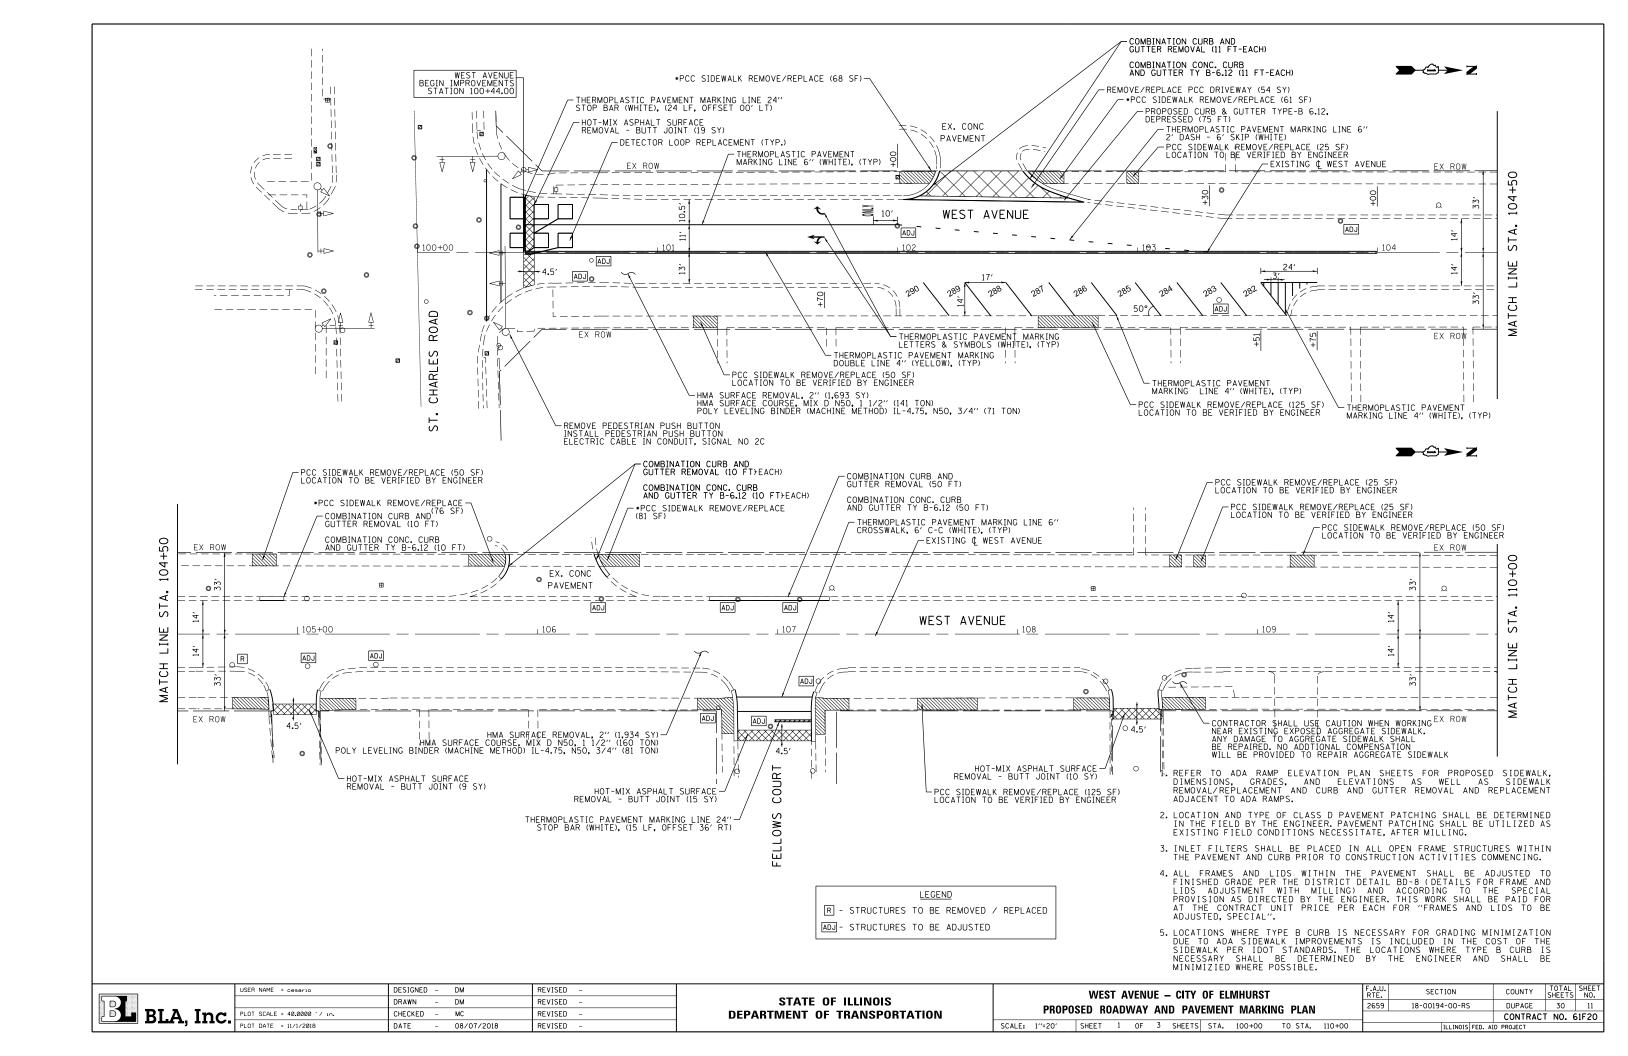

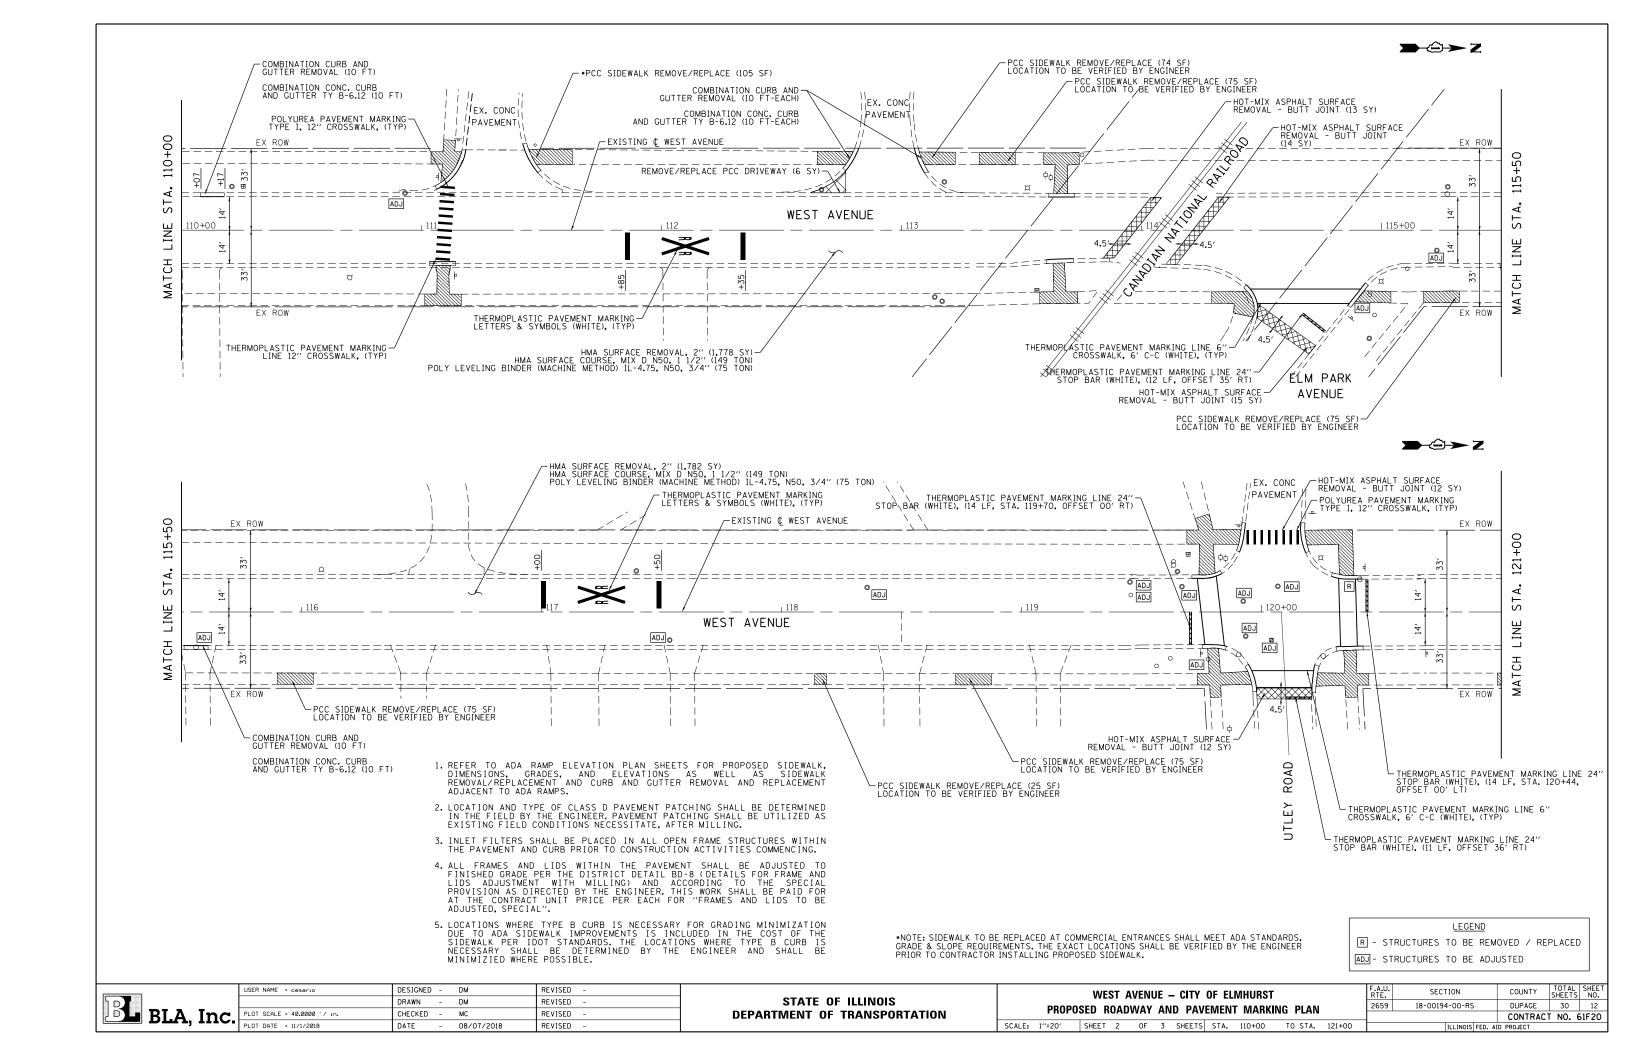

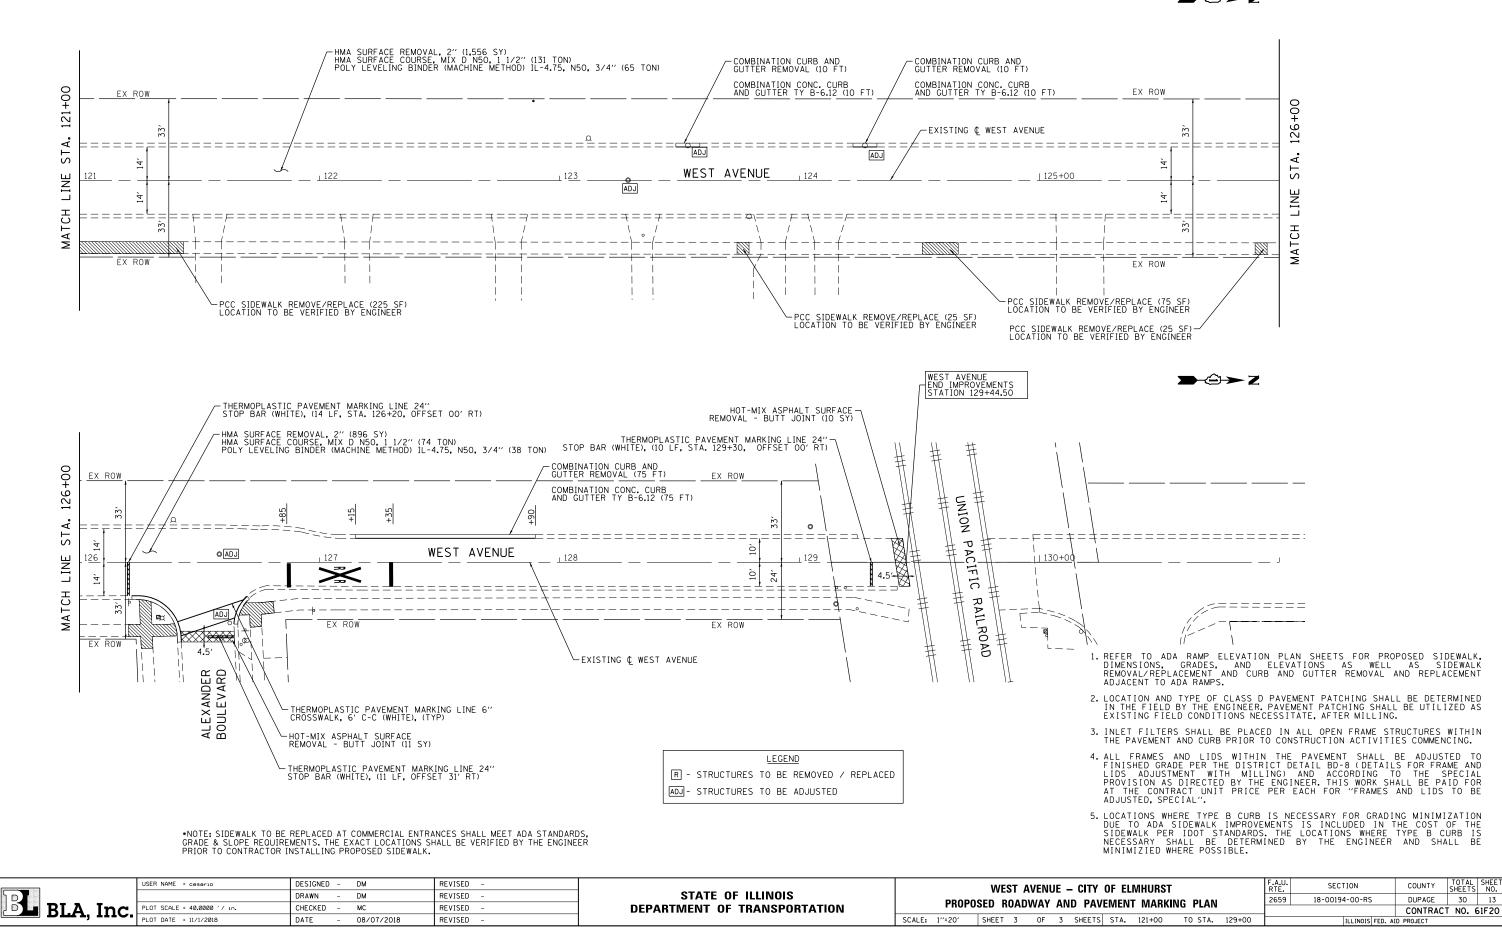

REMOVALS



EX ROW

COMBINATION CURB AND
GUTTER REMOVAL (11 FT)

SIDEWALK REMOVAL (73 SF)

COMBINATION CURB AND
GUTTER REMOVAL (11 FT)

LEGEND



DETECTABLE WARNING



SIDEWALK REMOVAL




HOT-MIX ASPHALT SURFACE REMOVAL - BUTT JOINT

PROPOSED



______ 105+00

WEST AVE

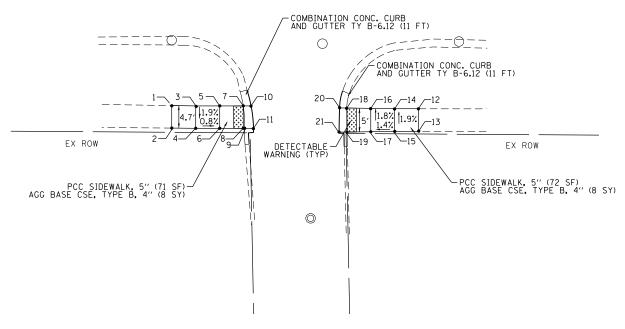

	SUNNYSID	SUNNYSIDE AVENUE					
POINT No.	STATION	OFFSET	ELEV.				
1	104+72.90	26.44′ RT	M.E.				
2	104+72.93	31.14′ RT	M.E.				
3	104+77.90	26.49' RT	669.20				
4	104+77.93	31.15′ RT	669.29				
5	104+82.90	26.45' RT	669.16				
6	104+82.93	31.12' RT	669.25				
7	104+87.80	26.42' RT	668.94				
8	104+87.84	31.08' RT	669.03				
9	104+88.13	31.08' RT	669.02				
10	104+89.43	26.42′ RT	668.93				
11	104+89.97	31.07′ RT	669.01				

SUNNYSIDE AVENUE									
POINT No.:	STATION	OFFSET	ELEV.						
12	105+24.36	26.76′ RT	M.E.						
13	105+24.39	31 . 48′ RT	M.E.						
14	105+19.36	26.80' RT	669.37						
15	105+19.39	31.52′ RT	669.46						
16	105+14.37	26.76′ RT	669.30						
17	105+14.41	31 . 62′ RT	669.39						
18	105+09.37	26.72′ RT	669.01						
19	105+09.45	31.72′ RT	669.11						
20	105+07.88	26.71' RT	669.03						
21	105+07.82	31.73′ RT	669.13						

BLA,	Inc.
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USER NAME = cesario	DESIGNED	-	DM	REVISED -
	DRAWN	-	DM	REVISED -
PLOT SCALE = 20.0000 '/ in.	CHECKED	-	MC	REVISED -
PLOT DATE = 10/1/2018	DATE	-	08/07/2018	REVISED -

STATI	E OF	ILLINOIS
DEPARTMENT	0F	TRANSPORTATION

	WEST AVENUE – CITY OF ELMHURST	F.A.L RTE.		COUNTY	TOTAL SHEETS	SHEET NO.
	ADA RAMP ELEVATION PLAN	2659	18-00194-00-RS	DUPAGE	30	14
				CONTRAC	T NO. (51F20
SCALE: 1"=10"	SHEET 1 OF 8 SHEETS STA. N/A TO STA. N/A		ILLINOIS FED. A	ID PROJECT		


EX ROW


EX ROW

WEST AVENUE

EX ROW

107

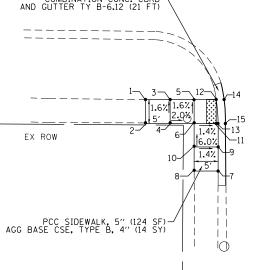

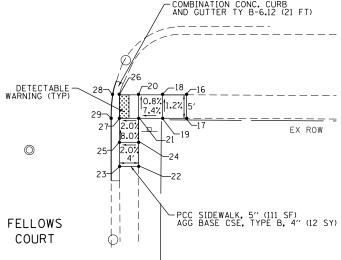

		FELLOWS	COURT	
POINT	No.:	STATION	OFFSET	ELEV.
1		106+66.65	26.70' RT	M.E.
2		106+66.69	31.70′ RT	M.E.
3		106+71.79	26.66′ RT	669.24
4		106+71.82	31.66′ RT	669.32
5		106+76.79	26.63′ RT	669.14
6		106+76.82	31 . 63′ RT	669.22
7		106+81.88	41 . 50′ RT	M.E.
8		106+76.89	41 . 53′ RT	M.E.
9		106+81.86	36.47′ RT	669.45
10		106+76.86	36.50' RT	669.52
11		106+81.41	31 . 59′ RT	669.15
12		106+81.38	26.60' RT	669.11
13		106+81.82	31 . 59′ RT	669.14
14		106+83.04	26.60' RT	669.09
15		106+83.34	31 . 59′ RT	669.12


POINT No.:	STATION	OFFSET	ELEV.
16	107+29.83	26.75' RT	M.E.
17	107+29.87	31 . 64′ RT	M.E.
18	107+24.83	26.78' RT	669.55
19	107+24.87	31 . 67′ RT	669.61
20	107+19.83	26.81' RT	669.20
21	107+19.87	31.71′ RT	669.26
22	107+19.93	41.74′ RT	M.E.
23	107+15.96	41.76′ RT	M.E.
24	107+19.90	36.71' RT	669.66
25	107+15.90	36.73' RT	669.56
26	107+15.80	26.84' RT	669.10
27	107+15.84	31.73′ RT	669.16
28	107+14.41	26.84' RT	669.08
29	107+14.13	31.73' RT	669.14

FELLOWS COURT

EX ROW

WEST AVENUE

107

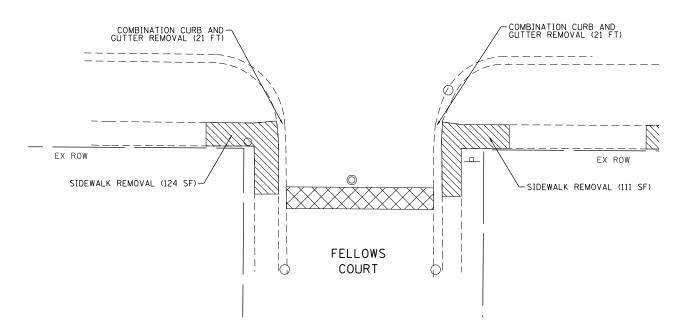

LEGEND



DETECTABLE WARNING



SIDEWALK REMOVAL



B	BLA,	Inc.
	BLA,	Inc.

USER NAME = cesario	DESIGNED	-	DM	REVISED -
	DRAWN	-	DM	REVISED -
PLOT SCALE = 20.0000 '/ in.	CHECKED	-	MC	REVISED -
PLOT DATE = 10/1/2018	DATE	-	08/07/2018	REVISED -

WEST AVENUE - CITY OF ELMHURST							F.A.U. RTE.	SECTION	COUNTY	TOTAL	SHEET NO.		
	ADA RAMP ELEVATION PLAN						2659	18-00194-00-RS	DUPAGE	30	15		
ADA NAIVIF ELEVATION FEAN									CONTRAC	T NO. 6	61F20		
SCALE: 1"=10"	SHEET 2	OF	8	SHEETS	STA.	N/A	TO STA.	N/A		ILLINOIS FED. A	ID PROJECT		

EX ROW	REMOVALS	EX ROW
=======================================	· · · · · · · · · · · · · · · · · · ·	===== 0
108	WEST AVENUE	
EX ROW SIDEWALK REMOVAL (74 SF) COMBINATION CURB AND GUTTER REMOVAL (11 FT:	s	EX ROW SIDEWALK REMOVAL (90 SF) WATION CURB AND REMOVAL (11 FT)
LEGEND DETECTABLE WARNING		
SIDEWALK REMOVAL		
HOT-MIX ASPHALT SURFACE	REMOVAL - BUTT JOINT	


PROPOSED

→Û→Z

EX ROW

EX ROW


WEST AVENUE

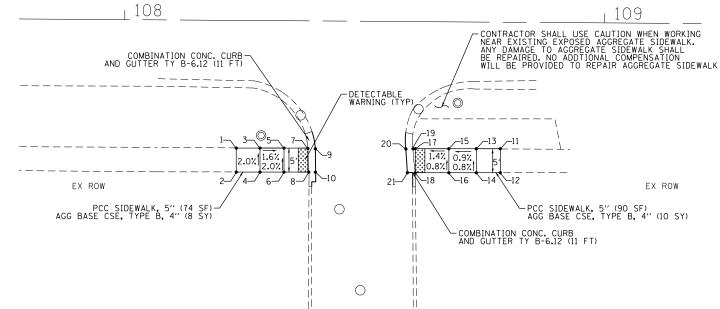

ALLEY					
POINT No.:	STATION	OFFSET	ELEV.		
1	108+23.41	26.61' RT	M.E.		
2	108+23.44	31.61' RT	M.E.		
3	108+28.35	26.58' RT	670.42		
4	108+28.38	31 . 58′ RT	670.52		
5	108+33.35	26.54′ RT	670.34		
6	108+33.38	31 . 54′ RT	670.44		
7	108+38.32	26.51' RT	670.28		
8	108+38.55	31.50′ RT	670.38		
9	108+39.88	26.51' RT	670.26		
10	108+39.98	31.51′ RT	670.36		
11	108+78.42	26.37' RT	M.E.		
12	108+78.45	31.37' RT	M.E.		
13	108+73.42	26.40′ RT	670.48		
14	108+73.45	31.40′ RT	670.52		
15	108+67.70	26.44′ RT	670.43		
16	108+67.74	31.44′ RT	670.47		
17	108+60.70	26.49′ RT	670.33		
18	108+60.74	31.49' RT	670.42		
19	108+60.23	26.49' RT	670.32		
20	108+58.74	26.49′ RT	670.30		
21	108+59.09	31.49′ RT	670.40		


	BLA,	Inc.
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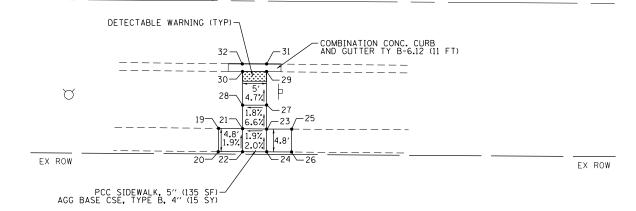
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PLOT SCALE = 20.0000 '/ in.	CHECKED	-	MC	REVISED -
PLOT DATE = 10/1/2018	DATE	-	08/07/2018	REVISED -

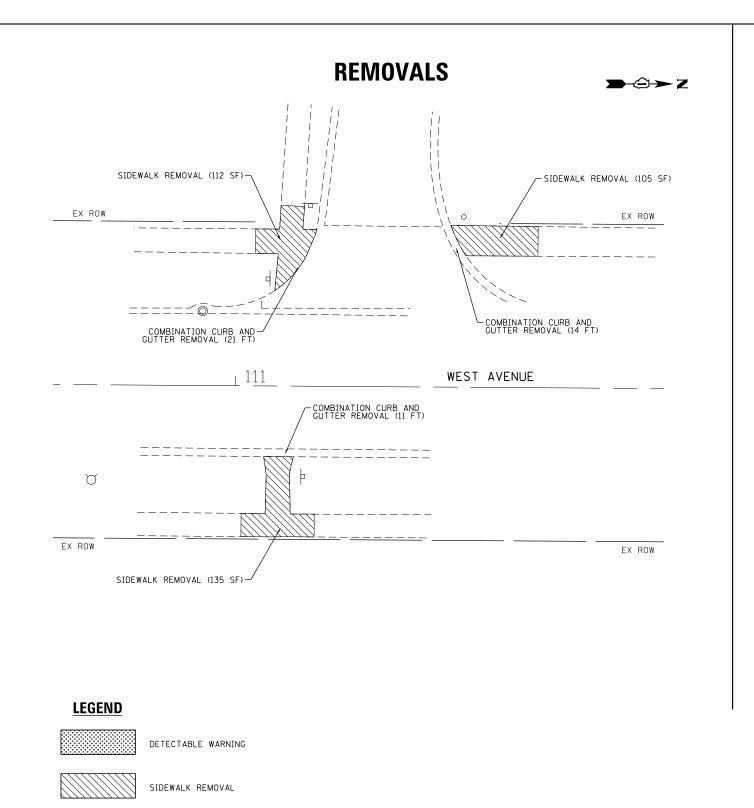

PROPOSED





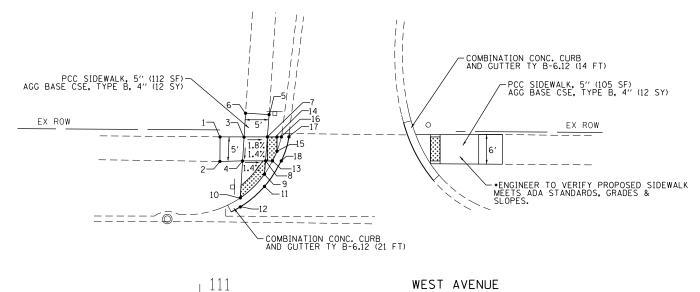

WHOLE FOODS ENTRANCE							
POINT No.:	STATION	OFFSET	ELEV.				
1	111+04.01	32.70′ LT	M.E.				
2	111+04.00	27.59′ LT	M.E.				
3	111+09.01	32.73′ LT	672.81				
4	111+08.72	27.73′ LT	672.74				
5	111+14.19	37.41′ LT	672.91				
6	111+09.29	37.69' LT	672.94				
7	111+13.86	32.76′ LT	672.72				
8	111+13.50	27.76′ LT	672.67				
9	111+13.30	25 . 00′ LT	672.65				
10	111+08.29	20.00' LT	672.60				
11	111+13.30	22 . 41′ LT	672.63				
12	111+08.29	18.13' LT	672.58				
13	111+14.96	27.77′ LT	672.64				
14	111+15.86	32.78′ LT	672.68				
15	111+15.88	29.79' LT	672.65				
16	111+16.78	32.78′ LT	672.67				
17	111+18.35	32.78′ LT	672.65				

WHOLE FOODS ENTRANCE					
POINT No.:	STATION	OFFSET	ELEV.		
18	111+16.78	27.77′ LT	672.62		
19	111+01.39	26.60' RT	M.E.		
20	111+01.37	31.43′ RT	M.E.		
21	111+06.39	26.63' RT	673.05		
22	111+06.42	31.43′ RT	673.14		
23	111+11.39	26.68' RT	673.14		
24	111+11.42	31.42′ RT	673.23		
25	111+16.62	26.64' RT	M.E.		
26	111+16.63	31.41' RT	M.E.		
27	111+11.36	21.68' RT	672.81		
28	111+06.36	21.71' RT	672.72		
29	111+11.31	14.72′ RT	672.48		
30	111+06.31	14.71' RT	672.41		
31	111+11.31	13.10' RT	672.46		
32	111+06.31	13.10' RT	672.39		


BLA,	Inc.

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	DRAWN	-	DM	REVISED -
PLOT SCALE = 20.0000 ' / in.	CHECKED	-	MC	REVISED -
PLOT DATE = 10/1/2018	DATE	-	08/07/2018	REVISED -

STATE OF ILLINOIS	
DEPARTMENT OF TRANSPORTATION	

	WEST AVENUE – CITY OF ELMHURST	F.A.U. RTE.	SECTION	COUNTY	TOTAL SHEETS	SHEET NO.
	ADA RAMP ELEVATION PLAN	2659	18-00194-00-RS	DUPAGE	30	17
				CONTRAC	T NO. (61F20
SCALE: 1"=10"	SHEET 4 OF 8 SHEETS STA. N/A TO STA. N/A		ILLINOIS FED. A	ID PROJECT		



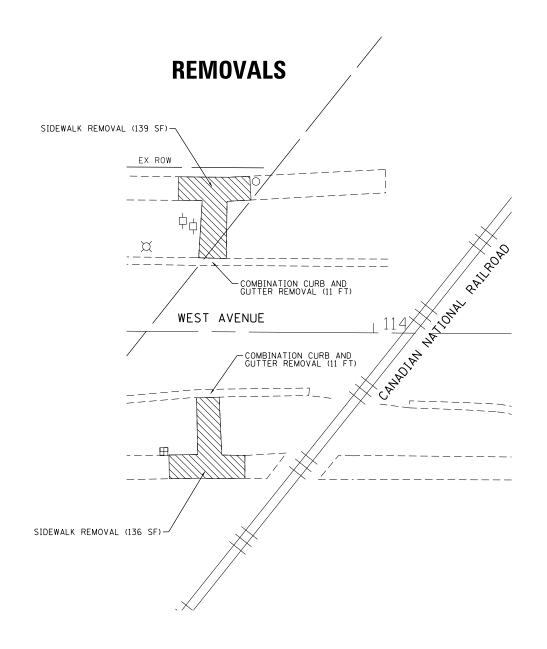

LEGEND




DETECTABLE WARNING



SIDEWALK REMOVAL



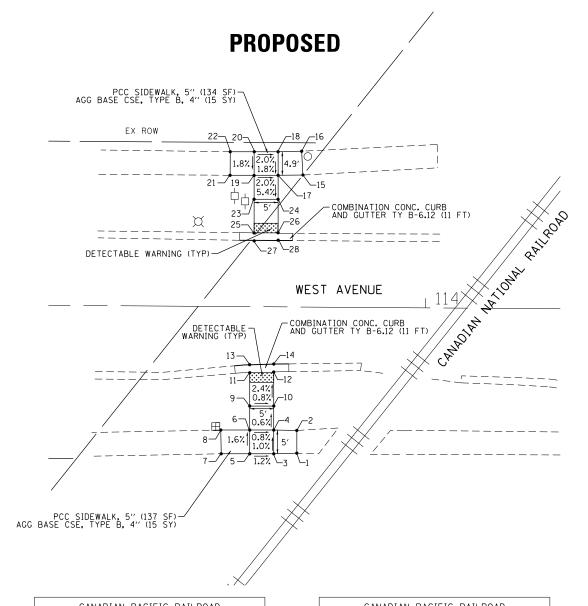

CANADIAN PACIFIC RAILROAD						
POINT No.:	STATION	OFFSET	ELEV.			
1	113+59.11	32.25′ LT	M.E.			
2	113+59.11	27.35′ LT	M.E.			
3	113+64.07	32.28′ LT	675.40			
4	113+64.11	27.38' LT	675.35			
5	113+69.07	32 . 31′ LT	675.46			
6 113+69.1		27 . 41′ LT	675.38			
7 113+73.99		32.46′ LT	M.E.			
8	113+74.28	27 . 50′ LT	M.E.			
9	113+69.14	22 . 41′ LT	672.22			
10	113+64.14	22.38′ LT	672.18			
11	113+69.19	15.41′ LT	675.06			
12	113+64.19	15.38′ LT	675.01			
13	113+69.19	13.85′ LT	675.04			
14	113+64.19	13.80′ LT	674.99			

CANADIAN PACIFIC RAILROAD						
POINT No.:	STATION	OFFSET	ELEV.			
15	113+57.52	25.75′ RT	M.E.			
16	113+57.65	30.70' RT	M.E.			
17	113+63.56	25.71′ RT	675.50			
18	113+63.59	30.66′ RT	675.59			
19	113+68.56	25.67′ RT	675.60			
20	113+68.59	30.62′ RT	675.69			
21	113+73.37	25.73′ RT	675.83			
22	113+73.40	30.46′ RT	675.86			
23	113+68.53	20.67′ RT	675.33			
24	113+63.53	20.71′ RT	675.23			
25	113+68.48	13.73′ RT	675.06			
26	113+63.48	13.77′ RT	675.96			
27	113+68.48	11 . 96′ RT	675.04			
28	113+63.48	12 . 10′ RT	675.94			


	BLA,	Inc.
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	DRAWN	-	DM	REVISED -
PLOT SCALE = 20.0000 '/ in.	CHECKED	-	MC	REVISED -
PLOT DATE = 10/1/2018	DATE	-	08/07/2018	REVISED -

STATE OF ILLINOIS
DEPARTMENT OF TRANSPORTATION

WEST AVENUE – CITY OF ELMHURST	F.A.U. RTE.	SECTION	COUNTY	TOTAL	SHEET NO.
ADA RAMP ELEVATION PLAN	2659	18-00194-00-RS	DUPAGE	30	18
ADA IIAWII EEEVATION I EAN			CONTRAC	T NO. 6	51F20
SCALE: 1"=10" SHEET 5 OF 8 SHEETS STA. N/A TO STA. N/A		ILLINOIS FED. A	ID PROJECT		



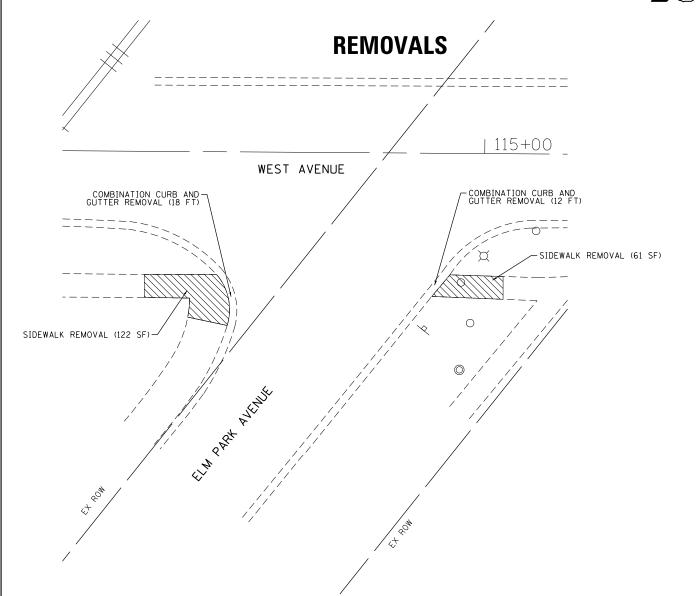


LEGEND

DETECTABLE WARNING

SIDEWALK REMOVAL



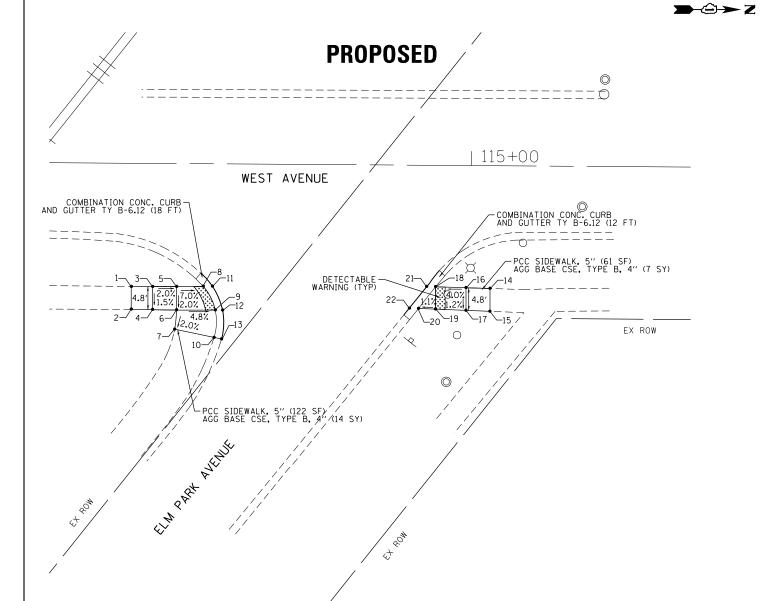

	ELM PARK	AVENUE	
POINT No.:	STATION	OFFSET	ELEV.
1	114+29.22	25.67' RT	674.65
2	114+29.26	30.46' RT	674.58
3	114+33.66	25.64′ RT	674.43
4	114+33.69	30.49' RT	674.36
5	114+38.66	25.61′ RT	673.33
6	114+38.69	30.53′ RT	674.23
7	114+38.34	34.51′ RT	674.17
8	114+44.25	25.57′ RT	673.94
9	114+46.77	30.47' RT	673.84
10	114+46.56	36.18' RT	674.13
11	114+46.19	25 . 57′ RT	673.92


ELM PARK AVENUE					
POINT No.:	STATION	OFFSET	ELEV.		
12	114+48.29	30.47′ RT	673.82		
13	114+48.10	36.56′ RT	673.63		
14	115+03.99	25.59′ RT	M.E.		
15	115+04.02	30.34′ RT	M.E.		
16	114+98.99	25.46′ RT	673.40		
17	114+99.02	30.17′ RT	673.34		
18	114+92.65	25.32′ RT	673.15		
19	114+92.68	29.96′ RT	673.09		
20	114+89.15	29.84′ RT	673.05		
21	114+90.76	25.32′ RT	673.13		
22	114+87.17	29.84′ RT	673.03		



- 1	USER NAME = cesario	DESIGNED	-	DM	REVISED -
		DRAWN	-	DM	REVISED -
	PLOT SCALE = 20.0000 '/ in.	CHECKED	-	MC	REVISED -
•	PLOT DATE = 10/1/2018	DATE	-	08/07/2018	REVISED -

STATE OF	ILLINOIS
DEPARTMENT OF	TRANSPORTATION

WEST AVENUE – CITY OF ELMHURST	F.A.U. RTE.	SECTION	COUNTY	TOTAL SHEETS	Ţ
ADA RAMP ELEVATION PLAN	2659	18-00194-00-RS	DUPAGE	30	Τ
			CONTRAC	T NO. (6
SCALE: 1"=10' SHEET 6 OF 8 SHEETS STA. N/A TO STA. N/A		ILLINOIS FED. A	ID PROJECT		Т

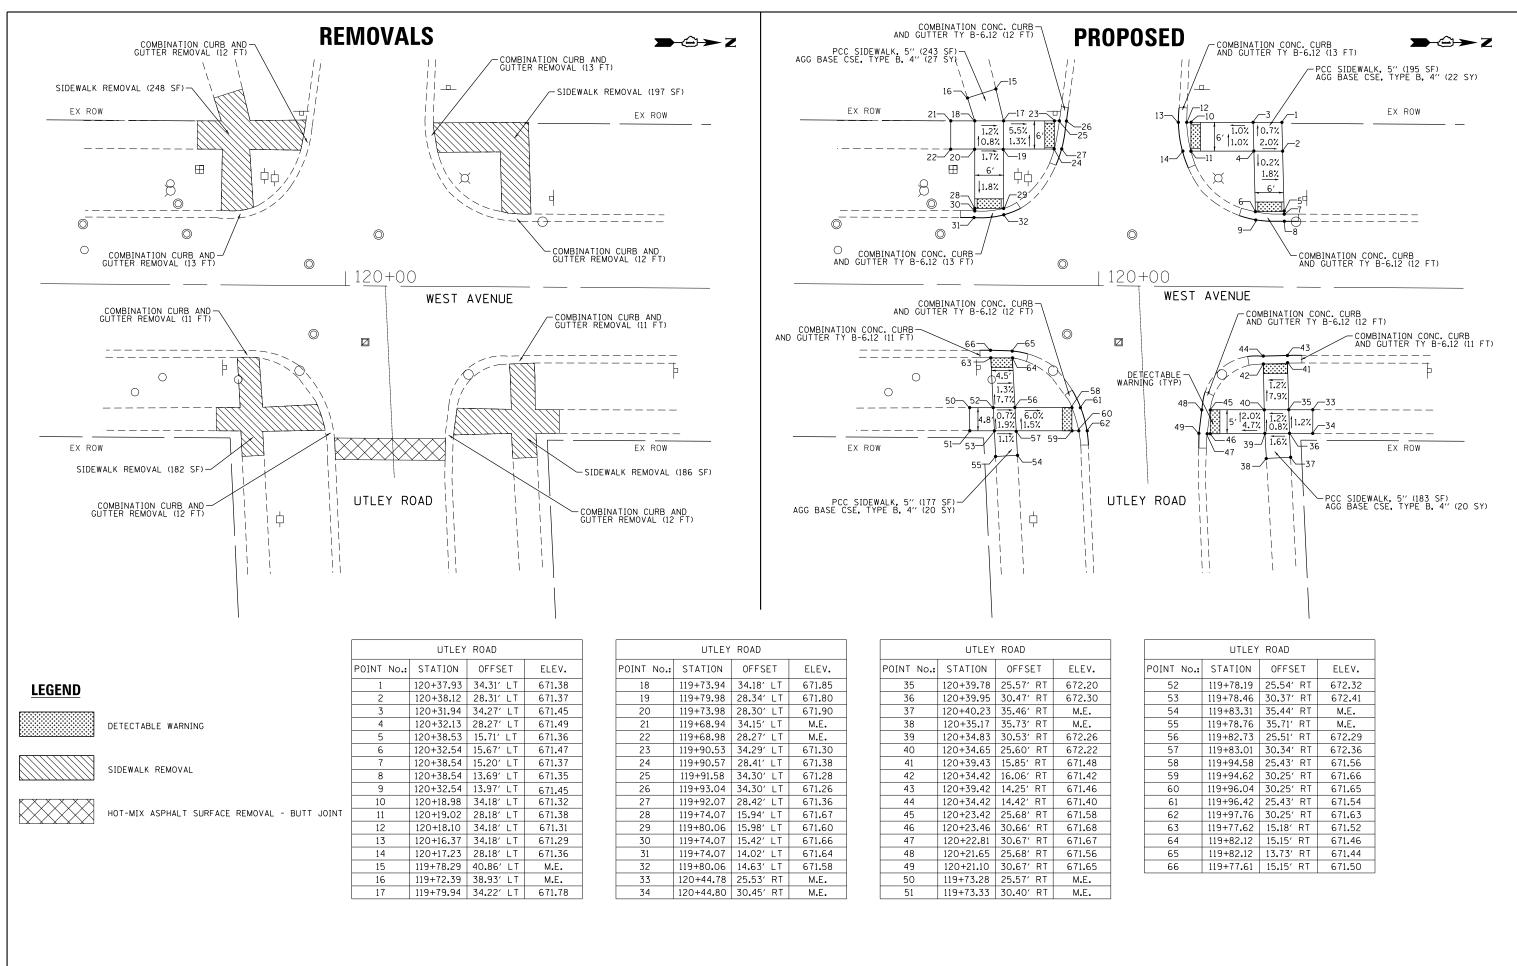

BLA,	Inc.


	USER NAME - Cesario	DESIGNED	_	UWI	KENISED -
		DRAWN	-	DM	REVISED -
4	PLOT SCALE = 20.0000 '/ in.	CHECKED	-	MC	REVISED -
-	PLOT DATE = 10/1/2018	DATE	-	08/07/2018	REVISED -

DESTONED

1	WEST AVENUE – CITY OF ELMHURST	F.A.U. RTE.	SECTION	COUNTY	TOTAL	SHEET NO.
ı	ADA RAMP ELEVATION PLAN	2659	18-00194-00-RS	DUPAGE	30	20
ı				CONTRAC	T NO.	61F20
	SCALE: 1''=10' SHEET 7 OF 8 SHEETS STA. N/A TO STA. N/A		ILLINOIS FED. A	D PROJECT		



REMOVALS

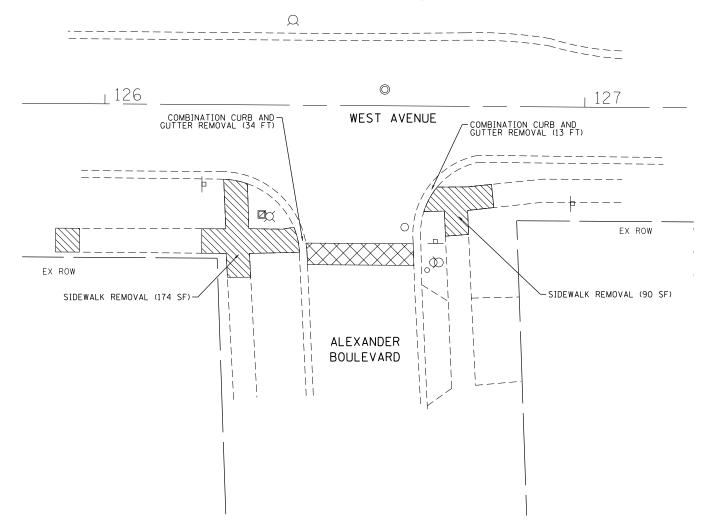

LEGEND



DETECTABLE WARNING




SIDEWALK REMOVAL



HOT-MIX ASPHALT SURFACE REMOVAL - BUTT JOINT

PROPOSED

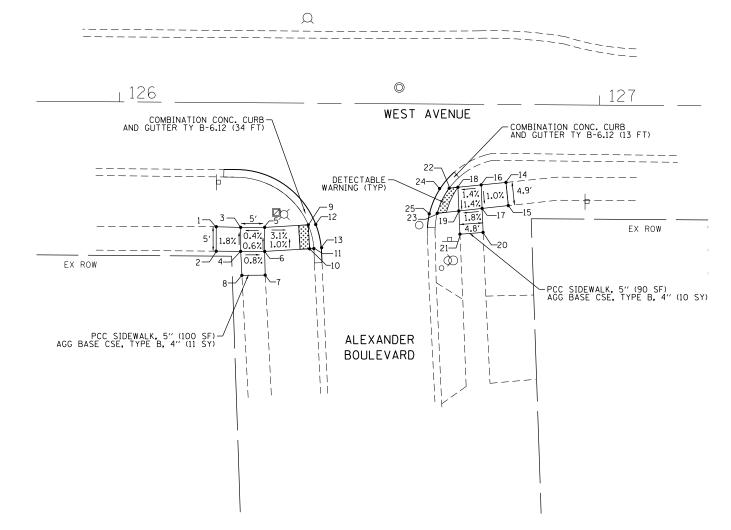


		ALEXANDER	BOULEVARD			
POINT	No.:	STATION	OFFSET	ELEV.		
1		126+20.36	25.88' RT	M.E.		
2		126+20.37	30.97' RT	M.E.		
3		126+25.44	25.89' RT	672.89		
4		126+25.48	30.98' RT	672.98		
5		126+30.44	25.95' RT	672.91		
6		126+30.48	30.95' RT	672.94		
7		126+30.62	35.90′ RT	M.E.		
8		126+25.77	35.97′ RT	M.E.		
9		126+39.52	25.36′ RT	673.19		
10		126+39.84	30.34' RT	673.24		
11		126+40.73	30.28' RT	673.23		
12		126+41.13	25.36′ RT	673.17		
13		126+42.28	30.28' RT	673.21		


ALEXANDER BOULEVARD							
POINT No.:	STATION	OFFSET	ELEV.				
14	126+80.65	16.23′ RT	M.E.				
15	126+81.18	21.03′ RT	M.E.				
16	126+75.50	16.79′ RT	673.77				
17	126+75.72	21 . 69′ RT	673.72				
18	126+70.65	17.32′ RT	673.70				
19	126+70.90	22.25′ RT	673.63				
20	126+75.96	26.69' RT	M.E.				
21	126+71.14	27.09' RT	M.E.				
22	126+68.84	17.51′ RT	673.67				
23	126+66.39	22.77′ RT	673.57				
24	126+66.89	17.73' RT	673.65				
25	126+64.73	23.00' RT	673.55				

	USER NAME = cesario	DESIGNED	-	DM	REVISED -
		DRAWN	-	DM	REVISED -
	PLOT SCALE = 20.0000 '/ in.	CHECKED	-	MC	REVISED -
•	PLOT DATE = 10/1/2018	DATE	-	08/07/2018	REVISED -

STATE OF ILLINOIS
DEPARTMENT OF TRANSPORTATION

	WEST AVENUE – CITY OF ELMHURST	F.A.U. RTE.	SECTION	COUNTY	TOTAL SHEETS	SHEET NO.
	ADA RAMP ELEVATION PLAN	2659	18-00194-00-RS	DUPAGE	30	21
				CONTRAC	T NO. (61F20
SCALE: 1"=10"	SHEET 8 OF 8 SHEETS STA. N/A TO STA. N/A		ILLINOIS FED. A	ID PROJECT		

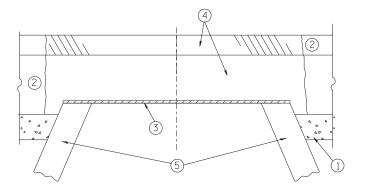

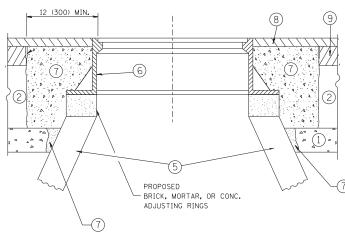

NOTES:

EXISTING BROKEN FRAMES AND LIDS SHALL BE REMOVED AND DISPOSED OF BY THE CONTRACTOR AND SHALL BE REPLACED AS DIRECTED BY THE ENGINEER. REPLACEMENT FRAMES AND LIDS WILL BE PAID FOR IN ACCORDANCE WITH ARTICLE 109.04 OF THE STANDARD SPECIFICATIONS UNLESS A SEPARATE PAY ITEM HAS BEEN PROVIDED.

IF THE EXISTING LIDS ARE OPEN, THE FRAME WILL BE ADJUSTED TO THE ELEVATION OF THE MILLED PAVEMENT SURFACE PRIOR TO THE MILLING OPERATION. THE FRAME WILL NOT BE REMOVED AND COVERED BY THE METAL PLATE.

CITY OF CHICAGO CASTINGS ARE THE PROPERTY OF THE CITY AND THE CONTRACTOR SHALL NOTIFY THE CITY FOR REMOVAL AND DISPOSITION OF THE CASTINGS.

THE METAL PLATE USED TO COVER THE STRUCTURE SHALL REMAIN THE PROPERTY OF THE CONTRACTOR.

WHEN STRUCTURES ARE TO BE ADJUSTED OR RECONSTRUCTED, THE LOWERING AND RAISING OF THE FRAMES AND LIDS WILL NOT BE PAID FOR SEPARATELY BUT WILL BE INCLUDED IN THE COST OF THE CORRESPONDING PAY ITEM.

SCALE: NONE

CONSTRUCTION PROCEDURES

STAGE 1 (BEFORE PAVEMENT MILLING)

- A) REMOVE A MINIMUM OF 12 (300) OF THE PAVEMENT FROM
- AROUND THE STRUCTURE.

 B) REMOVE THE EXISTING FRAME AND LID FROM THE STRUCTURE.
- C) COVER THE STRUCTURE OPENING WITH A 36 (900) DIAMETER METAL PLATE.

 D) BACKFILL WITH CRUSHED STONE AND A MINIMUM 1½ (40)
- THICK HMA SURFACE MIX APPROVED BY THE ENGINEER.

STAGE 2 (AFTER PAVEMENT MILLING)

- A) REMOVE THE HMA SURFACE MIX AND CRUSHED STONE.
- B) INSTALL THE FRAME AND LID; ADJUST THE FRAME TO ITS FINAL SURFACE ELEVATION.
- C) THE SURROUNDING SPACE SHALL BE FILLED WITH CLASS PP-1* CONCRETE TO THE ELEVATION OF THE SURFACE OF THE EXISTING BASE COURSE OR THE BINDER COURSE.
- *UNLESS OTHERWISE SPECIFIED IN THE PLANS.

THE PROCEDURE EXPLAINED ABOVE SHALL CONFORM TO THE APPLICABLE PORTIONS OF SECTIONS 353, 406, 602, AND 603 OF THE STANDARD SPECIFICATIONS EXCEPT THAT "THE CONTRACTOR SHALL ADJUST THE STRUCTURES TO THE FINISHED PAVEMENT ELEVATION NO MORE THAN 5 CALENDAR DAYS PRIOR TO PLACEMENT OF THE FINAL LIFT OF SURFACE UNLESS APPROVED BY THE

LEGEND

- 1 SUB-BASE GRANULAR MATERIAL
- (6) FRAME AND LID (SEE NOTES)
- 2 EXISTING PAVEMENT
- (7) CLASS PP-1* CONCRETE
- 3 36 (900) DIAMETER METAL PLATE
- PROPOSED CRUSHED STONE AND HMA SURFACE MIX
- (8) PROPOSED HMA SURFACE COURSE
- (5) EXISTING STRUCTURE
- (9) PROPOSED HMA BINDER COURSE

LOCATION OF STRUCTURES:

THE CONTRACTOR WILL BE REQUIRED TO KEEP A RECORD OF THE LOCATIONS OF THE BURIED STRUCTURES ACCORDING TO THE STATION AND DISTANCE LEFT OR RIGHT OF THE CENTERLINE OF PAVEMENT. UPON COMPLETION OF THE WORK. THE CONTRACTOR WILL DELIVER THE RECORD TO THE ENGINEER.

BASIS OF PAYMENT:

REMOVING FRAMES AND LIDS ON DRAINAGE AND UTILITY STRUCTURES IN THE PAVEMENT PRIOR TO MILLING, AND ADJUSTING TO FINAL GRADE PRIOR TO PLACING THE SURFACE COURSE, WILL BE PAID FOR AT THE CONTRACT UNIT PRICE EACH FOR "FRAMES AND LIDS TO BE ADJUSTED

THIS WORK WILL NOT BE PAID FOR WHEN DRAINAGE AND UTILITY STRUCTURES ARE SPECIFIED FOR PAYMENT AS STRUCTURE RECONSTRUCTION.

NEW FRAMES AND LIDS, WHEN SPECIFIED, WILL BE PAID FOR SEPARATELY.

DETAILS FOR FRAMES AND LIDS ADJUSTMENT WITH MILLING

ALL DIMENSIONS ARE IN INCHES (MILLIMETERS) UNLESS OTHERWISE SHOWN


DESIGNED - R. SHAH FILE NAME = USER NAME = bauerdl REVISED - R. WIEDEMAN 05-14-04 c:\pw_work\pwidot\bauerdl\d0108315\bd08 DRAWN REVISED - R. BORO 01-01-07 CHECKED REVISED - R. BORO 12-06-11 PLOT DATE = 12/6/2011 DATE REVISED

STATE OF ILLINOIS **DEPARTMENT OF TRANSPORTATION**

DETAILS FOR FRAMES AND LIDS ADJUSTMENT WITH MILLING SHEET NO. 1 OF 1 SHEETS STA.

COUNTY COUNTY SHEETS NO.

DUPAGE 30 22 18-00194-00-RS BD600-03 (BD-8) CONTRACT NO. 61F20

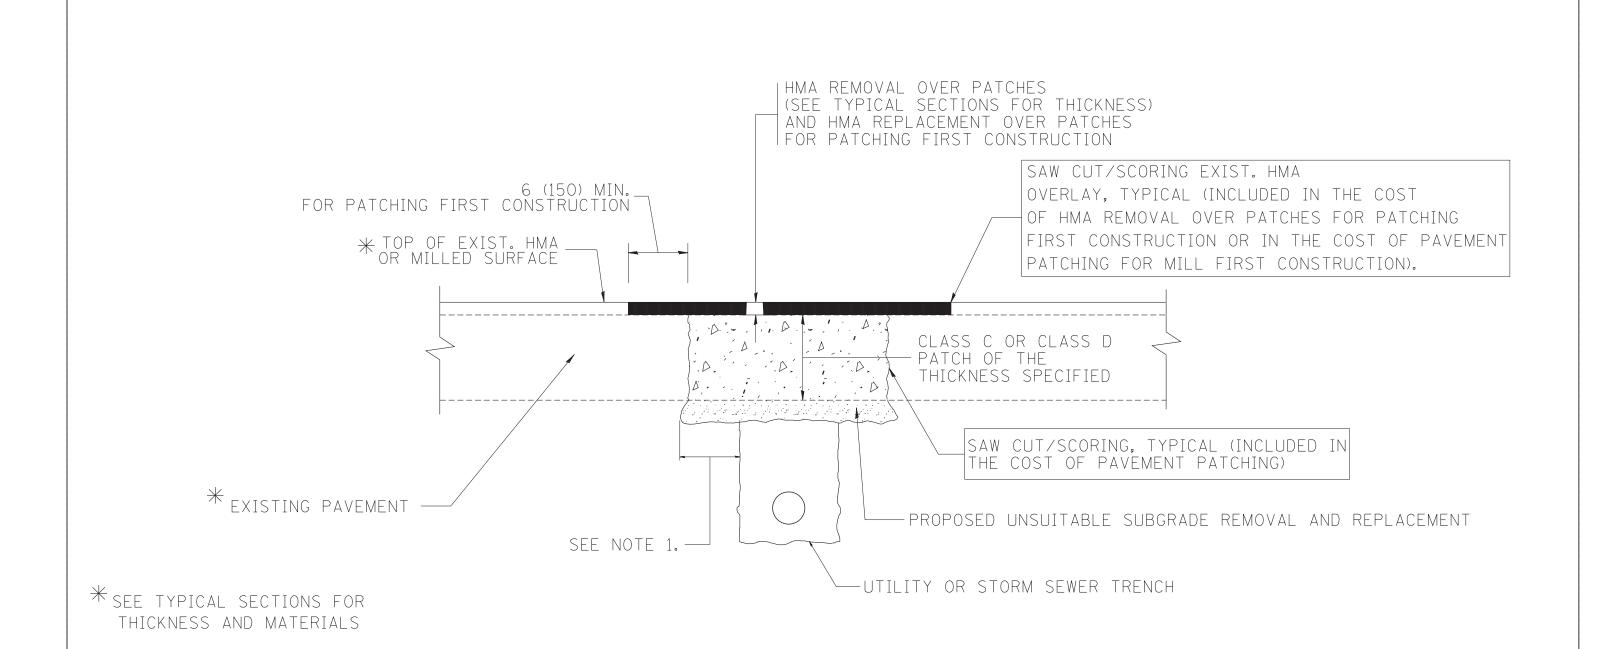

NOTES:

- 1. THE WIDTH OF THE FULL DEPTH PATCH OVER A TRENCH SHALL BE 12 (300) WIDER ON EACH SIDE OF THE TRENCH.
- 2. FOR METHOD OF MEASUREMENT AND BASIS OF PAYMENT, SEE RECURRING SPECIAL PROVISION "PATCHING WITH HOT-MIX ASPHALT OVERLAY REMOVAL".

SEQUENCE OF CONSTRUCTION (PATCHING FIRST)


- 1. REMOVE THE EXISTING HMA MATERIAL OVER THE AREA TO BE PATCHED.
- 2. REMOVE AND REPLACE WITH CLASS C OR D PATCH.
- 3. REPLACE HMA MATERIAL OVER THE AREA TO BE PATCHED.

SEQUENCE OF CONSTRUCTION (MILLING FIRST)


- 1. MILL HMA FIRST IF THERE IS AT LEAST 41/2 INCHES OR MORE OF HMA MATERIAL ON TOP OF THE EXISTING PAVEMENT OR IF THE PAVEMENT IS FULL DEPTH HMA. A MINIMUM OF 2 INCHES OF HMA MATERIAL SHALL BE IN PLACE AFTER MILLING.
- 2. REMOVE AND REPLACE WITH FULL DEPTH CLASS D PATCHES TO TOP OF MILLED SURFACE.

ALL DIMENSIONS ARE IN INCHES (MILLIMETERS) UNLESS OTHERWISE SHOWN.


FILE NA	AME =	USER NAME = bauerd1	DESIGNED - R. SHAH	REVISED -	A. ABBAS 04-27-98			PAVEMENT PATCHING FOR		RTF.	SECTION	COUNTY SHEETS NO.
c:\proje	ects\diststd22x34\bd22.dgn		DRAWN -	REVISED -	R. BORO 01-01-07	STATE OF ILLINOIS				2650	19 00104 00 PS	DUBAGE 20 22
		PLOT SCALE = 50.000 '/ IN.	CHECKED -	REVISED -	R. BORO 09-04-07	DEPARTMENT OF TRANSPORTATION		HMA SURFACED PAVEMENT		2039	BD400-04 (BD-22)	CONTRACT NO. 61F20
		PLOT DATE = 10/27/2008	DATE - 10-25-94	REVISED -	K. ENG 10-27-08		SCALE: NONE	SHEET NO. 1 OF 1 SHEETS STA.	TO STA.	FED. RO	AD DIST. NO. 1 ILLINOIS FED.	AID PROJECT

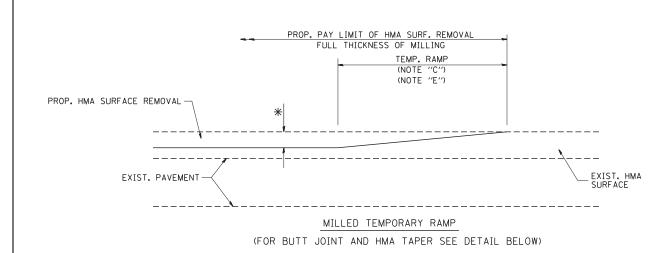

OPTION 1

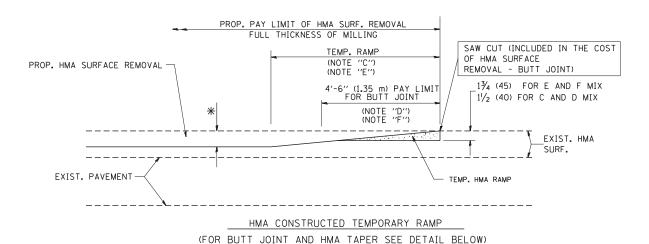


OPTION 2 TYPICAL TEMPORARY RAMP

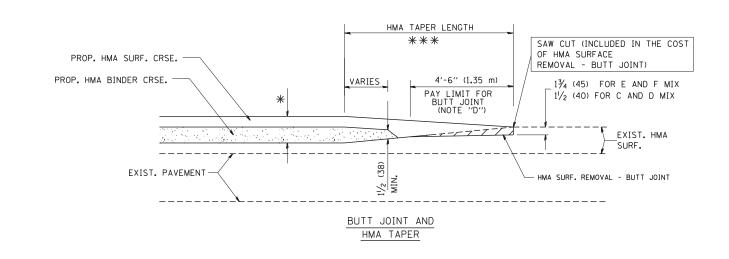


TYPICAL BUTT JOINT AND HMA TAPER FOR MILLING AND RESURFACING

FILE NAME = USER NAME = gaglianobt DESIGNED - M. DE YONG REVISED - R. SHAH 10-25-94 W:\diststd\22x34\bd32.dqr DRAWN REVISED A. ABBAS 03-21-97 CHECKED REVISED M. GOMEZ 04-06-01 DATE R. BORO 01-01-07 PLOT DATE = 1/4/2008 06-13-90 REVISED

STATE OF ILLINOIS
DEPARTMENT OF TRANSPORTATION

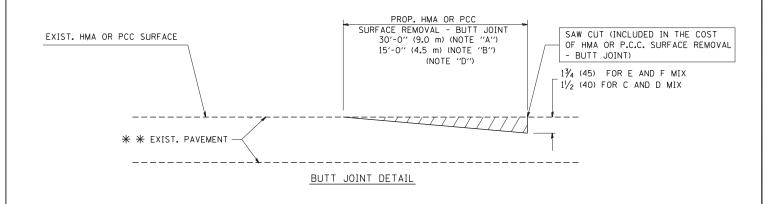

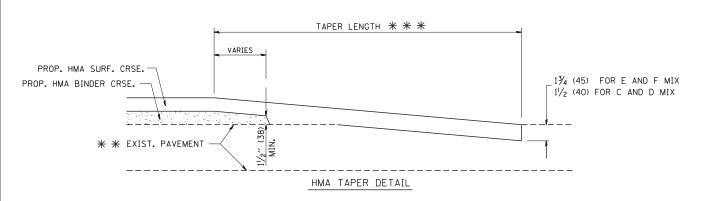

TYPICAL BUTT JOINT AND HMA TAPER FOR RESURFACING ONLY

* * PC CONCRETE, HMA OR HMA RESURFACED PAVEMENT.

NOTES


- A: MAINLINE ROADWAYS AND MAJOR SIDE ROADS.
- B: MINOR SIDE ROADS.
- C: THE TEMP. RAMP SHALL BE CONSTRUCTED IMMEDIATELY UPON REMOVAL OF THE EXISTING HMA SURFACE.
- D: THE BUTT JOINT SHALL BE CONSTRUCTED IMMEDIATELY PRIOR TO PLACING THE PROPOSED HMA COURSES.
- E: TAPER THE TEMP. RAMP AT A RATE OF 3'-0" (900 mm) PER 1 INCH (25 mm) OF MILLING THICKNESS.
- F: INSTALLATION AND REMOVAL OF THE 4'-6" (1.35 m) TEMP. RAMP IS INCLUDED IN COST OF HMA SURFACE REMOVAL BUTT JOINT
- G: SEE ARTICLE 406.08 AND 406.14 OF THE STANDARD SPECIFICATIONS FOR "HMA AND/OR PCC SURFACE REMOVAL, BUTT JOINT".
- * SEE TYPICAL SECTIONS FOR MILLING THICKNESS.
- ** * 20'-0" (6.1 m) PER 1 (25) RESURFACING (NOTE "A") 10'-0" (3.0 m) PER 1 (25) RESURFACING (NOTE "B")

BASIS OF PAYMENT:

THE BUTT JOINT WILL BE PAID FOR AT THE CONTRACT UNIT PRICE PER SQUARE YARD (SQUARE METER) FOR "HOT-MIX ASPHALT SURFACE REMOVAL - BUTT JOINT" OR FOR "PORTLAND CEMENT CONCRETE SURFACE REMOVAL- BUTT JOINT".

SCALE: NONE

ALL DIMENSIONS ARE IN INCHES (MILLIMETERS) UNLESS OTHERWISE SHOWN.

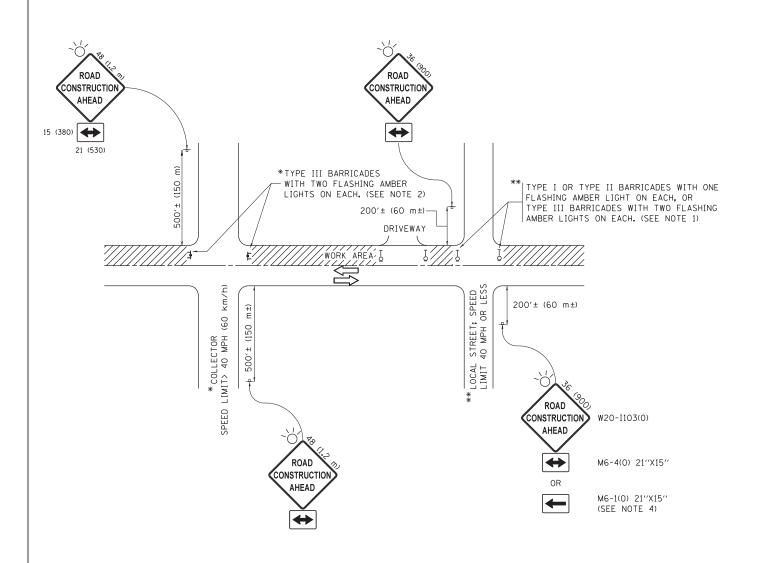

NOTES:

- SIDE ROAD WITH A SPEED LIMIT OF 40 MPH (60 km/h) OR LESS AS SHOWN ON THE DRAWING AND AS DIRECTED BY THE ENGINEER:
 - a) ONE "ROAD CONSTRUCTION AHEAD" SIGN 36 x 36 (900x900) WITH A FLASHER MOUNTED ON IT APPROXIMATELY 200" (60 m) IN ADVANCE OF THE MAIN ROUTE.
 - b) THE CLOSED PORTION OF THE MAIN ROUTE SHALL BE PROTECTED BY BLOCKING WITH TYPE I, TYPE II OR TYPE III BARRICADES, 1/3 OF THE CROSS SECTION OF THE CLOSED PORTION.
- 2. SIDE ROAD WITH A SPEED LIMIT GREATER THAN 40 MPH (60 km/h) AS SHOWN ON THE DRAWING AND AS DIRECTED BY THE ENGINEER:
 - a) ONE "ROAD CONSTRUCTION AHEAD" SIGN 48 x 48 (1.2 m x 1.2 m) WITH A FLASHER MOUNTED ON IT APPROXIMATELY 500" (150 m) IN ADVANCE OF THE MAIN ROUTE.
 - b) THE CLOSED PORTION OF THE MAIN ROUTE SHALL BE PROTECTED BY BLOCKING WITH TYPE III BARRICADES, 1/2 OF THE CROSS SECTION OF THE CLOSED PORTION.
- 3. CONES MAY BE SUBSTITUTED FOR BARRICADES OR DRUMS AT HALF THE SPACING DURING DAY OPERATIONS. CONES SHALL BE A MINIMUM OF 28 (710)
- 4. WHEN THE SIDE ROAD LIES BETWEEN THE BEGINNING OF THE MAINLINE SIGNING AND THE WORK ZONE, A SINGLE HEADED ARROW (M6-1) SHALL BE USED IN LIEU OF THE DOUBLE HEADED ARROW (M6-4).

SCALE: NONE


- 5. WHEN WORK IS BEING PERFORMED ON A SIDE ROAD OR DRIVEWAY, FOLLOW THE APPLICABLE STANDARD(S). THE DIRECTIONAL ARROW (M6-1 OR M6-4) SHALL BE COVERED OR REMOVED WHEN NO LONGER CONSISTENT WITH THE TRAFFIC CONTROL SET-UP.
- 6. ADVANCE WARNING SIGNS ARE TO BE OMITTED ON DRIVEWAYS UNLESS OTHERWISE SPECIFIED IN THE PLANS OR BY THE ENGINEER
- 7. THE TRAFFIC CONTROL AND PROTECTION FOR SIDE ROADS, INTERSECTIONS, AND DRIVEWAYS SHALL BE INCLUDED IN THE COST OF SPECIFIED TRAFFIC CONTROL STANDARDS OR ITEMS.


All dimensions are in inches (millimeters) unless otherwise shown.

FILE NAME =	USER NAME = footemj	DESIGNED - L.H.A.	REVISED	- A. HOUSEH 10-15-96
pw:\\IL084EBIDINTEG.:1ll:no:s.gov:PWIDOT\Do	cuments\IDOT Offices\District 1\Projects\Dist	CADSheets\tc10.dgn	REVISED	-T. RAMMACHER 01-06-00
	PLOT SCALE = 50.000 '/ in.	CHECKED -	REVISED	- A. SCHUETZE 07-01-13
Default	PLOT DATE = 9/15/2016	DATE - 06-89	REVISED	- A. SCHUETZE 09-15-16

STATI	E OF	: ILLINOIS
DEPARTMENT	0F	TRANSPORTATION

	TRAFFIC C	ONTR	OL AND I	ROTEC	TION FOR	F.A.U RTE.	SECTION	COUNTY	TOTAL SHEETS	SHEE NO.
CI	DE BUYDS	INTER	RECTIONS	C AND	DRIVEWAVS	2659	18-00194-00-RS	DUPAGE	30	25
31	SIDE ROADS, INTERSECTIONS, AND DRIVEWAYS						TC-10	CONTRACT NO. 61F20		
SHEET 1 OF 1 SHEETS STA. TO STA.							ILLINOIS FED. A	ID PROJECT		

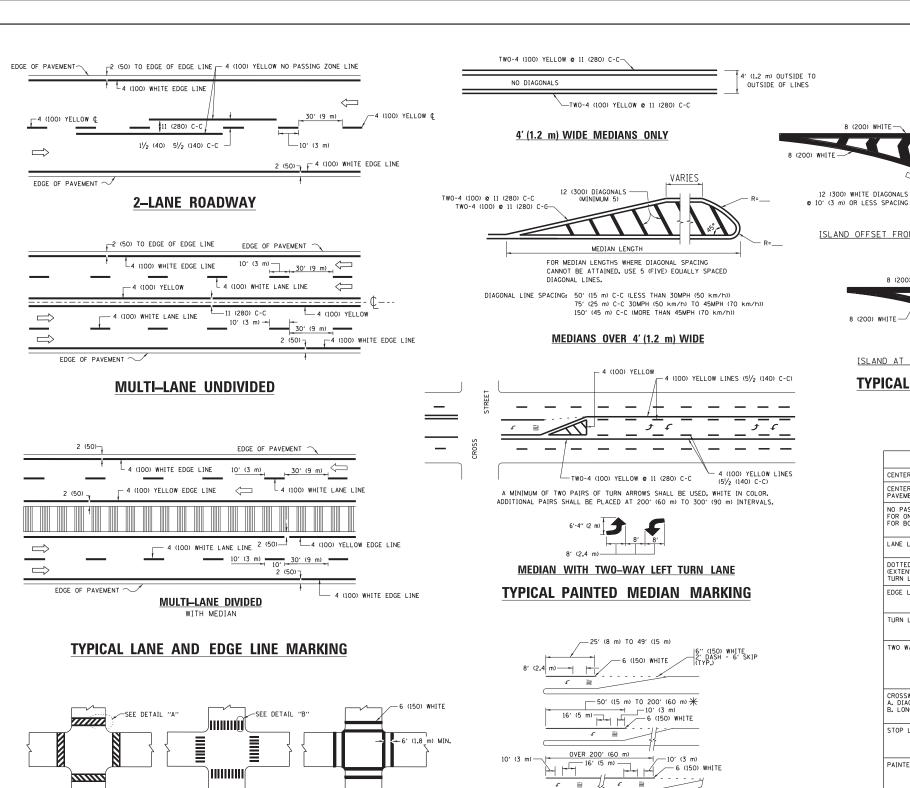

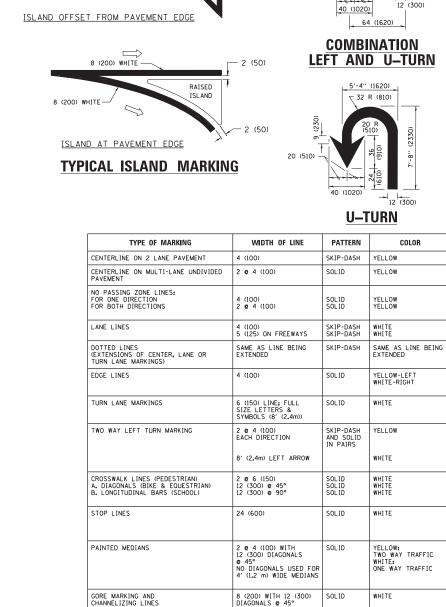

FOR FURTHER DETAILS ON PAVEMENT MARKING REFER TO STANDARD SPECIFICATIONS FOR ROAD AND BRIDGE CONSTRUCTION AND STATE STANDARD 780001.

RAILROAD CROSSING

SHOULDERS > 8')

2 ARROW COMBINATION LEFT AND U TURN

J TURN ARROW

SCALE: NONE

SHOULDER DIAGONALS (REQUIRED FOR

24 (600) TRANSVERSE LINES; "RR" IS 6' (1.8 LETTERS; 16 (400) LINE FOR "X"

12 (300) @ 45°

SEE DETAIL

SEE DETAIL

SOLID

SOLID

SOLID

SOLID

WHITE

WHITE

WHITE

WHITE - RIGHT YELLOW - LEFT

DIAGONALS: 15' (4.5' m) C-C (LESS THAN 30MPH (50 km/h)) 20' (6' m) C-C 30MPH (50 km/h) TO 45MPH (70 km/h)) 30' (9' m) C-C (OVER 45MPH (70 km/h))

50' (15 m) C-C (LESS THAN 30MPH (50 km/h)) 75' (25 m) C-C (30 MPH (50 km/h) T0 45MPH (70 km/h)) 150' (45 m) C-C (0VER 45MPH (70 km/h))

EVERS FILE NAME : USER NAME = leysa DESIGNED -REVISED -C. JUCIUS 09-09-09 W:\diststd\22x34\tc13.dar DRAWN REVISED C. JUCIUS 07-01-13 CHECKED REVISED C. JUCIUS 12-21-15 DATE PLOT DATE = 6/23/2017 03-19-90 REVISED C. JUCIUS 04-12-16

TYPICAL CROSSWALK MARKING

* MARKINGS SHALL BE INSTALLED PARALLEL TO THE CENTERLINE OF

6 (150) WHITE

DETAIL "A"

2' (600)

DETAIL "B"

-12 (300) WHITE

PEDESTRIAN

BICYCLE & EQUESTRIAN

STATE OF ILLINOIS **DEPARTMENT OF TRANSPORTATION**

FULL SIZE LETTERS 8' (2.4 m) AND ARROWS SHALL BE USED.

ARROW - "ONLY".

 \uparrow AREA = 15.6 SO. FT. (1.5 m²) **ONLY** AREA = 20.8 SO. FT. (1.9 m²) * TURN LANES IN EXCESS OF 400' (120 m) IN LENGTH MAY HAVE AN ADDITIONAL SET OF ARROW - "ONLY" INSTALLED MIDWAY BETWEEN THE OTHER TWO SETS OF

TYPICAL LEFT (OR RIGHT) TURN LANE

TYPICAL TURN LANE MARKING

		D	ISTRICT	ONE		F.A.U RTE.	SECTION	COUNTY	TOTAL SHEETS	SHEE NO.
TYPICAL PAVEMENT MARKINGS						2659	18-00194-00-RS	DUPAGE	30	26
	TIFICAL FAVLIVILIVI IVIANKIIVOS						TC-13	CONTRACT	NO. 61	F20
	SHEET 1	OF 1	SHEE.	IS STA.	TO STA.		ILLINOIS FED. A	D PROJECT		

6'-4" (1930)

COLOR

D(FT)

425

500

580

665

750

-20′

LANE REDUCTION TRANSITION

* LANE REDUCTION ARROWS REQUIRED AT SPEEDS OF 45 MPH OR GREATER OR WHEN SPECIFIED IN PLANS.

SPACING / REMARKS

10' (3 m) LINE WITH 30' (9 m) SPACE

5/2 (140) C-C FROM SKIP-DASH CENTERLINE

10' (3 m) LINE WITH 30' (9 m) SPACE

2' (600) LINE WITH 6' (1.8 m) SPACE

SEE TYPICAL TURN LANE MARKING DETAIL

10' (3 m) LINE WITH 30' (9 m) SPACE FOR SKIP-DASH; 5/2 (140) C-C BETWEEN SOLID LINE AND SKIP-DASH LINE SEE TYPICAL TWO-WAY LEFT TURN MARKING DETAIL

SEE TYPICAL CROSSWALK MARKING DETAILS. PLACE 4' (1.2 m) IN ADVANCE OF AND PARALLEL TO CROSSMALK, IF PRESENT.
OTHERWISE, PLACE AT DESIRED STOPPING POINT. PARALLEL TO CROSSROAD CENTERLINE, WHERE POSSIBLE

11 (280) C-C FOR THE DOUBLE LINE SEE TYPICAL PAINTED MEDIAN MARKING.

SEE STATE STANDARD 780001 AREA OF: "R"=3.6 SO. FT. (0.33 m²) EACH "X"=54.0 SO. FT. (5.0 m²)

16.3 SF

30.4 SF

NOT LESS THAN 6' (1.8 m) APART 2' (600) APART 2' (600) APART

OUTLINE MEDIANS IN YELLOW


1 (280) C-C

SPEED LIMIT

45


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55

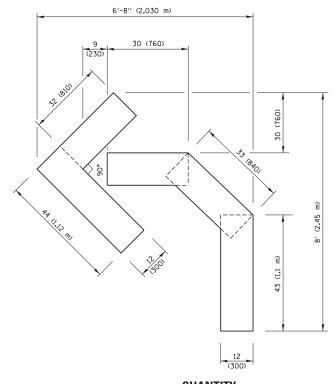


QUANTITY

4 (100) LINE = 45.5 ft. (13.9 m) 15.2 sq. ft. (1.41 sq. m)

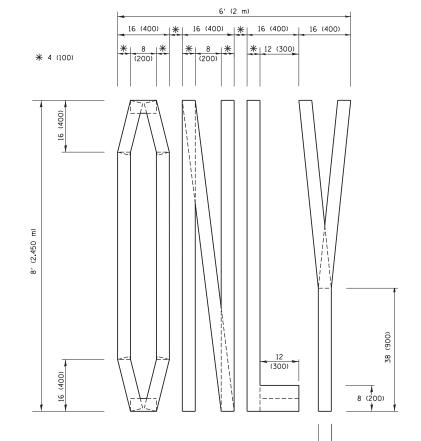

4 (100) LINE = 64.1 ft. (19.5 m) 21.4 sq. ft. (1.99 sq. m)

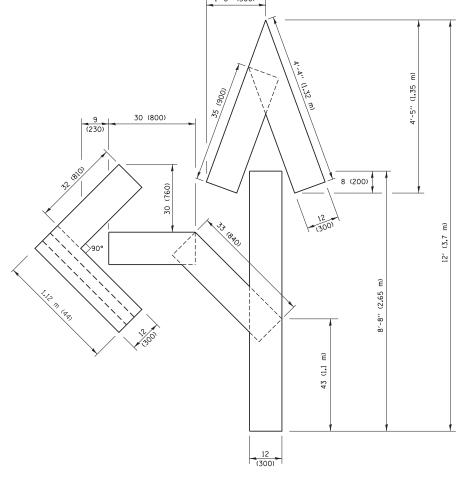


QUANTITY

4 (100) LINE = 82.5 ft. (25.1 m) 27.5 sq. ft. (2.53 sq. m)

NOTE:

ALL QUANTITIES OF PLACEMENT ARE REPRESENTED IN LINEAR FEET OF 4" LINES TO MATCH THE 4" TEMPORARY TAPE PAY ITEM AND REPRESENTS THE TOTAL QUANTITY OF 4" TAPE REQUIRED.

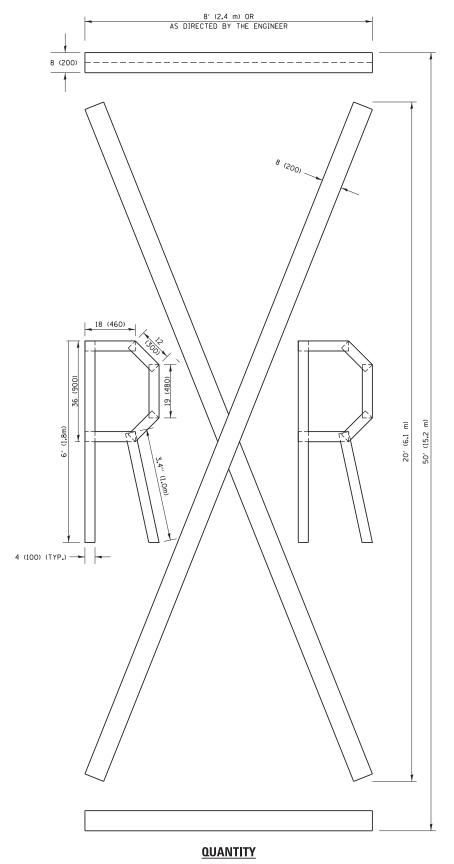

4 (100) LINE = 225.9 ft. (68.9 m) 75.3 sq. ft. (6.99 sq. m)

All dimensions are in inches (millimeters) unless otherwise shown.


FILE NAME =	USER NAME = footemj	DESIGNED -	REVISED	-T. RAMMACHER 03-02-9
pw:\\IL084EBIDINTEG.:ll1:no1s.gov:PWIDOT\Do	cuments\IDOT Offices\District 1\Projects\Dist	:@R‰w N\CADData\CADsheets\tc16.dgn	REVISED	-E. GOMEZ 08-28-00
	PLOT SCALE = 50.0000 '/ in.	CHECKED -	REVISED	-E. GOMEZ 08-28-00
	PLOT DATE = 9/15/2016	DATE - 09-18-94	REVISED	- A. SCHUETZE 09-15-16

QUANTITY

STATE OF ILLINOIS
DEPARTMENT OF TRANSPORTATION

					F.A.U. RTE.	SECTION	COUNTY	TOTAL SHEETS	SHEET NO.
SHORT	TERM PAVEMENT	AVEMENT MARKING LETTERS	LETTERS AND	SYMBOLS	2659	18-00194-00-RS	DUPAGE	31	27
						TC-16	CONTRACT	NO. 61	1F20
SCALE: NONE	SHEET NO. 1 OF 1	SHEETS	STA.	TO STA.	FFD. RO	AD DIST. NO. 1 ILLINOIS FED. AL	D PROJECT		

-14 d-- 0/15/2014 12-15/20 PM

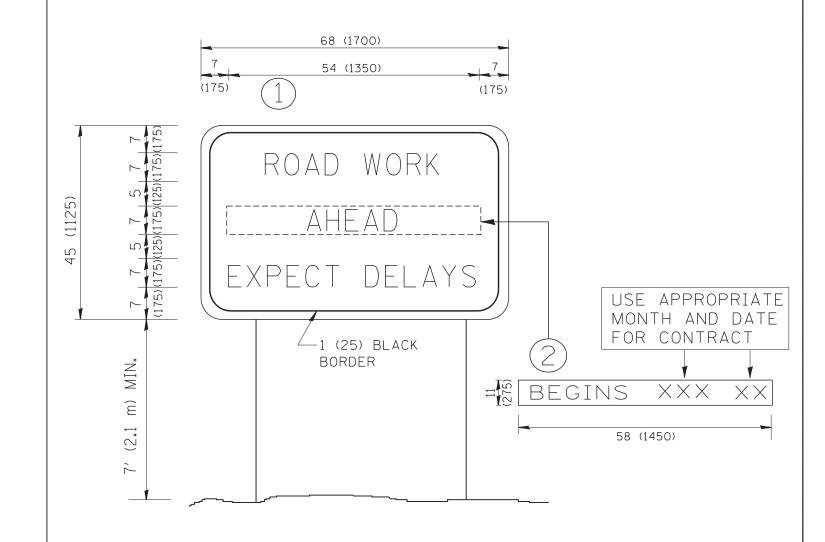

NOTES:

- 1. USE BLACK LETTERING ON ORANGE BACKGROUND.
- 2. ERECT SIGNS IN ADVANCE OF THE LOCATION FOR THE "ROAD CONSTRUCTION AHEAD" SIGN AT LOCATIONS AS DIRECTED BY THE ENGINEER.
- 3. ERECT SIGN (1) WITH INSTALLED PANEL (2) ONE WEEK PRIOR TO THE START OF CONSTRUCTION.
- 4. REMOVE PANEL (2) SOON AFTER THE START OF CONSTRUCTION.
- 5. SEE SPECIAL PROVISION FOR "TEMPORARY INFORMATION SIGNING" FOR ADDITIONAL INFORMATION.
- 6. ONE SIGN ASSEMBLY EQUALS 25.70 SQ. FT. (2.3 SQ. M.)
- 7. SHALL BE PAID FOR AS TEMPORARY INFORMATION SIGNING.


ALL DIMENSIONS ARE IN INCHES (MILLIMETERS) UNLESS OTHERWISE SHOWN.

FILE NAME =	USER NAME = gaglianobt	DESIGNED -	REVISED - R. MIRS 09-15-97			ARTERIAL ROAD		F.A.U. RTF.	SECTION	COUNTY TOTAL SHEETS	SHEET NO.
W:\diststd\22x34\tc22.dgn		DRAWN -	REVISED - R. MIRS 12-11-97	STATE OF ILLINOIS		INFORMATION SIGN		2659	18-00194-00-RS	DUPAGE 30	28
	PLOT SCALE = 50.000 '/ IN.	CHECKED -	REVISED -T. RAMMACHER 02-02-99	DEPARTMENT OF TRANSPORTATION	INFORMATION SIGN				TC-22	CONTRACT NO. 611	20
	PLOT DATE = 1/4/2008	DATE -	REVISED - C. JUCIUS 01-31-07		SCALE: NONE	SHEET NO. 1 OF 1 SHEETS STA.	TO STA.	FED. RO	AD DIST. NO. 1 ILLINOIS	FED. AID PROJECT	


LOOP DETECTOR NOTES

- 1. EACH PAIR OF LOOP WIRES SHALL BE PLACED IN A SEPARATE EMPTY COILABLE NONMETALLIC CONDUIT FROM THE EDGE OF PAVEMENT TO THE HANDHOLE. SPACING BETWEEN THE HOLES DRILLED IN THE PAVEMENT SHALL NOT BE LESS THAN 6" (150 mm). EMPTY COILABLE NONMETALLIC CONDUIT SHALL BE INCLUDED IN THE COST OF THE LOOP WIRE.
- 2. THE NUMBER OF LOOP TURNS SHALL BE AS RECOMMENDED BY THE AMPLIFIER MANUFACTURER. ALL ADJACENT SIDES OF THE LOOPS SHALL BE INSTALLED IN SUCH A WAY THAT THE CURRENT FLOW IS IN THE SAME DIRECTION TO REINFORCE ITS MAGNETIC FIELDS FOR SMALL VEHICLE DETECTION.
- 3. EACH LOOP LEAD-IN SHALL BE IDENTIFIED AND PERMANENTLY TAGGED IN THE HANDHOLE. EACH LEAD-IN CABLE TAG SHALL INDICATE THE LOCATION OF THE LOOP, LOOP ROTATION (CLOCKWISE/COUNTERCLOCKWISE), LOOP LEAD-IN DIRECTION (IN OR OUT), LOOP CABLE NUMBER AND LOCATION IN CABINET, AND NUMBER OF TURNS IN THE DETECTOR LOOPS IN WATER PROOF INK AS INDICATED ON THE DISTRICT 1 STANDARD TRAFFIC SIGNAL DESIGN DETAIL. THE CONTRACTOR SHALL MARK LOOP LOCATIONS ON RECORD DRAWINGS AND PRESENT TO THE ENGINEER AFTER FINAL INSPECTION. LOOPS SHALL BE MARKED BY LANE AND LOOP NUMBER. SEE DETAIL BELOW.
- 4. ALL LOOP CABLE SHALL BE FASTENED WITH PLASTIC TIE WRAP TO THE HANDHOLE HOOKS.
- 5. IN ASPHALT PAVEMENT, LOOPS SHOULD BE PLACED IN THE BINDER AND DIVEHOLES MARKED AT THE CURB WITH A SAW-CUT. THE SAW-CUT SHALL BE CUT IN ACCORDANCE WITH LOCAL AND E.P.A. DUST CONTROL REQUIREMENTS. DETECTOR LOOP(S) SHALL NOT BE INSTALLED IN WET CONDITIONS AND THE SAW-CUTS MUST BE FREE OF DEBRIS AND RESIDUE SUCH AS DUST AND WATER WHICH IS TO BE ACHIEVED BY THE USE OF COMPRESSED AIR, WIRE BRUSHING AND HEAT DRYING ACCORDING TO SEALANT MANUFACTURER REQUIREMENTS. THE DETECTOR WIRE SHALL BE HELD IN PLACE BY THE USE OF FORM WEDGES. WEDGES SHALL BE SPACED NO MORE THAN 18" (450 mm) APART.
- 6. LOOP SPLICES SHALL BE SOLDERED USING A SOLDERING IRON. BLOW TORCHES OR OTHER DEVICES WHICH OXIDIZE COPPER CABLE SHALL NOT BE ALLOWED FOR SOLDERING OPERATIONS. SEE DETAIL BELOW RIGHT.
- 7. PREFORMED DETECTOR LOOPS SHALL BE USED, AS SHOWN ON THE PLANS, WHERE NEW CONCRETE PAVEMENT IS PROPOSED. THE INSTALLATION OF PREFORMED LOOPS SHALL BE IN ACCORDANCE WITH THE DISTRICT 1 SPECIFICATIONS OR AS DIRECTED BY THE ENGINEER.

LOOP LEAD-IN CABLE TAG

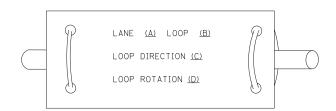



- A. LANE 1 IS THE LANE CLOSEST TO THE CENTERLINE OF THE ROADWAY
- B. LOOP \$1 IS THE LOOP IN THE LANE CLOSEST TO THE INTERSECTION.
- C. LABEL LOOP CABLE "IN" OR LOOP CABLE "OUT".
- D. LABEL LOOP CABLE CLOCKWISE OR LOOP CABLE COUNTERCLOCKWISE.

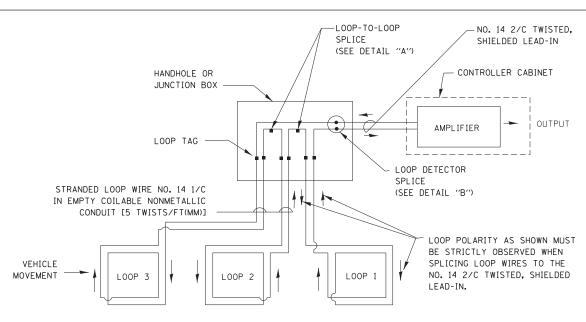

DETECTOR LOOP WIRING SCHEMATIC

- LOOPS SHALL BE SPLICED IN SERIES.
- SAW-CUTS SHALL BE A MINIMUM WIDTH OF 5/16" (8 mm).
- SAW-CUT DEPTHS SHALL BE 3" (75 mm). IF IN CONCRETE,
 THE SAW-CUT DEPTH SHALL BE TO THE TOP OF THE REINFORCEMENT.
- LOOP CORNERS SHALL BE DRILLED WITH A 2" (50 mm) DIAMETER CORE.

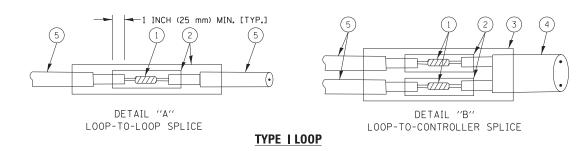

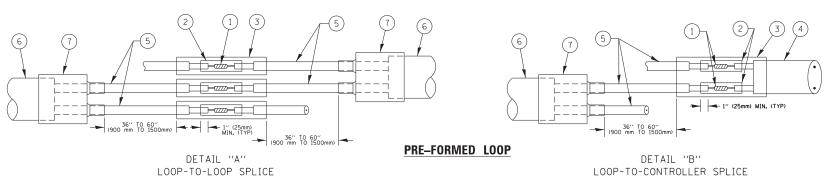

LOOP DETECTOR SPLICE

- 1 WESTERN UNION SPLICE SOLDERED WITH ROSIN CORE FLUX. ALL EXPOSED SURFACES OF THE SOLDER SHALL BE SMOOTH. THE WESTERN UNION SPLICES SHALL BE STAGGERED.
- (2) WCSMW 30/100 HEAT SHRINK TUBE, MINIMUM LENGTH 3" (75 mm), UNDERWATER GRADE.
- (3) WCS 200/750 HEAT SHRINK TUBE, MINIMUM LENGHT 6" (150 mm), UNDERWATER GRADE.

SCALE: NONE

(4) NO. 14 2/C TWISTED, SHIELDED CABLE.

- (5) LOOP CONDUCTOR WITH FLEXIBLE PLASTIC TUBE.
- 6 PRE-FORMED LOOP
- 7 XL POLYOLEFIN 2 CONDUCTOR BREAKOUT SEALS. TYCO CBR-2 OR APPROVED EQUAL

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		PLOT SCALE = 50.0000 '/ in.	CHECKED	-	DAD	REVISED	-	
		PLOT DATE = 1/13/2014	DATE	-	10-28-09	REVISED	-	

STATE OF ILLINOIS
DEPARTMENT OF TRANSPORTATION

	DIS	TRICT ON	IE		F.A.U. RTE.	SECTION	COUNTY	TOTAL SHEETS	SHEET NO.	
STANDARD 1	TDAEEI	C CIGNIAI	DEGICN	DETAILS	2659	18-00194-00-RS	DUPAGE	30	29	
STANDARD	INALLI	C SIGNAL	DESIGN	DETAILS		TS-05	CONTRACT	CT NO. 61F20		
SHEET NO. 2	OF 7	SHEETS	STA.	TO STA.	FFD. RO	AD DIST. NO. 1 JULINOIS FED. A	ID PROJECT			

LOOPS NEXT TO SHOULDERS PROVIDE A PAVEMENT REPLACEMENT NOTE WHICH SHOULD EQUAL 3' (900 mm) X WIDTH OF PAVED SHOULDER. PAVED OR NON-PAVED SHOULDER \mathbb{H} Ê (1.5 m) (1.8 m) (1.5 m) 1" (25 mm) UNI DUCT-TRENCHED TO E/P •• (3.0 m) (3.0 m) * = (600 mm)* * LINIT DUCT IS TO BE SHOWN ON PLAN SHEETS BUT SHALL NOT BE INCLUDED IN THE PAY ITEMS.

FILE NAME =

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LEFT TURN LANES WITH MEDIANS VOLUME DENSITY ("FAR OUT" DETECTION) ON SAME APPROACH (PROTECTED / PERMITTED LEFT TURN PHASING) HANDHOLE LOCATION MAY VARY DEPENDING ON GEOMETRICS AND DESIGN OF TRAFFIC SIGNALS. HEAVY-DUTY HANDHOLES TO BE USED WHEN THE MEDIAN IS MOUNTABLE. REFER TO STANDARD BI4001 TO ENSURE THAT HANDHOLE FITS IN MEDIAN. TRENCHED 1" (25 mm) WEDIAN (TYP.) ** UNIT DUCT (3) ** ** UNIT DUCT IS TO BE SHOWN ON PLAN SHEETS BUT SHALL NOT BE INCLUDED IN THE PAY ITEMS.

NOTE: DUAL LEFT TURNS NOT SHOWN REFER TO

PLAN SHEET FOR DETECTOR LOOP REPLACEMENT

VOLUME DENSITY ("FAR OUT" DETECTION)


ON SAME APPROACH

(PROTECTED / PERMITTED LEFT TURN PHASING)

* = (600 mm)

*

ARTERIAL-VOLUME DENSITY ("FAR OUT" DETECTION)
CROSS STREET-NON VOLUME DENSITY ("UPTIGHT" PRESENCE DETECTION)

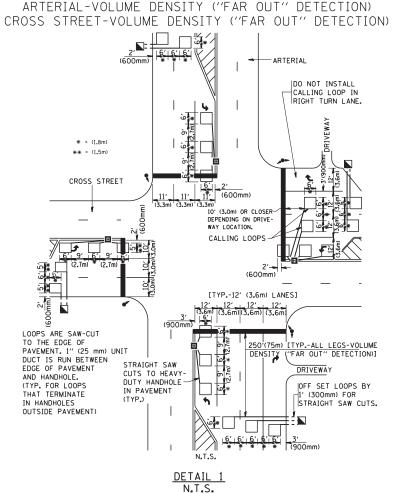

DESIGNED

CHECKED

R.K.F.

DRAWN

DATE

USER NAME = gaglianobt


PLOT DATE = 1/4/2008

REVISED

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REVISED



SCALE: NONE

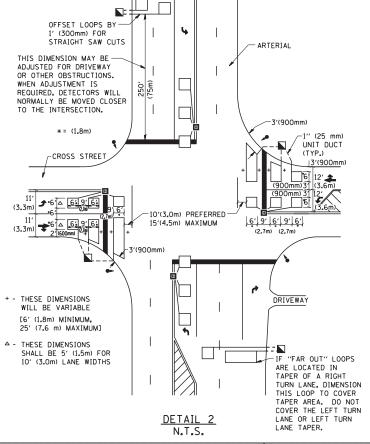NOTES

VEHICLES LOOP DETECTORS

- * ALL LEAD IN CABLE SHALL BE TWO CONDUCTOR NO. 14 TWISTED, SHIFLDED.
- * EACH DETECTOR LOOP SHALL HAVE ITS OWN SAW CUT FROM THE LOOP TO THE EDGE OF PAVEMENT OR TO A HANDHOLE IN THE PAVEMENT.
- * EACH DETECTOR LOOP SHALL HAVE ITS OWN ONE INCH (25 mm) UNIT DUCT BETWEEN THE EDGE OF PAVEMENT AND THE FIRST HANDHOLE OR JUNCTION BOX, EACH UNIT DUCT RUN SHALL BE SHOWN ON THE PLANS BY THE DESIGNER, BUT SHALL NOT BE PAID FOR SEPARATLY. THIS ITEM IS INCIDENTAL TO THE PAY ITEM FOR DETECTOR LOOPS.
- * ONE DIMENSION OF <u>ALL</u> DETECTOR LOOPS SHALL BE SIX FEET (1.8 m)
- * EACH LANE OF NON-LOCKING, PRESENCE DETECTION AND EACH LANE OF A DOUBLE LEFT TURN LANE REQUIRES A SEPARATE INDUCTIVE LOOP DETECTOR AND LEAD IN CABLE.
- * WHEN NON-LOCKING, PRESENCE DETECTION IS USED, MORE THAN ONE LOOP PER LANE IS REQUIRED BEHIND THE STOP BAR (i.e. 1-1/2, 1-3/4, 2).
- * WHEN SYSTEM LOOPS ARE REQUIRED ON AN APPROACH OF AN INTERSECTION, THE LOOPS USED FOR VOLUME DENSITY AND INTERSECTION TIMING SHALL ALSO BE USED AS SYSTEM DETECTORS. EACH ONE OF THESE TYPE OF LOOPS REQUIRES A SEPARATE TWO CONDUCTOR NO. 14 TWISTED SHIELDED CABLE AND A SEPARATE INDUCTIVE LOOP DETECTOR WHEN NEW CONTROLLERS ARE UTILIZED. THE DESIGNER SHALL LABEL THESE TYPES OF LOOPS AS "INTERSECTION AND SAMPLING (SYSTEM) DETECTORS" ON THE SIGNAL LAYOUT, THE INTERCONNECT PLAN AND THE SYSTEM CABLE PLAN. WHEN AN EXISTING CONTROLLER IS UTILIZED FOR THIS TYPE OF DETECTION, THE PAY ITEM "INDUCTIVE LOOP DETECTOR WITH SYSTEM OUTPUT" SHOULD BE USED.

PLACEMENT OF DETECTORS

THE FOLLOWING FIGURES REPRESENT THE MOST COMMON DETECTOR LOOP LOCATIONS AND SIZES. ADJUSTMENTS WILL BE NECESSARY FOR SPECIFIC GEOMETRIC CONSIDERATIONS.

LOCATIONS AND DEMENSIONS OF DETECTOR LOOPS ARE REQUIRED ON ALL SIGNAL LAYOUT PLAN SHEETS.

"FAR OUT" DETECTION REFERS TO LOCKING, PRESENCE TYPE DETECTION LOCATED IN THRU LANES, RIGHT TURN LANES, AND RIGHT TURN LANE TAPER AREAS (IF APPLICABLE), USUALLY 250' (75 m) IN ADVANCE OF STOP BARS, "UPTIGHT" DETECTION REFERS TO NON-LOCKING PRESENCE TYPE DETECTION LOCATED IN ALL LANES AND 10'-15' (3.0 m-4.5 m) BEHIND THE CROSSING STREET'S EDGE OF PAVEMENT EXTENDED.

JOTE.

ALL DETAILS AND NOTES SHOWN ARE FROM THE I.D.O.T. DISTRICT 1 TRAFFIC SIGNAL DESIGN GUIDELINES DATED JANUARY 1995

THIS DRAWING HAS BEEN PREPARED TO ASSIST THE RESIDENT ENGINEER FOR ALL ROADWAY RESURFACING OR S.M.A.R.T. PROJECTS WHERE THE DIMENSIONS ARE NOT SHOWN ON THE PLANS AND THE FINAL LOCATIONS FOR CROSSWALKS OR STOP BARS ARE NOT DETERMINED.

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DISTRICT 1 - DETECTOR LOOP INSTALLATION
DETAILS FOR ROADWAY RESURFACING

SHEET NO. 1 OF 1 SHEETS STA. TO STA.

2659 18-00194-00-RS DUPAGE 30 30		TS-07		CONTRACT	NO. 61	F20
2659 18-00194-00-RS DUPAGE 30 30		TS-07			NO. 61	F20

STATE OF ILLINOIS DEPARTMENT OF TRANSPORTATION