STATE OF ILLINOIS DEPARTMENT OF TRANSPORTATION

F.A.P. SECTION COUNTY TOTAL SHEET NO. VAR 2016-061-I VARIOUS 44 1 1. INDIS. CONTRACT NO. 62054

FOR INDEX OF SHEETS, SEE SHEET NO. 2


THIS PROJECT IS LOCATED IN:
THE CITY OF BERWYN
THE CITY OF BRAIDWOOD
THE CITY OF CHICAGO
THE CITY OF ELMHURST
THE CITY OF JOLIET
0. 002323
THE CITY OF LOCKPORT
THE CITY OF MARKHAM
THE CITY OF OAKBROOK TERRACE
THE VILLAGE OF CRETE
THE VILLAGE OF FOREST PARK
THE VILLAGE OF HODGKINS
THE VILLAGE OF MAYWOOD
THE VILLAGE OF ROMEOVILLE
THE VILLAGE OF VILLA PARK
THE FILL OF THE TANK
THE VILLAGE OF WILLOW SPRINGS
THE VILLAGE OF WILLOWBROOK
THE VILLAGE OF WOODRIDGE
I .

PROPOSED HIGHWAY PLANS

VARIOUS ROUTES
SECTION: 2016–061–I
PROJECT: HSIP–78FE(386)
GUARDRAIL REPLACEMENTS (SOUTH SECTION)
COOK, DUPAGE AND WILL COUNTIES

C-91-052-17

FOR LOCATION MAPS: SEE SHEET NO. 6 - 8

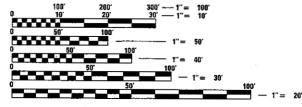

FULL SIZE PLANS HAVE BEEN PREPARED USING STANDARD ENGINEERING SCALES. REDUCED SIZED PLANS WILL NOT CONFORM TO STANDARD SCALES. IN MAKING MEASUREMENTS ON REDUCED PLANS, THE ABOVE SCALES MAY BE USED.


J.U.L.I.E.
JOINT UTILITY LOCATION INFORMATION FOR EXCAVATION
1–800–892–0123
OR 811


PROJECT ENGINEER: DANIEL WILGREEN (847) 705-4240
PROJECT MANAGER: FAWAD AQUEEL (847) 705-4247

CONTRACT NO. 62D54

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STANDARDS

000001-06	STANDARD	SYBMOLS.	ABBREVIATIONS.	ΔND	PATTERNS

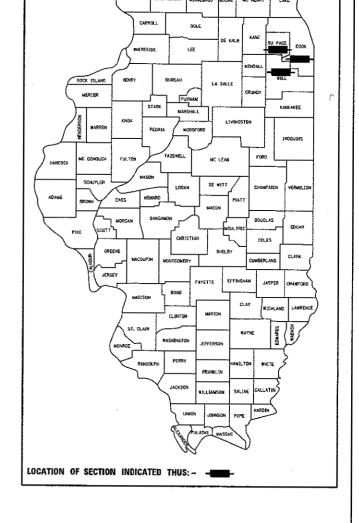- 280001-07 TEMPORARY EROSION CONTROL SYSTEMS
- 630001-92 STEEL PLATE BEAM GUARDRAIL
- 630301-108 SHOULDER WIDENING FOR TYPE 1 (SPECIAL) GUARDRAIL TERMINALS
- 631033-07 TRAFFIC BARRIER TERMINAL, TYPE 68
- 635001-02 DELINEATORS
- 701001-02 OFF-RD OPERATIONS, 2L, 2W, MORE THAN 15' AWAY
- 701006-05 OFF-RD OPERATIONS, 2L, 2W, 15' TO 24" FROM PAVEMENT EDGE
- 701011-04 OFF-RD MOVING OPERATIONS, 2L, 2W, DAY ONLY
- 701101-05 OFF-RD OPERATIONS, MULTILANE, 15' TO 24" FROM PAVEMENT EDGE
- 701106-02 OFF-RD OPERATIONS, MULTILANE, MORE THAN 15' AWAY
- 701301-04 LANE CLOSURE, 2L, 2W, SHORT TIME OPERATIONS
- 701306-04 LANE CLOSURE, 2L, 2W, SLOW MOVING OPERATIONS DAY ONLY, FOR SPEEDS > 45 MPH
- 701311-03 LANE CLOSURE 2L, 2W MOVING OPERATIONS- DAY ONLY
- 701336-06 LANE CLOSURE, 2L, 2W, WORK AREAS IN SERIES, FOR SPEEDS > 45 MPH
- 701421-08 LANE CLOSURE, MULTILANE, DAY OPERATIONS ONLY, FOR SPEEDS 2 45 MPH TO 55 MPH
- 701426-09 LANE CLOSURE, MULTILANE, INTERMITTENT OR MOVING OPER., FOR SPEEDS 2 45 MPH
- 701427-05 LANE CLOSURE, MULTILANE, INTERMITTENT OR MOVING OPER, FOR SPEEDS & 40 MPH
- 701428-01 TRAFFIC CONTROL SETUP AND REMOVAL FREEWAY/EXPRESSWAY
- 701501-06 URBAN LANE CLOSURE, 2L, 2W, UNDIVIDED
- 701601-09 URBAN LANE CLOSURE, MULTILANE, 1W OR 2W WITH NONTRAVERSABLE MEDIAN
- 701602-09 URBAN LANE CLOSURE, MULTILANE, 2W WITH BIDIRECTIONAL LEFT TURN LANE
- 701606-10 URBAN SINGLE LANE CLOSURE, MULTILANE, 2W WITH MOUNTABLE MEDIAN
- 701701-10 URBAN LANE CLOSURE, MULTILANE INTERSECTION
- 701901-0 TRAFFIC CONTROL DEVICES
- 725001-01 OBJECT AND TERMINAL MARKERS
- 782006 GUARDRAIL AND BARRIER WALL REFLECTOR MOUNTING DETAILS

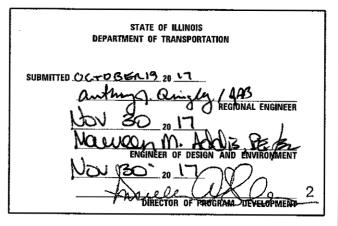COMMITMENTS

NO COMMITMENTS

GENERAL NOTES

- BEFORE STARTING ANY EXCAVATION, THE CONTRACTOR SHALL CALL "J.U.L.I.E." AT (800) 892-0123 OR 811 OR DIGGER AT 312-744-700 FOR FIELD LOCATIONS OF BURIED ELECTRIC, TELEPHONE AND GAS UTILITIES. 48 HOUR NOTIFICATION IS REQUIRED.
- (2) THE CONTRACTOR SHALL BE RESPONSIBLE FOR PROTECTING UTILITY PROPERTY FROM CONSTRUCTION OPERATIONS AS OUTLINED IN ARTICLE 107.39 OF THE STANDARD SPECIFICATIONS. ANY DAMAGE TO THE UNDERGROUND FACILITIES CAUSED BY THE CONTRACTOR SHALL BE REPAIRED TO THE SATISFACTION OF THE DEPARTMENT AT THE CONTRACTOR'S EXPENSE, INCLUDING TEMPORARY REPAIRS WHICH MAY BE REQUIRED TO KEEP THE FACILITY OPERATIONAL WHILE MATERIAL IS BEING OBTAINED TO MAKE PERMANENT REPAIRS.
- (3) THE CONTRACTOR SHALL COORDINATE CONSTRUCTION ACTIVITIES WITH UTILITY COMPANIES, AND THE MUNICIPALITIES LISTED ON THE COVER SHEET.
- THE RESIDENT ENGINEER SHALL CONTACT THE DEPARTMENT'S ELECTRICAL MAINTENANCE CONTRACTOR, MEADE ELECTRIC COMPANY, AT (773) 287-7672 PRIOR TO THE START OF CONSTRUCTION TO LOCATE ALL IDOT ELECTRICAL EQUIPMENT AND UNDERGROUND CABLES.
- THE CONTRACTOR SHALL CONTACT THE DISTRICT ONE TRAFFIC CONTROL SUPERVISOR AT (847) 705-4470 AND THE EXPRESSWAY TRAFFIC CONTROL SUPERVISOR AT (847) 705-4155 A MINIMUM OF 72 HOURS IN ADVANCE OF BEGINNING WORK. THE CONTRACTOR SHALL REGISTER ACCOUNT AT WWW.IDOTLCS.COM TO REQUEST CLOSURES ON THE EXPRESSWAYS.
- (6) THE CONTRACTOR WILL NOT BE ALLOWED TO SET UP A YARD OR FIELD OFFICE ON STATE PROPERTY WITHOUT WRITTEN PERMISSION FROM THE DEPARTMENT.
-) THE CONTRACTOR SHALL BE REQUIRED TO PROVIDE ACCESS TO ABUTTING PROPERTY AT ALL TIMES DURING THE CONSTRUCTION OF THIS PROJECT.
- B) IN ADDITION TO FIELD AND AERIAL SURVEYS, PLAN DIMENSIONS AND DETAILS RELATIVE TO THE EXISTING FACILITIES HAVE BEEN TAKEN FROM EXISTING PLANS AND ARE SUBJECT TO CONSTRUCTION VARIATIONS. IT SHALL BE THE CONTRACTOR'S RESPONSIBILITY TO VERIFY SUCH DIMENSIONS AND EXISTING CONDITIONS IN THE FIELD PRIOR TO CONSTRUCTION AND ORDERING MATERIALS. SUCH VARIATIONS SHALL NOT BE A CAUSE FOR ADDITIONAL COMPENSATION DUE TO A CHANGE IN THE SCOPE OF WORK. HOWEVER, THE CONTRACTOR WILL BE PAID FOR THE QUANTITY ACTUALLY FURNISHED AT THE UNIT PRICE BID FOR THE WORK.
- THE LOCATIONS OF THOSE BURIED AND ABOVE GROUND UTILITIES SHOWN ARE APPROXIMATE, ARE SHOWN FOR CONTRACTOR INFORMATIONAL USE ONLY, AND ARE NOT TO BE REFERENCED FOR CONSTRUCTION PURPOSES. THE IMPLIED PRESENCE OR ABSENCE OF UTILITIES IS NOT TO BE CONSTRUED BY THE OWNER, ENGINEER, CONTRACTOR, OR SUBCONTRACTORS TO BE AN ACCURATE AND COMPLETE REPRESENTATION OF UTILITIES THAT MAY OR MAY NOT EXIST ON THE CONSTRUCTION SITE. BURIED AND ABOVE GROUND UTILITY LOCATIONS, IDENTIFICATION, AND MARKING ARE THE SOLE RESPONSIBILITY OF THE CONTRACTOR. REROUTING, DISCONNECTION, PROTECTION, ETC. OF ANY UTILITIES MUST BE COORDINATED BETWEEN CONTRACTOR, UTILITY COMPANY, AND OWNER. SITE SAFETY, INCLUDING THE AVOIDANCE OF HAZARDS ASSOCIATED WITH BURIED AND ABOVE GROUND UTILITIES REMAIN THE SOLE RESPONSIBILITY OF THE CONTRACTOR.
- (10) DO NOT SCALE PLANS FOR CONSTRUCTION DIMENSIONS.
- THE CONTRACTOR SHALL TAKE ALL NECESSARY PRECAUTIONS FOR THE PROTECTION OF EXISTING PLANT MATERIAL FOR WHICH THE CONTRACT DOES NOT PROVIDE REMOVAL. THE PROTECTION OF EXISTING PLANT MATERIAL AND THE REPAIR OR REPLACEMENT OF EXISTING PLANT MATERIAL DAMAGED BY THE CONTRACTOR SHALL BE DONE IN ACCORDANCE WITH THE REQUIREMENTS OF SECTION 201 OF THE STANDARD SPECIFICATIONS.
- WHERE SECTION OR SUB-SECTION MONUMENTS ARE ENCOUNTERED, THE ENGINEER SHALL BE NOTIFIED BEFORE SUCH MONUMENTS ARE REMOVED. THE CONTRACTOR SHALL PROTECT AND CAREFULLY PRESERVE ALL PROPERTY MARKERS AND MONUMENTS UNTIL THE OWNER, AN AUTHORIZED SURVEYOR, OR AGENT HAS WITNESSED THEIR LOCATION.
- frames and grates adjustment of private utilities within the limits of the improvements shall be done by their respective owners and are not part of this contract.
- (4) THE CONTRACTOR SHALL VERIFY THE EXISTING TYPE/HEIGHT OF EXISTING GUARDRAIL BEFORE ORDERING THE NEW TERMINAL SECTION. THE TERMINAL SECTION SHALL MATCH THE HEIGHT OF THE EXISTING GUARDRAIL.
- REMOVED GUARDRAIL MUST BE REPLACED ON THE SAME DAY UNLESS AUTHORIZED BY THE RESIDENT ENGINEER. NO LOCATIONS WILL BE LEFT WITHOUT EITHER LIGHTED BARRICADES OR RESTORED GUARDRAIL AT ANY TIME.
- (16) THE CONTRACTOR SHALL ONLY PERFORM WORK ON ONE SIDE OF THE ROADWAY AT ANY TIME.
- 17) NO MATERIAL SHOULD BE LEFT ON OR NEAR THE ROADWAY DURING NON-WORKING HOURS.
- (18) WHEN GUARDRAIL POSTS ARE PLACED BEHIND CONCRETE HEADWALLS, THE POSTS SHALL NOT BE PLACED TO BLOCK THE DRAINAGE OPENING.

HOT-MIX ASPHALT MIXTURE REQUIREMENT	S	QUALITY MANAGEMENT
MIXTURE TYPE	AIR VOIDS • Ndes	PROGRAM (QMP)
HMA SHOULDER, 8"		·
HOT-MIX ASPHALT BINDER, IL-19.0, 6"	4% @ 50 GYR.	QC/QA
HOT-MIX ASPHALT SURFACE COURSE, MIX "D", N50 (IL-9.5mmm), 2"	4% @ 50 GYR.	QC/QA
QMP DESIGNATION: QUALTIY CONTROL/ QUALTIY ASSURANCE (QC/QA)	42 6 50 GIR.	GC/ UA

- THE UNIT WEIGHT USED TO CALCULATE ALL HMA SURFACE MIXTURE QUANTITIES IS 112 LBS/SQ YD/IN

SCALE:

- THE "AC TYPE" FOR POLYMERIZED HMA MIXES SHALL BE "SBS/SBR PG 76-22" AND FOR NON-POLYMERIZED HMA THE "AC TYPE" SHALL BE "PG 64-22" UNLESS MODIFIED BY DISTRICT ONE SPECIAL PROVISIONS.
- FOR USE OF RECYCLED MATERIALS SEE SPECIAL PROVISIONS
- QUALITY MANAGEMENT PROGRAM (QMP) IDENTIFIES THE PARTICULAR QUALITY CONTROL SPECIFICATION THAT APPLIES TO THE HMA MIXTURE

USER NAME = Bitgramisa	DESIGNED -	REVISED -
	DRAWN -	REVISED -
PLOT SCALE = 100.0000 ' / in.	CHECKED -	REVISED -
PLOT DATE = 10/17/2017	DATE -	REVISED -

STATE OF ILLINOIS
DEPARTMENT OF TRANSPORTATION

GUARDRAIL REPLACEMENT (SOUTH SECTION)

INDEX OF SHEETS, STATE STANDARDS, AND GENERAL NOTES

SHEET OF SHEETS STA. TO STA.

SECTION COUNTY TOTAL SHEET NO.

VAR. 2016-061-1 VARIOUS 44 2

CONTRACT NO. 62D54

			urban										urban	•					
	SUMMARY OF QUANTITIES	***************************************	2.5.700			NSTRUCTIO	N TYPE C	ODE			SUMMARY OF QUANTITIES	<u> </u>	- 20004		1	NSTRUCTIO	N TYPE CO	DE	
CODE NO	ITEM	UNIT	TOTAL QUANTITIES	10% STATE	90% FED 10% STATE 0021 DUPAGE COUNTY	90% FED 10% STATE 0021 WILL COUNTY			4:1	CODE NO	ITEM	UNIT	TOTAL	1	90% FED 10% STATE 0021 DUPAGE COUNTY	90% FED 10% STATE 0021 WILL COUNTY			
20200100	EARTH EXCAVATION	CU YD	98	45	42.5	10.5		,		63100089	TRAFFIC BARRIER TERMINAL, TYP	PE 6B EACH	3	CODITI	3	CODATT			
21101505	TOPSOIL EXCAVATION AND PLACEMENT	CU YD	7. 1		7_ 1					63100167	TRAFFIC BARRIER TERMINAL, TYP	E 1 EACH	37	13	15	9			
21101615	TOPSOIL FURNISH AND PLACE, 4"	SO YD	565	160	317.5	87.5			STATE OF THE PARTY		(SPECIAL) TANGENT								
11101013	TO SOLE FORMATS AND FEACE.	30 10	363	160	317.3	67.3				63100169	TRAFFIC BARRIER TERMINAL, TYP	E 1 EACH	5	1	3	1			-
25000210	SEEDING. CLASS 2A	ACRE	0.12	0.03	0.07	0.02		The state of the s			(SPECIAL) FLARED								
25000400	NITROGEN FERTILIZER NUTRIENT	POUND	10.81	2. 98	6. 04	1. 79				63200310	GUARDRAIL REMOVAL	FOOT	2777	851	1448	478			
25000500	PHOSPHORUS FERTILIZER NUTRIENT	POUND	10.81	2.98	6.04	1. 79	:			64300260	IMPACT ATTENUATORS (FULLY RED	IRECTIVE. EACH	5	2	3				
											NARROW), TEST LEVEL 3								
25000600	POTASSIUM FERTILIZER NUTRIENT	POUND	10.81	2. 98	6.04	1.79			400	* *********									
25100630	EROSION CONTROL BLANKET	SO YD	573.5	160	317.5	96				* 66900200	NON-SPECIAL WASTE DISPOSAL	CU YE	98	45	42.5	10.5			
			And the state of t			et sergenarite de la constanta			•	* 66900450	SPECIAL WASTE PLANS AND REPOR	TS LSUM	1	0.4	0.3	0.3			
25200110	SODDING. SALT TOLERANT	SQ YD	43		43					* 66900530	SOIL DISPOSAL ANALYSIS	EACH	4						-
40600290	BITUMINOUS MATERIALS (TACK COAT)	POUND	27	27							JOIL DISTOSIC ANALYSIS	EACH	1	2	Î	1			
						4				67000400	ENGINEER'S FIELD OFFICE, TYPE	A CAL M	6	2	2	2			
44004250	PAVED SHOULDER REMOVAL	SO YD	72	35	37	1	-			67100100	MOBILIZATION	LSUM	1	0.3	0.4	0.3			
48101200	AGGREGATE SHOULDERS. TYPE B	TON	488	140	294	54													
			Attended to the state of the st						1.00	70100310	TRAFFIC CONTROL AND PROTECTIO	N, LSUM	1	0.3	0.4	0.3			
48203029	HOT-MIX ASPHALT SHOULDERS, 8"	SQ YD	97	60	37						STANDARD 701421								
63000001	STEEL PLATE BEAM GUARDRAIL. TYPE A. 6	FOOT	1925	1262.5	587.5	75				70100460	TRAFFIC CONTROL AND PROTECTIO	N, LSUM	1	0.3	0.4	0.3			
	FOOT POSTS										STANDARD 701306								
63100045	TRAFFIC BARRIER TERMINAL, TYPE 2	EACH	1			1				70100600	TRAFFIC CONTROL AND PROTECTIO	N, LSUM	1	0.3	0.4	0.3			
*	SPECIALTY ITEMS							-	13	3	STANDARD 701336								
FILE NAME = pwi\VLO84EBIDIMTEGI	lilindisgov+PWIDOT\Documents\DOT Offices\District \Projects\Dio52iT\CADDato\Design\Dio527\\\\\\\\\\\\\\\\\\\\\\\\\\\\\\\\\\\\	DESIGNED - SE MARKENIGH - CHECKED - DATE - 10		REVISED REVISED REVISED REVISED	-		Di		ATE OF I	LLINOIS RANSPORTA	TION	RDRAIL REPLACEMENT (S SUMMARY OF QUAI ET NO. 1 OF 2 SHEETS	NTITIES	O STA.	F.A RTE.	SECTIO 2016-06 AD DIST. NO. 1 ILI	1-I	CONTRACT I	NO. 62D5

urban WERAN CONSTRUCTION TYPE CODE CONSTRUCTION TYPE CODE SUMMARY OF QUANTITIES SUMMARY OF QUANTITIES 90% FED 90% FED 90% FED 90% FED 90% FED 90% FED 10% STATE 10% STATE 10% STATE 10% STATE 10% STATE 10% STATE TOTAL TOTAL QUANTITIES CODE NO ITEM UNIT **OUANTITIES** UNIT ITEM CODE NO 0021 COOK 0021 0021 0021 DUPAGE COUNTY DUPAGE COUNTY COOK WILL COUNTY COUNTY COUNTY COUNTY 70102620 0.3 Z0030850 TEMPORARY INFORMATION SIGNING SQ FT 51.4 51.4 LSUM 0.4 TRAFFIC CONTROL AND PROTECTION. 0.3 STANDARD 701501 Z0064800 SELECTIVE CLEARING UNIT 13 70101615 0.3 LSUM 0.3 TRAFFIC CONTROL AND PROTECTION. 0.4 STANDARD 701606 LSUM 0.3 TRAFFIC CONTROL AND PROTECTION. 0.3 0.4 70102630 STANDARD 701601 70102632 TRAFFIC CONTROL AND PROTECTION. LSUM 0.3 0.3 0.4 STANDARD 701602 LSUM 0.3 70102635 TRAFFIC CONTROL AND PROTECTION. 0.3 0.4 STANDARD 701701 TERMINAL MARKER - DIRECT APPLIED EACH 42 14 18 10 72501000 FOOT 288 THERMOPLASTIC PAVEMENT MARKING - LINE 4" 288 78000200 FOOT 34 34 78000600 THERMOPLASTIC PAVEMENT MARKING - LINE 12" 78200005 GUARDRAIL REFLECTORS, TYPE A EACH 79 23 SQ FT 70 70 X0327980 PAVEMENT MARKING REMOVAL - WATER BLASTING LSUM 0.3 X7011015 TRAFFIC CONTROL AND PROTECTION 0.4 0.3 (EXPRESSWAYS) CAL DA 20 20 20 X7015005 CHANGEABLE MESSAGE SIGN SPECIALTY ITEMS TOTAL SHEET SHEETS NO. 44 4 SECTION COUNTY DESIGNED - SB REVISED -**GUARDRAIL REPLACEMENT (SOUTH SECTION)** STATE OF ILLINOIS Offices\District \Projects\DX052IT\CADData\Design\Dt REVISED 2016-061-I VARIOUS VAR **SUMMARY OF QUANTITIES DEPARTMENT OF TRANSPORTATION** CONTRACT NO. 62054 CHECKED REVISED PLOT SCALE = 100,0000 1/ In. SCALE:


10/17/17 PLOT DATE = 10/17/2017 DATE REVISED -

SHEET NO. 2 OF 2 SHEETS STA. TO STA. FED. ROAD DIST. NO. 1 ILLINOIS FED. AID PROJECT


GUARDRAIL REPLACEMENT SCHEDULE

LOCATION	EARTH EXCAVATION (CU YD)	TOPSOIL FURNISH AND PLACE, 4" (SQ YD)	PAVED SHLDR REMOVAL (SQ YD)	HOT-MIX ASPHALT SHOULDER, 8" (SQ YD)	AGGREGATE SHLDR, TYPE B (TON)	GUARDRAIL MARKER, TY. A (EACH)	GUARDRAIL REMOVAL (FOOT)	SPB GR, TY. A 6FT POSTS (FOOT)	TRAFFIC BAR TERM, TYPE 1 (SP) TANGENT (EACH)	TRAFFIC BAR TERM, TYPE 1 (SP) FLARED (EACH)	TRAFFIC BAR TERM, TYPE 2 (EACH)	TRAFFIC BAR TERM, TYPE 6B (EACH)	IMPACT ATTEN (REDIRECTIVE NARROW), TL 3 (EACH)
1	7		35	60		1	87	50		1			
2	1.5	15	33	80	45	1	50	25	1	1			
3	1.3	8.5			23	1	50	23	1				
<u>5</u> 4	1	8.5			11	1	60		1				
	1	8.5			11	1	58		1				
	1	8.5				1	50		1				
7	1	8.5				1	50		1				
8	1 1	8.5				1	50		1				
9	1 1	8.5			12	1	34		1				
10	1 1	8.5			12	1	50		1				
11	1 1	8.5			10	1	50		1				
12	1 1	8.5			7	1	31	+	1	+			+
13	1.5	15			27	2	75	25	1	1			+
15	1 1	8 . 5			5	1	50	25	1	1			
14 15	1	8.5			3	1	40		1				
	1.5				1.4	1		25	1	1		1	
16 17	1.5	15			14	2	51	25	1	1			
	-	8.5			15	1	262		1				
18	2	8.5				2	54	F.0	2				
19	3	30			15	3	140	50	3		1		
20	1	8.5			15	2	88		1		1		
21	1	8.5			11	1	50	110.5	1				
22	2.25	30				4	84	112.5					
23		0.5					50		ļ ,				1
24	1	8.5				1	50		1				
25	1	0.5			15	1	50		1				
26	1	8.5			13	1	50		1				
27	1	8.5			14	1	50		1				
28	1	8.5			15	1	50		1				
29	1	8.5			16	1 1	50		1				
30	3.75	40			12	3	50	137.5	1				
31	1	8.5			18	1	50		1				
32	1	8.5				1	50			1			
33	1.75	20			41	2	50	37.5	1				
34	2.5	8.5			19	4	50	-	1			1	
35	1	8.5			9	1	50		1				
36		8.5					130						
37	8.22	8.5	37	37			56						
38	1	8.5				1	50		1				
39	2.5	8.5				4	50			1		1	
40	2.5	8.5			24	4	50		1			1	
41	3	40			22	4	127	150					1
42	2	30			29	4	100	100					1
43	1.5	15			22	2	50	25	1				
44	25.75	60			24	11		1187.5	2				
45													2
										_		_	_
TOTAL	98	565	72	97	488	79	2777	1925	37	5	1	3	5

FILE NAME =	USER NAME = Bilgramisa	DESIGNED - RWB/SB	REVISED -			GUARDRAIL REPLACEMENT (SOUTH SECTION)	F.A.	SECTION	COUNTY TOTAL SHEET
pw:\\ILØ84EBIDINTEG.:ll:nois.gov:PWIDOT\Do	cuments\IDOT Offices\District 1\Projects\D10	521 07R/AMIN ata\Design \RWB5/25B sht-schedule.d	nREVISED -	STATE OF ILLINOIS		SCHEDULE OF QUANTITIES	VAR	2016-061-I	VARIOUS 44 5
	PLOT SCALE = 100.0000 '/ in.	CHECKED -	REVISED -	DEPARTMENT OF TRANSPORTATION		2CHEDOLE OL MONITHE2			CONTRACT NO. 62D54
Default	PLOT DATE = 10/17/2017	DATE - 9/14/17	REVISED -		SCALE:	SHEET 1 OF 1 SHEETS STA. TO STA.		ILLINOIS FED.	AID PROJECT

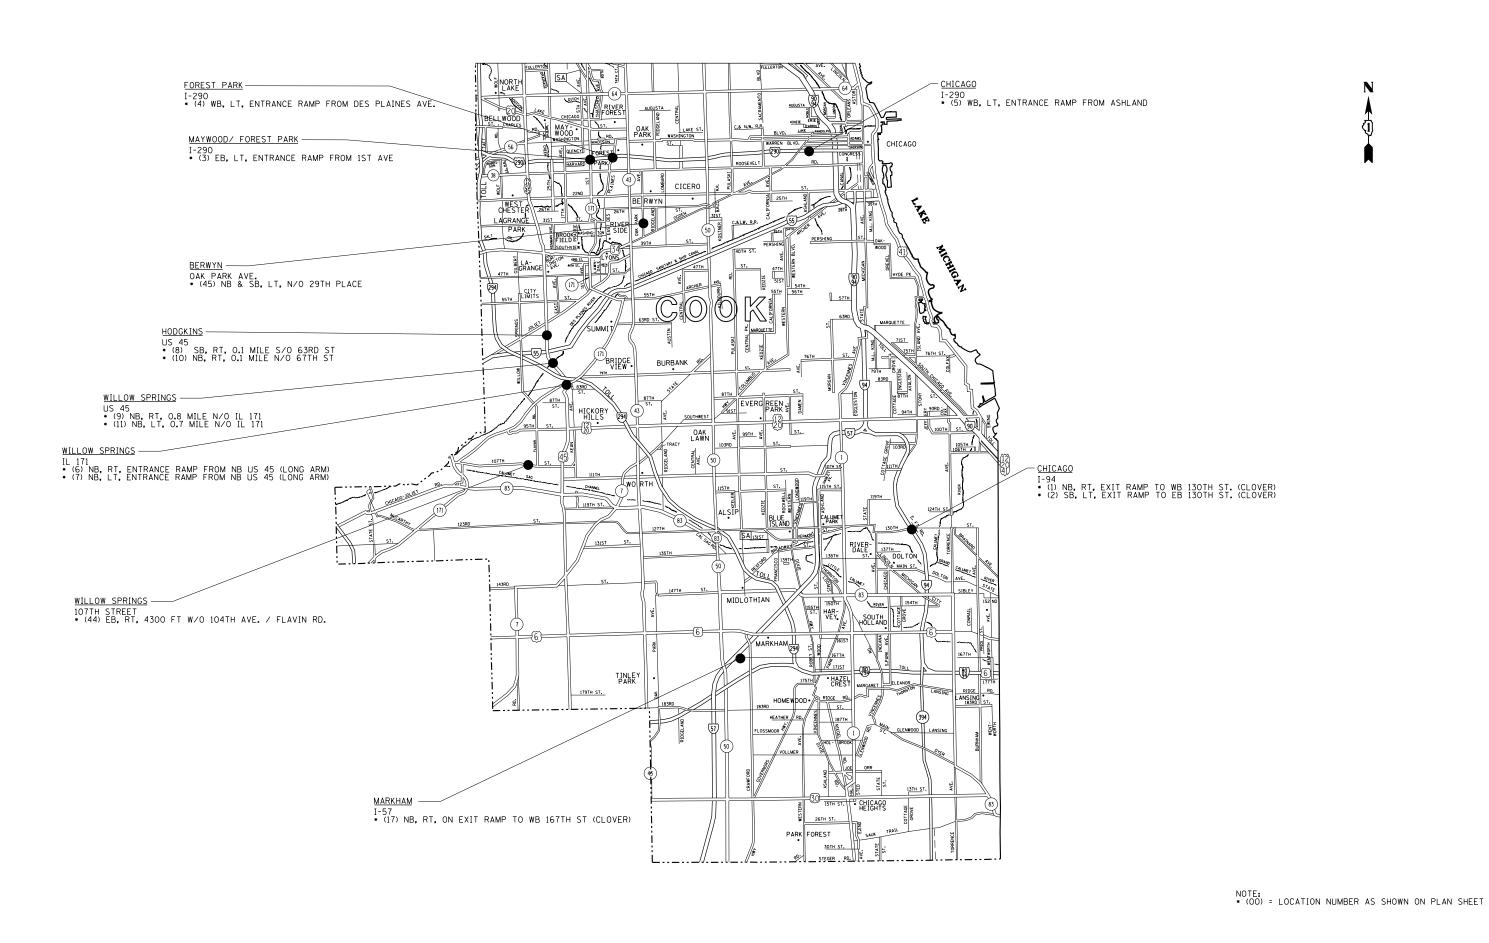



FILE NAME =	USER NAME = Bilgramisa	DESIGNED - SB	REVISED -		GUARDRAIL REPLACEMENT (SOUTH SECTION)	F.A. RTE.	SECTION	COUNTY	TOTAL SHEET SHEETS NO.
pw:\\ILØ84EBIDINTEG.:ll:no:s.gov:F	•		ht-details.dgn REVISED -	STATE OF ILLINOIS	LOCATION MAP (COOK COUNTY)	VAR	2016-061-I	VARIOUS	44 6
L	PLOT SCALE = 100.0000 ' / in.	CHECKED -	REVISED -	DEPARTMENT OF TRANSPORTATION	· · · · · · · · · · · · · · · · · · ·			CONTRACT	T NO. 62D54
Default	PLOT DATE = 10/17/2017	DATE -	REVISED -		SCALE: NTS SHEET 1 OF 3 SHEETS STA. TO STA.		ILLINOIS FED. A	ID PROJECT	

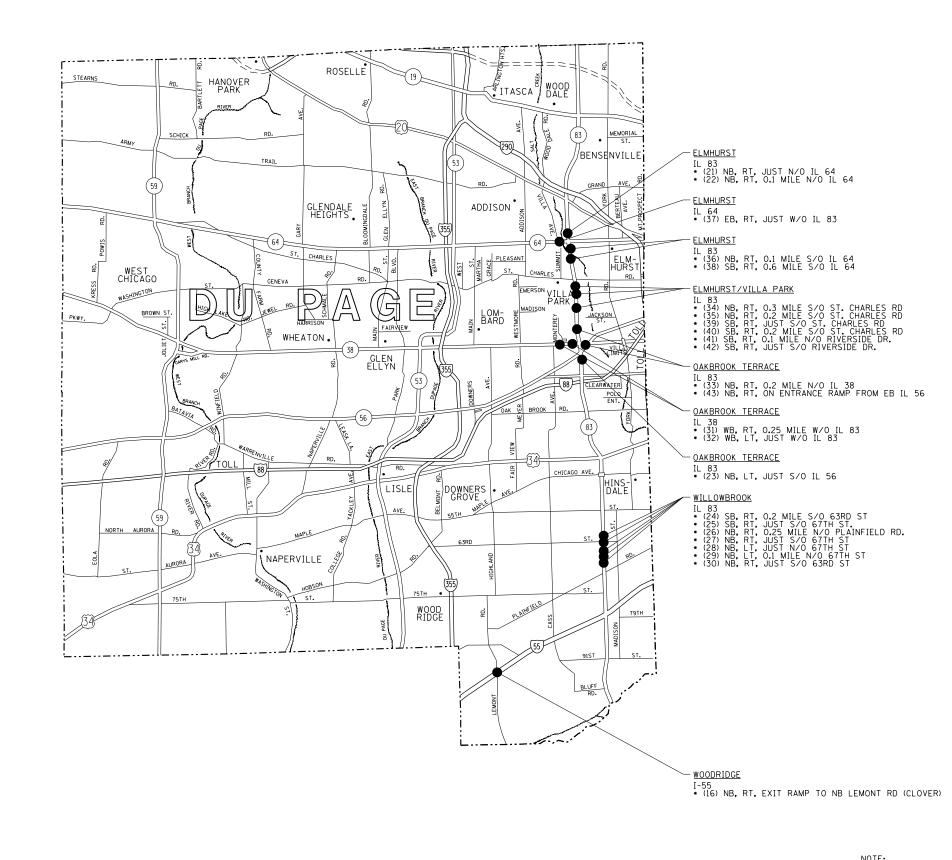



NOTE:
• (00) = LOCATION NUMBER AS SHOWN ON PLAN SHEET


FILE NAME =	USER NAME = Bilgramisa	DESIGNED - SB	REVISED -			GUARDRAIL REPLACEMENT (SOUTH SECTION)	F.A. RTE.	SECTION	COUNTY TOTAL S
pw:\\ILØ84EBIDINTEG.:ll:nois.gov:PWIDO	T\Documents\IDOT Offices\District 1\Projec		ht-details.dgn REVISED -	STATE OF ILLINOIS		LOCATION MAP (DUPAGE COUNTY)	VAR	2016-061-I	VARIOUS 44
	PLOT SCALE = 100.0000 '/ in.	CHECKED -	REVISED -	DEPARTMENT OF TRANSPORTATION		, ,			CONTRACT NO. 62
Default	PLOT DATE = 10/17/2017	DATE -	REVISED -		SCALE: NTS	SHEET 2 OF 3 SHEETS STA. TO STA.		ILLINOIS FED	. AID PROJECT

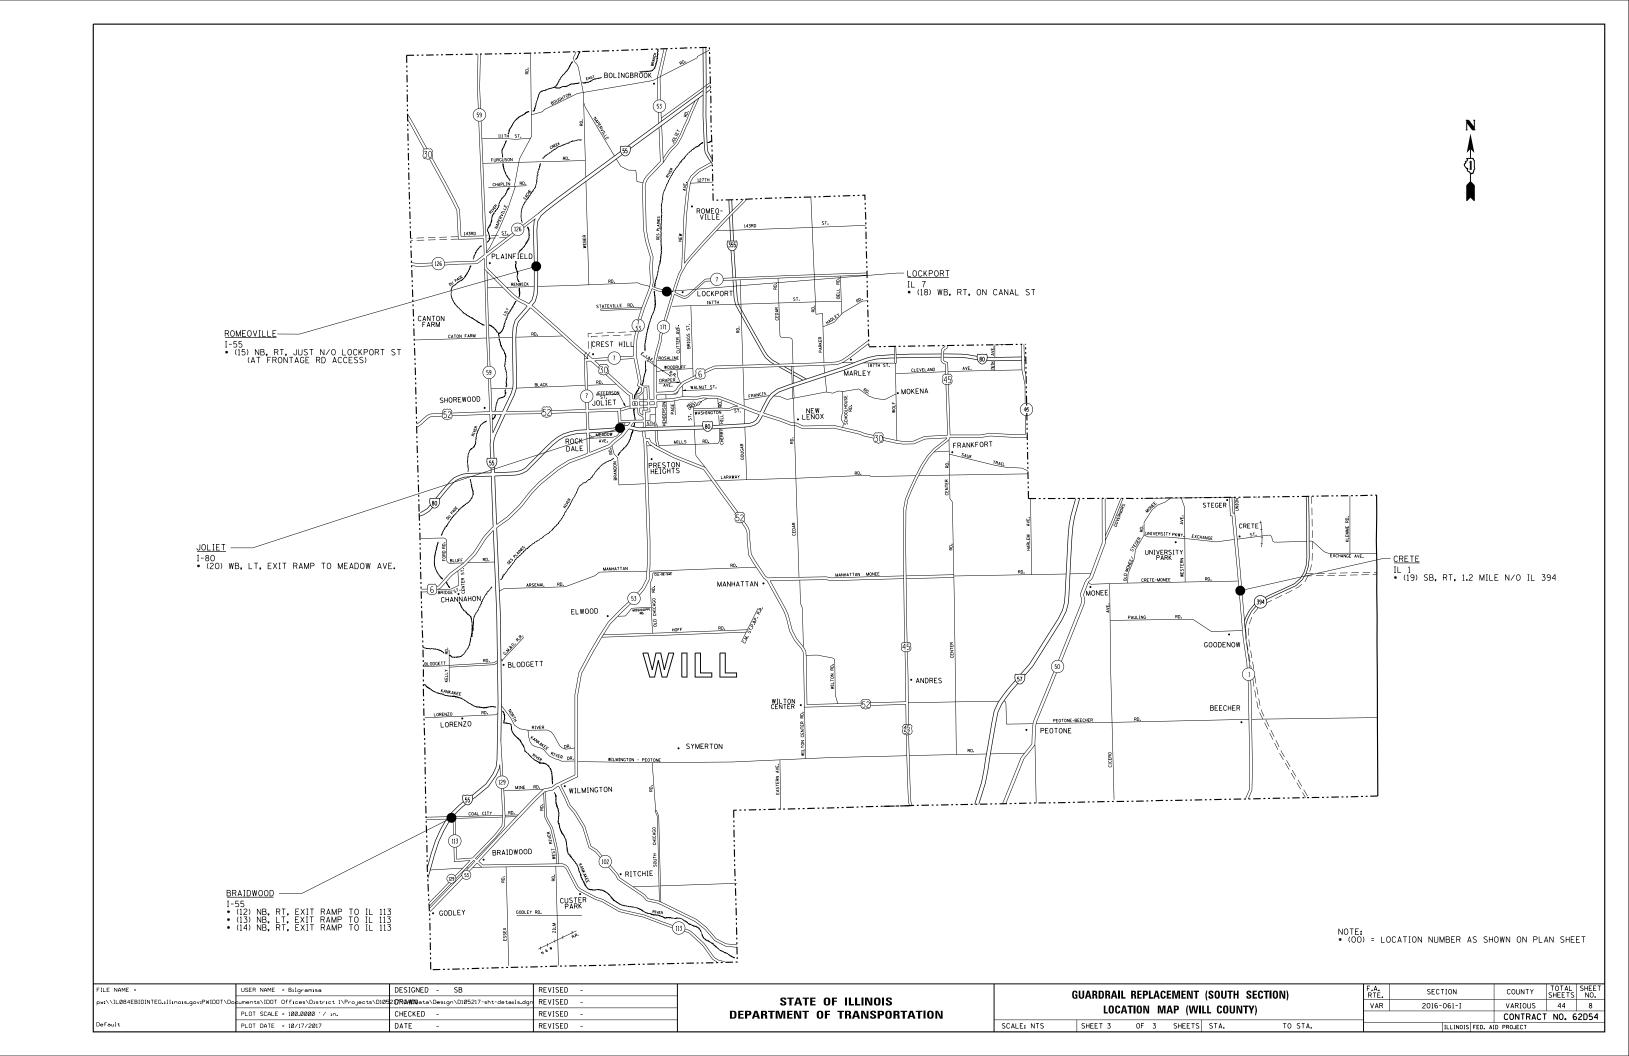


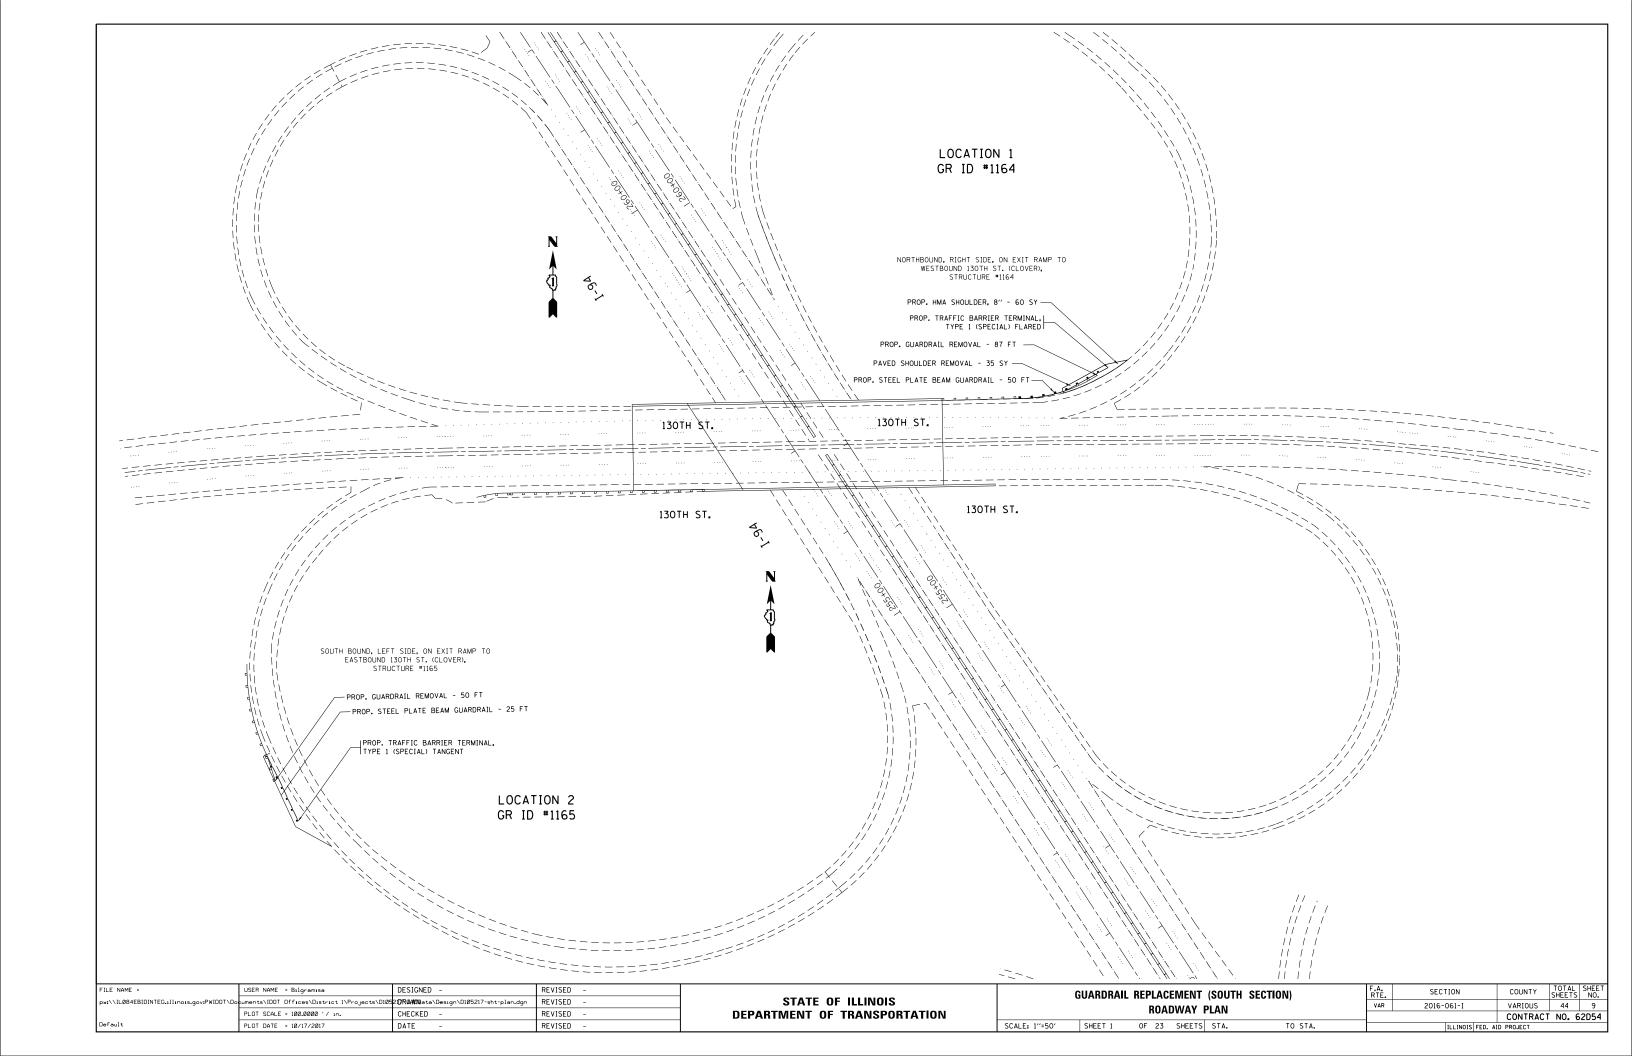


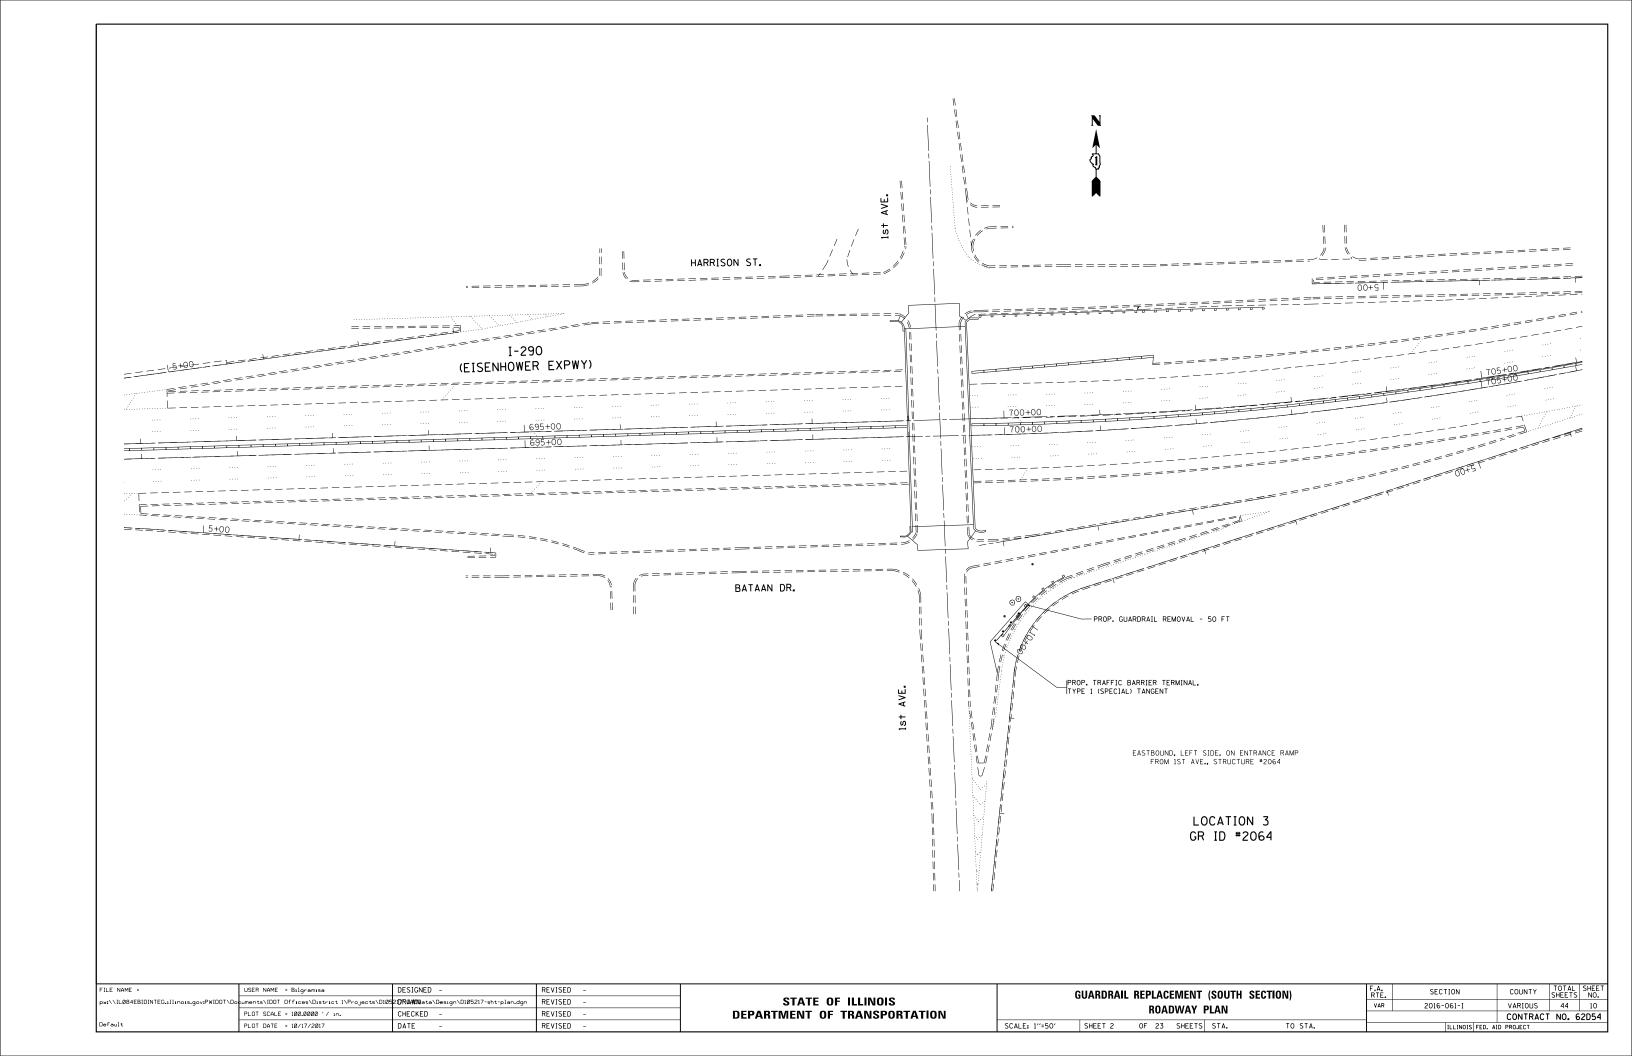


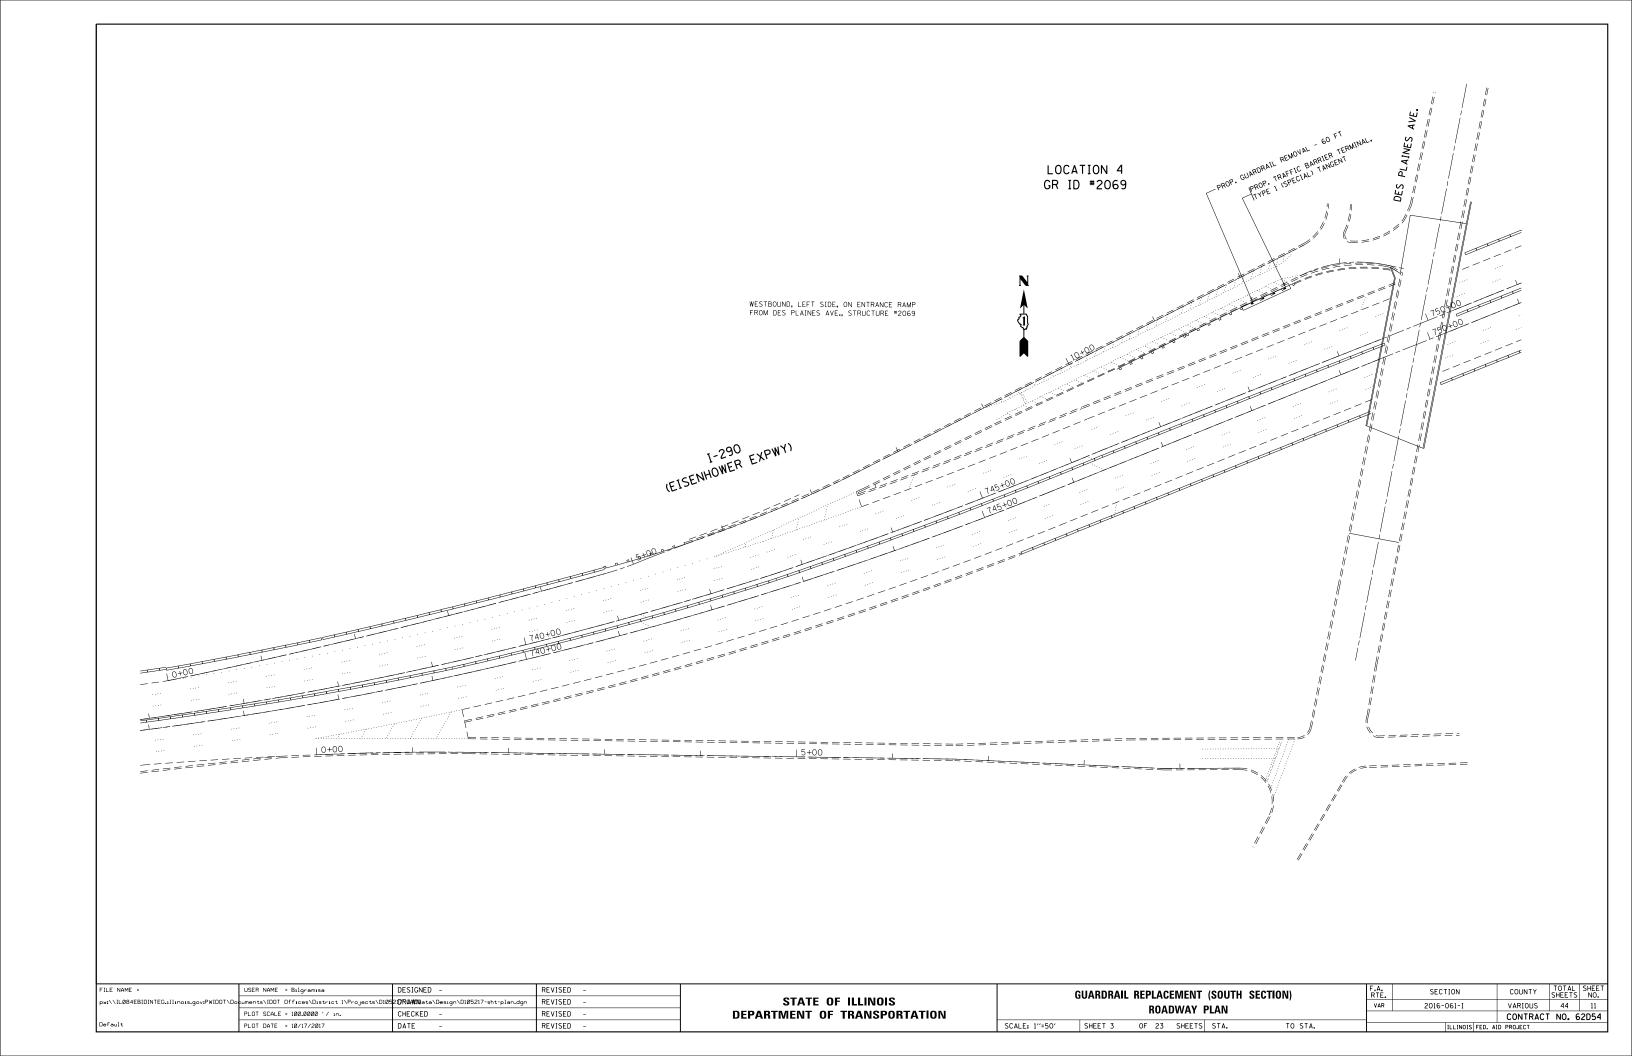


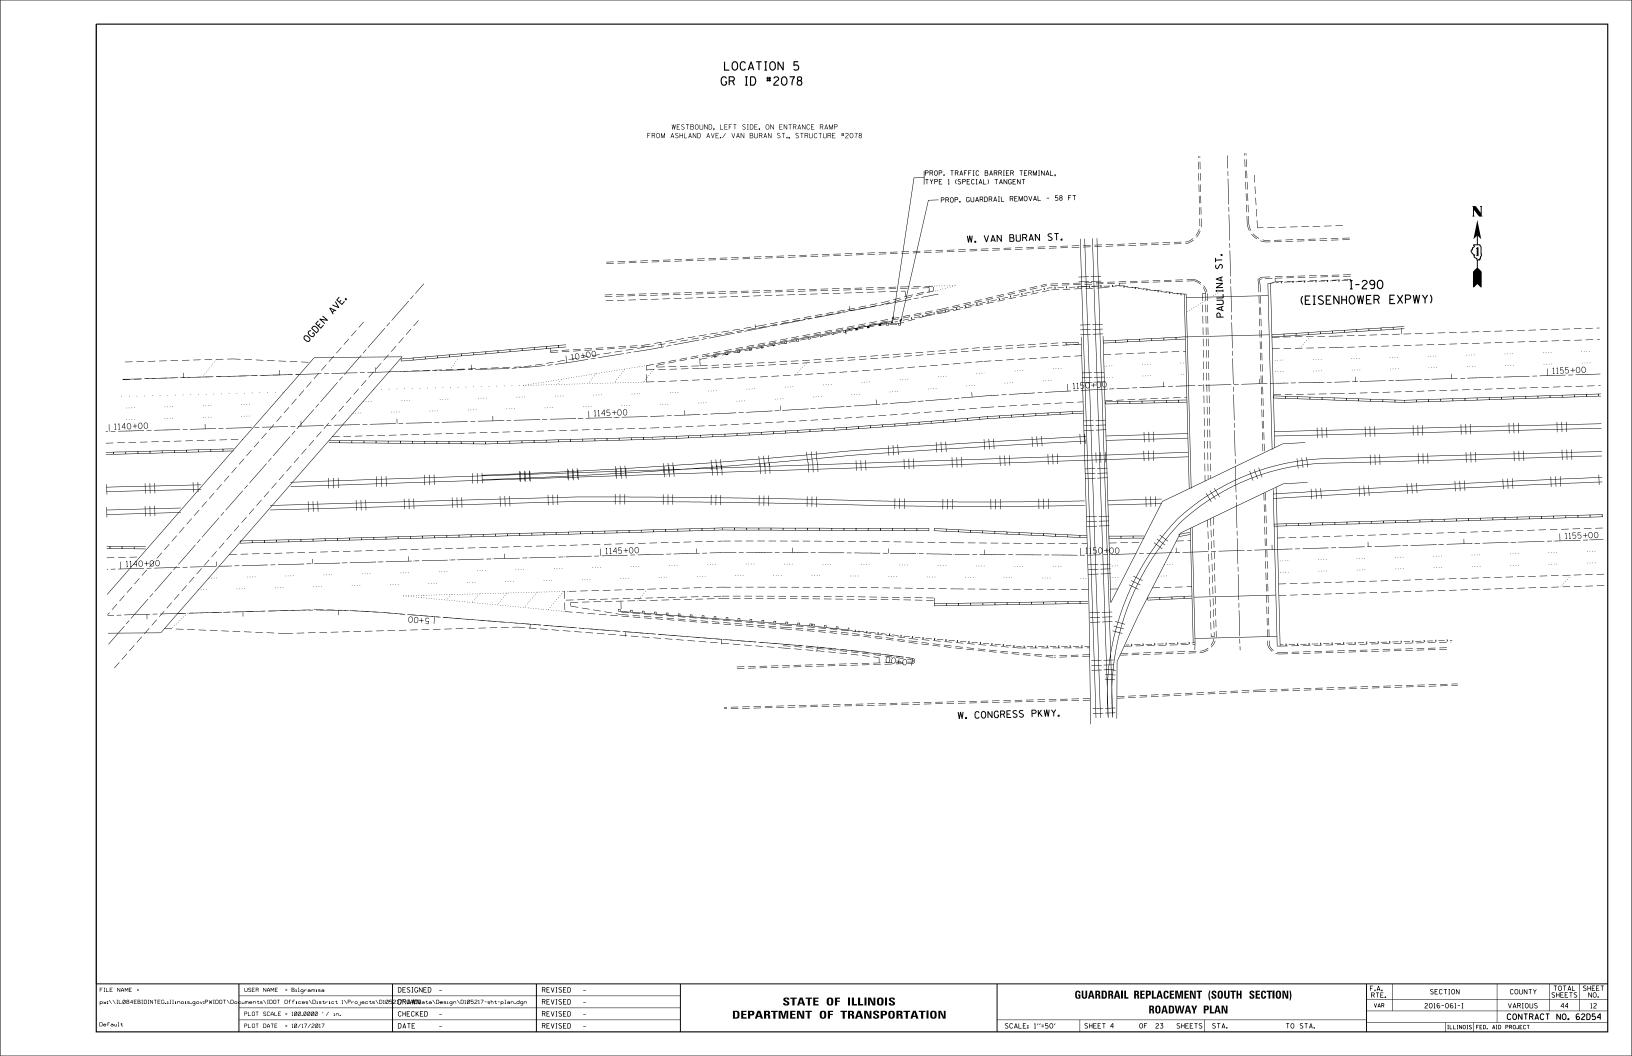


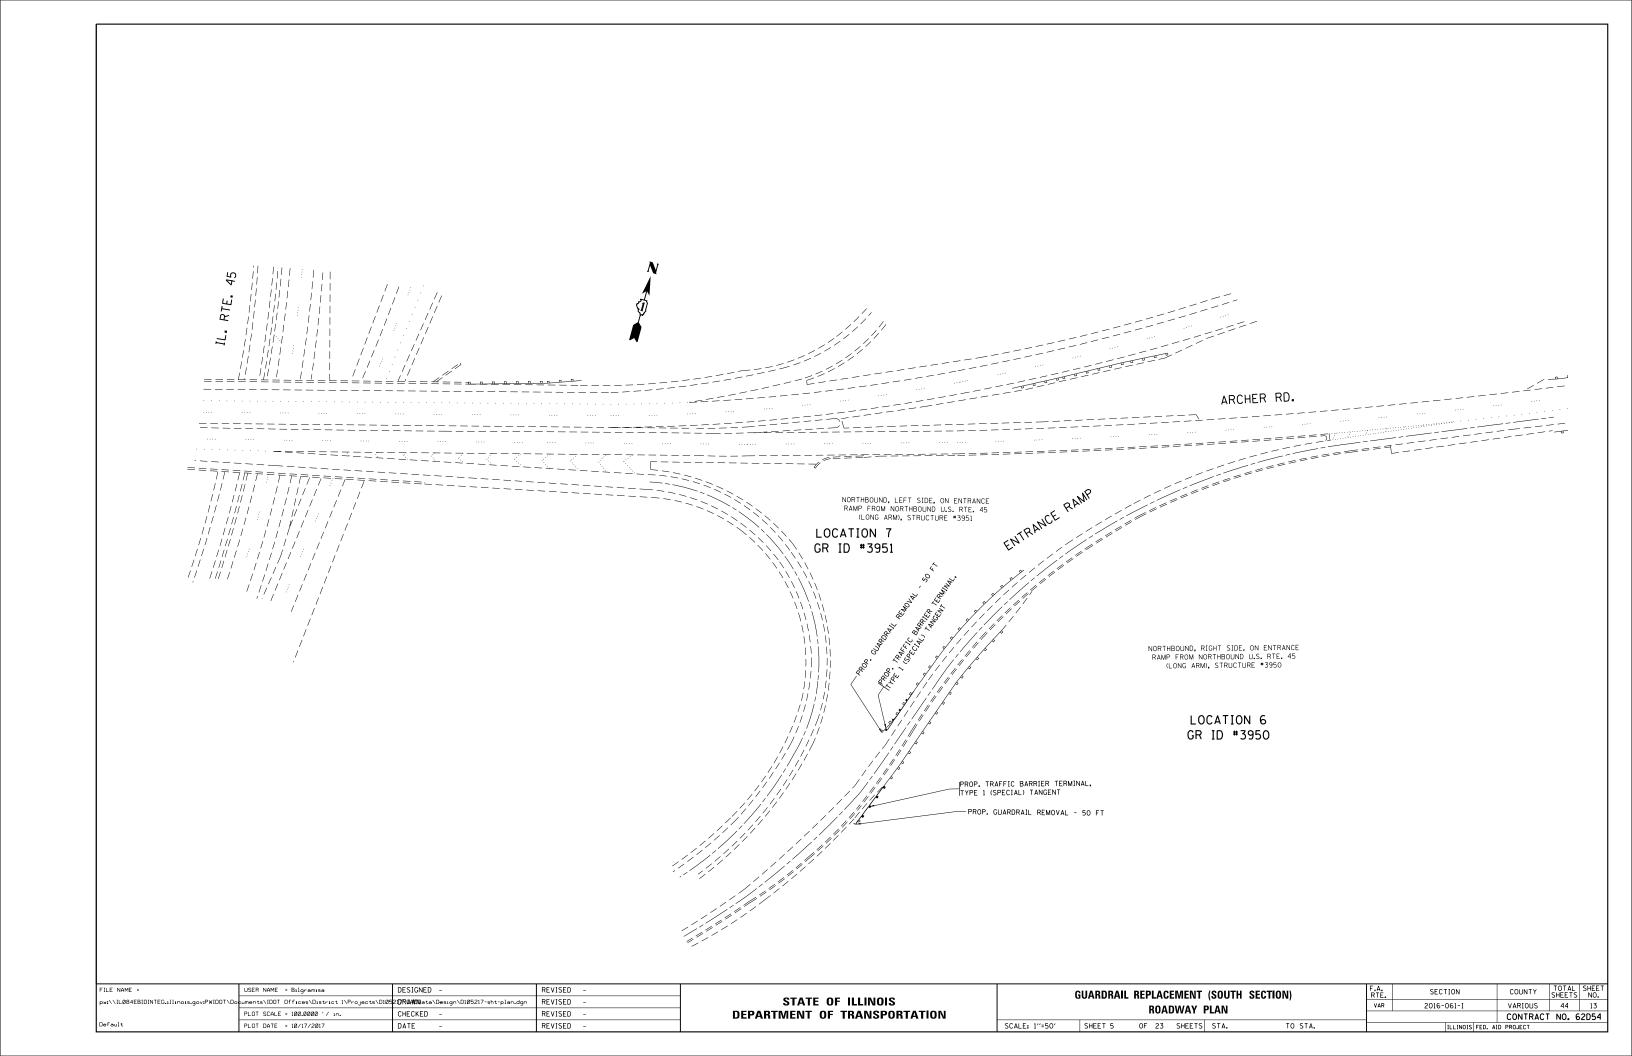


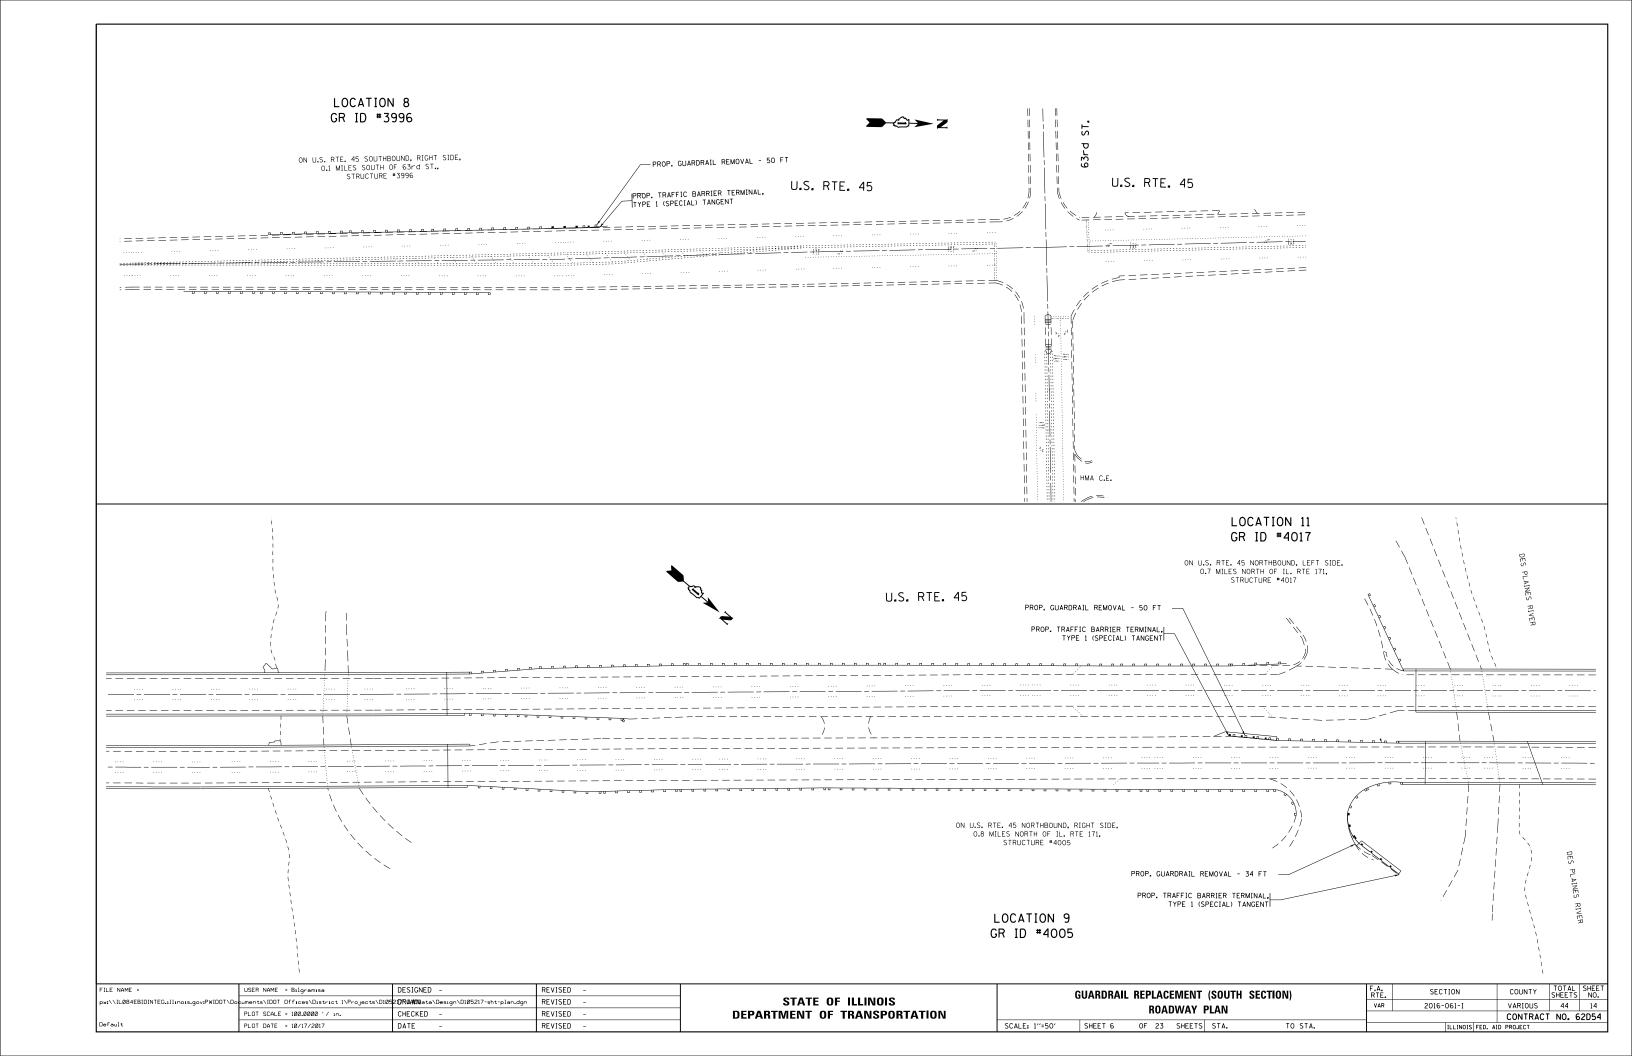


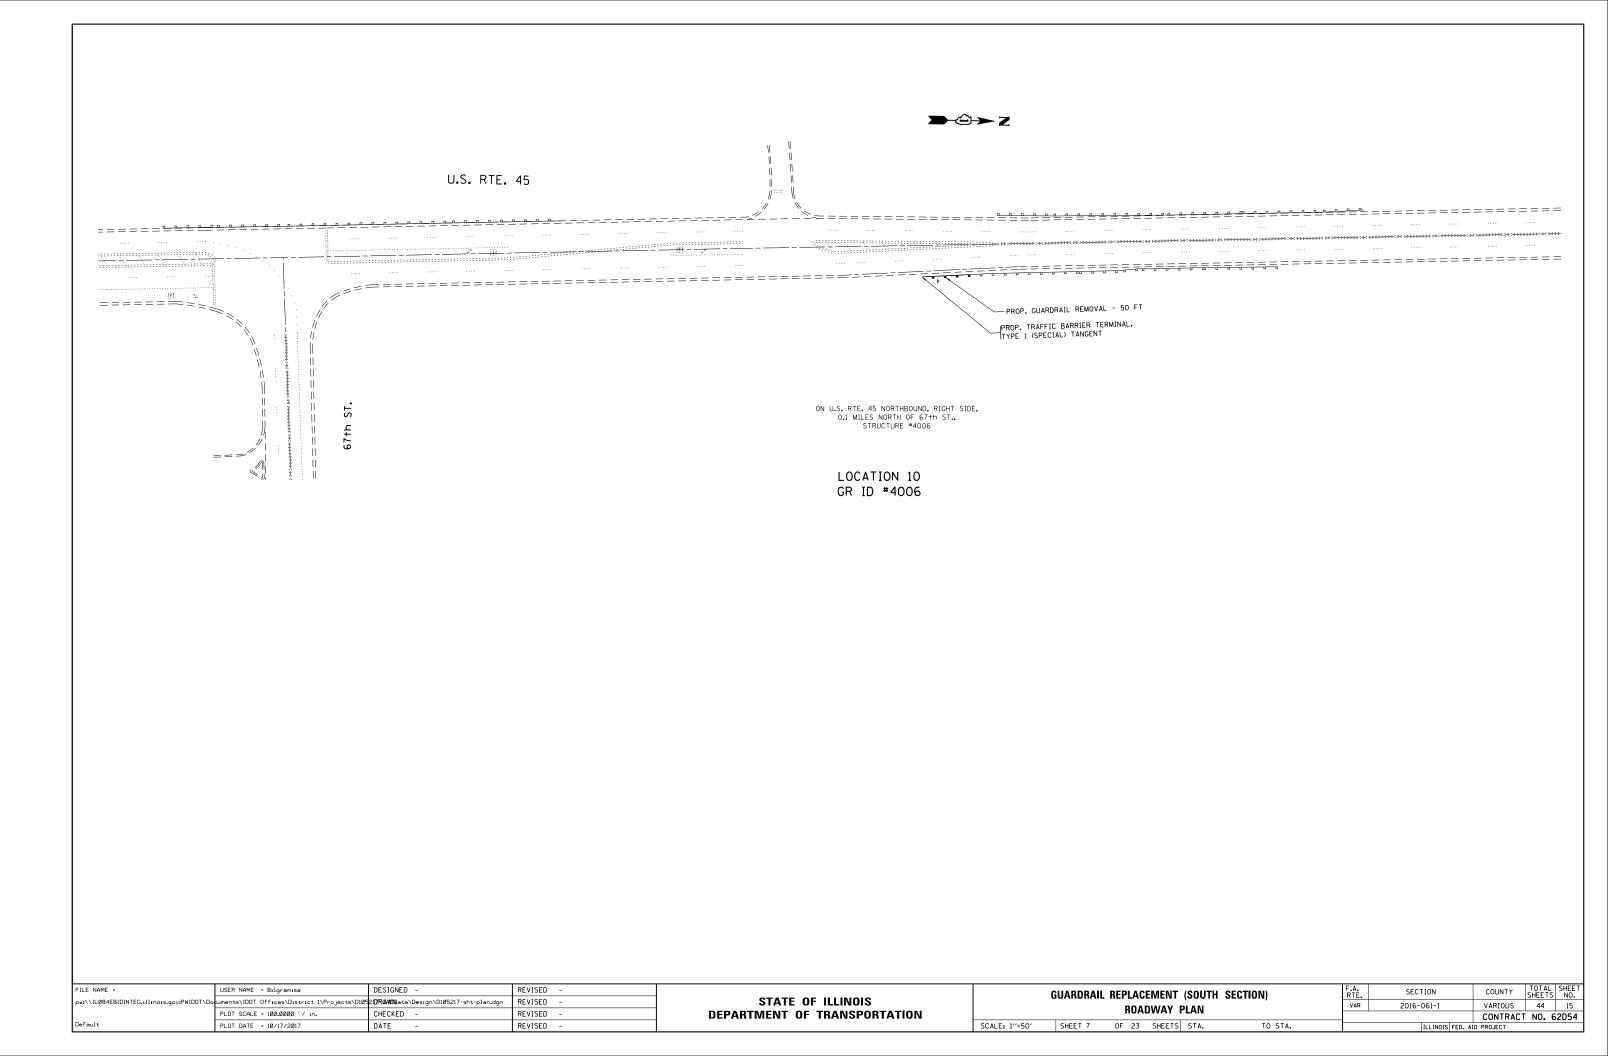


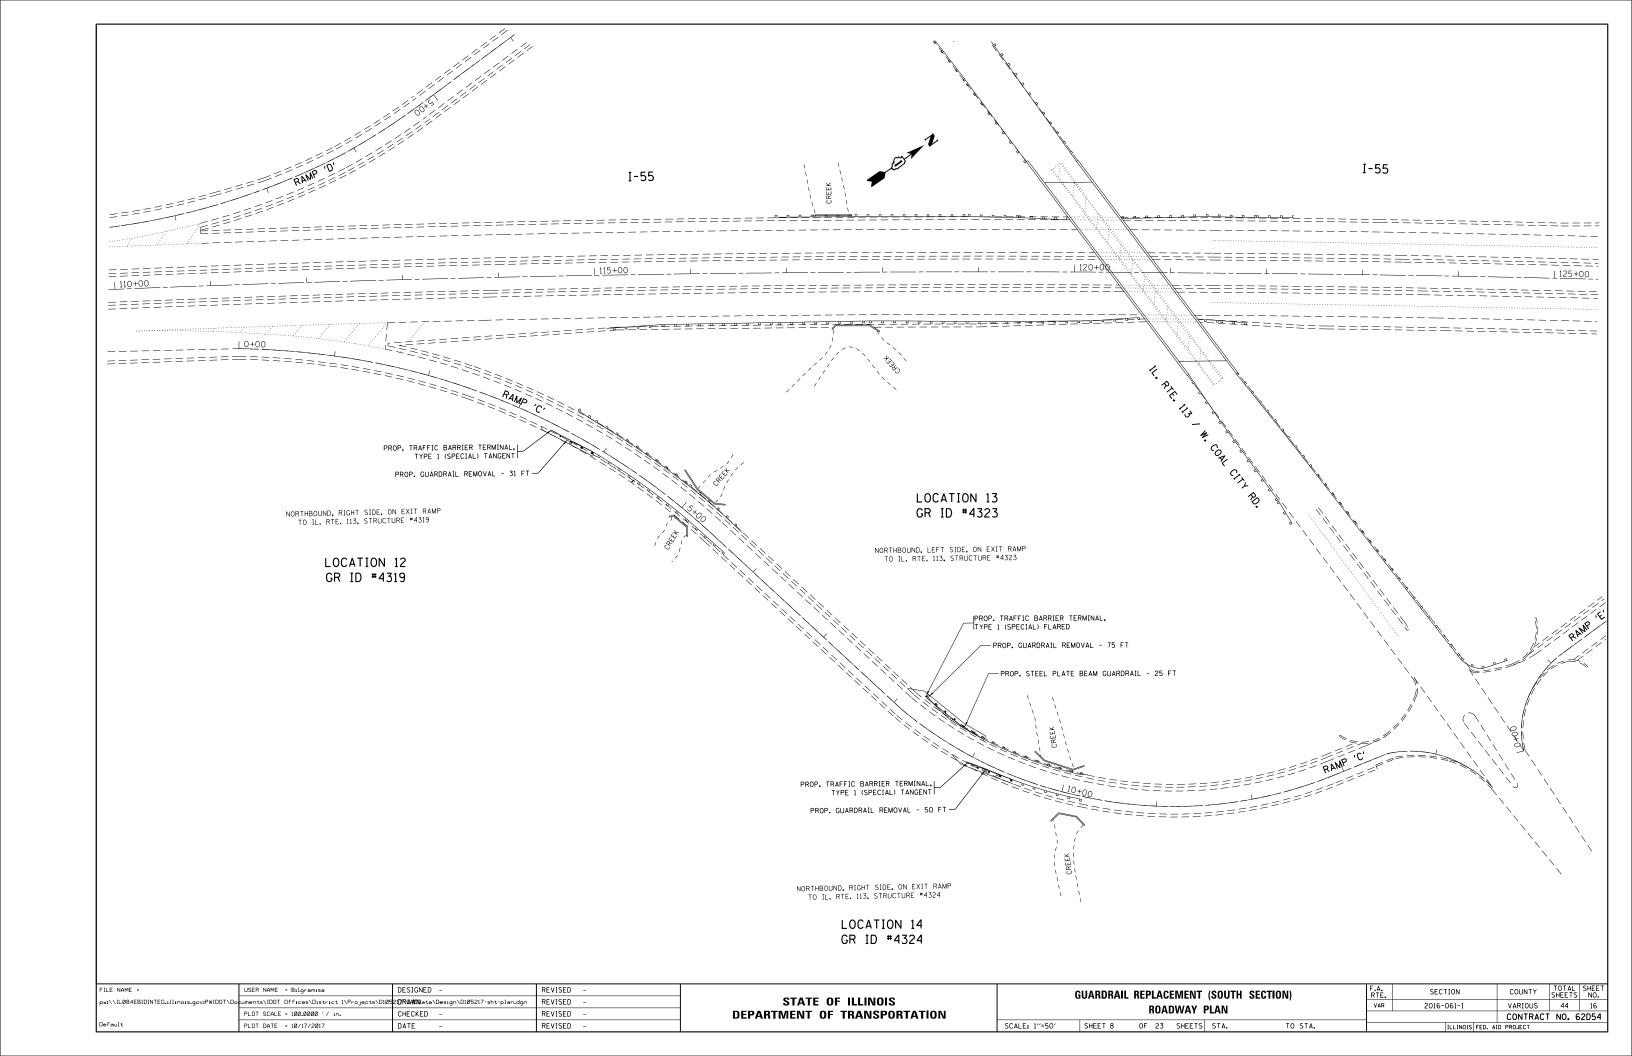


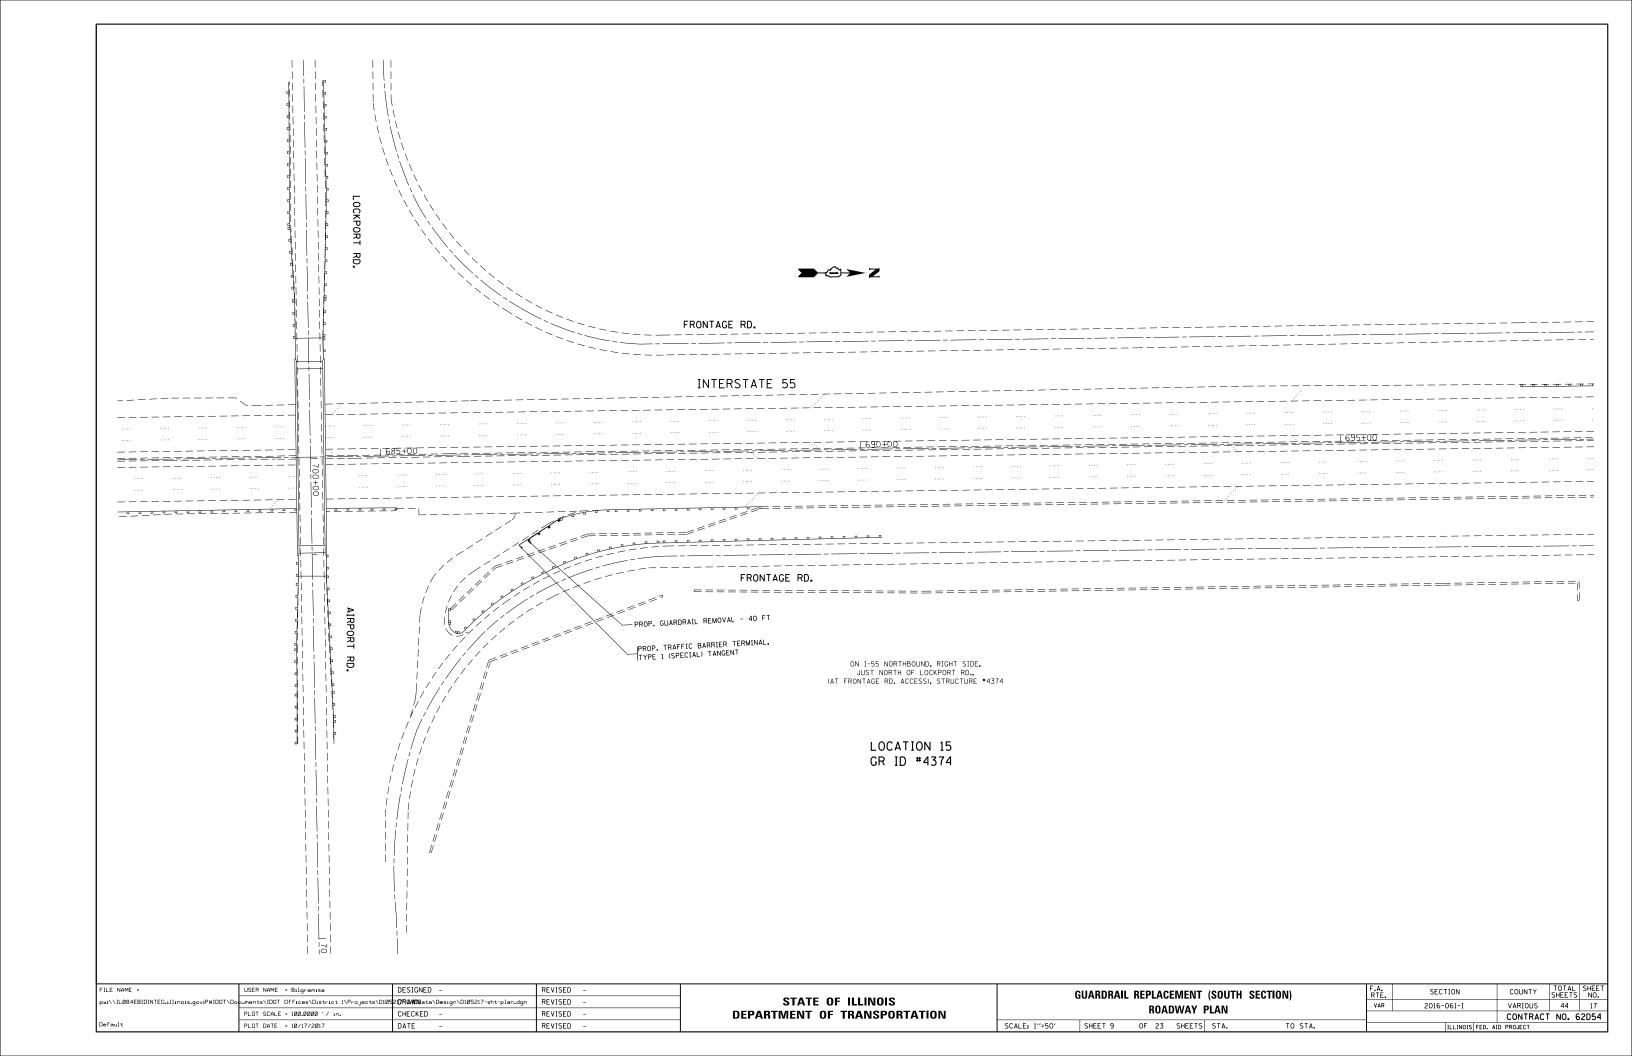


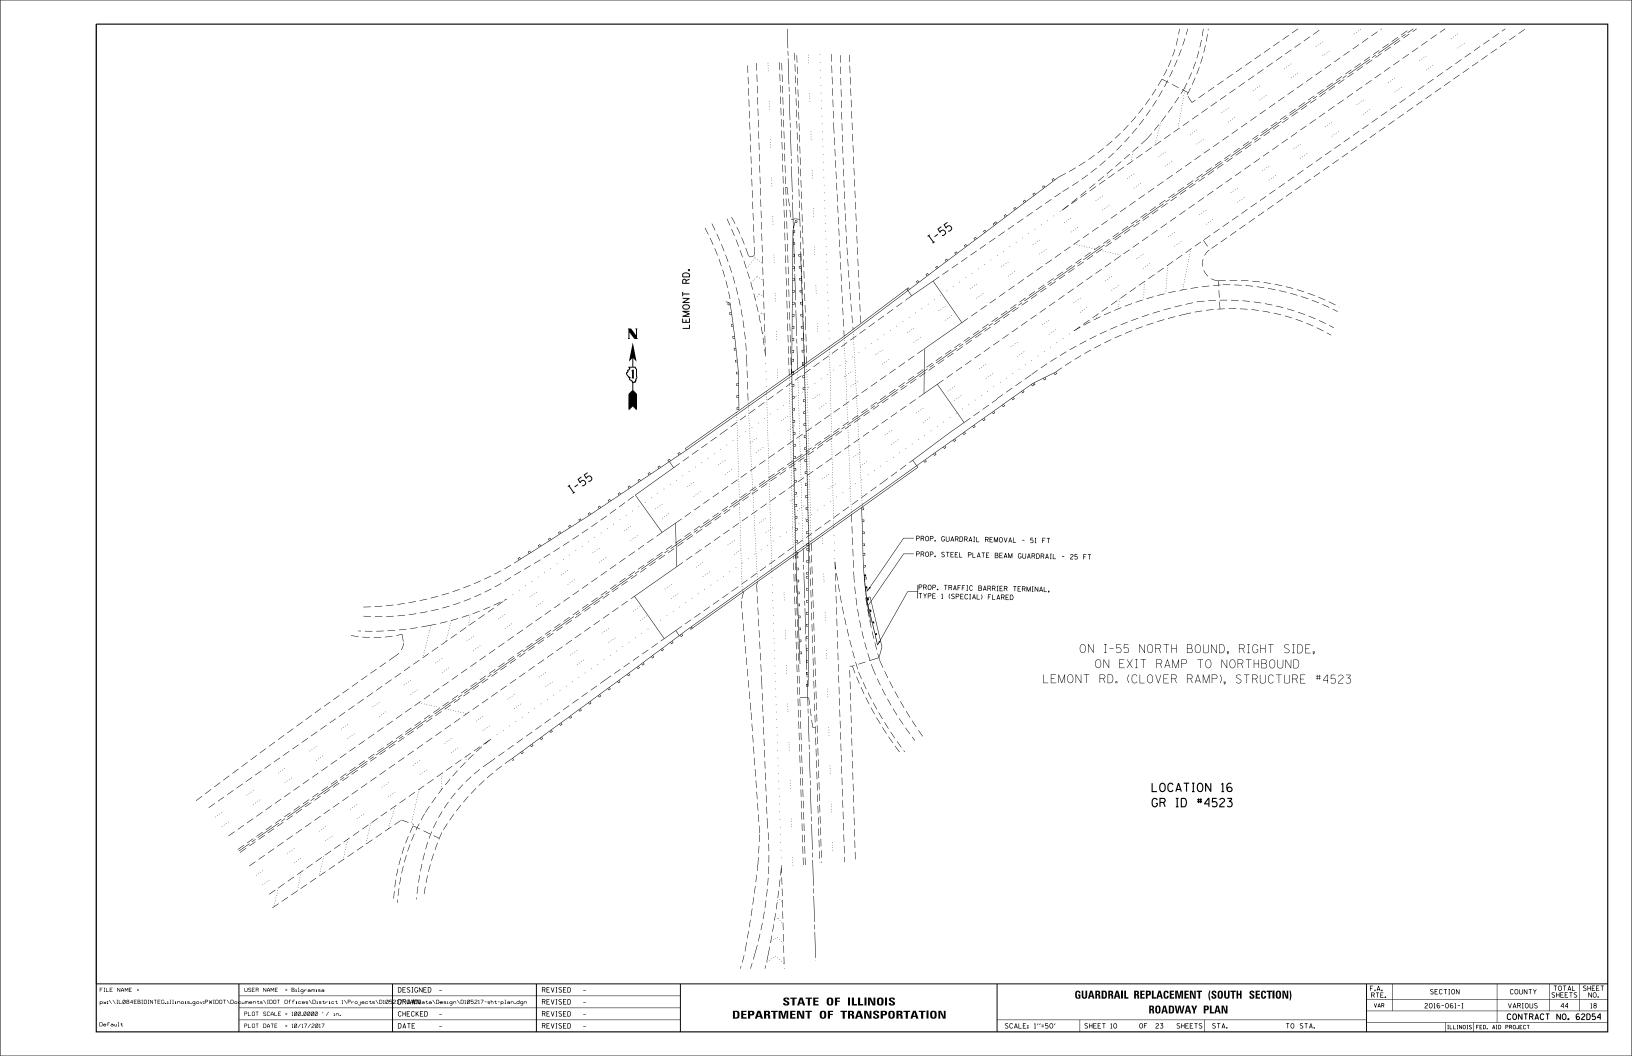

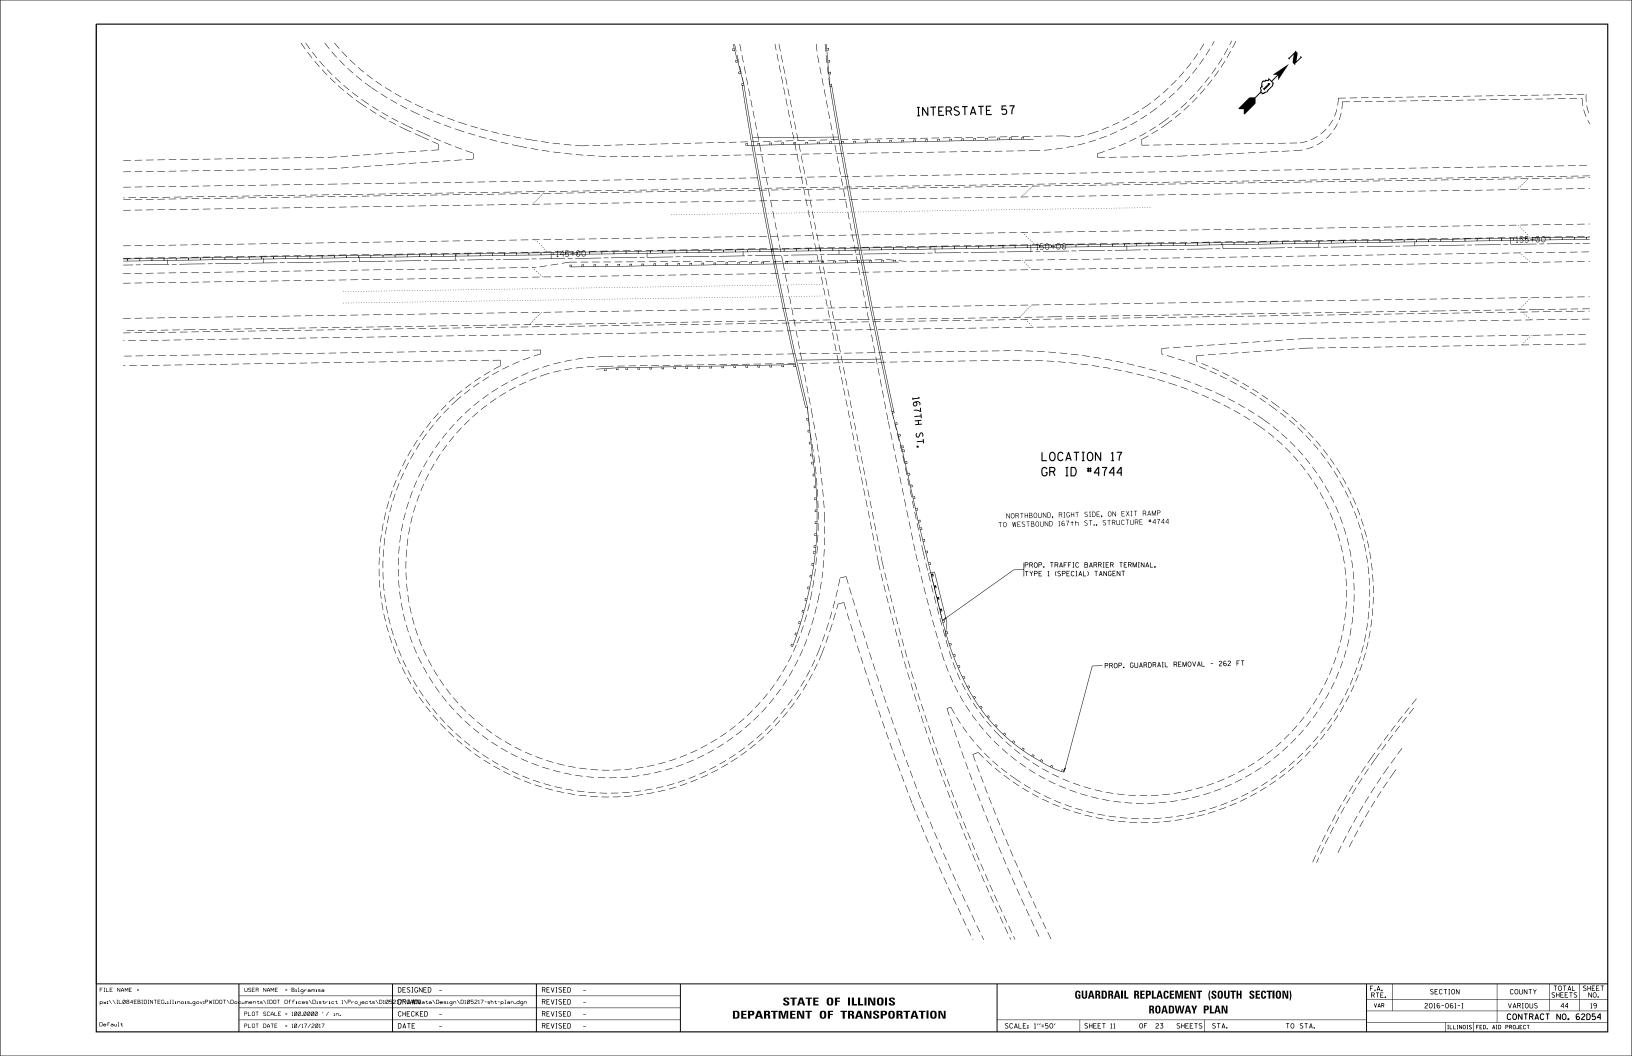


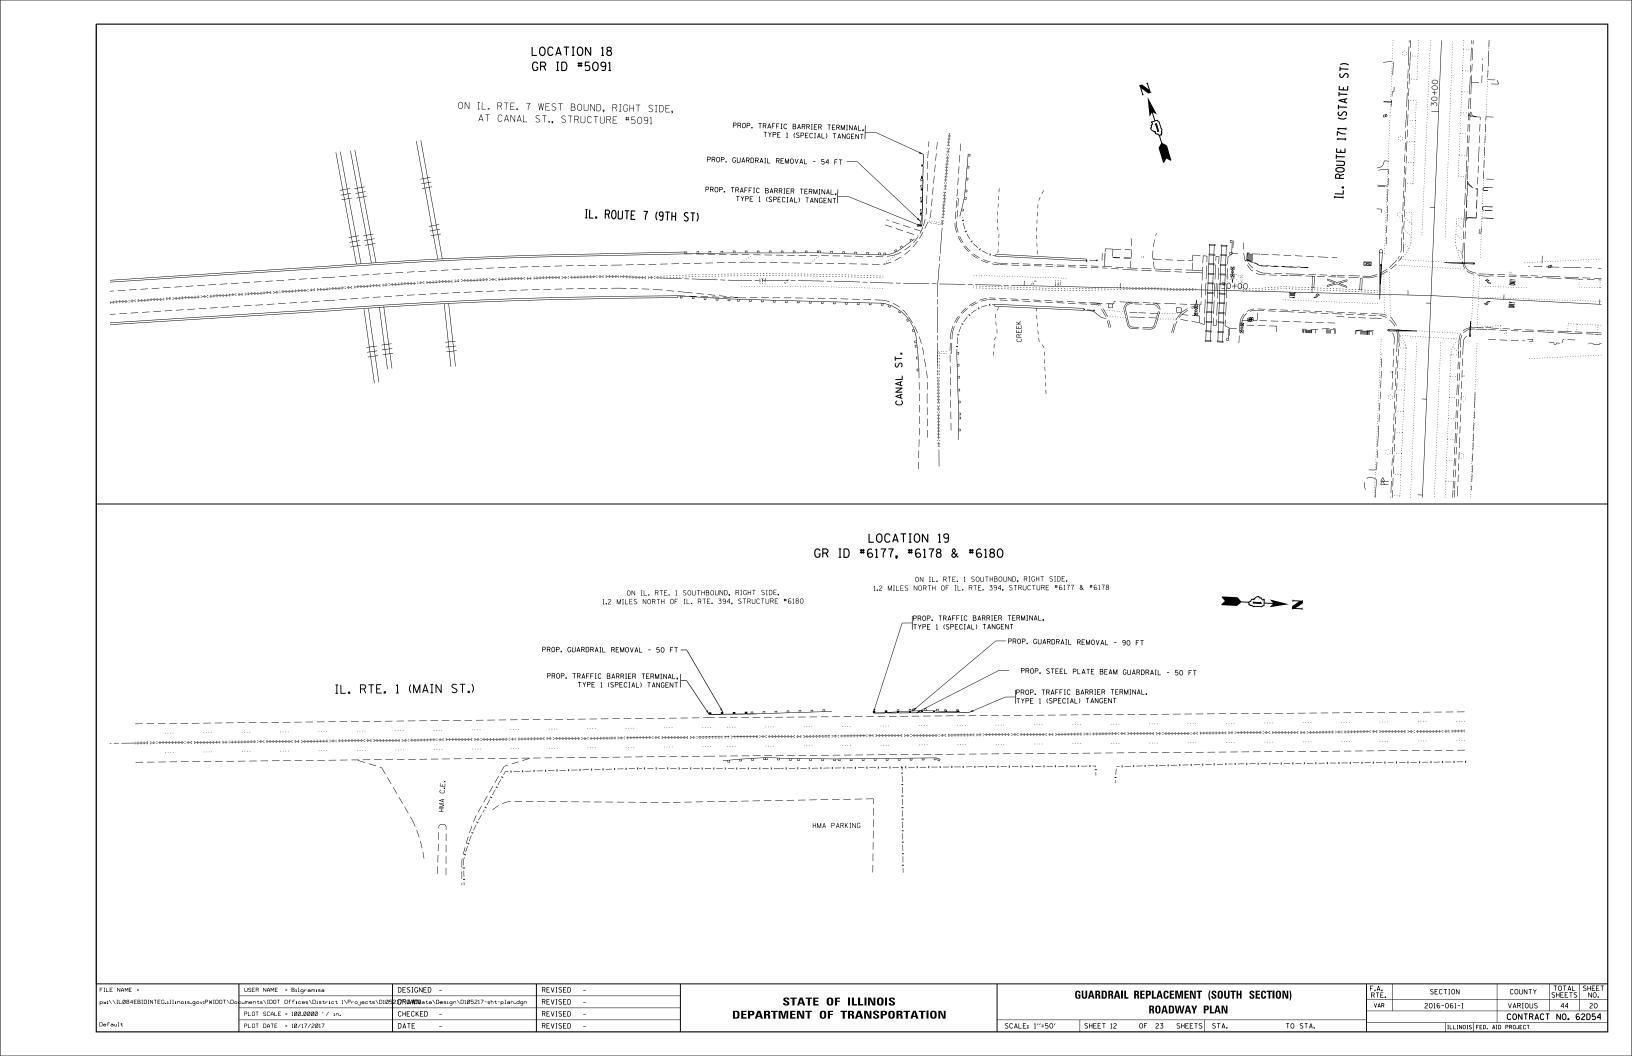

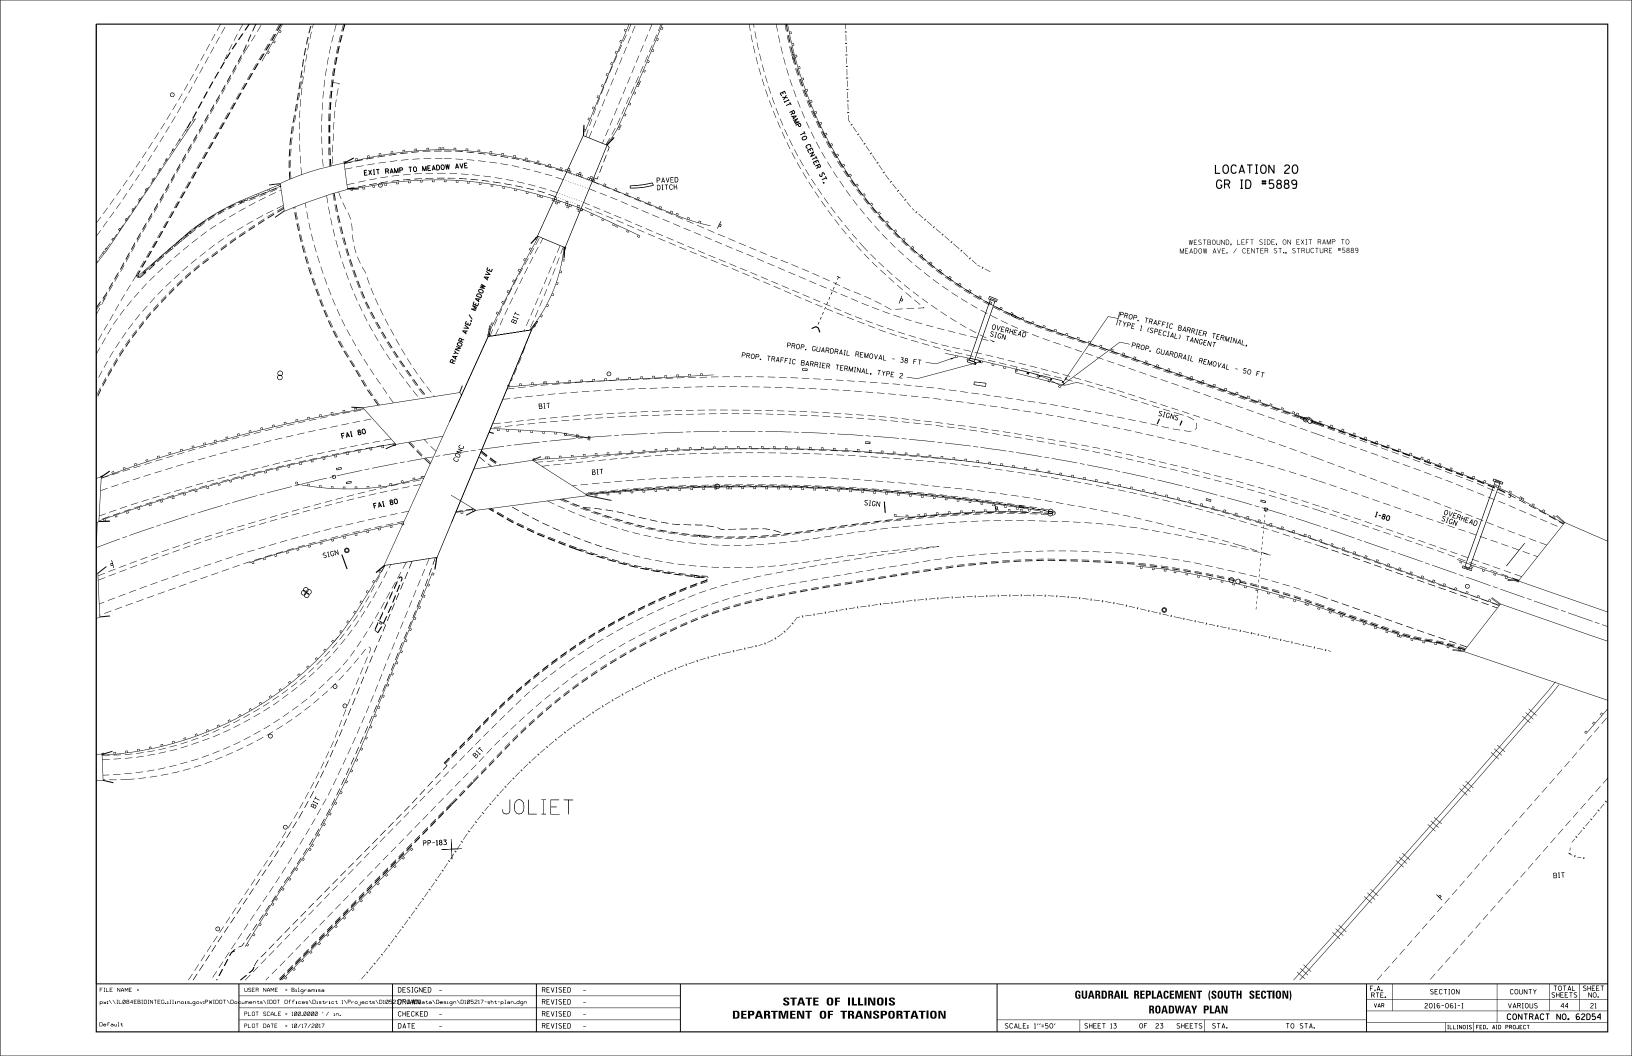

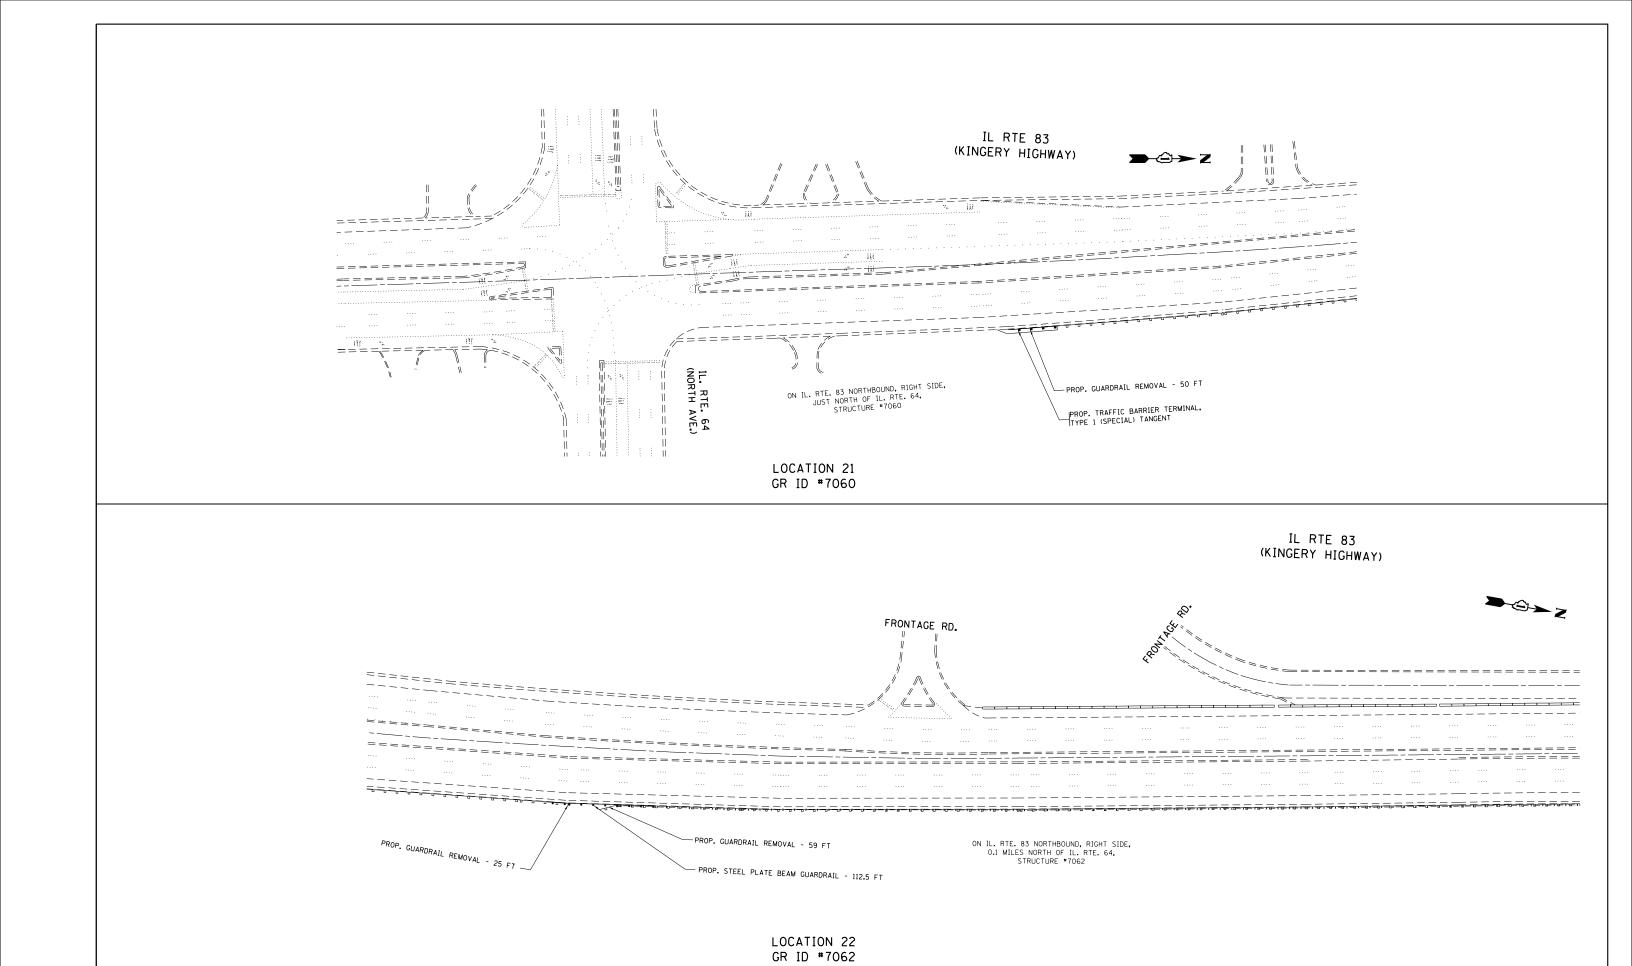



FILE NAME =	USER NAME = Bilgramisa	DESIGNED -	REVISED -		GUARDRAIL REPLACEMENT (SOUTH SECTION) ROADWAY PLAN SCALE: 1"=50" SHEET 14 OF 23 SHEETS STA. TO STA.	SECTION)	F.A.	SECTION	COUNTY	TOTAL	SHEET				
pw:\\ILØ84EBIDINTEG.:111:nois.gov:PWIDOT\	Ocuments\IDOT Offices\District 1\Projects\D10	521 7R@WIN ata\Design\D105217-sht-plan.dgn	REVISED -	STATE OF ILLINOIS		,,,,,,,,,,,,,,,,,,,,,,,,,,,,,,,,,,,,,,,	VAR	2016-061-I	VARIOUS	44	22				
	PLOT SCALE = 100.0000 '/ in.	CHECKED -	REVISED -	DEPARTMENT OF TRANSPORTATION					CONTRAC	T NO.	62D54				
Default	PLOT DATE = 10/17/2017	DATE -	REVISED -		SCALE: 1"=50"	SHEET 14	OF 23	3 SHEET	S STA.	TO STA.		ILLINOIS FED.	AID PROJECT		
												•			

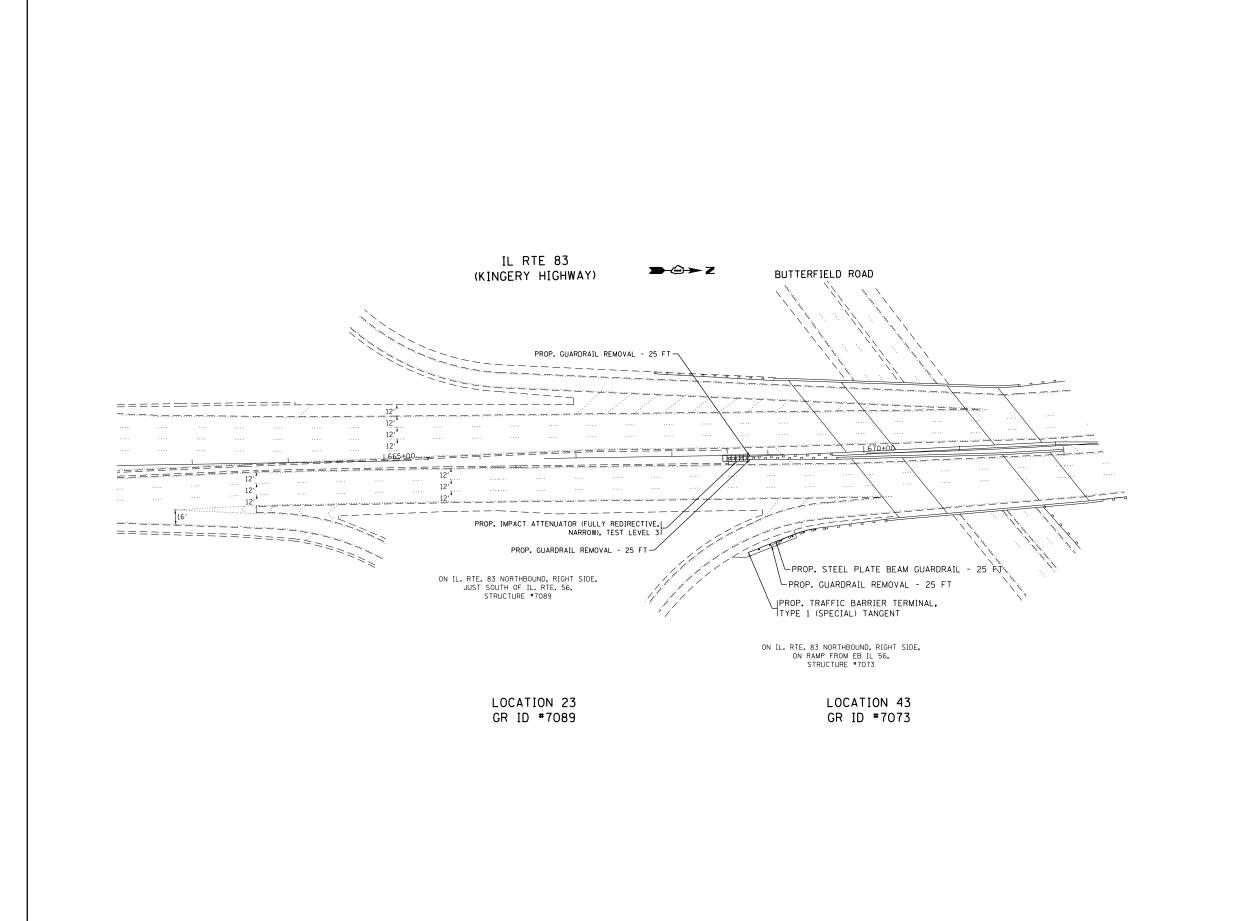



COUNTY TOTAL SHEET NO.


VARIOUS 44 23 FILE NAME = DESIGNED -REVISED USER NAME = Bilgramisa SECTION **GUARDRAIL REPLACEMENT (SOUTH SECTION)** STATE OF ILLINOIS ow:\\ILØ84EBIDINTEG.:llino: ov:PWIDOT\Documents\IDOT Offices\District 1\Projects\D105217RWMM9ata\Design\D105217-sht-plan.dgn REVISED 2016-061-I **ROADWAY PLAN** PLOT SCALE = 100.0000 '/ in. CHECKED -REVISED **DEPARTMENT OF TRANSPORTATION** CONTRACT NO. 62D54 REVISED SCALE: 1"=50" SHEET 15 OF 23 SHEETS STA. TO STA. PLOT DATE = 10/17/2017 DATE

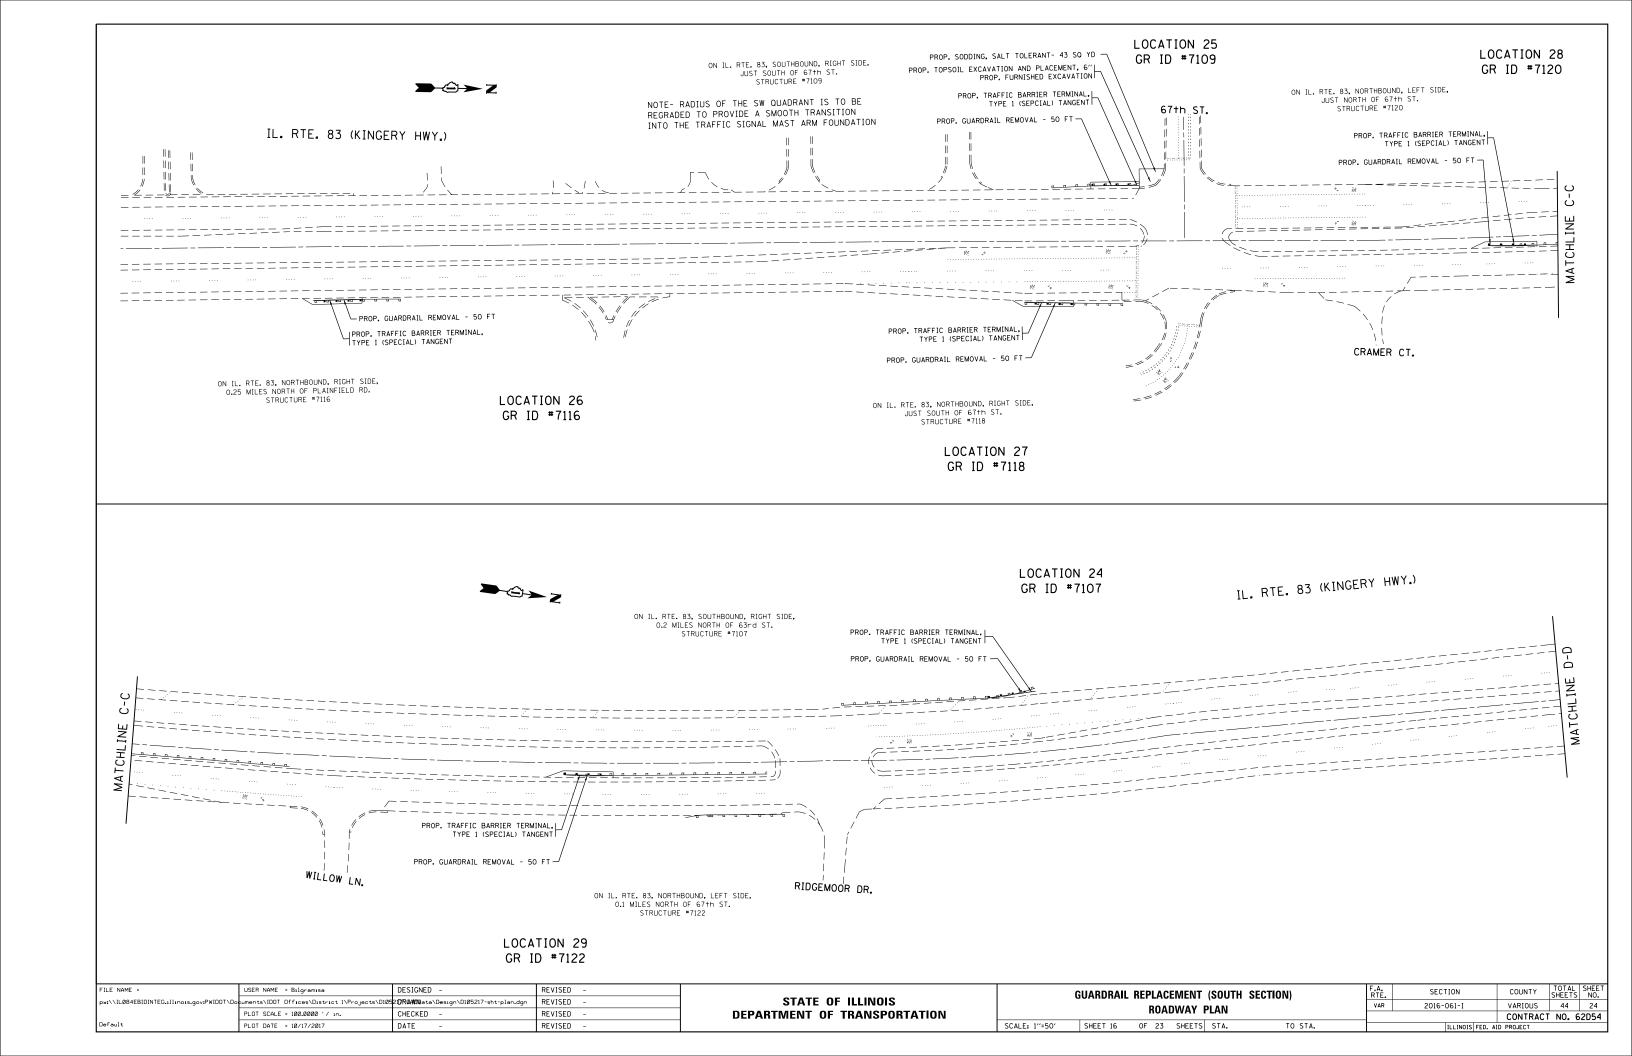

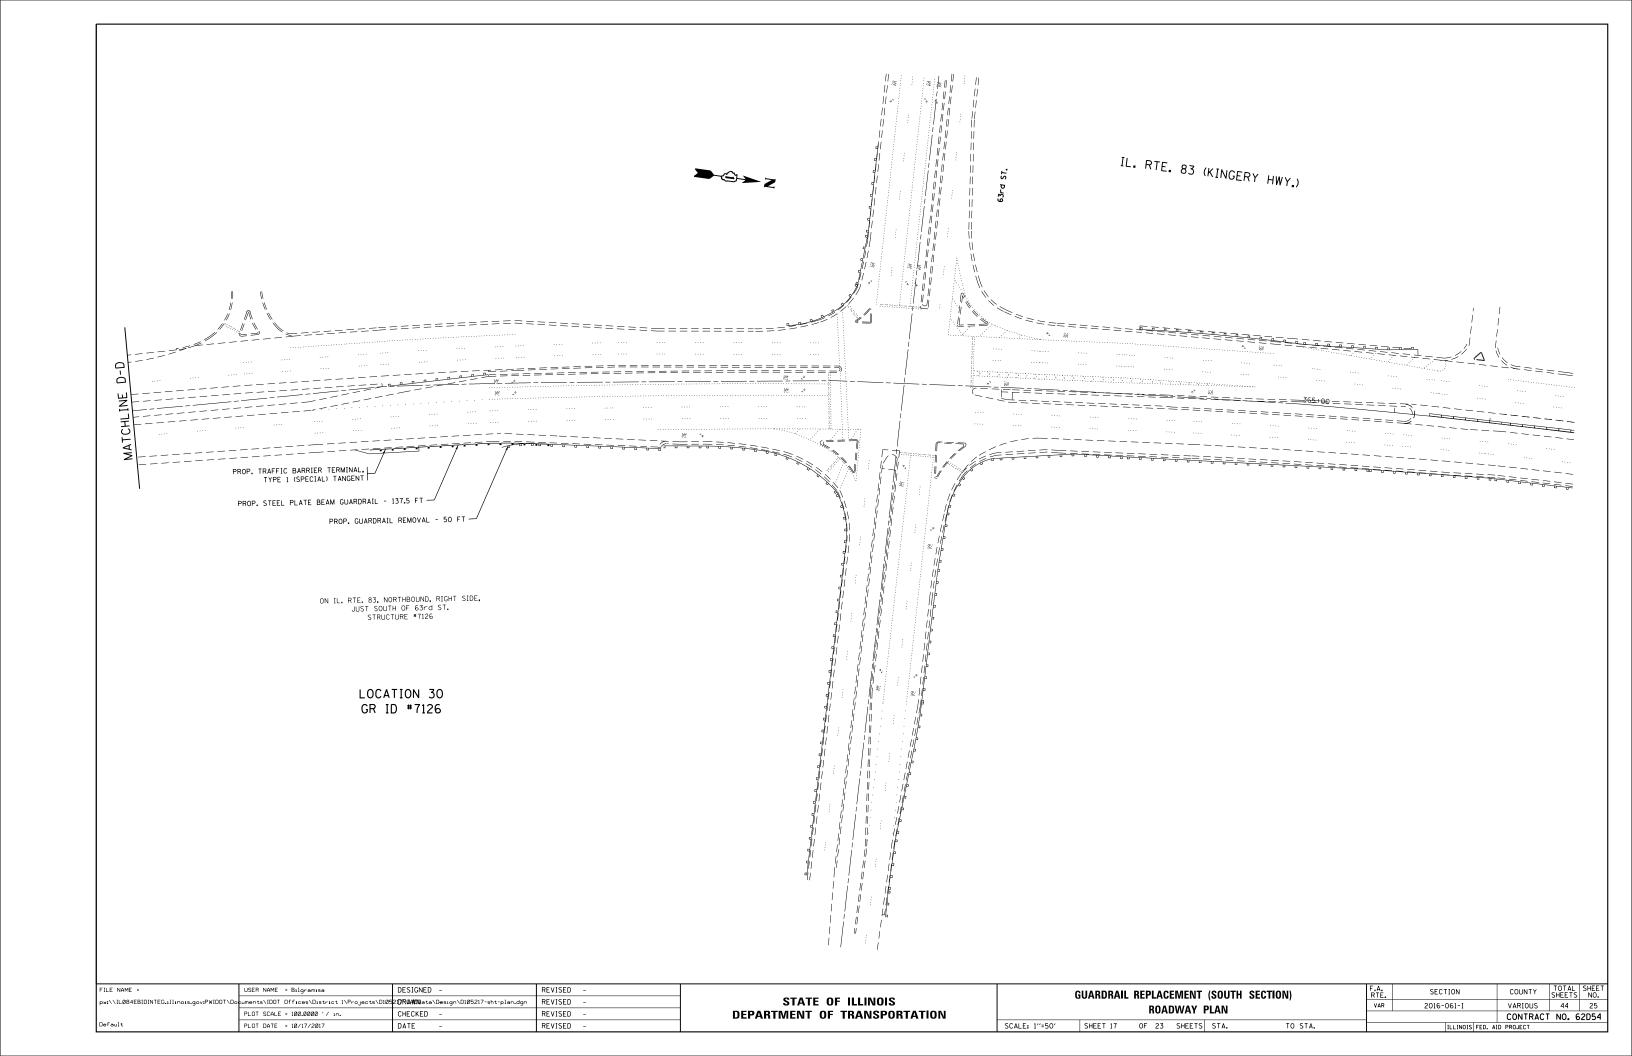

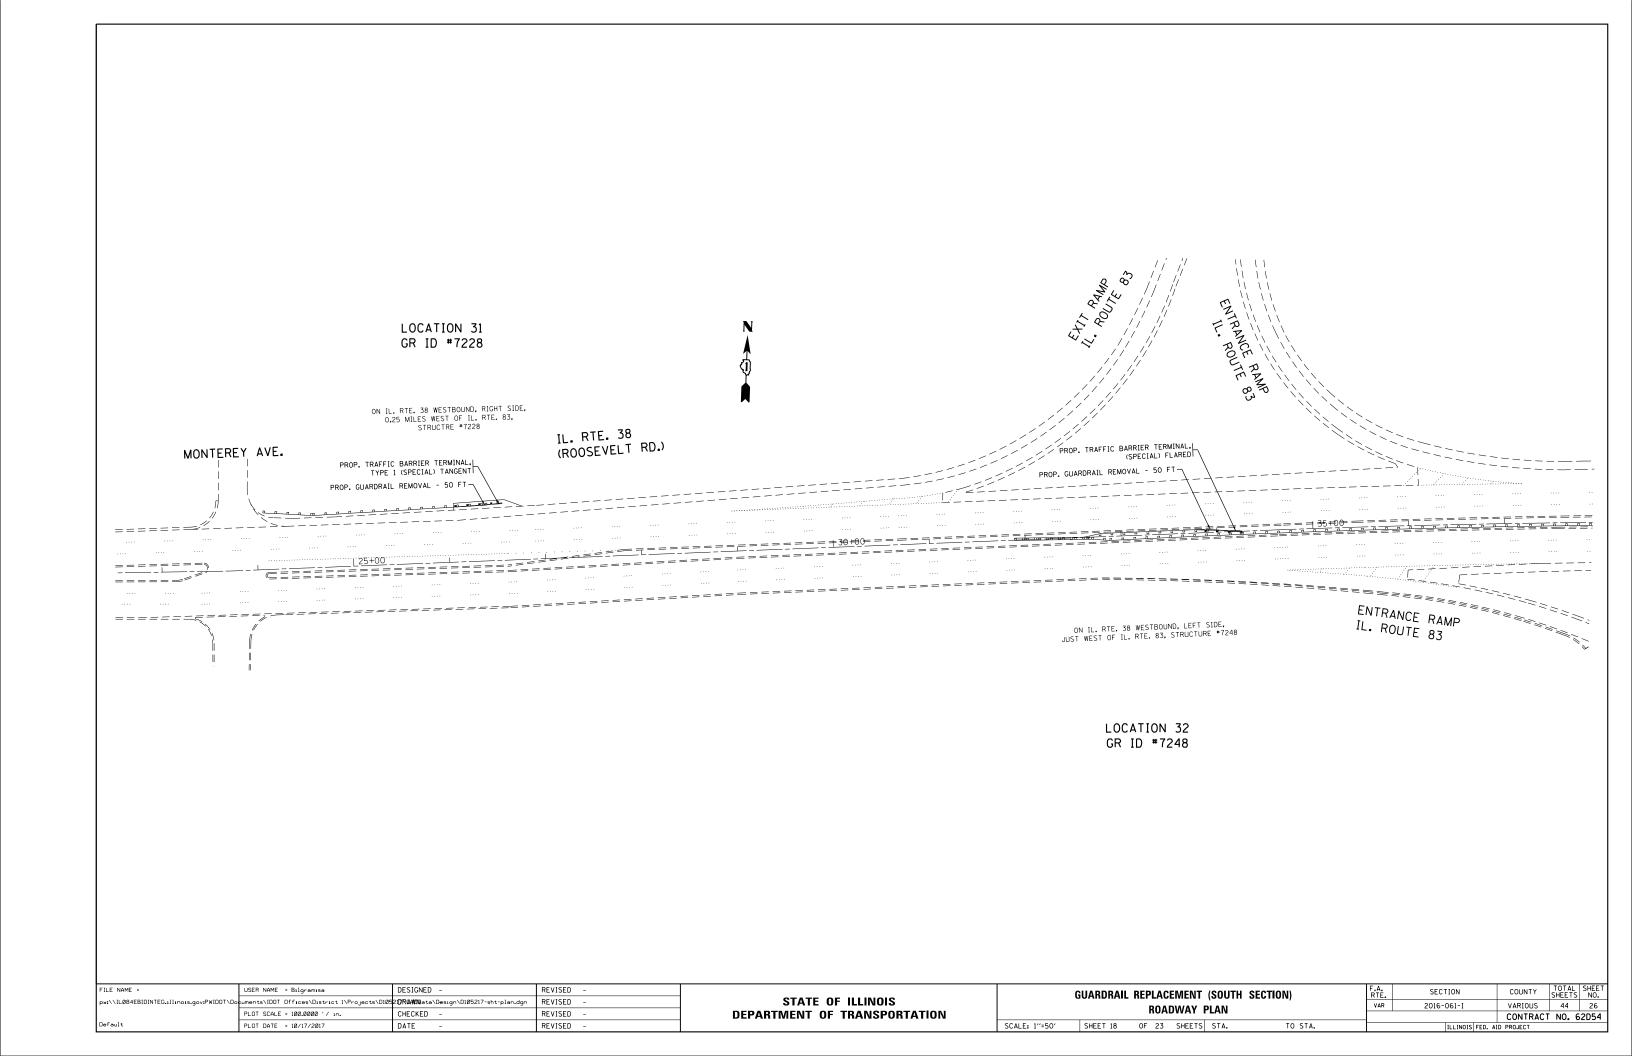


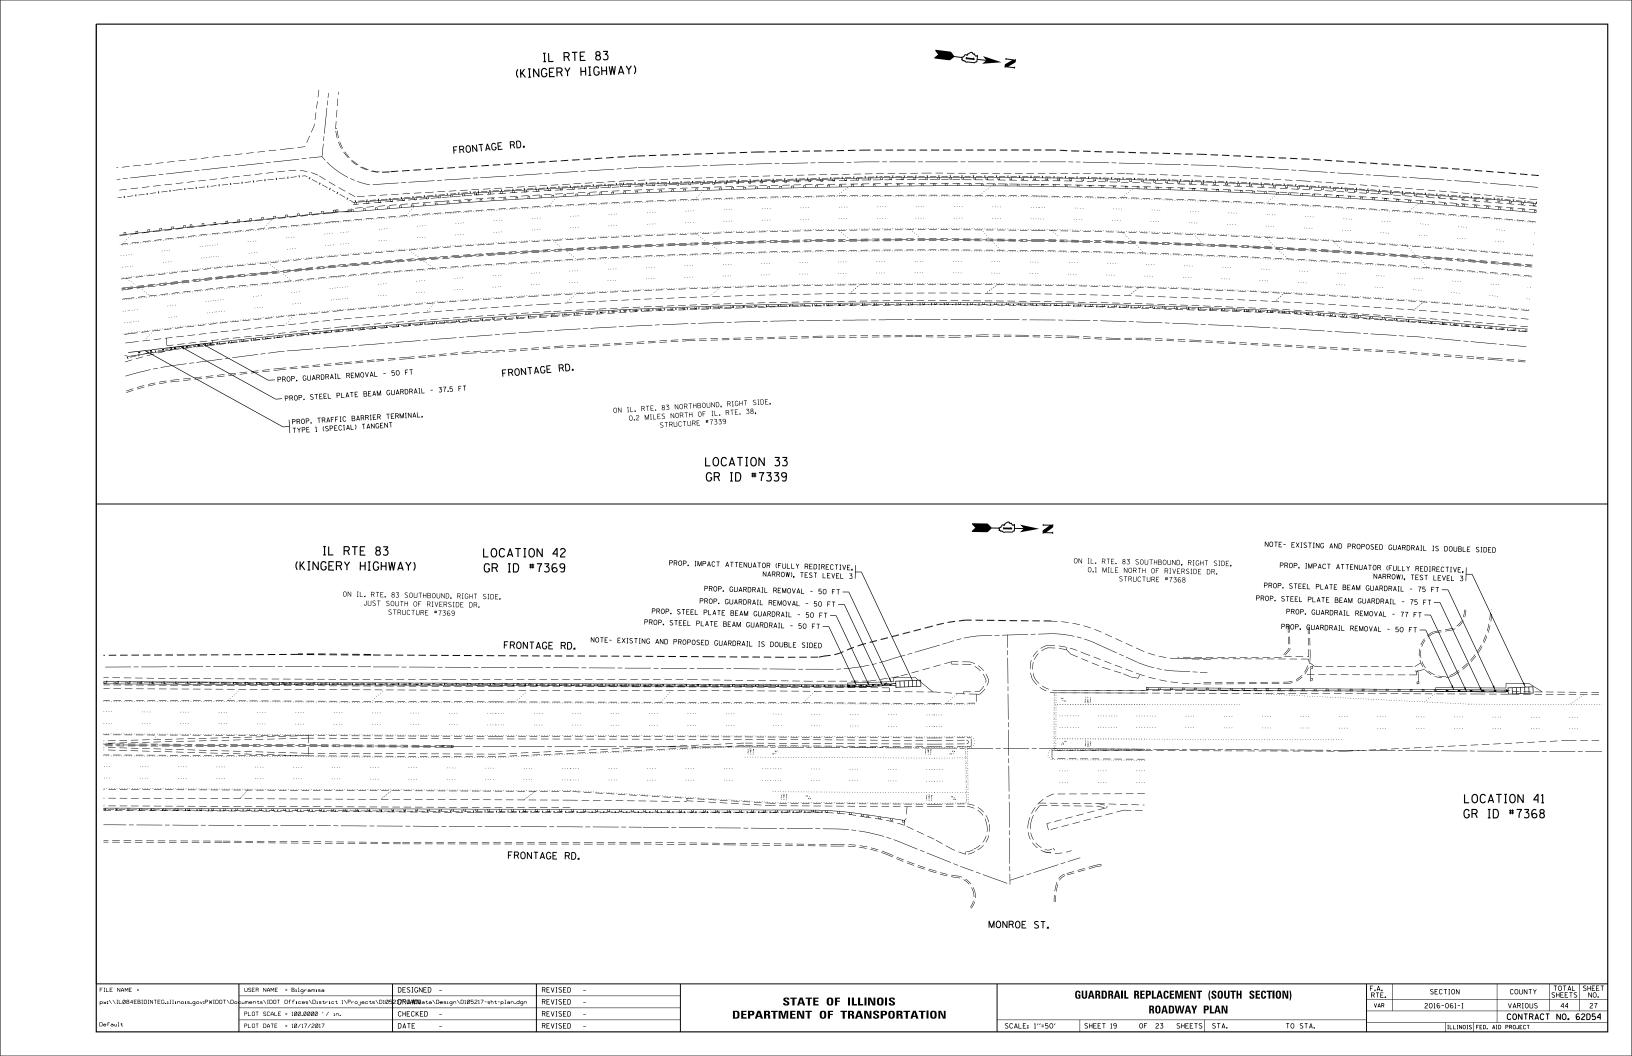


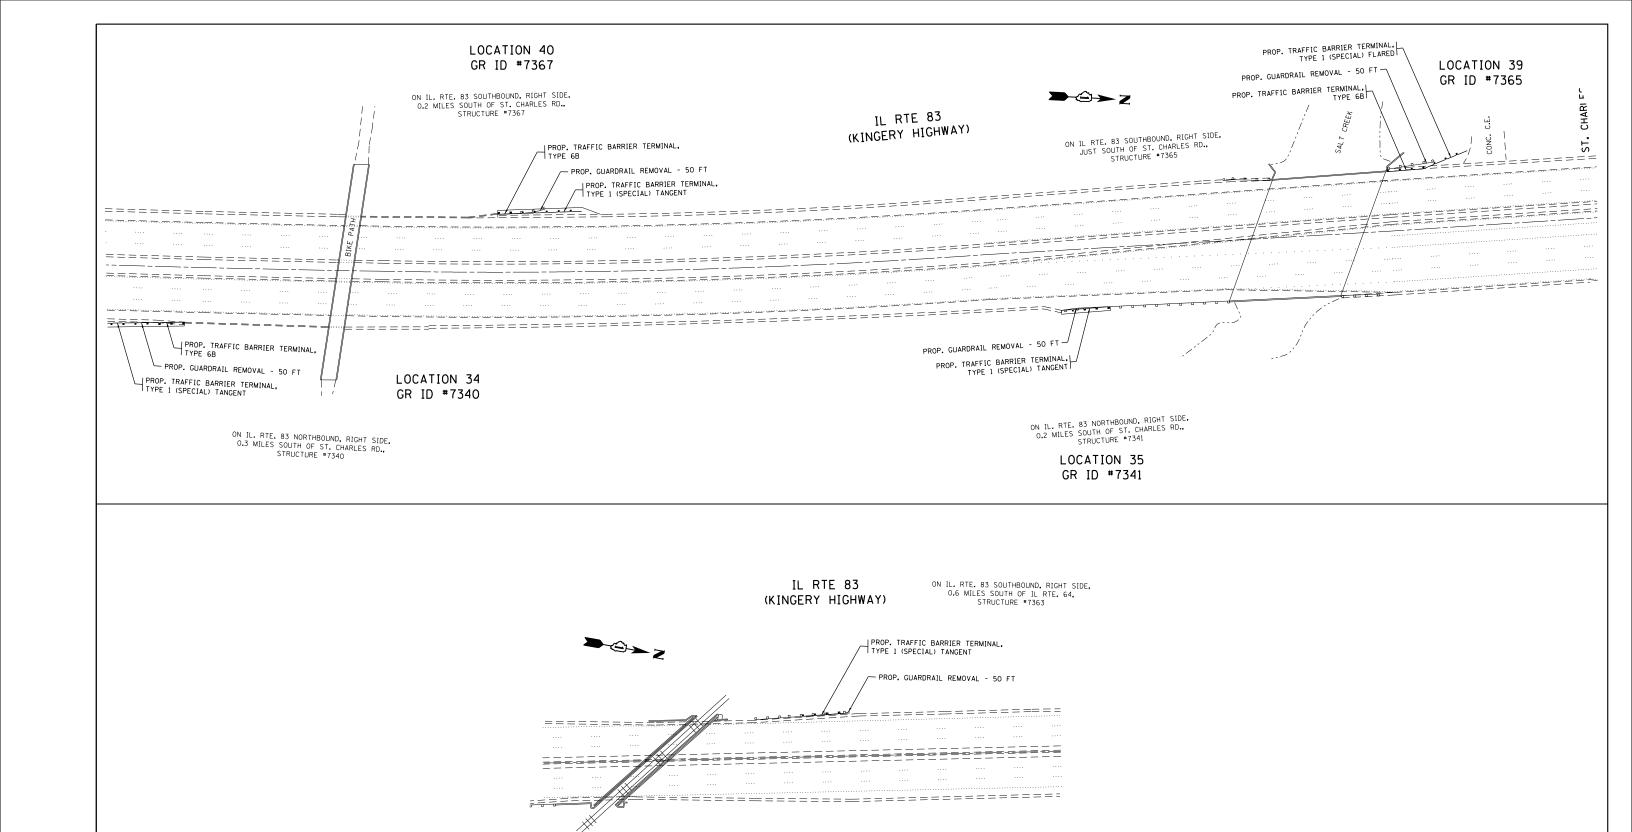


LOCATION 38 GR ID #7363

I	Default	PLOT DATE = 10/17/2017	DATE -	REVISED -		SCALE: 1"=50"	SHEET 20	OF 23 SHEE	TS STA.	TO STA.		ILLINOIS FED. A	ID PROJECT		
		PLOT SCALE = 100.0000 ' / in.	CHECKED -	REVISED -	DEPARTMENT OF TRANSPORTATION								CONTRACT	NO. 62D	54
	pw:\\IL084EBIDINTEG.:llinois.gov:PWIDOT\Do	cuments\IDOT Offices\District 1\Projects\Di05	DRAMONata\Design\D105217-sht-plan.dgn	REVISED -	STATE OF ILLINOIS	·	JOANDHAIL	ROADWAY	•	LOTION	VAR	2016-061-I	VARIOUS	44	28
	FILE NAME =	USER NAME = Bilgramisa	DESIGNED -	REVISED -		G	SIIARDRAII I	REPLACEMEN	IT (SOUTH SI		F.A.	SECTION	COUNTY	TOTAL SH SHEETS N	EET

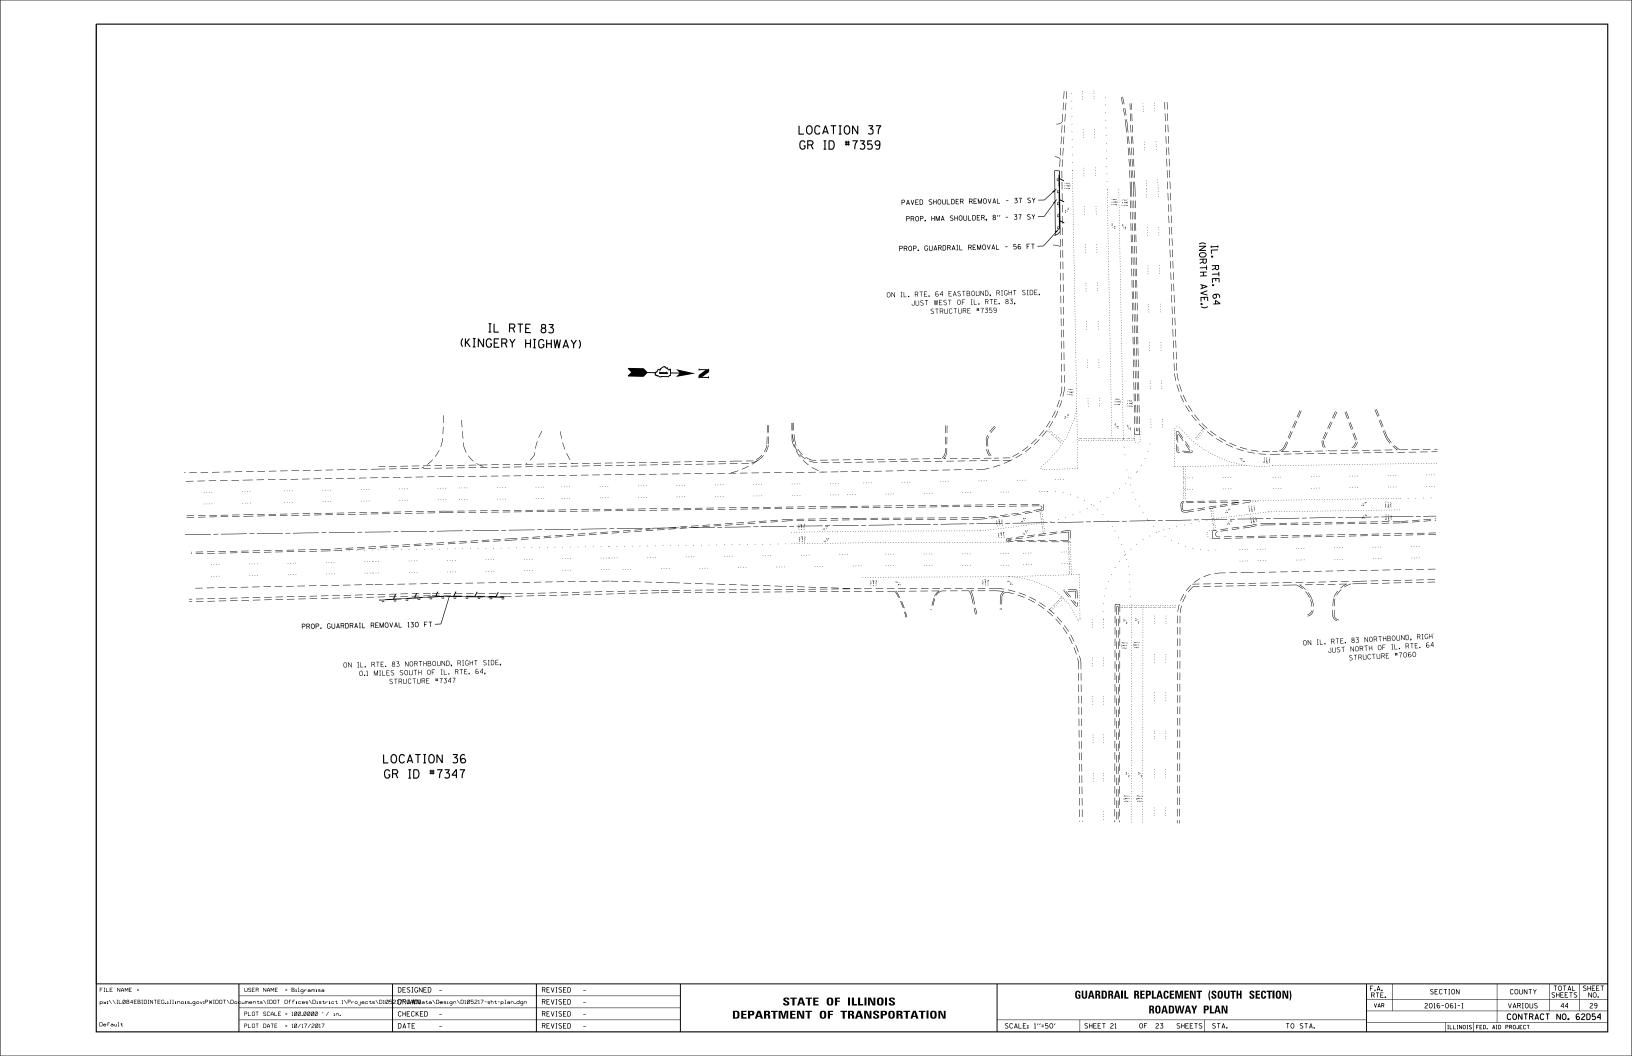


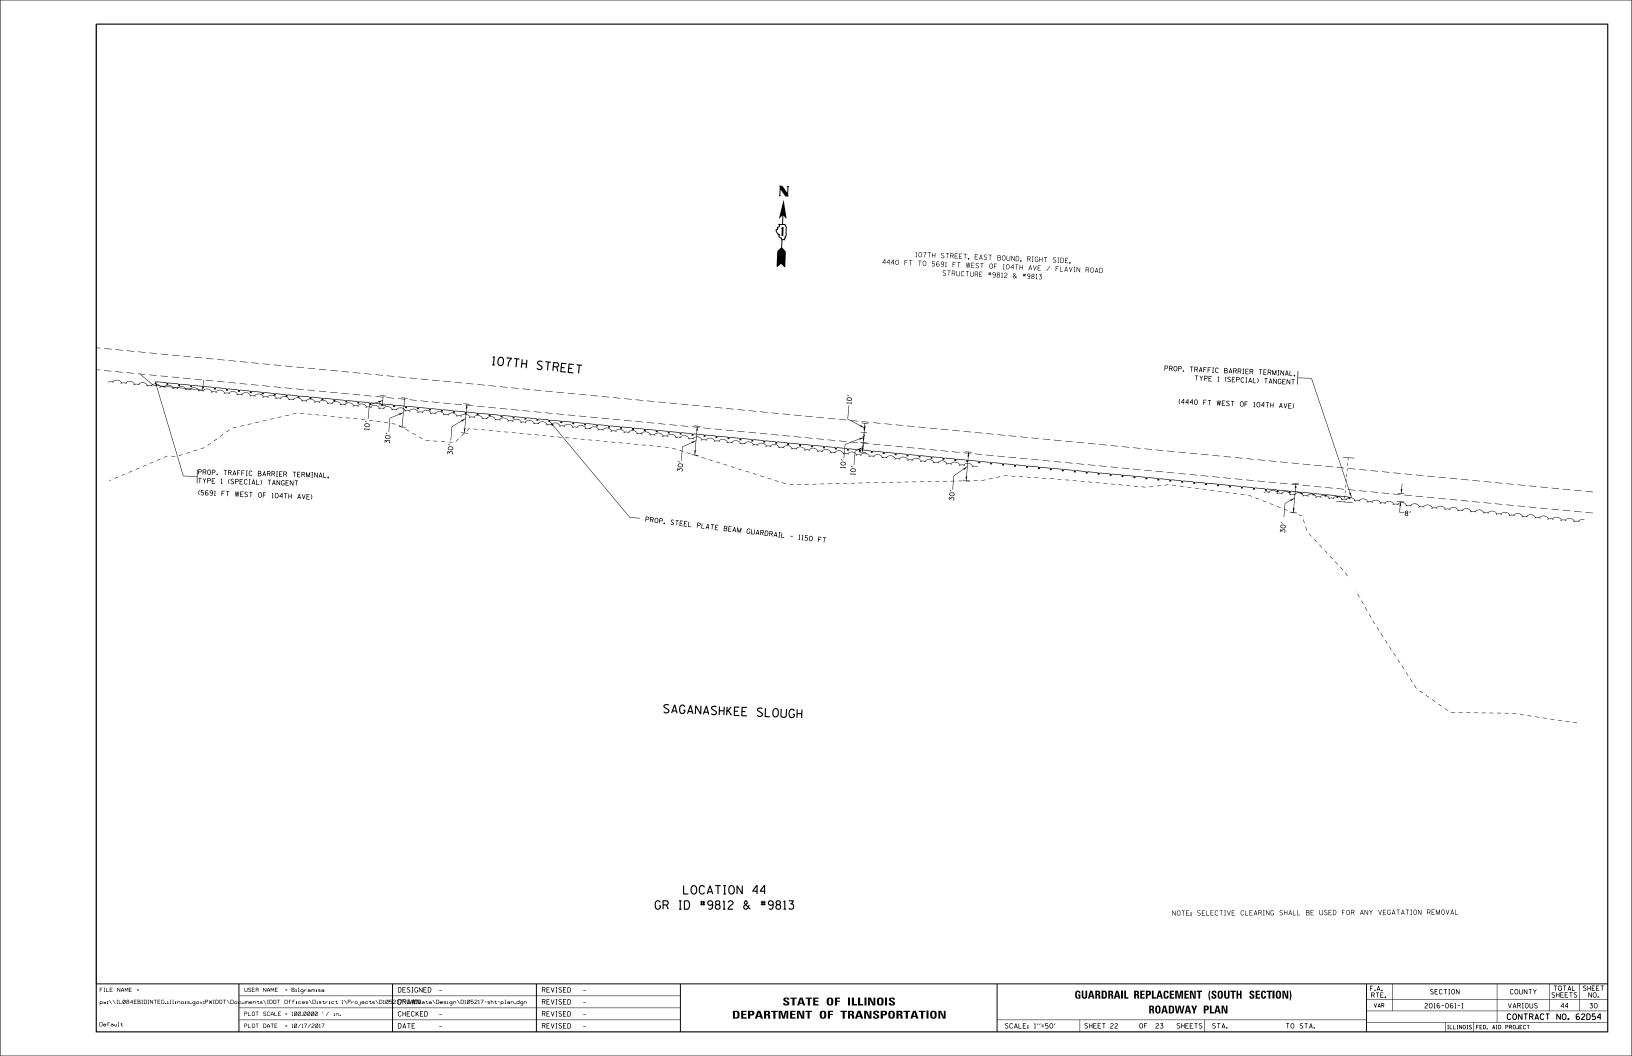

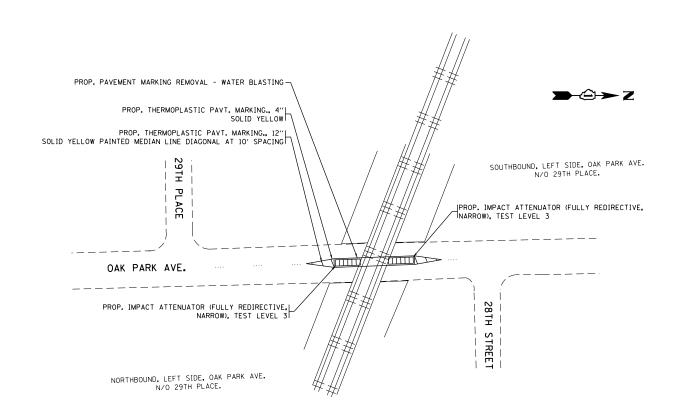

LOCATION 45

FILE NAME =	USER NAME = Bilgramisa	DESIGNED -	REVISED -		GI	ΠΔRDRΔΙΙ	REPLACEN	IFNIT	SOUTH SECTION	I)	F.A.	SECTION	COUNTY	TOTAL	SHEET
pw:\\IL084EBIDINTEG.:111:nois.gov:PWIDOT\Do	cuments\IDOT Offices\District 1\Projects\Di	052 17RAANIN ata\Design\D105217-sht-plan.dgn	REVISED -	STATE OF ILLINOIS		OAIIDIIAIL	ROADW		<u>.</u>	-,	VAR	2016-061-I	VARIOUS	44	31
	PLOT SCALE = 100.0000 '/ in.	CHECKED -	REVISED -	DEPARTMENT OF TRANSPORTATION			RUADW	AT P	LAN				CONTRAC	JT NO. F	2D54
Default	PLOT DATE = 10/17/2017	DATE -	REVISED -		SCALE: 1"=50"	SHEET 23	0F 23 SI	HEETS	STA.	TO STA.		ILLINOIS FED. A	ID PROJECT		

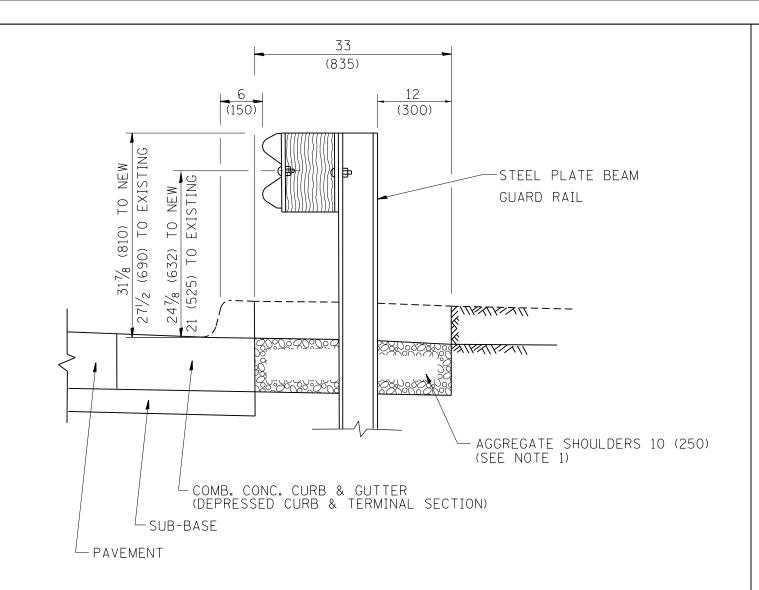


SECTION A-A

- NOTES: 1. THE AGGREGATE SHOULDER, 10" OR HMA SHOULDER, 6" (IF REQUIRED) SHALL EXTEND UNDER THE TRAFFIC BARRIER TERMINAL.
 - 2. "EXISTING" GUARDRAIL REFERS TO CONNECTING TERMINAL SECTION TO GUARD RAILING PRIOR TO THE MIDWEST GUARDRAIL SYSTEM.
 - 3. THE CONTRACTOR SHALL VERIFY THE TYPE/HEIGHT OF GUARDRAIL IN-PLACE BEFORE ORDERING THE NEW TERMINAL SECTION. COST INCLUDED WITH THE COST OF THE TERMINAL. THE TERMINAL SECTION HEIGHT TO BE PLACED MUST MATCH THE HEIGHT OF THE IN-PLACE GUARDRAIL.

DETAILS FOR STEEL PLATE BEAM

GUARD RAIL ADJACENT TO CURB AND GUTTER

[FOR ROADWAY SPEED 35 MPH (60 kmh) TO 45 MPH (70 kmh)]

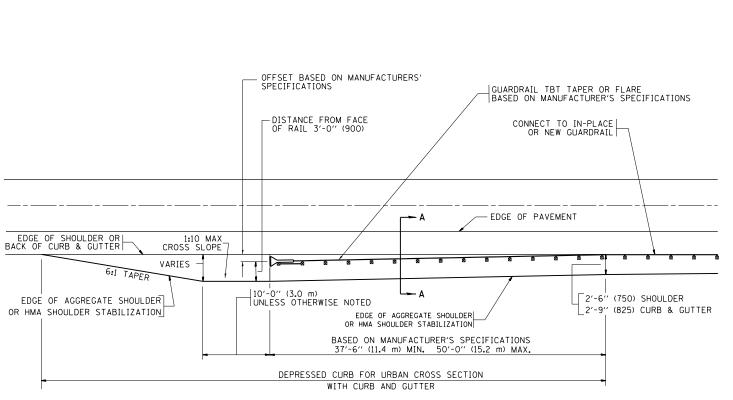

DEPRESSED CURB AND GUTTER AND SHOULDER TREATMENT AT TBT TY. 1 SPL.

BASIS OF PAYMENT: HMA SHOULDERS 6 (150) (IF REQUIRED) WILL BE

PAID FOR AT THE CONTRACT UNIT PRICE
PER SQUARE YARD (SQUARE METER) FOR
"HOT-MIX ASPHALT SHOULDERS 6" (150 mm)".

STEEL PLATE BEAM GUARD RAIL AND TRAFFIC BARRIER TERMINAL, OF THE TYPE SPECIFIED WILL BE PAID FOR SEPARATELY.

TBT = TRAFFIC BARRIER TERMINAL

ALL DIMENSIONS ARE IN INCHES (MILLIMETERS) UNLESS OTHERWISE SHOWN.

FILE NAME = USER NAME = Bilgramisa DESIGNED - M. DE YONG REVISED - E. COMEZ 08-28-00

pwi\\IL084EBIDINTEG.illinois.gov;PWIDDT\Documents\IDDT Offices\District \\Projects\D1082\D7R@MMDsta\Design\Districd.dgn REVISED - R. BORO 01-01-07


PLOT SCALE = 100.0000 '/ in. CHECKED - REVISED - R. BORO 09-14-2009


PLOT DATE = 10/17/2017 DATE - 09-22-90 REVISED - R. BORO 09-14-2009

STATE OF ILLINOIS
DEPARTMENT OF TRANSPORTATION


DETAILS FOR DEPRESSED CURB & GUTTER AND
SHOULDER TREATMENT AT TBT TY 1 SPL.

SCALE: NONE SHEET NO. 1 OF 1 SHEETS STA. TO STA.

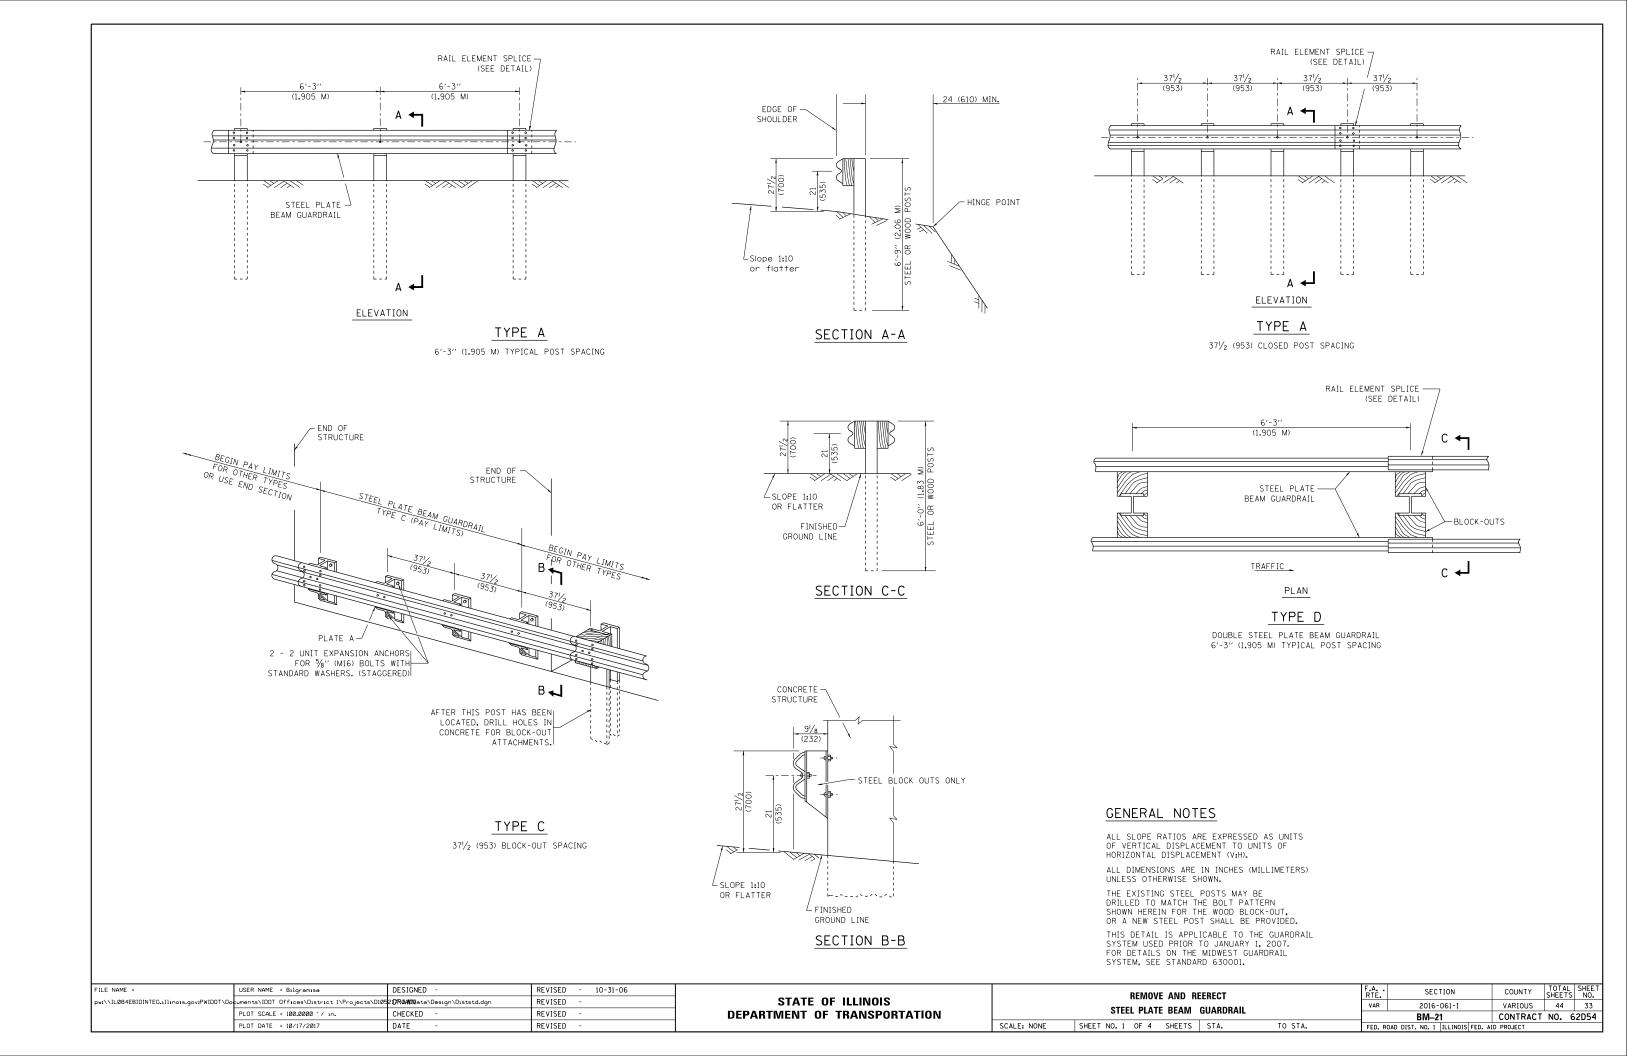

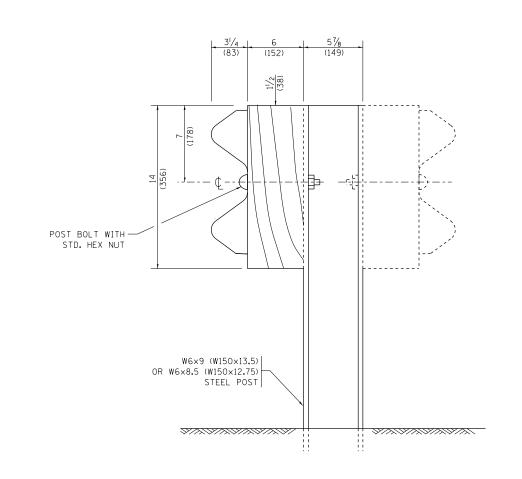


STEEL POST CONSTRUCTION

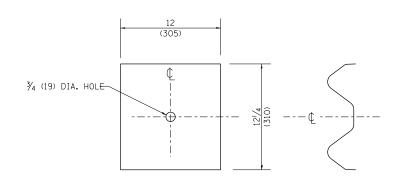


NOTE:

PLATE A SHALL BE PLACED BETWEEN RAIL ELEMENT AND BLOCK-OUT AT NON-SPLICE MOUNTING POINTS ONLY WHEN STEEL BLOCK-OUTS ARE USED.


PLATE A

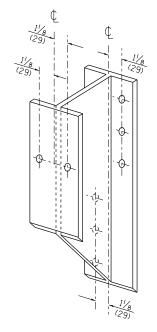

STEEL BLOCK-OUT DETAIL

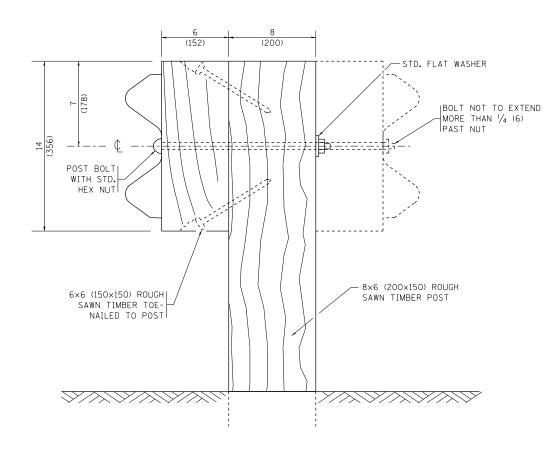



WOOD POST CONSTRUCTION

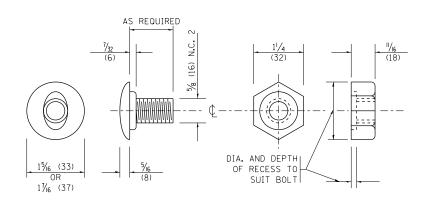


POST OR SPLICE BOLT & NUT

FILE NAME =	USER NAME = Bilgramisa	DESIGNED -	REVISED - 10-31-06			DEMOVE AND REEDECT		F.A	SECTION	COUNTY	TOTAL	SHEET NO.
pw:\\IL084EBIDINTEG.:llinois.gov:PWIDOT\Do	cuments\IDOT Offices\District 1\Projects\D1	052 :DRAMDN ata\Design\Diststd.dgn	REVISED -	STATE OF ILLINOIS				VAR	2016-061-I	VARIOUS	44	34
	PLOT SCALE = 100.0000 '/ in.	CHECKED -	REVISED -	DEPARTMENT OF TRANSPORTATION	REMOVE AND REERECT STEEL PLATE BEAM GUARDRAIL SCALE, NONE SHEET NO. 2 OF 4 SHEETS STA. TO STA.				BM-21	CONTRACT	NO. f	2D54
	PLOT DATE = 10/17/2017	DATE -	REVISED -		SCALE: NONE	SHEET NO. 2 OF 4 SHEETS STA.	TO STA.	FED. ROAD	DIST. NO. 1 ILLINOIS FED. AI	D PROJECT		

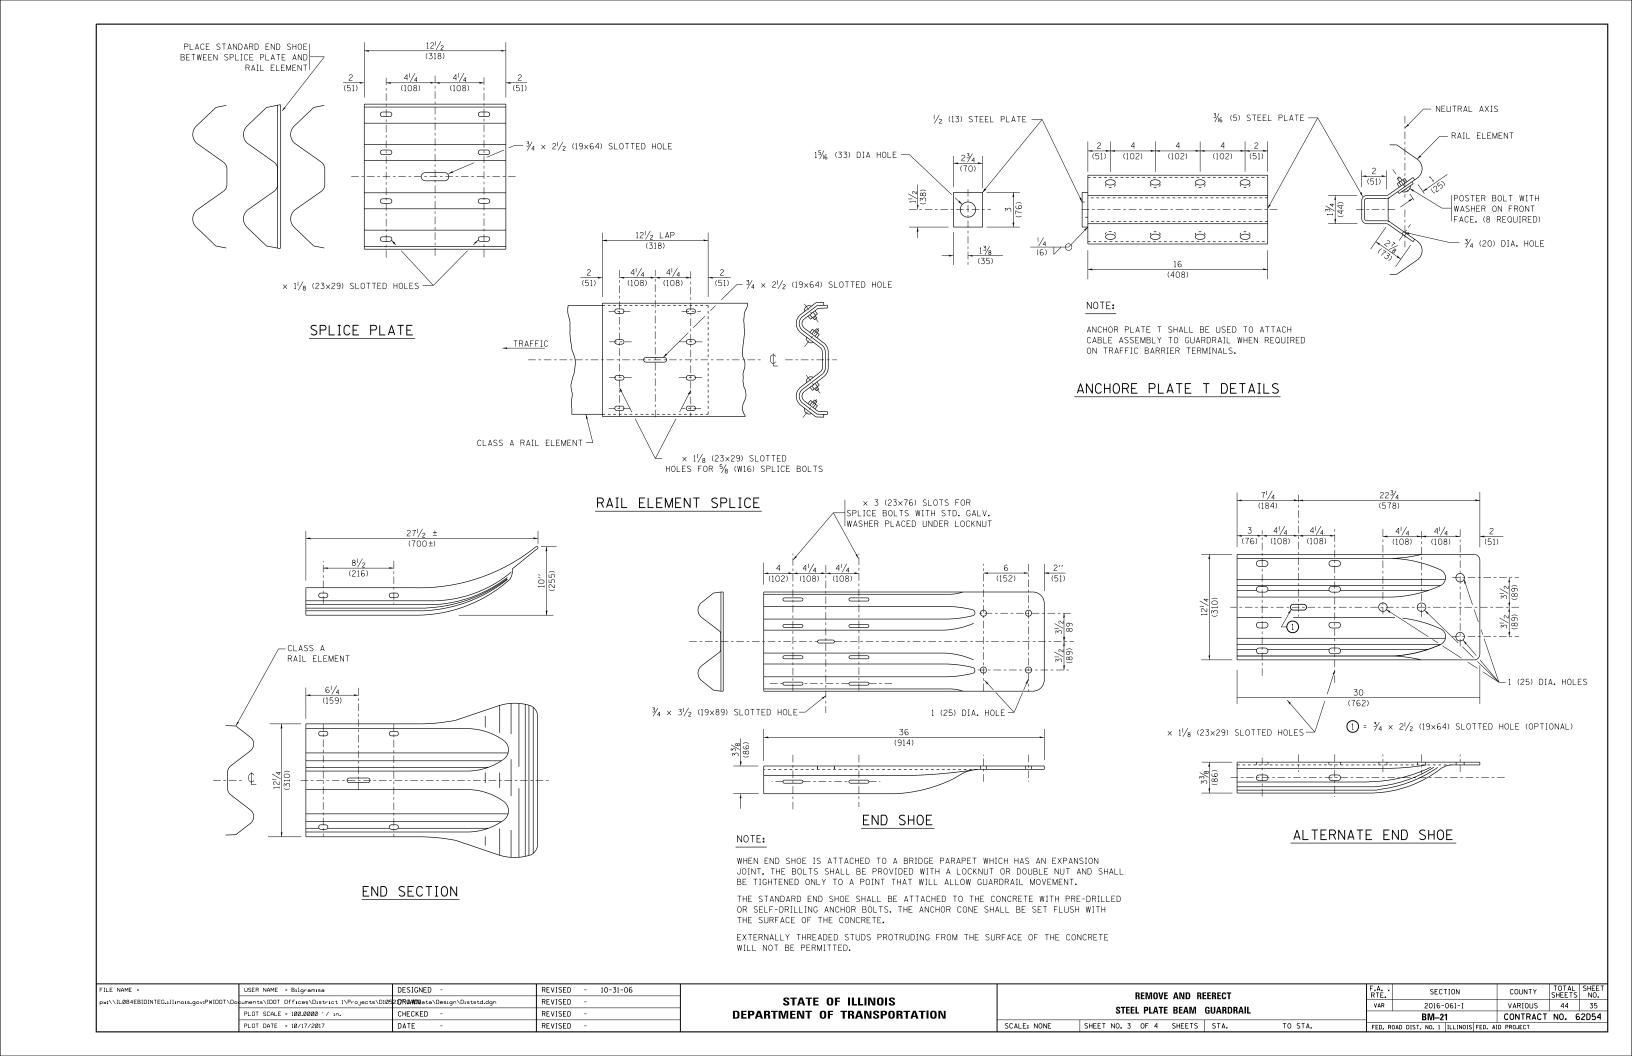

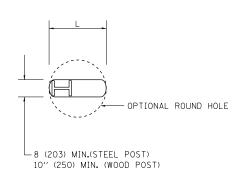

PLAN

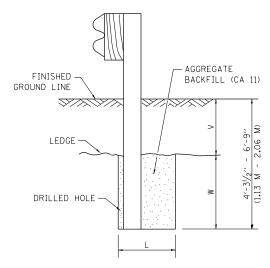


NOTE:

LEDGE LINE IS TOP OF ROCK LEDGE OR HARD SLAG FILL.

ELEVATION

FOOTING FOR POST WHEN IMPERVIOUS MATERIAL IS ENCOUNTERED

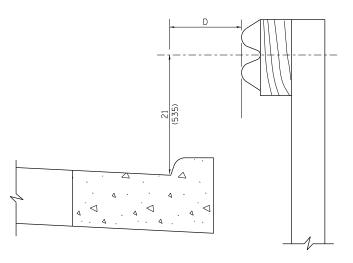


NOTE:

IF IT IS NECESSARY FOR D TO BE MORE THAN 12 (300) AND LESS THAN 10'-0" (3.0 M) TYPE M-2 (M-5) CURB AND GUTTER (STD. 606001) SHALL BE USED IN FRONT OF AND IN ADVANCE OF THE GUARDRAIL.


GUARDRAIL PLACED BEHIND CURB

(D = O DESIRABLE TO 12 (300) MAXIMUM)

V	w	L					
V	W W	STEEL POST	WOOD POST				
0 - 18	24	21	23				
(0 - 460)	(610)	(530)	(580)				
>18 - 41.5	12	8	10				
(> 460 - 825)	(305)	(203)	(250)				
>41.5 - 53.5	12 - 0	8	10				
(> 825 - 1.13 M)	(350 - 0)	(203)	(250)				

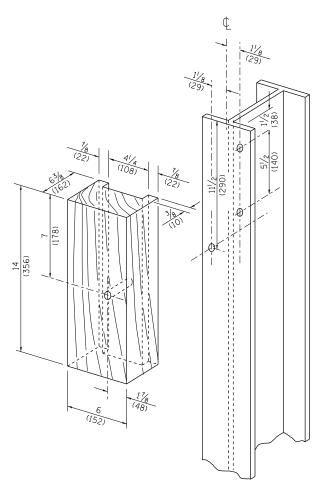


WOOD BLOCK-OUT AND STEEL POST DETAILS

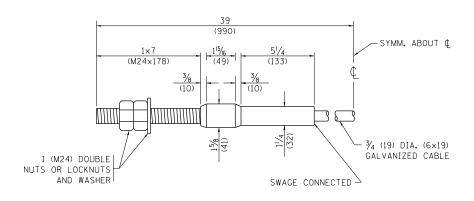

CABLE ASSEMBLY

(40,000 LBS (18,100 KG) MIN. BREAKING STRENGTH)
TIGHTEN TO TAUT TENSION

FILE NAME =	USER NAME = Bilgramisa	DESIGNED -	REVISED - 10-31-06			REMOVE AND REERECT	F.A	SECTION	COUNTY TOTAL SHEET
pw:\\ILØ84EBIDINTEG.:llinois.gov:PWIDOT\Do	cuments\IDOT Offices\District 1\Projects\D10	0521 7R/AWIN ata\Design\Diststd.dgn	REVISED -	STATE OF ILLINOIS			VAR	2016-061-I	VARIOUS 44 36
	PLOT SCALE = 100.0000 ' / in.	CHECKED -	REVISED -	DEPARTMENT OF TRANSPORTATION		STEEL PLATE BEAM GUARDRAIL		BM-21	CONTRACT NO. 62D54
	PLOT DATE = 10/17/2017	DATE -	REVISED -		SCALE: NONE	SHEET NO. 4 OF 4 SHEETS STA. TO STA.	FED. ROAD	DIST. NO. 1 ILLINOIS FED.	AID PROJECT

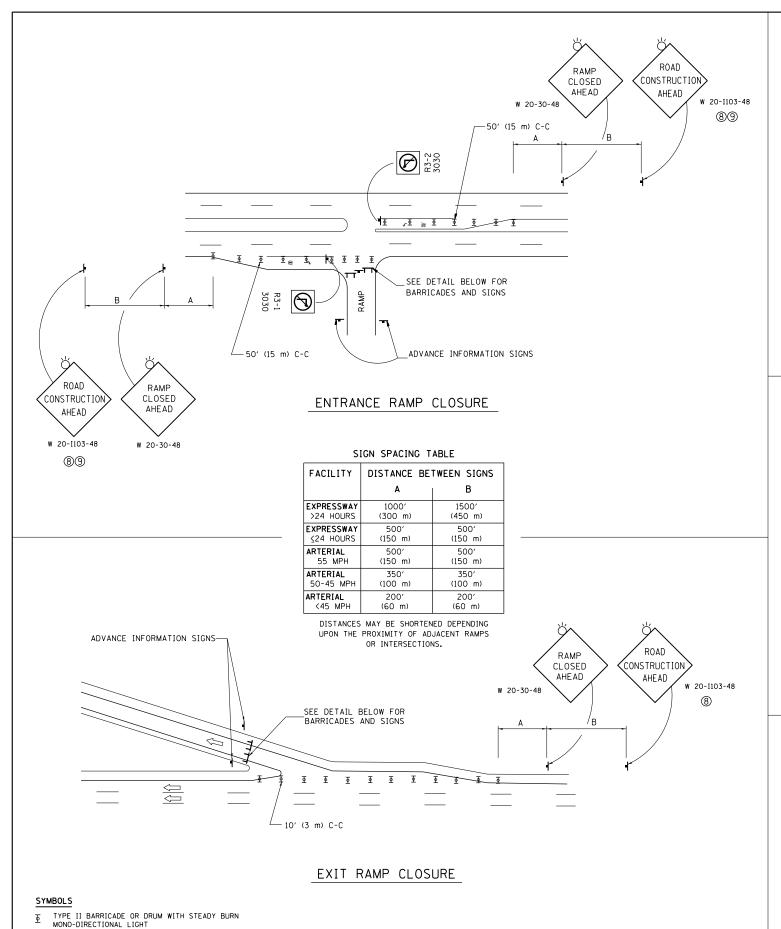


TYPE III BARRICADE WITH 2 FLASHING LIGHTS

THE "RAMP CLOSED" SIGN SHALL BE B/W WITH 8 (200) CAPS. FLASHER UNIT AMBER BOTH SIDES OF EACH TYPE III BARRICADES A' (I.2 m) CLOSED TO CLOSED TO

DETAIL FOR REQUIRED BARRICADES & SIGNS



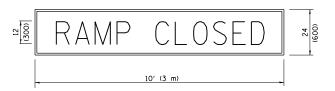

BLACK LEGEND ON ORANGE

BACKGROUND MOUNTED


DIAGONALLY

E MOD FONT

1 (25) BORDER

SIGNS ARE REQUIRED ON ALL THE EXIT

THESE SIGNS ARE REQUIRED ON ALL THE EXIT
GUIDE SIGNS FOR EXIT RAMPS THAT WILL BE
CLOSED FOR MORE THAN FOUR (4) CONSECUTIVE DAYS.

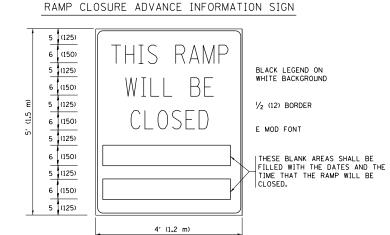

THESE SIGNS ARE REQUIRED ON BOTH SIDES OF THE RAMP, MINIMUM OF 1 WEEK IN ADVANCE OF THE CLOSURE.

THESE SIGNS SHALL BE FABRICATED AND PAID FOR ACCORDING TO THE TEMPORARY INFORMATION SIGNING SPECIAL PROVISION


GENERAL NOTES:


- ① CONES MAY BE SUBSTITUTED FOR DRUMS OR TYPE II
 BARRICADES DURING DAY OPERATIONS. CONES SHALL BE
 A MINIMUM OF 28 (700) HIGH.
- STEADY BURN LIGHTS WILL NOT BE REQUIRED FOR DAY OPERATIONS.
- (3) A FLAGGER SHALL BE POSITIONED AT EACH CLOSED RAMP THAT IS OPEN TO CONSTRUCTION VEHICLES, PRECEEDED BY A W20-7 FLAGGER WARNING SIGN.
- 4 ALL ROUTE MARKERS AND TRAILBLAZER ASSEMBLIES WHICH DIRECT MOTORISTS TO A CLOSED ENTRANCE RAMP SHALL BE COVERED WHEN THE RAMP IS CLOSED FOR MORE THAN FOUR (4) DAYS.
- (5) THE SIGNING AND BARRICADING WHICH IS REQUIRED BY THIS DETAIL SHALL BE INCLUDED IN THE COST OF TRAFFIC CONTROL AND PROTECTION (EXPRESSWAYS).

- AUTHORIZATION FROM THE DISTRICT'S BUREAU OF TRAFFIC IS REQUIRED FOR ALL RAMP CLOSURES.
- (7) THE RAMP CLOSURE ADVANCE INFORMATION SIGNS SHALL BE ERECTED IF THE CLOSURE TIME EXCEEDS TWENTY-FOUR (24) HOURS, ADDITIONAL ADVANCE WARNING SIGNS ON EXIT GUIDE SIGNING WILL BE REQUIRED FOR EXIT RAMP CLOSURES THAT EXCEED FOUR (4) DAYS IN LENGTH
- (8) ROAD CONSTRUCTION AHEAD SIGNS MAY BE OMITTED WHEN THIS DETAIL IS USED IN CONJUNCTION WITH OTHER TRAFFIC CONTROL THAT ALREADY INCLUDES A ROAD CONSTRUCTION AHEAD SIGN.
- ARTERIAL ROAD CONSTRUCTION AHEAD SIGNS SHALL BE INSTALLED ON THE LEFT SIDE OF TRAFFIC IF THE MEDIAN IS MORE THAN 10 FT WIDE.

ALL DIMENSIONS ARE IN INCHES (MILLIMETERS)
UNLESS OTHERWISE SHOWN.

FILE NAME =	USER NAME = Bilgramisa	DESIGNED - DWS	REVISED - JAF 02-06		ENTRANCE AND EXIT RAMP	F.A	SECTION	COUNTY	TOTAL	SHEET NO.
pw:\\IL084EBIDINTEG.:ll:nois.gov:PWIDOT\Do	cuments\IDOT Offices\District 1\Projects\Di05	2 :DRAWIN ata\Design\Diststd.dgn	REVISED - SPB 01-07	STATE OF ILLINOIS		VAR	2016-061-I	VARIOUS	44	37
	PLOT SCALE = 100.00000 '/ in.	CHECKED -	REVISED - SPB 12-09	DEPARTMENT OF TRANSPORTATION	CLOSURE DETAILS		TC-08	CONTRACT	NO. 62	2D54
	PLOT DATE = 10/17/2017	DATE - 02-83	REVISED - MD 06-13		SCALE: NONE SHEET NO. 1 OF 1 SHEETS STA. TO STA.	FFD. RC	OAD DIST. NO. 1 JULINOIS FED.	. AID PROJECT		

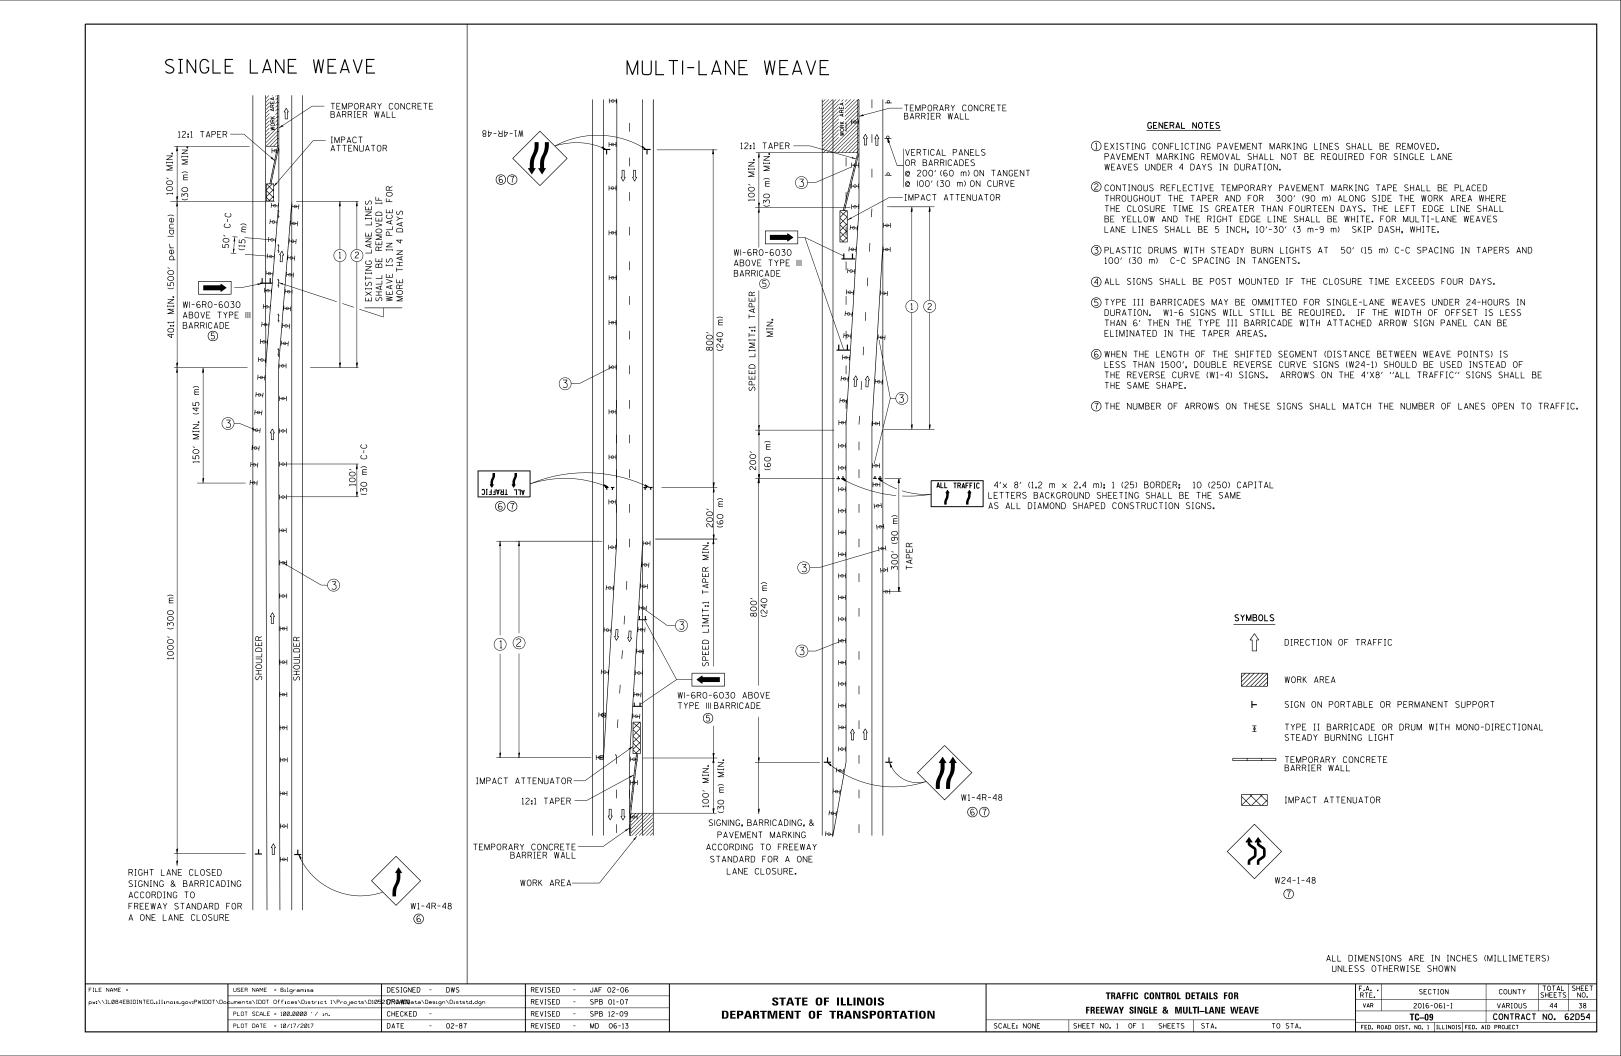

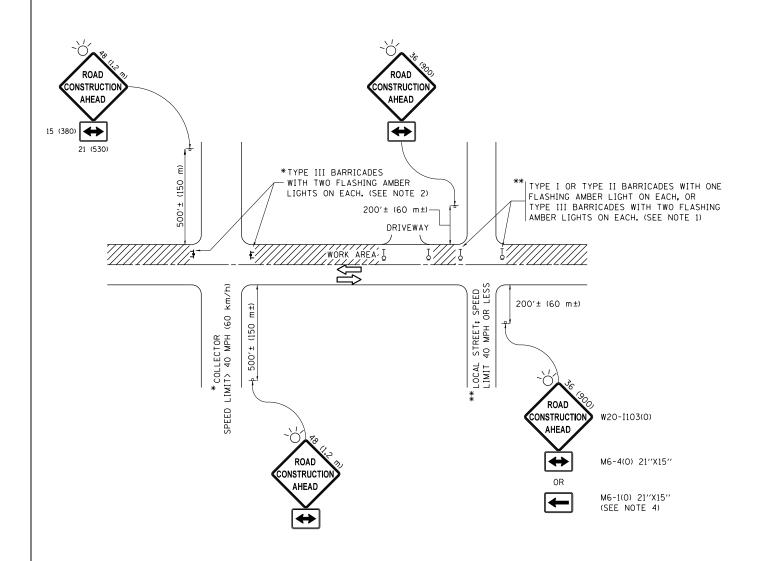

NOTES:

- SIDE ROAD WITH A SPEED LIMIT OF 40 MPH (60 km/h) OR LESS AS SHOWN ON THE DRAWING AND AS DIRECTED BY THE ENGINEER:
 - a) ONE "ROAD CONSTRUCTION AHEAD" SIGN 36 x 36 (900x900) WITH A FLASHER MOUNTED ON IT APPROXIMATELY 200" (60 m) IN ADVANCE OF THE MAIN ROUTE.
 - b) THE CLOSED PORTION OF THE MAIN ROUTE SHALL BE PROTECTED BY BLOCKING WITH TYPE I, TYPE II OR TYPE III BARRICADES, 1/3 OF THE CROSS SECTION OF THE CLOSED PORTION.
- 2. SIDE ROAD WITH A SPEED LIMIT GREATER THAN 40 MPH (60 km/h) AS SHOWN ON THE DRAWING AND AS DIRECTED BY THE ENGINEER:
 - a) ONE "ROAD CONSTRUCTION AHEAD" SIGN 48 x 48 (1.2 m x 1.2 m) WITH A FLASHER MOUNTED ON IT APPROXIMATELY 500" (150 m) IN ADVANCE OF THE MAIN ROUTE.
 - b) THE CLOSED PORTION OF THE MAIN ROUTE SHALL BE PROTECTED BY BLOCKING WITH TYPE III BARRICADES, 1/2 OF THE CROSS SECTION OF THE CLOSED PORTION.
- 3. CONES MAY BE SUBSTITUTED FOR BARRICADES OR DRUMS AT HALF THE SPACING DURING DAY OPERATIONS. CONES SHALL BE A MINIMUM OF 28 (710) IN HEIGHT
- 4. WHEN THE SIDE ROAD LIES BETWEEN THE BEGINNING OF THE MAINLINE SIGNING AND THE WORK ZONE, A SINGLE HEADED ARROW (M6-1) SHALL BE USED IN LIEU OF THE DOUBLE HEADED ARROW (M6-4).

SCALE: NONE


- 5. WHEN WORK IS BEING PERFORMED ON A SIDE ROAD OR DRIVEWAY, FOLLOW THE APPLICABLE STANDARD(S). THE DIRECTIONAL ARROW (M6-1 OR M6-4) SHALL BE COVERED OR REMOVED WHEN NO LONGER CONSISTENT WITH THE TRAFFIC CONTROL SET-UP.
- 6. ADVANCE WARNING SIGNS ARE TO BE OMITTED ON DRIVEWAYS UNLESS OTHERWISE SPECIFIED IN THE PLANS OR BY THE ENGINFER.
- 7. THE TRAFFIC CONTROL AND PROTECTION FOR SIDE ROADS, INTERSECTIONS, AND DRIVEWAYS SHALL BE INCLUDED IN THE COST OF SPECIFIED TRAFFIC CONTROL STANDARDS OR ITEMS.

All dimensions are in inches (millimeters) unless otherwise shown.


FILE NAME =	USER NAME = Bilgramisa	DESIGNED - L.H.A.	REVISED	- A. HOUSEH 10-15-96
pw:\\ILØ84EBIDINTEG.:ll:no:s.gov:PWIDOT\Do	cuments\IDOT Offices\District 1\Projects\D105	2 17RMMI Nata\Design\Diststd.dgn	REVISED	-T. RAMMACHER 01-06-00
	PLOT SCALE = 100.0000 ' / in.	CHECKED -	REVISED	- A. SCHUETZE 07-01-13
Default	PLOT DATE = 10/17/2017	DATE - 06-89	REVISED	- A. SCHUETZE 09-15-16

STATE OF IL	LINOIS
DEPARTMENT OF TRA	ANSPORTATION

	TRAFFIC	CONTROL	AND P	TRAFFIC CONTROL AND PROTECTION FOR									
СI	TRAFFIC CONTROL AND PROTECTION FOR DE ROADS, INTERSECTIONS, AND DRIVEWAYS		VAR	2016-0	061-I								
31	SIDE NUADS, INTERSECTIONS, AND DRIVEVVATS			TC-10									
	SHEET 1	OF 1	SHEETS	STA.	TO STA.			ILLING					

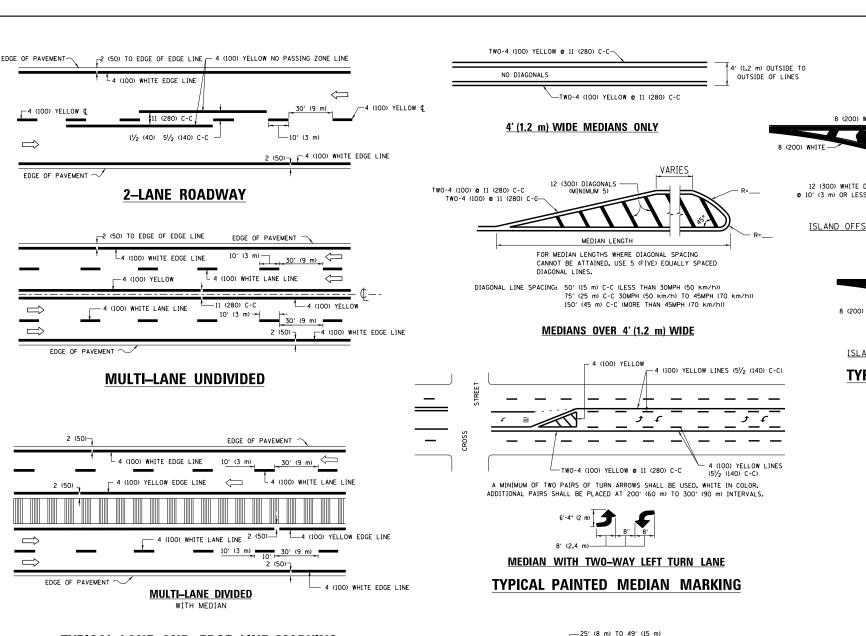

TYPICAL LANE AND EDGE LINE MARKING

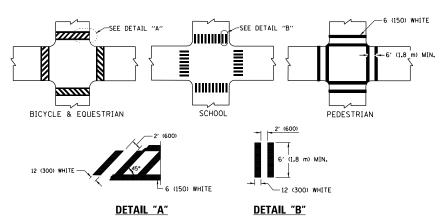

TYPICAL CROSSWALK MARKING


* MARKINGS SHALL BE INSTALLED PARALLEL TO THE CENTERLINE OF THE ROAD WHICH IT CROSSES

FULL SIZE LETTERS 8' (2.4 m) AND ARROWS SHALL BE USED. \P AREA = 15.6 SQ. FT. (1.5 m²)


* TURN LANES IN EXCESS OF 400' (120 m) IN LENGTH MAY HAVE AN ADDITIONAL SET OF ARROW - "ONLY" INSTALLED MIDWAY BETWEEN THE OTHER TWO SETS OF ARROW - "ONLY".

TYPICAL LEFT (OR RIGHT) TURN LANE

TYPICAL TURN LANE MARKING

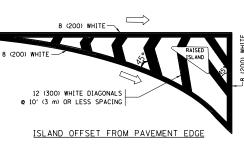



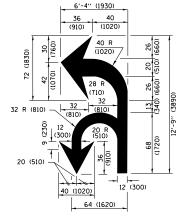


COMBINATION

LEFT AND U-TURN

5'-4" (1620)

√ 32 R (810)

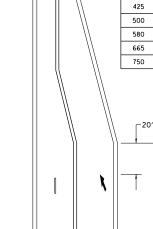

LANE REDUCTION TRANSITION

D(FT)

345

SPEED LIMIT

45

50

55

* LANE REDUCTION ARROWS REQUIRED AT SPEEDS OF 45 MPH OR GREATER OR WHEN SPECIFIED IN PLANS.

TYPE OF MARKING	WIDTH OF LINE	PATTERN	COLOR	SPACING /REMARKS
CENTERLINE ON 2 LANE PAVEMENT	4 (100)	SKIP-DASH	YELLOW	10' (3 m) LINE WITH 30' (9 m) SPACE
CENTERLINE ON MULTI-LANE UNDIVIDED PAVEMENT	2 @ 4 (100)	SOLID	YELLOW	11 (280) C-C
NO PASSING ZONE LINES: FOR ONE DIRECTION FOR BOTH DIRECTIONS	4 (100) 2 @ 4 (100)	SOLID SOLID	YELLOW YELLOW	5½ (140) C-C FROM SKIP-DASH CENTERLINE 11 (280) C-C OMIT SKIP-DASH CENTERLINE BETWEEN
LANE LINES	4 (100) 5 (125) ON FREEWAYS	SKIP-DASH SKIP-DASH	WHITE WHITE	10' (3 m) LINE WITH 30' (9 m) SPACE
DOTTED LINES (EXTENSIONS OF CENTER, LANE OR TURN LANE MARKINGS)	SAME AS LINE BEING EXTENDED	SKIP-DASH	SAME AS LINE BEING EXTENDED	2' (600) LINE WITH 6' (1.8 m) SPACE
EDGE LINES	4 (100)	SOLID	YELLOW-LEFT WHITE-RIGHT	OUTLINE MEDIANS IN YELLOW
TURN LANE MARKINGS	6 (150) LINE: FULL SIZE LETTERS & SYMBOLS (8' (2.4m))	SOLID	WHITE	SEE TYPICAL TURN LANE MARKING DETAIL
TWO WAY LEFT TURN MARKING	2 @ 4 (100) EACH DIRECTION 8' (2.4m) LEFT ARROW	SKIP-DASH AND SOLID IN PAIRS	YELLOW	10' (3 m) LINE WITH 30' (9 m) SPACE FOR SKIP-DASH: 5½ (140) C-C BETWEEN SOLID LINE AND SKIP-DASH LINE SEE TYPICAL TWO-WAY LEFT TURN MARKING DETAIL
CROSSWALK LINES (PEDESTRIAN) A. DIAGONALS (BIKE & EQUESTRIAN) B. LONGITUDINAL BARS (SCHOOL)	2 e 6 (150) 12 (300) e 45° 12 (300) e 90°	SOLID SOLID SOLID	WHITE WHITE WHITE	NOT LESS THAN 6' (1.8 m) APART 2' (600) APART 2' (600) APART SEE TYPICAL CROSSWALK MARKING DETAILS.
STOP LINES	24 (600)	SOLID	WHITE	PLACE 4' (1,2 m) IN ADVANCE OF AND PARALLEL TO CROSSWALK, IF PRESENT. OTHERWISE, PLACE AT DESIRED STOPPING POINT. PARALLEL TO CROSSROAD CENTERLINE, WHERE POSSIBLE
PAINTED MEDIANS	2 @ 4 (100) WITH 12 (300) DIAGONALS @ 45° NO DIAGONALS USED FOR 4' (1.2 m) WIDE MEDIANS	SOLID	YELLOW: TWO WAY TRAFFIC WHITE: ONE WAY TRAFFIC	11 (280) C-C FOR THE DOUBLE LINE SEE TYPICAL PAINTED MEDIAN MARKING.
GORE MARKING AND CHANNELIZING LINES	8 (200) WITH 12 (300) DIAGONALS @ 45°	SOLID	WHITE	DIAGONALS: 15' (4,5 m) C-C (LESS THAN 30MPH (50 km/h)) 20' (6 m) C-C 30MPH (50 km/h) TO 45MPH (70 km/h)) 30' (9 m) C-C (OVER 45MPH (70 km/h))
RAILROAD CROSSING	24 (600) TRANSVERSE LINES; "RR" IS 6' (1.8 m) LETTERS; 16 (400) LINE FOR "X"	SOLID	WHITE	SEE STATE STANDARD 780001 AREA OF: "R"=3.6 SQ. FT. (0.33 m²) EACH "X"=54.0 SQ. FT. (5.0 m²)
SHOULDER DIAGONALS (REQUIRED FOR SHOULDERS > 8')	12 (300) © 45°	SOLID	WHITE - RIGHT YELLOW - LEFT	50' (15 m) C-C (LESS THAN 30MPH (50 km/h)) 75' (25 m) C-C (30 MPH (50 km/h) T0 45MPH (70 km/h)) 150' (45 m) C-C (0VER 45MPH (70 km/h))
U TURN ARROW	SEE DETAIL	SOLID	WHITE	16.3 SF
2 ARROW COMBINATION LEFT AND U TURN	SEE DETAIL	SOLID	WHITE	30.4 SF

FOR FURTHER DETAILS ON PAVEMENT MARKING REFER TO STANDARD SPECIFICATIONS FOR ROAD AND BRIDGE CONSTRUCTION AND STATE STANDARD 780001.

All dimensions are in inches (millimeters) unless otherwise shown.

FILE NAME = DESIGNED - EVERS USER NAME = Bilgramisa REVISED - C. JUCIUS 09-09-09 ow:\\ILØ84EBIDINTEG.:111:no: ments\IDOT Offices\District 1\Projects\D105217RQ4000ata\Design\Diststd.dgr REVISED -C. JUCIUS 07-01-13 CHECKED REVISED -C. JUCIUS 12-21-15 PLOT DATE = 10/17/2017 DATE 03-19-90 REVISED -C. JUCIUS 04-12-16

STATE OF ILLINOIS
DEPARTMENT OF TRANSPORTATION

_								
	DISTRICT ONE	F.A. RTE.	SECTION	COUNTY	TOTAL SHEETS	SHEET NO.		
ı	TYPICAL PAVEMENT MARKINGS	VAR	2016-061-I	VARIOUS	44	40		
ı		TC-13 CONTRACT NO						
	SCALE: NONE SHEET 1 OF 1 SHEETS STA. TO STA.		ILLINOIS FED. A	D PROJECT				

TURN BAY ENTRANCE AT START OF LANE CLOSURE TAPER


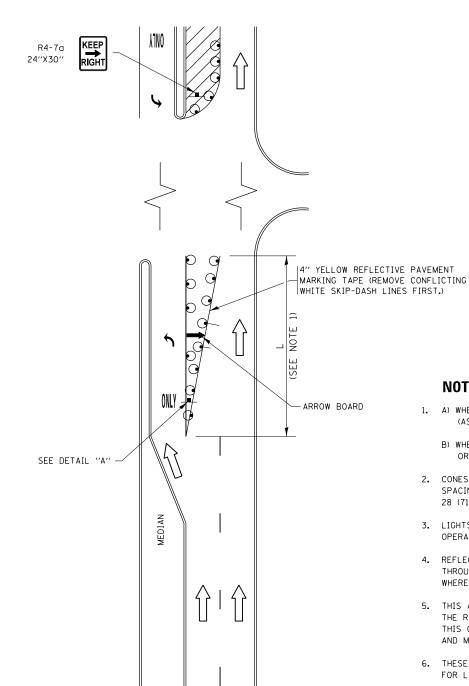


FIGURE 1

TURN BAY ENTRANCE WITHIN A LANE CLOSURE


CONFLICTING |

PAVEMENT MARKING REMOVAL (TYP.)

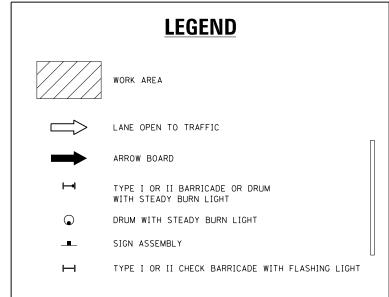

NOTES:

- 1. A) WHEN "L" IS < THE STORAGE LENGTH OF THE TURN LANE (AS SHOWN IN FIG. 1), USE FIGURE 1.
 - B) WHEN "L" IS > THE STORAGE LENGTH OF THE TURN LANE OR THE TURN LANE IS WITHIN THE LANE CLOSURE, USE FIGURE 2.
- 2. CONES MAY BE SUBSTITUTED FOR BARRICADES OR DRUMS AT HALF THE SPACING DURING DAY OPERATIONS. CONES SHALL BE A MINIMUM OF 28 (710) IN HEIGHT.
- 3. LIGHTS WILL NOT BE REQUIRED ON BARRICADES OR DRUMS FOR DAY OPERATIONS. ALL LIGHTS SHALL BE MONODIRECTIONAL.
- 4. REFLECTIVE TEMPORARY PAVEMENT MARKINGS SHALL BE PLACED THROUGHOUT THE BARRICADED AREAS OF EACH TURN BAY AS SHOWN WHERE THE CLOSURE TIME IS GREATER THAN FOURTEEN (14) DAYS.
- 5. THIS APPLICATION ALSO APPLIES WHEN WORK IS BEING PERFORMED IN THE RIGHT LANE(S) AND THE RIGHT TURN BAY IS TO REMAIN OPEN. UNDER THIS CONDITION, "RIGHT TURN LANE" R3-I100R 24 x 24 (600 x 600) AND M6-2R 21 \times 15 (530 \times 380) SHALL BE USED.
- 6. THESE CONTROLS SHALL SUPPLEMENT MAINLINE TRAFFIC CONTROL FOR LANE CLOSURES.
- 7. THE SIGNS SHALL BE MOUNTED ABOVE THE BARRICADES/DRUMS ON SEPARATE SIGN SUPPORTS THAT MEET NCHRP 350 OR MASH PREQUIREMENTS.
- 8. TRAFFIC CONTROL AND PROTECTION AT TURN BAYS (TO REMAIN OPEN TO TRAFFIC) SHALL BE INCLUDED IN THE COST OF SPECIFIED TRAFFIC CONTROL STANDARDS OR ITEMS.

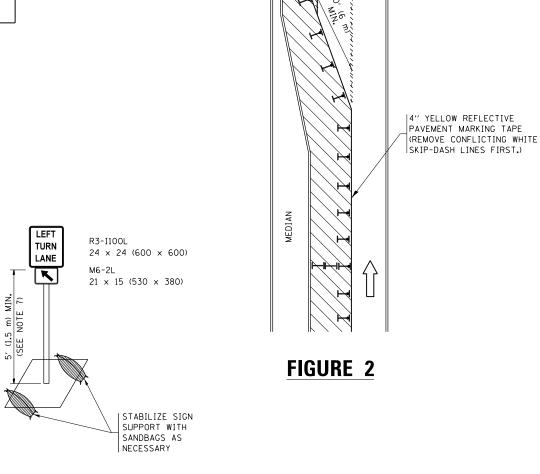

DETAIL A

All dimensions are in inches (millimeters) unless otherwise shown.

SEE DETAIL "A"


6" WHITE REFLECTIVE

PAVEMENT MARKING TAPE

FILE NAME =	USER NAME = Bilgramisa	REVISED -1. RAMMACHER 09-08-94 REVISED - R. BORO 09-14-09
pw:\\IL084EBIDINTEG.:1ll:nois.gov:PWIDOT\Do	cuments\IDOT Offices\District 1\Projects\D105	2 REWASED e\Design\ A us HOUSEH 11-07-95 REVISED - A. SCHUETZE 07-01-1
	PLOT SCALE = 100.0000 ' / in.	REVISED - A. HOUSEH 10-12-96 REVISED - A. SCHUETZE 09-15-1
Default	PLOT DATE = 10/17/2017	REVISED -T. RAMMACHER 01-06-00 REVISED -


STATE OF ILLINOIS **DEPARTMENT OF TRANSPORTATION**

	TRAFF	IC CONT	ROL AND	PROTEC	CTION AT TURN	BAYS	F.A. RTE.	SECTION	COUNTY	TOTAL SHEETS	SHEET NO.
ı	(TO REMAIN OPEN TO TRAFFIC)						VAR	2016-061-I	VARIOUS	44	41
ı	(10 HEWAIN OFEN TO HIATTIC)						TC-14	CONTRACT	NO.	62D54	
ı	SCALE: NONE	SHEET 1	OF 1	SHEETS	STA.	TO STA.		ILLINOIS FED. A	D PROJECT		

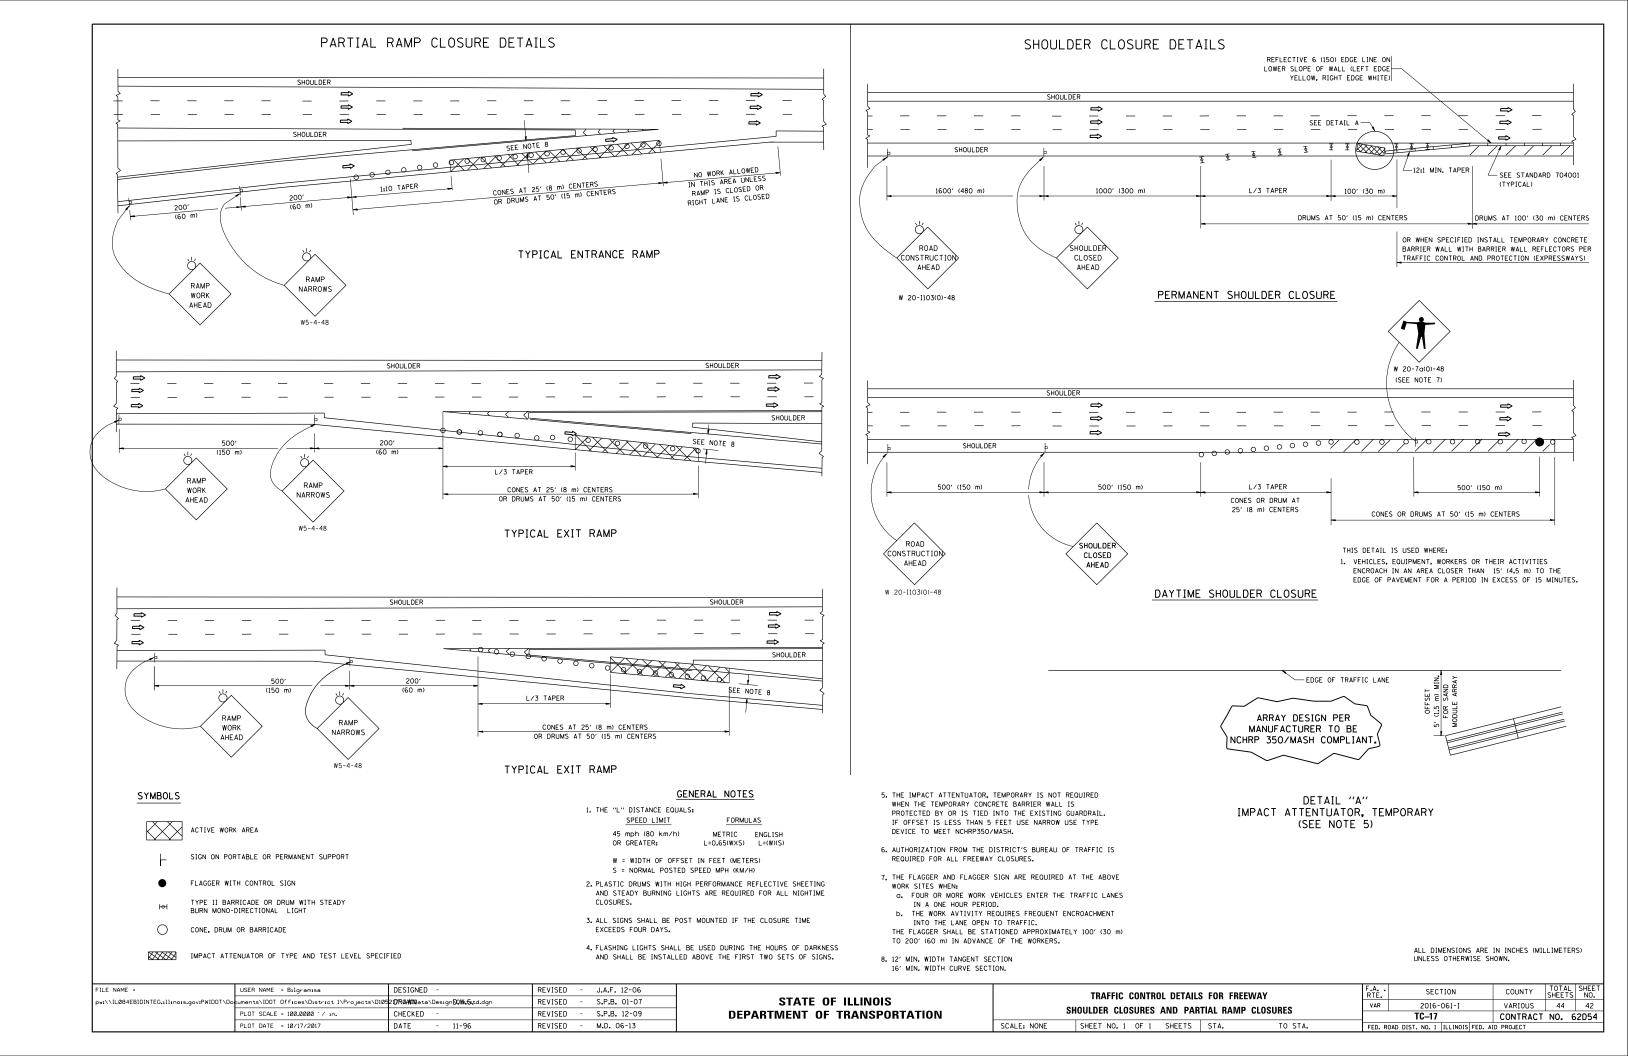


SIGNING FOR FLAGGING OPERATIONS AT WORK ZONE OPENINGS

WORK ZONE EXIT OPENING

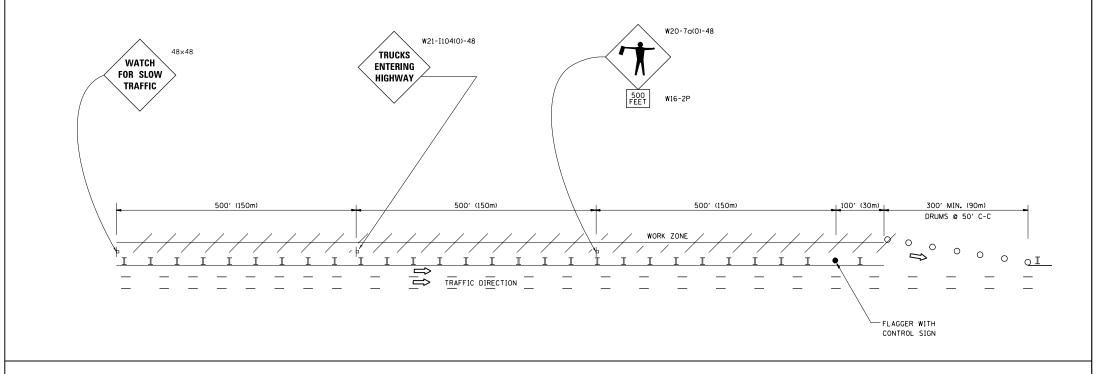


WORK ZONE ENTRY OPENING

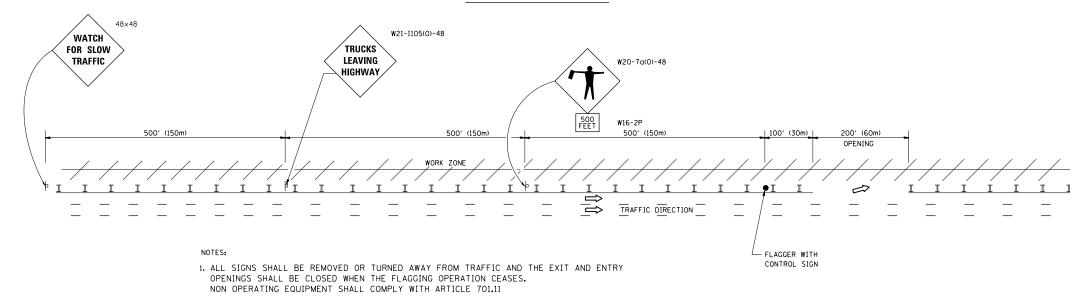

- 2. WORK ZONE OPENINGS SHALL BE A MINIMUM OF ONE HALF MILE APART AND A MINIMUM OF ONE QUARTER MILE FROM ALL ENTRANCE AND EXIT RAMPS.
- 3. EXITING THE WORK ZONE AT ANY PLACE OTHER THAN AT A WORK ZONE EXIT OPENING WILL BE PROHIBITED.
- 4. ALL VEHICLES SHALL ENTER THE WORK ZONE AT ENTRY OPENINGS, USING THEIR TURN SIGNALS TO WARN MOTORISTS
- 5. FLAGGERS SHALL NOT STOP TRAFFIC OR DIRECT TRAFFIC INTO AN ADJACENT LANE.

ALL DIMENSIONS ARE IN INCHES (MILLIMETERS)
UNLESS OTHERWISE SHOWN

- 1	FILE NAME =	USER NAME = Bilgramisa	DESIGNED -	REVISED -	J.A.F. 02-06		FRFF\	NAY/EXPRESSWAY S	IGNING FO	OR FLAGGING	OPERATIONS	RTE.	SECTION	COUNTY	SHEETS	NO.
- 1	pw:\\IL084EBIDINTEG.:ll:no:s.gov:PWIDOT\Do	uments\IDOT Offices\District 1\Projects\D1	05217RAMINata\Design\Diststd.dgn	REVISED -	S.P.B. 01-07	STATE OF ILLINOIS						VAR	2016-061-I	VARIOUS	44	43
- 1		PLOT SCALE = 100.0000 ' / in.	CHECKED -	REVISED -	S.P.B. 12-09	DEPARTMENT OF TRANSPORTATION	AI	WORK ZONE OPENIN	NGS UN F	-KEEWAYS/EX	PRESSWAYS		TC-18	CONTRACT	T NO. 6	2D54
l		PLOT DATE = 10/17/2017	DATE -	REVISED -	M.D. 06-13		SCALE: NONE	SHEET NO. 1 OF 1	SHEETS	STA.	TO STA.	FED. ROAD D		ED. AID PROJECT		

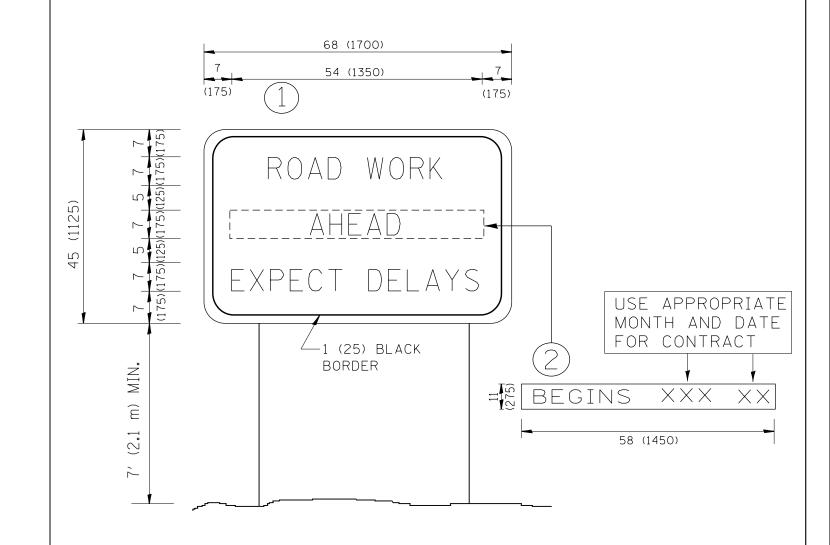

NOTES:

- 1. USE BLACK LETTERING ON ORANGE BACKGROUND.
- 2. ERECT SIGNS IN ADVANCE OF THE LOCATION FOR THE "ROAD CONSTRUCTION AHEAD" SIGN AT LOCATIONS AS DIRECTED BY THE ENGINEER.
- 3. ERECT SIGN (1) WITH INSTALLED PANEL (2) ONE WEEK PRIOR TO THE START OF CONSTRUCTION.
- 4. REMOVE PANEL (2) SOON AFTER THE START OF CONSTRUCTION.
- 5. SEE SPECIAL PROVISION FOR "TEMPORARY INFORMATION SIGNING" FOR ADDITIONAL INFORMATION.
- 6. ONE SIGN ASSEMBLY EQUALS 25.70 SQ. FT. (2.3 SQ. M.)
- 7. SHALL BE PAID FOR AS TEMPORARY INFORMATION SIGNING.

ALL DIMENSIONS ARE IN INCHES (MILLIMETERS) UNLESS OTHERWISE SHOWN.

F	ILE NAME =	USER NAME = Bilgramisa	DESIGNED -	REVISED - R. MIRS 09-15-97			ARTERIAL RO	ΛD		F.A	SECTION	COUNTY	CHEETS	SHEET
р	pw:\\IL084EBIDINTEG:illinois.gov:PWIDDT\Do uments\ID0T\Offices\District\I\Projects\Di0T\DotStAbUsion\Dossgn\Diststd.dgn PLOT\SCALE = 100.0000 '/ in. CHECKED -			REVISED - R. MIRS 12-11-97	STATE OF ILLINOIS	INFORMATION SIGN			VAR	2016-061-I	VARIOUS	44	44	
				REVISED -T. RAMMACHER 02-02-	DEPARTMENT OF TRANSPORTATION					TC-22	CONTRACT NO. 62D54			
		PLOT DATE = 10/17/2017	DATE -	REVISED - C. JUCIUS 01-31-0		SCALE: NONE SHEET NO. 1 OF 1 SHEETS STA. TO STA.			FED. ROAD	DIST. NO. 1 ILLINOIS FED.	AID PROJECT			