FOR INDEX OF SHEETS, SEE SHEET NO. 2 FOR LIST OF HIGHWAY STANDARDS, SEE SHEET NO. 2

01-19-2024 LETTING ITEM 051

POSTED SPEED LIMIT = 45 MPH

FUNCTIONAL CLASSIFICATION = MAJOR COLLECTOR

TRAFFIC DATA: **BULL VALLEY ROAD**

ADT = 10,000

STATE OF ILLINOIS

DEPARTMENT OF TRANSPORTATION

PLANS FOR PROPOSED FEDERAL AID HIGHWAY


CURRAN ROAD TO CRYSTAL LAKE AVENUE SECTION 21-00091-00-RS PROJECT NO. DDGD(509) **ROAD RESURFACING IMPROVEMENTS** CITY OF MCHENRY MCHENRY COUNTY JOB NO. C-91-213-22

RANGE 10 EAST, SECTIONS 17 & 18

FAU 3860 (BULL VALLEY ROAD)

END IMPROVEMENT

STA 126+00

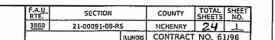




BEGIN IMPROVEMENT STA 100+00.00 (SN 056-3109)

ENGINEERING SCALES. REDUCED SIZED PLANS WILL NOT CONFORM TO STANDARD SCALES. IN MAKING MEASUREMENTS ON REDUCED PLANS, THE ABOVE SCALES MAY BE USED.

JOINT UTILITY LOCATION INFORMATION FOR EXCAVATORS 1-800-892-0123 OR 811

> PRINTED BY THE AUTHORITY OF THE STATE OF ILLINOIS

CONTRACT NO. 61J96

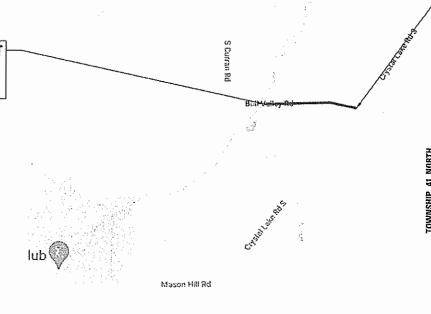

LOCATION MAP SCALE = 1 IN : 2000 FT

GROSS LENGTH = 3740 FT. = 0.71 MILE NET LENGTH = 3740 FT. = 0.71 MILE

AGENCY RESPONSIBLE FOR LETTING LOCAL AGENCY

APPROVED SEPT.

CITY OF MCHENRY, ENGINEER GREGORY S. GRUENPE

STATE OF ILLINOIS
DEPARTMENT OF TRANSPORTATION

DISTRICT T ENGINEER OF LOCAL ROADS & STREETS

RELEASING FOR BID BASED ON LIMITED

LICENSE N

REVIEW NOVEMBER 7 20 23

DATE: 11/06/2023 ANDRE A. 062-072501 LICENSE EXPIRES: 11-30-23

Hampton, Lenzini and Renwick, Inc.

Civil Engineers - Structural Engineers
Land Surveyors - Environmental Services

1707 N, RANDALL ROAD, SUITE 100 ELGIN, ILLINOIS 60123 847.697.6700 vww.hirengineering.com

PROJECT NUMBER: 20,0361,330

DATE: 11/05/2023

E. RAWOS, PE SCHAUMBURG, CARMEN PROGRAM

AID

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INDEX OF SHEETS

COVER SHEET INDEX OF SHEETS AND GENERAL NOTES 3-5 SUMMARY OF QUANTITIES TYPICAL SECTIONS ALIGNMENT AND TIES 8-10 RESURFACING PLAN SHEETS 11-13 EROSION AND SEDIMENT CONTROL PLANS 14-16 PAVEMENT MARKING PLAN SHEETS 17-19 LANDSCAPING PLAN SHEETS ADA SIDEWALK DETAILS 20

HIGHWAY STANDARDS

000001-08 STANDARD SYMBOLS, ABBREVIATIONS AND PATTERNS TEMPORARY EROSION CONTROL SYSTEMS 280001-07 424011-04 CORNER PARALLEL CURB RAMPS FOR SIDEWALKS 424026-03 ENTRANCE / ALLEY PEDESTRIAN CROSSINGS CLASS A PATCHES 442001-04 442101-09 CLASS B PATCHES 442201-03 CLASS C AND D PATCHES 482011-03 HMA SHOULDER STRIPS/SHOULDERS WITH RESURFACING OR WIDENING AND RESURFACING PROJECTS 606001-08 CONCRETE CURB TYPE B AND COMBINATION CONCRETE CURB AND GUTTER OUTLET FOR CONCRETE CURB AND GUTTER, TYPE B-6.24 (B-15.60) 606006-04 630001-12 STEEL PLATE BEAM GUARDRAIL 701006-05 OFF-ROAD OPERATIONS, 2L, 2W, 15' (4.5 M) TO 24" (600 MM) FROM PAVEMENT EDGE 701301-04 LANE CLOSURE 2L 2W SHORT TIME OPERATIONS LANE CLOSURE, 2L, 2W, SLOW MOVING OPERATIONS DAY ONLY, FOR SPEEDS 45MPH 701306-04 701501-06 URBAN LANE CLOSURE, 2L, 2W, UNDIVIDED URBAN LANE CLOSURE, 2L, 2W, WITH BIDIRECTIONAL LEFT TURN LANE 701502-09 701801-06 SIDEWALK, CORNER OR CROSSWALK CLOSURE 701901-09 TRAFFIC CONTROL DEVICES TYPICAL PAVEMENT MARKINGS 780001-05

DISTRICT ONE DETAILS

BD-24 CURB OR CURB AND GUTTER REMOVAL AND REPLACEMENT

TC-10 TRAFFIC CONTROL AND PROTECTION FOR SIDE ROADS, INTERSECTIONS, AND DRIVEWAYS

TC-13 DISTRICT ONE TYPICAL PAVEMENT MARKINGS

TC-16 SHORT TERM PAVEMENT MARKINGS LETTERS AND SYMBOLS

GENERAL NOTES

SPECIFICATIONS, STANDARDS, AND SPECIAL PROVISIONS

ALL WORK SHALL BE IN ACCORDANCE WITH THE IDOT "STANDARD SPECIFICATIONS FOR ROAD AND BRIDGE CONSTRUCTION," ADOPTED JANUARY 1, 2022, (HEREINAFTER REFERRED TO AS THE STANDARD SPECIFICATIONS); THE "SUPPLEMENTAL SPECIFICATIONS AND RECURRING SPECIAL PROVISIONS," ADOPTED JANUARY 1, 2024; "STANDARD SPECIFICATIONS FOR WATER AND SEWER CONSTRUCTION IN ILLINOIS", SIXTH EDITION; THE DETAILS IN THE PLANS; AND THE SPECIAL PROVISIONS INCLUDED IN THE CONTRACT DOCUMENTS.

ANY REFERENCE TO STANDARDS THROUGHOUT THE PLANS OR SPECIAL PROVISIONS SHALL BE INTERPRETED AS THE MORE STRINGENT OF THE LATEST STANDARD OF MCHENRY COUNTY, OR THE LATEST STANDARD OF THE ILLINOIS DEPARTMENT OF TRANSPORTATION.

ALL TRAFFIC CONTROL AND OTHER ADVISORY SIGNS NEEDED FOR CONSTRUCTION ARE TO BE FURNISHED BY THE CONTRACTOR IN ACCORDANCE WITH ARTICLE 107.14 OF THE STANDARD SPECIFICATIONS.

THE CONTRACTOR SHALL AT TIMES PROVIDE PROTECTION FOR TRAFFIC AS CALLED FOR IN THE APPLICATION OF TRAFFIC CONTROL DEVICES, THE STANDARD SPECIFICATIONS AND THE PLANS.

ALL WORK SHALL BE INCLUDED WITHIN THE PROPOSED RIGHT OF WAY (ROW) LIMITS OF THE PROJECT, AS SHOWN. NO EQUIPMENT, MATERIAL, YARD OR FIELD OFFICE SHALL BE SETUP OR STORED ON TOWNSHIP OR PRIVATE PROPERTY WITHOUT WRITTEN PERMISSION FROM THE ENGINEER.

THE CONTRACTOR SHALL COORDINATE CONSTRUCTION ACTIVITIES WITH OTHER ROADWAY PROJECTS WITHIN THE AREA THAT ARE UNDER CONSTRUCTION AT THE SAME TIME. CONTRACT 61J51 IS A SIGNAL UPGRADE PROJECT AT BULL VALLEY ROAD AND CRYSTAL LAKE AVENUE.

STAKING

THE CONTRACTOR SHALL PROTECT AND CAREFULLY PRESERVE ALL SECTION OR SUBSECTION MONUMENTS, PROPERTY CORNERS, AND REFERENCE MARKERS UNTIL THE OWNER, HIS AGENT, OR AN AUTHORIZED SURVEYOR HAS WITNESSED OR OTHERWISE REFERENCE THEIR COATIONS. ALL RADII FOR PROPOSED CURB AND GUTTER ARE TO THE EDGE OF PAVEMENT, UNLESS OTHERWISE NOTED. CURB AND GUTTER LOCATIONS SHOWN AT POINTS OF CURVE, ETC., ARE EDGE OF PAVEMENT LIMITESS OTHERWISE NOTED.

STRUCTURE OFFSET LOCATIONS GIVEN ON THE DETAILED PLANS ARE TO BE THE FOLLOWING POINTS: A) FOR STRUCTURES FALLING IN THE CURB LINE TO THE EDGE OF PAVEMENT;

B) FOR ALL OTHER STRUCTURES TO THE CENTER OF THE STRUCTURE.

ALL ELEVATIONS ARE ON A LOCAL DATUM

ALL OFFSET LOCATIONS GIVEN ON THE DETAILED PLANS FOR STRUCTURES, EDGE OF PAVEMENT, ETC. ARE FROM THE CENTERLINE OR BASELINE AS SHOWN ON THE PLANS.

LITHITIES

THE CONTRACTOR SHALL COOPERATE WITH MCHENRY COUNTY AND STATE IF ANY UTILITY IMPROVEMENTS ARE REQUIRED BY MCHENRY COUNTY OR STATE WITHIN THE DURATION OF THE CONTRACT.

THE CONTRACTOR SHALL BE RESPONSIBLE FOR CONTACTING THE OWNERS OF ALL UTILITIES, LISTED BELOW, PRIOR TO CONSTUCTION TO DETERMINE THE LOCATION OF ALL UTILITY EQUIPMENT. THE CONTRACTOR SHALL COOPERATE WITH ALL UTILITY OWNERS AS PROVIDED FOR IN THE STANDARD SPECIFICATIONS IF UTILITY RELOCATION, ADJUSTMENT, OR PROTECTION IF NECESSARY.

THE LOCATION OF EXISTING DRAINAGE STRUCTURES, STORM SEWERS, WATER MAINS, SANITARY SEWERS, AND ANY OTHER PUBLIC OR PRIVATE UTILITIES AS SHOWN ON THE PLANS IS APPROXIMATE, AND THEIR EXACT LOCATION IS TO BE DETERMINED IN THE FIELD BY THE CONTRACTOR.

THE CONTRACTOR SHALL BE RESPONSIBLE FOR THE PROTECTION OF ALL UNDERGROUND AND SURFACE UTILITIES EVEN THOUGH THEY MAY NOT BE SHOWN ON THE PLANS. ANY UTILITY THAT IS DAMAGED DURING CONSTRUCTION SHALL BE REPAIRED OR REPLACED TO THE SATISFACTION OF THE OWNER.

SEWER AND WATER MAINS

INLET FILTERS SHALL BE USED ON ALL EXISTING DRAINAGE STRUCTURES, OR AS REQUIRED BY THE ENGINEER.

ANY LOOSE MATERIAL DEPOSITED IN THE FLOW LINE OF DRAINAGE STRUCTURES, WHICH OBSTRUCTS THE NATURAL FLOW OF WATER SHALL BE REMOVED AT THE CLOSE OF EACH WORKING DAY, PRIOR TO ACCEPTANCE OF THE IMPROVEMENT. ALL DRAINAGE STRUCTURES SHALL BE FREE OF DIRT AND DEBRIS. WHEN EXISTING DRAINAGE FACILITIES ARE DISTURBED, THE CONTRACTOR SHALL PROVIDE AND MAINTAIN IN AN OPERATING CONDITION TEMPORARY OUTLETS AND CONNECTIONS FOR ALL DRAINS, SEWERS AND CATCH BASINS. THE CONTRACTOR SHALL PROVIDE FACILITIES WHICH HAVE THE CAPACITY TO RECEIVE AND DISCHARGE THE STORM WATER FLOW RATES NORMALLY ACCEPTED AND RELEASED BY EXISTING DRAINAGE FACILITIES.

ALL FRAMES, GRATES, LIDS, AND BOXES SCHEDULED TO BE REMOVED FROM EXISTING STRUCTURES SHALL REMAIN THE PROPERTY OF MCHENRY COUNTY OR STATE, AS APPLICABLE. ANY ITEMS DAMAGED DURING REMOVAL SHALL BE REPLACED BY THE CONTRACTOR.

ALL FRAMES WITH CLOSED LIDS TO BE FURNISHED, AS PART OF THIS CONTRACT SHALL HAVE CAST INTO THE LID ONE OF THE FOLLOWING WORDS: FOR STORM SEWER STRUCTURES "STORM", FOR SANITARY SEWER STRUCTURES "SANITARY", FOR WATER SYSTEM STRUCTURES "WATER",

FRAME ELEVATIONS GIVEN ON THE PLANS ARE ONLY TO ASSIST THE CONTRACTOR IN DETERMINING THE APPROXIMATE OVERALL HEIGHT OF THE STRUCTURE. FRAMES ON ALL STRUCTURES WILL BE ADJUSTED TO THE FINAL ELEVATION AND CROSS SLOPE OF THE AREA IN WHICH THEY ARE LOCATED.

BEFORE STARTING ANY EXCAVATIONS, THE CONTRACTOR SHALL CALL J.U.L.I.E. AT (800)-892-0123 OR AT 811. THE PUBLIC & PRIVATE UTILITY CONTACTS OPERATING WITHIN THE PROJECT LIMITS ARE AS FOLLOWS:

SEDIMENTATION & EROSION CONTROL NOTES

EROSION CONTROL AND SEDIMENT CONTROL MEASURES SHALL BE IN ACCORDANCE WITH THE SWPPP FOR THE PROJECT AND THE FOLLOWING COMMENTS

SOIL DISTURBANCE SHALL BE CONDUCTED IN SUCH A MANNER AS TO MINIMIZE EROSION. SOIL-STABILIZATION MEASURES SHALL CONSIDER THE TIME OF YEAR, SITE CONDITIONS, AND THE USE OF TEMPORARY OR PERMANENT MEASURES. SOIL-EROSION AND SEDIMENT-CONTROL FEATURES SHALL BE CONSTRUCTED PRIOR TO THE COMMENCEMENT OF LAND AND EARTH DISTURBANCE OF UPLAND AREAS.

DISTRUBED AREAS SHALL BE STABILIZED WITH TEMPORARY OR PERMANENT MEASURES AS SOON AS PRACTICAL IN PORTIONS OF THE SITE WHERE CONSTRUCTION ACTIVITIES HAVE TEMPORARILY OR PERMANENTLY CEASED, BUT IN NO CASE MORE THAN 7 DAYS AFTER THE CONSTRUCTION ACTIVITY.

AREAS OR EMBANKMENTS HAVING SLOPES GREATER THAN 3H:1V SHALL BE STABILIZED WITH SOD, MAT, OR BLANKET IN COMBINATION WITH SEEDING.

ALL STORM SEWERS THAT ARE OR WILL BE FUNCTIONING DURING CONSTRUCTION SHALL BE PROTECTED BY AN APPROPRIATE SEDIMENT-CONTROL MEASURE AS FOUND IN THE SWPPP.

ALL TEMPORARY EROSION AND SEDIMENT-CONTROL MEASURES SHALL BE REMOVED WITHIN 30 DAYS AFTER FINAL SITE STABILIZATION IS ACHIEVED OR AFTER THE TEMPORARY MEASURES ARE NO LONGER NEEDED.

ALL TEMPORARY AND PERMANENT EROSION-CONTROL MEASURES MUST BE MAINTAINED AND REPAIRED BY THE CONTRACTOR AS NEEDED WITHIN 24 HOURS OF DISCOVERY. MAINTENANCE NOT PERFORMED IN A TIMELY FASHION MAY RESULT IN AN INCIDENCE OF NON-COMPLIANCE.

A STABILIZED MAT OF AGGREGATE UNDERLAIN WITH FILTER CLOTH (OR OTHER APPROPRIATE MEASURE) SHALL BE LOCATED AT ANY POINT WHERE TRAFFIC WILL BE ENTERING OR LEAVING A CONSTRUCTION SITE TO OR FROM A PUBLIC RIGHT-OF-WAY, STREET, ALLEY, OR PARKING AREA. ANY SEDIMENT OR SOIL REACHING AN IMPROVED RIGHT-OF-WAY, STREET, ALLEY, OR PARKING AREA SHALL BE REMOVED BY SCRAPING OR STREET CLEANING AS ACCUMULATIONS WARRANT AND TRANSPORTED TO A CONTROLLED SEDIMENT-DISPOSAL AREA. ALL OF THIS WORK WILL BE IN COMPLIANCE WITH THE DETAILS AND PROVISIONS SPECIFIED FOR STABILIZED CONSTRUCTION ENTRANCE.

SOIL STOCKPILES SHALL NOT BE LOCATED IN A FLOOD-PRONE AREA OR A DESIGNATED BUFFER PROTECTING WATERS OF THE UNITED STATES.

IF DE-WATERING SERVICES ARE USED, ADJOINING PROPERTIES AND DISCHARGE LOCATIONS SHALL BE PROTECTED FROM EROSION. DISCHARGES SHALL BE ROUTED THROUGH AN EFFECTIVE SEDIMENT-CONTROL MEASURE (e.g. SEDIMENT TRAP, SEDIMENT BASIN, FILTER BAG OR OTHER APPROVED MEASURE).

THE EROSION-CONTROL MEASURES INDICATED ON THE PLANS ARE THE MINIMUM REQUIREMENTS.

ADDITIONAL MEASURES MAY BE REQUIRED. AS DIRECTED BY THE ENGINEER OR GOVERNING AGENCY

EARTH EXCAVATION SHALL CONSIST OF THE EXCAVATION AND TRANSPORTATION OF ALL EARTH AS SHOWN ON THE CROSS SECTIONS THROUGHOUT THE LIMITS OF THE CONTRACT. ANY OF THE EXACAVATED MATERIALS THAT ARE UNSUITABLE FOR EMBANKMENT UNDER THE PAVEMENT SHALL BE USED AT OTHER LOCATIONS PROVIDED BY THE CONTRACTOR.

THE CONTRACTOR'S ATTENTION IS CALLED TO THE FACT THAT THE PRESERVATION OF EXISTING TREES IS OF UTMOST IMPORTANCE TO THE CITY OF MCHENRY, THE CONTRACTOR SHALL TAKE PRECAUTION BY PRESERVING EXISTING TREES WITHIN THE RIGHT OF WAY. IF ANY DAMAGE OCCURS, TREES SHALL BE REPLACED IN KIND PER ARTICLE 201.07. REPAIR OR REPLACEMENT OF EXISTING PLANT MATERIAL REQUIREMENTS STATED HEREIN.

EXISTING VEGETATED AREAS (TREES, SHRUBS, VEGETATIVE BUFFERS, TURF AREAS, ETC.) WHERE DISTURBANCE IS NOT OCCURRING (INCLUDING AREAS OUTSIDE THE PROJECT LIMITS) SHALL NOT BE DISTURBED TO ENSURE THAT EXISTING VEGETATION IS PRESERVED HEALTHY TO MINIMIZE SOIL EROSION AND TO ELIMINATE SOIL COMPACTION. NO MATERIALS ARE TO BE STORED OR VEHICLES DRIVEN OR PARKED WITHIN THESE UNDISTURBED AREAS AT ANY TIME.

PHOSPHORUS-FREE FERTILIZER HAS BEEN INTENTIONALLY OMITTED. A PHOSPHORUS-FREE FERTILIZER IN THAT AREA SHALL BE USED (MIDDLE NUMBER SHOULD EQUAL 0).

MISCELLANEOUS

THE CONTRACTOR SHALL MAINTAIN EXISTING SIDE STREET ACCESS, EXISTING DRIVEWAY ACCESS, AND PEDESTRIAN ACCESS TO ABUTTING PROPERTY AT ALL TIMES DURING CONSTRUCTION OF THE PROJECT UNLESS A DETOUR PLAN IS PROVIDED IN THE PLANS.

WHERE NEW WORK MEETS EXISTING FEATURES TO REMAIN, FIELD CHECK ALL DIMENSIONS AND ELEVATIONS BEFORE

IT IS THE CONTRACTOR'S RESPONSIBILTY TO ASCERTAIN EXISTING FIELD CONDITIONS BEFORE BIDDING ON THIS CONTRACT.

PROCEEDING WITH CONSTRUCTION. NOTIFY ENGINEER IMMEDIATELY OF ANY DISCREPANCIES.

THE CONTRACTOR WILL BE REQUIRED TO COMPLY WITH ALL STATE REGULATIONS REGARDING AIR, WATER, AND

NOISE POLLUTION. THE CONTRACTOR IS PROHIBITED FROM BURNING ANY MATERIAL WITHIN OR ADJACENT TO THE IMPROVEMENT.

ALL DISTURBED AREAS WITHIN THE PROJECT THAT ARE NOT OTHERWISE PAVED SHALL BE SEEDED. SEED LIMITS SHOWN ON THE PLANS ARE THE MAXIMUM PAY WIDTHS FOR PAYMENT PURPOSES. FERTILIZER NUTRIENTS.

USE A FERTILIZER WITH AN ANALYSIS OF 1:1 RATIO AT THE FOLLOWING RATE PER ACRE:

NITROGEN FERTILIZER NUTRIENT 90 LBS POTASSIUM FERTILIZER NUTRIENT 90 LBS

FERTILIZER IS NOT REQUIRED FOR SEEDING CLASS 3, 4, 4A, 4B, 5A, 5B, AND 7.

THE CONTRACTOR SHALL BE REQUIRED TO TEMPORARILY RESET ALL EXISTING MAILBOXES WHICH INTERFERE WITH THIER CONSTRUCTION OPERATIONS, AND AFTER COMPLETION OF ROADWAY CONSTRUCTION, TO SET THEM IN THEIR PERMANENT LOCATIONS AS DIRECTED BY THE ENGINEER. THIS WORK SHALL BE IN COMFORMANCE WITH ARTICLE 107.20 OF THE STANDARD SPECIFICATIONS.

THE CONTRACTOR SHALL BE SOLELY RESPONSIBLE FOR THEIR WORK. ANY WORK THAT IS VANDALIZED OR OTHERWISE DAMAGED AND JUDGED UNACCEPTABLE BY THE ENGINEER SHALL BE REMOVED AND REPLACED.

LUAMBT	ON, LENZINI AND RENWICK, INC.	USER NAME = ajungermann	DESIGNED -	REVISED -
HAWPI	380 SHEPARD DRIVE ELGIN, ILLINOIS 60123		DRAWN - SMS	REVISED -
HAR	ILLINOIS PROFESSIONAL DESIGN FIRM LS / PE / SE CORP. 184,000959	PLOT SCALE = 2.0000 / in.	CHECKED -	REVISED -
	LS / PE / SE CORP. 184.000959	PLOT DATE = 11/1/2023	DATE -	REVISED -

STATE OF ILLINOIS
DEPARTMENT OF TRANSPORTATION

SCALE: N.T.S.

SHEET

BULL VALLEY ROAD		F.A.U. RTE	SEC.	TION		COUNTY	TOTAL SHEETS	SHEE
GENERAL NOTES		3860	21-0009	1-00-RS		MCHENRY	24	2
GENERAL NOTES						CONTRACT	NO. 6	1J96
OF SHEETS STA	TO STA			ILLINOIS.	EED A	D DDOJECT		

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				80% FED			İ	
				20% LOCAL ROADWAY				1
CODE	ITEM	UNIT	TOTAL	0005				
NO.	11211	OWIT	QUANTITY	URBAN				
				UNDAN				
21101615	TOPSOIL FURNISH AND PLACE, 4 INCH	SQ YD	2208	2208				
35000010								
25000210	SEEDING, CLASS 2A	ACRE	0.75	0.75				
25000400	NITROGEN FERTILIZER NUTRIENT	POUND	50	50				
23000100	THE PERSON NAMED IN CONTRACTOR OF THE PE	1 0010						
25000600	POTASSIUM FERTILIZER NUTRIENT	POUND	50	50				
25100115	MULCH, METHOD 2	ACRE	0.75	0.75				
20000250	TEMPORARY ERROLLON CONTROL SEED INC	201112			1			
28000250	TEMPORARY EROSION CONTROL SEEDING	POUND	50	50				
28000305	TEMPORARY DITCH CHECKS	FOOT	78	78				
	TELL OWN DITCH CITCHS	1001	,,,					
28000400	PERIMETER EROSION BARRIER	FOOT	922	922				
				······································			-	
35102000	AGGREGATE BASE COURSE, TYPE B, 8"	SQ YD	21	21				
								-
35000300	ACCRECATE DAGE DERAID	TON		226				
35800200	AGGREGATE BASE REPAIR	TON	336	336				
40600290	BITUMINOUS MATERIALS (TACK COAT)	POUND	6163	6163				
.0000250	and an internal and an interna	1 00115						
40600400	MIXTURE FOR CRACKS, JOINTS, AND FLANGEWAYS	TON	11	11				
			***************************************				1	-
					1			1
40600982	HOT-MIX ASPHALT SURFACE REMOVAL - BUTT JOINT	SQ YD	127	127				
		1				1		-
					Winner			
40600000	DOLVMED TED SOT MIN ACRUM T BUNDED COURSE 11 - 27 - 27				1			
40603200	POLYMERIZED HOT-MIX ASPHALT BINDER COURSE, 1L-4.75, N50	TON	377	377				
							<u> </u>	
40604063	HOT-MIX ASPHALT SURFACE COURSE, IL-9.5, MIX"D", N70	TON	767	767				
10004002	HOLEMAN ASTROCT SOUTHER COOKSE, TE-8.3, MIN D , NVO	TON	101	707	1			1

* SPECIALTY ITEMS

HAMPTON, LENZINE AND RENWICK, INC.
2013 SILPHAND DEBYC
ELON ILLINOIS 6912
ELON ELINOIS SONOTESSONIAL DESIGN FERM
LEYPE / SE CORP. 194,002559

STATE OF ILLINOIS
DEPARTMENT OF TRANSPORTATION

BULL VALLEY ROAD SUMMARY OF QUANTITIES

SCALE: N.T.S. | SHEET 1 OF 2 SHEETS | STA.

TO STA.

CONSTRUCTION CODE

ANALYSIS OF THE PROPERTY OF TH

				80% FED	T	1	7	T	ı
				20% LOCAL					
CODE			TOTAL	ROADWAY				******	
	ITEM	UNIT	TOTAL	0005					
NO.			QUANTITY	URBAN				+	
1010000					***************************************			+	
42400200	PORTLAND CEMENT CONCRETE SIDEWALK, 5 INCH	SQ FT	193	193					
	11-7-1-1-1-1-1-1-1-1-1-1-1-1-1-1-1-1-1-							+	
4346888	DETECTABLE MARAUNCE								
42400800	DETECTABLE WARNINGS	SQ FT	20	20				•	
44000158	HOT-MIX ASPHALT SURFACE REMOVAL, 2 1/4"	SQ YD	9130	9130					
7,7000130	THOT PAY ASTRACT SOMEACE, E 174	30 10	9130	9130					
					· · · · · · · · · · · · · · · · · · ·				
44000500	COMBINATION CURB AND GUTTER REMOVAL	FOOT	15	15		ļ			
44000600	SIDEWALK REMOVAL	SQ FT	193	193					

44201692	CLASS D PATCHES, TYPE II, 4 INCH	SQ YD	112	112					

44201694	CLASS D PATCHES, TYPE 111, 4 INCH	SQ YD	112	112					
								 	
			ļ						
44201505									
44201696	CLASS D PATCHES, TYPE IV, 4 INCH	SQ YD	112	112					
		T T		***************************************					·
48102100	AGGREGATE WEDGE SHOULDERS, TYPE B	TON	104	104					
40102100	AGGREGATE WEDGE SHOULDERS, TIPE B	TON	184	184					
60604500	COMBINATION CONCRETE CURB AND GUTTER, TYPE B-6.18 (ABUTTING EXISTING PAVEMENT)	FOOT	15	15					
	FAVENCINT	,							
67100100	MOBILIZATION	L SUM	1	1					
		1		-					
]				
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70100460	TRAFFIC CONTROL STANDARD 701306	L SUM	1	1					
						<u> </u>			
					1				
								 	
70102620	TRAFFIC CONTROL STANDARD 701501	L SUM	1	1					
		1		***************************************				+	
7010000	TRAFFIC CONTROL CTANDARD TO TOO		_		***************************************		***************************************		
70102622	TRAFFIC CONTROL STANDARD 701502	L SUM	1	1					

70102640	TRAFFIC CONTOOL STANDARD 701901		,	*				<u></u>	
70102040	TRACTIC CONTROL STANDARD /01801	L SUM	1						
	TRAFFIC CONTROL STANDARD 701801	L SUM		1					

* SPECIALTY ITEMS

STATE OF ILLINOIS
DEPARTMENT OF TRANSPORTATION

BULL VALLEY ROAD
SUMMARY OF QUANTITIES

SCALE: N.T.S. SHEET 2 OF 2 SHEETS STA.

TO STA,

CONSTRUCTION CODE

					80% FED					
	CODE			TOT41	20% LOCAL ROADWAY					
	CODE NO.	ITEM	UNIT	TOTAL	0005			-		
	NO.			QUANTITY	URBAN					
	70107025	CHANGEABLE MESSAGE SIGN	CAL DA	35	35					-
									1	
	70300100	SHORT TERM PAVEMENT MARKING	FOOT	1560	1560					
	70300150	SHORT TERM PAVEMENT MARKING REMOVAL	SQ FT	173	173					
*	78000100	THERMOPLASTIC PAVEMENT MARKING - LEITERS AND SYMBOLS	SO ET	202	702		-			
	78000100	THERMOFEASTIC FAVEMENT MARKING - LETTERS AND SIMBOLS	SQ FT	203	203					
*	78000200	THERMOPLASTIC PAVEMENT MARKING - LINE 4"	FOOT	11720	11720					
*	78000400	THERMOPLASTIC PAVEMENT MARKING - LINE 6"	FOOT	972	972					
*	78000600	THERMOPLASTIC PAVEMENT MARKING - LINE 12"	FOOT	81	81					
										THE STATE OF THE S
*	78000650	THERMOPLASTIC PAVEMENT MARKING - LINE 24"	FOOT	53	53					
	78300300	DALECT DESIGNATIVE DAVEMENT MADVED DESCRIPTION	Escu	4.						
	78300200	RAISED REFLECTIVE PAVEMENT MARKER REMOVAL	EACH	41	41					
*	85000200	MAINTENANCE OF EXISTING TRAFFIC SIGNAL INSTALLATION	EACH	1	1					
	X0320050	CONSTRUCTION LAYOUT (SPECIAL)	L SUM	1	1	***************************************				
			2 33		-				***************************************	

	X2511630	EROSION CONTROL BLANKET (SPECIAL)	SQ YD	9	9					
	XX006821	CONCRETE TRUCK WASHOUT	L SUM	1	1					
					***************************************				***	

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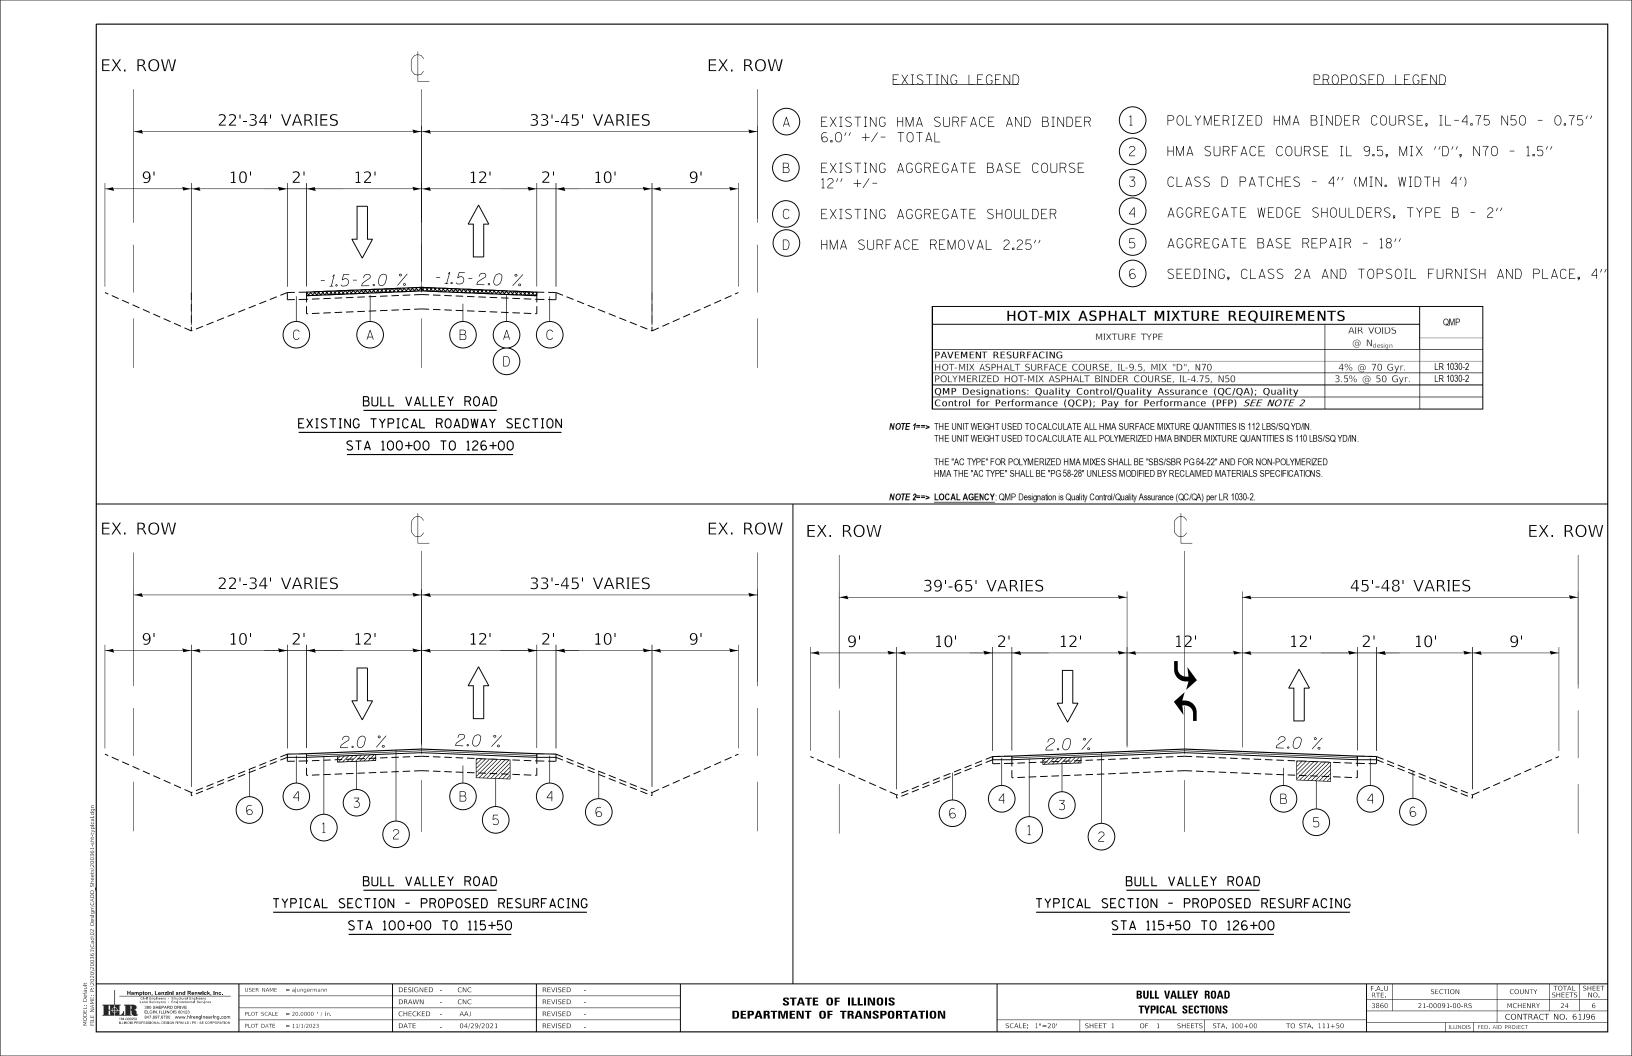
* SPECIALTY ITEMS


	1		USER NAME == ajungermann	DESIGNED -	REVISED -
	HAMPTO	I, LENZINI AND RENWICK, INC. 360 SHEPARD DRIVE ELGIN, BLINGAS 53°23		DRAWN - SMS	REVISED -
	₽⊕ AR	ALINOIS PROFESSIONAL DESIGN FIRM LEFFE / SE CORP. 14 500 153	PLOT SCALE = 2.1035 1 / in.	CHECKED -	REVISED -
÷		CELT ET SE CONT. COLORDS	PLOT DATE = 11/1/2023	DATE -	REVISED -

STATE	OF	ILLINOIS
DEPARTMENT ()F 1	TRANSPORTATION

	BULL VALLEY ROAD								SEC	пом		COUNTY	TOTAL SHEETS	SHEET NO.
ı		\$11	MMA	RV :	DF QUA	ANTITIES	•	3860	21-0009			MCHENRY	24	5
L			TAILT		UI (10)							CONTRACT		1J96
	SCALE: N.T.S. SHEET 2 OF 2 SHEETS STA. TO STA.										FED. A	D PROJECT		


CONSTRUCTION CODE




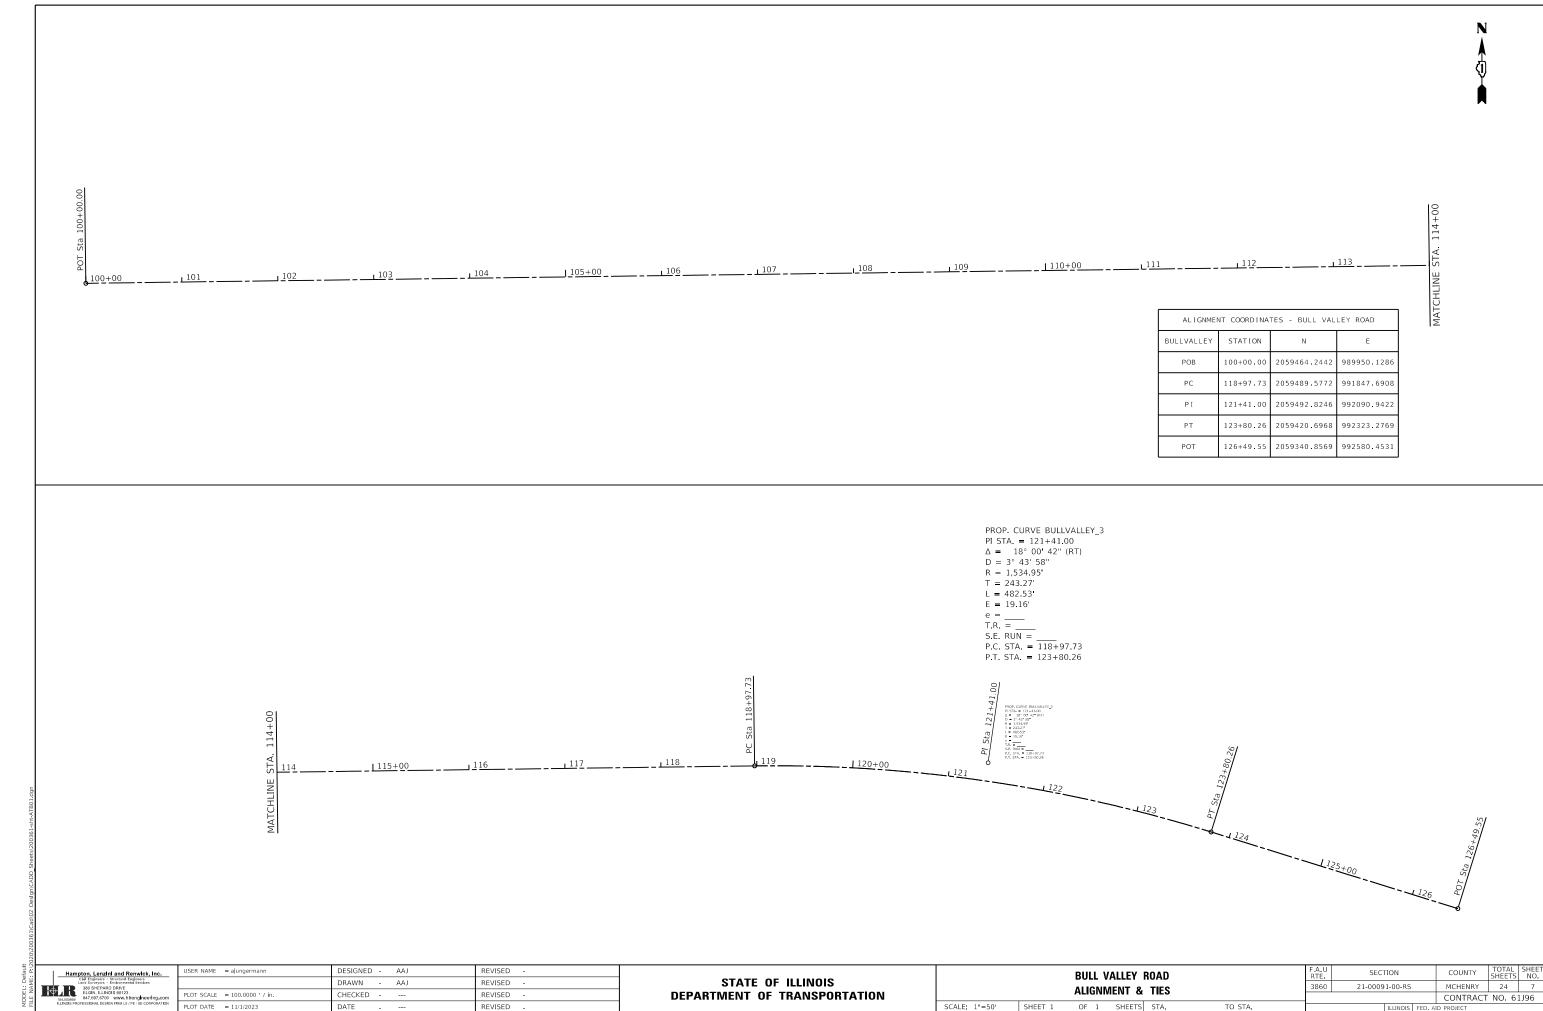



PLOT DATE = 11/1/2023 DATE REVISED


SCALE: 1"=50' SHEET 1 OF 1 SHEETS STA.

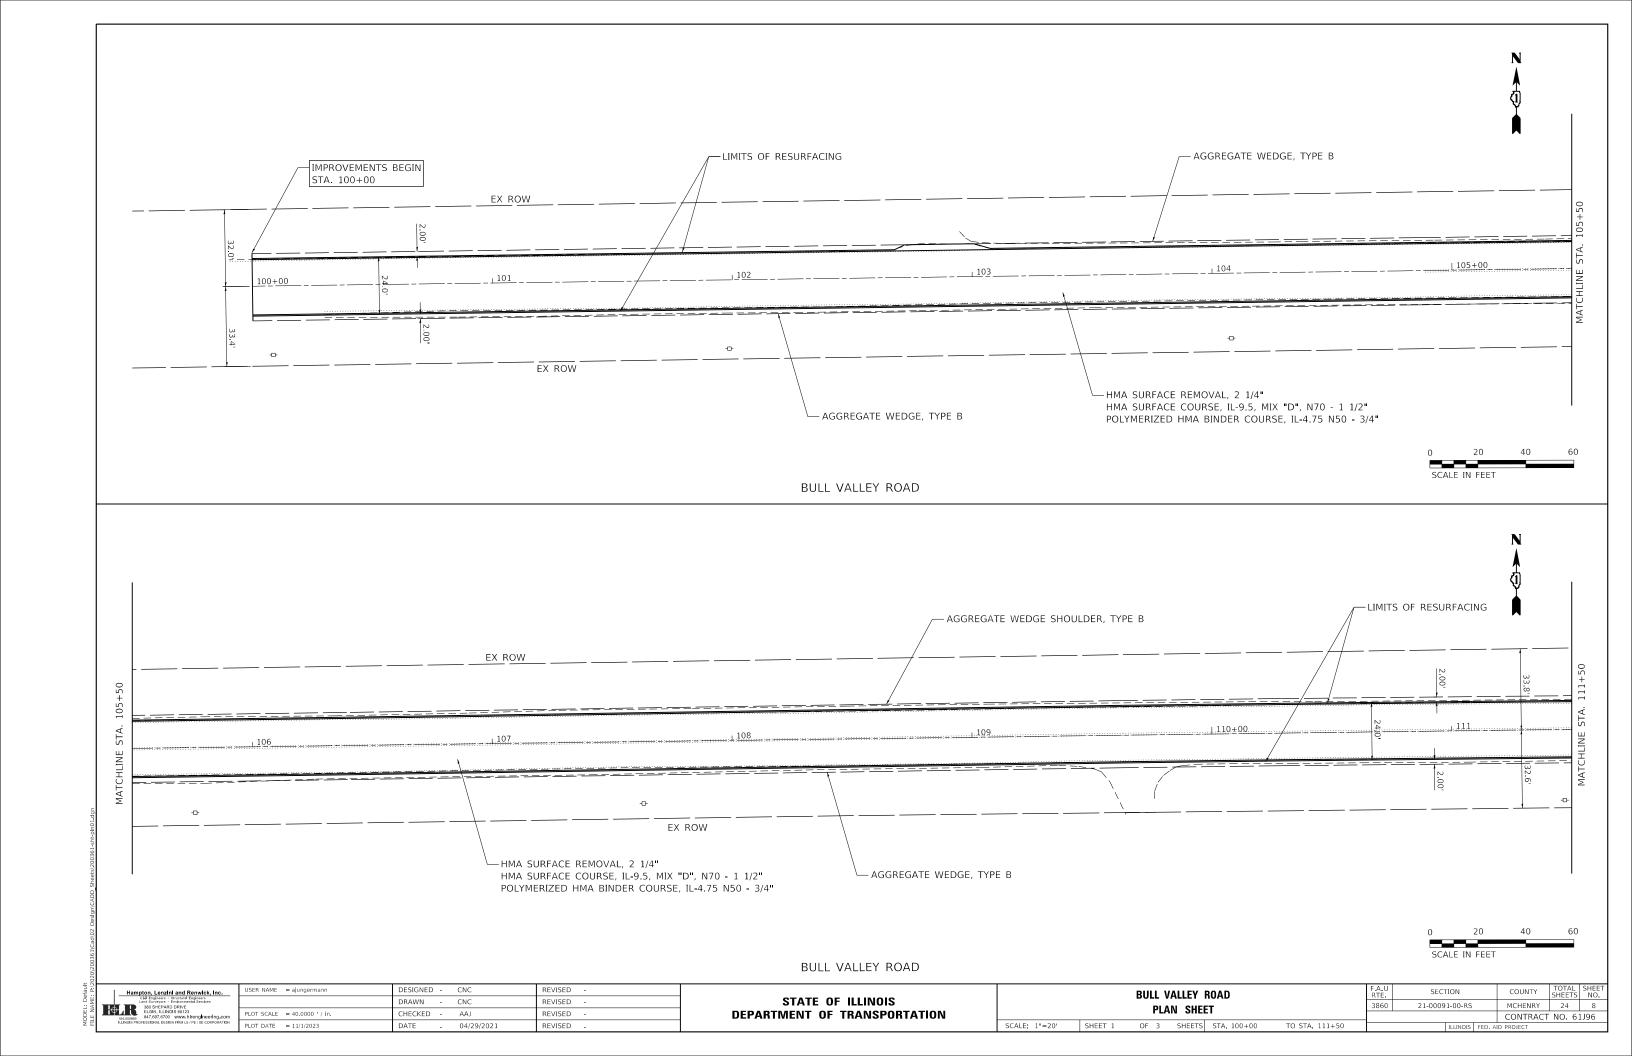


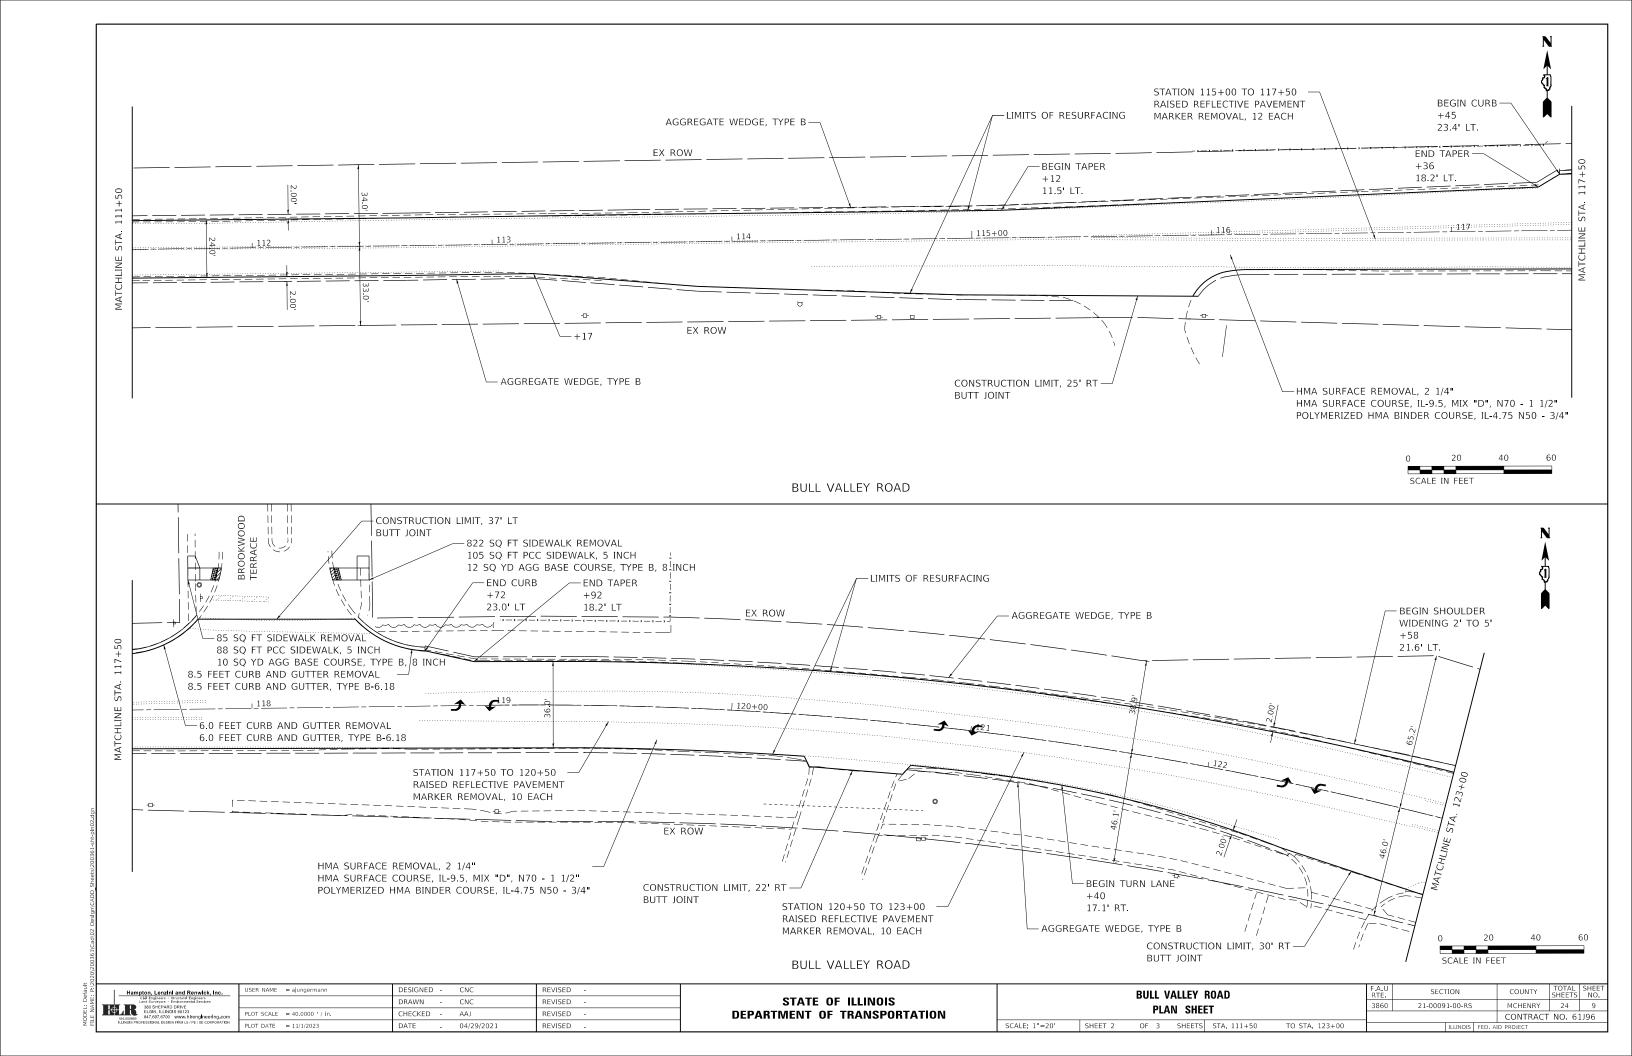


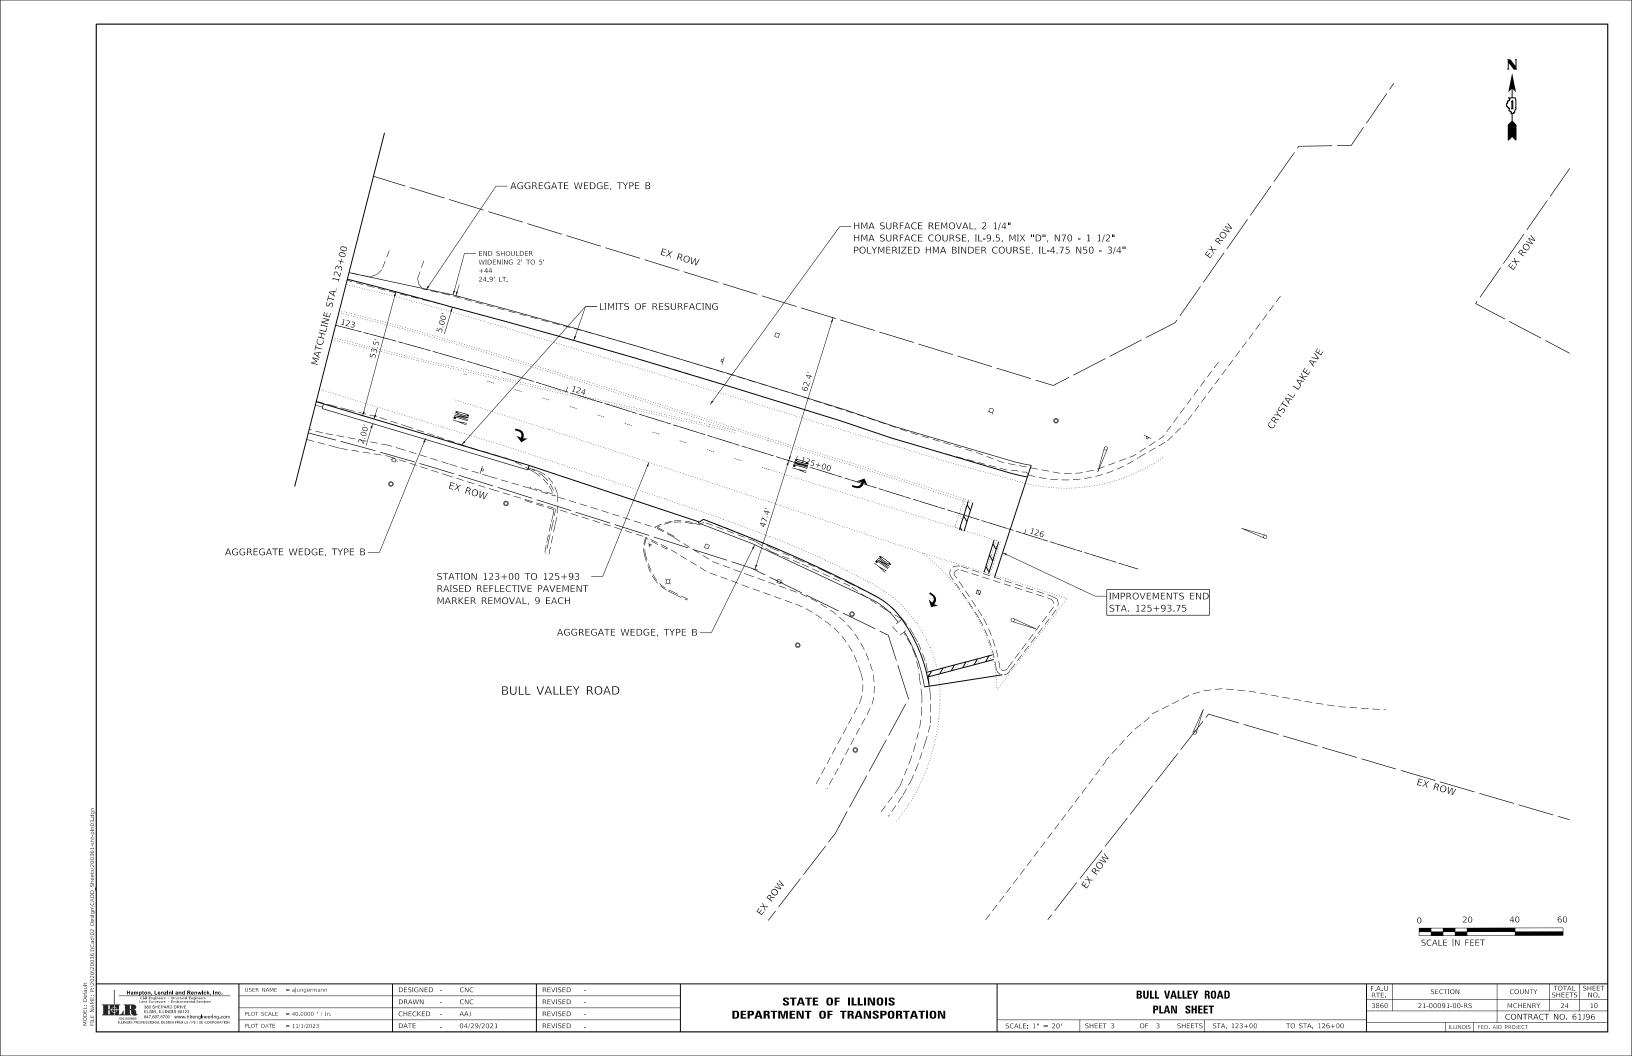


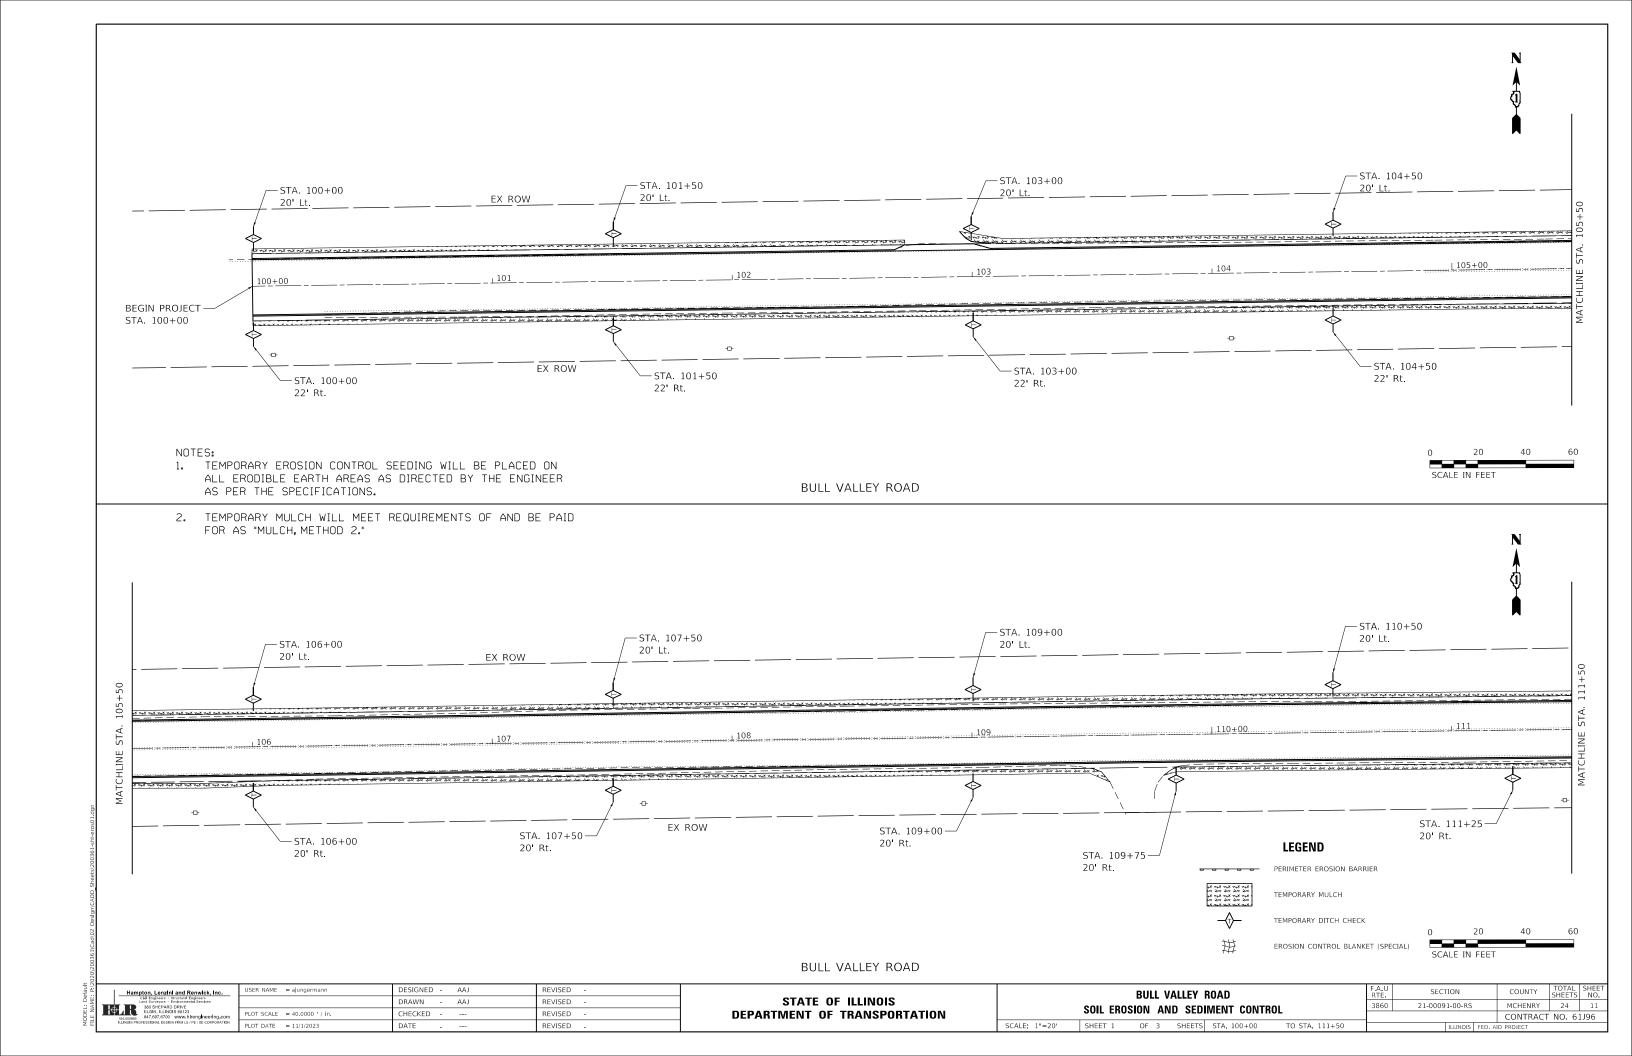


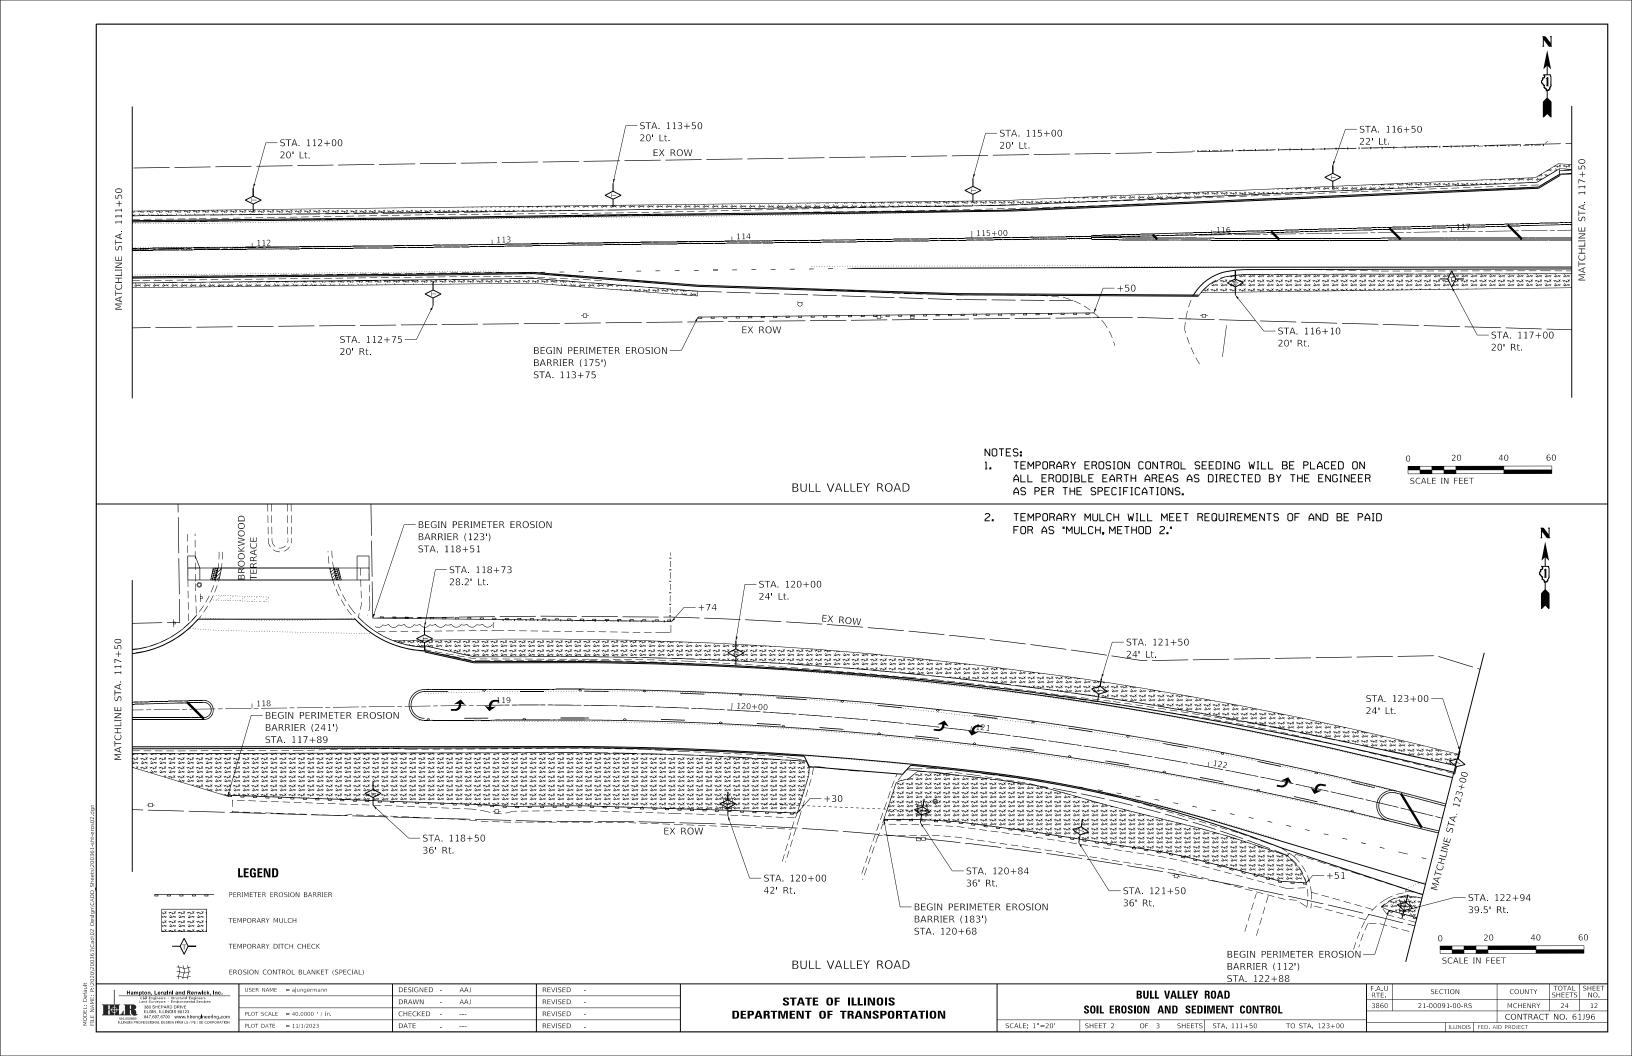


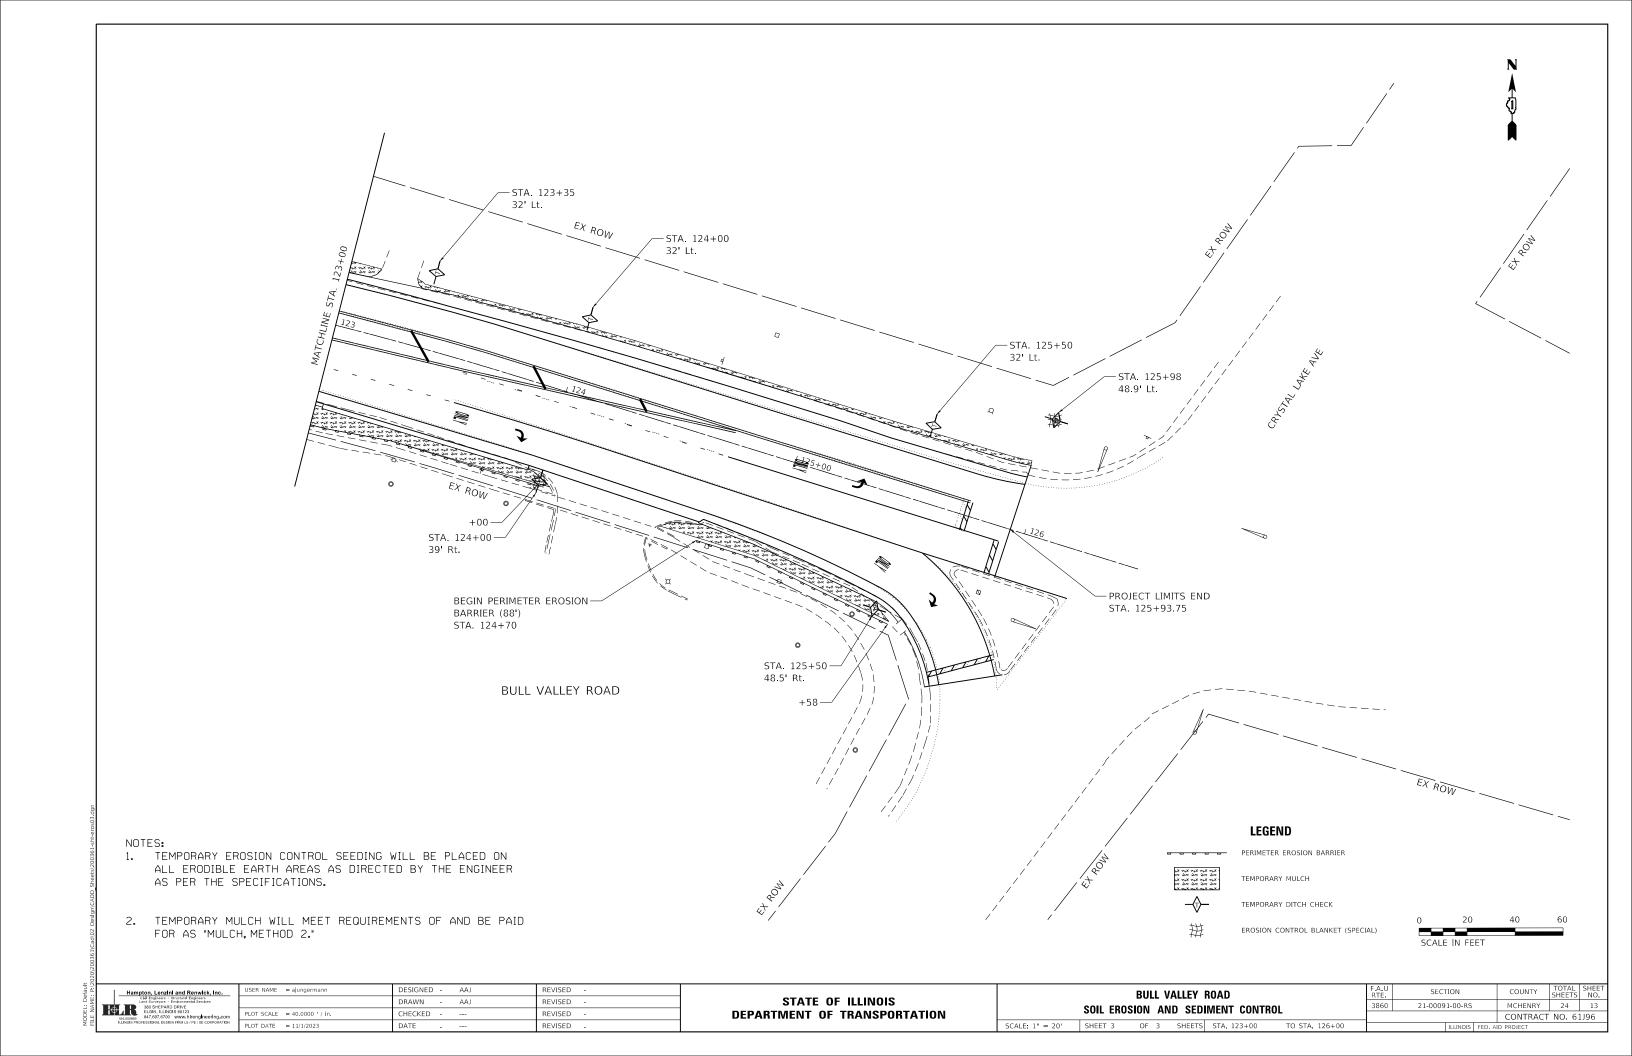


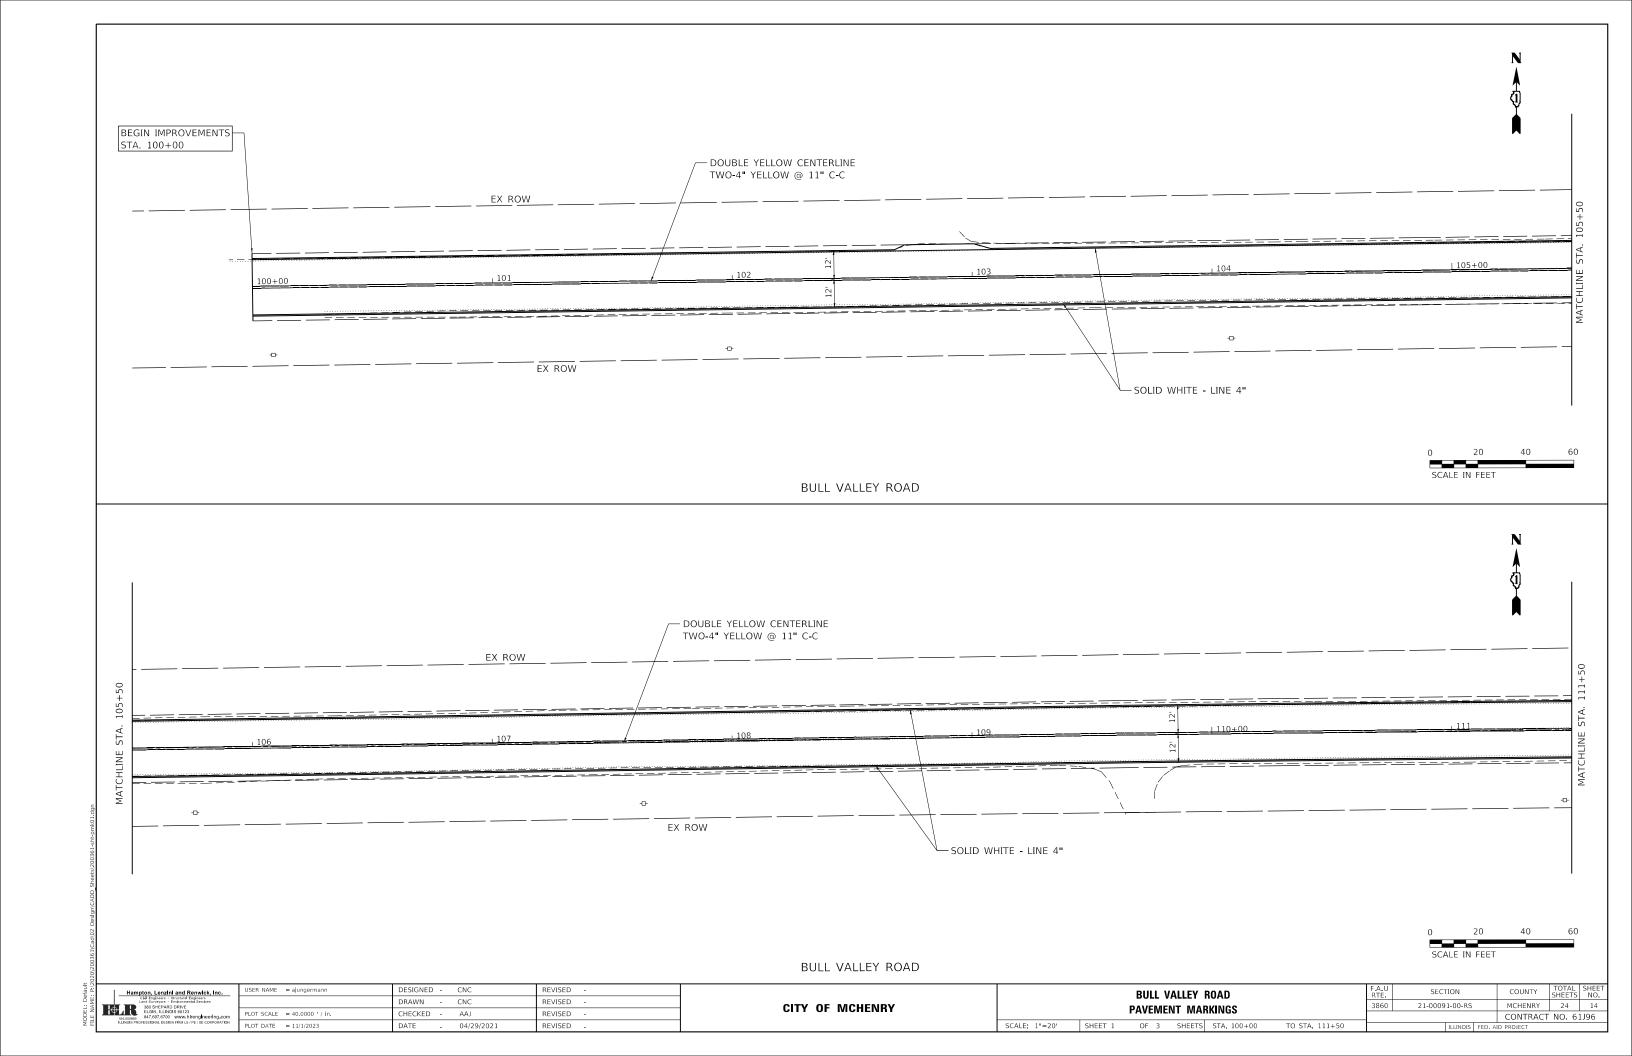


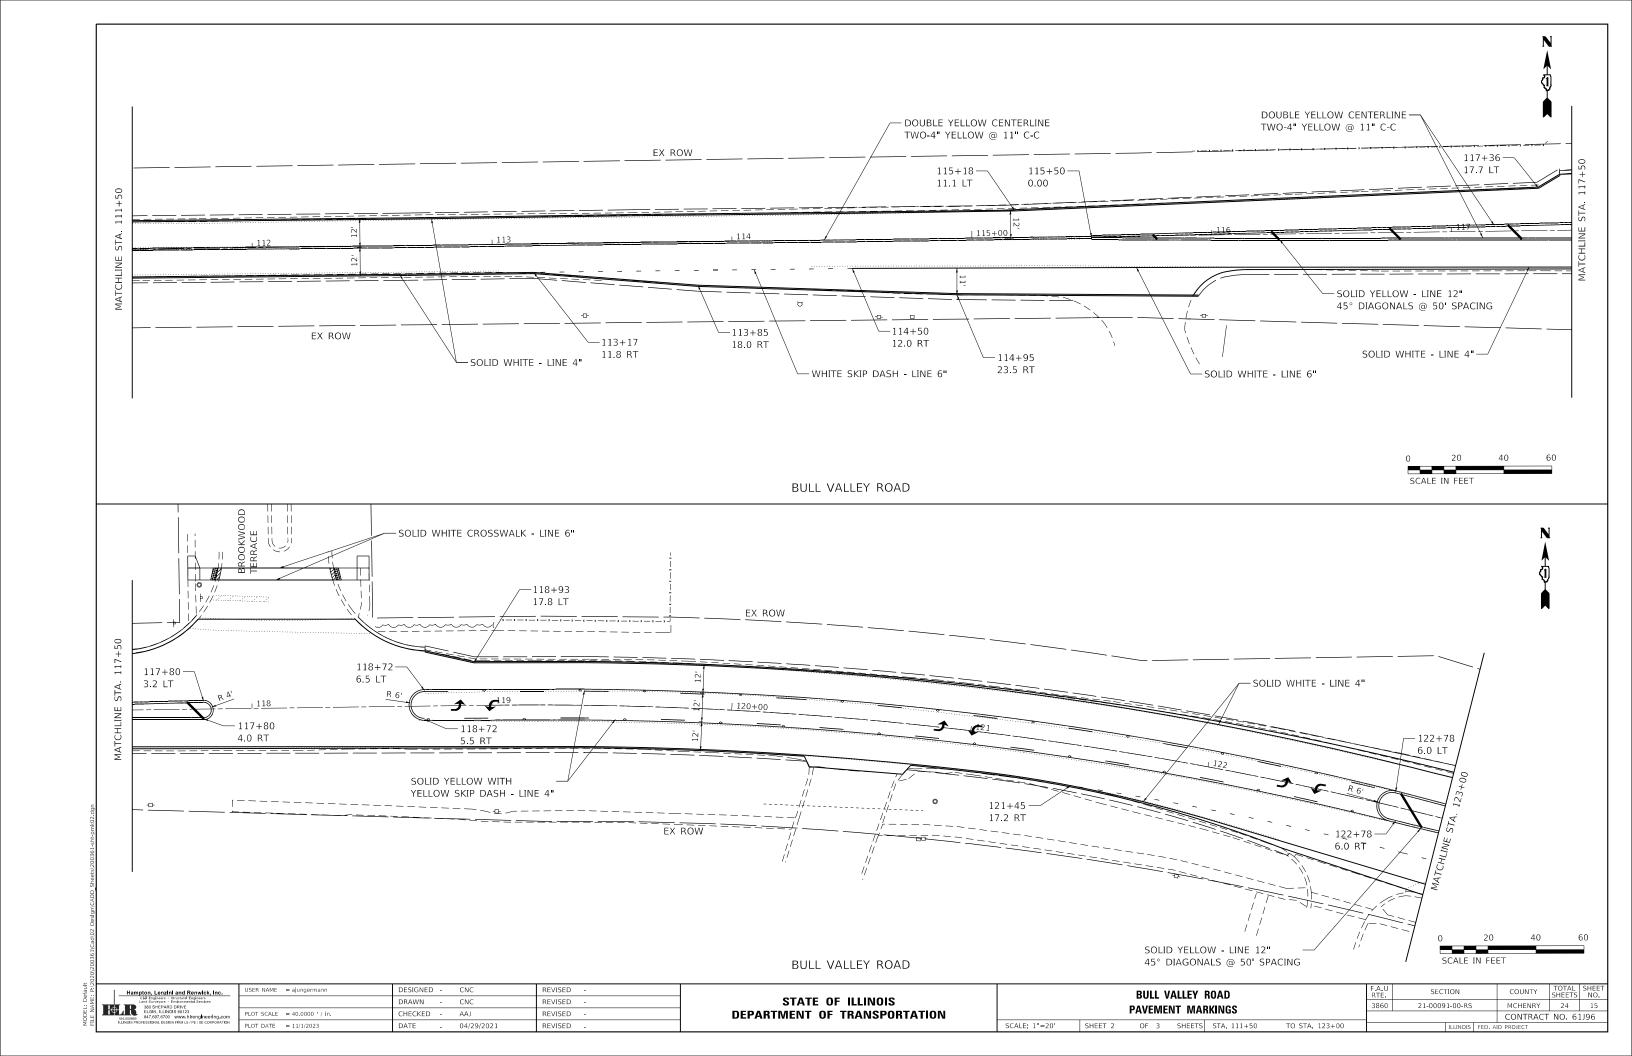


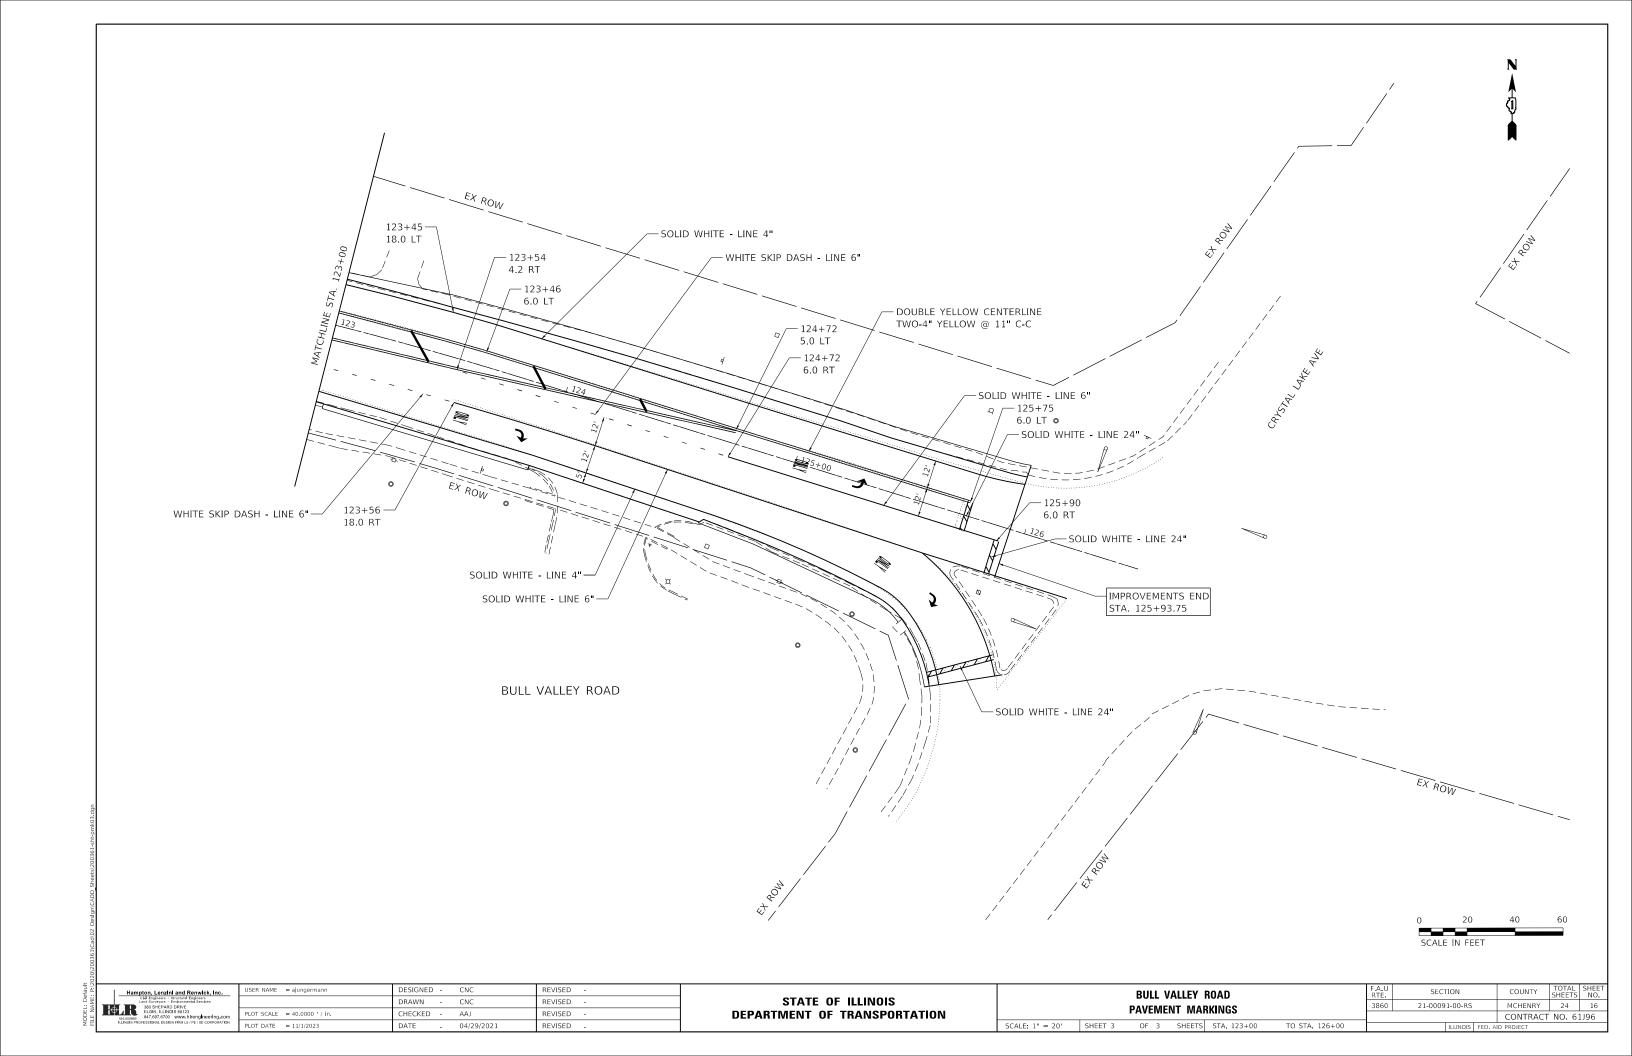

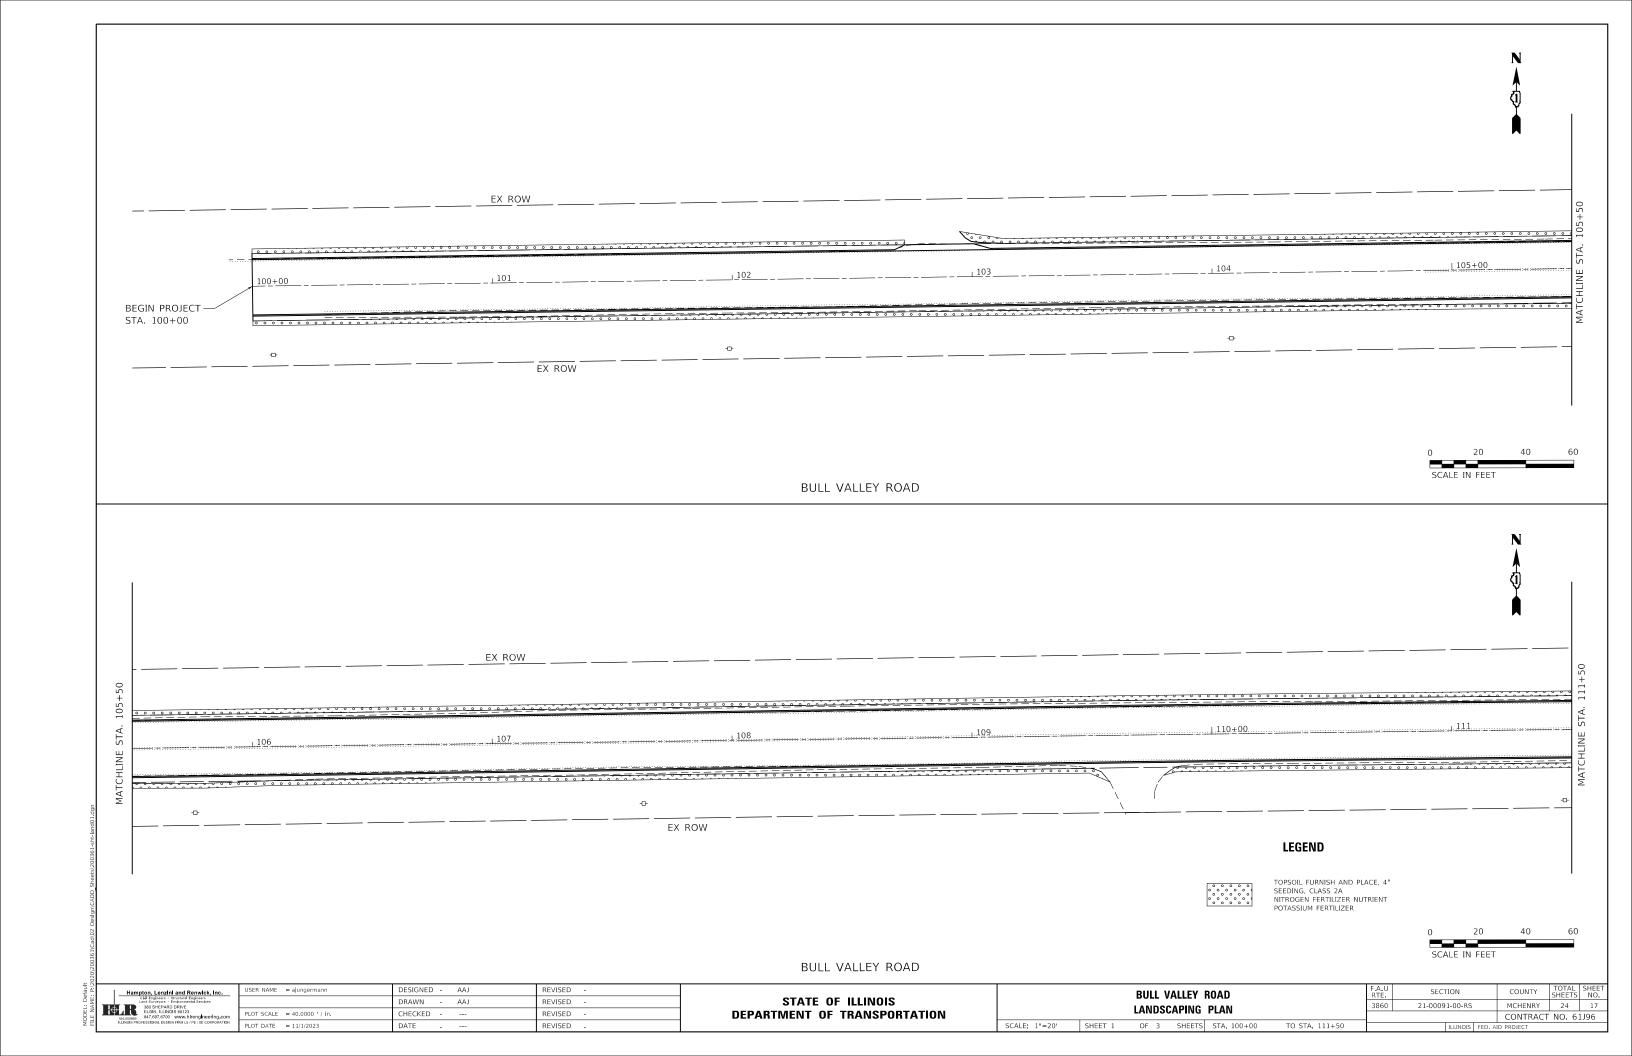


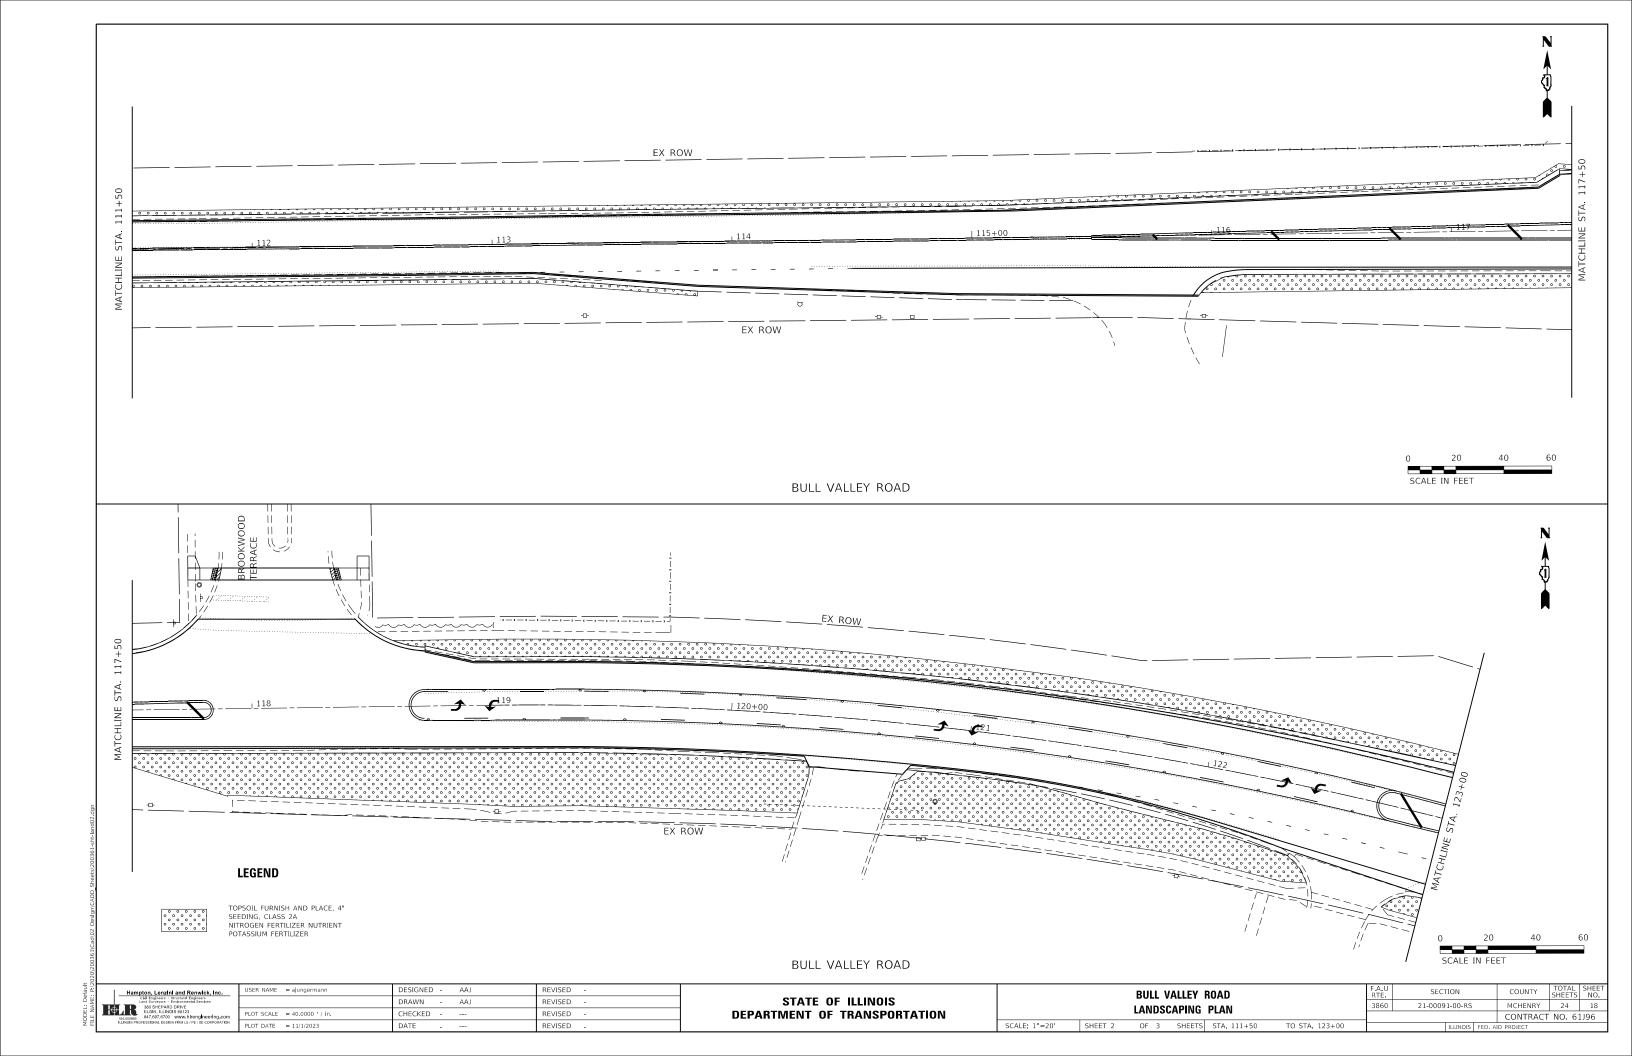

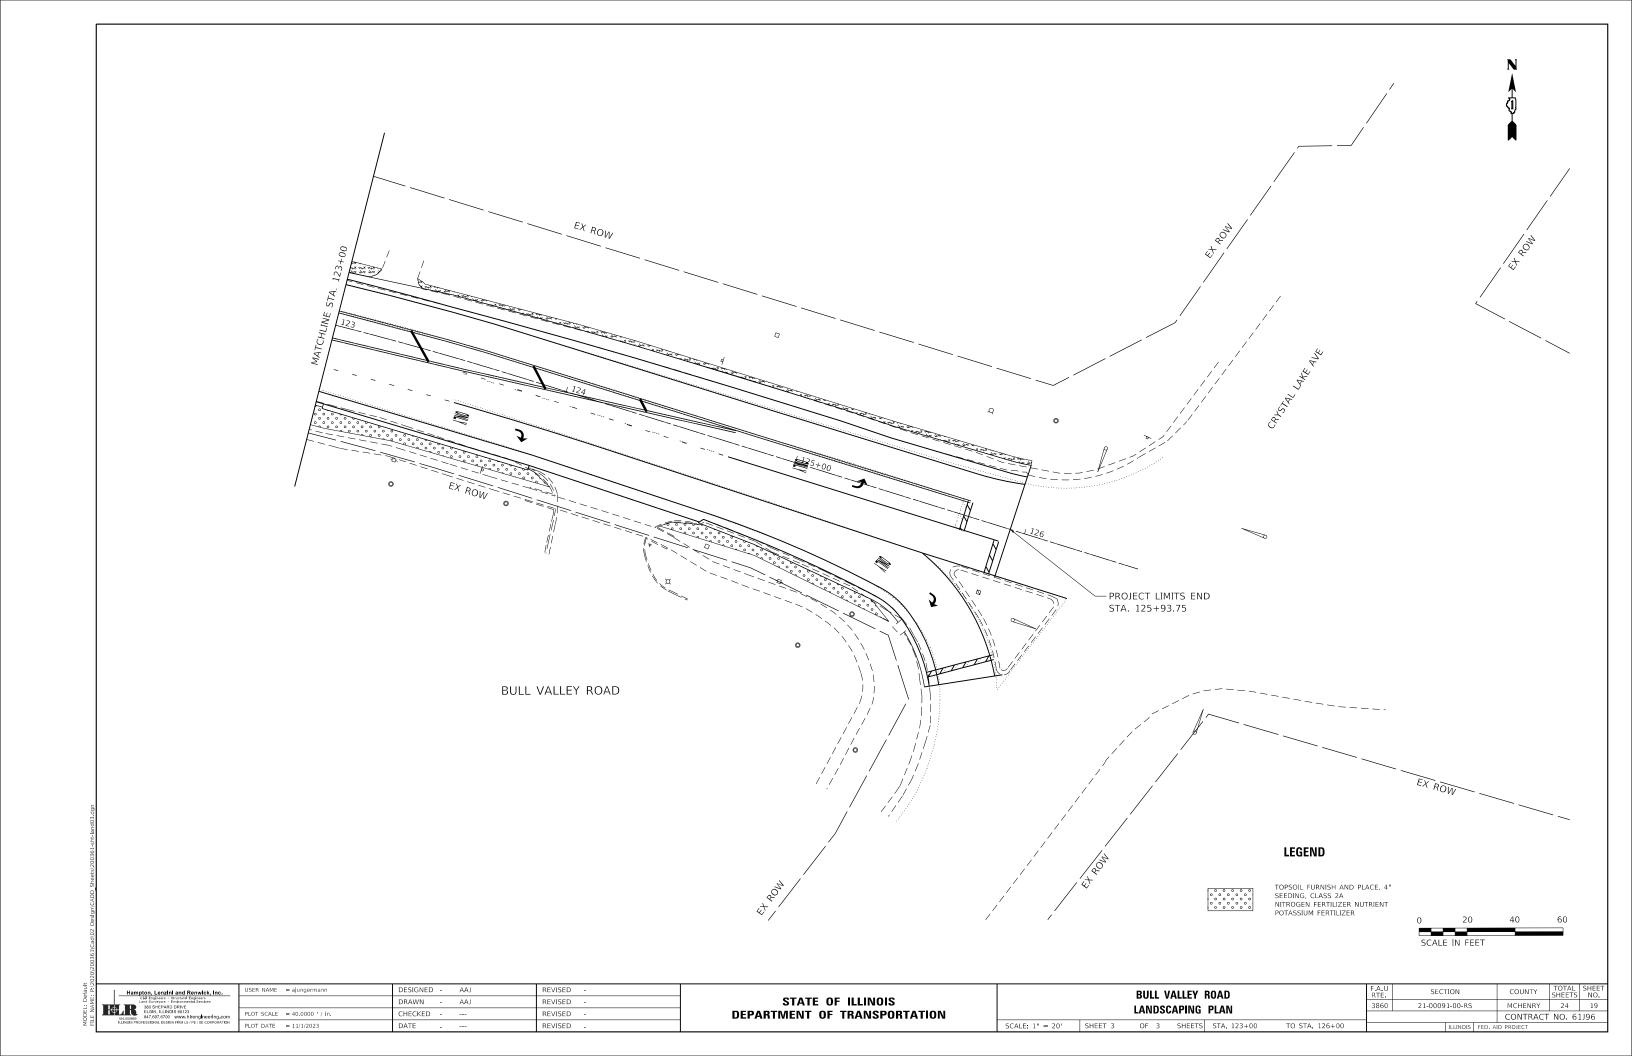

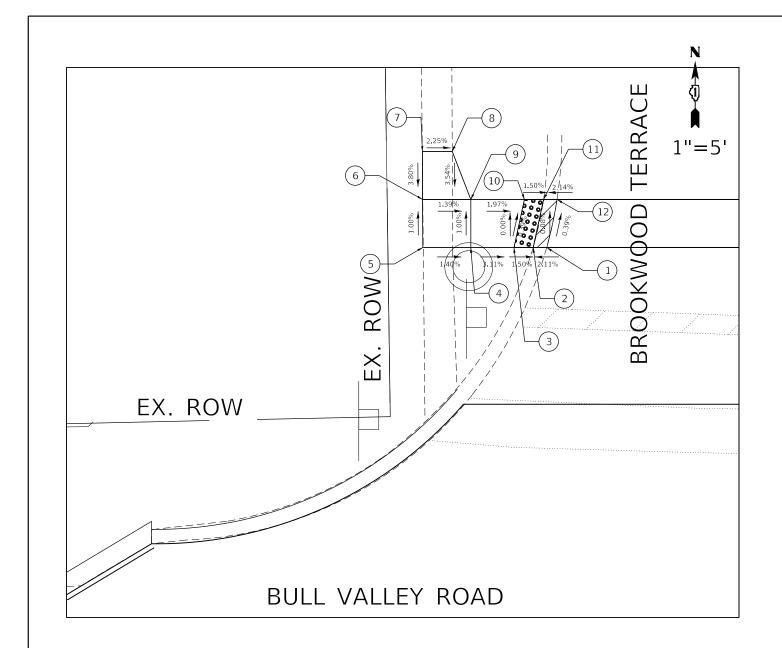

Point	Station	Offset	Elevation
1	117+86.87	53.68 Lt	815.76
2	117+85.46	53.70 Lt	815.73
3	117+83.46	53.73 Lt	815.76
4	117+78.96	53.79 Lt	815.90
5	117+73.96	53.85 Lt	815.97
6	117+74.00	58.85 Lt	815.92
7	117+74.05	63.85 Lt	816.11
8	117+77.16	63.81 Lt	816.04
9	117+79.03	58.79 Lt	815.85
10	117+84.61	58.71 Lt	815.74
11	117+86.61	58.68 Lt	815.71
12	117+88.01	58.67 Lt	815.74

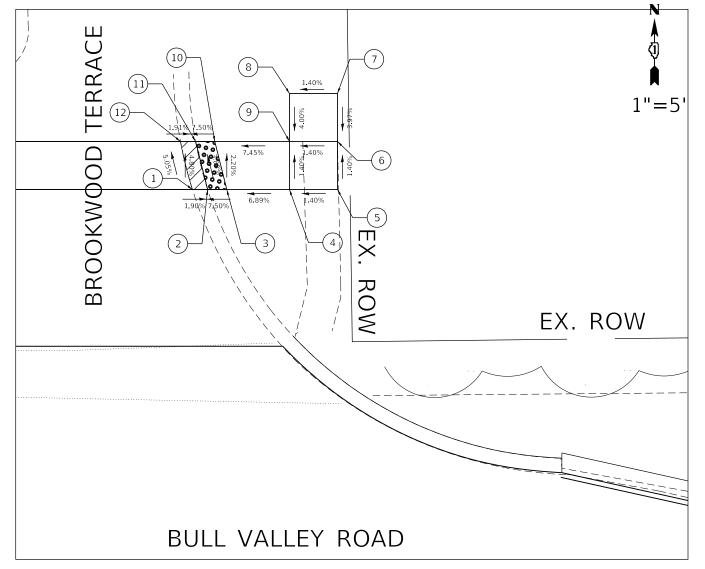


POINT	STATION	OFFSET	ELEVATION
1	118+34.35	53.04 Lt	816.20
2	118+35.93	53.03 Lt	816.17
3	118+37.93	53.00 Lt	816.32
4	118+44.46	52.91 Lt	816.77
5	118+49.46	52.84 Lt	816.84
6	118+49.53	57.81 Lt	816.77
7	118+49.60	62.84 Lt	816.97
8	118+44.6	62.91 Lt	816.90
9	118+44.53	57.91 Lt	816.70
10	118+36.74	58.02 Lt	816.12
11	118+34.74	58.04 Lt	815.97
12	118+33.17	58.31 Lt	815.94
	_	-	

NOTES

CROSS SLOPE BETWEEN POINTS 1-12, 2-11, AND CROSS SLOPE BETWEEN POINTS 3-10 ARE DESIGNED TO MAXIMUM EXTENT PRACTICABLE

OSEK NAME = ajungernann	DESIGNED - AAJ	KENISED -
	DRAWN - AAJ	REVISED -
PLOT SCALE = 10.0000 ' / in.	CHECKED -	REVISED -
PLOT DATE = 11/1/2023	DATE -	REVISED -

BULL VALLEY ROAD						F.A.U RTE	SECTION			COUNTY	TOTAL SHEETS	SHEET NO.
INTERSECTION DETAILS					3860	21-00091-0		MCHENRY	24	20		
	HALL	IJL	CIION L	LIAILS						CONTRACT	NO. 6	1J96
HEET 1	OF	3	SHEETS	STA.	TO STA.		ILLI	INOIS	FED. AI	D PROJECT		

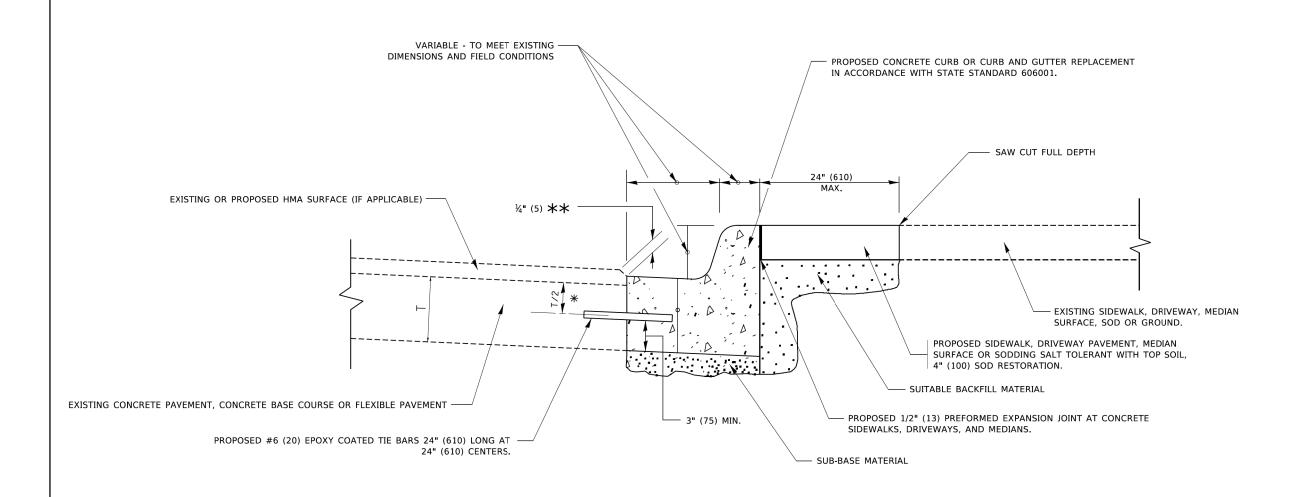

- ★ 3" (75) MINIMUM FROM TOP AND BOTTOM OF THE CONCRETE PAVEMENT OR BASE COURSE.
- $\star\star$ if the final surface of the pavement is concrete, the gutter is to be flush with the pavement.

CURB OR CURB AND GUTTER REMOVAL AND REPLACEMENT

ALL DIMENSIONS ARE IN INCHES (MILLIMETERS) UNLESS OTHERWISE SHOWN.

	USER NAME = footemj	DESIGNED - A. HOUSEH	REVISED - A. ABBAS 03-21-97	STATE OF ILLINOIS DEPARTMENT OF TRANSPORTATION	CURB OR CURB AND GUTTER REMOVAL AND REPLACEMENT			F.A. RTE.	SECTION	COUNTY	TOTAL SHEET SHEETS NO.	
		DRAWN -	REVISED - M. GOMEZ 01-22-01									
	PLOT SCALE = 50.0000 ' / in.	CHECKED -	REVISED - R. BORO 12-15-09					BD	0600-06 (BD-24)	CONTRACT	NO.	
	PLOT DATE = 7/11/2019	DATE - 03-11-94	REVISED - K. SMITH 07-11-19		SCALE: NONE	SHEET 1 OF 1 SHEETS	STA.	TO STA.		ILLINOIS FED.	AID PROJECT	

SCALE: N.T.S.


SHEET 1

LUAMBTON	LENZINI AND DENIMICK INC.	USER NAM			
HAMPION	HAMPTON, LENZINI AND RENWICK, INC. 380 SHEPARD DRIVE ELGIN, ILLINOIS 60123				
H R	ILLINOIS PROFESSIONAL DESIGN FIRM LS / PF / SE CORP 184 000959	PLOT SCA			
	LS / PE / SE CORP. 184.000959	PLOT DAT			


]	USER NAME = ajungermann	DESIGNED -	REVISED -
-		DRAWN - AC	REVISED -
4	PLOT SCALE = 2.0000 ' / in.	CHECKED -	REVISED -
	PLOT DATE = 11/1/2023	DATE -	REVISED -

STATE OF ILLINOIS					
DEPARTMENT	0F	TRANSPORTATION			

BULL VALLEY ROAD DISTRICT 1 DETAILS			F.A.U. RTE	SECTION			COUNTY	TOTAL SHEETS	SHEE
			3860	21-00091-00-RS			MCHENRY	24	21
							CONTRACT	NO. 6	1J96
OF 4 SHEETS	STA.	TO STA.			ILLINOIS	FED. A	ID PROJECT		

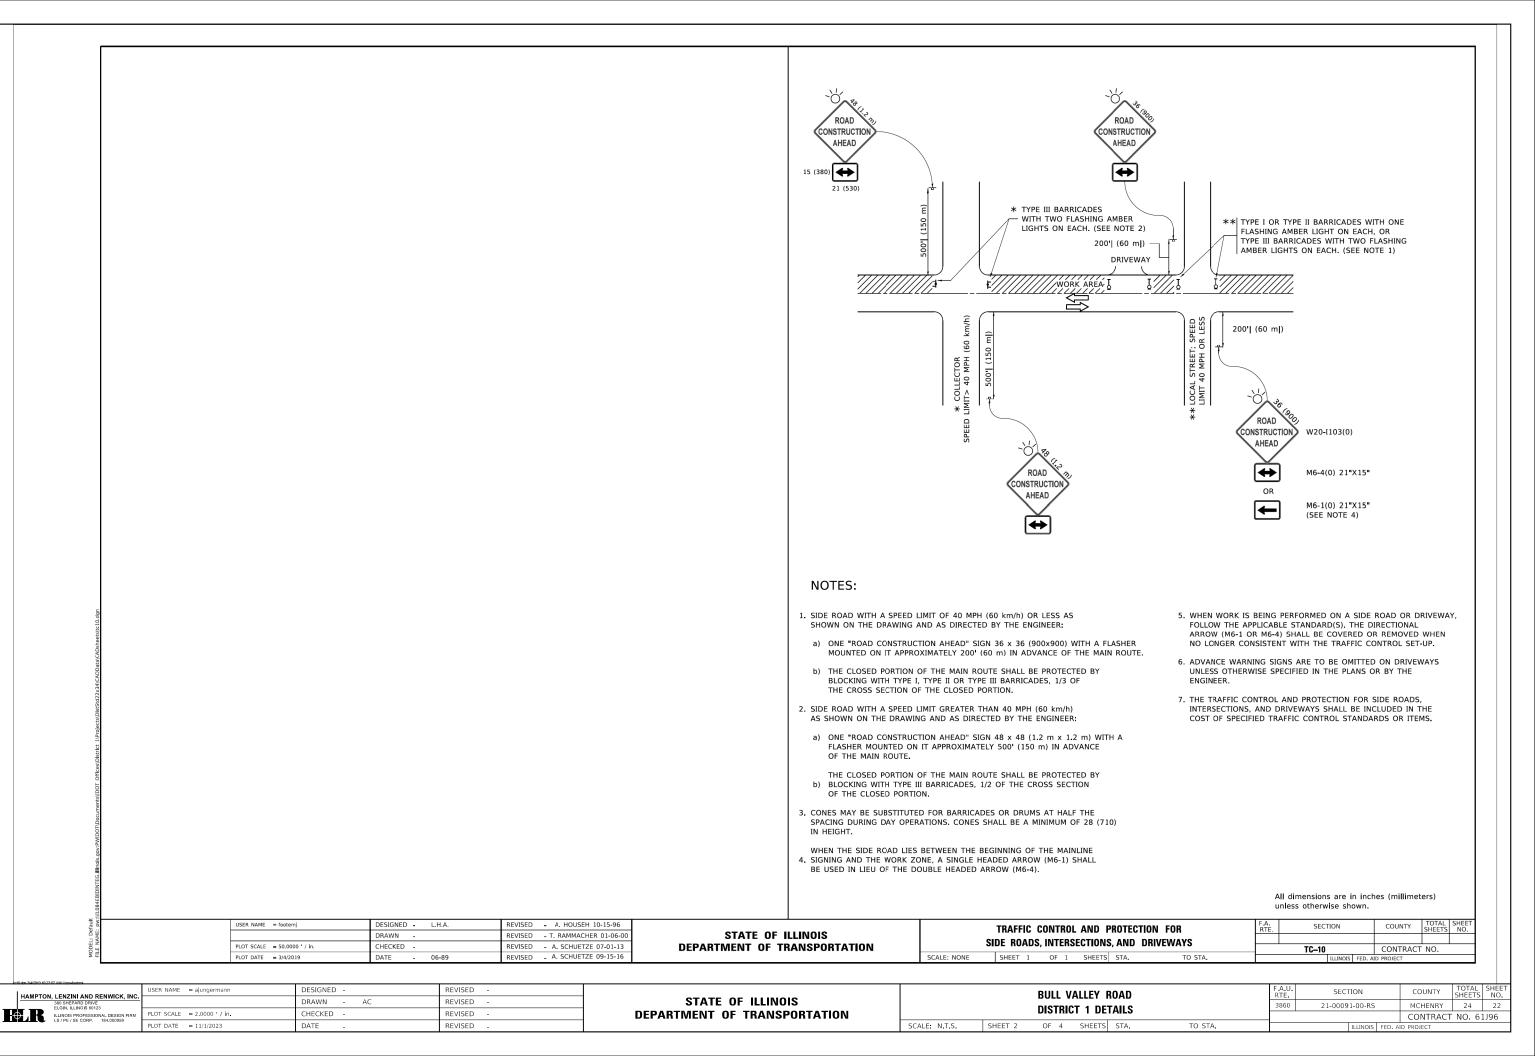

FILE NAME: P:\2020\

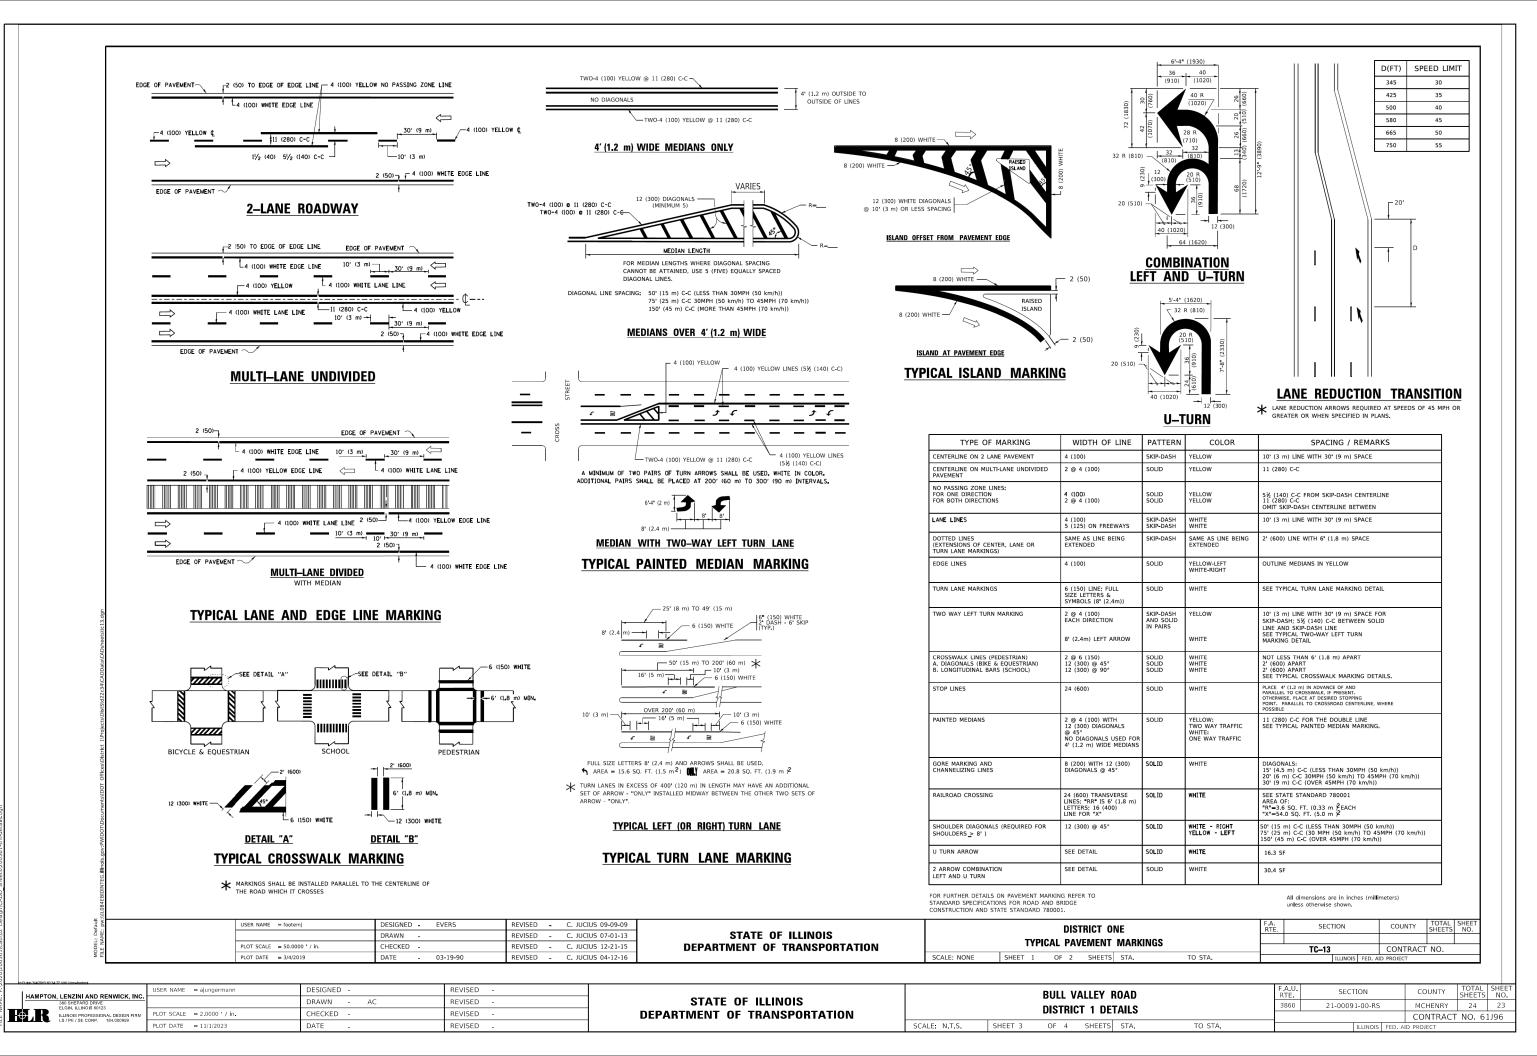

MODEL: Default

