
#### 01-19-2024 LETTING ITEM 120

INDEX OF SHEETS		
SHEET#	SHEET TITLE	
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2	HIGHWAY STANDARDS & UTILITIES	
3	GENERAL NOTES	
4-6	SUMMARY OF QUANTITIES	
7-12	SCHEDULES OF QUANTITIES	
13-16	TYPICAL SECTIONS	
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25-30	RIGHT-OF-WAY PLANS	
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42-52	PLAN AND PROFILES	
53-58	INTERSECTIONS DETAILS	
59-67	ADA DETAILS	
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82-104	CROSS SECTIONS	

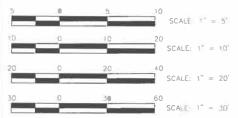

FULL SIZE PLANS HAVE BEEN PREPARED USING STANDARD ENGINEERING SCALES REDUCED SIZED PLANS WILL NOT CONFORM TO STANDARD SCALES. IN MAKING MEASUREMENTS ON REDUCED

JOINT UTILITY LOCATION INFORMATION FOR EXCAVATION 1-800-892-0123 OR 811



CATALOG NO. 03156-00 CONTRACT NO. 89809

IMEG CORP. has adopted safety procedures for its employees who provide professional engineering and surveying services. A copy of these procedures is available from the safety officer. IMEG CORP. personnel are not trained in contractor (construction) safety and compliance procedures. The methods and means to comply with construction site safety are the sole responsibility of the contractor

# STATE OF ILLINOIS DEPARTMENT OF TRANSPORTATION PROPOSED HIGHWAY PLANS

JOHNSON STREET (FAU 6926) RECONSTRUCTION SECTION 19-00155-00-PV PROJECT #11SC(152)

# MACOMB, ILLINOIS

McDONOUGH COUNTY --- C-94-042-21



**LOCATION MAP** 

(NOT TO SCALE) GROSS LENGTH OF PROJECT = 4149.06 FT = 0.785 MILE NET LENGTH OF PROJECT = 4149.06 FT = 0.785 MILE

DESIGN ADT : 4640 (2042)

RTE CLASS : (JOHNSON) MAJOR COLLECTOR (GRANT) MINOR ARTERIAL

DESIGN SPEED: 30 MPH


SEC 19-00155-00-PV

BEGINS, STA. 400+40








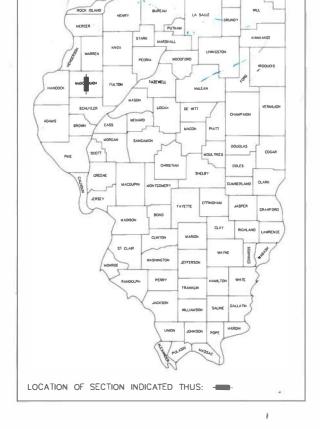


MCARTHUR ST & GRANT ST

McDONOUGH 104

CONTRACT NO 89809

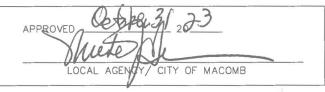

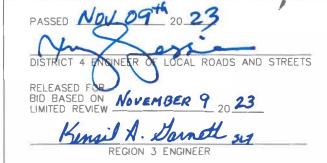

STATE OF ILLINOIS DEPARTMENT OF TRANSPORTATION

PRINTED BY THE AUTHORITY OF THE STATE OF ILLINOIS



714 E. Jackson Street Macomb, Illinois 61455

#### **HIGHWAY STANDARDS**

No.	Standard
000001-08	Standard Symbols, Abbreviations and Patterns
001001-02	Areas of Reinforcement Bars
001006	Decimal of an Inch and of a Foot
280001-07	Temporary Erosion Control System
420001-10	Pavement Joints
420106-07	36' Jointed PCC Pavement
420111-04	PCC Pavement Roundouts
424001-11	Perpendicular Curb Ramps for Sidewalks
424011-04	Corner Parallel Curb Ramps for Sidewalks
542301-03	Precast Reinforced Concrete Flared End Section
542306-03	Precast Reinforced Concrete Elliptical Flared End Section
542401-04	Metal Flared End Sections for Pipe Culverts
542546-01	Flush Inlet Box for Median
602006-04	Catch Basin, Type B
602301-04	Inlet, Type A
602306-03	Inlet, Type B
602401-07	Precast Manhole, Type A, 4' Diameter
602402-03	Precast Manhole, Type A, 5' Diameter
602406-11	Precast Manhole, Type A, 6' Diameter
602411-09	Precast Manhole, Type A, 7' Diameter
602416-09	Precast Manhole, Type A, 8' Diameter
602601-06	Precast Reinforced Concrete Flat Slab Top
602701-02	Manhole Steps
604001-05	Frame and Lids, Type 1
604006-05	Frame and Grate, Type 3
604036-03	Grate, Type 8
604106-01	Median Inlet for 36 in RC Pipe
606001-08	Concrete Curb Type B and Combination Concrete Curb and Gutter
606006-04	Outlet for Concrete Curb and Gutter, Type B-6.24
664001-02	Chain Link Fence
665001-02	Woven Wire Fence
667101-02	Permanent Survey Markers
701001-02	Off-Road Operations, 2L, 2W, More Than 15' Away
701006-05	Off-Road Operations, 2L, 2W, 15' to 24" From Pavement Edge
701301-04	Lane Closure, 2L, 2W, Short Time Operations
701311-03	Lane Closure, 2L, 2W, Moving Operations - Day Only
701501-06	Urban Lane Closure, 2L, 2W, Undivided
701701-10	Urban Lane Closure, Multilane Intersection
701801-06	Sidewalk, Corner or Crosswalk Closure
701901-09	Traffic Control Devices
720001-01	Sign Panel Mounting Details
720006-04	Sign Panel Erection Details
720011-01	Metal Posts for Signs, Markers and Delineators
729001-01	Applications of Types A and B Metal Posts (For Signs & Markers)
780001-05	Typical Pavement Markings
BLR 21-9	Typical Application of Traffic Control Devices for Construction on Rural Local Highways
BLR-22-7	Typ. Appl. of T.C.D. for Rural Loc. Hwys. (2-Lane 2 Way Rural Traff.) (Rd. Closed to Thru Traff.)

LIST OF DISTRICT 4 STANDARDS		
No.	DISTRICT STANDARD	
423001-D4	SUBURBAN ENTRANCES WITH CURBED RADII	
542016-D4	PIPE CULVERT EXTENSION COLLAR (WITHOUT END SECTION)	
602021-D4	INLET-MANHOLE, TYPE G-1	
602101-D4	PRECAST REINFORCED CONCRETE FLAT TOP FOR INLET-MANHOLE TYPE G-1 AND TYPE G-1, SPECIAL	
604001-D4	FRAME AND GRATES FOR TYPE G-1 AND TYPE G-1, SPECIAL DRAINAGE STRUCTURES	
667101-D4	PERMANENT SURVEY TIE & PERMANENT SURVEY MARKERS TY.I - TY.II	
780001-D4	TYPICAL PAVEMENT MARKINGS	

#### UTILITIES

WATER: CITY OF MACOMB (309) 836-3916

SANITARY SEWER: CITY OF MACOMB (309) 833-2088

STORM SEWER: CITY OF MACOMB (309) 833-2088

TELEPHONE: FRONTIER COMMUNICATIONS (217) 243-0299

GAS: AMEREN (888) 659-4540

TELEPHONE / FIBER: McDONOUGH TELEPHONE (309) 776-3211

ELECTRIC: AMEREN (888) 789-2477

CABLE TELEVISION: COMCAST (309) 833-4539

ILLINOIS STATE FIBER (217) 558-1176

#### **UTILITY NOTE**

THE locations of those buried and above ground utilities shown are approximate, are shown for contractor informational use only, and are not to be referenced for construction purposes. The implied presence or absence of utilities is not to be construed by the owner, engineer, contractor, or subcontractors to be an accurate and complete representation of utilities that may or may not exist on the construction site. Buried and above ground utility location, identification, and marking are the sole responsibility of the contractor. Rerouting, disconnection, protection, etc. of any utility must be coordinated between the contractor, utility company and owner. Site safety, including the avoidance of hazards associated with buried and aboveground utilities, remains the sole responsibility of the contractor.

#### **LEGEND**

PROPOSED

<del>\_\_\_</del>

PROPOSED

LLOLIND	-
EXISTING	
0	STORM MANHOLE
	STORM INLET
0	STORM INLET
⊲	FLARED END SECTION
©	SANITARY MANHOLE
0	SANITARY/STORM CLEANOUT
$\bowtie$	WATER VALVE
Ø	HYDRANT
W	WATER METER
*	WATER SERVICE
-	POWER POLE
ф≕∞	POWER POLE W/ LIGHT
←	GUY WIRE
H	HANDHOLE
8	GAS VALVE
P	MAIL BOX
12"	SIGNS
	CONIFER TREE
12"	DECIDUOUS TREE
Zwy Zwy	BUSH/SHRUB
▲	CONTROL POINT
	RAILROAD SPIKE, FOUND
•	5/8" DIA. REBAR, FOUND
	1/2" SQ. PIN, FOUND
•	P.K. NAIL, FOUND
0	PIPE, FOUND
•	CONCRETE MONUMENT, FOUND
<b>+</b>	BENCHMARK
•	SOIL BORING HOLE
( <sup>1</sup> / <sub>2</sub> )	SECTION CORNER
×100.00	SPOT ELEVATION
1.0%	DRAINAGE SLOPE
	LOT LINE
	CENTERLINE
	UNDERLYING LOT LINE
	EASEMENT LINE
	SECTION LINE
	R.O.W. LINE
— <del></del>	SANITARY SEWER
	STORM SEWER
ww	PIPE UNDERDRAIN WATER LINE
	WATER LINE

		CENTERLINE
		UNDERLYING LOT LINE
		EASEMENT LINE
		SECTION LINE
		R.O.W. LINE
	<del></del>	SANITARY SEWER
$-\!$	$-\!$	STORM SEWER
		PIPE UNDERDRAIN
	ww	WATER LINE
	- w - w - w -	ABANDONED WATER LINE
	—Е——Е——	UNDERGROUND ELECTRIC
	—	GAS LINE
	—тv ——тv ——	TELEVISION LINE
	—	TELEPHONE LINE
	—_FOC—FOC—	FIBER OPTIC CABLE
	××	WIRE FENCE
—/——/——		SILT FENCE
100		CONTOUR
	. ~~~~~	TREE LINE
		TRACKS
		CONSTRUCTION LIMITS

<b>♦IM</b>	EG
714 E. JACKSON STREET MACOMB, IL 61455	PH: 309.833.4594 www.imegcorp.com

USER NAME = TAB	DESIGNED — LRR/MJC	REVISED - 09-06-2023
	DRAWN — TAB	REVISED - ·
PLOT SCALE =	CHECKED — LRR	REVISED - ·
PLOT DATE = 09-06-2023	DATE - 01/11/2023	REVISED - ·

F.A.U. RTE.	SECTION	COUNTY	TOTAL SHEETS	SHEET NO.
6926	19-00155-00-PV	McDONOUGH	104	2
JOH	INSON ST & GRANT ST	CONTRACT NO	D. 89809	
ILLINOIS DROJECT NO 115C(152)				

files by the Contractor shall not result in an extension of time for any interim or final completion date or shall not be considered cause for additional compensation. The Contractor shall not use, share, or distribute these electronic files except for the purpose of constructing this contract. Any claims by third parties due to use or errors shall be the sole responsibility of the Contractor. The Contractor shall include this disclaimer with the transfer of these electronic files to any other parties and shall include appropriate language binding them to similar responsibilities.

#### TREE REMOVAL - UTILITY RELOCATION

Tree removal may be necessary prior to utility companies being able to relocate their facilities outside the construction limits. The Contractor should coordinate any contract tree removal activities with the utility companies to eliminate conflicts and potential delays caused by utility tree removal activities or incomplete utility relocations.

#### TREE REMOVAL RESTRICTIONS

Due to the potential presence of endangered bats, no tree removal will be allowed on this project between April 1st and September 30th.

#### PLAN ELEVATIONS - U.S.G.S. MEAN SEA LEVEL DATUM

Use one of the following two options.

- 1. All elevations shown on the plans are established from U.S.G.S. mean sea level datum
- 2. All elevations shown refer to U.S.G.S. datum at mean sea level unless otherwise noted.

# TEMPORARY MATERIAL REQUIREMENTS - UTILITY AND DRIVEWAY CROSSINGS

Incidental hot—mix asphalt surface shall be used for all temporary side road crossings. Aggregate surface course may be used for all driveway crossings except during winter shutdown in accordance with Article 107.09.

#### **ENVIRONMENTAL REVIEWS**

Prior to the use of any proposed borrow areas, use areas (temporary access roads, detours, run—arounds, etc.) and/or waste areas, the Contractor shall file the required environmental resource request surveys according to Section 107.22 of the Standard Specifications. These surveys are required in order for the Department to conduct cultural and biological resource surveys for the proposed site.

The required environmental resource documentation shall include the following:

- •BDE Form 2289 (Borrow Site Review)
- \*BDE Form 2290 (Waste/Use Area Review)
- · A location map showing the size limits and location of the use area
- •Color photographs depicting the use area
- •Borrow Area Entry Agreement form -D4 PI0101

Prior to any waste materials being removed from the construction site the required environmental resource surveys shall be obtained and filed by the Contractor. Excess waste products removed from the construction site shall be disposed of as required in Section 202.03 of the Standard Specifications.

Any protruding metal bars shall be removed prior to the disposal of broken concrete at approved disposal sites.

Please note that a minimum of four weeks shall be allowed for the District to obtain the required waste site environmental clearances and six weeks for the required borrow site environmental clearances

#### AGGREGATE FOR DRIVEWAY REPLACEMENT

The material used for construction of permanent aggregate driveways shall be gravel or crushed stone, as directed by the Engineer, to replace in kind the existing aggregate driveways. No additional compensation shall be provided for this requirement but shall be considered as included in the cost of the pay item for the aggregate as specified on the plans.

#### POLYMERIZED BITUMINOUS MATERIALS (TACK COAT) RATES

Surface Type Residual Rate
Milled (HMA or PCC) 0.08 lb/sf
Existing Pavement 0.08 lb/sf
Fog Coat (between lifts) 0.08 lb/sf

#### **BUTT JOINT CUTTING TIME RESTRICTION**

Butt joints shall not be milled more than three (3) days prior to placement of the HMA surface

#### FINAL FINISH ON P.C. CONCRETE PAVEMENT, TYPE B

A Type "B" final finish, obtained in accordance with Article 420.09(e)(2) of the Standard Specifications, shall be provided for the Portland Cement Concrete Payement.

#### **ORDERING LENGTH CONFIRMATION - DRAINAGE ITEMS**

The Contractor shall consult with the Engineer in regard to the exact length of the box/pipe culverts, storm sewers, and/or pipe drains required prior to ordering these items

#### **EXISTING DRAINAGE PIPES CONNECTED TO NEW STRUCTURES**

In accordance with Section 602 of the Standard Specifications, the connecting of existing drain tiles, pipe culverts, or storm sewers to the proposed drainage system structures will not be paid for separately but shall be considered as included in the pay items provided.

#### TRANSITION PAYMENT METHOD - NEW/OLD CONSTRUCTION

Ten feet (10 ft.) (3 m) transitions shall be used to match proposed items of work to existing items in the field unless otherwise shown. The transition shall be paid for at the contract unit price for the proposed item of work specified.

#### WOVEN WIRE FENCE REPLACEMENT COMMITMENT

The woven wire fence shall be installed prior to the removal of the existing farm fences. The Contractor shall provide a pull post at the intersection of new and existing fences. When so directed by the Engineer, the Contractor shall install the woven wire fence prior to commencing any other work in the area. The Contractor shall perform any clearing and minor grading as directed by the Engineer to provide a smooth ground surface for the proposed fence.

#### SETTING OF SECTION CORNER MONUMENTATION

All section corner locations on this project shall be located and verified by a licensed Land Surveyor prior to any removal work being performed. The Land Surveyor shall locate the existing section corners through courthouse research, personal knowledge or through the assistance of local firms performing Land Surveying in the area. If the section corner does not exist through either its physical location or through ties in the field it shall not be reset, there shall be no calculating of section corners onto a project required.

Once the paving and striping operations have been performed the section corner shall be reset at the direction of a licensed Land Surveyor. If any dimensions have been changed, it shall be the responsibility of the surveyor to file a new monument record in the appropriate courthouse.

A copy of all drawings or monument records produced from this project shall be sent to the Chief of Surveys, Illinois Department of Transportation, Region Three/District Four, Peoria, Illinois.

The supplying, drilling, setting of disks, professional services, labor and any other additional work required to perform this work shall be paid for under pay item for Permanent Survey Markers, Type I.

Refer to District Four CADD Standard 667101 for details

# GENERAL NOTES

- ALL IMPROVEMENTS SHOWN ON THESE ENGINEERING PLANS SHALL COMPLY WITH THE STANDARD SPECIFICATIONS FOR ROAD AND BRIDGE CONSTRUCTION IN ILLINOIS, ADOPTED JANUARY 1, 2022, SUPPLEMENTAL SPECIFICATIONS AND RECURRING SPECIAL PROVISIONS, STANDARDS OF THE ILLINOIS DEPARTMENT OF NATURAL RESOURCES, LATEST EDITION AND THE SPECIAL PROVISIONS PREPARED FOR THIS PROJECT.
- ALL DEBRIS RESULTING FROM CONSTRUCTION OPERATIONS SHALL BE PROPERLY DISPOSED OF OFF-SITE AND IN ACCORDANCE WITH ALL APPLICABLE LAWS AND REGULATIONS.
- LOCATION OF EXISTING UNDERGROUND UTILITIES ARE SHOWN ON PLANS FOR THE CONVENIENCE
  OF THE BIDDER ONLY. THE OWNER OR ENGINEER ASSUMES NO RESPONSIBILITY WHATSOEVER IN
  RESPECT TO THE ACCURACY OF THE INFORMATION SHOWN ON THE PLANS RELATIVE TO THE
  LOCATION OR SIZE. IT SHALL BE THE CONTRACTOR'S RESPONSIBILITY TO DETERMINE THE ACTUAL
  LOCATION OF ALL FACILITIES
- 4. ALL WORK AND MATERIALS SHALL BE IN ACCORDANCE WITH CODE REQUIREMENTS
- THE CONTRACTOR SHALL BE REQUIRED TO MAKE ARRANGEMENTS FOR THE PROPER BRACING, SHORING AND OTHER REQUIRED PROTECTION OF ALL ROADWAYS, STRUCTURES, POLES, CABLES AND PIPE LINES, BEFORE CONSTRUCTION BEGINS.
- TRENCH BACKFILL SHELL BE REQUIRED FOR ALL UTILITIES THAT ARE CONSTRUCTED UNDER OR WITHIN 2 FEET (2') OF THE EDGE OF PAVEMENTS, SIDEWALKS OR CURB AND GUTTER, TRENCH BACKFILL WILL BE CONSIDERED INCIDENTAL
- 7. THE EDGES OF ALL IMPROVED SURFACES WHICH ARE DISTURBED DURING CONSTRUCTION SHALL BE SAW CUT PRIOR TO RESTORATION. ANY SAW CUTTING OR PAVEMENT PATCHES, BUTT JOINTS, CONCRETE CURBS, SIDEWALKS, OR ANY OTHER AREAS NECESSARY TO COMPLETE THIS PROJECT WILL NOT BE PAID FOR SEPARATELY BUT SHALL BE CONSIDERED INCIDENTAL TO CONSTRUCTION, UNLESS OTHERWISE SPECIFIED.
- 8. THE CONTRACTOR SHALL EXERCISE PROPER CAUTION TO PROTECT THE EXISTING IMPROVEMENTS. THE CONTRACTOR SHALL BE RESPONSIBLE FOR REPAIRING ANY DAMAGE.

**SURVEY** 

#### ABBREBVIATIONS

EDGE TO EDGE

FI EVATION

**EXISTING** 

GRAVEI

**GUTTER** 

SQUARE FEET

SHOULDER

STREET

SIDEWALK

FLOWLINE

В-В

BI DO

C&G

CON

CL

CY

DIA

DRV

E-E

EX

FL GRVL

GUT

LF

PCC

**PVMT** 

SHLD

ST

SW

SY

LS

EL

<u> </u>			<u> </u>
	ACRES	BM	BENCHMARK
	BACK TO BACK	PL	PROPERTY LINE
	BITUMINOUS	ROW	RIGHT OF WAY
G	BUILDING	SEC	SECTION
	CURB AND GUTTER	UE	UTILITY EASEMENT
	CENTERLINE		
С	CONCRETE	UTILITI	ES
	CUBIC YARD	CO	CLEANOUT
	DELTA ANGLE	FES	FLARED END SECTION
	DIAMETER	FH	FIRE HYDRANT
	DRIVEWAY	1	

FH FIRE HYDRANT
MH MANHOLE
SAN SANITARY
STM STORM
UTIL UTILITY
WM WATER MAIN

PIPES

LINEAL/LINEAR FEET
LANDSCAPING
DIP
DUCTILE IRON PIPE
PORTLAND CEMENT CONCRETE
PROPOSED
PAVEMENT
PVC
POLYVINYL CHLORIDE PIPE
RADIUS
RCP
CORRUGATED METAL PIPE
DUCTILE IRON PIPE
HIGH DENSITY POLYETHYLENE PIPE
HIGH DENSITY POLYETHYLENE PIPE
PVC
POLYVINYL CHLORIDE PIPE
RADIUS

ALIGNMENT/PROFILE/XSECTIONS

SQUARE YARD OF CURB PC POINT OF CURVATURE
TOP OF CURB PI POINT OF INTERSECTION OF HORIZONTAL CURVE
PT POINT OF TANGENCY

STA STATION

XSEC CROSS SECTION

HOT-MIX ASPHALT REQUIREMENTS		
MIXTURE USES	SURFACE COURSE	
PG	64-22	
DESIGN AIR VOIDS	4.0% @Ndes = 50	
MIXTURE COMPOSITION (GRADATION MIXTURE)	IL 9.5	
FRICTION AGGREGATE	MIXTURE C (DOLOMITE OR 1/4")	
MIXTURE WEIGHT	112 lb/SQ. YD./INCH	
QUALITY MGMT PROGRAM	QCQA	
SUBLOT SIZE	N/A	

SCALE:

RATE OF APPLICATION TABLE		
AGGREGATE (SURFACE, SHOULDERS, BASE COURSE OR BACKFILL)	1.8 TONS/CU YD	
STONE RIPRAP	1.35 TONS/CU YD	
SEEDING AREAS  NITROGEN FERTILIZER NUTRIENT  PHOSPHORUS FERTILIZER NUTRIENT  POTASSIUM FERTILIZER NUTRIENT  MULCH  TEMPORARY EROSION CONTROL SEEDING	90 LBS/ACRE 90 LBS/ACRE 90 LBS/ACRE 2 TONS/ACRE 100 LBS/ACRE	



USER NAME = TAB	DESIGNED — LRR/MJC	REVISED — 09-06-2023
	DRAWN — TAB	REVISED — ·
PLOT SCALE =	CHECKED — LRR	REVISED — ·
PLOT DATE = 09-06-2023	DATE - 01/11/2023	REVISED - ·

 STATE OF ILLINOIS
DEPARTMENT OF TRANSPORTATION

GENERAL N	OTES	F.A.U. RTE.
JOHNSON STREET REC	_	6926
MACOMB, ILLINOI		JOH
SHEET NO. 3 OF 104 SHEET:		

F.A.U. RTE.	SECTION	COUNTY	TOTAL SHEETS	SHEET NO.
6926	19-00155-00-PV	McDONOUGH	104	3
JOH	NSON ST & GRANT ST	CONTRACT NO	D. 89809	
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	Pay Item	Description	Unit	Quantity
*	20100110	TREE REMOVAL (6 TO 15 UNITS DIAMETER)	UNIT	124
*	20100210	TREE REMOVAL (OVER 15 UNITS DIAMETER)	UNIT	632
	20200100	EARTH EXCAVATION	CU YD	12,623
	20400800	FURNISHED EXCAVATION	CU YD	1,446
	20800150	TRENCH BACKFILL	CU YD	731
	21001000	GEOTECHNICAL FABRIC FOR GROUND STABILIZATION	SQ YD	20,491
	21101505	TOPSOIL EXCAVATION AND PLACEMENT	CU YD	1,584
*	25000110	SEEDING CLASS 1A	ACRE	4.4
*	25000210	SEEDING CLASS 2A	ACRE	1.1
*	25000400	NITROGEN FERTILIZER NUTRIENT	POUND	496
*	25000500	PHOSPHORUS FERTILIZER NUTRIENT	POUND	496
*	25000600	POTASSIUM FERTILIZER NUTRIENT	POUND	496
*	25100125	MULCH, METHOD 3	ACRE	5.5
*	25100630	EROSION CONTROL BLANKET	SQ YD	2,732
*	25100900	TURF REINFORCEMENT MAT	SQ YD	206
	28000250	TEMPORARY EROSION CONTROL SEEDING	POUND	550
	28000400	PERIMETER EROSION BARRIER	FOOT	9,370
	28000500	INLET AND PIPE PROTECTION	EACH	8
	28000510	INLET FILTERS	EACH	35
	28100107	STONE RIPRAP, CLASS A4	SQ YD	228
	28100109	STONE RIPRAP, CLASS A5	SQ YD	444
	28200200	FILTER FABRIC	SQ YD	730
	28300400	AGGREGATE DITCH	TON	25
	35101800	AGGREGATE BASE COURSE, TYPE B 6"	SQ YD	21,023
	40200500	AGGREGATE SURFACE COURSE, TYPE A 6"	SQ YD	71
	40200700	AGGREGATE SURFACE COURSE, TYPE A 8"	SQ YD	159
	40201000	AGGREGATE FOR TEMPORARY ACCESS	TON	811
	40600295	POLYMERIZED BITUMINOUS MATERIALS (TACK COAT)	POUND	135

Pay Item	Description	Unit	Quantity
40600982	HOT-MIX ASPHALT SURFACE REMOVAL - BUTT JOINT	SQ YD	187
40604050	HOT-MIX ASPHALT SURFACE COURSE, IL-9.5, MIX "C", N50	TON	22
42000201	PORTLAND CEMENT CONCRETE PAVEMENT 7" (JOINTED)	SQ YD	1,868
42000301	PORTLAND CEMENT CONCRETE PAVEMENT 8" (JOINTED)	SQ YD	15,647
42300200	PORTLAND CEMENT CONCRETE DRIVEWAY PAVEMENT, 6 INCH	SQ YD	237
42300300	PORTLAND CEMENT CONCRETE DRIVEWAY PAVEMENT, 7 INCH	SQ YD	364
42400100	PORTLAND CEMENT CONCRETE SIDEWALK 4 INCH	SQ FT	2,874
42400200	PORTLAND CEMENT CONCRETE SIDEWALK 5 INCH	SQ FT	22,588
44000100	PAVEMENT REMOVAL	SQ YD	12,588
44000200	DRIVEWAY PAVEMENT REMOVAL	SQ YD	2,217
44000500	COMBINATION CURB AND GUTTER REMOVAL	FOOT	911
44000600			
	SIDEWALK REMOVAL	SQ FT	1,497
48100500	AGGREGATE SHOULDERS, TYPE A 6"	SQ YD	234
50105220	PIPE CULVERT REMOVAL	FOOT	649
50800105	REINFORCEMENT BARS	POUND	54
50800205	REINFORCEMENT BARS, EPOXY COATED	POUND	250
50901760	PIPE HANDRAIL	FOOT	52
52200800	SEGMENTAL CONCRETE BLOCK WALL	SQ FT	460
54213447	END SECTIONS 12"	EACH	1
54213477	END SECTIONS 42"	EACH	2
54213483	END SECTIONS 48"	EACH	1
54214317	END SECTIONS, EQUIVALENT ROUND-SIZE 42"	EACH	2
54244405	FLUSH INLET BOX FOR MEDIAN STANDARD 542546	EACH	1
54248510	CONCRETE COLLAR	CU YD	0.9
54262715	METAL FLARED END SECTIONS 15"	EACH	2
542A5497	PIPE CULVERTS, CLASS A, TYPE 1 EQUIVALENT ROUND-SIZE 42"	FOOT	68
542D0220	PIPE CULVERTS, CLASS D, TYPE 1 15"	FOOT	56
550B0050	STORM SEWERS, CLASS B, TYPE 1 12"	FOOT	460

\* SPECIALTY ITEMS

	EG
714 E. JACKSON STREET	PH: 309.833.4594
MACOMB, IL 61455	www.imegcorp.com

USER NAME = TAB	DESIGNED — LRR/MJC	REVISED — 09-06-2023
	DRAWN — TAB	REVISED — ·
PLOT SCALE =	CHECKED — LRR	REVISED — ·
PLOT DATE = 09-06-2023	DATE - 01/11/2023	REVISED - ·

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09.833.4594 negcorp.com	
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Pay Item	Description	Unit	Quantity
550B0070	STORM SEWERS, CLASS B, TYPE 1 15"	FOOT	66
550B0090	STORM SEWERS, CLASS B, TYPE 1 18"	FOOT	101
550B0120	STORM SEWERS, CLASS B, TYPE 1 24"	FOOT	78
550B0180	STORM SEWERS, CLASS B, TYPE 1 42"	FOOT	464
550B0190	STORM SEWERS, CLASS B, TYPE 1 48"	FOOT	23
550B0340	STORM SEWERS, CLASS B, TYPE 2 12"	FOOT	207
550B0380	STORM SEWERS, CLASS B, TYPE 2 18"	FOOT	162
550B0410	STORM SEWERS, CLASS B, TYPE 2 24"	FOOT	578
550B0430	STORM SEWERS, CLASS B, TYPE 2 30"	FOOT	60
550B0450	STORM SEWERS, CLASS B, TYPE 2 36"	FOOT	463
550B0470	STORM SEWERS, CLASS B, TYPE 2 42"	FOOT	175
550B2320	STORM SEWERS, RUBBER GASKET, CLASS B, TYPE 1 12"	FOOT	61
550B2330	STORM SEWERS, RUBBER GASKET, CLASS B, TYPE 1 15"	FOOT	173
550B2340	STORM SEWERS, RUBBER GASKET, CLASS B, TYPE 1 18"	FOOT	62
550B2400	STORM SEWERS, RUBBER GASKET, CLASS B, TYPE 1 36"	FOOT	173
550B2600	STORM SEWERS, RUBBER GASKET, CLASS B, TYPE 2 36"	FOOT	95
55100500	STORM SEWER REMOVAL 12"	FOOT	63
55100700	STORM SEWER REMOVAL 15"	FOOT	46
55100900	STORM SEWER REMOVAL 18"	FOOT	187
56100010	DUCTILE IRON WATER MAIN TEE, 8" X 4"	EACH	1
56100020	DUCTILE IRON WATER MAIN TEE, 8" X 8"	EACH	1
56100500	WATER MAIN 4"	FOOT	87
56100700	WATER MAIN 8"	FOOT	332
56101150		EACH	1
56104800			
		EACH	1
56105000		EACH	1
56109420	DUCTILE IRON WATER MAIN FITTINGS 8" 45.00 DEGREE BEND	EACH	2
56109430	DUCTILE IRON WATER MAIN FITTINGS 4" 90.00 DEGREE BEND	EACH	2

L	Pay Item	Description	Unit	Quantity
	56109434	DUCTILE IRON WATER MAIN FITTINGS 8" 90.00 DEGREE BEND	EACH	1
	56200300	WATER SERVICE LINE 1"	FOOT	116
	56400100	FIRE HYDRANTS TO BE MOVED	EACH	1
	56400500	FIRE HYDRANTS TO BE REMOVED	EACH	1
	56400810	FIRE HYDRANT EXTENSION	FOOT	2
-	56400820	FIRE HYDRANT WITH AUXILIARY VALVE AND VALVE BOX	EACH	1
	56500300	DOMESTIC METER VAULTS TO BE ADJUSTED	EACH	3
	56500500	DOMESTIC METER VAULTS	EACH	1
	56500600	DOMESTIC WATER SERVICES BOXES TO BE ADJUSTED	EACH	3
_	56500800	DOMESTIC WATER SERVICE BOXES	EACH	2
	60100905	PIPE DRAINS 4"	FOOT	56
	60146304	PIPE UNDERDRAINS FOR STRUCTURES 4"	FOOT	124
	60218400	MANHOLES, TYPE A, 4'-DIAMETER, TYPE 1 FRAME, CLOSED LID	EACH	2
	60221100	MANHOLES, TYPE A, 5'-DIAMETER, TYPE 1 FRAME, CLOSED LID	EACH	4
	60223700	MANHOLES, TYPE A, 6'-DIAMETER, TYPE 1 FRAME, OPEN LID	EACH	1
	60223800	MANHOLES, TYPE A, 6'-DIAMETER, TYPE 1 FRAME, CLOSED LID	EACH	1
_	60224071	MANHOLES, TYPE A, 6'-DIAMETER, WITH MEDIAN INLET (604106)	EACH	1
	60224446	MANHOLES, TYPE A, 7'-DIAMETER, TYPE 1 FRAME, CLOSED LID	EACH	2
_	60224459	MANHOLES, TYPE A, 8'-DIAMETER, TYPE 1 FRAME, CLOSED LID	EACH	5
	60235700	INLETS, TYPE A, TYPE 3 FRAME AND GRATE	EACH	2
	60236200	INLETS, TYPE A, TYPE 8 GRATE	EACH	2
_	60240210	INLETS, TYPE B, TYPE 1 FRAME, OPEN LID	EACH	3
	60240220	INLETS, TYPE B, TYPE 3 FRAME AND GRATE	EACH	1
	60255500	MANHOLES TO BE ADJUSTED	EACH	2
_	60266600	VALVE BOXES TO BE ADJUSTED	EACH	7
	60500040	REMOVING MANHOLES	EACH	1
	60500060	DEMOVING INJETS	FACIL	-
_	60500060	REMOVING INLETS	EACH	3
	60500105	FILLING MANHOLES	EACH	1

\* SPECIALTY ITEMS

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-	Pay Item	Description	Unit	Quantity
	60600095	CLASS SI CONCRETE (OUTLET)	CU YD	6
	60605000	COMBINATION CONCRETE CURB AND GUTTER, TYPE B-6.24	FOOT	7,700
*	66400505	CHAIN LINK FENCE, 8'	FOOT	115
*	66500105	WOVEN WIRE FENCE, 4'	FOOT	1,099
	66700205	PERMANENT SURVEY MARKERS, TYPE I	EACH	3
	66700305	PERMANENT SURVEY MARKERS, TYPE II	EACH	1
	67100100	MOBILIZATION	L SUM	1
*	72000100	SIGN PANEL - TYPE 1	SQ FT	168
*	72800100	TELESCOPING STEEL SIGN SUPPORT	FOOT	378
*	78009000	MODIFIED URETHANE PAVEMENT MARKING - LETTERS AND SYMBOLS	SQ FT	900
*	78009004	MODIFIED URETHANE PAVEMENT MARKING - LINE 4"	FOOT	10,208
*	78009006	MODIFIED URETHANE PAVEMENT MARKING - LINE 6"	FOOT	991
*	78009008	MODIFIED URETHANE PAVEMENT MARKING - LINE 8"	FOOT	760
*	78009012	MODIFIED URETHANE PAVEMENT MARKING - LINE 12"	FOOT	305
*	78009024	MODIFIED URETHANE PAVEMENT MARKING - LINE 24"	FOOT	267
*	X0120014	WATER MAIN ABANDONMENT	EACH	3
*	X0324636	WATER VALVE BOXES TO BE ABANDONED	EACH	1
	X1200036	SANITARY SERVICE CLEANOUT	EACH	2
	X1200050	BOX CULVERT REMOVAL	FOOT	32
	X4230720	PORTLAND CEMENT CONCRETE DRIVEWAY PAVEMENT, 7 INCH, SPECIAL	SQ YD	654
	X4240450	PORTLAND CEMENT CONCRETE SIDEWALK 7 INCH, SPECIAL	SQ FT	1,536
	X4240800	DETECTABLE WARNINGS (SPECIAL)	SQ FT	298
	X4404700	SIDEWALK REMOVAL (SPECIAL)	SQ FT	261
*	X5620030	WATER SERVICE CONNECTION 1"	EACH	2
*	X5620128	ADJUSTING WATER SERVICE LINES	EACH	2

	Pay Item	Description	Unit	Quantity
	X5630704	CONNECTION TO EXISTING WATER MAIN 4"	EACH	1
t				_
	X5630708	CONNECTION TO EXISTING WATER MAIN 8"	EACH	2
	X6021824	INLET-MANHOLE, TYPE G-1, 4' DIAMETER, SPECIAL	EACH	1
	X6024242	INLETS, SPECIAL, NO. 1	EACH	30
	X7010216	TRAFFIC CONTROL AND PROTECTION, (SPECIAL)	L SUM	1
	Z0012450	CONCRETE STEPS	CU YD	4
	Z0013798	CONSTRUCTION LAYOUT	L SUM	1
ŧ	Z0076600	TRAINEES	HOURS	1,000
<i>‡</i>	Z0076604	TRAINEES TRAINING PROGRAM GRADUATE	HOURS	1,000

<sup>\*</sup> SPECIALTY ITEMS # 0042

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	DRAWN — TAB	REVISED - ·	S
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PLOT DATE = 09-06-2023	DATE - 01/11/2023	REVISED — ·	

STATE OF ILLINOIS	
DEPARTMENT OF TRANSPORTATION	

(	SUMMARY OF QUANTITIES								
JOHNSON STREET RECONSTRUCTION									
	CHEET	ΝО	6	ΛE	104	CHEETS			

F.A.U. RTE.	A.U. SECTION			COUNTY	TOTAL SHEETS	SHEE'
6926	926 19-00155-00-PV			McD0N0UGH	104	6
JOHNSON ST & GRANT ST				CONTRACT NO	D. 89809	
		ILLINOIS	PROJE	CT NO. 11SC(152)		

SUMMARY OF QUANTITIES	F.A.U. RTE.	SECTION		COUNTY	TOTAL SHEETS	SHE
OHNSON STREET RECONSTRUCTION	6926	19-00155-00-PV		McD0N0UGH	104	6
MACOMB, ILLINOIS	JOH	NSON ST & GRANT ST		COUNTY SHEETS		
SHEET NO. 6 OF 104 SHEETS		ILLINOIS	PROJE	CT NO. 11SC(152)		

EARTHWORK TABULATION								
	2020	0100	20400800	21101505				
	EARTH EX	CAVATION						
	EXCAVATION BELOW TOPSOIL	TOPSOIL EXCAVATION	FURNISHED EXCAVATION	TOPSOIL EXCAVATION AND PLACEMENT	EMBANKMENT	TOPSOIL EXCAVATION USED IN EMBANKMENT		
LOCATION	CU YD	CU YD	CU YD	CU YD	CU YD	EARTH EXCAVATION		
STAGE 1 - 400+40 TO 407+00	1193	976	182	328	1565	652		
STAGE 2 - 407+00 TO 414+75	947	917	1313	320	2487	619		
STAGE 3 - 414+75 TO 423+75	1598	1215	-48	419	1736	781		
STAGE 4 - 423+75 TO 431+52.7	1142 **	878	0	212	691	0		
STAGE 5 - 431+52.7 TO 433+66.3 & GRANT ST. EAST	1285 **	417	0	147	56	0		
STAGE 6 - GRANT ST 85+90 TO 90+45.84	1600 **	455	0	158	187	0		
SUB TOTALS	7765	4859						
TOTALS	120	523	1446	1584	6722	2052		

1313	320	2487	(	519	I TOP:	SOIL EXCAVATION		
-48	419	1736		781	** EXCESS SUITABLE EXCAVATE			
0	212	691				MATERIAL FROM STAGES 4, 5 & 6 MAY BE USED TO COMPLETE OFF		
0	147	56		0	ROA	D EMBANKMENT	NEEDED FOR	
0	158	187		0		GE 1 & 2 IN LIE SITE. FURNISHEI		
1446	1584	6722	2	052	QUANTITY WILL BE REDUCED BAS ON VOLUME OF STAGE 4, 5, & 6 MATERIAL USED.			
		TEMPORAR	Y EROSIO	N CONTROL				
		280002	28000250		00	28000500	28000510	
		TEMPORARY EROSION CONTROL SEEDING		PERIME EROSIC BARRII	ON	INLET AND PIPE PROTECTION	INLET FILTERS	
LOCATION		POUN	ID	F001	г	EACH	EACH	
400+00 TO 410	+00	160		1,895	5	3	12	
410+00 TO 420	+50	180	180		)	4	10	
420+50 TO 431	+00	90		2,430	)	1	6	
431+00 & 86+00 TO 94+50 (GRANT								
ST)		120	120		5		7	
	TOTALS	550 9,37		)	8	35		
		PERMANI	ENT EROSIO	N PROTECTIO	N			

FURNISHED EXCAVATION =

EMBANKMENT - [(EXCAVATION BELOW TOPSOIL + TOPSOIL EXCAVATION USED IN EMBANKMENT) x 0.75)]

TOPSOIL EXCAVATION =
TOTAL VOLUME OF STRIPPED
MATERIAL — TOPSOIL EXCAVATION
AND PLACEMENT

EARTH EXCAVATION =
EXCAVATION BELOW TOPSOIL +
TOPSOIL EXCAVATION

TOTALS	330	-,		0				
PERMANENT EROSION PROTECTION								
28100107 28100109 28200200 28300400								
	STONE RIPRAP, CLASS A4	STONE RIPRAP, CLASS A5	FILTER FABRIC	AGGREGATE DITCH				
LOCATION	SQ YD	SQ YD	SQ YD	TON				
JOHNSON STREET								
400+89.7 TO 401+06.7 RT			19	8				
401+06.7 TO 401+25 RT	40		40					
401+25 TO 401+33.6 RT			9	3				
401+30 TO 401+41.6 LT			13	6				
401+41.6 TO 401+80.4 LT	96		96					
409+40 TO 409+59 LT	92		92					
419+95, 210' TO 271' LT		444	444					
GRANT STREET								
85+84 RT			9	4				
87+12 LT			8	3.6				
TOTALS	228	444	730	24.6				

			PAVEMENT	SCHEDULE		
		35101800	42000201	42000301	21001000	48100500
ST	ATION	AGGREGATE BASE COURSE, TYPE B, 6"	PCC PAVEMENT, 7" (JOINTED)	PCC PAVEMENT, 8" (JOINTED)	GEOTECHNICAL FABRIC F/GRND STAB	AGGREGATE SHOULDER, TYPE A, 6"
FROM	то	SQ YD	SQ YD	SQ YD	SQ YD	SQ YD
JOHNSON ST	REET	•				
400+50	407+00	2,461		2,259	2,461	208
407+00	414+75	3,280		2,842	3,280	
414+75	423+75	3,846		3,300	3,846	
423+75	431+52.70	3,365		2,882	3,365	
431+52.70	433+46.28	1,673		1,541	1,673	
HARMONY L	ANE	•				
402+93 RT		302			302	
GREENVIEW	ENTRANCE					
403+03 LT		180	143		180	
NEW SCHOO	L ENTRANCE					
405+02 RT		274	230		274	
408+27 RT		329	277		329	
HIGH SCHOO	L ENTRANCE					
414+14 RT		492	405		492	
419+61 RT		409	329		409	
WEAR AVEN	UE					
415+12 LT		244		210	244	
McARTHUR S	CHOOL					
428+57 RT		422	345		422	
GRANT STRE	ET					
86+00	90+45.84	1,885		1,604	1,885	26
91+75.91	94+21.76	1,152		1,009	1,152	
McARTHUR S	CHOOL	,				
93+00 RT		177	139		177	
TO	OTALS	20,491	1,868	15,647	20,491	234

	TREE REIV	IOVAL	
		20100110	20100210
STATION	OFFSET	6 to 15	OVER 15
OHNSON TREET		UNIT	UNIT
403+54	42' RT		24
403+90	42' RT		18
408+64	44' LT	8	
414+93	67' LT		24
415+41	57' LT		24
415+51	31' LT		24
415+85	33' LT		24
415+97	35' LT		24
420+05	201'LT	12	
420+13	201'LT	14	
424+69 *	44' RT	12	
425+17 *	44' RT	12	
425+34 *	44' RT	20	
425+68	44' RT	12	
428+14	45' RT	12	
428+96	44' RT		30
429+11	43' RT		30
429+19	43' RT	12	
429+27	43' RT		18
429+27 *	44' LT		48
429+43	43' RT		24
429+51	43' RT		30
429+95	44' RT		30
431+03 *	33' LT		48
431+47	32' LT		36
433+22*	32' RT		24
433+41*	31'RT		30
RANT STREET			
90+00	47' RT		24
90+37	41' LT		24
90+65	42' LT		26
92+27 *	51' RT		24
92+51	51' RT		24
93+20	36' LT	10	
	TOTALS	124	632

\* DENOTES STUMP

			SEEDING SCHEDU	LE				
	25000110	25000210	25100125	25000400	25000500	25000600	25100630	25100900
LOCATION	SEEDING CLASS 1A ACRE	SEEDING CLASS 2A ACRE	MULCH METHOD 3 ACRE	NITROGEN FERT NUTRIENT POUND	PHOSPHORUS FERT NUTRIENT POUND	POTASSIUM FERT NUTRIENT POUND	EROSION CONTROL BLANKET SQ YD	TURF REINF MAT SQ YD
LT STA 400+00 TO 401+40		0.08	0.08	7.2	7.2	7.2	303	
RT STA 400+00 TO 401+38		0.09	0.09	8.1	8.1	8.1	228	
LT STA 401+40 TO 405+18	0.37		0.37	33.3	33.3	33.3		206
RT STA 401+38 TO 405+00	0.21		0.21	18.9	18.9	18.9	230	
LT STA 405+18 TO WEIR AVE		0.90	0.90	81.0	81.0	81.0	242	
RT STA 405+00 TO SOUTH HIGH SCHOOL DR	0.68		0.68	61.2	61.2	61.2		
LT STA WEIR AVE TO 419+90	0.31		0.31	27.9	27.9	27.9	190	
RT STA S HIGH SCHOOL DR TO NORTH DR	0.50		0.50	45.0	45.0	45.0	984	
LT STA 419+90 TO 425+31	0.40		0.40	36.0	36.0	36.0		
RT STA N HIGH SCHOOL DR TO MCARTHUR DR	0.30		0.30	27.0	27.0	27.0		
LT STA 425+31 TO 430+00	0.28		0.28	25.2	25.2	25.2	355	
RT STA McARTHUR DR TO 94+50 GRANT	0.37		0.37	33.3	33.3	33.3		
RT STA 85+89 TO JOHNSON ST	0.69		0.69	62.1	62.1	62.1	200	
LT STA 85+89 TO JOHNSON ST	0.25		0.25	22.5	22.5	22.5		
NORTH SIDE GRANT - EAST OF JOHNSON	0.08		0.08	7.2	7.2	7.2		
TOTALS	4.4	1.1	5.5	496	496	496	2732	206

SCALE:

	EG
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MACOMB, IL 61455	www.imegcorp.com

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STATE OF ILLINOIS
<b>DEPARTMENT OF TRANSPORTATION</b>

S	CHE	DU	LΕ	S (	OF C	)L	<b>JANTITIES</b>
J	OHNS	S NC	STR		REC	10	NSTRUCTION
	CHEET N	7	ΛE	104	CHEETS		

RTE.	SECTION	COUNTY	SHEETS	NO.
6926	19-00155-00-PV	McDONOUGH	104	7
JOH	NSON ST & GRANT ST	CONTRACT NO	D. 89809	
	ILLINOIS PRO	JECT NO. 11SC(152)		
	6926	6926 19-00155-00-PV JOHNSON ST & GRANT ST	6926   19-00155-00-PV	SHEETS   SHEETS   SHEETS     SHEETS     SHEETS     SHEETS     SHEETS     SHEETS   SHEETS     SHEETS     SHEETS     SHEETS     SHEETS     SHEETS   SHEETS     SHEETS     SHEETS     SHEETS   SHEETS     SHEETS

			42400100	42400200	X4240450	X4240800
STA	TION		4"	5"	7" SPL	DET WARNING SPECIAL
FROM	то	LT / RT	SQ FT	SQ FT	SQ FT	SQ FT
			JOHNSON S			
402+51	402+65	RT		109		
402+65	402+75	RT			81	
402+71		RT				16
403+15	403+36	RT			144	
403+22		RT				30
403+36	404+65	RT		1,054		
404+65	404+78	RT			99	
404+72		RT				16
405+30	405+43	RT			99	
405+38		RT				19
405+44	407+91	RT		1,979		
407+78	407+88	RT		95		
407+91	408+02	RT			83	
497+96		RT				16
408+53	408+67	RT			98	
408+58		RT				18
408+67	409+28	RT		475		
409+43	413+77	RT		3,457		
413+77	413+89	RT			88	
413+85		RT				16
414+34	414+49	RT			105	
414+39		RT				20
414+49	419+26	RT		3,812		
419+26	419+38	RT			88	
419+33		RT				16
419+82	419+97	RT			105	
419+88		RT				20
419+97	420+71	RT		590		
420+95	428+22	RT		5,822		
428+22	428+33	RT			88	
428+29		RT				16
428+79	428+94	RT			105	-
428+84		RT				20
428+94	431+85	RT		2,612		
431+85	432+04	RT		,-	42	
432+03		RT				16
432+55	432+71	LT			39	
432+62	.52.72	LT				16
432+71	433+00	LT	309			
432+72	432+84	RT	309		57	
432+74		RT	309		57	16
	l .	1	GRANT ST	REET	I .	I
87+50	87+71	LT		194		
88+28	90+62	LT		2,195		
92+63	92+78	RT			83	
92+74		RT				13
93+21	93+36	RT			75	
93+27		RT				14
93+50	93+50	RT		82		
91+65	92+63	RT	496			
91+75	92+03	LT	162			
92+22	93+67	LT	739			
92+88	92+88	LT	15			
93+36	94+22	RT	499			
93+50	J4122	RT	36	112		
22120	I	TOTALS	2,874	22,588	1,536	298
		TOTALS	2,074		1,550	230

		DRIVEW	/AY SCHEDULE			
	40200500	40200700	42300200	42300300	X4230720	35101800
LOCATION	AGGREGATE SURFACE COURSE, TYA, 6"	AGGREGATE SURFACE COURSE, TYA 8"	PCC DRIVEWAY PAVEMENT, 6"	PCC DRIVEWAY PAVEMENT, 7"	PCC DRIVEWAY PAVEMENT 7" SPECIAL	AGGREGATE BASE COURSE, TYB, 6"
	SQ YD	SQ YD	SQ YD	SQ YD	SQ YD	SQ YD
JOHNSON STREET						
400+64 RT.		74				
409+35 RT		20		39		
416+31 LT			23			
417+75 LT			24			
419+16 LT			30			
419+70 LT			26			
420+83 RT				90		
421+32	31		45			
422+14 LT			25			
423+21 LT	12		14			
423+47 LT		39				
423+49 LT				33		
424+16 LT		3		42		
424+17 LT		3				
425+18 LT	28		16			
430+09 LT					168	
GRANT STREET						
87+84 RT		20		40		
87+99 LT				120		
88+75 RT					486	532
92+13 LT			34			
TOTALS	71	159	237	364	654	532

	44000200	
DRIV	EWAY PAVEMENT F	REMOVAL
STATION	LT / RT	SQ YD
	JOHNSON STREE	T
409+33	RT	14.1
414+13	RT	343.5
416+31	LT	29.1
417+75	LT	35.5
419+16	LT	34.5
419+61	RT	283.2
419+70	LT	32.6
420+83	RT	91.9
421+32	LT	42.2
422+14	LT	32.3
423+38	LT	72.6
428+58	RT	255.9
430+12	LT	166.4
	GRANT STREET	
87+97	LT	146.7
89+20	RT	460.8
92+16	LT	20.9
93+05	RT	154.3
	TOTAL	2216.5
	X4404700	

	X4404700	
SIDE	WALK REMOVAL (SI	PECIAL)
LOCA	ATION	SQ FT
JOHNSON / GRAN	IT INTERSECTION	
431+38.1	RT	108
GRANT STREET		
93+53.5	RT	153
TO	TAL	261

	4400	0600	
	SIDEWALK	REMOVAL	
STA	TION		
FROM	то	LT / RT	SQ FT
JOHNSON / GR	ANT INTERSECT	TION	
433+46 (J)	93+66 (G)	LT	631
432+36	433+00	LT	248
GRANT STREET	-		
92+00		LT	39
93+24	94+21	RT	494
93+53	95+53	RT	85
		TOTAL	1497

	4400	0500	
	CURB & GUTT	ER REMOVAL	
STAT	TION		
FROM	то	LT / RT	FOOT
IOHNSON STREET			
431+62	431+66	LT	31
432+36	433+46	LT	126
JOHNSON / GRANT	INTERSECTION		
421+63 (J)	92+70 (G)	RT	173
433+46 (J)	93+66 (G)	LT	370
GRANT STREET		-	
92+70	92+83	RT	60
93+08	93+34	RT	64
93+34	94+21	RT	87
		TOTAL	911

		40201000		
	AGGREGAT	TE FOR TEMPORA	RY ACCESS	
STATI	ON			
FROM	то	LT / RT	DEPTH	TONS
	:	JOHNSON STREET	[	
417+30	419+29	RT	6"	55
421+00	425+50	RT	6"	131
Driveways			6"	425
Storm Sewers			12"	200
	TOTAL	•		811

COMBINATION CONCRETE CURB & GUTTER					
			60605000	60600095	
	STATION		B6.24	CLASS SI CONCRETE (OUTLET)	
FROM	то	LT / RT	FOOT	CU YD	
JOHNSON :	STREET				
402+50	402+87	LT	64		
402+50	402+76	RT	32		
403+16	414+96	LT	1,225		
403+09	404+80	RT	213		
405+26	408+07	RT	315		
408+48	413+98	RT	626		
414+27	419+46	RT	660		
415+25	431+89	LT	1,699		
419+76	428+42	RT	969		
428+72 (J)	91+78 (G)	RT	422		
432+40	433+46	LT	136		
432+66	433+46	RT	99		
GRANT STE	REET				
85+89	86+24	RT		2.9	
86+24	90+42	RT	423		
87+11	87+50	LT		2.9	
87+50	90+45	LT	294		
91+78	94+22	LT	247		
91+78	92+81	RT	139		
93+10	94+22	RT	137		
		TOTALS	7,700	5.8	

	44000100	
	PAVEMENT REMOVAL	
STA	TION	
FROM	то	SQ YD
JOHNSON STREET		
400+50	407+00	1,659
407+00	414+75	1,954
414+75	423+75	2,306
423+75	431+52.70	2,195
431+52.70	433+70	1,346
GRANT STREET		
86+00	90+45.84	1,445
91+75.91	94+21.76	1,041
HARMONY LANE		
402+92	66' RT	214
403+02	57' LT	222
WEAR AVENUE		
415+11	95' LT	206
	TOTAL	12,588



SER NAME = TAB	DESIGNED — LRR/MJC	REVISED — 09-06-2023
	DRAWN — TAB	REVISED — ·
LOT SCALE =	CHECKED — LRR	REVISED — ·
OT DATE = 09-06-2023	DATE - 01/11/2023	REVISED — ·

STATE OF ILLINOIS
DEPARTMENT OF TRANSPORTATION

S	CHED	ULE	ES (	OF QL	JANTITIES
J	OHNSO	N STI		RECOI	NSTRUCTION
	SHEET NO	8 0	104	CHEETS	

F.A.U. RTE.	SEC.	TION		COUNTY	TOTAL SHEETS	SHEE.
6926	19-00155	-00-PV		McD0N0UGH	104	8
JOH	NSON ST & GF	RANT ST		CONTRACT NO	0. 89809	
		ILLINOIS F	PROJE	CT NO. 11SC(152)		

	CULVERT REMOVAL						
		50105220	X1200050	20800150			
STATION	LT / RT	PIPE CULVERT REMOVAL	BOX CULVERT REMOVAL	TRENCH BACKFILL			
		FOOT	FOOT	CU YD			
JOHNSON STREET							
402+95	RT	58					
403+00	LT	58					
404+37	CL	41					
407+00	RT	79					
409+15	CL	46					
409+33	RT	32					
414+15	RT	41					
416+06	C/L		32	19			
416+32	LT	20					
417+75	LT	24					
420+83	RT	41					
421+43	LT	46					
422+14	LT	32					
423+38	LT	43					
424+13	LT	37					
428+58	RT	51					
	TOTALS	649	32	19			

STORM SEWER STRUCTURE REMOVAL					
	60500050	60500060			
	REMOVING MANHOLES	REMOVING INLETS			
LOCATION	EACH	EACH			
420+49, 23.3' RT		1			
431+55, 24' RT		1			
431+67, 24' LT		1			
432+18, 24.9' RT	1				
TOTALS	1	3			

STORM SEWER REMOVAL					
	55100500	55100700	55100900	20800150	
	12"	15"	18"	TRENCH BACKFILL	
LOCATION	FOOT	FOOT	FOOT	CU YD	
JOHNSON STREET					
431+55, 22' RT TO 431+67, 22' LT		46		15	
431+55, 22' RT TO 432+17, 25' RT			61		
432+17, 25' RT TO 433+44, 22' RT			126		
GRANT STREET					
91+34, 18' RT TO 91+74, 67' RT	63			11	
TOTALS	63	46	187	26	

	HMA TRANSITIONS					
	40600982	40604050	40600295			
	HMA SURFACE REMOVAL (BUTT JOINT)	HMA SURFACE COURSE IL-95 MIX C N50	POLYMERIZED BIT MATLS (TACK COAT)			
LOCATION	SQ YD	TON	POUND			
JOHNSON STREET						
400+40 TO 400+50	24	3	18			
433+46.28 TO 433+56.23	41	5	29			
HARMONY LANE						
402+93, 65.9' RT TO 75.9' RT	36	4	26			
WEAR AVENUE						
01+95.4 TO 02+05.4	18	2	13			
GRANT STREET						
85+90 TO 86+00	28	3	20			
94+21.76 TO 94+31.76	40	5	29			
TOTALS	187	22	135			

66500105						
	'EN WIRE FENCE, 4'					
LOC	ATION					
FROM	<u>TO</u>	FOOT				
405+15.8, 45' LT	409+00, 45' LT	384				
409+00, 45' LT	409+75, 40' LT	75				
409+75, 40' LT	414+70.7, 40' LT	496				
414+70, 40' LT	01+20.2, 25.4' RT	144				
TOTAL		1099.00				

66400505								
CHAI	CHAIN LINK FENCE, 8'							
LOCA	LOCATION							
FROM	то	FOOT						
419+80.12, 100' RT	419+98.1, 40.65' RT	62						
427+65, 40.78' RT 428+17.52, 49.0' RT 53								
TOTAL	TOTAL 115							

CONCRETE STEPS									
	Z0012450	50800205	50901760						
LOCATION	CONCRETE STEPS	REINFORCEMENT BARS EPOXY COATED	PIPE HANDRAIL						
	CU YD	POUND	FOOT						
93+51.7 RT (GRANT ST)	4	250	52						
TOTALS	4	250	52						

PERMANENT SURVEY MARKERS								
66700205 66700305								
	PERMANENT SURVEY MARKER TYPE I	PERMANENT SURVEY MARKER TYPE II						
LOCATION	EACH	EACH						
405+18.61, 21.81' RT	1							
406+03.51, 21.96' RT		1						
432+00.79, 12.71' RT	1							
432+77.41, 12.27' RT	1							
TOTALS	3	1						

CONCRETE COLLAR									
	54248510 50800105								
	CONCRETE REINFO								
LOCATION	SIZE	CU YD	POUND						
409+07.5, 39.8' RT	18"	0.5	30						
431+77, 74.8' RT	12"	0.4	24						
TOTALS		0.9	54						

SEGMENTAL CONCRETE BLOCK WALL										
	52200800	60146304								
LOCATION	SEGMENTAL CONCRETE BLOCK WALL	PIPE DRAINS 4"	PIPE UNDERDRAINS FOR STRUCTURES 4"							
	SQ FT	FOOT	FOOT							
329+95 TO 431+55.84 RT	460	56	124							
TOTALS	460	56	124							

		SIGN SC	HEDULE							
	72000100									
		SIG	N PANEL TY	'PE 1						
	R1-1	R3-6	R3-8	R3-9b	R4-7	TELES STEEL SIGN SUPPORT				
OCATION	SF	SF	SF	SF	SF	FT				
100+00 TO 407+50	18.75			12	6	84				
107+50 TO 415+50	18.75		12.5	6		84				
115+50 TO 422+00	6.25			12		42				
122+00 TO 429+50				6		14				
129+50 TO 433+60	25	7.5	12.5			98				
GRANT ST WEST			6.25		6	28				
GRANT ST EAST	6.25		6.25			28				
SUB-TOTALS	75	7.5	37.5	36	12					
TOTALS			168		•	378				

		MODIFIED	URETHANE PAVEMEN	T MARKING TABULAT	ΓΙΟΝ		
	78009000	78009000 78009004 78009006 7800				78009012	78009024
LOCATION	LETTERS & SYMBOLS, WHITE (LARGE)	LINE, 4" DOUBLE YELLOW	LINE, 4" SKIP DASH YELLOW	LINE, 6" WHITE	LINE, 8" WHITE	LINE, 12" DIAGONAL YELLOW	LINE, 24" WHITE (STOP BAR)
JOHNSON STREET	SQ FT	FOOT	FOOT	FOOT	FOOT	FOOT	FOOT
400+50 to 402+70		848				75	
402+95 LT (Greenview Ent.)							14
403+02 RT (Harmony Lane)				96			18
403+32 to 404+75	31.2		364				
405+05 RT (New School)		10		115	5		26
405+31 to 407+95	31.2	808			115	48	
408+29 RT (New School)		32		113	16		25
408+55 to 414+87	124.8	742	964		114	48	
414+13 RT (MHS South Ent.)				103			18
415+05 LT (Wear Ave.)							12
415+37 to 428+25	249.6		3,236				
419+62 RT (MHS North Ent.)				103			18
428+58 RT (McArthur Ent.)				103			
428+86 to 431+70	124.4	570			185		26
432+59 to 433+54	38.4	297		136		4	18
GRANT STREET							
86+00 to 90+48	150.2	1,490			150	99	30
91+52 to 94+75	150.2	847		126	175	31	31
93+00 RT (McArthur Ent.)				96			31
		5,644	4,564				
TOTALS	900.0	10,	,208	991	760	305	267



USER NAME = TAB	DESIGNED — LRR/MJC	REVISED — 09-06-2023
	DRAWN — TAB	REVISED - ·
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PLOT DATE = 09-06-2023	DATE - 01/11/2023	REVISED - ·

F.A.U. RTE.	SEC <sup>-</sup>	ΓΙΟΝ		COUNTY	TOTAL SHEETS	SHEET NO.
6926	19-00155-	-00-PV		McDONOUGH	104	9
JOH	NSON ST & GF	RANT ST		CONTRACT NO	0. 89809	
		ILLINOIS	PROJE	CT NO. 11SC(152)		

								WAT	TER MAIN 8	FITTINGS	SCHEDULE										
	56100500	56100700	X5630704	56400100	56400500	X5630708	56104800	56105000	56100010	56100020	56109420	56109430	56109434	56101150	X0120014	56400820	X5620030	X0324636	56500800	56500500	56200300
	WATER MAIN 4"	WATER MAIN 8"	CONNECT TO EXISTING WATER MAIN 4"	FIRE HYDRANT TO BE MOVED	FIRE HYDRANT TO BE REMOVED	CONNECT TO EXISTING WATER MAIN 8"	WATER VALVE 4"	WATER VALVE 8"	8"X8"X4" TEE	8"x8"x8" TEE	8"-45 DEGREE BEND	4"-90 DEGREE BEND	8"-90 Degree Bend	8"x6" Reducer	WATER MAIN ABANDONMEN T	FIRE HYDRANT WITH AUX. VALVE	WATER SERVICE CONNECTION 1"	WATER VALVE BOXES TO BE ABANDONED	DOMESTIC WATER SERVICE BOXES	DOMESTIC METER VAULT	WATER SERVICE LINE 1"
LOCATION	FOOT	FOOT	EACH	EACH	EACH	EACH	EACH	EACH	EACH	EACH	EACH	EACH	EACH	EACH	EACH	EACH	EACH	EACH	EACH	EACH	FOOT
22' RT, 86+75					1																
18.8' RT, 87+40		13				1							1		1						
32' RT, 87+31																1					
32' RT, 87+31								1		1				1							
32' RT, 87+40 TO 53.5' RT 90+58.5		319																			
33.9' RT, 88+54.9																	1		1	1	116
24' RT, 89+23																		1			
39.2' RT, 89+25							1		1												
39.8' RT 89+31 TO 47' RT, 89+37	87																				
44.2' LT, 89+33.4																	1		1		
47' LT, 89+37			1									2			1						
55.4' RT, 90+47.7											1										
52.1' RT, 90+55.2											1										
59.3' LT, 90+56				1																	
53.6' RT, 90+58.5						1															
49.6' RT, 90+60.2															1						
TOTALS	87	332	1	1	1	2	1	1	1	1	2	2	1	1	3	1	2	1	2	1	116

		WATER ADJU	JSTMENTS		
	56400810	56500300	56500600	60266600	X5620128
	FIRE HYDRANT EXTENSION	DOMESTIC METER VAULTS TO BE ADJUSTED	DOMESTIC WATER SERVICE BOXES TO BE ADJUSTED	VALVE BOXES TO BE ADJUSTED	ADJUSTING WATER SERVICE LINES
LOCATION	FOOT	EACH	EACH	EACH	EACH
400+72 TO 401+25 RT					1
403+05.06, 36.4' RT				1	
403+08.2, 35.1' RT				1	
403+23.6, 36.4' RT				1	
412+40.8, 40.4' RT				1	
416+40.3, 28.5' RT	1				
416+40.3, 32.6' RT				1	
420+22.7, 25.4' RT	1				
420+22.7, 27.5' RT				1	
420+97.8, 38.4' LT		1			
420+98.5, 34.5' LT			1		
421+87.0, 32.7' LT			1		
421+87.0, 35.5' LT		1			
424+95.0, 30.3' LT			1		
424+95.4, 33.5' LT		1			
429+00.8, 29.3' RT				1	
432+90, 24.9' RT					1
TOTALS	2	3	3	7	2

60255500						
MANHOLE TO BE A	DJUSTED					
LOCATION	EACH					
JOHNSON STREET						
431+62.4, 57.7' LT	1					
431+64.3, 80.1' LT	<u>1</u>					
TOTAL	2					

60500105									
FILLING MANHOLES  LOCATION EACH  GRANT STREET									
FILLING MANHO LOCATION GRANT STREET	EACH								
GRANT STREET									
431+62.4, 57.7' LT	1								
TOTAL	1								

X1200036										
SANITARY SERVICE CLEANOUT										
LOCATION	EACH									
JOHNSON STREET										
430+80.7, 21.75' RT	1									
GRANT STREET										
90+44, 48.3' LT	1									
TOTAL	2									



USER NAME = TAB	DESIGNED — LRR/MJC	REVISED - 09-06-2023
	DRAWN — TAB	REVISED
PLOT SCALE =	CHECKED — LRR	REVISED
PLOT DATE = 09-06-2023	DATE - 01/11/2023	REVISED

STATE OF ILLINOIS
DEPARTMENT OF TRANSPORTATION

_	_		EET		JANTITIES DISTRUCTION
SHEET NO.	10	OF	104	SHEETS	

SCALE:

F.A.U. RTE.	SEC	TION		COUNTY	TOTAL SHEETS	SHEET NO.
6926	19-0015	5-00-P	٧	McDONOUGH	104	10
JOH	INSON ST & G	RANT S	Т	CONTRACT NO	0. 89809	
		ILLINOIS	PROJE	CT NO. 11SC(152)	)	

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lovember 2, 2023 11:51:16 AM	\19000882.01\DESIGN\CIVIL\C3D\PLOT\
Thursday, i	G: \2019\1

	1EG
714 E. JACKSON STREET	PH: 309.833.4594
MACOMB, IL 61455	www.imegcorp.com
	atration #184.007637-0014 ALL RIGHTS RESERVED

USER NAME = TAB	DESIGNED	_	LRR/MJC	REVISED	_	09-06-2023
	DRAWN	_	TAB	REVISED	-	•
PLOT SCALE =	CHECKED	_	LRR	REVISED	-	•
PLOT DATE = 09-06-2023	DATE	_	01/11/2023	REVISED	_	

X6024242

60235700

60236200

60240210

60240220

X6021824

60218400

60221100

60223800

60223700

60224071

60224446

MH TY A 7' DIA

TY 1 FR & CL

1

1

60224459

MH TY A 8' DIA

TY 1 FR & CL

1

54244405

FLUSH INLET

BOX FOR

MEDIANS

STATE OF ILLINOIS DEPARTMENT OF TRANSPORTATION SCHEDULES OF QUANTITIES
JOHNSON STREET RECONSTRUCTION
MACOMB, ILLINOIS
SHEET NO. 11 OF 104 SHEETS

F.A.U. RTE.	SEC.	TION	COUNTY	TOTAL SHEETS	SHEET NO.	
6926	19-00155	-00-PV		McD0N0UGH	104	11
JOH	NSON ST & GF	RANT ST		CONTRACT NO	D. 89809	
		ILLINOIS F	PROJE	CT NO. 11SC(152)		

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November 2	19000882.01
Thursday,	C:\2019\

	550B0050	550B2320	55080070	550B2330	55080090	550B2340	550B0120	55080180	550B2410	55080190	55080340	550B0380	55080410	550B0450	550B2600	550B0430	550B0470	542A5497	542D0220	54213447	54213477	54213693	54214317	54262715	20800150
	CLASS B, TYPE 1, 12"	RG CLASS B, TYPE 1, 12"	CLASS B, TYPE 1, 15"	RG CLASS B, TYPE 1, 15"		RG CLASS B, TYPE 1, 18"	CLASS B, TYPE 1, 24"		RG CLASS B, TYPE 1, 42"	CLASS B, TYPE 1, 48"	CLASS B, TYPE 2, 12"	CLASS B, TYPE 2, 18"	CLASS B, TYPE 2, 24"	CLASS B, TYPE 2, 36"	RG CLASS B, TYPE 2 36"	CLASS B, TYPE 2, 30"	CLASS B, TYPE 2, 42"	PIPE CULVERT CLASS A, TYPE 1 EQRS 42"	PIPE CULVERT CLASS D, TYPE 1, 15"	END SECTIONS 12"	END SECTIONS 42"	END SECTIONS 48"	END SECTIONS, EQRS 42"	METAL FL END SEC, 15"	TRENCH BACKFILL
RUCTURE-STRUCTURE	FOOT	FOOT	FOOT	FOOT	FOOT	FOOT	FOOT	FOOT	FOOT	FOOT	FOOT	FOOT	FOOT	FOOT	FOOT	FOOT	FOOT	FOOT		EA	EA	EA	EA	EA	CY
7 INLET - 01-6 INLET			33																						8.2
6 INLET - 01-5 MANHOLE												29													3.8
5 MANHOLE - 01-4 MANHOLE												85													16.6
4 MANHOLE - 01-3 MANHOLE													354											++	167.5
3 MANHOLE - 01-2 MANHOLE													106											++	
2 MANHOLE - FE 01-2.1																	175							++	
4.2 INLET - 01-4.1 INLET	33																								6.4
3.2 INLET - 01-3.1 INLET	33																								6.7
3.1 INLET - 01-3 MANHOLE	2																							++	0.5
7 INLET - 02-6 MANHOLE							32																	++	-
-6 MANHOLE - 02-5 MANHOLE														200		60								++	36.3
-5 MANHOLE - 02-4 INLET														298										++	-
-4 MANHOLE - 02-3 MANHOLE														165	0.5									+	
-3 MANHOLE - 01-2 MANHOLE	20														95									<del>                                     </del>	119.8
-2 INLET - 02-1 INLET	39																								10
1 INLET - 01-2 MANHOLE	2																								0.6
6.1 INLET - 02-6 MANHOLE				20																					4.1
5.2 INLET - 02-5.1 INLET	40				-														-		-				7.3
5.1 INLET - 02-5 MANHOLE		18																	-		-				3.9
4.2 INLET - 02-4.1 INLET			33										<u> </u>						-		-				5.5
-4.1 INLET - 02-4 INLET				27	-														-		-				4.6
-3.1 INLET - 02-3 MANHOLE	_	18		-	-														-		-				16.3
-4.1 INLET - 01-4 MANHOLE	2																								0.5
4 INLET - 11-1 MANHOLE				85									<u> </u>						-		-				17.1
-3 INLET - 11-2 INLET					49																				13.2
-2 INLET - 11-1 MANHOLE												48													25.3
-1 MANHOLE - 12-1 INLET													73												61.8
-2 INLET - 12-1 INLET				41																					6.8
-1 INLET - 12-3 MANHOLE													45												16.6
-1.1 INLET - 11-1 MANHOLE	35																								10.1
OM EXISTING 12" - 11-1.1 INLET											38													$\perp$	0.3
-1 INLET - 11-1.1 INLET	95																								14.4
-4.3 INLET - 01-4 MANHOLE	4																								
3-3 INLET - 03-2 INLET	33																								6.1
3-2 INLET - 03-1 MANHOLE	7																							$\perp$	0.6
3-1 INLET - 03-1.1 INLET											138													$\perp$	
3-1.1 INLET - FE 03-1.2											16													$\perp$	
4-5 MANHOLE - 04-4 INLET					5																				0.6
4-4 INLET - 04-2 INLET					33																			$\perp$	8.5
4-2 INLET - 04-1 MANHOLE					14																			$\perp$	1.9
KISTING 18" RCP - 04-5 MANHOLE						11																			2.7
5-3 INLET - 05-2 INLET	39																								8
5-2 INLET - 05-1 MANHOLE	5																								0.6
5-3 INLET - 06-2 INLET	33																								7.1
-2 INLET - 06-1 MANHOLE	5																								0.7
-1 INLET - 08-2 MANHOLE	43																								7
8 - 08-4 MANHOLE								14																	
3-4 MANHOLE - 08-2 MANHOLE									173																21.1
3-2 MANHOLE - 06-1 MANHOLE								123																	
-1 MANHOLE - 05-1 MANHOLE								201																	
-1 MANHOLE - 04-1 MANHOLE								126																	
-6 INLET - 08-7 INLET											13														
-3 INLET - 09-2 INLET						51																			11.1
9-2 INLET - 08-4 MANHOLE							46																		13.2
3-5 INLET - 08-6 INLET		25																							4.4
8-7 INLET - 08-4 MANHOLE											2														
-1 END SEC - 10.2 END SEC																		68							7.8
-1 MANHOLE - FE 4-1.1										23															
-2 INLET - 08-2 MANHOLE	10																								
10-1A TO FE 10-1B																			56						
0+34, 23.2' RT - FE 10-1A																								1	
0+94, 25.2' RT - FE 10-1B																								1	
1+14.19, 35.52' RT - FE 10-1																							1		
1+54, 38.09' LT - FE 10-2																							1		
02+51.35, 45.16' LT - FE 8-4																					1		_		
09+45.2, 54.7' LT - FE 4-11																					<u> </u>	1			
9+49.85, 50.64' LT - FE 03-1.2																				1				<del>                                     </del>	
																				<u> </u>	1			+	
9+94.9, 210.2' LT - FE 01-2.1	1					1							1				1		1	1				1 1	
9+94.9, 210.2' LT - FE 01-2.1  TOTALS	460	61	66	173	101	62	78	464	173	23	207	162	578	463	95	60	175	68	56	1	2	1	2	2	686

STORM SEWER PIPE


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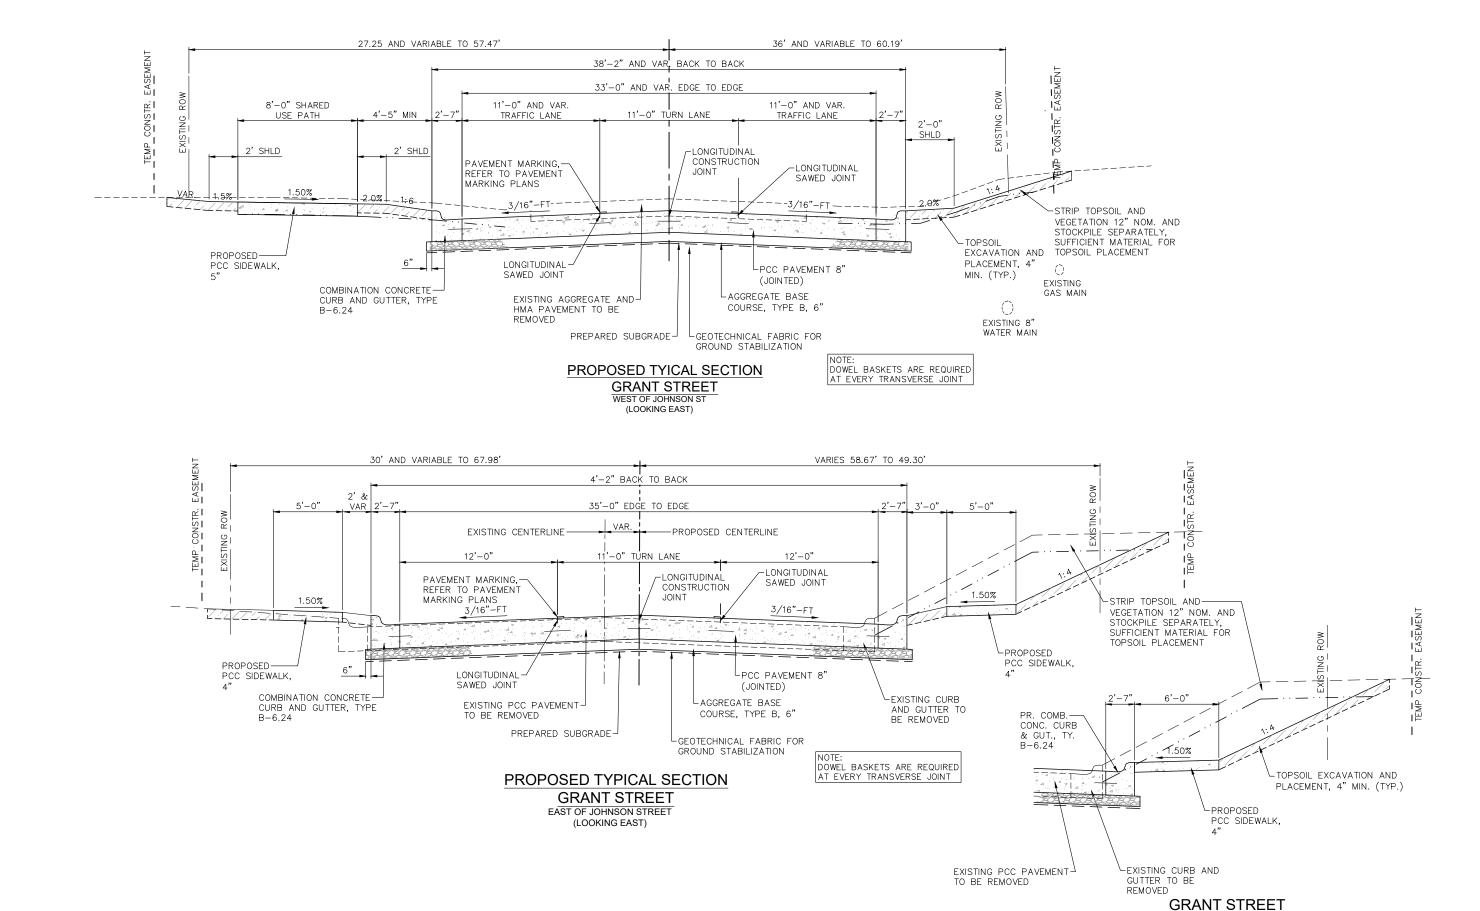
USER NAME = TAB	DESIGNED	_	LRR/MJC	REVISED	_	09-06-2023
	DRAWN	_	TAB	REVISED	-	•
PLOT SCALE =	CHECKED	_	LRR	REVISED	-	•
PLOT DATE = 09-06-2023	DATE	_	01/11/2023	REVISED	_	

DEPARTMENT OF TRANSPORTATION

S	CHED	ULE	S OF QI	UANTITIES
J	OHNSO	N STR	EET RECO	NSTRUCTION
	CHEET NO	12 05	104 CHEETC	

F.A.U. RTE.	SECTION	COUNTY	TOTAL SHEETS	SHEET NO.
6926	19-00155-00-PV	McDONOUGH	104	12
JOH	NSON ST & GRANT ST	CONTRACT NO	D. 89809	
	ILLINOIS PROJE	CT NO. 11SC(152)		



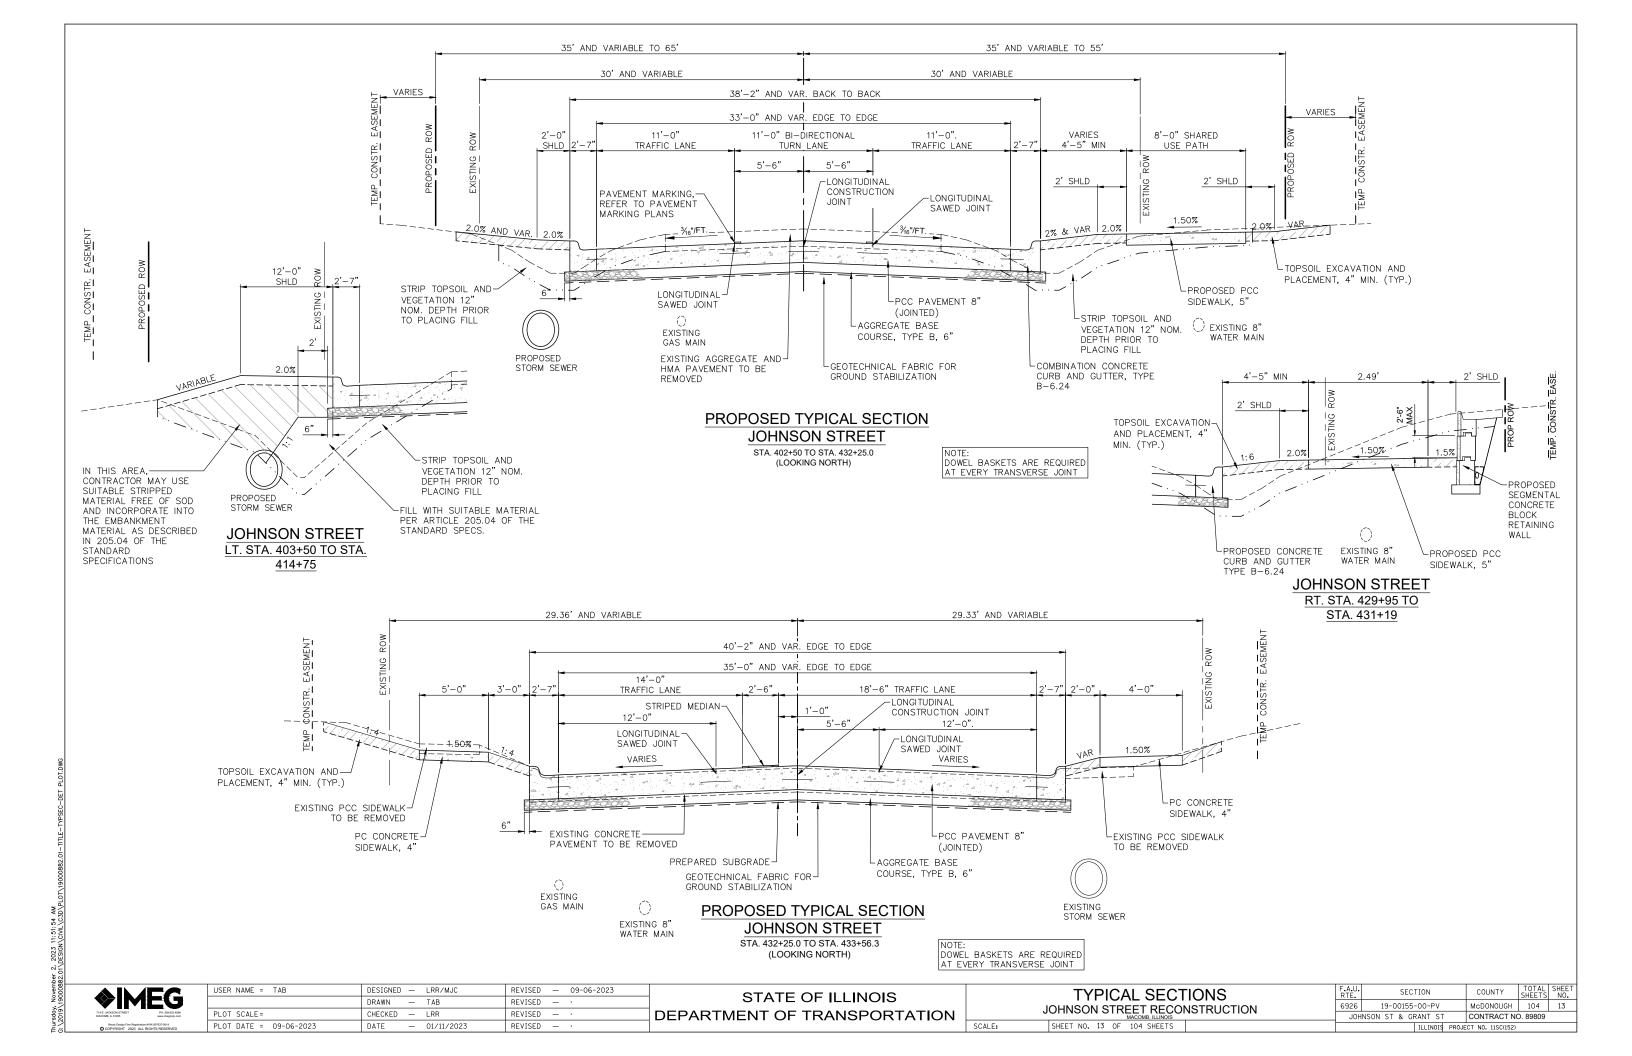

	EG
714 E. JACKSON STREET	PH: 309.833.4594
MACOMB, IL 61455	www.imegcorp.com

USER NAME = TAB	DESIGNED —	LRR/MJC	REVISED — 09-06-2023	
	DRAWN —	TAB	REVISED - ·	STATE OF ILLINOIS
PLOT SCALE=	CHECKED —	LRR	REVISED — ·	DEPARTMENT OF TRANSPORTATION
PLOT DATE = 09-06-2023	DATE —	01/11/2023	REVISED - ·	


JOHNSON STRE	L SECTIONS ET RECONSTRUCTION
SHEET NO. 14 OF 1	104 SHEETS


SCALE:

RTE.	SECTION	COUNTY	SHEETS	NO.		
6926	19-00155-00-PV	McDONOUGH	104	14		
JOH	NSON ST & GRANT ST	CONTRACT NO	D. 89809			
ILLINOIS PROJECT NO. 11SC(152)						

RT. STA. 93+22 TO STA. 94+21.76

	USER NAME = TAB	DESIGNED — LRR/MJC	REVISED —	09-
<b>VIMEG</b>		DRAWN — TAB	REVISED —	
714 E. JACKSON STREET PH: 309.033.4594 MACOMB, E. 61455 www.imegoarp.com	PLOT SCALE=	CHECKED — LRR	REVISED —	
Illinois Design Firm Registration #184.007537-0014	PLOT DATE = 09-06-2023	DATE - 01/11/2023	REVISED —	

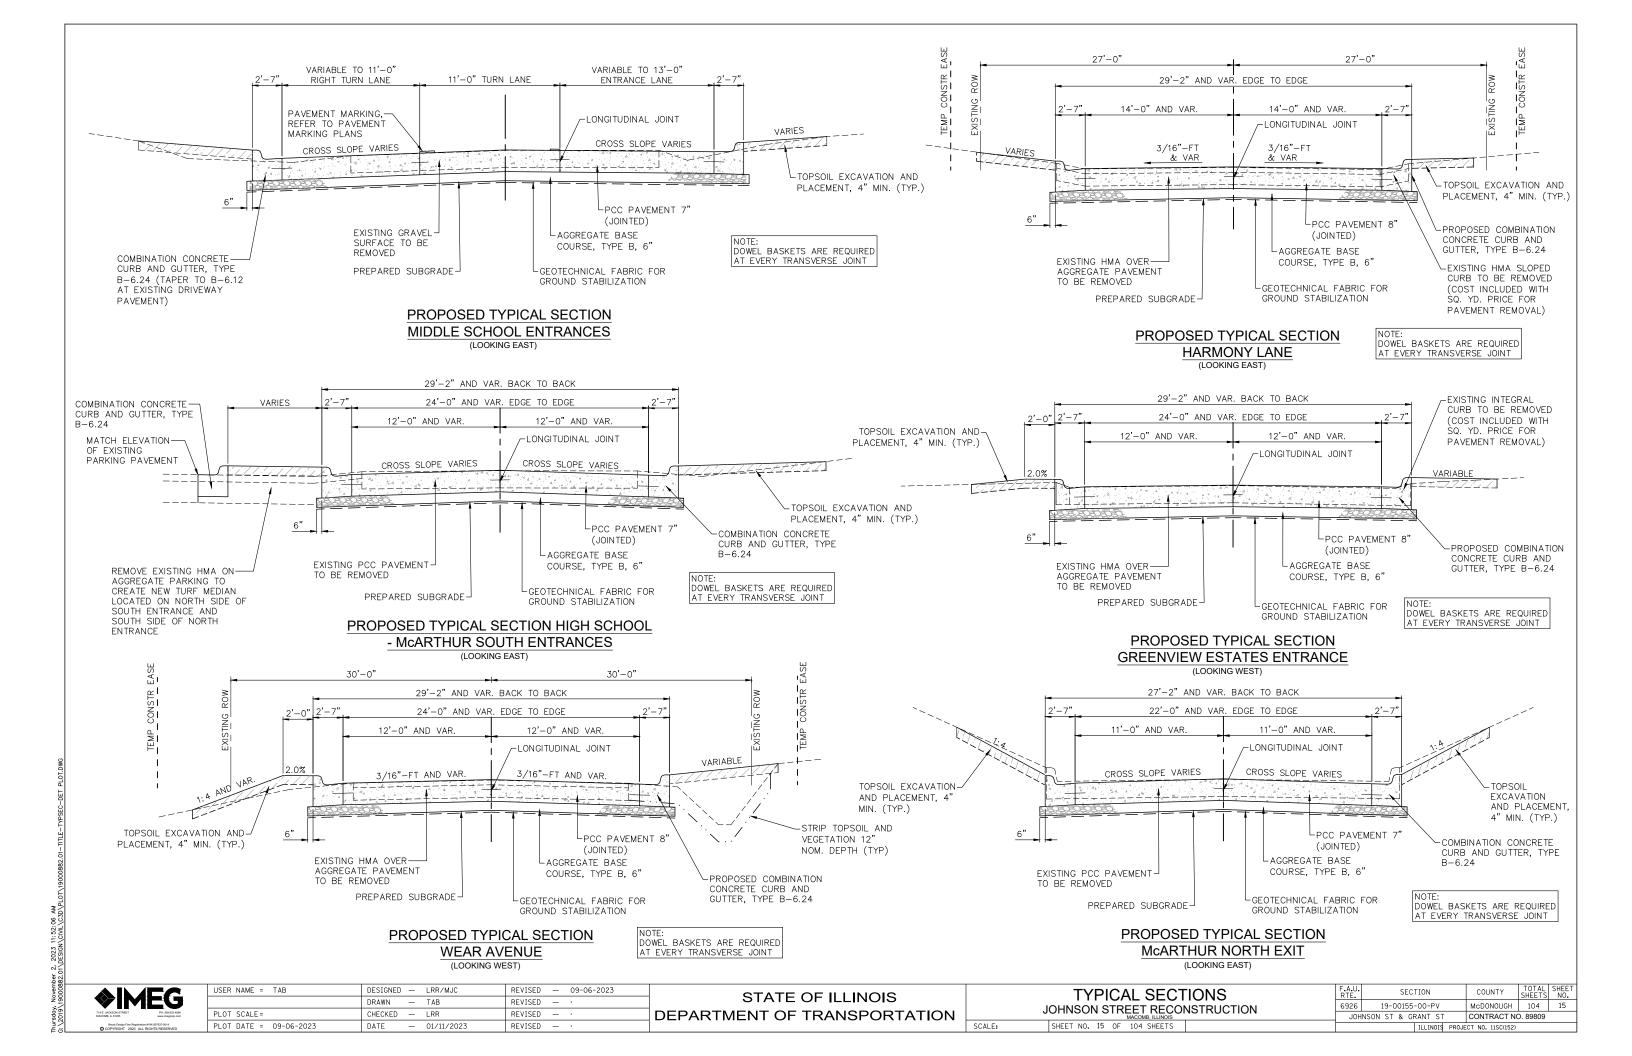

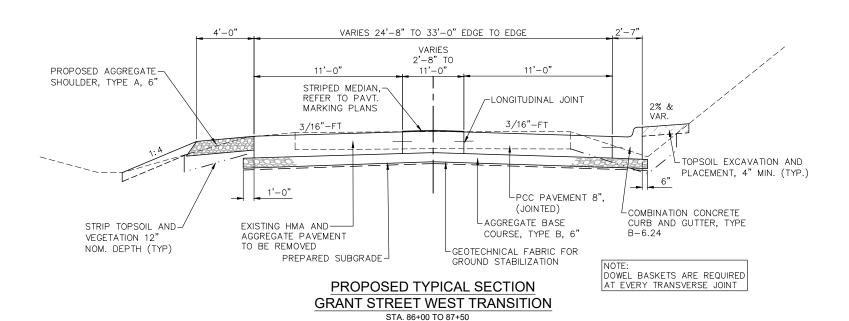

(LOOKING EAST)

THE ACCION STREET PH 300 ACCION NO PER PAGE ACCION

 USER NAME = TAB
 DESIGNED - LRR/MJC
 REVISED - 09-06-2023
 09-06-2023

 PLOT SCALE = PLOT DATE = 09-06-2023
 DATE - 01/11/2023
 REVISED - 09-06-2023
 - 09-06-2023


TYPICAL SECTIONS


JOHNSON STREET RECONSTRUCTION

MACOMB, ILLINOIS

SHEET NO. 16 OF 104 SHEETS

REVISED	_	09-06-2023	CTATE OF ILLINIOIS	
REVISED	_	•	STATE OF ILLINOIS	
REVISED	_	•	DEPARTMENT OF TRANSPORTATION	
DEVICED				SCALE.

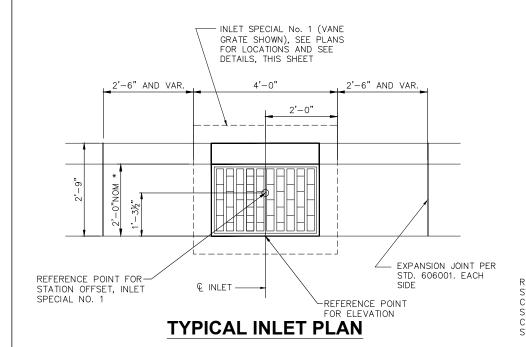

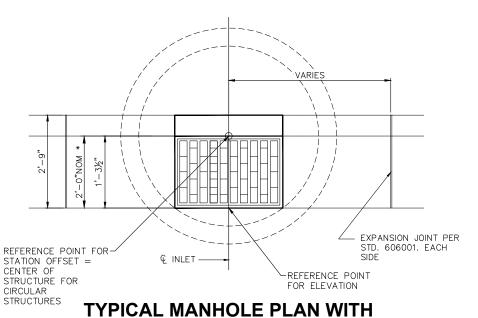

**CURB INLET FRAME** 

FRAME AND GRATE, SEE NOTE 1 GRATE=ELEVATION, SEE PLAN FOR EACH C.C.C.&G, ELEVATION TYPE B6.24 PAVEMENT, 7" OR 8" GROUT BED, TYPICAL 3'-0" 6" PRECAST CONCRETE SECTIONS OUTLET PIPE CONSTRUCTED IN ACCORDANCE WITH ARTICLE 602.07 Δ Δ Q INLET -- SAND CUSHION

1. FRAME AND GRATE FOR INLETS SPECIAL No. 1 SHALL BE IN ACCORDANCE WITH DISTRICT STANDARD 604001-D4. DIAGONAL GRATE SHALL BE USED IN SAG LOCATIONS. VANE GRATE SHALL BE USED AT ALL OTHER LOCATIONS.

2. INLET TO BE CONSTRUCTED IN ACCORDANCE WITH SECTION 602 OF THE STANDARD SPECIFICATIONS AND THE SPECIAL PROVISIONS FOR THIS PROJECT.

3. REINFORCEMENT SHALL BE IN ACCORDANCE WITH IDOT STANDARD DRAWING 602006-04, CATCH BASIN TYPE

# **INLET SPECIAL NO. 1 DETAIL**

DESIGNED — LRR/MJC REVISED - 09-06-2023 USER NAME = TAB DRAWN — TAB REVISED PLOT SCALE = CHECKED — LRR REVISED PLOT DATE = 09-06-2023 DATE - 01/11/2023 REVISED

TYPICAL DETAILS JOHNSON STREET RECONSTRUCTION

19-00155-00-PV McDONOUGH 104 17 JOHNSON ST & GRANT ST CONTRACT NO. 89809

# **BUTT JOINT DETAIL**


HMA SURFACE -COURSE, 2" (ONE

SAWCUT PRIOR TO -HMA PLACEMENT


HMA SURFACE REMOVAL-

(BUTT JOINT)

ROADWAY SURFACE

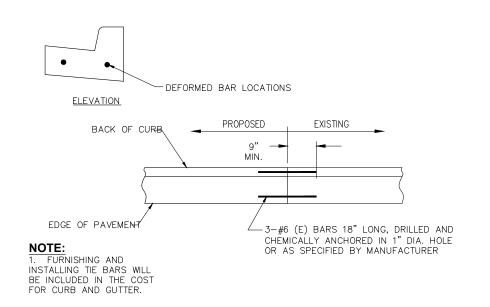

# TIE TO EXISTING CURB DETAIL

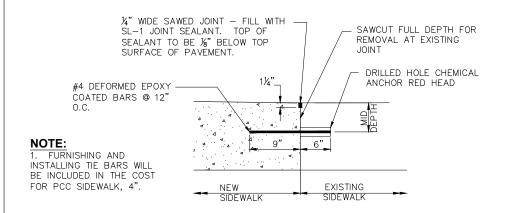

# TIE TO EXISTING SIDEWALK DETAIL


**♦IMEG** 


FRONT ELEVATION


STATE OF ILLINOIS DEPARTMENT OF TRANSPORTATION

**SECTION** 

SHEET NO. 17 OF 104 SHEETS

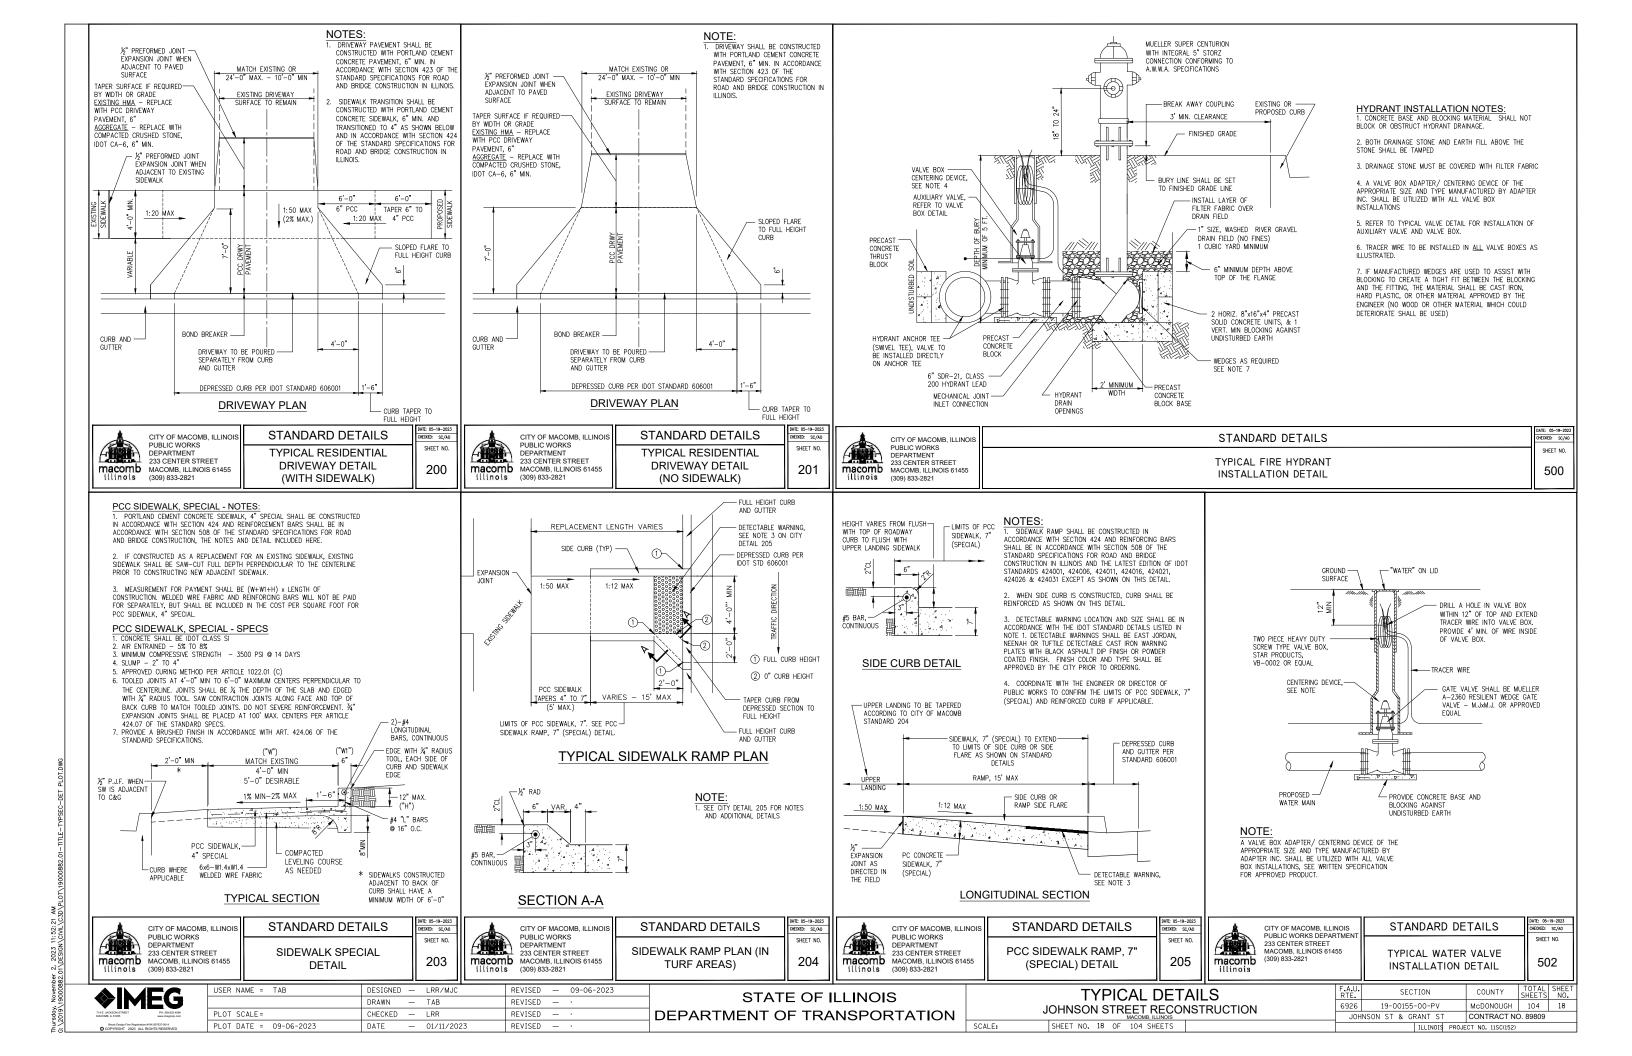


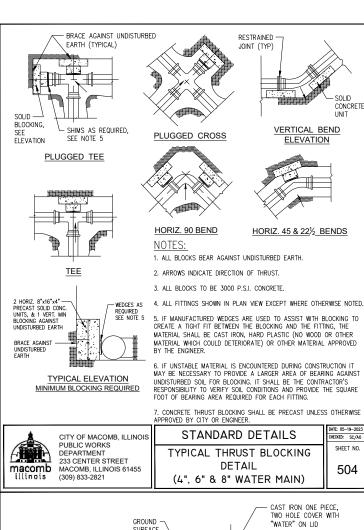

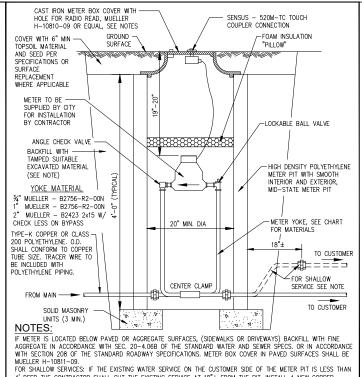

4' DEEP THE CONTRACTOR SHALL CUT THE EXISTING SERVICE AT 18"± FROM THE PIT, INSTALL A NEW COPPER "GOOSENECK" TO REACH THE REQUIRED DEPTH OF 4' MIN. COVER. THE CONTRACTOR SHALL THEN PROCEED WITH THE INSTALLATION OF THE NEW METER AND PIT AS SHOWN IN THIS DETAIL.

STANDARD DETAILS CITY OF MACOMB, ILLINOIS PUBLIC WORKS DEPARTMENT 233 CENTER STREET WATER METER INSTALLATION DETAIL 505 macomb MACOMB, ILLINOIS 61455 (309) 833-2821 (METER SIZE 2" & UNDER)

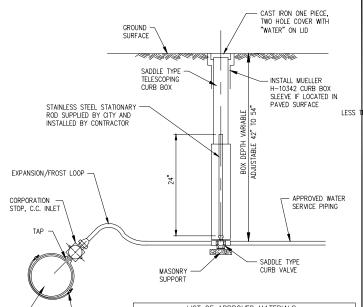

LIST OF APPROVED MATERIALS BRONZE SERVICE CORPORATION CURB CURB BOX STOP VALVE MODEL MODEL MODEL MODEL -13000 OR S-13000 H-15008N H-1504-2N H-10314 H-13000 OR S-13000 | H-15008N | H-1504-2N | H-10314 H-13000 OR S-13000 H-15008N B-25209N H-10386 2" H-13000 OR S-13000 H-15008N B-25209N H-10386


SERVICE ITEMS AS MANUFACTURED BY MUELLER. SEE SPECIAL PROVISION FOR OTHER ACCEPTABLE MANUFACTURERS

CITY OF MACOMB, ILLINOI PUBLIC WORKS DEPARTMENT

233 CENTER STREET

STANDARD DETAILS TYPICAL WATER SERVICE INSTALLATION DETAIL

SHEET NO 503

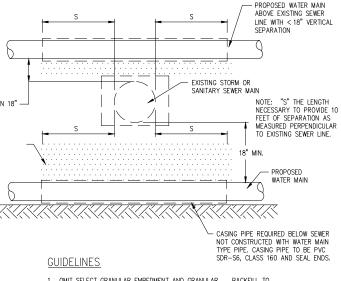

1. OMIT SELECT GRANULAR EMBEDMENT AND GRANULAR BACKFILL TO ONE (1) FOOT OVER TOP OF WATER MAIN AND USE SELECT EXCAVATED MATERIAL (CLASS IV) AND COMPACT THE LENGTH OF CASING.

2. IF SELECT GRANULAR BACKFILL EXISTS, REMOVE WITHIN WIDTH OF EXISTING SEWER TRENCH AND REPLACE WITH SELECT EXCAVATED MATERIAL (CLASS IV) AND COMPACT TO A MINIMUM OF 95% STANDARD PROCTOR DENSITY. AS AN OPTION, CLSM MAY BE USED.

3. PROVIDE ADEQUATE SUPPORT FOR SEWER LINE TO PREVENT DAMAGE DUE TO SETTLEMENT.

4. WHEN WATER MAIN IS ABOVE SEWER, POINT LOADS SHALL NOT BE ALLOWED BETWEEN WATER MAIN CASING AND SEWER.

#### WATER AND SEWER SEPARATION REQUIREMENTS NOT TO SCALE

TYPICAL DETAILS JOHNSON STREET RECONSTRUCTION SHEET NO. 19 OF 104 SHEETS

PROPOSED 6" PVC, SDR-26 OR SCHEDULE 40 CLEANOUT RISER PIPE

AND REPLACEMENT PIPE

REMOVE AND REPLACE-

INSTALL NEW WYE AND

EXISTING SANITARY

SERVICE, FIELD

VERIFY MATERIAL

COUPLINGS

LENGTH AS REQUIRED TO

FLEXIBLE NEOPRENE

COUPLING, EACH END

COUNTY 19-00155-00-PV MCDONOLIGH 104 CONTRACT NO. 89809 JOHNSON ST & GRANT ST

'x6" WYE

-THREADED CLEANOUT ACCESS FITTING

-BACKFILL BELOW

BACKFILLED WITH

MATERIAL

PAVEMENT, SIDEWALKS AND CURB AREAS WITH TRENCH BACKFILL. ALL

OTHER AREAS TO BE

SELECTED EXCAVATED

-BEDDING, HAUNCHING

TO 12" OVER PIPE

GRADATION CA-7

SHALL BE IDOT

CRUSHED ROCK


AND INITIAL BACKFILL

#### **CLEANOUT NOTES**

SEWER PIPE SHALL BE IDENTICAL AND/OR INVERTS OF BOTH PIPES IN EACH END SHALL BE AT THE SAME ELEVATION TO ASSURE A SMOOTH FLOWLINE.

3. COUPLING BETWEEN EXISTING PIPE AND REPAIR PIPE MATERIAL WITH STAINLESS STEEL BANDS, SUCH AS


EXISTING CLEANOUT SHALL BE REMOVED AND PIPE REMOVED AND REPLACE IN ACCORDANCE WITH THE NEW CLEANOUT. COST FOR COMPLETE REMOVAL OF EXISTING CLEANOUT AND REPLACEMENT OF EXISTING CARRIER PIPE SHALL BE INCLUDED IN THE CONTRACT PRICE FOR THE NEW SANITARY SERVICE CLEANOUT.

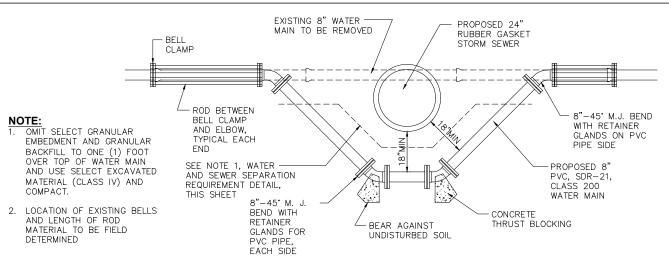

# **TUPICAL WATER MAIN ADJUSTMENT BELOW STORM SEWER DETAIL**

THREADED

CLEANOUT PLUG

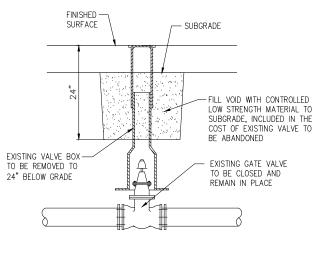

### WATER VALVE BOXES TO BE ABANDONED DETAIL

#### REPLACEMENT PIPE SHALL BE PVC, SDR 26. OR SCHEDULE 40 SEWER PIPE MATERIAL

# INSIDE DIAMETER OF REPLACEMENT PIPE AND EXISTING

# ON EACH END SHALL BE OF FLEXIBLE NEOPRENE TYPE FERNCO WITH SHEAR RINGS, OR EQUAL.

#### SANITARY SERVICE CLEANOUT DETAIL NOT TO SCALE

TYPICAL ELEVATION




SERVICE PIPING SHALL BE TYPE-K COPPER OR CLASS 200 POLYETHYLENE. O.D. SHALL CONFORM TO COPPER TUBE

TRACER WIRE TO BE INCLUDED WITH POLYETHYLENE PIPING.

(309) 833-2821

**♦IMEG** 

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**♦IMEG** 

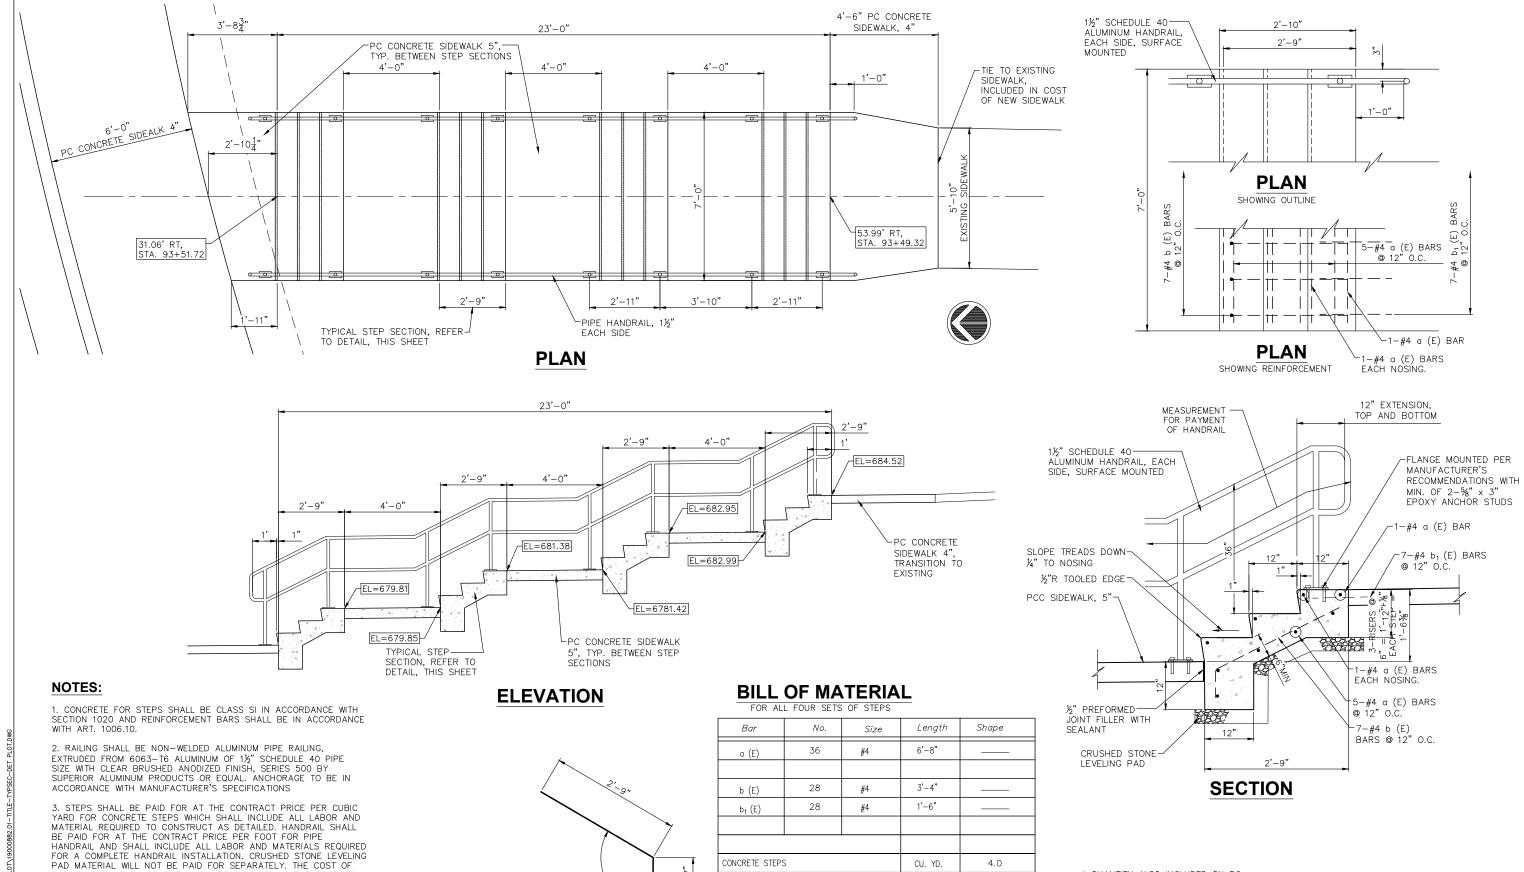THE CONCRETE STEPS

USER NAME = TAB DESIGNED - LRR/MJC REVISED - 09-06-2023 DRAWN — TAB REVISED -PLOT SCALE = CHECKED — LRR REVISED — PLOT DATE = 09-06-2023 DATE - 01/11/2023 REVISED

FURNISHING AND PLACEMENT SHALL BE INCLUDED IN THE COST OF

4. THE REINFORCEMENT BARS WILL MEASURED AND PAID FOR AT THE CONTRACT PRICE PER POUND FOR REINFORCEMENT BARS, EPOXY COATED

## STATE OF ILLINOIS DEPARTMENT OF TRANSPORTATION

PIPE HANDRAIL, 1½"

COATED)

REINFORCEMENT BARS (EPOXY

PC CONCRETE SIDEWALK, 5"

120°

BAR b (E)

SIDEWALK STEP DETAILS JOHNSON STREET RECONSTRUCTION SHEET NO. 20 OF 104 SHEETS

250

52

112\*

POUND


FOOT

SQ FT

\* QUANTITY ALSO INCLUDED ON PC

CONCRETE SIDEWALK, 5" SCHEDULE, SHEET


19-00155-00-PV McDONOUGH 104 20 JOHNSON ST & GRANT ST CONTRACT NO. 89809

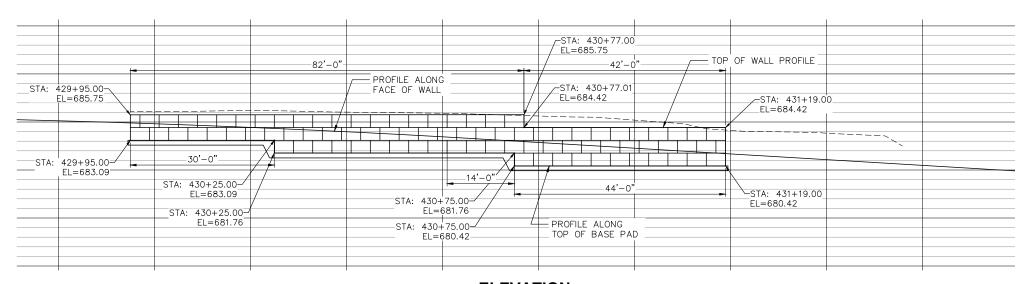

#### **BILL OF MATERIAL**

SEGMENTAL CONCRETE BLOCK WALL	SQ. FT.	460.0
PIPE UNDERDRAIN FOR STRUCTURES	FOOT	124
PIPE DRAINS, 4"	FOOT	56

# ELEVATION LOOKING AT BACK FACE

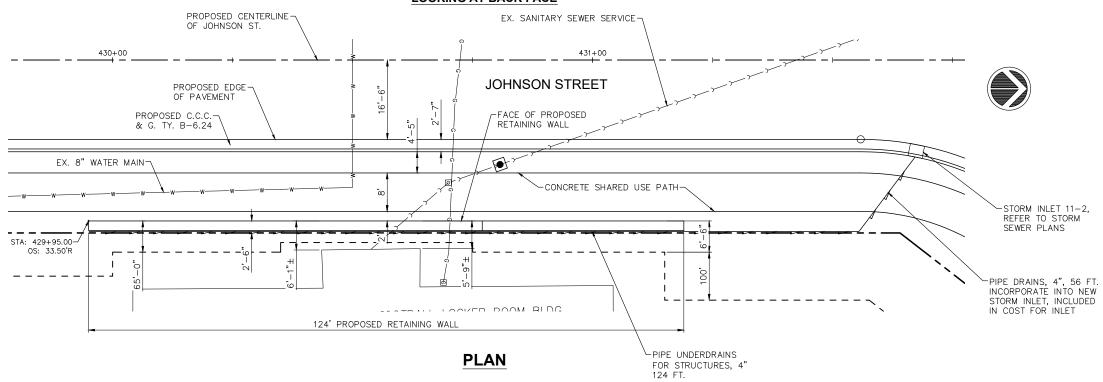

#### **GENERAL NOTES**

- I. ALL WORK SHALL CONFORM TO ILLINOIS DEPARTMENT OF TRANSPORTATION STANDARD SPECIFICATIONS FOR ROAD AND BRIDGE CONSTRUCTION, ADOPTED JANUARY 1, 2022 AND THE SUPPLEMENTAL SPECIFICATIONS AND RECURRING SPECIAL PROVISIONS ADOPTED JANUARY 1, 2023.
- 2. IT SHALL BE THE RESPONSIBILITY OF THE CONTRACTOR TO VERIFY ALL DIMENSIONS AND CONDITIONS EXISTING IN THE FIELD PRIOR TO CONSTRUCTION AND ORDERING MATERIALS.
- 3. ALLOWABLE SOIL PRESSURE AT TOE IS TO BE 1500 PSF. FIELD VERIFY AT TIME OF CONSTRUCTION.
- 4. BACKFILL BEHIND THE RETAINING WALL WITH POROUS GRANULAR BACKFILL IN ACCORDANCE W/ SECTION 209 OF THE STANDARD SPECIFICATIONS.
- 5. THE SQ. FT. PRICE FOR THE SEGMENTAL CONCRETE BLOCK RETAINING WALL WILL INCLUDE ALL EXCAVATION, FURNISHING AND INSTALLING THE CONCRETE BLOCKS, AGGREGATE OR CONCRETE LEVELING PAD, GEOTEXTILE FABRIC, COMPACTED AGGREGATE BACKFILL AT FACE OF WALL AND THE POROUS GRANULAR BACKFILL BEHIND THE WALL. THE EARTH EXCAVATION, UNDERDRAINS FOR STRUCTURES AND THE PIPE DRAINS (SPECIAL) WILL BE MEASURED AND PAID FOR SEPARATELY.




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PLOT DATE =	09-06-2023	DATE	_	01/11/2023	REVISED	_	•	

STATE OF ILLINOIS
DEPARTMENT OF TRANSPORTATION

	_		TR	EET		AND ELEVATION NSTRUCTION
SCALE:	SHEET NO.	21	OF	104	SHEETS	


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	6926	19-00155-00-PV	McD0N0UGH	104	21	
_	JOH	NSON ST & GRANT ST	CONTRACT NO. 89809			
		ILLINOIS PROJE	CT NO. 11SC(152)			

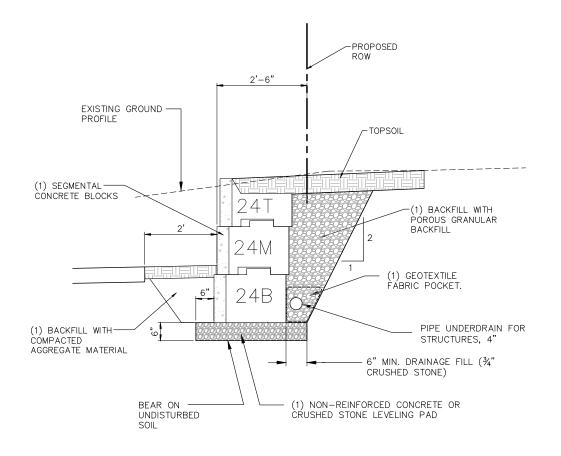

#### NOTE:

(1) ITEMS WILL NOT BE MEASURED FOR PAYMENT SEPARATELY BUT SHALL BE INCLUDED IN THE CONTRACT PRICE PER SQUARE FOOT FOR SEGMENTAL CONCRETE BLOCK RETAINING WALL.

## **TYPICAL WALL SECTION**

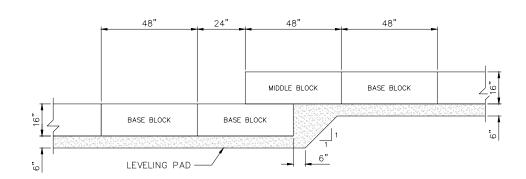

**BASE PAD STEP DETAIL** 

# MIDDLE/BASE

SCALE:

RIGHT CORNER HALF

TOP BLOCK

(24")

# 4'-0"

#### LEFT CORNER TOP **BLOCK**


# **TYPICAL BLOCK DETAIL**




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	DRAWN — TAB	REVISED - ·	STATE OF ILLINOIS
PLOT SCALE=	CHECKED — LRR	REVISED — ·	DEPARTMENT OF TRANSPORTATION
PLOT DATE = 09-06-2023	DATE - 01/11/2023	REVISED — ·	

	RET	ΆΙ	NI	N	G V	VALL	DETAILS
J	JOHNSON STREET RECONSTRUCTION						
	SHEET	NΩ	22	ΛE	104	CHEETS	


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6926	19-00155	-00-PV		McD0N0UGH	104	22
JOH	NSON ST & GF	RANT ST	CONTRACT NO. 89809			
		ILLINOIS	PROJE	CT NO. 11SC(152)		

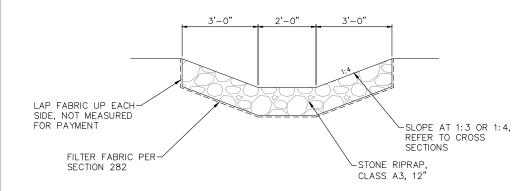


## AGGREGATE DITCH DETAIL

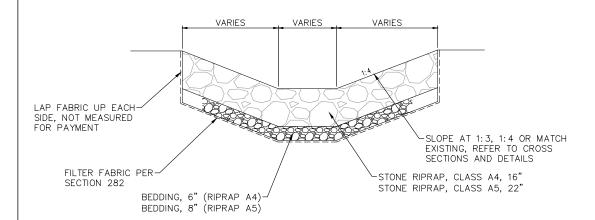

# STONE RIPRAP CLASS A4 OR A5 DETAIL

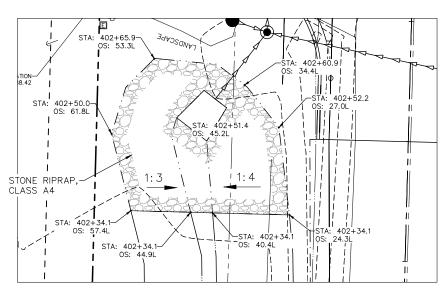


LT. STA. 402+51.4

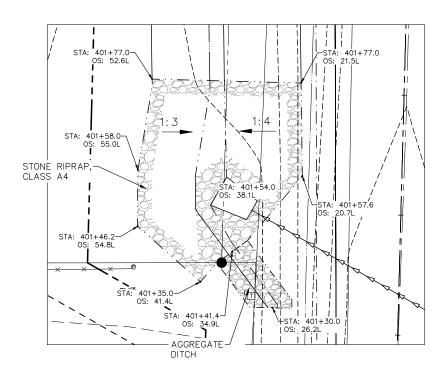


LT. STA. 401+54

# RIPRAP NOTES: 1. STONE RIPRAP SHALL BE CONSTRUCTED IN ACCORDANCE WITH SECTION 281 AND FILTER FABRIC IN ACCORDANCE WITH SECTION 282 OF THE STANDARD ROADWAY SPECS.


2. THE LIMITS OF RIPRAP SHOWN ON PLAN MAY BE VARIED IN THE FIELD WITH THE APPROVAL OF THE ENGINEER TO FIT NEW AND EXISTING CONDITIONS.

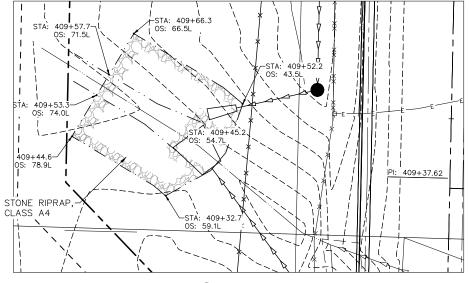

LT. STA. 409+45.2

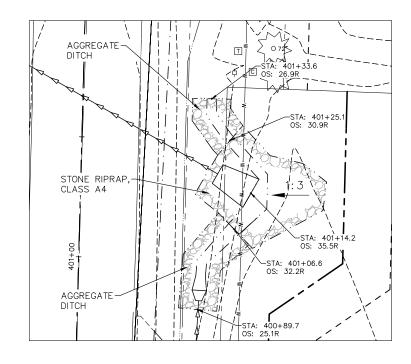

RT. STA. 401+06.6

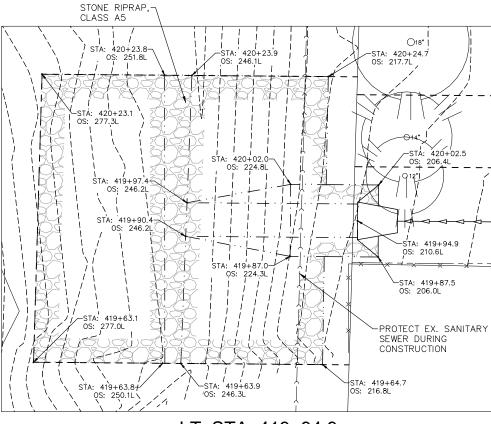

LT. STA. 419+94.9


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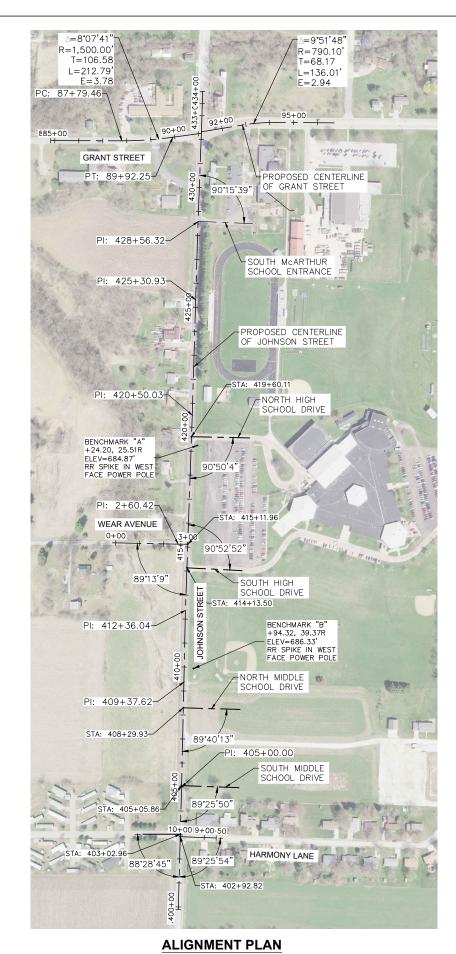
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PLOT DATE = 09-06-2023	DATE - 01/11/2023	REVISED — ·


STATE OF ILLINOIS
DEPARTMENT OF TRANSPORTATION

J	OHN			TR	EET	DET	AILS NSTRUCTION
	SHEET	NO.	23	OF	104	SHEETS	

F.A.U. RTE.	SECTION	COUNTY	TOTAL SHEETS	SHEET NO.
6926	19-00155-00-PV	McDONOUGH	104	23
JOH	INSON ST & GRANT ST	CONTRACT NO. 89809		
	THE PROJECT	CT NO 115C(152)		



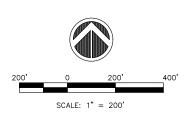

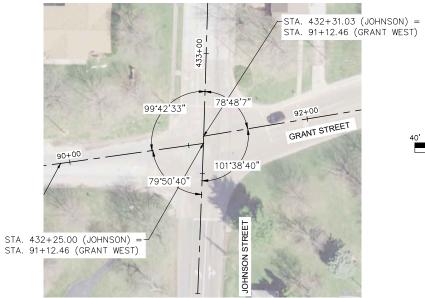

#### **JOHNSON - GRANT INTERSECTION ENLARGEMENT**


Alignment Name: 19000882-GRANT ST-WEST										
	Station Range: Start: 84+82.75, End: 91+12.46									
PI Station Northing Easting Distance Direction										
84+82.75	1,377,377.0348	2,154,269.4050'								
			403.28'	S 89°50'49.72" E						
88+86.03	1,377,375.9589	2,154,672.6847								
			226.78	N 82°01'29.10" E						
91+12.46	1,377,407.4242	2,154,897.2756								


Alignment Name: 19000882-GRANT-ST-EAST									
Station Range: Start: 91+12.46, End: 96+68.71									
PI Station	Northing	Easting	Distance	Direction					
91+12.46	1,377,413.4530	2,154,897.4584							
			241.46	N 80°32'09.70" E					
93+53.92	1,377,453.1561	2,155,135.6341'							
			315.13'	S 89°36'02.51" E					
96+68.71	1,377,450.9599	2,155,450.7524							

Alignment Name: 19000882-JOHNSON NORTH								
Station Range: Start: 432+25.00, End: 434+00.00								
PI Station	Northing	Easting	Distance	Direction				
432+25.00	1,377,407.4242	2,154,897.2756						
			175.00'	N 1°44'02.49" E				
434+00.00	1,377,582.3394	2,154,902.5710						


Alignment Name: JOHNSON SOUTH Station Range: Start: 399+89.09, End: 432+25.00							
PI Station	Northing	Easting	Distance	Direction			
399+89.09	1,374,172.9920	2,154,801.1235					
			510.91'	N 1°31'37.22" E			
405+00.00	1,374,683.7206	2,154,814.7383					
			437.62"	N 1°15'54.54" E			
409+37.62	1,375,121.2300	2,154,824.4005					
			298.43'	N 1°14'09.05" E			
412+36.04	1,375,419.5890	2,154,830.8370"					
			813.99	N 2°00'04.84" E			
420+50.03	1,376,233.0796	2,154,859.2638					
			480.90"	N 1°41'34.71" E			
425+30.93	1,376,713.7715	2,154,873.4715'					
			325.38"	N 1°43'19.09" E			
428+56.32	1,377,039.0094	2,154,883.2491					
			368.68'	N 2°10'49.25" E			
432+25.00	1,377,407.4242	2,154,897.2756					

Alignment Name: WEAR AVENUE								
Station Range: Start: -0+13.68, End: 3+00.00								
PI Station	PI Station Northing Easting Distance Direction							
13.68	1,375,701.3300							
			274.10'	S 88°46'46.04" E				
2+60.42	1,375,695.4914	2,154,800.8961'						
			39.58'	S 89°46'54.45" E				
3+00.00	1,375,695.3407	2,154,840.4729						
	Alignment Na	me: HARMO	NLY LAN	E				
	Station Range:	Start: 8+50.00, End	10+00.00					
PI Station	Northing	Easting	Distance	Direction				
8+50.00	1,374,471.1328'	2,154,959.1171'						
			150.00'	N 87°54'16.45" W				
10+00.00	1,374,476.6174'	2,154,809.2174'						

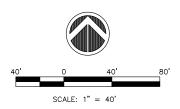

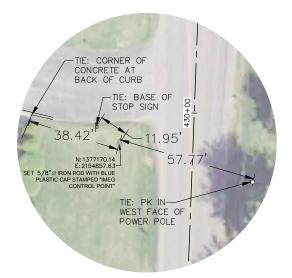

**CONTROL POINT #1** (NOT TO SCALE) STA: 429+86.38, 30.59L

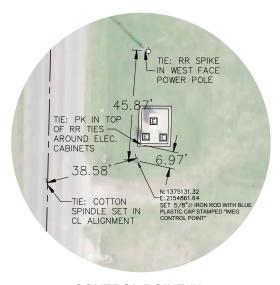

**CONTROL POINT #2** (NOT TO SCALE) STA: 409+48.51, 37.01R





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PH: 309.033.4594 www.imegcorp.com	PLOT SCALE =	CHECKED — LRR	REVISED — ·
Registration #184.037537-0014 323 ALL RIGHTS RESERVED	PLOT DATE = 09-06-2023	DATE - 01/11/2023	REVISED - ·


STATE OF ILLINOIS **DEPARTMENT OF TRANSPORTATION** 


HORIZONTAL & VERTICAL CONTROL JOHNSON STREET RECONSTRUCTION							
SCALE:	SHEET NO.	24 OF	104 SHEETS				

F.A.U. RTE.	SEC.	TION		COUNTY	TOTAL SHEETS	SHEET NO.
6926	19-00155	-00-PV		McD0N0UGH	104	24
JOH	NSON ST & GF	RANT ST	CONTRACT NO	D. 89809		
		ILLINOIS	PROJE	CT NO. 11SC(152)		

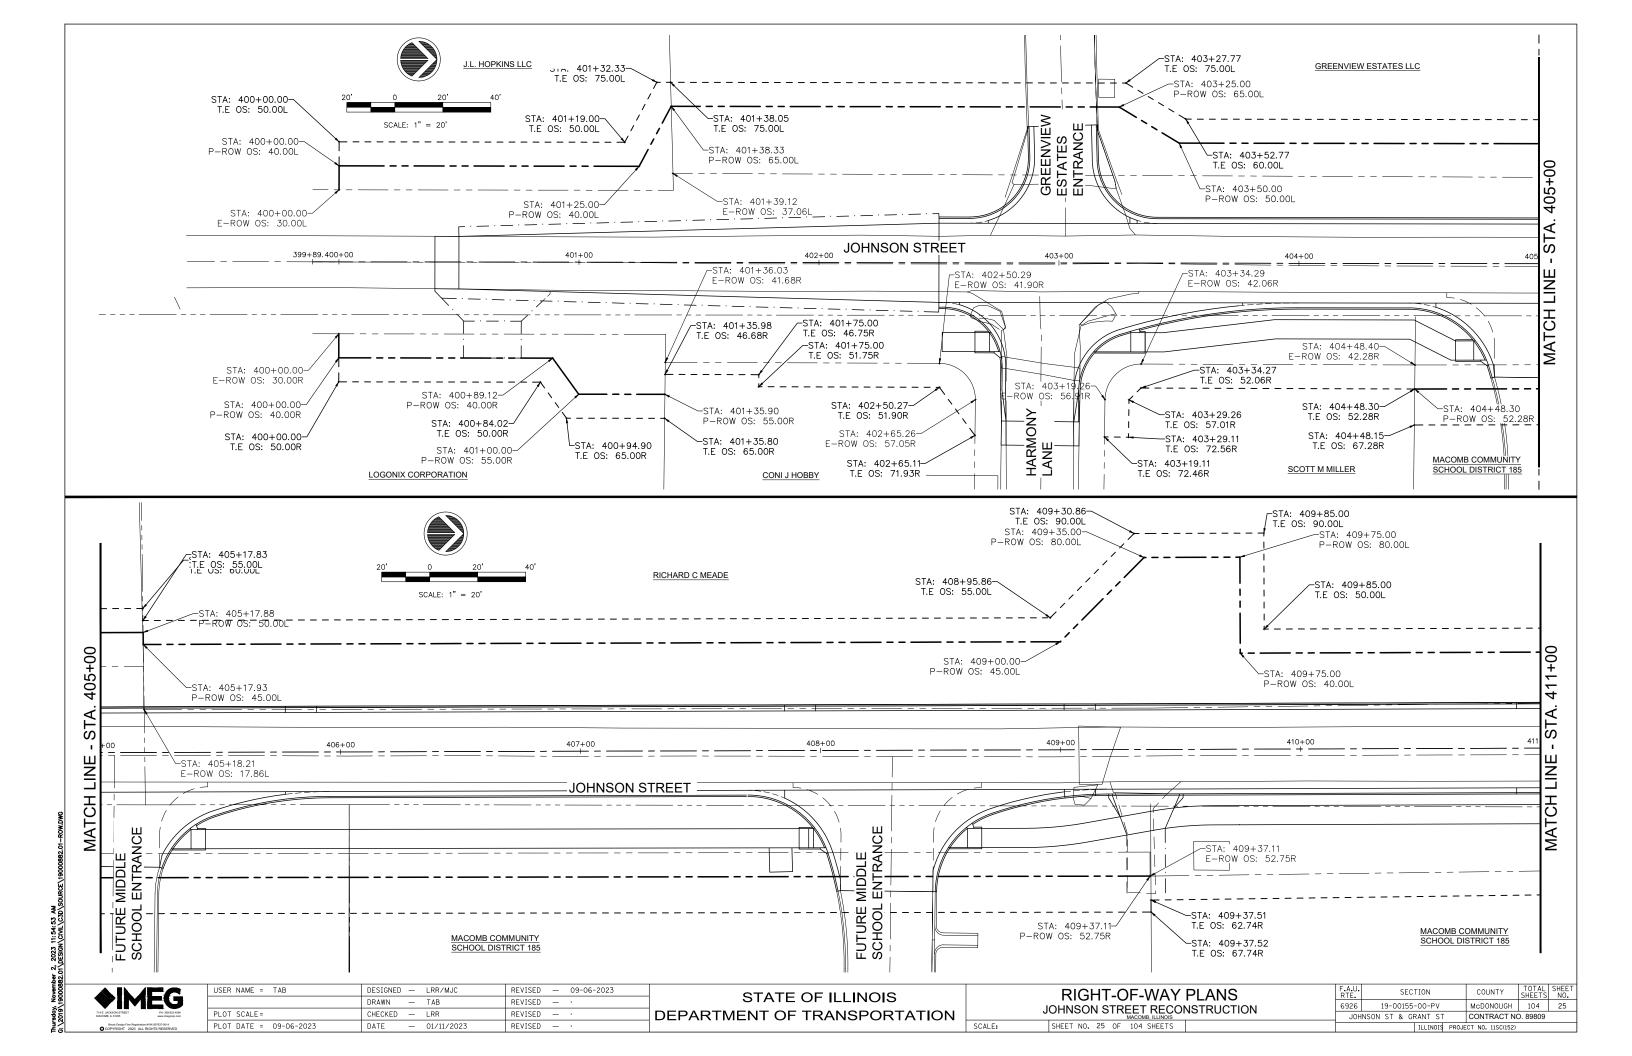

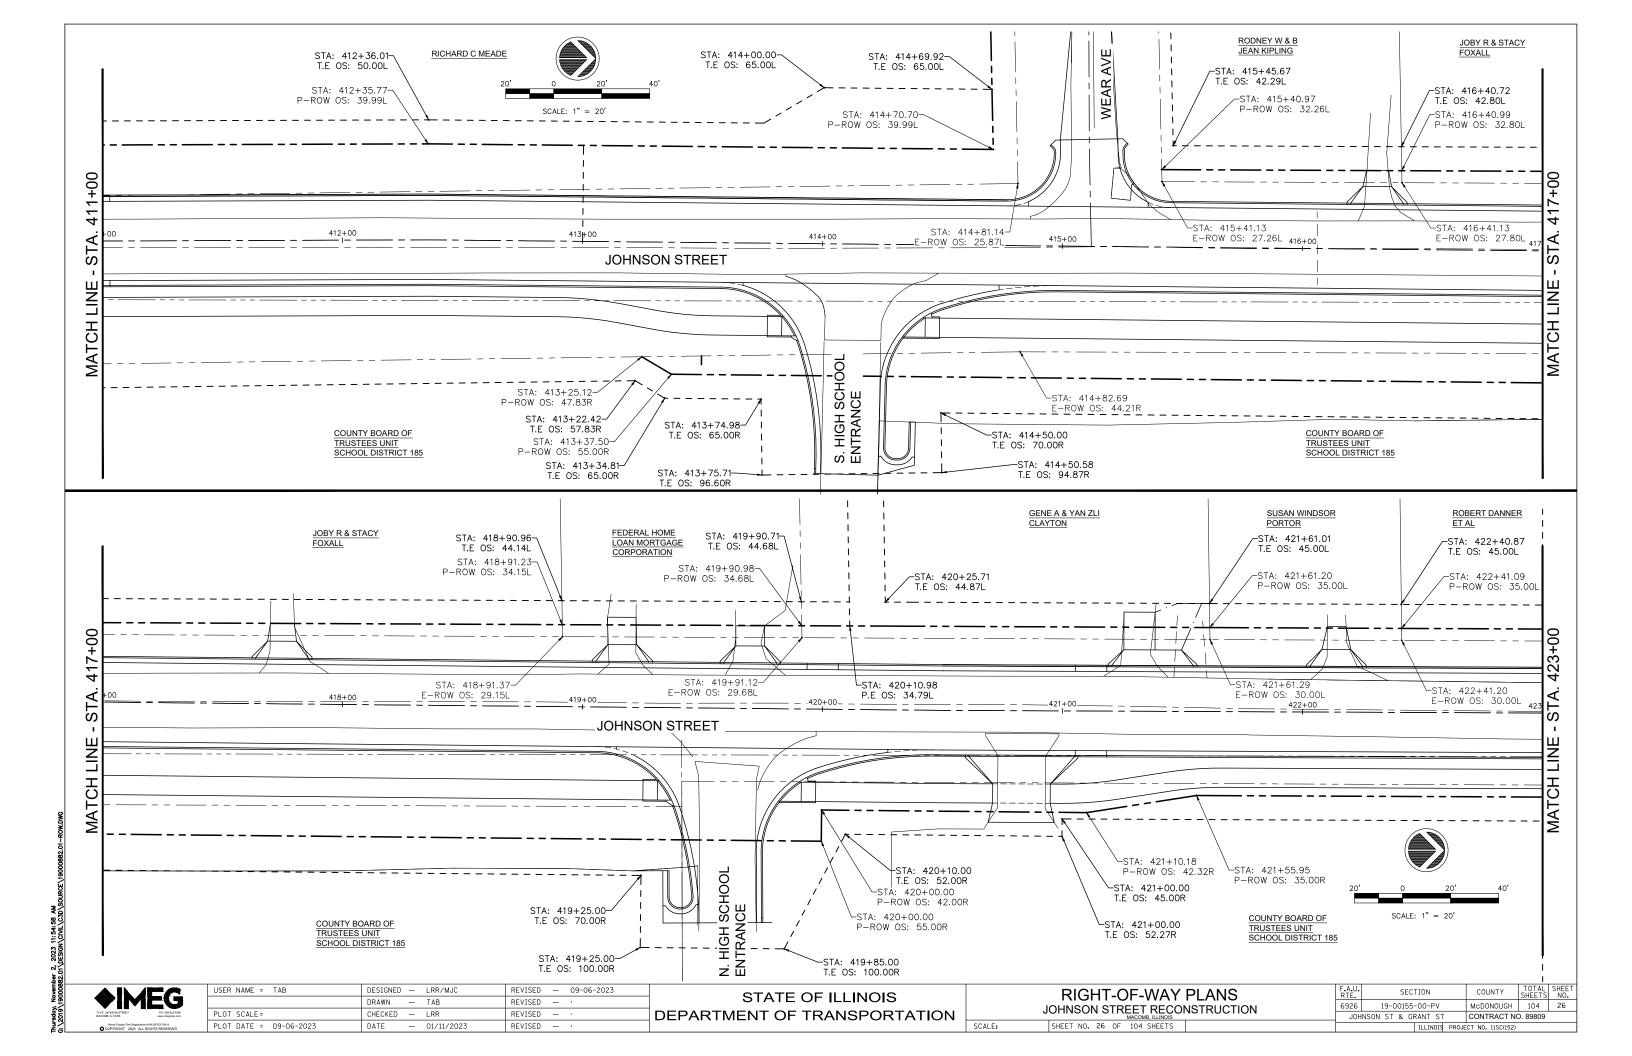

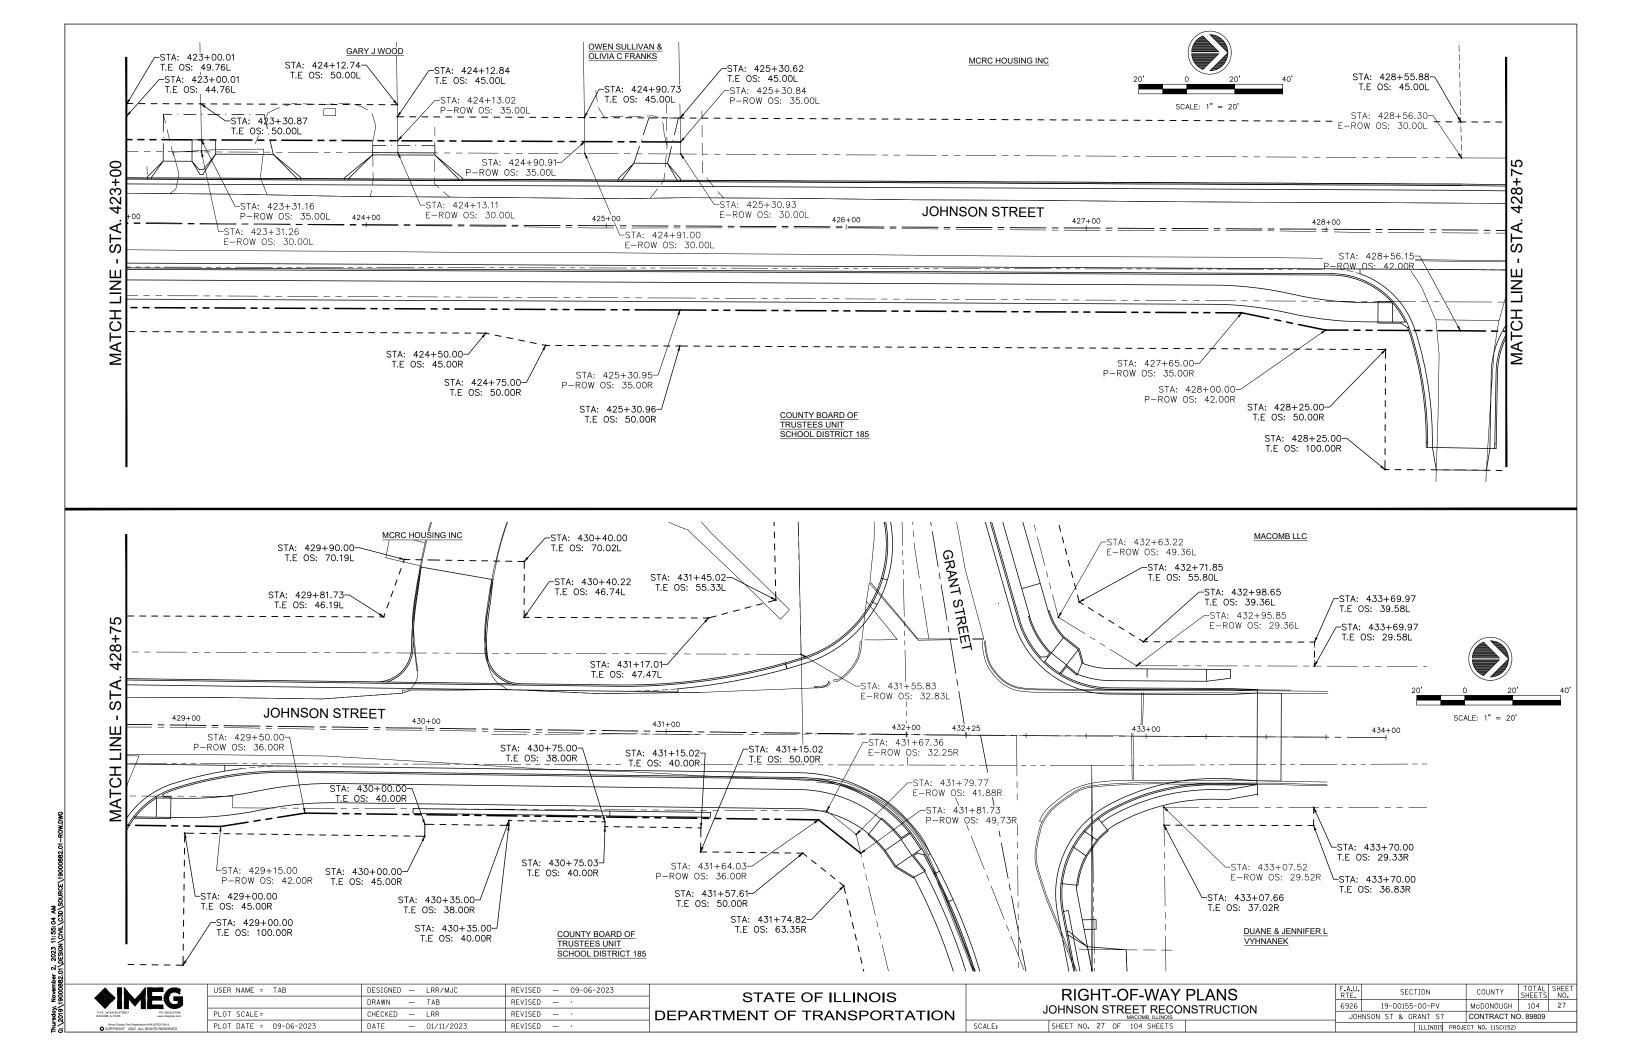

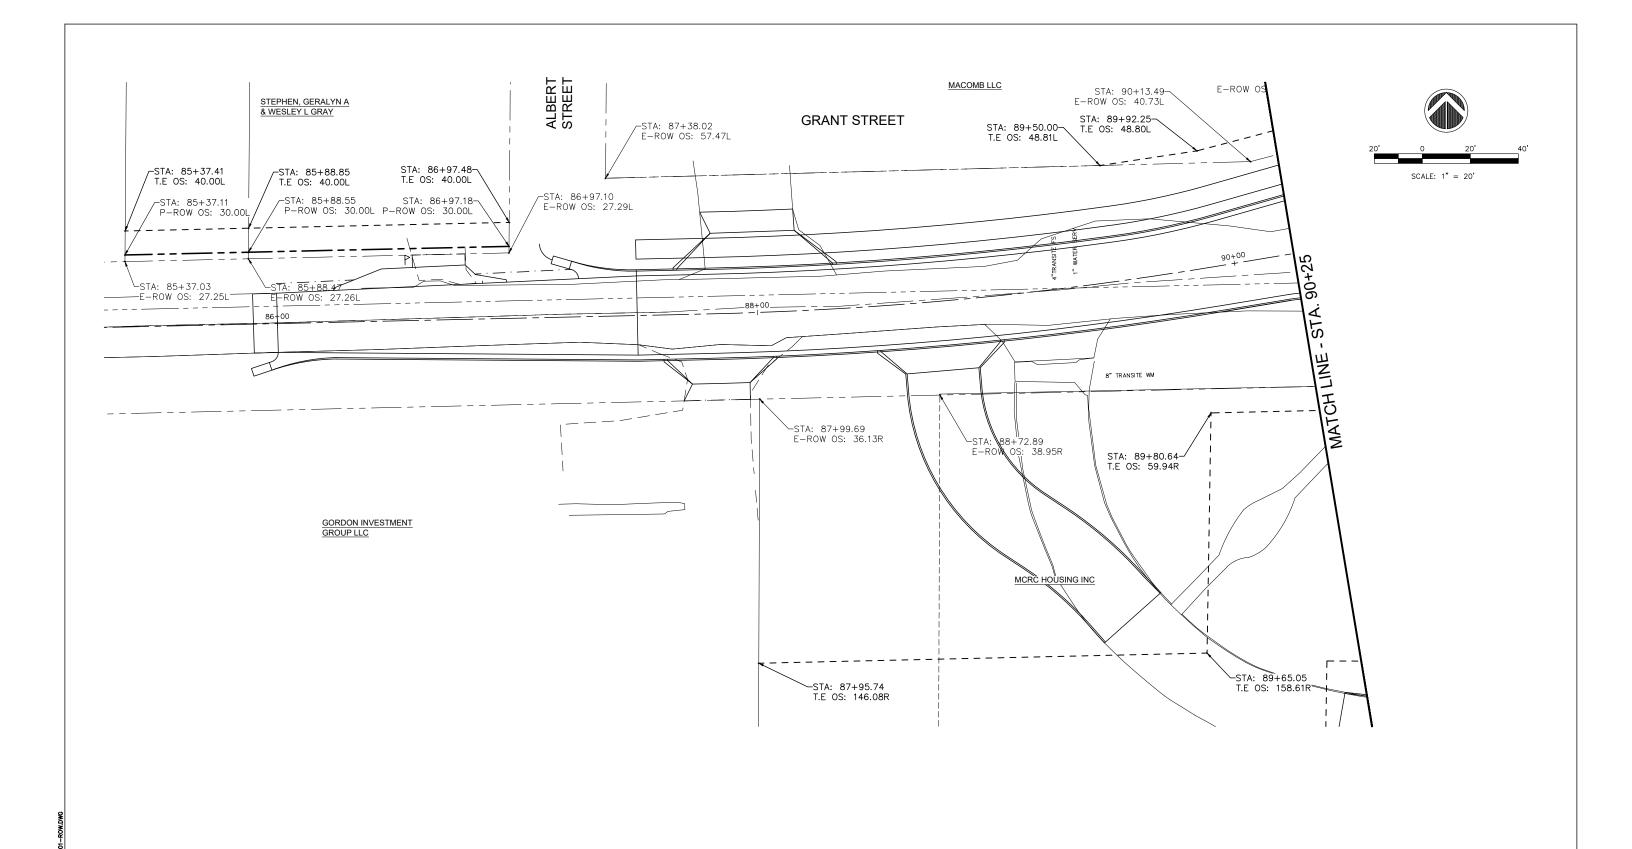


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714 E. JACKSON STREET	PH: 309.833.4594
MACOMB, IL 61455	www.imegcorp.com


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RIGHT-OF-WAY PLANS								
JOHNSON STREET RECONSTRUCTION								
	SHEET NO	28	ΟF	104	SHEETS			

SCALE:

F.A.U. RTE.	SECTION		COUNTY	TOTAL SHEETS	SHEET NO.
6926	19-00155-00-PV	/	McDONOUGH	104	28
JOH	INSON ST & GRANT S	ST	CONTRACT NO. 89809		
	ILLIN0	IS PROJE	CT NO. 11SC(152)		



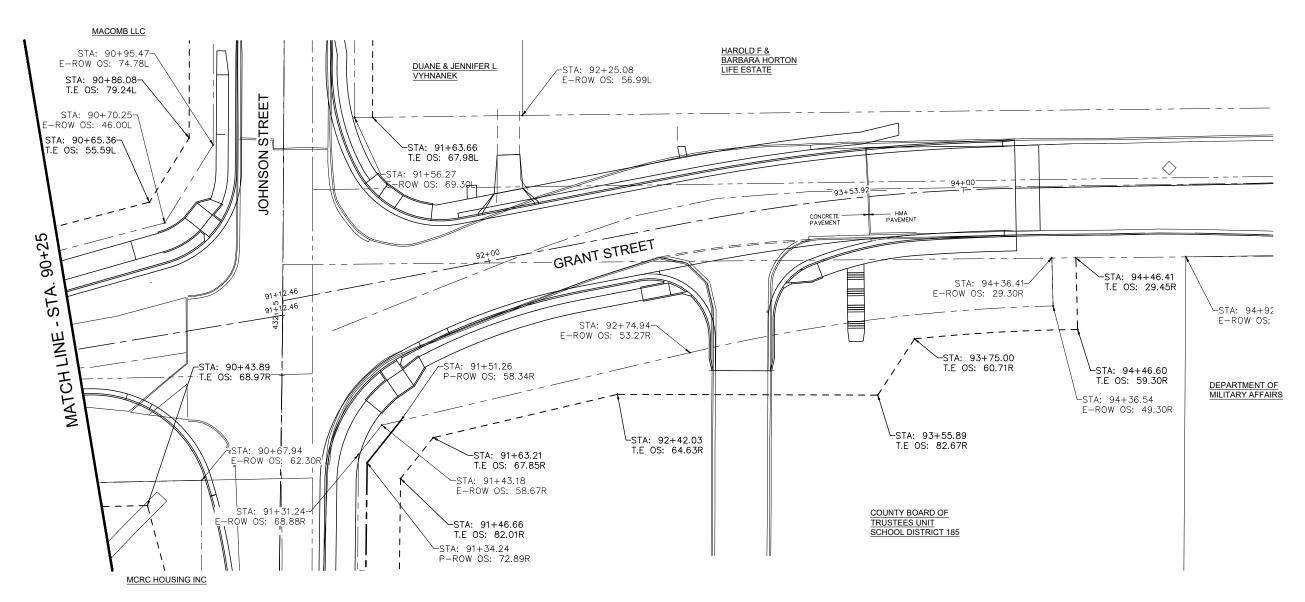


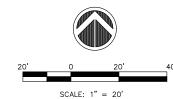
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714 E. JACKSON STREET	PH: 309.833.4594
MACIOMB, IL 61455	www.imegcorp.com
	intration #184.037637-0014 ALL RIGHTS RESERVED

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.E <b>:</b>	SHEET NO.	29	OF	104	SHEETS	

F.A.U RTE.	SECTION	COUNTY	SHEETS	NO.
6926	19-00155-00-PV	McD0N0UGH	104	29
JO	HNSON ST & GRANT ST	CONTRACT NO	D. 89809	
	ILLINOIS	PROJECT NO. 11SC(152)		



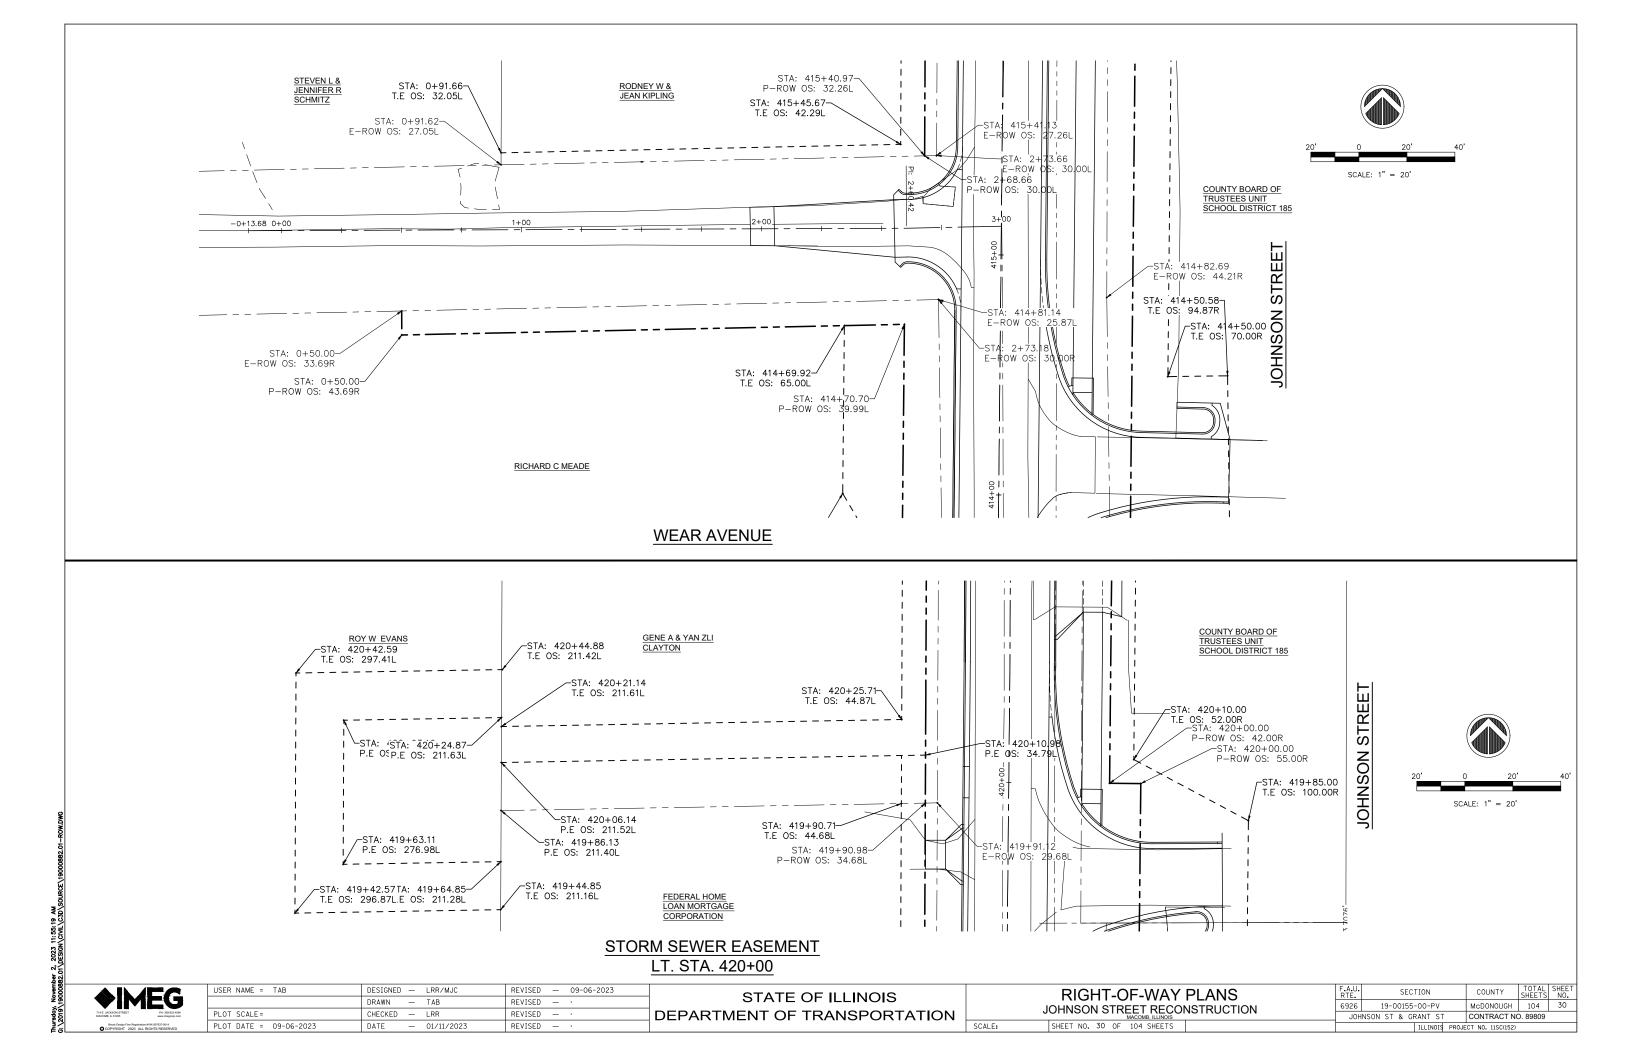

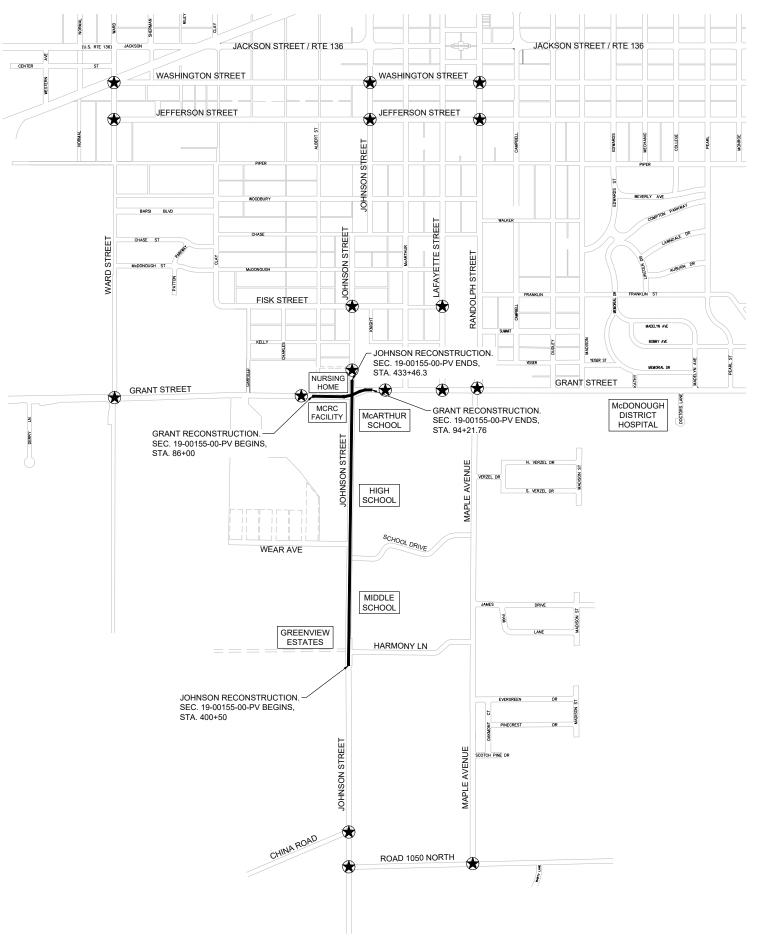

#### STREET MAP NOT TO SCALE

INTERSECTIONS CALLED OUT FOR SIGNAGE ON THE FOLLOWING STAGING PLAN SHEETS

#### STAGING:

- 1. Storm Sewe
- 2. 400+50 to 431+52.70 Northbound Lane
- 3. 400+50 to 431+52.70 Southbound Lane
- 4. 431+52.70 to North Limits Johnson AND-88+00 to East Limits Grant
- 5. Grant 86+00 to 88+00

#### DETOUR SIGNAGE:

- ERECT SIGNAGE AS LAID OUT IN THE FOLLOWING PLAN SHEETS.
- WHEN COMPLETING ONE STAGE AND PREPARING TO MOVE THE CLOSED SECTION OF JOHNSON STREET (OR GRANT STREET) TO THE NEXT STAGE CONTRACTOR SHALL NOTIFY THE CITY OF MACOMB A MINIMUM OF 48 HOURS IN ADVANCE SO THAT PUBLIC INFORMATION NOTICES CAN BE ISSUED.
- 3. NOT ALL SIGNAGE REQUIRED IS SHOWN ON THESE PLANS.

#### TRAFFIC CONTROL AND PROTECTION:

- REFER TO IDOT TRAFFIC CONTROL STANDARDS: 701001-02, 701301-04, 701501-06, 701901-09, BLR 21-9, BLR 22-7.
- ERECT SIGNAGE AS PER THE MUTCD INCLUDING, BUT NOT LIMITED TO "ROAD WORK AHEAD", "ROAD CLOSED AHEAD", "ROAD CLOSED 500 FT", ETC.
- 3. NOT ALL SIGNAGE REQUIRED IS SHOWN ON THESE PLANS. IT IS THE RESPONSIBILITY OF THE CONTRACTOR TO ENSURE THAT SIGNAGE IS PROPERLY INSTALLED.

#### NOTE:

THE CONTRACTOR MAY ELECT TO PROVIDE A SEPARATE TRAFFIC CONTROL / STAGING PLAN TO THE CITY / ENGINEER IN WRITING.

THIS PLAN WILL NEED TO BE APPROVED BY THE CITY, THE ENGINEER, AND THE SCHOOL DISTRICT PRIOR TO THE START OF CONSTRUCTION.

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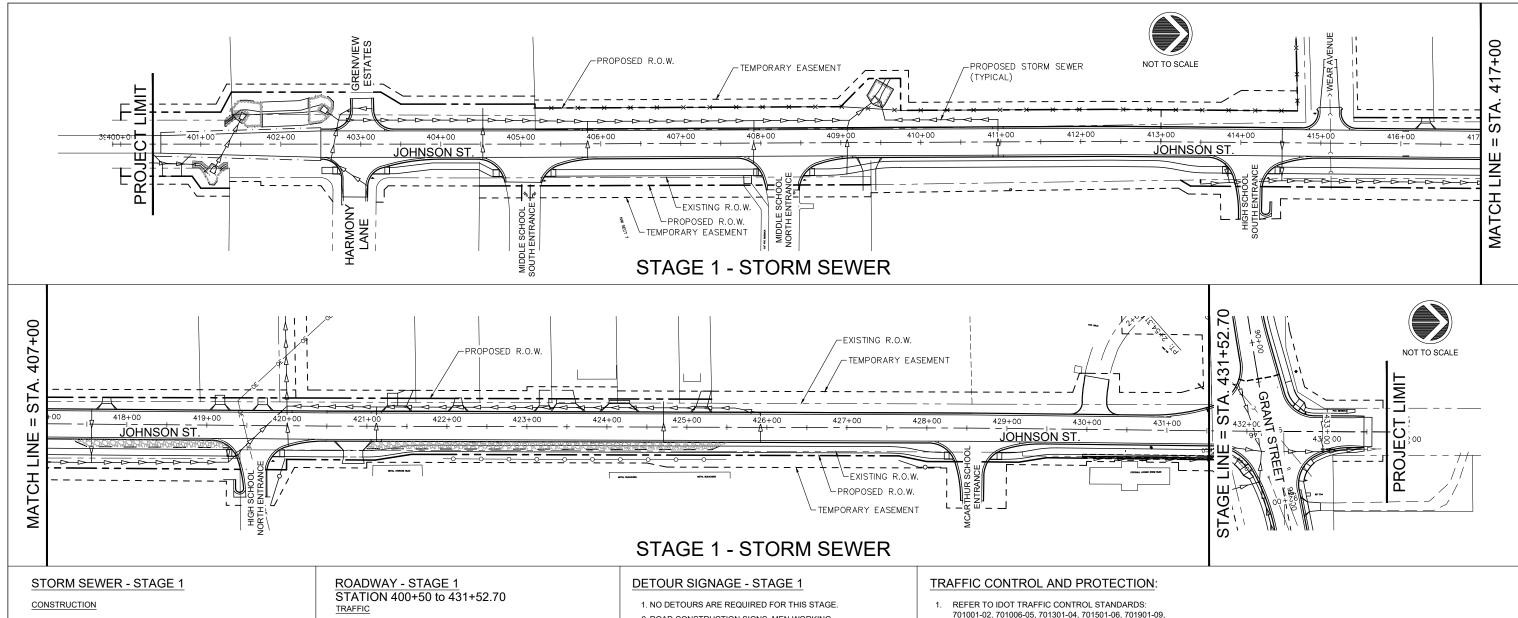
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 DATE — 01/11/2023
 REVISED — •

STATE OF ILLINOIS
DEPARTMENT OF TRANSPORTATION

STAGING PLAN - STREET MAP
JOHNSON STREET RECONSTRUCTION
MACOMB.ILLINOIS
SHEET NO. 31 OF 104 SHEETS

F.A.U. SECTION COUNTY TOTAL SHEE NO. 6926 19-00155-00-PV McDONOUGH 104 31

JOHNSON ST & GRANT ST CONTRACT NO. 89809



- CONSTRUCT ALL MAINLINE STORM SEWER WITH THE EXCEPTION OF THE STORM SEWER IN THE GRANT / JOHNSON INTERSECTION. GRANT / JOHNSON STORM SEWER SHALL BE CONSTRUCTED DURING THE SAME STAGE THAT THE INTERSECTION PAVEMENT IS CONSTRUCTED.
- 2. CONSTRUCT ALL CROSS ROAD STORM SEWER DURING THIS STAGE.
- 3. COORDINATE UTILITY ADJUSTMENTS BY OTHERS.

#### TRAFFIC

- CONSTRUCT UNDERGROUND UTILITIES WHILE KEEPING THE ROAD OPEN AS MUCH AS POSSIBLE. COMPLETE ROAD CLOSURES WILL NOT BE ALLOWED AT THIS TIME. A MINIMUM OF 1-LANE, 2-WAY TRAFFIC SHALL BE MAINTAINED DURING WORKING HOURS. FLAGGERS SHALL BE USED AS NEEDED DURING CONSTRUCTION OPERATIONS. OUTSIDE OF WORKING HOURS, 2-LANE, 2-WAY TRAFFIC SHALL BE
- MINIMIZE CLOSURE OF DRIVEWAYS. DRIVEWAYS SHALL BE CLOSED ONLY DURING CONSTRUCTION OF STORM SEWER THROUGH ADJACENT PAVEMENT. NO DRIVEWAYS SHALL REMAIN CLOSED AFTER WORKING HOURS.
- 3. THE ENTRANCE TO GREENVIEW ESTATES SHALL MAINTAIN 1-LANE OF TRAFFIC AT ALL TIMES. THE ENTRANCE OFF OF JOHNSON STREET IS THE ONLY ACCESS TO THIS AREA.
- WEAR AVENUE SHALL MAINTAIN 1-LANE OF TRAFFIC AT ALL TIMES. THE INTERSECTION OF WEAR AVE. / JOHNSON ST. IS THE ONLY ACCESS TO THIS AREA.

- NORTH-SOUTH TRAFFIC ON JOHNSON STREET SHALL BE MAINTAINED DURING THIS STAGE.
- 2. USE FLAGGERS AS NECESSARY AS NEEDED
- 2. ROAD CONSTRUCTION SIGNS, MEN WORKING, FLAGGERS, ETC. SIGNS SHALL BE ERECTED AS REQUIRED BY THE MUCTD
- 701001-02, 701006-05, 701301-04, 701501-06, 701901-09, BLR 21-9, BLR 22-7.
- 2. ERECT SIGNAGE AS PER THE MUTCD INCLUDING, BUT NOT LIMITED TO "ROAD WORK AHEAD", "ROAD CLOSED AHEAD", "ROAD CLOSED 500 FT", ETC.
- NOT ALL SIGNAGE REQUIRED IS SHOWN ON THESE PLANS. IT IS THE RESPONSIBILITY OF THE CONTRACTOR TO ENSURE THAT SIGNAGE IS PROPERLY INSTALLED.


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STATE OF ILLINOIS **DEPARTMENT OF TRANSPORTATION** 

	STAGING PLAN - STAGE 1						
JOHNSON STREET RECONSTRUCTION							
	SHEET	NΟ	32	ΛE	104	CHEETS	

F.A.U. RTE.	SECTION	COUNTY	TOTAL SHEETS	SHEET NO.	
6926	19-00155-00-P\	McD0N0UGH	104	32	
JOH	NSON ST & GRANT S	CONTRACT NO	D. 89809		
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#### ROADWAY - STAGE 2 STATION 400+50 to 431+52.70

#### CONSTRUCTION

- STORM SEWERS WILL HAVE BEEN CONSTRUCTED DURING STAGE 1.
- 2. REMOVE PAVEMENT, CURB AND GUTTERS, ENTRANCES TO HARMONY LANE, THE MIDDLE SCHOOL, THE HIGH SCHOOL, AND MCARTHUR SCHOOL.
- 3. PERFORM EARTHWORK.
- 4. CONSTRUCT CURB AND GUTTER AND PAVEMENT.
- 5. CONSTRUCT ENTRANCES TO HARMONY LANE, THE MIDDLE SCHOOL, THE HIGH SCHOOL, AND MCARTHUR SCHOOL...
- 6. SHARED USE PATH AND ASSOCIATED ITEMS MAY BE CONSTRUCTED NOW OR IN LATER STAGES.
- ROADWAY CONSTRUCTION SHALL BE GIVEN PRIORITY OVER SHARED USE PATH CONSTRUCTION.
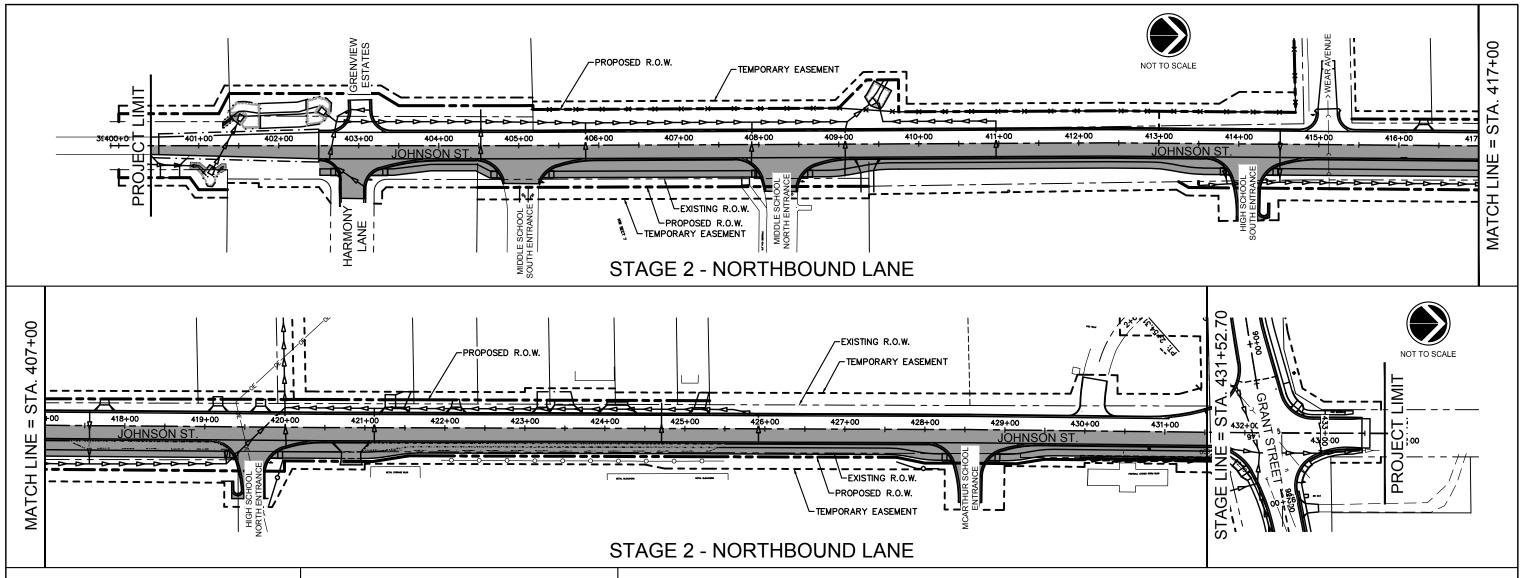
#### ROADWAY - STAGE 2 STATION 400+50 to 431+52.70

#### TRAFFI

- 1. 1-LANE, 1-WAY TRAFFIC ON JOHNSON STREET SHALL BE MAINTAINED DURING STAGE 2 AND STAGE 3.
- 2. TRAFFIC SHALL BE NORTHBOUND ONLY AND SHALL TRAVEL UPON THE EXISTING SOUTHBOUND LANE.
- ACCESS TO THE HOUSES ON THE WEST SIDE OF JOHNSON STREET WILL BE FROM THE SOUTH ON JOHNSON.
- 4. ACCESS TO WEAR AVENUE WILL BE FROM THE SOUTH ON JOHNSON.
- ACCESS TO GREENVIEW ESTATES WILL BE FROM THE SOUTH ON JOHNSON.
- 6. ACCESS TO HARMONY LANE WILL BE FROM MAPLE AVENUE.
- ACCESS TO THE MIDDLE SCHOOL AND HIGH SCHOOL WILL BE FROM MAPLE AVENUE.
- 8. ACCESS TO MCARTHUR SCHOOL WILL BE FROM GRANT STREET. THE ENTRANCE OFF GRANT STREET WILL NEED TO BE TEMPORARILY SIGNED AS TWO-WAY TRAFFIC DURING THIS STAGE SINCE THE ENTRANCE TO JOHNSON STREET WILL BE CONSTRUCTED DURING THIS STAGE.
- COORDINATE WITH THE SCHOOL DISTRICT FOR STAGE 2 AND STAGE 3 TRAFFIC PATTERNS.
- 10. USE FLAGGERS AS NECESSARY AS NEEDED

#### DETOUR SIGNAGE - STAGE 2

#### IINA ROAD / JOHNSON STREET (EAST BOUND)

"JOHNSON STREET NORTHBOUND TRAFFIC ONLY HARMONY TO GRANT"
 "MCARTHUR SCHOOL, HIGH SCHOOL, MIDDLE SCHOOL" (RIGHT TURN ARROW)

#### ROAD 1050 NORTH / JOHNSON STREET (NORTH BOUND)

- 1. "JOHNSON STREET NORTHBOUND TRAFFIC ONLY HARMONY TO GRANT"
- 2. "MCARTHUR SCHOOL, HIGH SCHOOL, MIDDLE SCHOOL" (RIGHT TURN ARROW)

#### ROAD 1050 NORTH / JOHNSON STREET (SOUTH BOUND)

1. "MCARTHUR SCHOOL, HIGH SCHOOL, MIDDLE SCHOOL" (LEFT TURN ARROW)

#### ROAD 1050 NORTH / MAPLE AVENUE (EAST BOUND

1. "MCARTHUR SCHOOL, HIGH SCHOOL, MIDDLE SCHOOL" (LEFT TURN ARROW)

#### ROAD 1050 NORTH / MAPLE AVENUE (WEST BOUND)

- 1. "JOHNSON STREET NORTHBOUND TRAFFIC ONLY HARMONY TO GRANT"
- 2. "MCARTHUR SCHOOL, HIGH SCHOOL, MIDDLE SCHOOL" (RIGHT TURN ARROW)

#### ROAD 1050 NORTH / MAPLE AVENUE (SOUTH BOUND)

- 1. "JOHNSON STREET NORTHBOUND TRAFFIC ONLY HARMONY TO GRANT"
- 2. "SOUTH JOHNSON STREET" (RIGHT TURN ARROW)

#### GRANT STREET / MAPLE AVENUE (EAST BOUND)

- 1. "SOUTH JOHNSON STREET" (RIGHT TURN ARROW)
- 2. "MCARTHUR SCHOOL, HIGH SCHOOL, MIDDLE SCHOOL" (RIGHT TURN ARROW)

#### GRANT STREET / MAPLE AVENUE (WEST BOUND)

- 1. "JOHNSON STREET NORTHBOUND TRAFFIC ONLY HARMONY TO GRANT"
- 2. "SOUTH JOHNSON STREET" (LEFT TURN ARROW)
- 3. "MCARTHUR SCHOOL, HIGH SCHOOL, MIDDLE SCHOOL" (LEFT TURN ARROW)

  3. "MCARTHUR SCHOOL, HIGH SCHOOL, MIDDLE SCHOOL" (LEFT TURN ARROW)

  3. "MCARTHUR SCHOOL, HIGH SCHOOL, MIDDLE SCHOOL" (LEFT TURN ARROW)

  3. "MCARTHUR SCHOOL, HIGH SCHOOL, MIDDLE SCHOOL" (LEFT TURN ARROW)

  3. "MCARTHUR SCHOOL, HIGH SCHOOL, MIDDLE SCHOOL" (LEFT TURN ARROW)

  3. "MCARTHUR SCHOOL, HIGH SCHOOL, MIDDLE SCHOOL" (LEFT TURN ARROW)

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  3. "MCARTHUR SCHOOL, HIGH SCHOOL, MIDDLE SCHOOL" (LEFT TURN ARROW)

  3. "MCARTHUR SCHOOL, HIGH SCHOOL, MIDDLE SCHOOL" (LEFT TURN ARROW)

  3. "MCARTHUR SCHOOL, MIDDLE SCHOOL" (LEFT TURN ARROW)

  3. "MCARTHUR SCHOOL, MIDDLE SCHOOL" (LEFT TURN ARROW)

  4. "MCARTHUR SCHOOL (LEFT TURN ARROW)

  5. "MCARTHUR SCHOOL (LEFT TURN ARROW)

  5. "MCARTHUR SCHOOL (LEFT TURN ARROW)

  5. "MCARTHUR SCHOOL (LEFT TURN ARROW)

  6. "MCARTHU

#### GRANT STREET / RANDOLPH STREET (SOUTHBOUND)

- 1. "JOHNSON STREET NORTHBOUND TRAFFIC ONLY HARMONY TO GRANT"
- 2. "SOUTH JOHNSON STREET" (AHEAD ARROW)
- 3. "MCARTHUR SCHOOL, HIGH SCHOOL, MIDDLE SCHOOL" (AHEAD ARROW)

#### GRANT STREET / JOHNSON (WESTBOUND)

- 1. "JOHNSON STREET NORTHBOUND TRAFFIC ONLY HARMONY TO GRANT"
- 2. "MCARTHUR SCHOOL, HIGH SCHOOL, MIDDLE SCHOOL USE MAPLE AVENUE"

#### GRANT STREET / JOHNSON (SOUTHBOUND)

- "JOHNSON STREET NORTHBOUND TRAFFIC ONLY HARMONY TO GRANT"
- 2. "MCARTHUR SCHOOL, HIGH SCHOOL, MIDDLE SCHOOL USE MAPLE AVENUE"

#### GRANT STREET / JOHNSON (SOUTHBOUND) SOUTH SIDE OF INTERSECTION

1. "DO NOT ENTER, ONE WAY TRAFFIC"

#### GRANT STREET / JOHNSON (EASTBOUND)

- 1. "JOHNSON STREET NORTHBOUND TRAFFIC ONLY HARMONY TO GRANT"
- "MCARTHUR SCHOOL, HIGH SCHOOL, MIDDLE SCHOOL USE MAPLE AVENUE"

# TRAFFIC CONTROL AND PROTECTION:

- REFER TO IDOT TRAFFIC CONTROL STANDARDS: 701001-02, 701006-05, 701301-04, 701501-06, 701901-09, BLR 21-9. BLR 22-7.
- 2. ERECT SIGNAGE AS PER THE MUTCD INCLUDING, BUT NOT LIMITED TO "ROAD WORK AHEAD", "ROAD CLOSED 500 FT", ETC.
- . NOT ALL SIGNAGE REQUIRED IS SHOWN ON THESE PLANS. IT IS THE RESPONSIBILITY OF THE CONTRACTOR TO ENSURE THAT SIGNAGE IS PROPERLY INSTALLED


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#### **ROADWAY - STAGE 3** STATION 400+50 to 431+52.70

- STORM SEWERS WILL HAVE BEEN CONSTRUCTED DURING STAGE 1
- 2. CONSTRUCT TEMPORARY AGGREGATE SURFACE FOR PARKING ALONG THE EAST SIDE OF JOHNSON STREET FOR THE USE OF THE HOUSES ON THE WEST SIDE OF JOHNSON AS SHOWN ON THE PLANS. (PAID FOR AS TEMPORARY AGGREGATE).
- THE CONTRACTOR SHALL STAGE WORK TO MAINTAIN 1 LANE OF TRAFFIC TO GREENVIEW ESTATES.
- THE CONTRACTOR SHALL STAGE WORK TO MAINTAIN 1 LANE OF ACCESS TO WEAR AVENUE.
- REMOVE PAVEMENT AND CURB AND GUTTERS.
- PERFORM EARTHWORK
- CONSTRUCT CURB AND GUTTER AND PAVEMENT.
- CONSTRUCT ENTRANCES TO GREENVIEW ESTATES AND WEAR AVENUE
- CONSTRUCT ENTRANCE TO THE MCRC PROPERTY AT STA. 430+00. MCRC WILL HAVE ACCESS FROM GRANT STREET.
- 10. CONCRETE DRIVEWAY PAVEMENTS TO THE HOUSES ON THE WEST SIDE OF JOHNSON MAY BE CONSTRUCTED NOW OR THE CONTRACTOR MAY ELECT TO LEAVE THE DRIVEWAYS AS AGGREGATE UNTIL THE FINAL CONCRETE ENTRANCES ARE CONSTRUCTED. IF THE CONTRACTOR ELECTS TO CONSTRUCT THE DRIVEWAYS IN A LATER STAGE THE TEMPORARY AGGREGATE FOR DRIVEWAYS WILL BE MEASURED AND PAID FOR AS TEMPORARY AGGREGATE.
- 11. ROADWAY CONSTRUCTION SHALL BE GIVEN PRIORITY OVER SHARED USE PATH CONSTRUCTION.

# STATION 400+50 to 431+52.70

- TRAFFIC

  1. 1-LANE, 1-WAY TRAFFIC ON JOHNSON STREET SHALL BE MAINTAINED DURING THIS STAGE.
- 2. TRAFFIC SHALL BE NORTHBOUND ONLY AND SHALL TRAVEL UPON THE NEWLY CONSTRUCTED NORTHBOUND
- ACCESS TO THE HOUSES ON THE WEST SIDE OF JOHNSON STREET WILL BE FROM THE SOUTH ON JOHNSON. TEMPORARY PARKING WILL BE PROVIDED ON THE EAST SIDE OF JOHNSON STREET.
- 4. ACCESS TO WEAR AVENUE WILL BE FROM THE SOUTH ON JOHNSON.
- ACCESS TO GREENVIEW ESTATES WILL BE FROM THE SOUTH ON JOHNSON.
- ACCESS TO HARMONY LANE WILL BE FROM JOHNSON FROM THE SOUTH, OR MAPLE AVENUE.
- ACCESS TO THE MIDDLE SCHOOL AND HIGH SCHOOL WILL BE FROM JOHNSON FROM THE SOUTH, OR MAPLE **AVENUE**
- ACCESS TO MCARTHUR SCHOOL WILL BE FROM GRANT STREET. THE ENTRANCE OFF GRANT STREET WILL NEED TO BE TEMPORARILY SIGNED AS TWO-WAY TRAFFIC DURING THIS STAGE SINCE THE ENTRANCE TO JOHNSON STREET WILL BE CONSTRUCTED DURING THIS STAGE.
- COORDINATE WITH THE SCHOOL DISTRICT FOR STAGE 3 TRAFFIC PATTERNS.
- 10. USE FLAGGERS AS NECESSARY AS NEEDED.
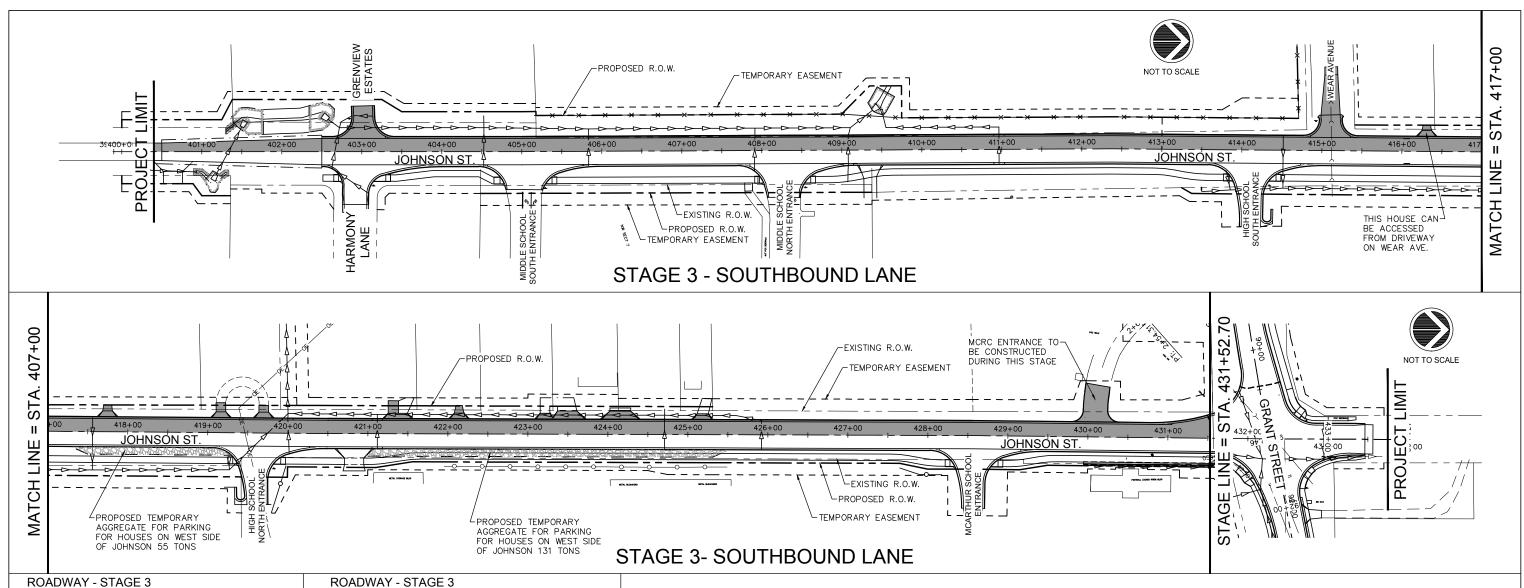
#### **DETOUR SIGNAGE - STAGE 3**

#### CHINA ROAD / JOHNSON STREET (EAST BOUND)

- 1. "JOHNSON STREET NORTHBOUND TRAFFIC ONLY HARMONY TO GRANT"
- 2. "MCARTHUR SCHOOL, HIGH SCHOOL, MIDDLE SCHOOL" (LEFT TURN ARROW)

#### ROAD 1050 NORTH / JOHNSON STREET (NORTH BOUND)

- "JOHNSON STREET NORTHBOUND TRAFFIC ONLY HARMONY TO GRANT"
- 2. "MCARTHUR SCHOOL, HIGH SCHOOL, MIDDLE SCHOOL" (AHEAD ARROW)

#### ROAD 1050 NORTH / MAPLE AVENUE (WEST BOUND)

1. "JOHNSON STREET NORTHBOUND TRAFFIC ONLY HARMONY TO GRANT"

#### ROAD 1050 NORTH / MAPLE AVENUE (SOUTH BOUND)

- "JOHNSON STREET NORTHBOUND TRAFFIC ONLY HARMONY TO GRANT"
- 2. "SOUTH JOHNSON STREET" (RIGHT TURN ARROW)

#### GRANT STREET / MAPLE AVENUE (EAST BOUND)

- "SOUTH JOHNSON STREET" (RIGHT TURN ARROW)
- 2. "MCARTHUR SCHOOL, HIGH SCHOOL, MIDDLE SCHOOL" (RIGHT TURN ARROW)

#### GRANT STREET / MAPLE AVENUE (WEST BOUND)

- "JOHNSON STREET NORTHBOUND TRAFFIC ONLY HARMONY TO GRANT"
- "SOUTH JOHNSON STREET" (LEFT TURN ARROW)
- "MCARTHUR SCHOOL, HIGH SCHOOL, MIDDLE SCHOOL" (LEFT TURN ARROW)

#### GRANT STREET / RANDOLPH STREET (SOUTHBOUND)

- "JOHNSON STREET NORTHBOUND TRAFFIC ONLY HARMONY TO GRANT"
- "SOUTH JOHNSON STREET" (AHEAD ARROW)
- "MCARTHUR SCHOOL, HIGH SCHOOL, MIDDLE SCHOOL" (AHEAD ARROW)

#### GRANT STREET / JOHNSON (WESTBOUND)

- 1. "JOHNSON STREET NORTHBOUND TRAFFIC ONLY HARMONY TO GRANT"
- "MCARTHUR SCHOOL, HIGH SCHOOL, MIDDLE SCHOOL USE MAPLE AVENUE"

- 1. "JOHNSON STREET NORTHBOUND TRAFFIC ONLY HARMONY TO GRANT"
- 2. "MCARTHUR SCHOOL, HIGH SCHOOL, MIDDLE SCHOOL USE MAPLE AVENUE"

#### GRANT STREET / JOHNSON (SOUTHBOUND) SOUTH SIDE OF INTERSECTION

1. "DO NOT ENTER, ONE WAY TRAFFIC"

#### GRANT STREET / JOHNSON (EASTBOUND)

- 1. "JOHNSON STREET NORTHBOUND TRAFFIC ONLY HARMONY TO GRANT"
- 2. "MCARTHUR SCHOOL, HIGH SCHOOL, MIDDLE SCHOOL USE MAPLE AVENUE"

#### MIDDLE SCHOOL ENTRANCES

1. "ONE WAY" (RIGHT ARROW)

SCALE:

1. "ONE WAY" (LEFT ARROW)

#### HIGH SCHOOL ENTRANCES

1. "ONE WAY" (RIGHT ARROW)

#### MCARTHUR SCHOOL ENTRANCE

1. "ONE WAY" (RIGHT ARROW)

## TRAFFIC CONTROL AND PROTECTION:

- REFER TO IDOT TRAFFIC CONTROL STANDARDS: 701001-02, 701006-05, 701301-04, 701501-06, 701901-09, BLR 21-9, BLR 22-7.
- ERECT SIGNAGE AS PER THE MUTCD INCLUDING, BUT NOT LIMITED TO "ROAD WORK AHEAD", "ROAD CLOSED AHEAD", "ROAD CLOSED 500 FT", ETC.
- NOT ALL SIGNAGE REQUIRED IS SHOWN ON THESE PLANS. IT IS THE RESPONSIBILITY OF THE CONTRACTOR TO ENSURE THAT SIGNAGE IS PROPERLY INSTALLED.


	EG
714 E. JACKSON STREET	PH: 309.833.4594
MACOMB, IL 61455	www.imegcorp.com

USER NAME = TAB	DESIGNED —	LRR/MJC	REVISED — 09-06-2023
	DRAWN —	TAB	REVISED
PLOT SCALE =	CHECKED —	LRR	REVISED
PLOT DATE = 09-06-2023	DATE —	01/11/2023	REVISED

STATE OF ILLINOIS DEPARTMENT OF TRANSPORTATION

STAGING PLAN - STAGE 3 JOHNSON STREET RECONSTRUCTION SHEET NO. 34 OF 104 SHEETS

	F.A.U. RTE.				COUNTY	TOTAL SHEETS	SHEE.
	6926	19-00155-00-PV			McD0N0UGH	104	34
_	JOHNSON ST & GRANT ST			CONTRACT NO	0. 89809		
			TI I TNIOTS	DDA ID	CT NO 115C(152)		

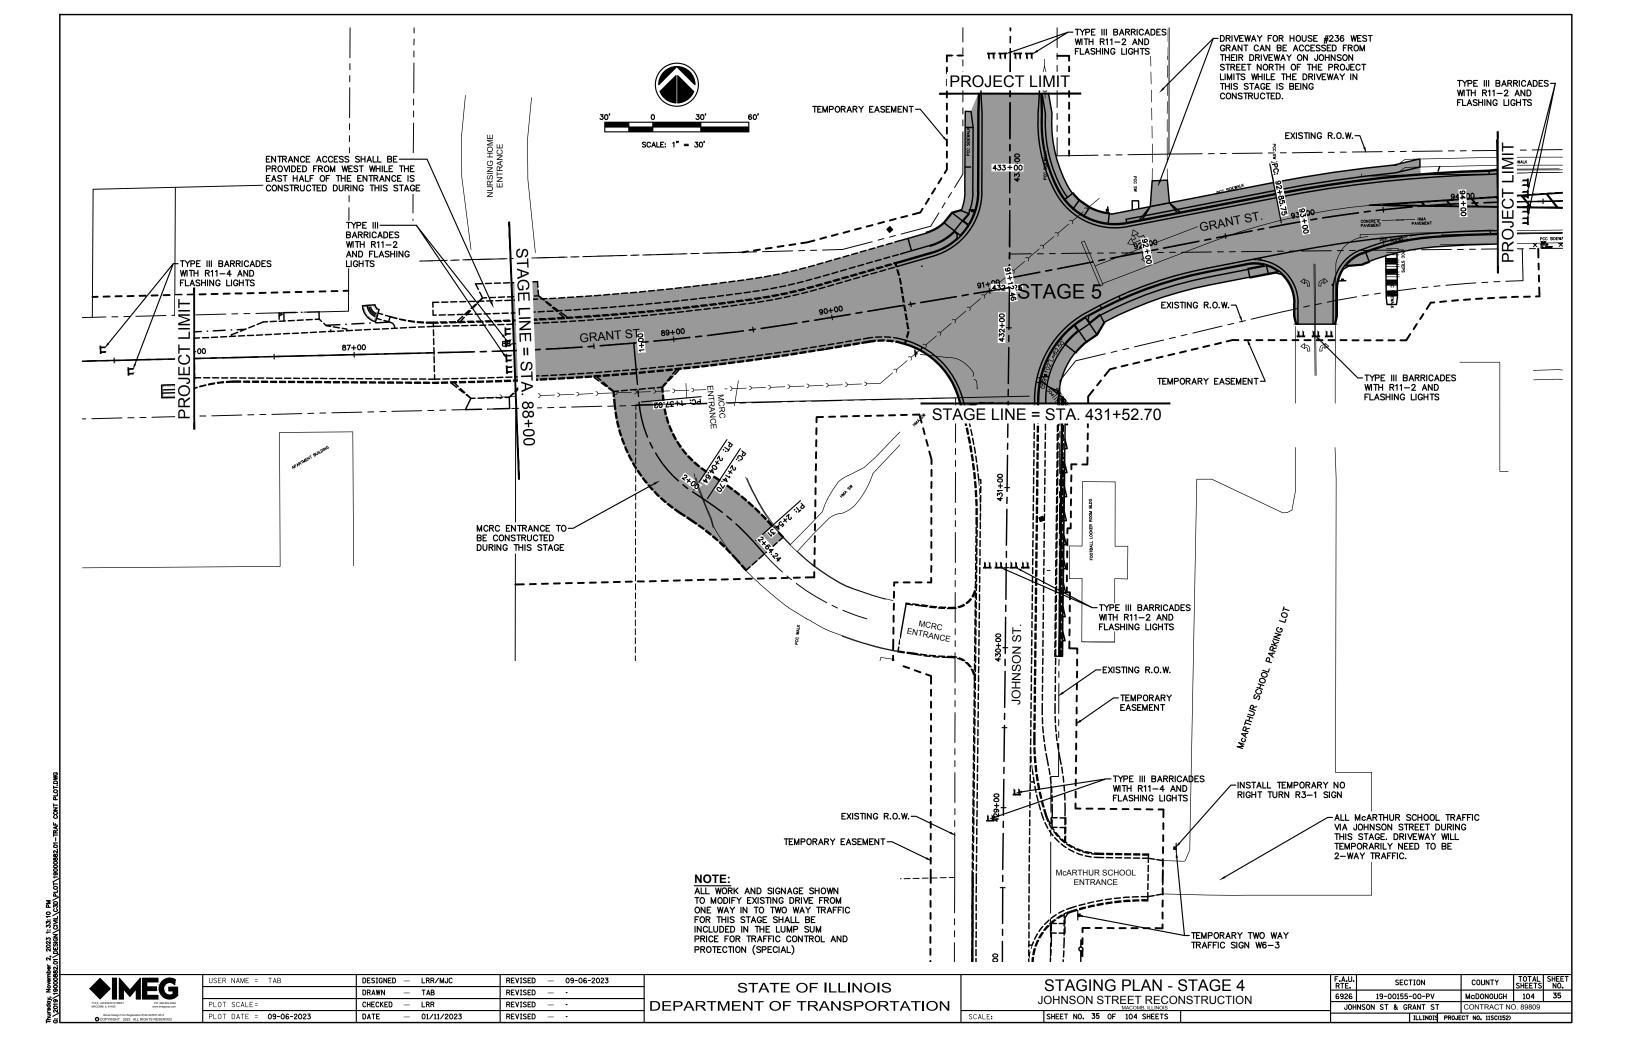

#### ROADWAY - STAGE 4 JOHNSON STREET FROM 431+52.70 to NORTH LIMITS AND GRANT STREET FROM 88+00 TO THE EAST LIMITS

#### CONSTRUCTION

- OPEN JOHNSON STREET TO ALL TRAFFIC SOUTH OF STA, 429+00. BOTH OF THE MIDDLE SCHOOL ENTRANCES AND BOTH OF THE HIGH SCHOOL ENTRANCES WILL BE ACCESSED FROM SOUTH JOHNSON STREET.
- 2. REMOVE EXISTING PAVEMENT AND OTHER ITEMS INDICATED FROM JOHNSON STREET STA. 431+52.70 TO NORTH LIMITS AND FROM GRANT STREET STA. 88+00 TO THE EAST LIMITS.
- 3. CONSTRUCT ALL STORM SEWERS LOCATED WITHIN THIS STAGE AREA.
- 4. PERFORM EARTHWORK.
- 5. CONSTRUCT CURB & GUTTER AND PAVEMENT IN THIS STAGE AREA.
- 6. CONSTRUCT THE McARTHUR SCHOOL ENTRANCE OFF OF GRANT
- 7. CONSTRUCT THE MCRC ENTRANCE OFF OF GRANT STREET
- 8. CONSTRUCT THE EAST HALF OF THE ENTRANCE TO COUNTRY VIEW NURSING HOME
- 9. CONSTRUCT DRIVEWAYS IN THIS SECTION.
- 10. CONSTRUCT RETAINING WALL AND SIDEWALK IN THE STATION 430+00±
- 11. SHARED USE PATH AND OTHER ITEMS MAY BE CONSTRUCTED NOW OR IN LATER STAGES.
- 12. OPEN JOHNSON STREET TO ALL TRAFFIC SOUTH OF THE MCRC ENTRANCE LOCATED AT 430+25.

#### STORM SEWER - STAGE 4

#### CONSTRUCTION

- CONSTRUCT THE STORM SEWER IN THE AREA OF THE JOHNSON / GRANT INTERSECTION.
- 2. IF STORM SEWER IN THE JOHNSON / GRANT INTERSECTION IS TO BE CONSTRUCTED PRIOR TO CLOSURE OF THIS AREA FOR PAVEMENT CONSTRUCTION DURING STAGE 4 THEN 1 LANE TRAFFIC MUST BE MAINTAINED AT ALL TIMES. COMPLETE CLOSURE OF THE INTERSECTION PRIOR TO STAGE 4 WILL NOT BE PERMITTED.
- 3. COORDINATE UTILITY ADJUSTMENTS BY OTHERS

CONSTRUCT UNDERGROUND UTILITIES WITHIN THIS STAGING AREA WHILE THE STAGE IS SHUT DOWN TO **ROADWAY - STAGE 4** JOHNSON STREET FROM 431+52.70 to NORTH LIMITS AND GRANT STREET FROM 88+00 TO THE EAST

#### **TRAFFIC**

- 1. 2-WAY, 2-LANE TRAFFIC SHALL BE MAINTAINED OUTSIDE OF THIS STAGING AREA AT ALL TIMES.
- UPDATE DETOUR SIGNAGE AT JOHNSON / CHINA ROAD, JOHNSON / ROAD 1050 NORTH, MAPLE AVE. / ROAD 1050 NORTH, MAPLE AVE. / GRANT, AND GRANT / JOHNSON ERECTED DURING PREVIOUS STAGES
- 3. ERECT DETOUR SIGNAGE ON WARD STREET AND RANDOLPH STREET AT JEFFERSON & WASHINGTON STREETS, AND OTHER SIGNAGE AS
- 4. MAINTAIN TRAFFIC ON THE WEST HALF OF THE ENTRANCE DRIVE TO THE COUNTRY VIEW NURSING HOME. CONSTRUCT EAST HALF OF ENTRANCE DURING THIS STAGE. CONSTRUCT THE WEST HALF DURING
- 5. McARTHUR SCHOOL WILL BE ACCESSED FROM JOHNSON STREET AND WILL NEED TO HAVE THAT ENTRANCE TEMPORARILY BE 2-WAY TRAFFIC
- 6. THE HIGH SCHOOL WILL BE ACCESSED FROM THE SOUTH ON JOHNSON STREET (BOTH ENTRANCES OPEN), AND FROM MAPLE AVENUE.
- THE NEW MIDDLE SCHOOL WILL BE ACCESSED FROM THE SOUTH ON JOHNSON STREET (BOTH ENTRANCES OPEN).
- HARMONY LANE, GREENVIEW ESTATES, AND WEAR AVENUE WILL BE ACCESSED FROM JOHNSON STREET TO THE SOUTH AND FROM MAPLE
- MCRC WILL BE ACCESS VIA THEIR NEW ENTRANCE ON JOHNSON STREET FROM THE SOUTH.
- 10. CONSTRUCT IMPROVEMENTS IN THIS STAGE AREA WHILE CLOSING THIS PORTION OF JOHNSON STREET AND GRANT STREET TO ALL TRAFFIC.

#### **DETOUR SIGNAGE - STAGE 4**

#### CHINA ROAD / JOHNSON STREET (EAST BOUND)

- "JOHNSON / GRANT INTERSECTION CLOSED"
- "GRANT STREET, HOSPITAL" (RIGHT TURN ARROW)

# ROAD 1050 NORTH / JOHNSON STREET (NORTH BOUND) 1. "JOHNSON / GRANT INTERSECTION CLOSED"

- 2. "GRANT STREET, HOSPITAL" (RIGHT TURN ARROW)

#### ROAD 1050 NORTH / JOHNSON STREET (SOUTH BOUND) "GRANT STREET, HOSPITAL" (LEFT TURN ARROW)

#### ROAD 1050 NORTH / MAPLE AVENUE (EAST BOUND) "GRANT STREET, HOSPITAL" (LEFT TURN ARROW)

#### ROAD 1050 NORTH / MAPLE AVENUE (WEST BOUND)

- "JOHNSON / GRANT INTERSECTION CLOSED"
- "GRANT STREET, HOSPITAL" (RIGHT TURN ARROW)

# MAPLE AVENUE / GRANT STREET (NORTH BOUND) 1. "HOSPITAL" (RIGHT TURN ARROW)

- "JOHNSON / GRANT INTERSECTION CLOSED
- "WEST GRANT STREET DETOUR STRAIGHT AHEAD"

#### RANDOLPH STREET / GRANT STREET (SOUTH BOUND)

- "JOHNSON / GRANT INTERSECTION CLOSED"
- "HIGH SCHOOL, MIDDLE SCHOOL, McARTHUR SCHOOL, SOUTH JOHNSON STREET, CHINA ROAD STRAIGHT AHEAD"

#### RANDOLPH STREET / GRANT STREET (EAST BOUND)

"SOUTH JOHNSON STREET, MIDDLE SCHOOL, HIGH SCHOOL, McARTHUR SCHOOL" (RIGHT TURN ARROW)

# RANDOLPH STREET / GRANT STREET (WEST BOUND) 1. "JOHNSON / GRANT INTERSECTION CLOSED"

- "SOUTH JOHNSON STREET, CHINA ROAD, MIDDLE SCHOOL, HIGH SCHOOL, McARTHUR SCHOOL" (LEFT TURN ARROW)

# JOHNSON STREET / FISK STREET (SOUTH BOUND) 1. "JOHNSON / GRANT INTERSECTION CLOSED"

"DETOUR" (LEFT TURN ARROW)

# FISK STREET / LAFAYETTE STREET (EAST BOUND) 1. "DETOUR" (RIGHT TURN ARROW)

# LAFAYETTE STREET / GRANT STREET (SOUTH BOUND) 1. "END DETOUR"

# WARD STREET / GRANT STREET (EAST BOUND) 1. "JOHNSON / GRANT INTERSECTION CLOSED"

- "HIGH SCHOOL, MIDDLE SCHOOL, McARTHUR SCHOOL, SOUTH JOHNSON STREET" (LEFT TURN ARROW)
- 3. "HOSPITAL" (LEFT TURN ARROW)

#### WARD STREET / GRANT STREET (NORTH BOUND)

- "JOHNSON / GRANT INTERSECTION CLOSED 2. "HIGH SCHOOL, MIDDLE SCHOOL, McARTHUR SCHOOL, SOUTH
- JOHNSON STREET STRAIGHT AHEAD" "HOSPITAL STRAIGHT AHEAD"

WARD STREET / GRANT STREET (SOUTH BOUND)

1. "JOHNSON / GRANT INTERSECTION CLOSED"

#### WARD STREET / JEFFERSON STREET (NORTH BOUND)

- "HIGH SCHOOL, MIDDLE SCHOOL, McARTHUR SCHOOL, SOUTH JOHNSON STREET" (RIGHT TURN ARROW)
- 2. "HOSPITAL" (RIGHT TURN ARROW)

- WARD STREET / JEFFERSON STREET (SOUTH BOUND) "JOHNSON / GRANT INTERSECTION CLOSED"
- "HIGH SCHOOL, MIDDLE SCHOOL, McARTHUR SCHOOL, SOUTH
- JOHNSON STREET" (LEFT TURN ARROW) 3. "HOSPITAL" (LEFT TURN ARROW)

#### JEFFERSON STREET / RANDOLPH STREET (EAST BOUND)

- "HIGH SCHOOL, MIDDLE SCHOOL, McARTHUR SCHOOL, SOUTH JOHNSON STREET" (RIGHT TURN ARROW)
- 2. "HOSPITAL" (RIGHT TURN ARROW)

#### WASHINGTON STREET / RANDOLPH STREET (NORTH BOUND)

1. "WEST GRANT STREET DETOUR" (LEFT TURN ARROW)

#### WASHINGTON STREET / WARD STREET (WEST BOUND)

"WEST GRANT STREET DETOUR" (LEFT TURN ARROW)

#### JOHNSON STREET / WASHINGTON STREET (SOUTH BOUND) "JOHNSON / GRANT INTERSECTION CLOSED"

- 2. "WEST GRANT STREET DETOUR" (RIGHT TURN ARROW)


# JOHNSON STREET / JEFFERSON STREET (SOUTH BOUND) 1. "JOHNSON / GRANT INTERSECTION CLOSED"

- "HIGH SCHOOL, MIDDLE SCHOOL, McARTHUR SCHOOL, SOUTH JOHNSON STREET" (LEFT TURN ARROW)
- "HOSPITAL" (LEFT TURN ARROW)

#### TRAFFIC CONTROL AND PROTECTION:

- REFER TO IDOT TRAFFIC CONTROL STANDARDS 701001-02, 701006-05, 701301-04, 701501-06, 701901-09,
- 2. ERECT SIGNAGE AS PER THE MUTCD INCLUDING, BUT NOT LIMITED TO "ROAD WORK AHEAD", "ROAD CLOSED AHEAD", "ROAD CLOSED 500 FT", ETC.
- 3. NOT ALL SIGNAGE REQUIRED IS SHOWN ON THESE PLANS. IT IS THE RESPONSIBILITY OF THE CONTRACTOR TO ENSURE THAT SIGNAGE IS PROPERLY INSTALLED.

USER NAME = TAB	DESIGNED — LRR/MJC	REVISED — 09-06-2023
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PLOT SCALE=	CHECKED — LRR	REVISED — ·
PLOT DATE = 09-06-2023	DATE - 01/11/2023	REVISED — ·

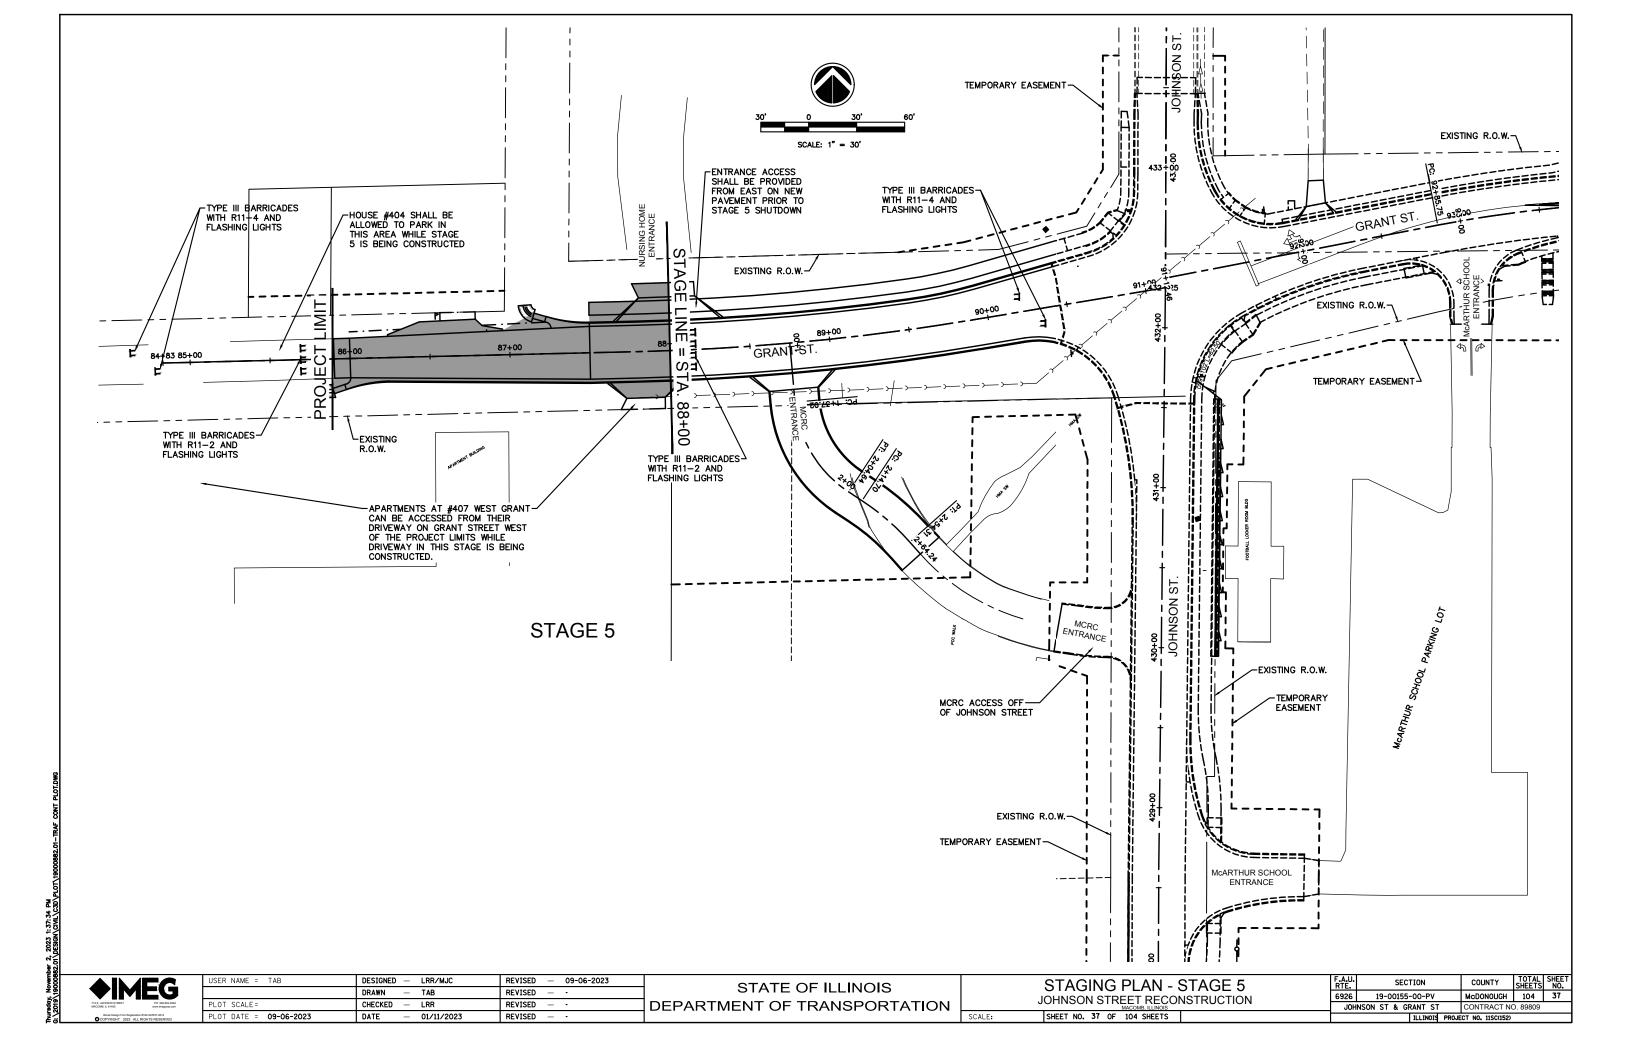

#### **ROADWAY - STAGE 5 GRANT STREET FROM WEST LIMITS TO 88+00**

- 1. OPEN JOHNSON STREET TO ALL TRAFFIC. NORTH-SOUTH TRAFFIC WILL FLOW AS NORMAL.
- 2. OPEN GRANT STREET EAST OF JOHNSON STREET.
- 3. REMOVE EXISTING PAVEMENT AND OTHER ITEMS INDICATED FROM PROJECT LIMITS TO STA. 88+00.
- 4. CONSTRUCT ANY STORM SEWERS LOCATED WITHIN THIS STAGE
- PERFORM EARTHWORK.
- 6. CONSTRUCT CURB & GUTTER AND PAVEMENT
- 7. CONSTRUCT WEST HALF OF ENTRANCE TO NURSING HOME.
- 8. CONSTRUCT REMAINING DRIVEWAYS IN THIS STAGE AREA.
- 9. CONSTRUCT ANY REMAINING DRIVEWAYS FROM STAGE 3 AND STAGE 4 AREAS THAT COULD NOT BE CONSTRUCTED UNTIL TEMPORARY
- 10. SHARED USE PATH AND OTHER ITEMS MAY BE CONSTRUCTED NOW OR IN PREVIOUS STAGES.
- 11. OPEN JOHNSON AND GRANT STREETS TO ALL TRAFFIC.
- 12. PERFORM SEEDING OPERATIONS.
- 13. PERFORM PAVEMENT STRIPING OPERATIONS

### **ROADWAY - STAGE 5 GRANT STREET FROM WEST LIMITS TO 88+00**

- 1. 2-WAY, 2-LANE TRAFFIC SHALL BE MAINTAINED OUTSIDE OF THIS STAGING AREA AT ALL TIMES.
- 2. UPDATE DETOUR SIGNAGE AT JOHNSON / CHINA ROAD, JOHNSON / ROAD 1050 NORTH, MAPLE AVE. / ROAD 1050 NORTH, MAPLE AVE. / GRANT, AND GRANT / JOHNSON ERECTED DURING PREVIOUS
- 3. UPDATE DETOUR SIGNAGE ON WARD STREET AND RANDOLPH STREET AT JEFFERSON & WASHINGTON STREETS, AND OTHER
- 4. TRAFFIC WILL FLOW NORTH-SOUTH THE ENTIRE LENGTH OF JOHNSON AND THROUGH THE GRANT STREET INTERSECTION FOR THE FIRST TIME SINCE CONSTRUCTION STARTED.
- 5. McARTHUR SCHOOL WILL BE ACCESSED FROM JOHNSON STREET AND GRANT STREET AS PER NORMAL OPERATIONS.
- 6. THE HIGH SCHOOL WILL BE ACCESSED FROM JOHNSON STREET (BOTH ENTRANCES OPEN), AND FROM MAPLE AVENUE AS PER
- 7. THE NEW MIDDLE SCHOOL WILL BE ACCESSED FROM JOHNSON STREET (BOTH ENTRANCES OPEN) AS PER NORMAL OPERATIONS.
- 8. MCRC WILL BE ACCESS VIA THEIR NEW ENTRANCES ON JOHNSON STREET AND GRANT STREET AS PER NEW NORMAL OPERATIONS.
- 9. CONSTRUCT IMPROVEMENTS IN THIS STAGE AREA WHILE CLOSING THIS PORTION OF GRANT STREET TO ALL TRAFFIC.

#### DETOUR SIGNAGE - STAGE 5

## GRANT STREET / JOHNSON STREET (WEST BOUND) 1. "GRANT STREET CLOSED"

- 2. "WEST GRANT STREET DETOUR" (RIGHT TURN

### $\frac{\text{WASHINGTON STREET}}{1.} \text{ "WEST GRANT STREET DETOUR" (LEFT TURN}$ ARROW)

### WASHINGTON STREET / WARD STREET (WEST BOUND)

"WEST GRANT STREET DETOUR" (LEFT TURN

### WARD STREET / GRANT STREET (EAST BOUND) 1. "JOHNSON / GRANT INTERSECTION CLOSED"

- "HIGH SCHOOL, MIDDLE SCHOOL, McARTHUR SCHOOL, SOUTH JOHNSON STREET" (LEFT TURN
- 3. "HOSPITAL" (LEFT TURN ARROW)

### WARD STREET / GRANT STREET (NORTH BOUND)

- "JOHNSON / GRANT INTERSECTION CLOSED" "HIGH SCHOOL, MIDDLE SCHOOL, McARTHUR
- SCHOOL, SOUTH JOHNSON STREET STRAIGHT
- 3. "HOSPITAL STRAIGHT AHEAD"

## WARD STREET / GRANT STREET (SOUTH BOUND) 1. "JOHNSON / GRANT INTERSECTION CLOSED"

### WARD STREET / JEFFERSON STREET (NORTH BOUND) 1. "HIGH SCHOOL, MIDDLE SCHOOL, McARTHUR

- SCHOOL, SOUTH JOHNSON STREET" (RIGHT TURN
- 2. "HOSPITAL" (RIGHT TURN ARROW)

### WARD STREET / JEFFERSON STREET (SOUTH BOUND)

- "JOHNSON / GRANT INTERSECTION CLOSED" "HIGH SCHOOL, MIDDLE SCHOOL, McARTHUR
- SCHOOL, SOUTH JOHNSON STREET" (LEFT TURN
- "HOSPITAL" (LEFT TURN ARROW)

## JEFFERSON STREET / JOHNSON STREET (EAST BOUND) 1. "HIGH SCHOOL, MIDDLE SCHOOL, McARTHUR

- SCHOOL, SOUTH JOHNSON STREET" (RIGHT TURN ARROW)
- "HOSPITAL" (RIGHT TURN ARROW)

### JOHNSON STREET / WASHINGTON STREET (SOUTH BOUND)

- "JOHNSON / GRANT INTERSECTION CLOSED"
- "WEST GRANT STREET DETOUR" (RIGHT TURN

#### TRAFFIC CONTROL AND PROTECTION:


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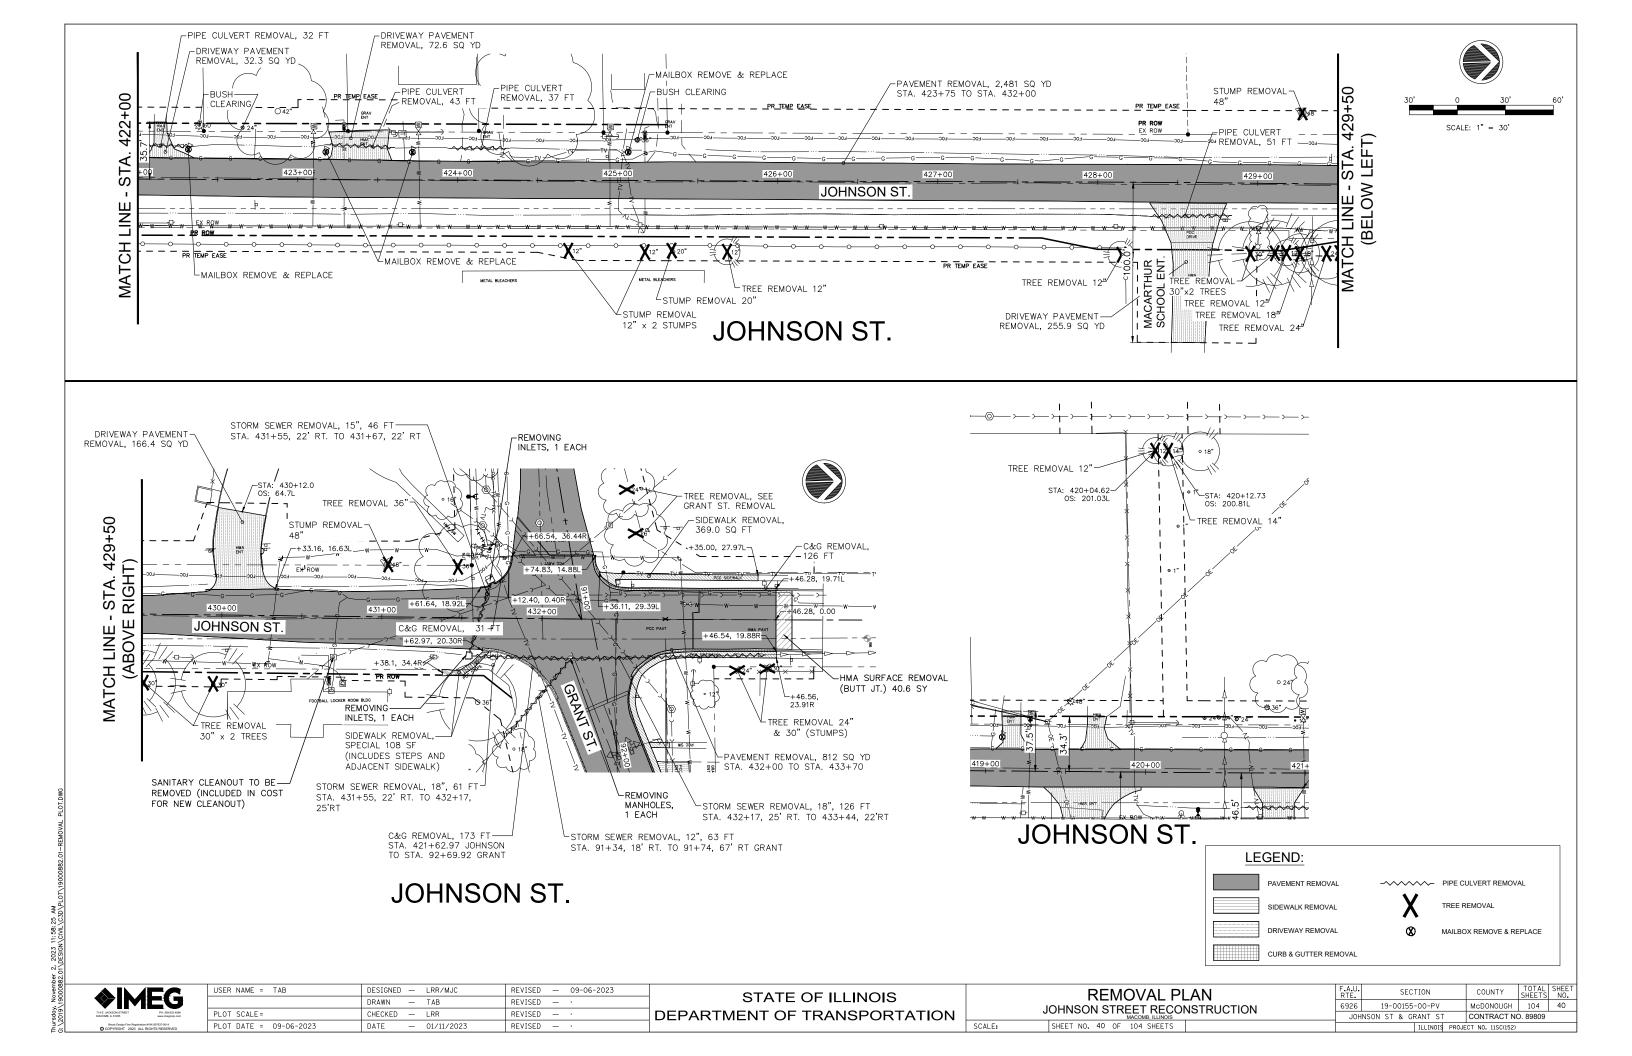
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	DRAWN —	TAB	REVISED	_	•
PLOT SCALE =	CHECKED —	LRR	REVISED	_	•
PLOT DATE = 09-06-2023	DATE —	01/11/2023	REVISED	_	•


STATE OF ILLINOIS DEPARTMENT OF TRANSPORTATION


STAGING PLAN - STAGE 5 JOHNSON STREET RECONSTRUCTION SHEET NO. 38 OF 104 SHEETS


F.A.U. RTE.	SEC.	TION		COUNTY	TOTAL SHEETS	SHEI NO
6926	19-00155	-00-PV		McD0N0UGH	104	38
JOH	NSON ST & GF	RANT ST		CONTRACT NO	D. 89809	
		ILLINOIS	PROJE	CT NO. 11SC(152)		




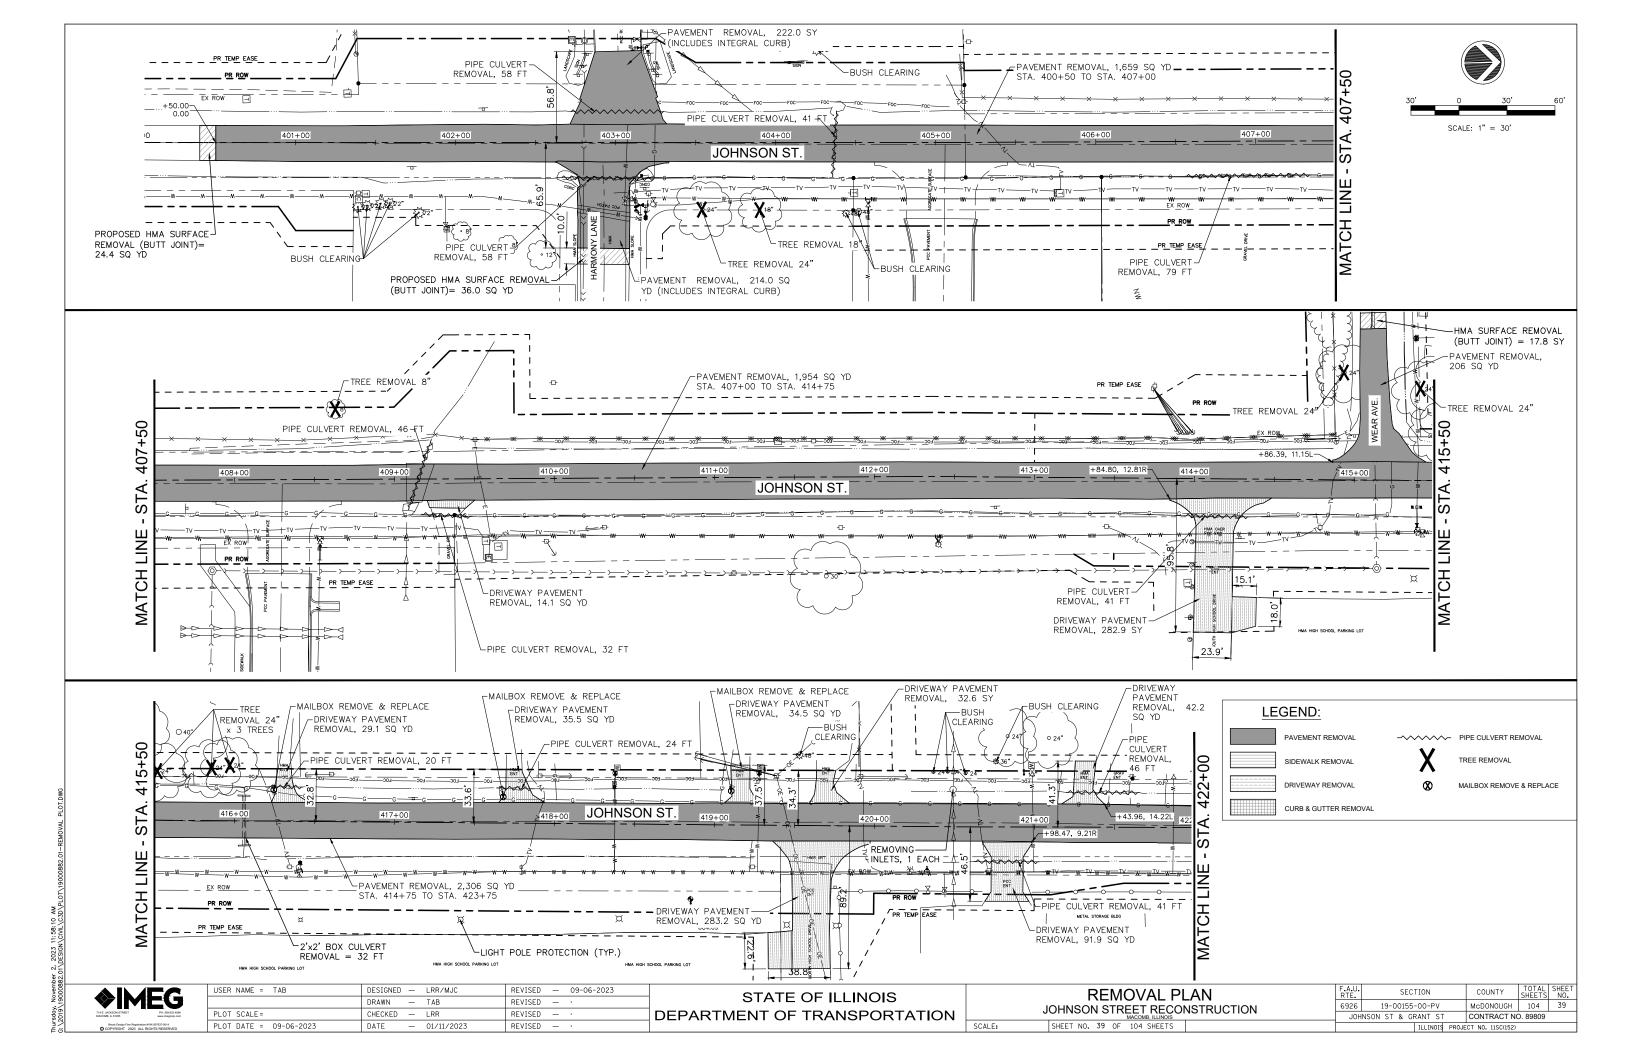


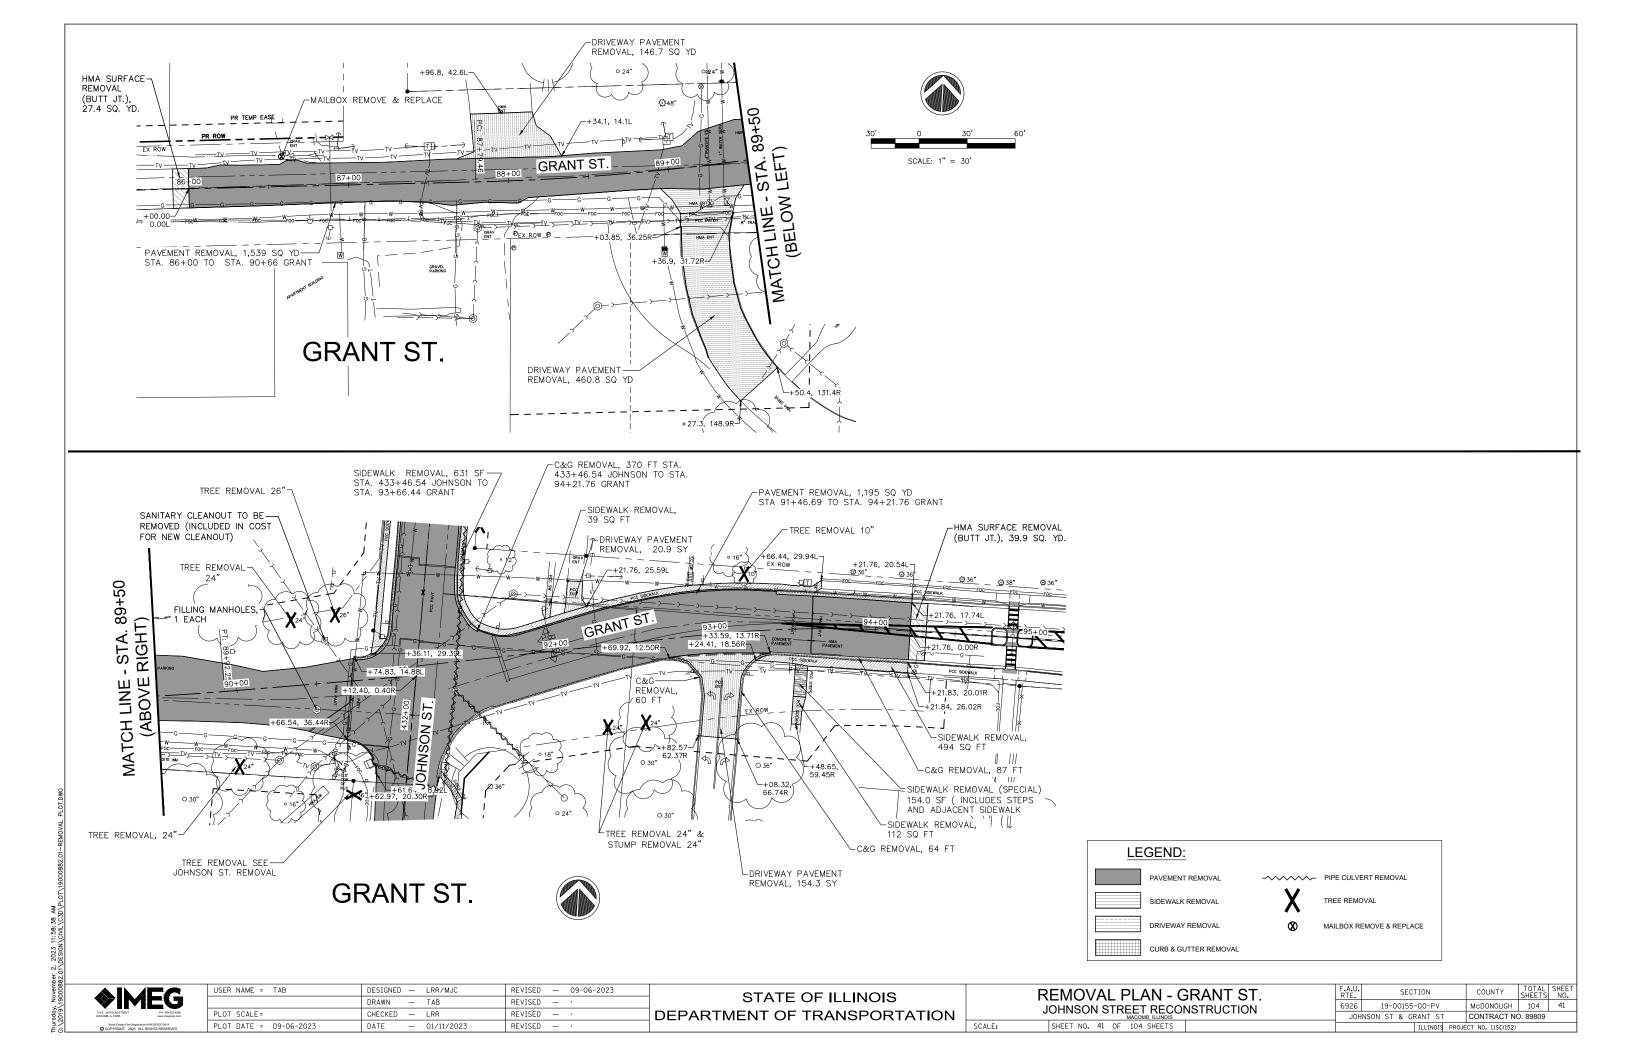


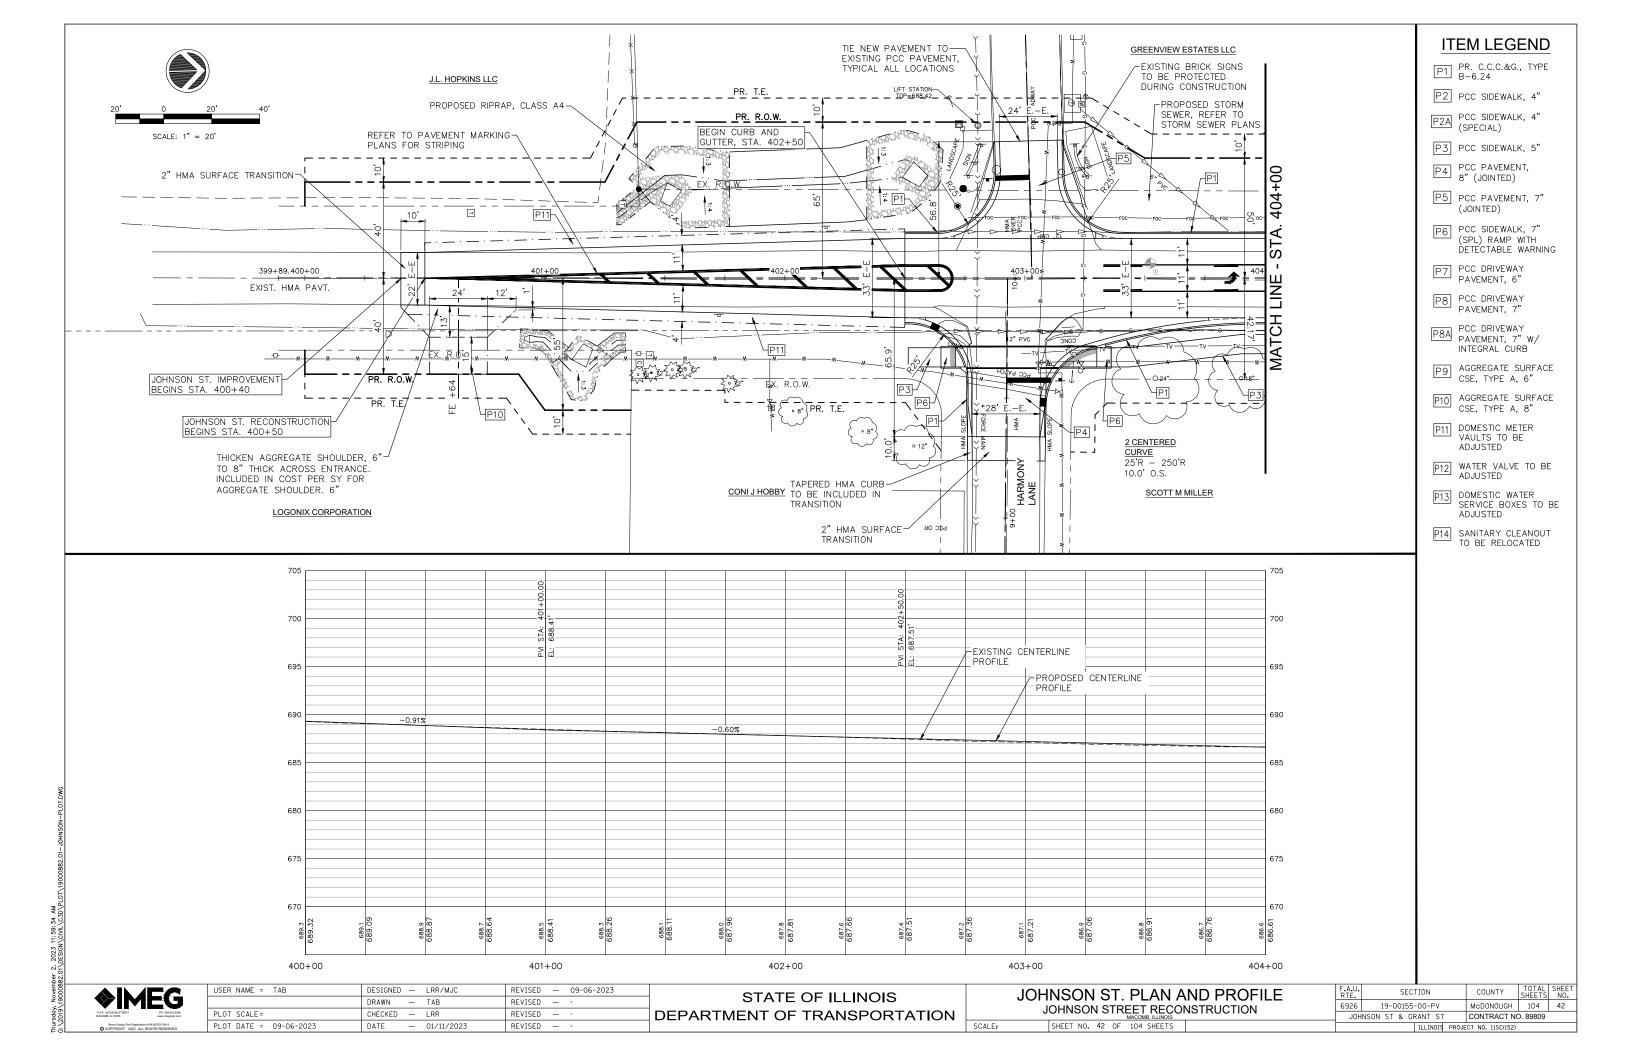


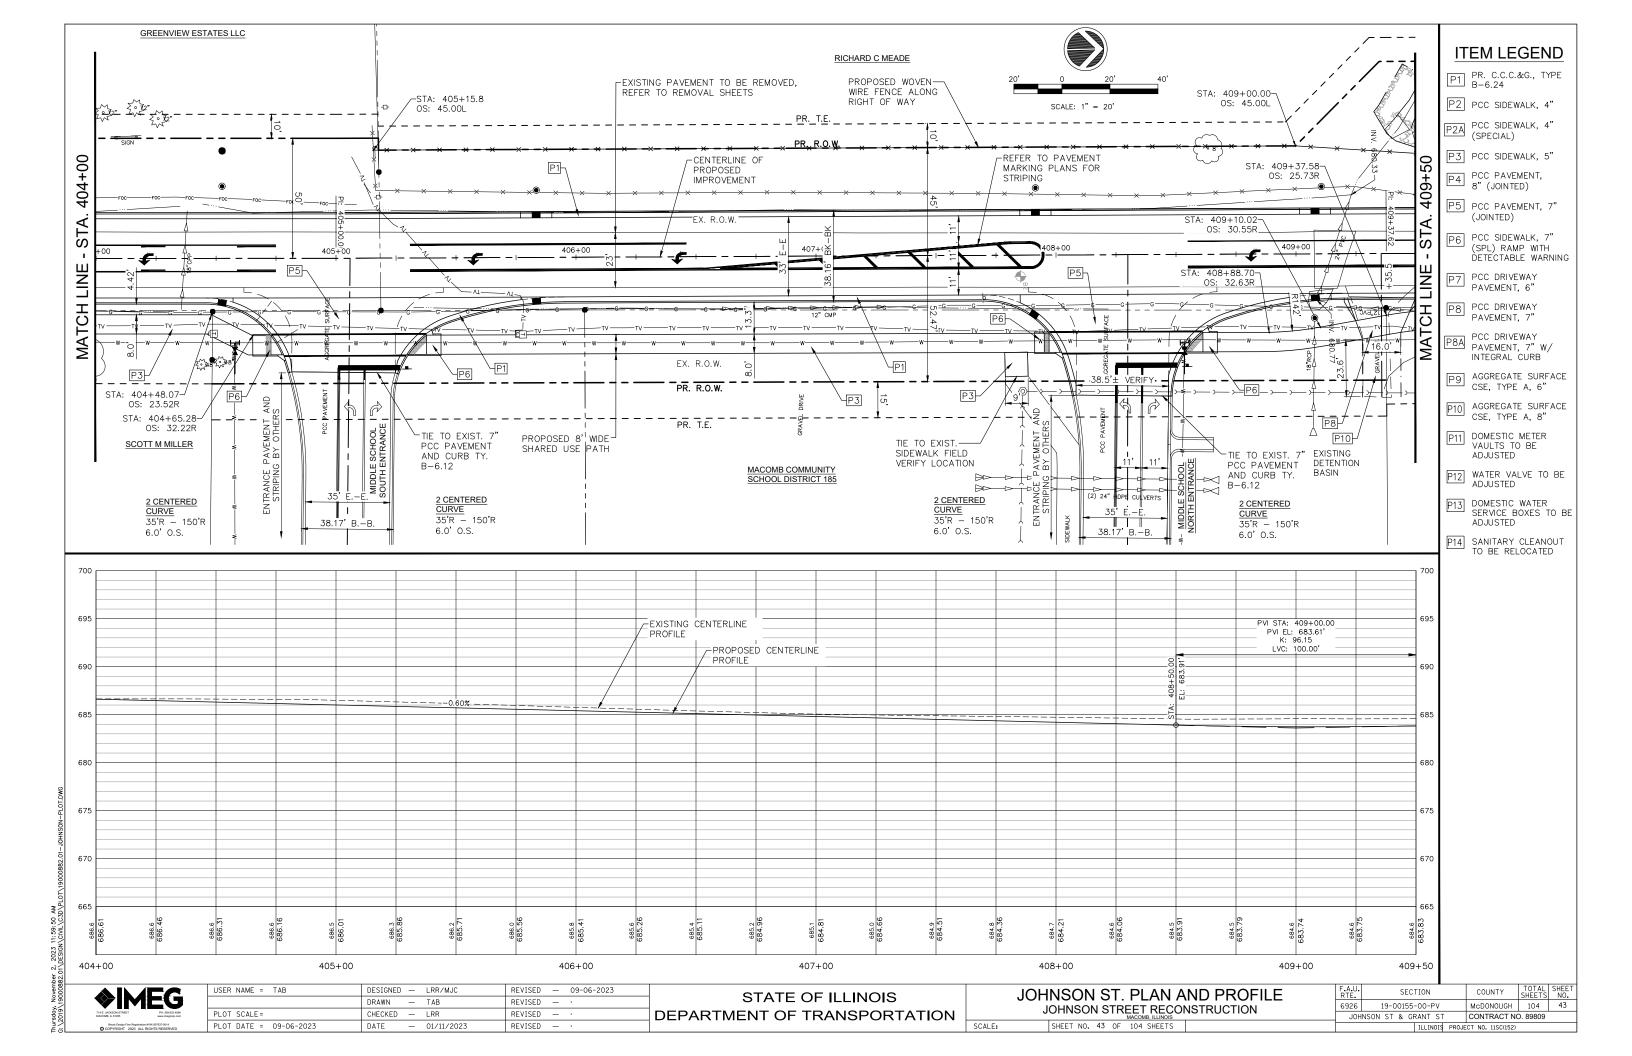


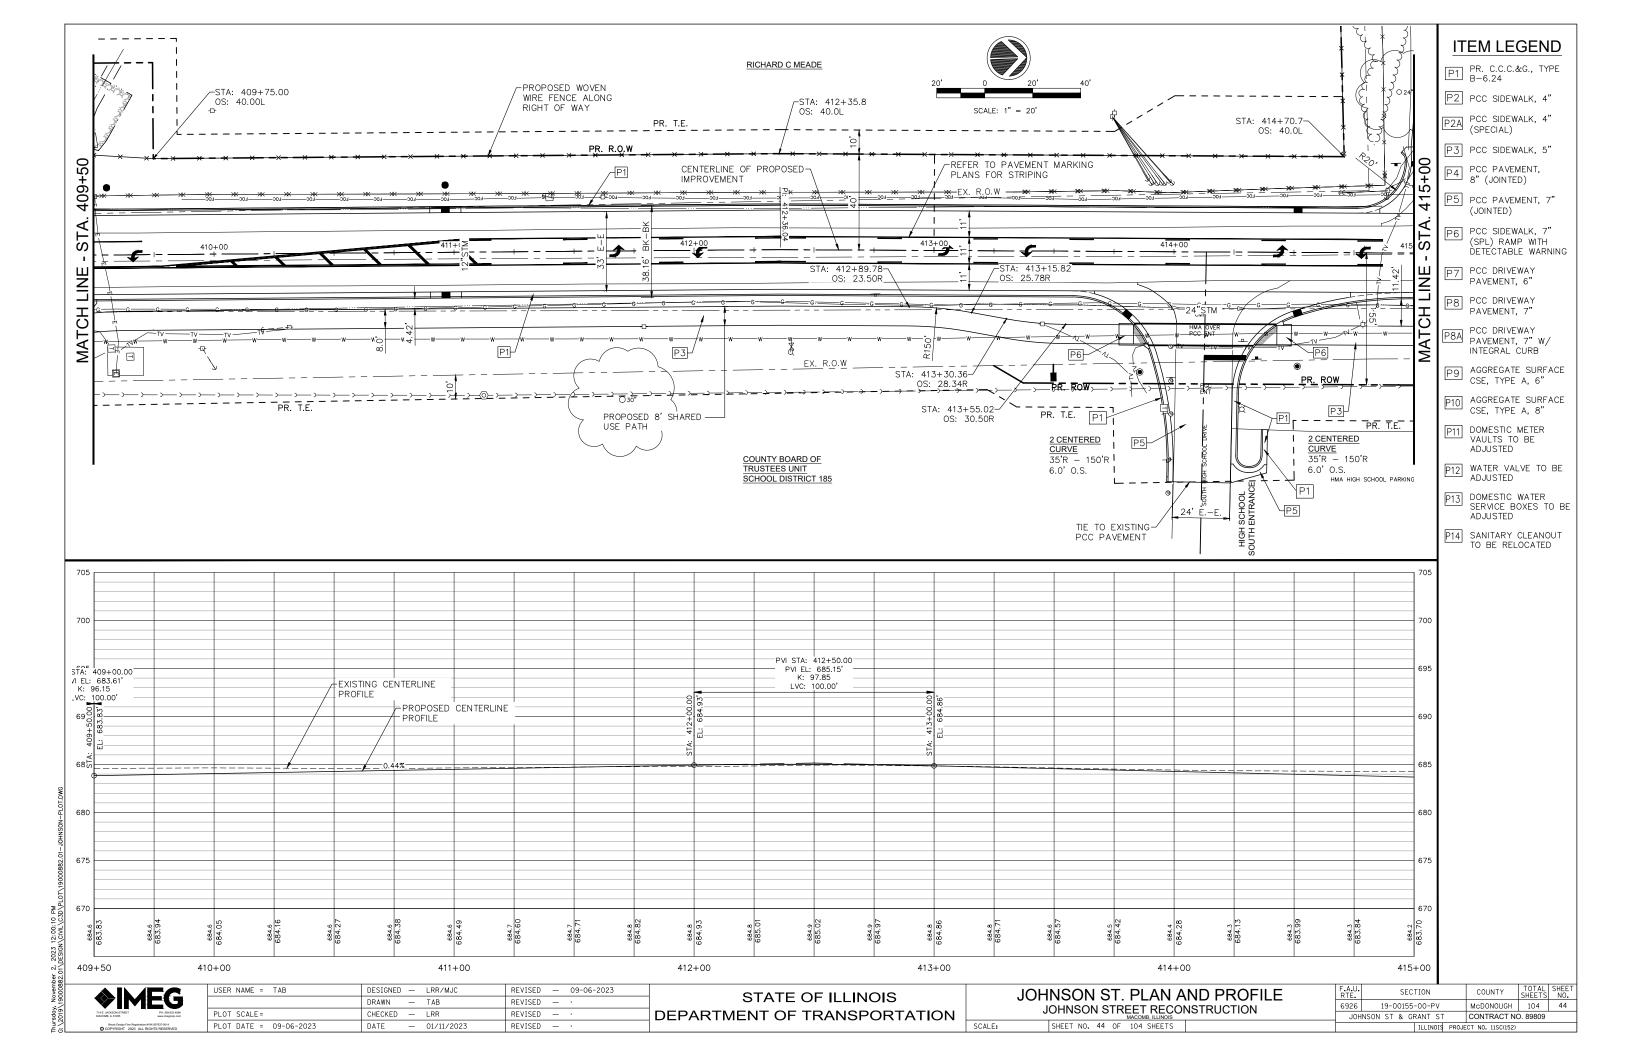


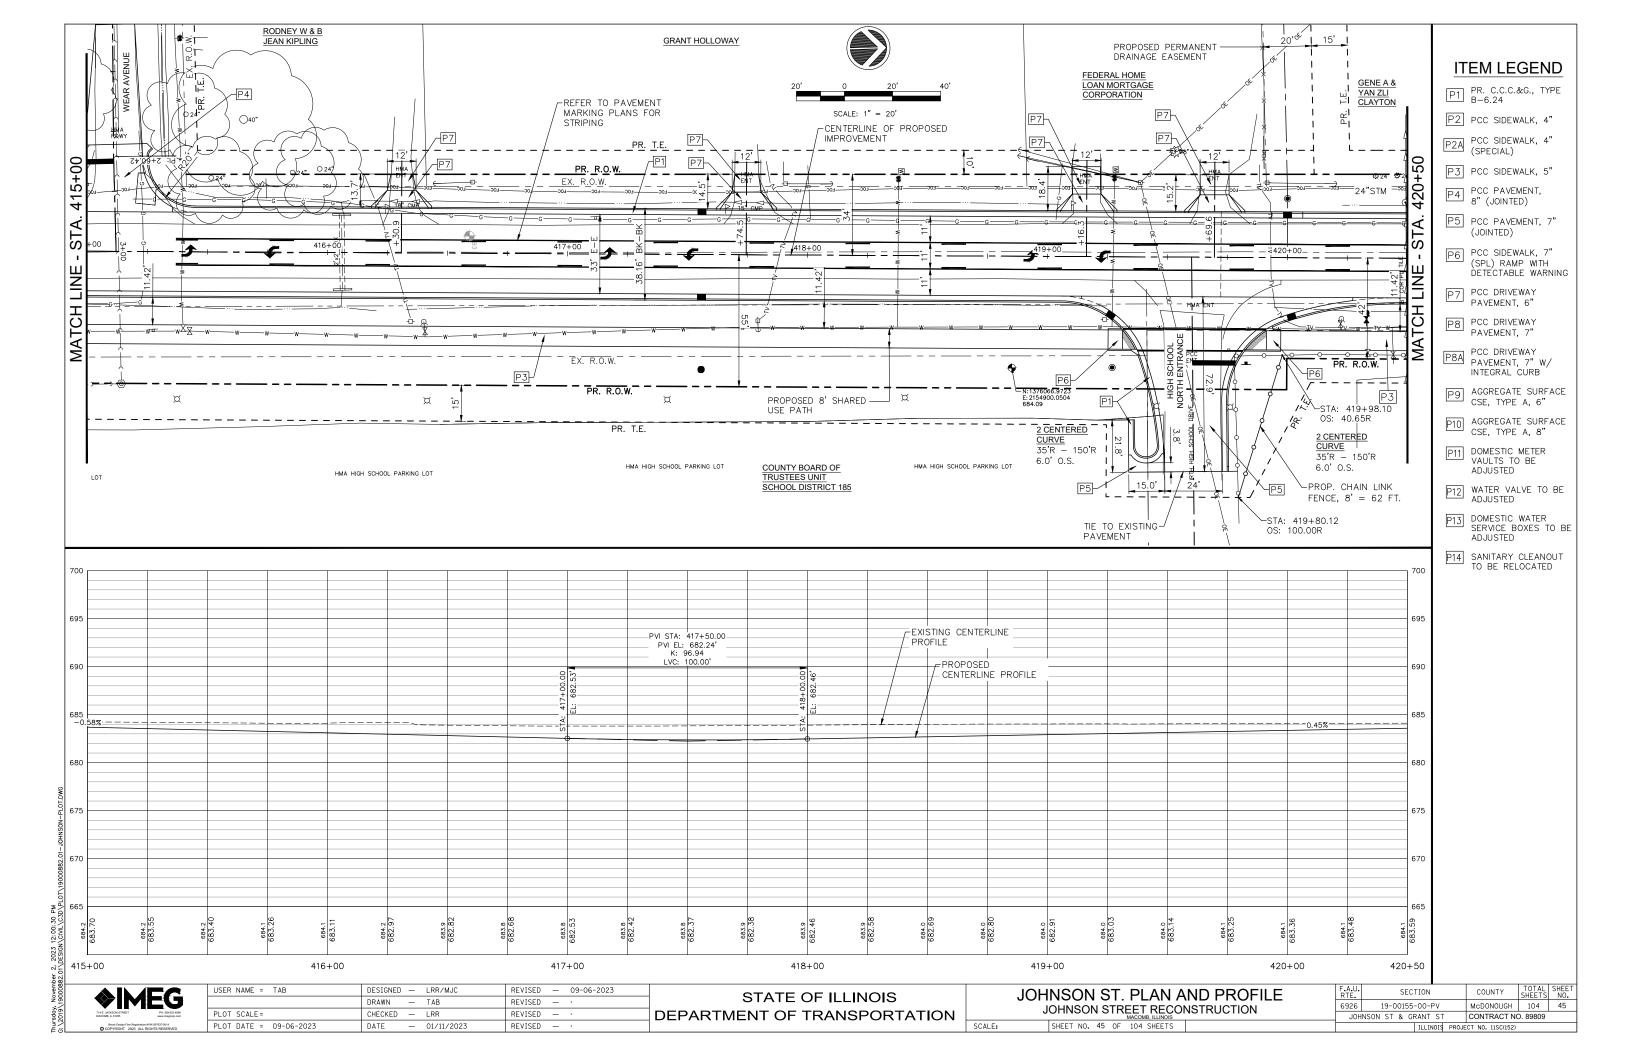


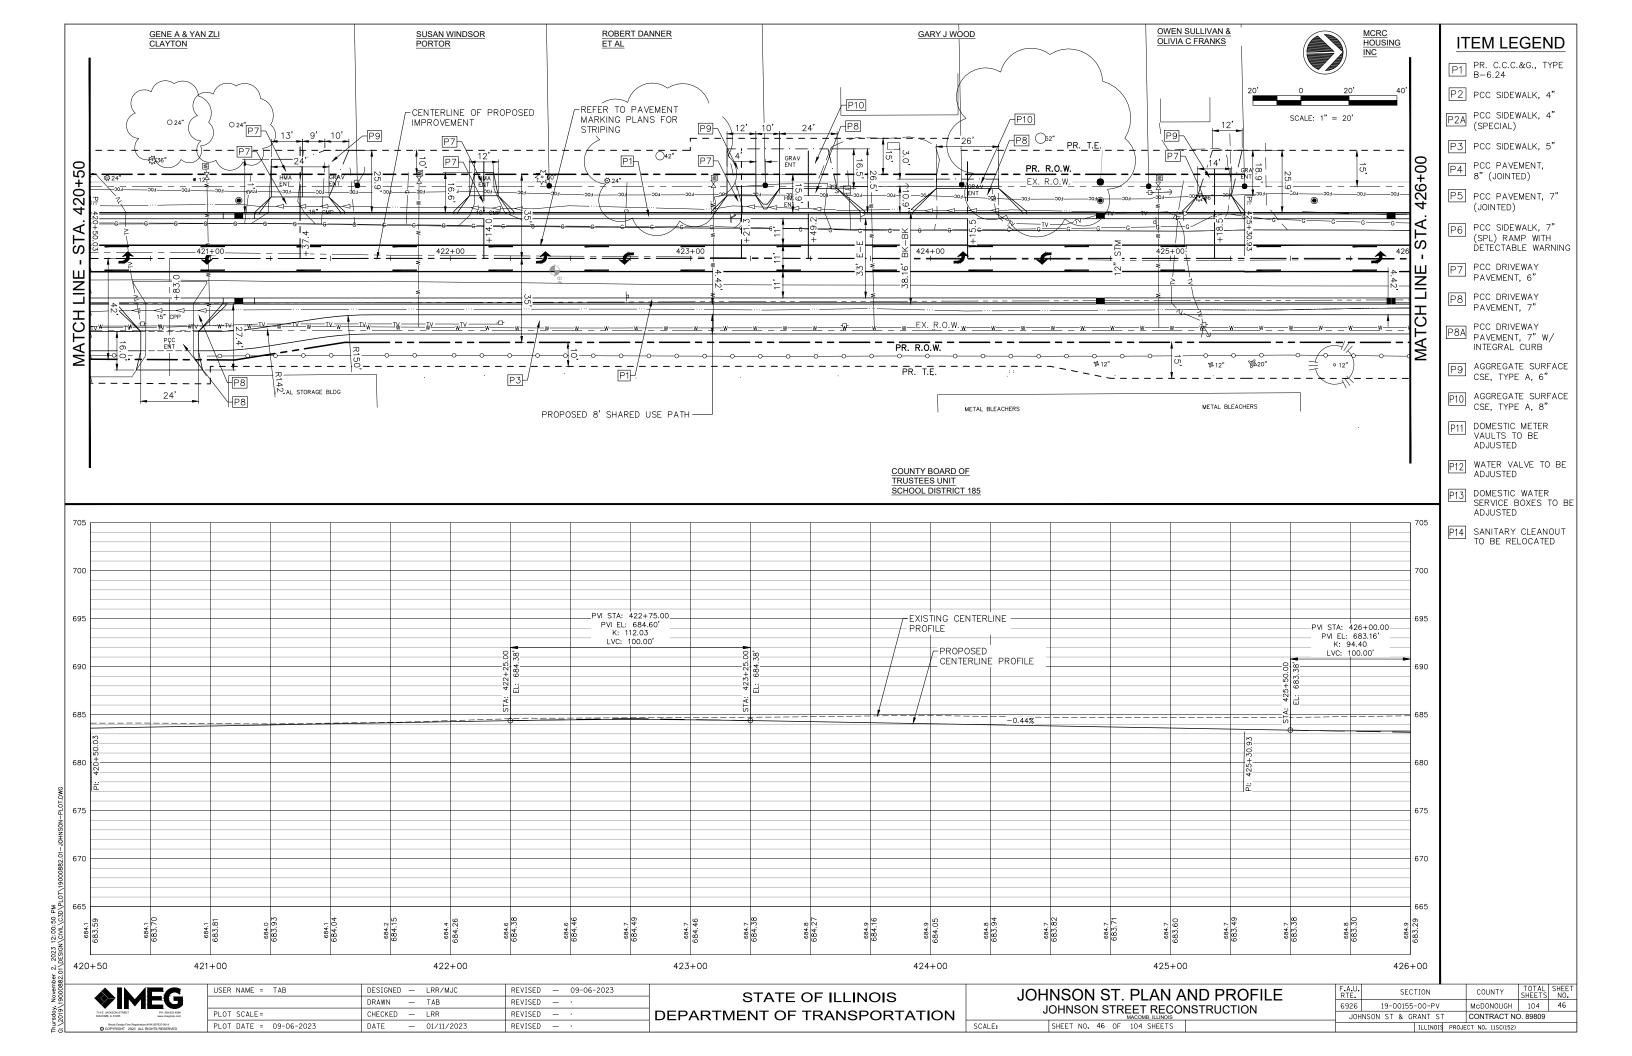

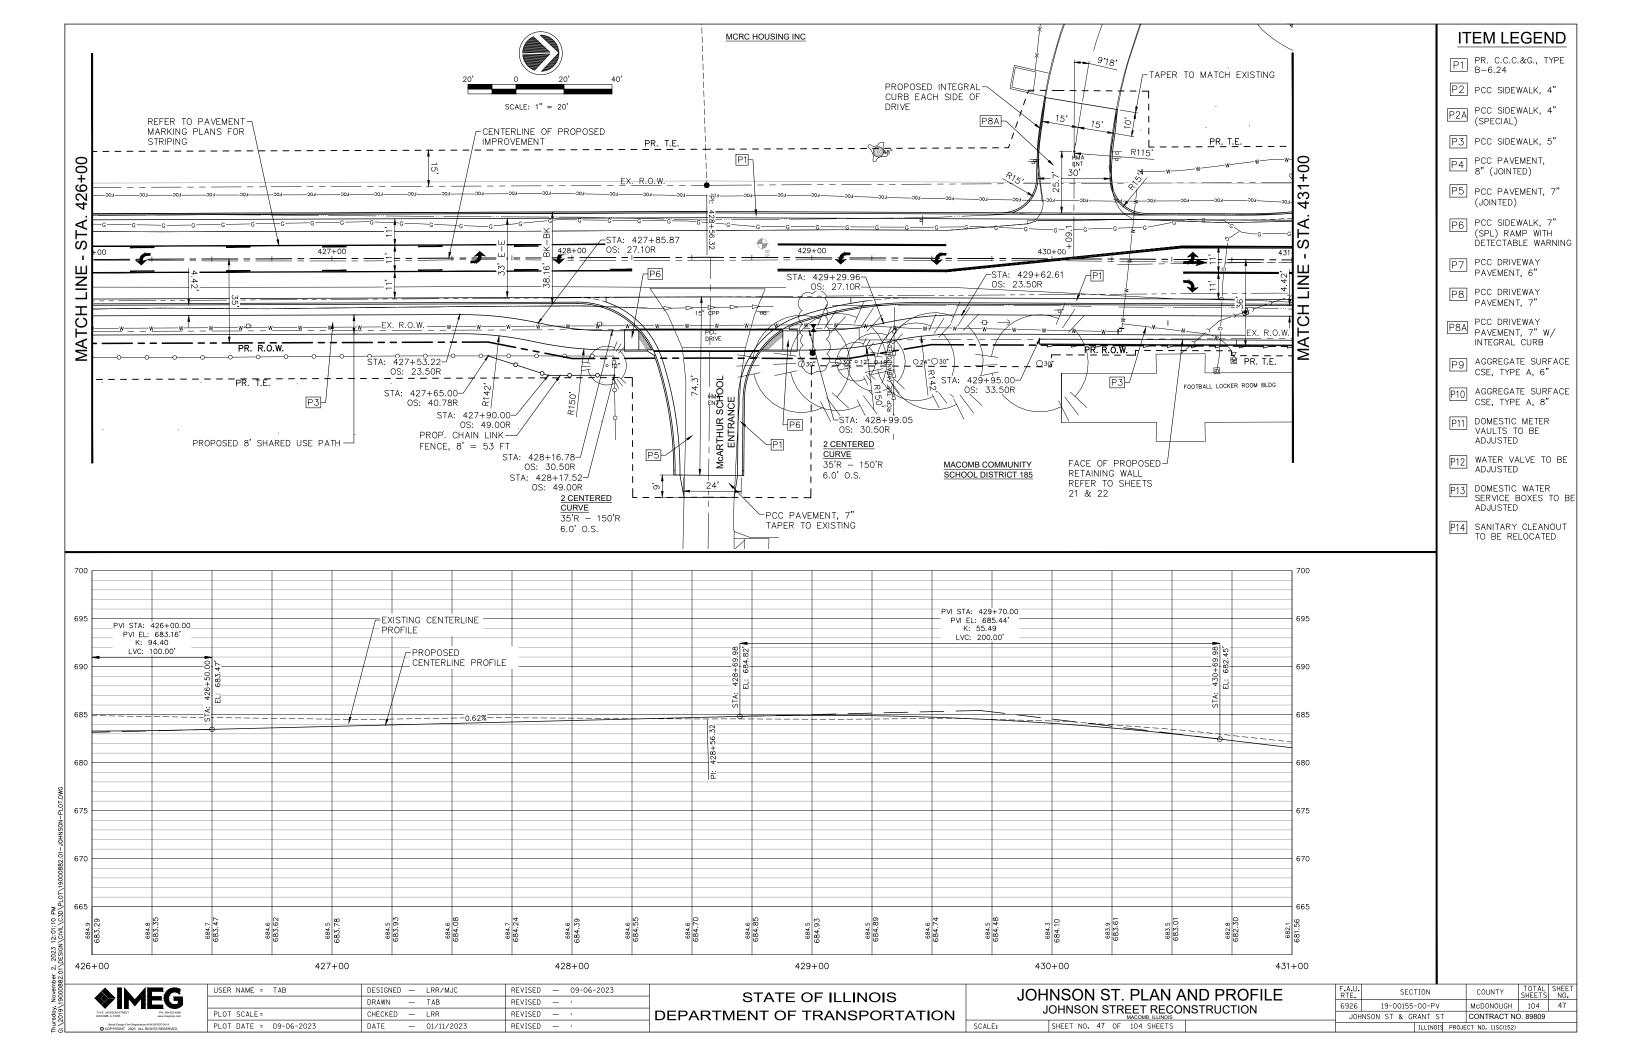

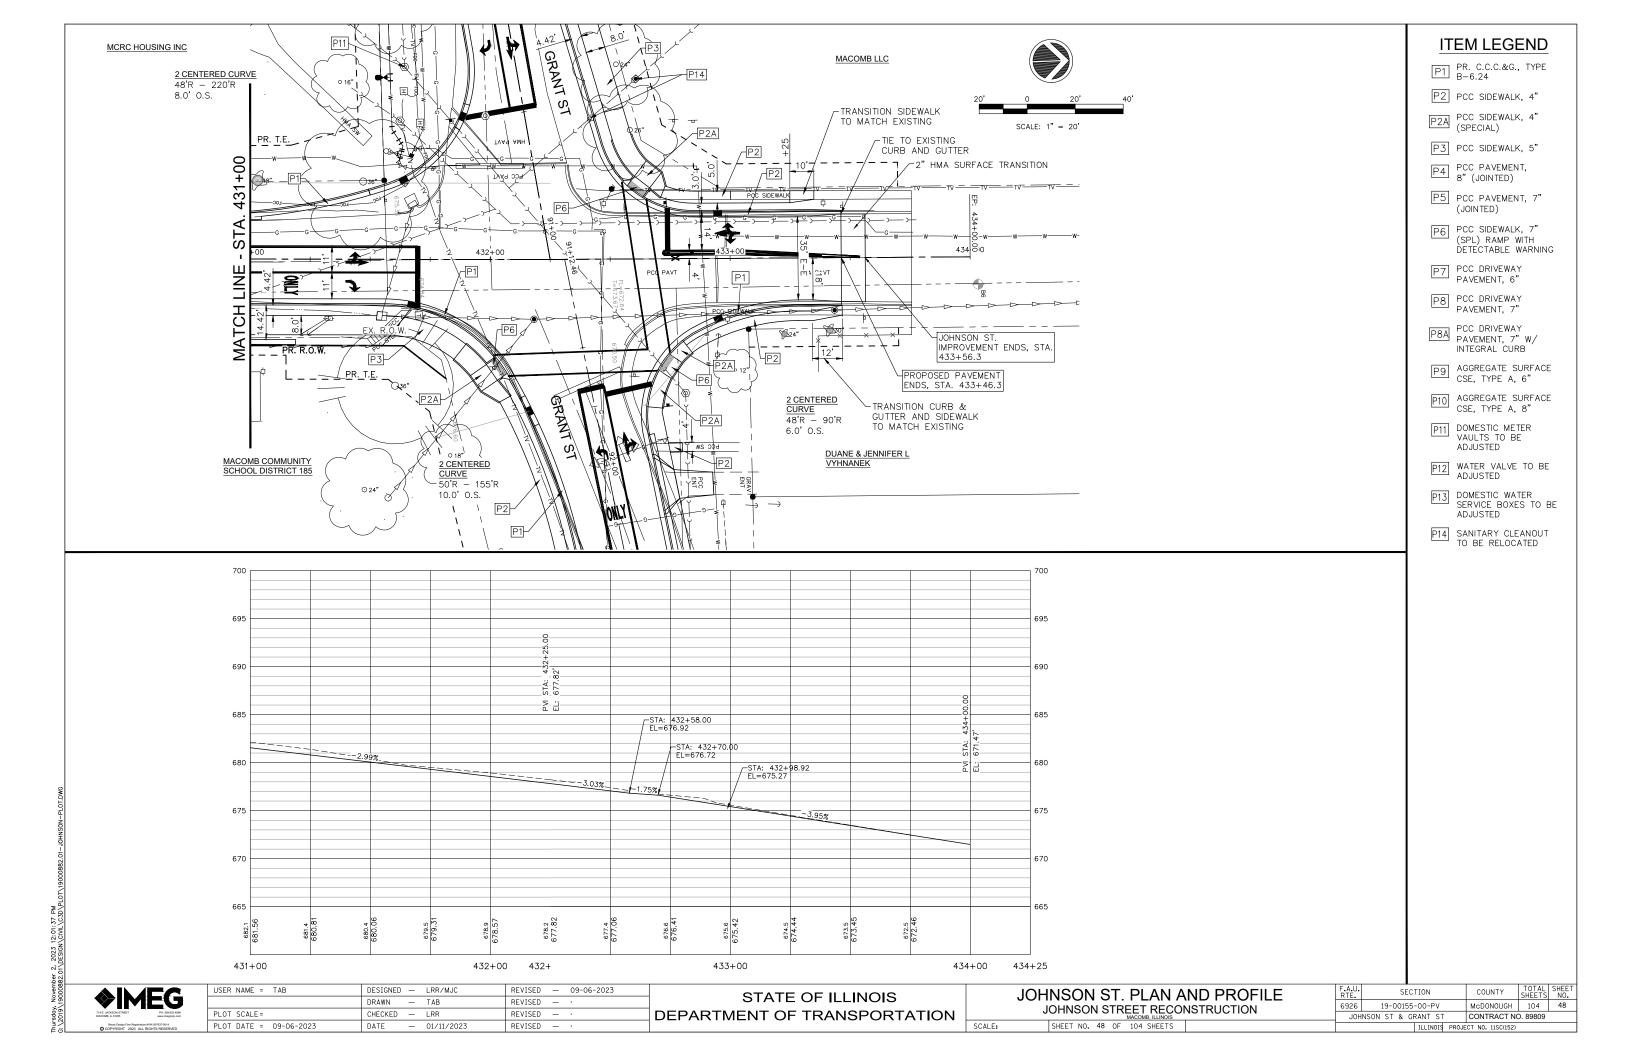

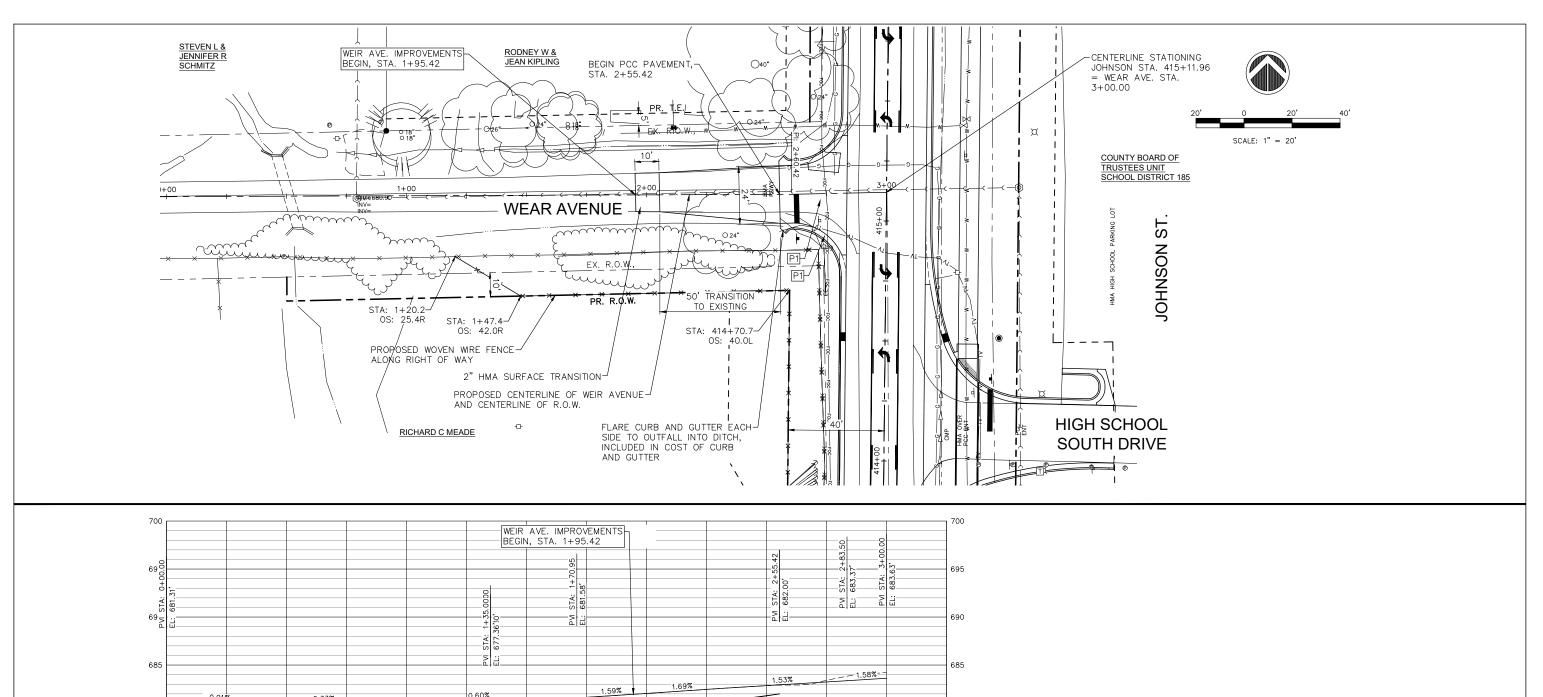

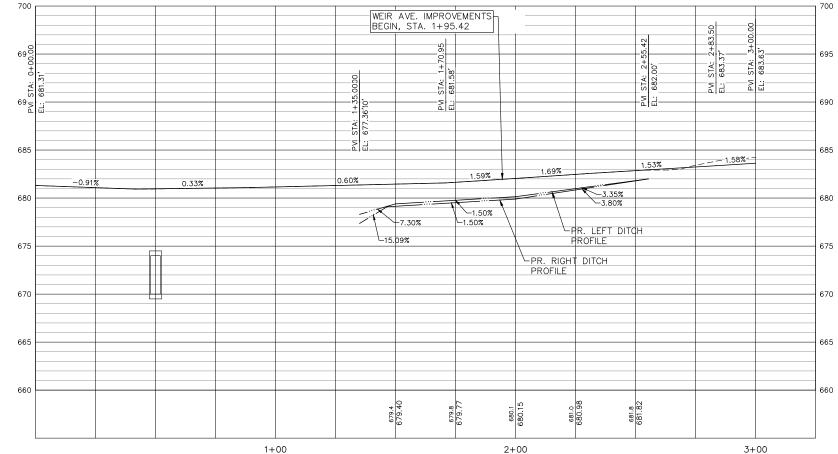



**IMEG** 


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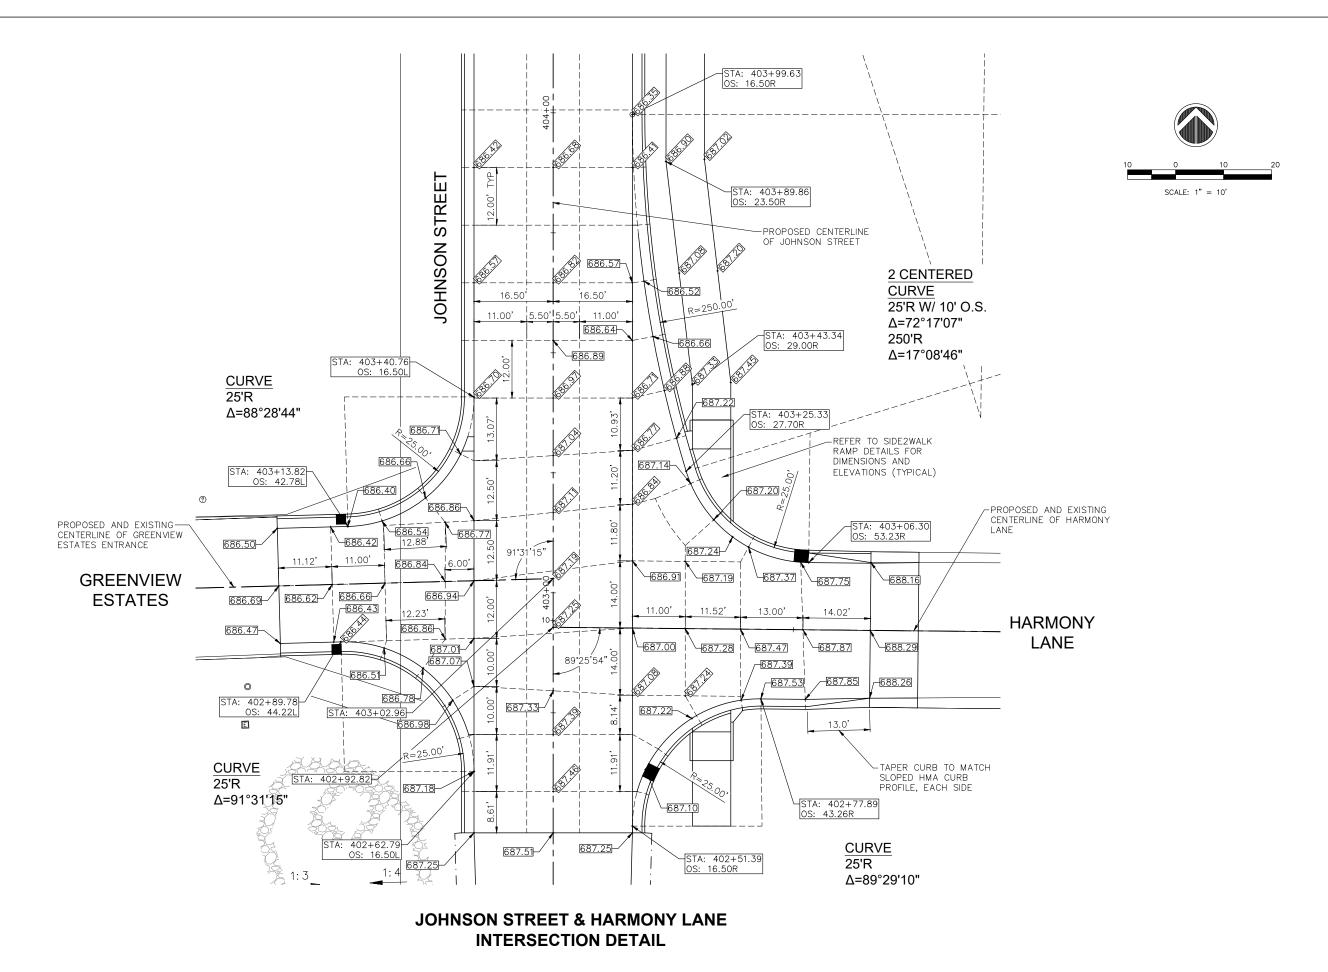
STATE OF ILLINOIS **DEPARTMENT OF TRANSPORTATION**  WEIR AVE. PLAN AND PROFILE JOHNSON STREET RECONSTRUCTION SHEET NO. 49 OF 104 SHEETS

19-00155-00-PV McDONOUGH 104 49 JOHNSON ST & GRANT ST CONTRACT NO. 89809



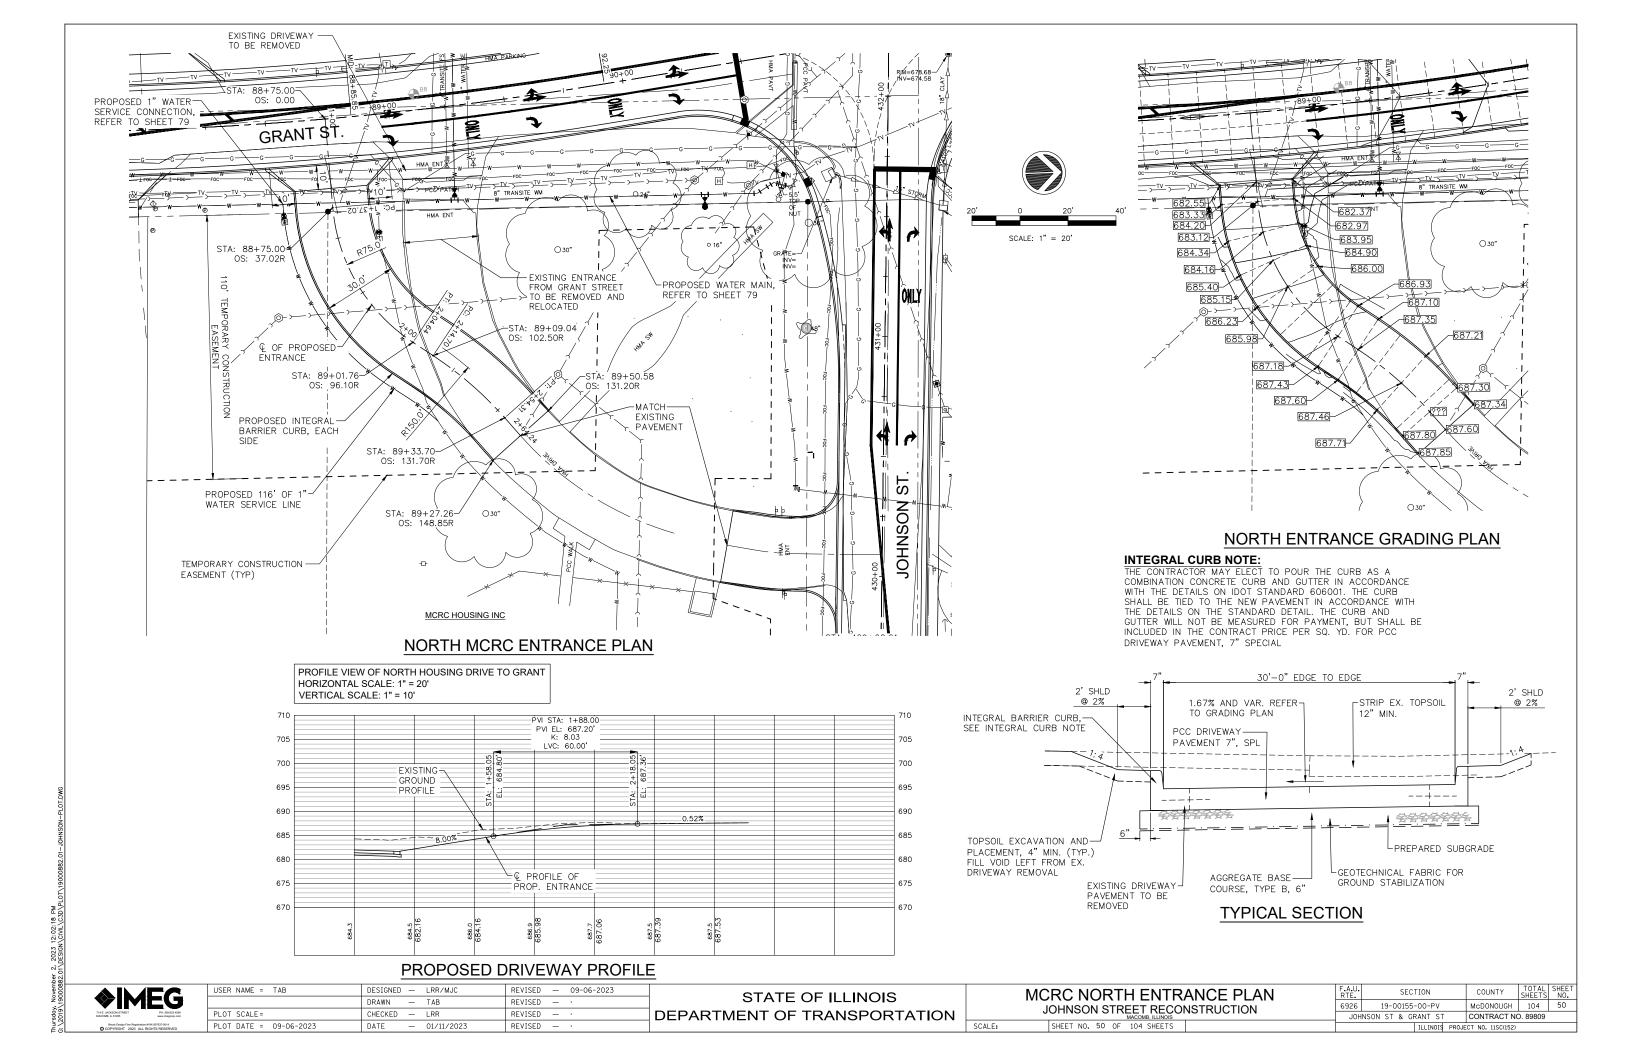

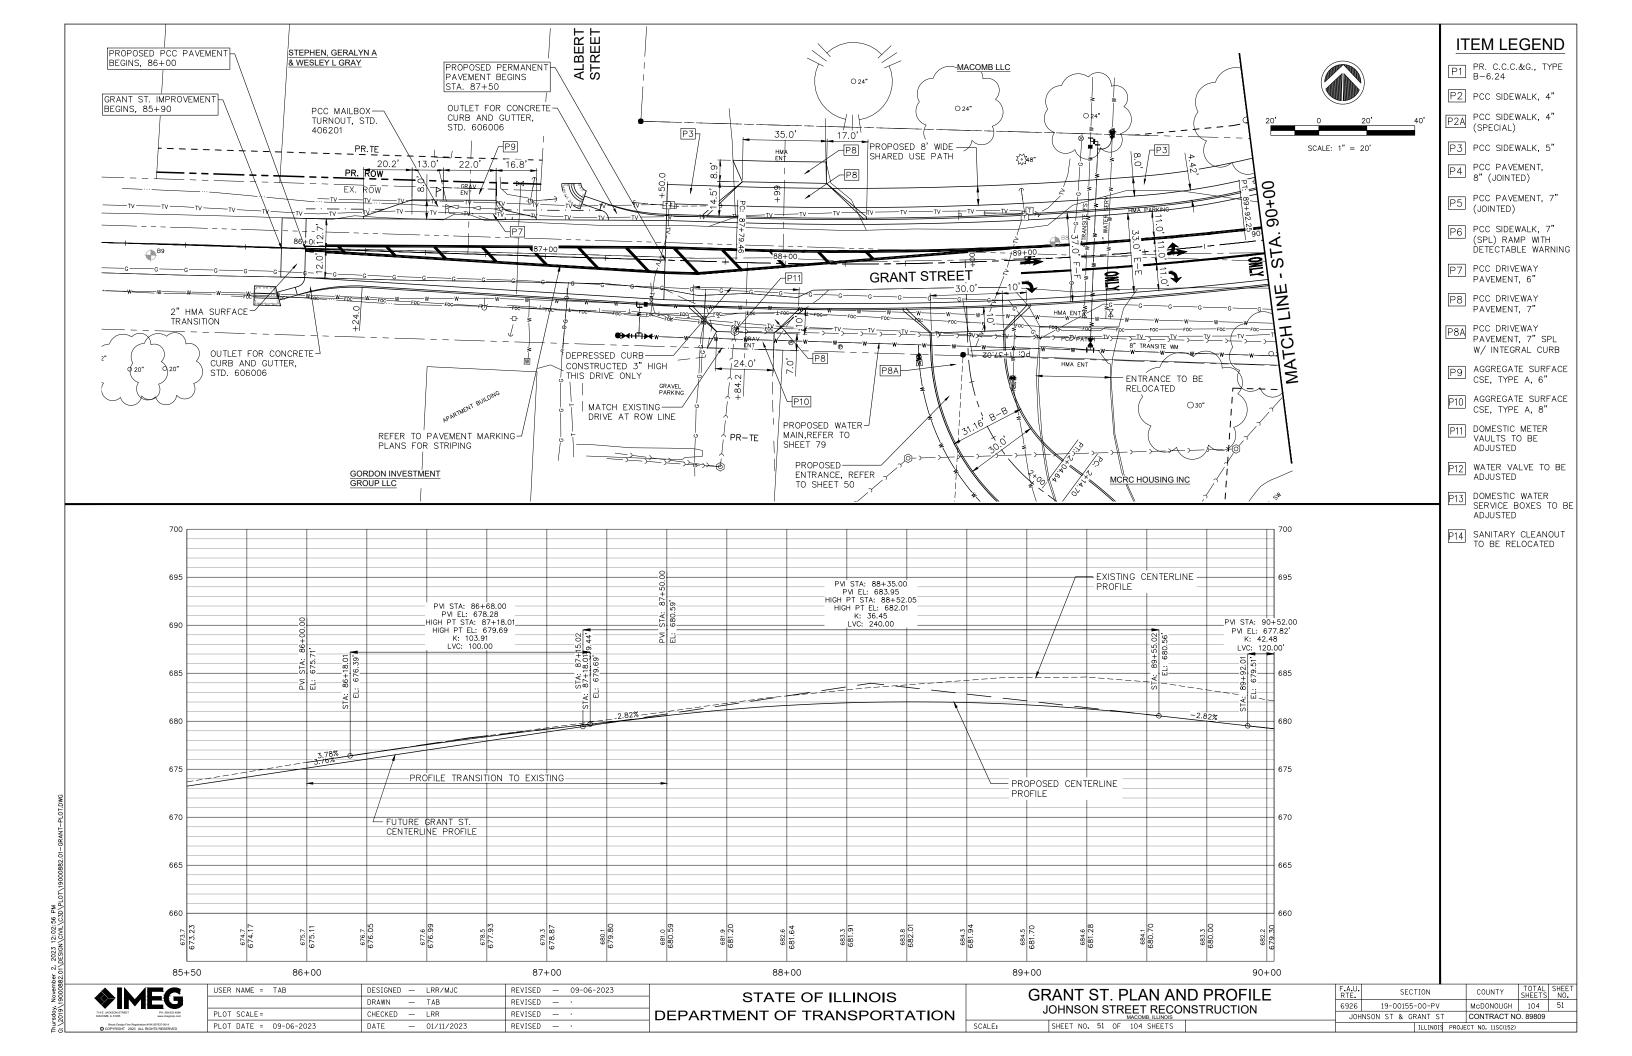


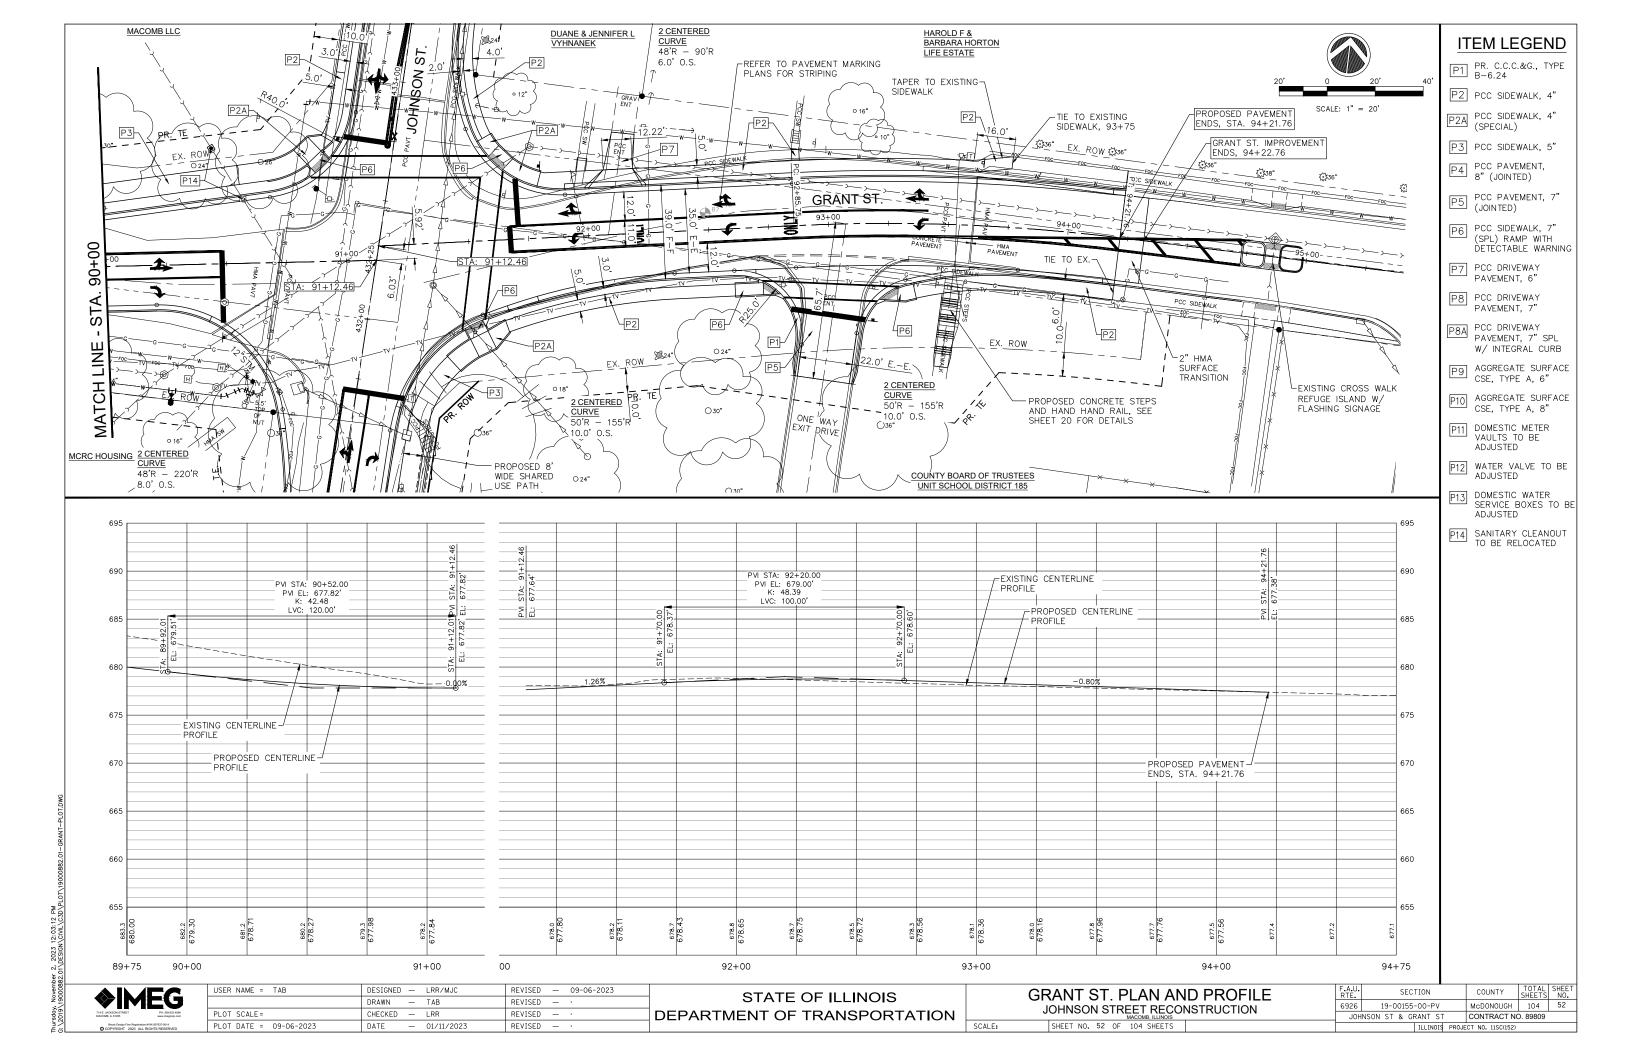



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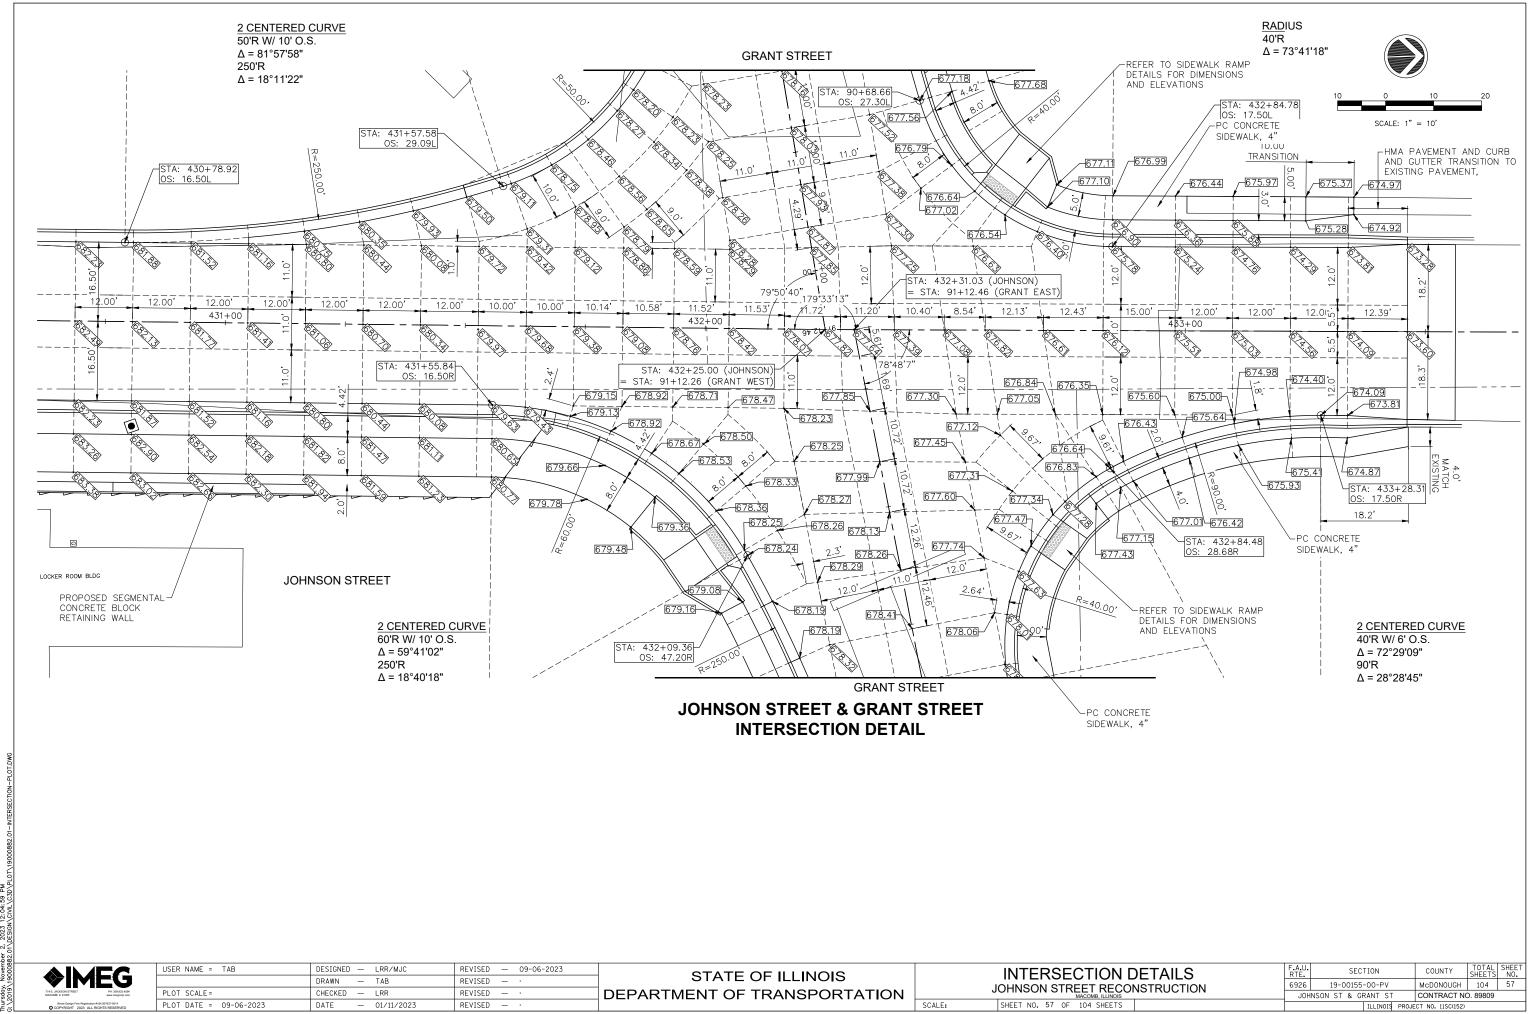
STATE OF ILLINOIS
DEPARTMENT OF TRANSPORTATION


INTERSECTION DETAILS
JOHNSON STREET RECONSTRUCTION
MACOMB, ILLINOIS
SHEET NO. 53 OF 104 SHEETS




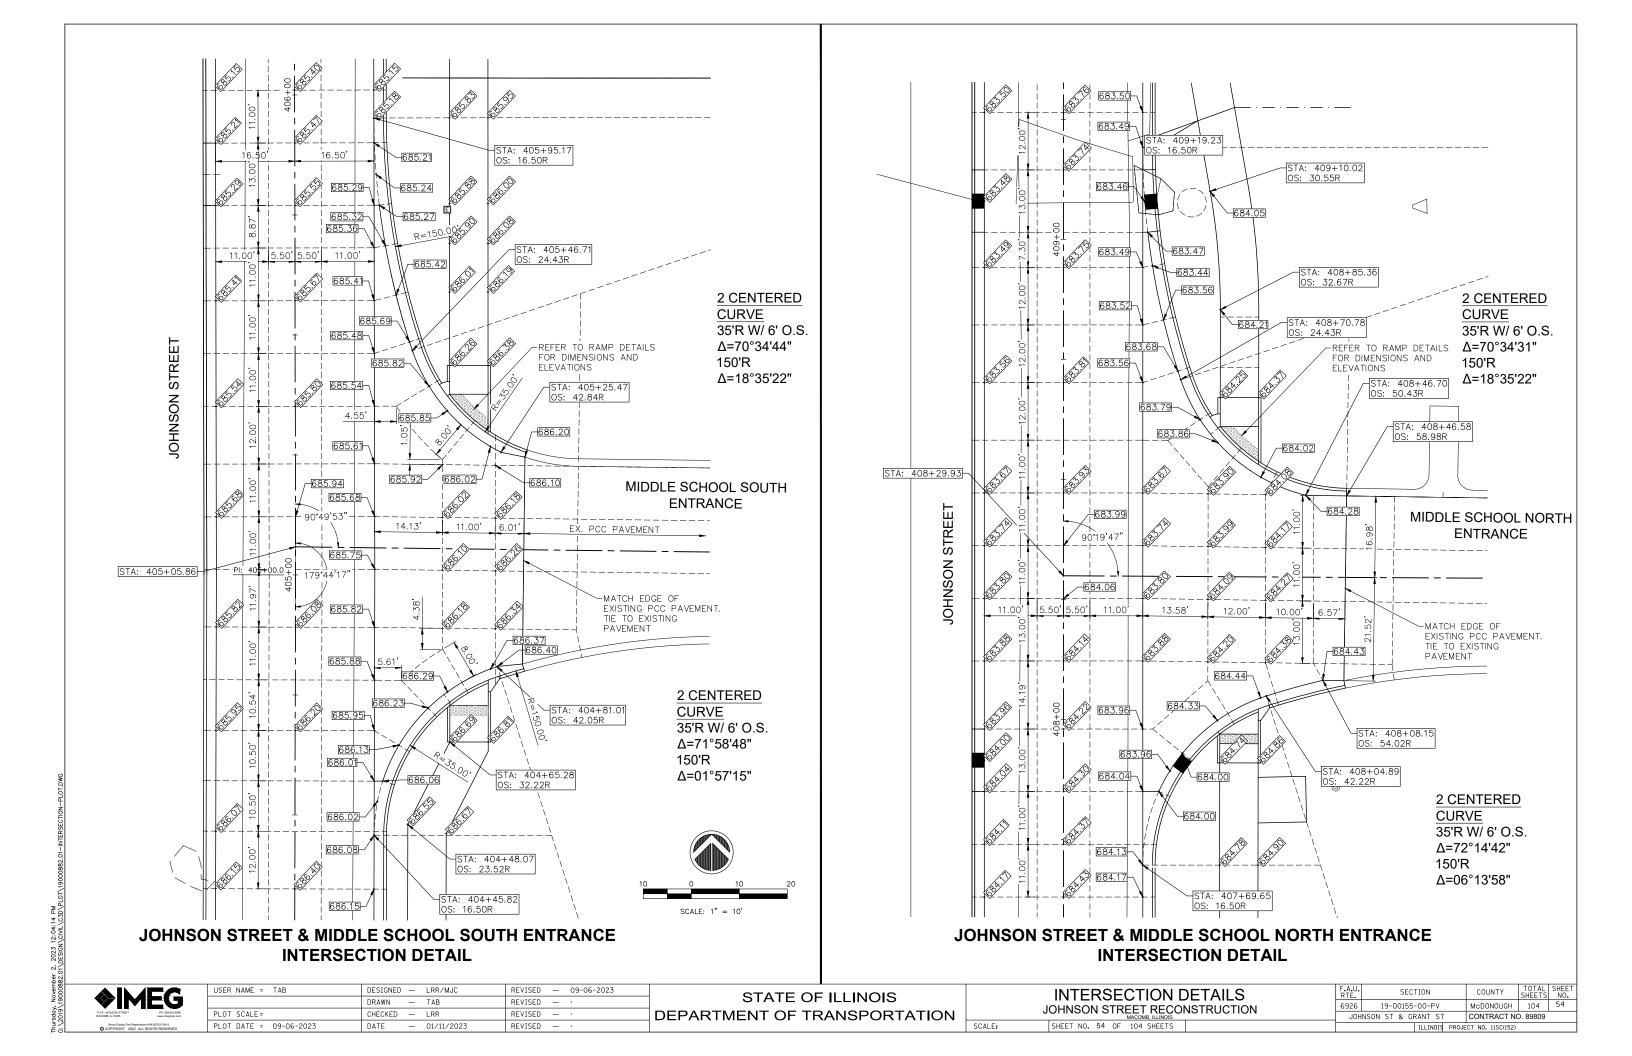

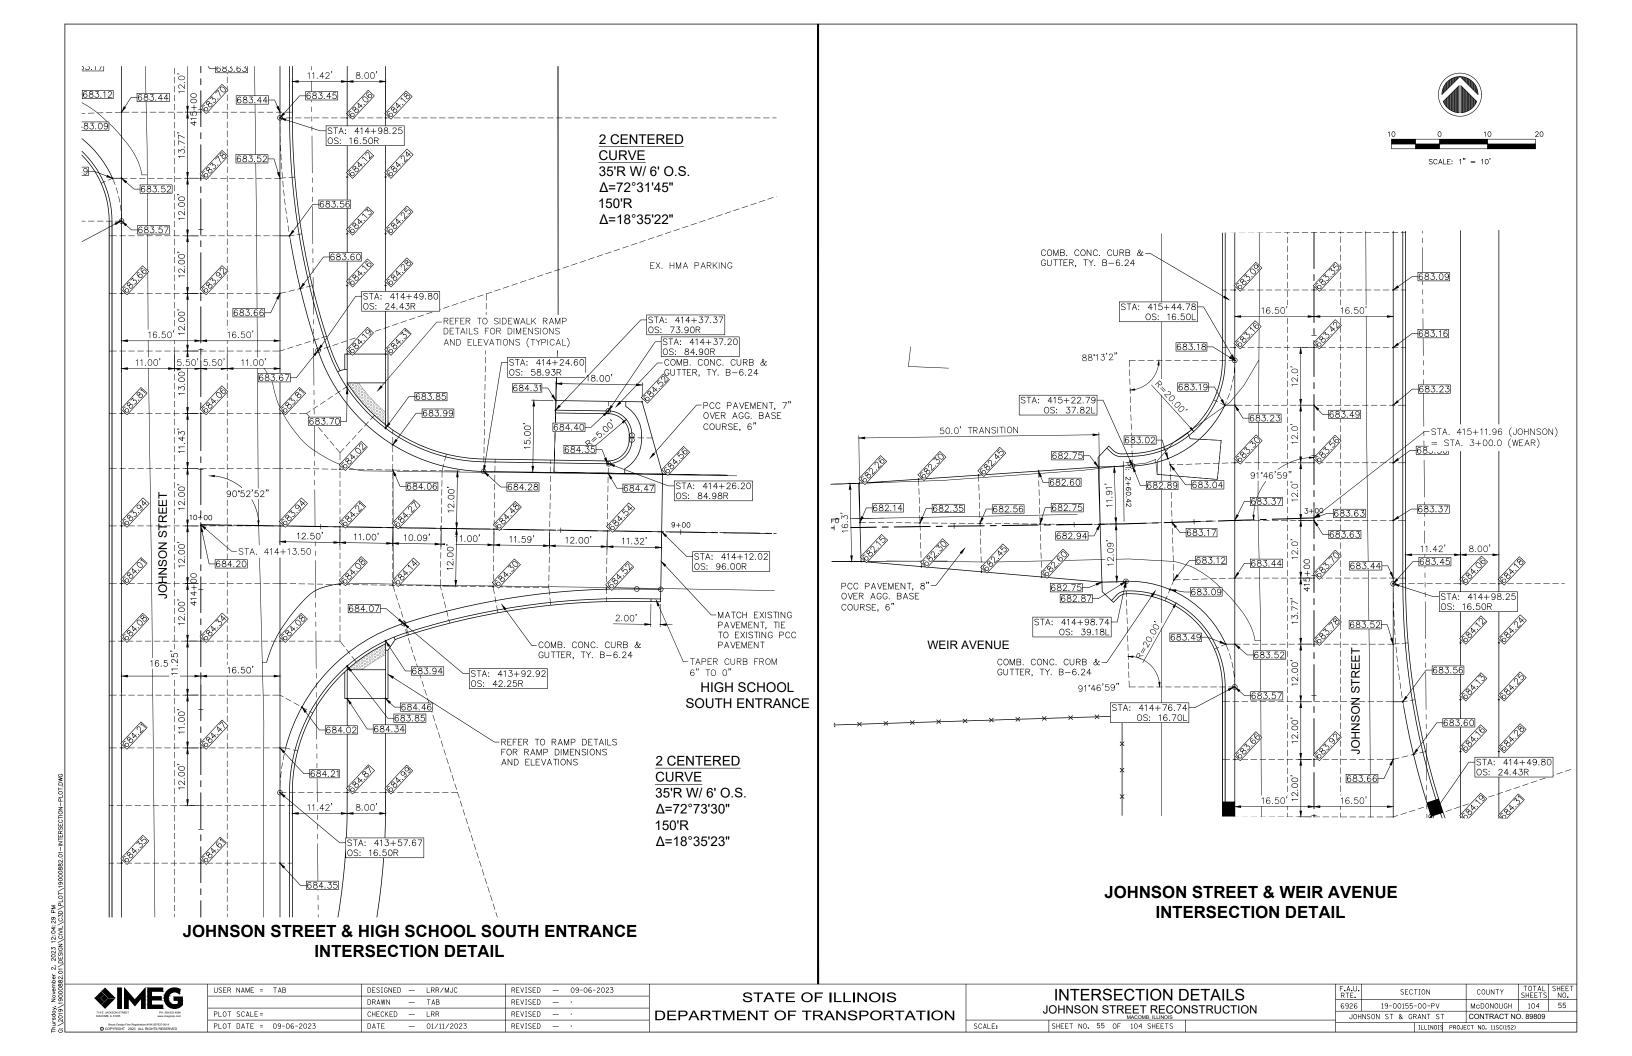

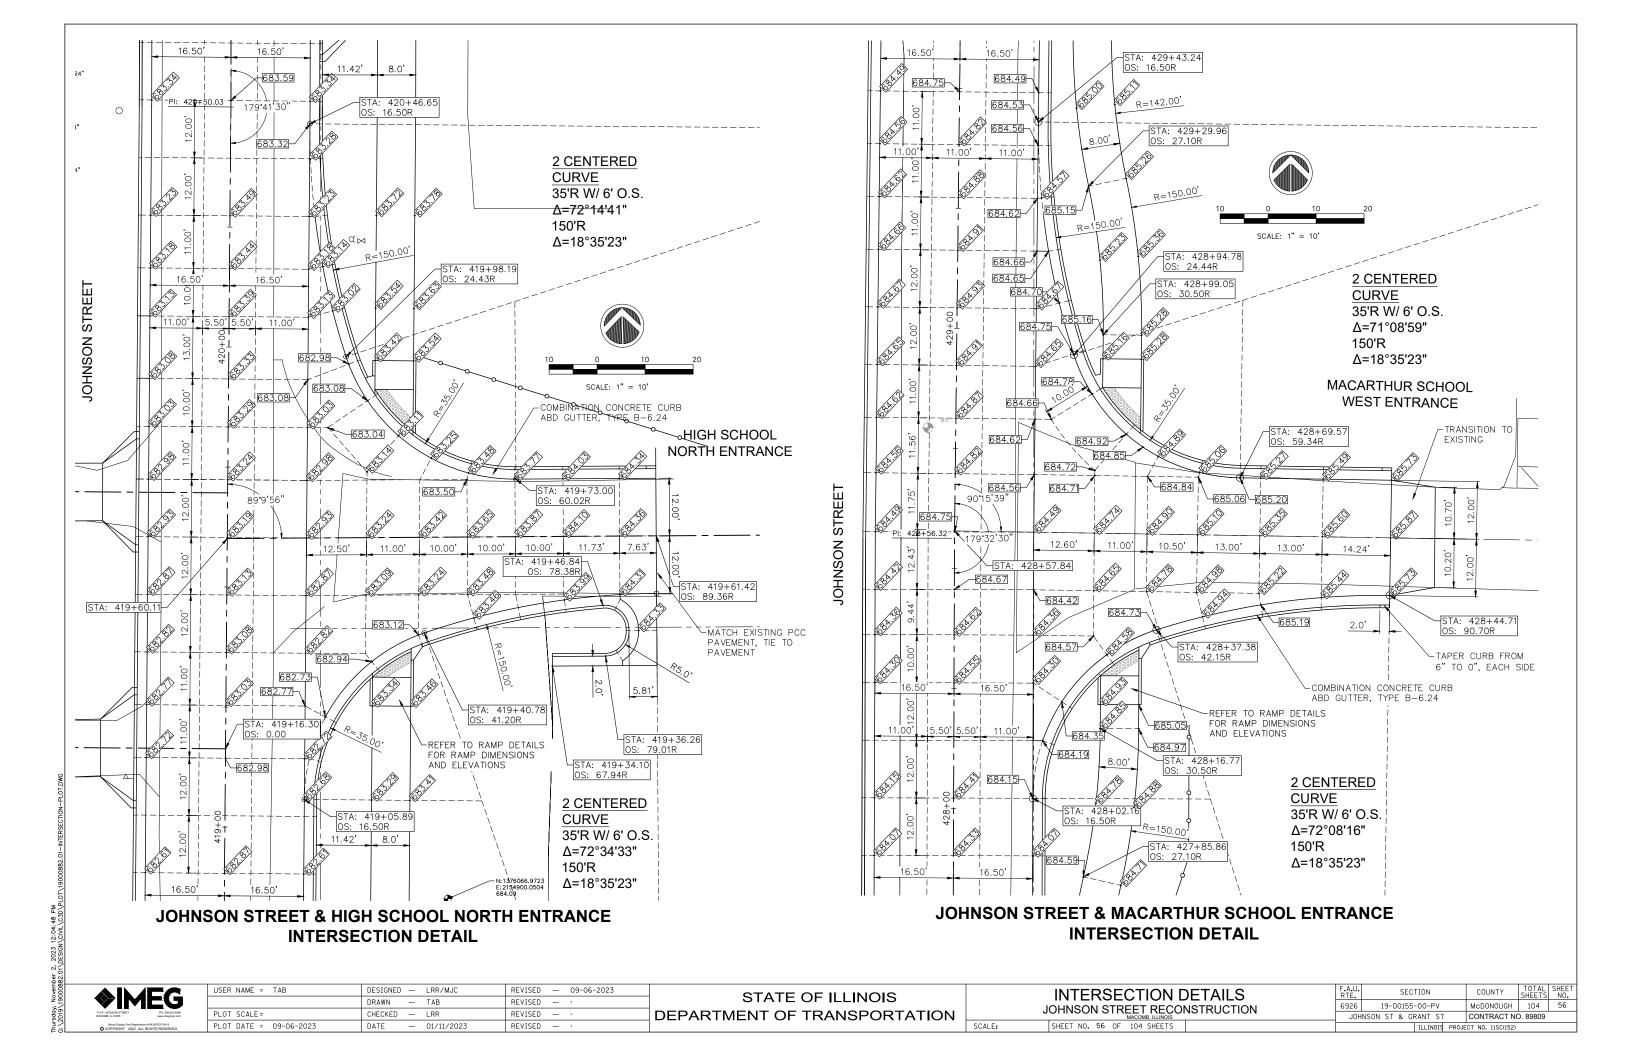

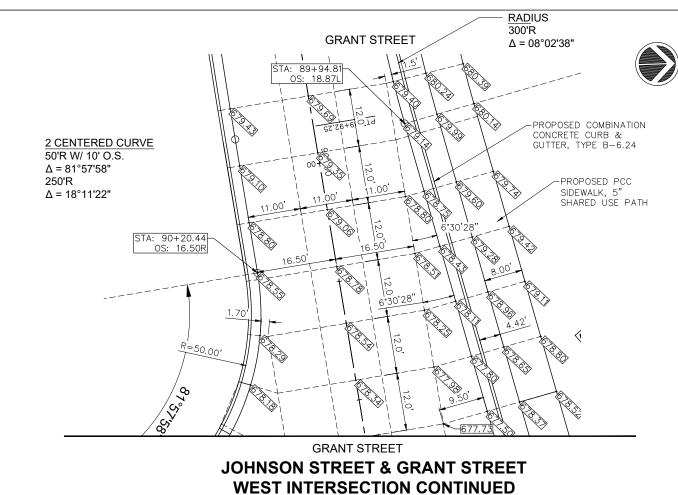

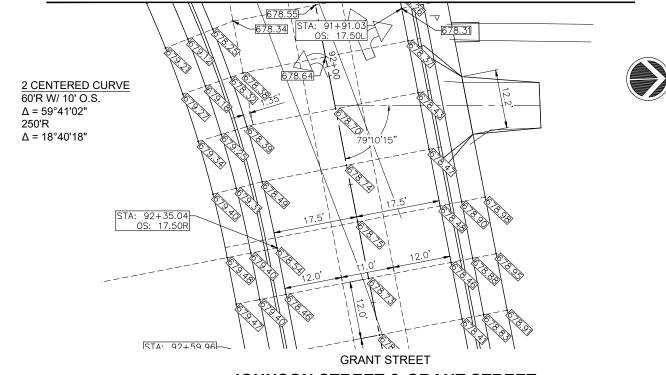

CURVE CURVE TIE TO EXISTING PAVEMENT 25'R W/ 5' O.S. 25'R AND CURB & GUTTER STA: 92+95.52 OS: 64.69F Δ= 67°58'51" Δ= 101°04'13" 150'R Δ= 17°48'17" GRANT STREET **GRANT STREET & NORTH McARTHUR** SCHOOL DR. INTERSECTION DETAIL **JOHNSON STREET & GRANT STREET EAST INTERSECTION CONTINUED** USER NAME = TAB DESIGNED — LRR/MJC REVISED — 09-06-2023 INTERSECTION DETAILS STATE OF ILLINOIS DRAWN — TAB REVISED -19-00155-00-PV McDONOUGH 104 58 JOHNSON STREET RECONSTRUCTION PLOT SCALE = CHECKED — LRR REVISED **DEPARTMENT OF TRANSPORTATION** JOHNSON ST & GRANT ST CONTRACT NO. 89809 SHEET NO. 58 OF 104 SHEETS PLOT DATE = 09-06-2023 DATE - 01/11/2023 REVISED

STA: 92+59.96-OS: 17.50R

REFER TO RAMP DETAILS -FOR DIMENSIONS AND

ELEVATIONS

678.63 678.68

STA: 92+86.50 OS: 49.68R

678.86

10.80

10.91

SCALE: 1" = 10'

STA: 93+32.36

STA: 93+11.05

OS: 45.65R

STA: 93+80.29 OS: 17.50R

└PROPOSED 6' WIDE PCC SIDEWALK, 4"

ADJACENT TO BOC

-PROPOSED COMB.

2 CENTERED

CONC. CURB AND GUTTER TYPE B-6.24

### JOHNSON STREET SIDEWALK COMPLIANCE TABLE at HARMONY LANE

Point	Station	Offset FEET	Elevation FEET	Point to Point		Sidewalk Designation	,,,,,,,,,,,,,,,,,,,,,,,,,,,,,,,,,,,,,,,	Δ Elevation	Slope	Legally Acceptable Range	Remarks
							FT	FT	%	Pos. or Neg.	
	HARMONYLA										
101	402+71.04	29.00	687.20	101	102	Crosswalk Cross Slope - Yield Condition	8.95	0.08	0.9%	0.0% to 2.0%	
102	402+74.93	37.00	687.28	102	103	Landing/Turning Space	3.89	0.04	1.0%	0.1% to 2.0%	
103	402+71.04	37.00	687.32	103	104	Ramp Running Slope	6.00	0.45	7.5%	0.5% to 8.3%	
104	402+65.04	37.00	687.77	104	105	Landing/Turning Space	13.64	0.17	1.2%	0.1% to 2.0%	
105	402+51.39	37.00	687.94	105	106	Sidewalk Cross Slope	8.00	-0.12	-1.5%	0.5% to 2.0%	
106	402+51.39	29.00	687.82	106	107	Landing/Turning Space	13.64	-0.17	-1.2%	0.1% to 2.0%	
107	402+65.04	29.00	687.65	107	101	Ramp Running Slope	6.00	-0.45	-7.5%	0.5% to 8.3%	
				103	101	Ramp Cross Slope	8.00	-0.12	-1.5%	0.1% to 2.0%	
				104	107	Ramp Cross Slope	8.00	-0.12	-1.5%	0.1% to 2.0%	
	HARMONY LA	ANERT, SES	SIDE:								
121	403+15.29	37.00	687.25	121	122	Crosswalk Cross Slope - Yield Condition	16.99	-0.14	-0.8%	0.0% to 2.0%	
122	403+29.98	29.00	687.11	122	123	Ramp Running Slope	6.00	0.27	4.5%	0.5% to 8.3%	
123	403+35.98	29.00	687.38	123	124	Ramp Cross Slope	8.00	0.12	1.5%	0.1% to 2.0%	
124	403+35.98	37.00	687.50	124	125	Ramp Running Slope	6.00	-0.25	-4.2%	0.5% to 8.3%	
125	403+29.98	37.00	687.25	125	121	Landing/Turning Space	14.69	0.00	0.0%	0.1% to 2.0%	
				122	125	Ramp Cross Slope	8.00	0.14	1.7%	0.1% to 2.0%	
126	403+40.98	29.00	687.36	123	126	Landing/Turning Space	5.00	-0.02	-0.4%	0.1% to 2.0%	
127	403+40.98	37.00	687.48	124	127	Landing/Turning Space	5.95	-0.02	-0.3%	0.1% to 2.0%	
				126	127	Sidewalk Cross Slone	8.00	0.12	1 5%	0.5% to 2.0%	

### **GENERAL NOTES:**

- 1. ALL SPOT GRADES ARE TOP / EDGE OF PAVEMENT, SIDEWALK BREAKS, TOP / EDGE OF SIDEWALK, AND TOP OF DRIVEWAYS UNLESS NOTED OTHERWISE.
- 2. ALL ADA RAMPS SHALL HAVE A 1/2" DEPRESSED CURB AND 5% MAX GUTTER SLOPE PER STANDARD 606001.
- 3. INCLUDE ALL COST FOR 6" WIDE CONCRETE SIDEWALK SIDE CURBS IN THE SIDEWALK UNIT PRICE BID AND NO ADDITIONAL COMPENSATION WILL BE ALLOWED.
- 4. LANDING (UPPER & LOWER) AND TURNING AREAS ARE DESIGNATED WITH A "L".



### LEGEND:

—ADA = PROPOSED ADA DEPRESSED CURB

SSC = PROPOSED 6" WIDE CONC

R = PROPOSED RAMP L = PROPOSED LANDING


SIDEWALK ELEVATION POINT LOCATION & NUMBER

SIDEWALK SIDE CURB

PAVEMENT ELEVATION POINT & ELEVATION

---- = GRADE REFERENCE LINE

1.00% SLOPE

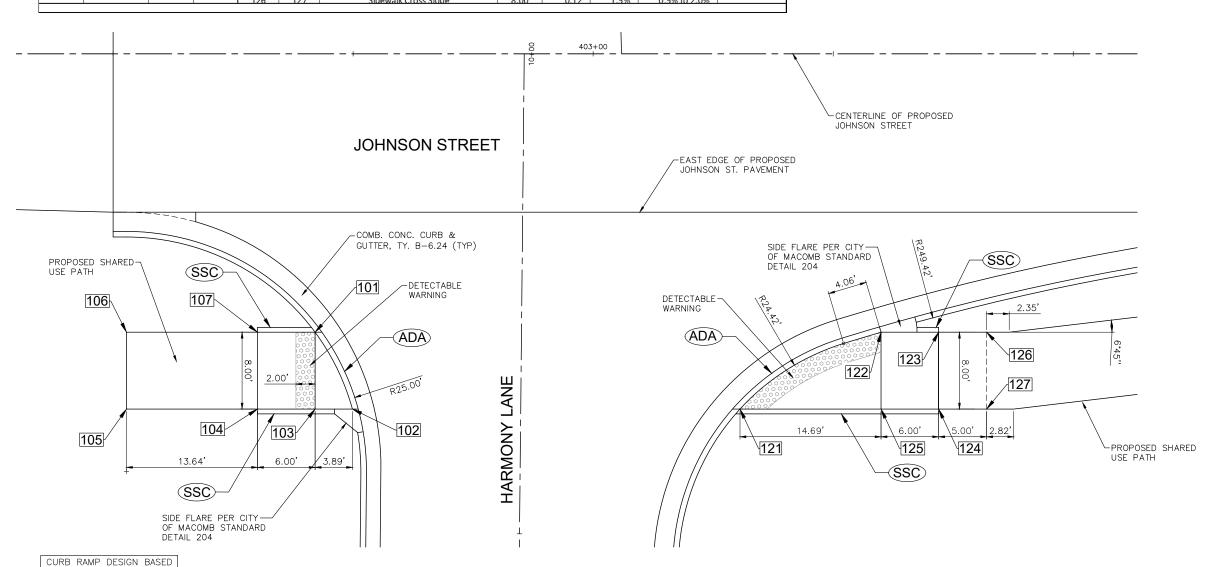

ON STANDARD 424001 HARMONY LANE = STOP CONDITION JOHNSON STREET = FREE FLOW

### **PAVEMENT & SIDEWALK ELEVATIONS** STA. 402+93, JOHNSON STREET & HARMONY LANE INTERSECTION

**IMEG** 

USER NAME = TAB	DESIGNED — LRR/MJC	REVISED — 09-06-2023	
	DRAWN — TAB	REVISED — ·	
PLOT SCALE =	CHECKED — LRR	REVISED - ·	DEF
PLOT DATE = 09-06-2023	DATE - 01/11/2023	REVISED - ·	

STATE OF ILLINOIS PARTMENT OF TRANSPORTATION

			Α	DA	A D	<b>ETA</b>	II	LS
J	OHN	SO	N S			RECC	10	NSTRUCTION
	CHEET	NO	50	ΛE	104	CHEETS		


F.A.U. RTE.	SEC.	TION		COUNTY	TOTAL SHEETS	SHEE'
6926	19-00155	-00-PV		McD0N0UGH	59	
JOH	NSON ST & GF	RANT ST	CONTRACT NO	D. 89809		
		ILLINOIS	PROJE	CT NO. 11SC(152)		

at MIDDLE SCHOOL SOUTH ENTRANCE

Point	Station	Offset FEET	Elevation FEET	Point t	o Point	Sidewalk Designation	Distance*	Δ Elevation	Slope %	Legally Acceptable Range Pos. or Neg.	Remarks
	MIDDLESCHO	OL SOUTH	ENTRANCE	IT. SW SID	F				/0	FUS. OF INCE.	
MIDDLE SCHOOL SOUTH ENTRANCE LT. SW SIDE  201 404+72.86 32.20' 686.24 201 202 Crosswalk Cross Slope - Yield Condition								0.10	1.1%	0.0% to 2.0%	
202	404+77.56	40.19'	686.34	202	203	Landing/Turning Space	9.30 4.68	0.02	0.4%	0.1% to 2.0%	
203	404+72.89	40.20'	686.36	203	204	Ramp Running Slope	7.58	0.45	5.9%	0.5% to 8.3%	
204	404+65.30	40.22'	686.81	204	205	Ramp Cross Slope	8.00	-0.12	-1.5%	0.1% to 2.0%	
205	404+65.28	32.22'	686.69	205	201	Ramp Running Slope	7.58	-0.45	-5.9%	0.5% to 8.3%	
				203	201	Ramp Cross Slope	8.00	-0.12	-1.5%	0.1% to 2.0%	
206	404+60.82	29.97	686.75	205	206	Landing/Turning Space	5.00	0.06	1.2%	0.1% to 2.0%	
207	404+57.21	37.11	686.90	204	207	Landing/Turning Space	8.84	0.09	1.0%	0.1% to 2.0%	
				206	207	Sidewalk Cross Slope	8.84	0.15	1.7%	0.5% to 2.0%	
						4 17 47 10 10 10 10					
	MIDDLE SCHO										
221	405+30.03	40.16'	685.97	221	222	Crosswalk Cross Slope - Yield Condition	11.04	-0.16	-1.4%	0.0% to 2.0%	
222	405+37.58	32.17'	685.81	222	223	Ramp Running Slope	6.00	0.45	7.5%	0.5% to 8.3%	
223	405+43.58	32.18'	686.26	223	224	Ramp Cross Slope	8.00	0.12	1.5%	0.1% to 2.0%	
224	405+43.57	40.18'	686.38	224	225	Ramp Running Slope	6.00	-0.43	-7.2%	0.5% to 8.3%	
225	405+37.57	40.17'	685.95	225	221	Landing/Turning Space	7.60	0.02	0.3%	0.1% to 2.0%	
				222	225	Ramp Cross Slope	8.00	0.14	1.8%	0.1% to 2.0%	
226	405+48.58	32.19	686.17	226	223	Landing/Turning Space	5.00	0.09	1.8%	0.1% to 2.0%	
227	405+48.57	40.19	686.29	227	224	Landing/Turning Space	5.00	0.09	1.8%	0.1% to 2.0%	
				226	227	Sidewalk Cross Slope	8.00	0.12	1.5%	0.5% to 2.0%	


### GENERAL NOTES:

- 1. ALL SPOT GRADES ARE TOP / EDGE OF PAVEMENT, SIDEWALK BREAKS, TOP / EDGE OF SIDEWALK, AND TOP OF DRIVEWAYS UNLESS NOTED OTHERWISE.
- 2. ALL ADA RAMPS SHALL HAVE A 1/2" DEPRESSED CURB AND 5% MAX GUTTER SLOPE PER STANDARD 606001.
- 3. INCLUDE ALL COST FOR 6" WIDE CONCRETE SIDEWALK SIDE CURBS IN THE SIDEWALK UNIT PRICE BID AND NO ADDITIONAL COMPENSATION WILL BE ALLOWED.
- 4. LANDING (UPPER & LOWER) AND TURNING AREAS ARE DESIGNATED WITH A "L".

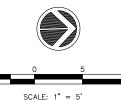

### LEGEND:

—ADA = PROPOSED ADA DEPRESSED CURB

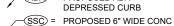


SIDEWALK SIDE CURB R = PROPOSED RAMP

L = PROPOSED LANDING SIDEWALK ELEVATION POINT

LOCATION & NUMBER PAVEMENT ELEVATION

POINT & ELEVATION = GRADE REFERENCE LINE

1.00% SLOPE

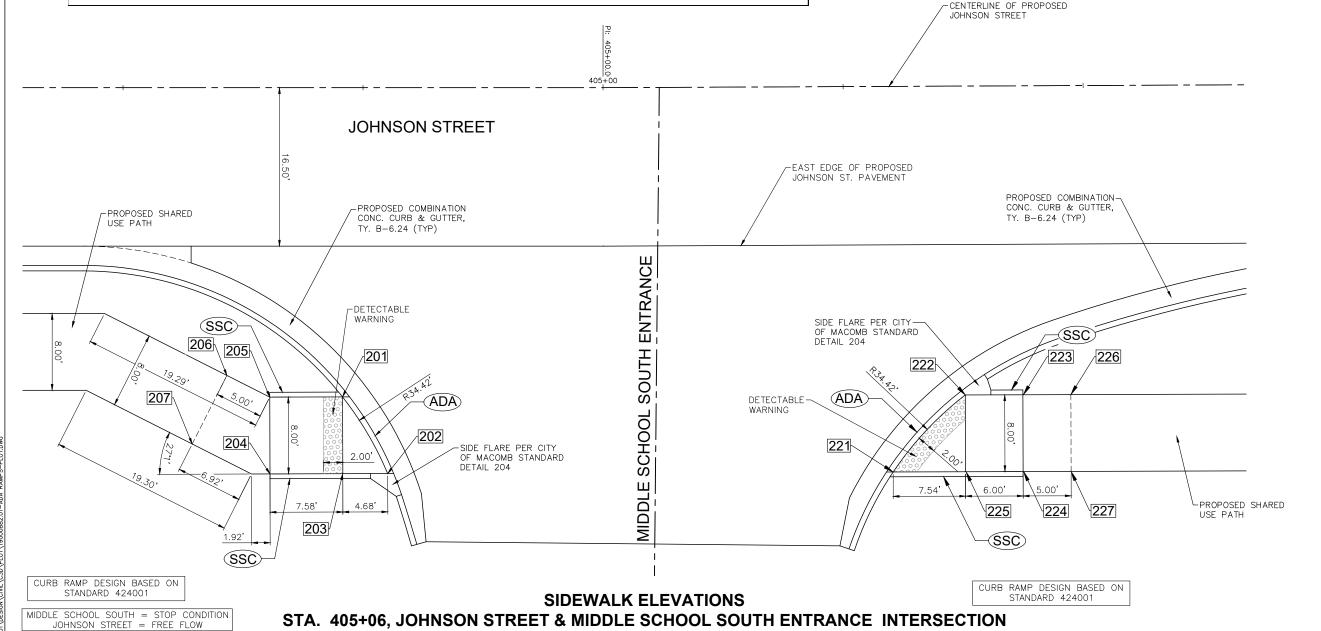

USER NAME = TAB DESIGNED — LRR/MJC REVISED — 09-06-2023 STATE OF ILLINOIS DRAWN — TAB REVISED -PLOT SCALE = CHECKED — LRR REVISED DEPARTMENT OF TRANSPORTATION PLOT DATE = 09-06-2023 DATE - 01/11/2023 REVISED

**ADA DETAILS** JOHNSON STREET RECONSTRUCTION SHEET NO. 60 OF 104 SHEETS


19-00155-00-PV McDONOUGH 104 60 JOHNSON ST & GRANT ST CONTRACT NO. 89809

at MIDDLE SCHOOL NORTH ENTRANCE

Point	Station	Offset FEET	Elevation FEET	Point t	Point to Point Sidewalk Designation		Distance*	Δ Elevation	Slope %	Legally Acceptable Range Pos. or Neg.	Remarks		
MIDDLE SCHOOL NORTH ENTRANCE LT. SW SIDE													
301	407+96.95	32.54	684.29	301	302	Crosswalk Cross Slope - Yield Condition	9.25	0.08	0.9%	0.0% to 2.0%			
302	408+01.54	40.55	684.37	302	303	Landing/Turning Space	4.60	0.04	0.9%	0.1% to 2.0%			
303	407+96.94	40.54	684.41	303	304	Ramp Running Slope	6.00	0.45	7.5%	0.5% to 8.3%			
304	407+90.93	40.52	684.86	304	305	Ramp Cross Slope	8.00	-0.12	-1.5%	0.1% to 2.0%			
305	407+90.94	32.53	684.74	305	301	Ramp Running Slope	6.00	-0.45	-7.5%	0.5% to 8.3%			
306	407+85.95	32.53	684.82	305	306	Landing/Turning Space	5.00	0.08	1.6%	0.1% to 2.0%			
307	407+85.94	40.53	684.94	304	307	Landing/Turning Space	5.00	0.08	1.6%	0.1% to 2.0%			
				306	307	Sidewalk Cross Slope	8.00	0.12	1.5%	0.5% to 2.0%			
				303	301	Ramp Cross Slope	8.00	-0.12	-1.5%	0.1% to 2.0%			
							715		10 10				
	MIDDLE SCHO												
321	408+53.80	40.62	683.92	321	322	Crosswalk Cross Slope - Yield Condition	10.84	-0.12	-1.1%	0.0% to 2.0%			
322	408+61.06	32.63	683.80	322	323	Ramp Running Slope	6.00	0.45	7.5%	0.5% to 8.3%			
323	408+67.06	32.64	684.25	323	324	Ramp Cross Slope	8.00	0.12	1.5%	0.1% to 2.0%			
324	408+67.05	40.64	684.37	324	325	Ramp Running Slope	6.00	-0.43	-7.2%	0.5% to 8.3%			
325	408+61.05	40.63	683.94	325	321	Landing/Turning Space	7.25	-0.02	-0.3%	0.1% to 2.0%			
326	408+72.06	32.65	684.33	323	326	Landing/Turning Space	5.00	0.08	1.6%	0.1% to 2.0%			
327	408+72.05	40.65	684.45	324	327	Landing/Turning Space	5.00	0.08	1.6%	0.1% to 2.0%			
				326	327	Sidewalk Cross Slope	8.00	0.12	1.5%	0.5% to 2.0%			
				322	325	Ramp Cross Slope	8.00	0.14	1.8%	0.1% to 2.0%			

### **GENERAL NOTES:**

- 1. ALL SPOT GRADES ARE TOP / EDGE OF PAVEMENT, SIDEWALK BREAKS, TOP / EDGE OF SIDEWALK, AND TOP OF DRIVEWAYS UNLESS NOTED OTHERWISE.
- 2. ALL ADA RAMPS SHALL HAVE A 1/2" DEPRESSED CURB AND 5% MAX GUTTER SLOPE PER STANDARD 606001.
- 3. INCLUDE ALL COST FOR 6" WIDE CONCRETE SIDEWALK SIDE CURBS IN THE SIDEWALK UNIT PRICE BID AND NO ADDITIONAL COMPENSATION WILL BE ALLOWED.
- 4. LANDING (UPPER & LOWER) AND TURNING AREAS ARE DESIGNATED WITH A "L".

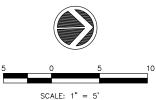

### LEGEND:

—ADA = PROPOSED ADA DEPRESSED CURB

SSC = PROPOSED 6" WIDE CONC SIDEWALK SIDE CURB


> R = PROPOSED RAMP L = PROPOSED LANDING

SIDEWALK ELEVATION POINT LOCATION & NUMBER

PAVEMENT ELEVATION POINT & ELEVATION

= GRADE REFERENCE LINE

1.00% SLOPE

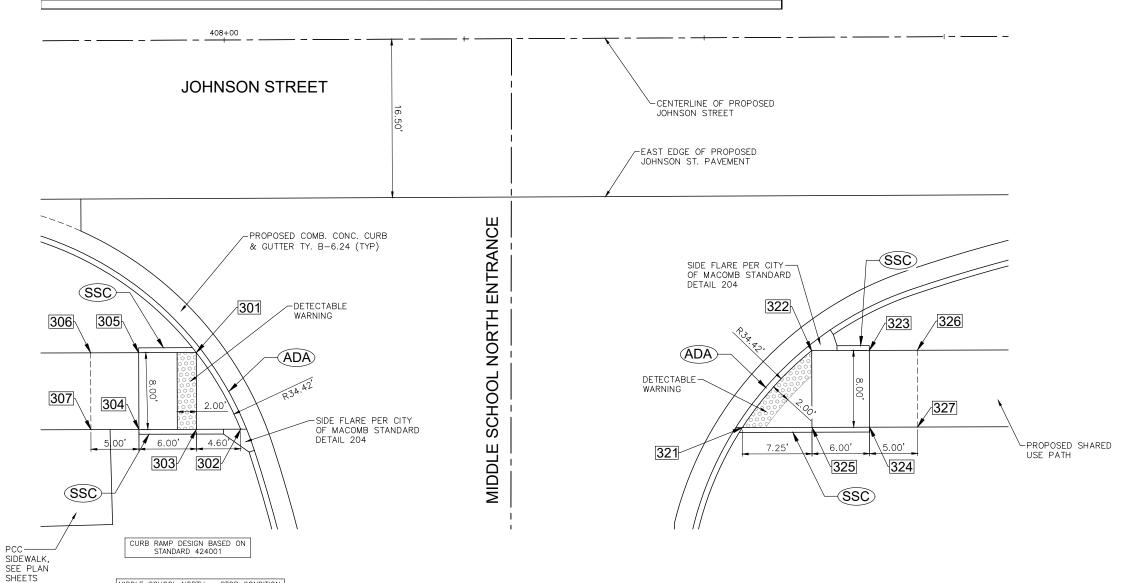

### **PAVEMENT & SIDEWALK ELEVATIONS** STA. 408+30, JOHNSON STREET & MIDDLE SCHOOL NORTH ENTRANCE INTERSECTION



MIDDLE SCHOOL NORTH = STOP CONDITION JOHNSON STREET = FREE FLOW

USER NAME = TAB	DESIGNED — LRR/MJC	REVISED — 09-06-2023	
	DRAWN — TAB	REVISED - ·	
PLOT SCALE =	CHECKED — LRR	REVISED — ·	DEPAR
PLOT DATE = 09-06-2023	DATE - 01/11/2023	REVISED — ·	

STATE OF ILLINOIS RTMENT OF TRANSPORTATION


			Α	DA	A D	<b>ETAI</b>	LS
J	OHNS	SOI	N S	TR		RECO	NSTRUCTION
	CHEET	NO	61	ΛE	104	CHEETS	

F.A.U. RTE.	SEC.	TION		COUNTY	TOTAL SHEETS	SHEE NO.
6926	19-00155-	-00-PV		McD0N0UGH	104	61
JOH	INSON ST & GF	RANT ST		CONTRACT NO	D. 89809	
		ILLINOIS	PROJE	CT NO. 11SC(152)		

Point	Station	Offset FEET	Elevation FEET	Point t	o Point	Sidewalk Designation	Distance*	Δ Elevation	Slope	Legally Acceptable Range	Remarks
								FT	%	Pos. or Neg.	
HIGH SCHOOL SOUTH ENTRANCE LT, SW SIDE:											
401	413+83.28	683.89	402	Crosswalk Cross Slope - Yield Condition	9.67	0.09	0.9%	0.0% to 2.0%			
402	413+88.65	38.50	683.98	402	403	Landing/Turning Space	5.37	0.03	0.6%	0.1% to 2.0%	
403	413+83.28	38.50	684.01	403	404	Ramp Running Slope	6.00	0.45	7.5%	0.5% to 8.3%	
404	413+77.28	38.50	684.46	404	405	Ramp Cross Slope	8.00	-0.12	-1.5%	0.1% to 2.0%	
405	413+77.28	30.50	684.34	405	401	Ramp Running Slope	6.00	-0.45	-7.5%	0.5% to 8.3%	
406	413+72.28	30.50	684.42	405	406	Landing/Turning Space	5.00	0.08	1.6%	0.1% to 2.0%	
407	413+72.28	38.50	684.54	404	407	Landing/Turning Space	5.00	0.08	1.6%	0.1% to 2.0%	
				406	407	Sidewalk Cross Slope	8.00	0.12	1.5%	0.5% to 2.0%	
				403	401	Ramp Cross Slope	8.00	-0.12	-1.5%	0.1% to 2.0%	
	HIGH SCHOOL										
421	414+34.32	38.50	683.89	421	422	Crosswalk Cross Slope - Yield Condition	11.90	-0.15	-1.3%	0.0% to 2.0%	
422	414+43.0	30.50	683.74	422	423	Ramp Running Slope	6.00	0.45	7.5%	0.5% to 8.3%	
423	414+49.05	30.50	684.19	423	424	Ramp Cross Slope	8.00	0.12	1.5%	0.1% to 2.0%	
424	414+49.05	38.50	684.31	424	425	Ramp Running Slope	6.00	-0.42	-7.0%	0.5% to 8.3%	
425	414+43.05	38.50	683.89	425	421	Landing/Turning Space	8.73	0.00	0.0%	0.1% to 2.0%	
426	414+54.05	30.50	684.18	423	426	Landing/Turning Space	5.00	-0.01	-0.2%	0.1% to 2.0%	
427	414+54.05	38.50	684.30	424	427	Landing/Turning Space	5.00	-0.01	-0.2%	0.1% to 2.0%	
				426	427	Sidewalk Cross Slope	8.00	0.12	1.5%	0.5% to 2.0%	
				422	425	Ramp Cross Slope	8.00	0.15	1.9%	0.1% to 2.0%	

### GENERAL NOTES:

- 1. ALL SPOT GRADES ARE TOP / EDGE OF PAVEMENT, SIDEWALK BREAKS, TOP / EDGE OF SIDEWALK, AND TOP OF DRIVEWAYS UNLESS NOTED OTHERWISE.
- 2. ALL ADA RAMPS SHALL HAVE A 1/2" DEPRESSED CURB AND 5% MAX GUTTER SLOPE PER STANDARD 606001.
- 3. INCLUDE ALL COST FOR 6" WIDE CONCRETE SIDEWALK SIDE CURBS IN THE SIDEWALK UNIT PRICE BID AND NO ADDITIONAL COMPENSATION WILL BE ALLOWED.
- 4. LANDING (UPPER & LOWER) AND TURNING AREAS ARE DESIGNATED WITH A "L".

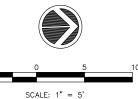

### LEGEND:

ADA = PROPOSED ADA DEPRESSED CURB

SSC = PROPOSED 6" WIDE CONC SIDEWALK SIDE CURB


R = PROPOSED RAMP L = PROPOSED LANDING

SIDEWALK ELEVATION POINT LOCATION & NUMBER

PAVEMENT ELEVATION POINT & ELEVATION

= GRADE REFERENCE LINE 1.00%

SLOPE

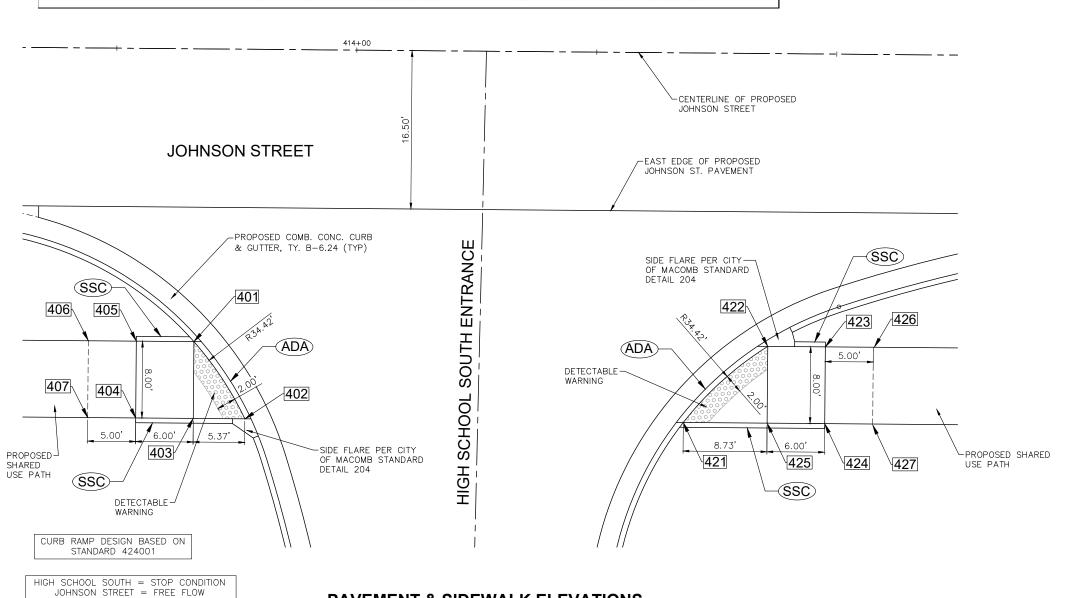

**PAVEMENT & SIDEWALK ELEVATIONS** 

STA. 414+14, JOHNSON STREET & HIGH SCHOOL SOUTH ENTRANCE INTERSECTION

	EG
714 E. JACKSON STREET	PH: 309.833.4594
MACOMB, IL 61455	www.imegcorp.com


USER NAME = TAB	DESIGNED — LRR/MJC	REVISED — 09-06-2023	CTATE OF ILLINOIS
	DRAWN — TAB	REVISED — ·	STATE OF ILLINOIS
PLOT SCALE=	CHECKED — LRR	REVISED — ·	DEPARTMENT OF TRANSPORTATION
PLOT DATE = 09-06-2023	DATE - 01/11/2023	REVISED - ·	

at HIGH SCHOOL NORTH ENTRANCE

Point	Station	Offset FEET	Elevation FEET	Point to Point		Sidewalk Designation	Distance*	Δ Elevation	Slope %	Legally Acceptable Range Pos. or Neg.	Remarks
	HIGH SCHOOL	NORTH EN	TRANCELT	SW SIDE:					/0	103. Of INCE.	
501	419+31.50	30.50	682.89	501	502	Crosswalk Cross Slope - Yield Condition	9.67	0.15	1.6%	0.0% to 2.0%	
502	419+36.87	38.50	683.04	502	503	Landing/Turning Space	5.37	0.00	0.0%	0.1% to 2.0%	
503	419+31.50	38.50	683.04	503	504	Ramp Running Slope	6.00	0.42	7.0%	0.5% to 8.3%	
504	419+25.50	38.50	683.46	504	505	Ramp Cross Slope	8.00	-0.12	-1.5%	0.1% to 2.0%	
505	419+25.50	30.50	683.34	505	501	Ramp Running Slope	6.00	-0.45	-7.5%	0.5% to 8.3%	
506	419+20.50	30.50	683.33	505	506	Landing/Turning Space	5.00	-0.01	-0.2%	0.1% to 2.0%	
507	419+20.50	38.50	683.45	504	507	Landing/Turning Space	5.00	-0.01	-0.2%	0.1% to 2.0%	
		100 00000		506	507	Sidewalk Cross Slope	8.00	0.12	1.5%	0.5% to 2.0%	
				503	501	Ramp Cross Slope	8.00	-0.15	-1.9%	0.1% to 2.0%	
	HIGH SCHOOL										
521	419+82.72	38.50	683.09	521	522	Crosswalk Cross Slope - Yield Condition	11.90	-0.12	-1.0%	0.0% to 2.0%	
522	419+91.45	30.50	682.97	522	523	Ramp Running Slope	6.00	0.45	7.5%	0.5% to 8.3%	
523	419+97.45	30.50	683.42	523	524	Ramp Cross Slope	8.00	0.12	1.5%	0.1% to 2.0%	
524	419+97.45	38.50	683.54	524	525	Ramp Running Slope	6.00	-0.43	-7.2%	0.5% to 8.3%	
525	419+91.45	38.50	683.11	525	521	Landing/Turning Space	8.73	-0.02	-0.2%	0.1% to 2.0%	
526	420+02.45	30.50	683.49	523	526	Landing/Turning Space	5.00	0.07	1.4%	0.1% to 2.0%	
527	420+02.45	38.50	683.61	524	527	Landing/Turning Space	5.00	0.07	1.4%	0.1% to 2.0%	
				526	527	Sidewalk Cross Slope	8.00	0.12	1.5%	0.5% to 2.0%	
				522	525	Ramp Cross Slope	8.00	0.14	1.7%	0.1% to 2.0%	

### GENERAL NOTES:

- 1. ALL SPOT GRADES ARE TOP / EDGE OF PAVEMENT, SIDEWALK BREAKS, TOP / EDGE OF SIDEWALK, AND TOP OF DRIVEWAYS UNLESS NOTED OTHERWISE.
- 2. ALL ADA RAMPS SHALL HAVE A 1/2" DEPRESSED CURB AND 5% MAX GUTTER SLOPE PER STANDARD 606001.
- 3. INCLUDE ALL COST FOR 6" WIDE CONCRETE SIDEWALK SIDE CURBS IN THE SIDEWALK UNIT PRICE BID AND NO ADDITIONAL COMPENSATION WILL BE ALLOWED.
- 4. LANDING (UPPER & LOWER) AND TURNING AREAS ARE DESIGNATED WITH A "L".

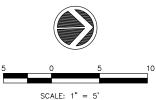

### LEGEND:

ADA = PROPOSED ADA DEPRESSED CURB

SSC = PROPOSED 6" WIDE CONC SIDEWALK SIDE CURB


> R = PROPOSED RAMP L = PROPOSED LANDING

SIDEWALK ELEVATION POINT LOCATION & NUMBER

PAVEMENT ELEVATION POINT & ELEVATION

---- = GRADE REFERENCE LINE

1.00% SLOPE

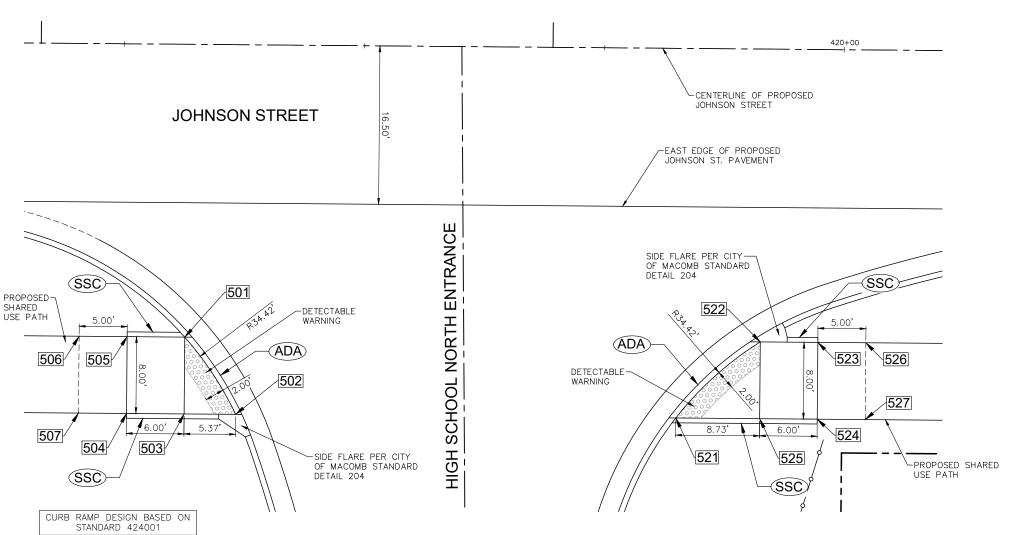

HIGH SCHOOL NORTH = STOP CONDITION JOHNSON STREET = FREE FLOW

### **PAVEMENT & SIDEWALK ELEVATIONS** STA. 419+60, JOHNSON STREET & HIGH SCHOOL NORTH ENTRANCE INTERSECTION

	Æ
714 E. JACKSON STREET	PH: 309.833.4594
MACOMB, IL 61455	www.imegcorp.com
Illinois Design Firm Registro COPYRIGHT 2023 A	


USER NAME = TAB	DESIGNED — LRR/MJC	REVISED — 09-06-2023	CTATE OF ILLINOIS
	DRAWN — TAB	REVISED - ·	STATE OF ILLINOIS
PLOT SCALE=	CHECKED — LRR	REVISED - ·	DEPARTMENT OF TRANSPORTATION
PLOT DATE = 09-06-2023	DATE - 01/11/2023	REVISED — ·	

at MACARTHUR SCHOOL ENTRANCE

Point	Station	Offset FEET	Elevation FEET	Point to Point		Sidewalk Designation	Distance*	Δ Elevation	Slope %	Legally Acceptable Range Pos. or Neg.	Remarks
	MACARTHUR	SCHOOL EN	NTRANCE LT	. SW SIDE:					70	1 OJ. OI HCK.	
601	428+27.78	30.50	684.48	601	602	Crosswalk Cross Slope - Yield Condition	9.67	0.13	1.3%	0.0% to 2.0%	
602	428+33.15	38.50	684.61	602	603	Landing/Turning Space	5.37	0.01	0.2%	0.1% to 2.0%	
603	428+27.78	38.50	684.62	603	604	Ramp Running Slope	6.00	0.43	7.2%	0.5% to 8.3%	
604	428+21.70	38.50	685.05	604	605	Ramp Cross Slope	8.00	-0.12	-1.5%	0.1% to 2.0%	
605	428+21.78	30.50	684.93	605	601	Ramp Running Slope	6.00	-0.45	-7.5%	0.5% to 8.3%	
606	428+16.78	30.50	684.85	605	606	Landing/Turning Space	5.00	-0.08	-1.6%	0.1% to 2.0%	
607	428+16.78	38.50	684.97	604	607	Landing/Turning Space	5.00	-0.08	-1.6%	0.1% to 2.0%	
				606	607	Sidewalk Cross Slope	8.00	0.12	1.5%	0.5% to 2.0%	
				603	601	Ramp Cross Slope	8.00	-0.14	-1.7%	0.1% to 2.0%	
	MACARTHUR	SCHOOL EN	NTRANCE RT	. SE SIDE:							
621	428+79.31	38.50	684.78	621	622	Crosswalk Cross Slope - Yield Condition	11.91	-0.06	-0.5%	0.0% to 2.0%	
622	428+88.05	30.50	684.72	622	623	Ramp Running Slope	6.00	0.44	7.3%	0.5% to 8.3%	
623	428+94.05	30.50	685.16	623	624	Ramp Cross Slope	8.00	0.12	1.5%	0.1% to 2.0%	
624	428+94.05	38.50	685.28	624	625	Ramp Running Slope	6.00	-0.44	-7.3%	0.5% to 8.3%	
625	428+88.05	38.50	684.84	625	621	Landing/Turning Space	8.74	-0.06	-0.7%	0.1% to 2.0%	
626	428+99.05	30.50	685.18	623	626	Landing/Turning Space	5.00	0.02	0.4%	0.1% to 2.0%	
627	428+99.05	38.50	685.30	624	627	Landing/Turning Space	5.00	0.02	0.4%	0.1% to 2.0%	
				626	627	Sidewalk Cross Slope	8.00	0.12	1.5%	0.5% to 2.0%	
				622	625	Ramp Cross Slope	8.00	0.12	1.5%	0.1% to 2.0%	

### GENERAL NOTES:

- 1. ALL SPOT GRADES ARE TOP / EDGE OF PAVEMENT, SIDEWALK BREAKS, TOP / EDGE OF SIDEWALK, AND TOP OF DRIVEWAYS UNLESS NOTED OTHERWISE.
- 2. ALL ADA RAMPS SHALL HAVE A 1/2" DEPRESSED CURB AND 5% MAX GUTTER SLOPE PER STANDARD 606001.
- 3. INCLUDE ALL COST FOR 6" WIDE CONCRETE SIDEWALK SIDE CURBS IN THE SIDEWALK UNIT PRICE BID AND NO ADDITIONAL COMPENSATION WILL BE ALLOWED.
- 4. LANDING (UPPER & LOWER) AND TURNING AREAS ARE DESIGNATED WITH A "L".

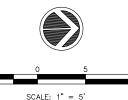

### LEGEND:

ADA = PROPOSED ADA DEPRESSED CURB

SSC = PROPOSED 6" WIDE CONC

R = PROPOSED RAMP L = PROPOSED LANDING

SIDEWALK ELEVATION POINT


SIDEWALK SIDE CURB

LOCATION & NUMBER

PAVEMENT ELEVATION POINT & ELEVATION

= GRADE REFERENCE LINE

1.00% SLOPE

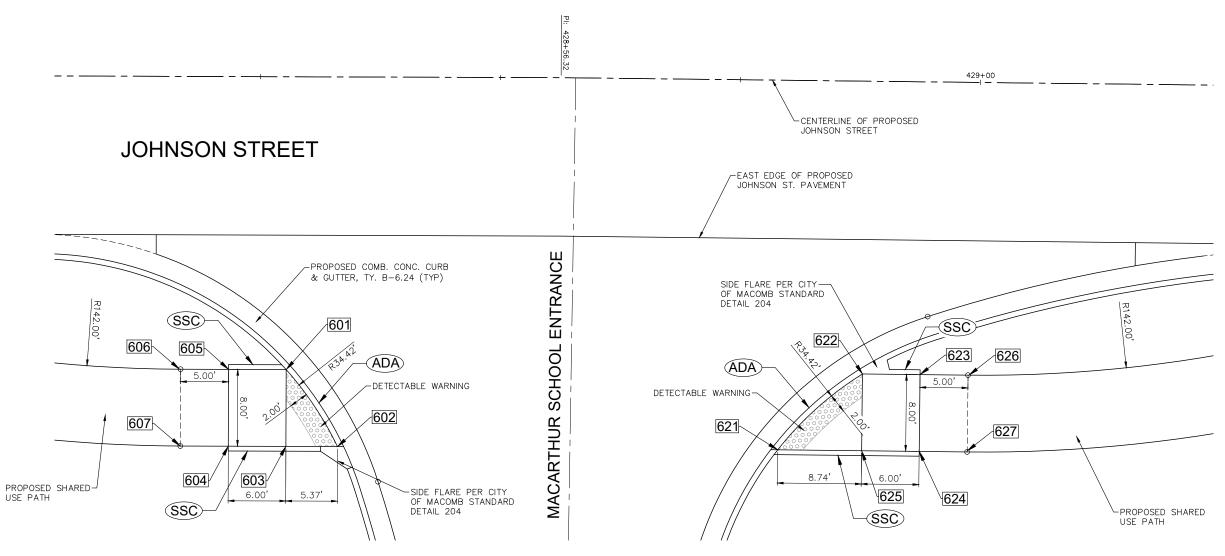

CURB RAMP DESIGN BASED ON STANDARD 424001

MACARTHUR SCHOOL = STOP CONDITION JOHNSON STREET = FREE FLOW

### **PAVEMENT & SIDEWALK ELEVATIONS** STA. 428+59, JOHNSON STREET & MACARTHUR SCHOOL ENTRANCE INTERSECTION

<b>♦IM</b>	EG
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MACOMB, IL 61455	www.imegcorp.com
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USER NAME = TAB	DESIGNED — LRR/MJC	REVISED — 09-06-2023	STATE OF ILLINIOLS
	DRAWN — TAB	REVISED - ·	STATE OF ILLINOIS
PLOT SCALE=	CHECKED — LRR	REVISED — ·	DEPARTMENT OF TRANSPORTATION
PLOT DATE = 09-06-2023	DATE - 01/11/2023	REVISED — ·	


	ADA DETAILS								
J	OHNS	108	N S	TR		RECO	NSTRUCTION		
	CHEET I	NΩ	64	ΛE	104	CHEETS			

at GRANT STREET

Point	Station	Offset FEET	Elevation FEET	Point t	o Point	Sidewalk Designation		Δ Elevation	Slope	Legally Acceptable Range	Remarks
	CDANITATORS	TRT CECIE					FT	FT	%	Pos. or Neg.	
704	GRANT STREE			704	702		0.04	0.00	4.00/	0.00( . 2.00(	
701	432+02.12	41.23	678.28	701	702	Crosswalk Cross Slope - Yield Condition	8.01	-0.08	-1.0%	0.0% to 2.0%	
702	432+06.71	47.79	678.20	702	703	Ramp Running Slope	4.43	0.33	7.4%	0.5% to 8.3%	
703	432+03.08	50.33	678.53	703	704	Ramp Running Slope	8.54	0.55	6.4%	0.5% to 8.3%	
704	432+08.45	56.96	679.08	704	705	Crosswalk Cross Slope - Yield Condition	5.00	0.08	1.6%	0.0% to 2.0%	
705	432+04.06	59.34	679.16	705	706	Ramp Running Slope	8.75	-0.51	-5.8%	0.5% to 8.3%	
706	431+96.50	54.93	678.65	706	707	Ramp Running Slope	8.00	0.08	1.0%	0.5% to 8.3%	
707	431+91.91	48.38	678.73	707	708	Ramp Running Slope	9.69	0.75	7.7%	0.5% to 8.3%	
708	431+84.98	41.63	679.48	708	709	Landing/Turning Space	8.00	-0.12	-1.5%	0.1% to 2.0%	
709	431+89.94	35.35	679.36	709	710	Ramp Running Slope	12.02	-0.75	-6.2%	0.5% to 8.3%	
710	431+98.49	43.77	678.61	710	701	Ramp Running Slope	4.34	-0.33	-7.6%	0.5% to 8.3%	
				703	706	Landing/Turning Space	8.02	0.12	1.5%	0.1% to 2.0%	
				703	710	Landing/Turning Space	8.00	0.08	1.0%	0.1% to 2.0%	
				707	710	Landing/Turning Space	8.02	-0.12	-1.5%	0.1% to 2.0%	
	GRANT STREE										
721	432+65.83	58.69	678.27	721	722	Crosswalk Cross Slope - Yield Condition	16.00	-0.85	-5.3%	0.0% to 2.0%	
722	432+70.17	46.39	677.42	722	723	Ramp Running Slope	8.01	-0.13	-1.6%	0.5% to 8.3%	
723	432+74.73	39.81	677.29	723	724	Ramp Running Slope	7.81	0.11	1.4%	0.5% to 8.3%	
724	432+80.37	34.43	677.40	724	725	Landing/Turning Space	6.00	0.09	1.5%	0.1% to 2.0%	
725	432+84.07	39.15	677.49	725	726	Ramp Running Slope	6.01	-0.14	-2.3%	0.5% to 8.3%	
726	432+79.68	43.31	677.35	726	727	Ramp Running Slope	8.00	0.16	2.0%	0.5% to 8.3%	
727	432+75.13	49.83	677.51	727	728	Landing/Turning Space	9.03	-0.15	-1.7%	0.1% to 2.0%	
728	732+71.75	59.68	677.36	728	721	Ramp Running Slope	12.95	0.91	7.0%	0.5% to 8.3%	
				722	727	Landing/Turning Space	6.04	0.09	1.5%	0.1% to 2.0%	
				723	726	Landing/Turning Space	6.04	0.06	1.0%	0.1% to 2.0%	

### GENERAL NOTES:

- 1. ALL SPOT GRADES ARE TOP / EDGE OF PAVEMENT, SIDEWALK BREAKS, TOP / EDGE OF SIDEWALK, AND TOP OF DRIVEWAYS UNLESS NOTED OTHERWISE.
- 2. ALL ADA RAMPS SHALL HAVE A 1/2" DEPRESSED CURB AND 5% MAX GUTTER SLOPE PER STANDARD 606001.
- 3. INCLUDE ALL COST FOR 6" WIDE CONCRETE SIDEWALK SIDE CURBS IN THE SIDEWALK UNIT PRICE BID AND NO ADDITIONAL COMPENSATION WILL BE ALLOWED.
- 4. LANDING (UPPER & LOWER) AND TURNING AREAS ARE DESIGNATED WITH A "L".

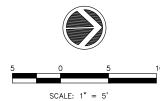

### LEGEND:

—ADA = PROPOSED ADA DEPRESSED CURB

SSC = PROPOSED 6" WIDE CONC

R = PROPOSED RAMP

L = PROPOSED LANDING

SIDEWALK SIDE CURB


LOCATION & NUMBER


SIDEWALK ELEVATION POINT

PAVEMENT ELEVATION

POINT & ELEVATION = GRADE REFERENCE LINE

1.00% SLOPE

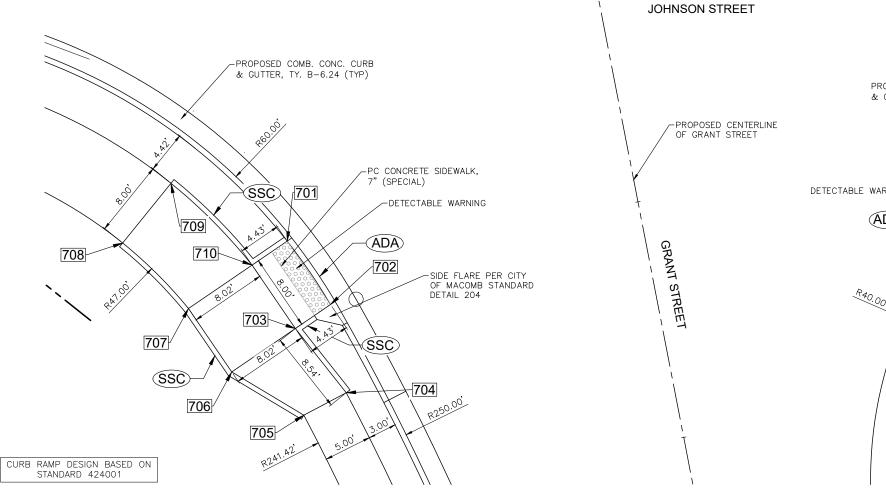

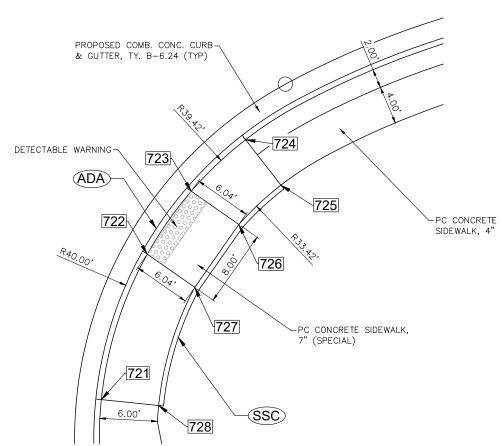

### **PAVEMENT & SIDEWALK ELEVATIONS** STA. 432+25, JOHNSON STREET & GRANT STREET INTERSECTION

GRANT STREET = STOP CONDITION JOHNSON STREET = STOP CONDITION

> USER NAME = TAB DESIGNED — LRR/MJC REVISED — 09-06-2023 DRAWN - TAB REVISED -PLOT SCALE = CHECKED — LRR REVISED PLOT DATE = 09-06-2023 DATE - 01/11/2023 REVISED -


STATE OF ILLINOIS **DEPARTMENT OF TRANSPORTATION** 

**ADA DETAILS** JOHNSON STREET RECONSTRUCTION SHEET NO. 65 OF 104 SHEETS

19-00155-00-PV McDONOUGH 104 65 JOHNSON ST & GRANT ST CONTRACT NO. 89809

### GENERAL NOTES:

- ALL SPOT GRADES ARE TOP / EDGE OF PAVEMENT, SIDEWALK BREAKS, TOP / EDGE OF SIDEWALK, AND TOP OF DRIVEWAYS UNLESS NOTED OTHERWISE.
- 2. ALL ADA RAMPS SHALL HAVE A 1/2" DEPRESSED CURB AND 5% MAX GUTTER SLOPE PER STANDARD 606001.
- 3. INCLUDE ALL COST FOR 6" WIDE CONCRETE SIDEWALK SIDE CURBS IN THE SIDEWALK UNIT PRICE BID AND NO ADDITIONAL COMPENSATION WILL BE ALLOWED.
- 4. LANDING (UPPER & LOWER) AND TURNING AREAS ARE DESIGNATED WITH A "L".

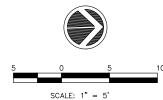

### LEGEND:

ADA = PROPOSED ADA DEPRESSED CURB SSC = PROPOSED 6" WIDE CONC

R = PROPOSED RAMP

L = PROPOSED LANDING

SIDEWALK ELEVATION POINT LOCATION & NUMBER

SIDEWALK SIDE CURB

= PAVEMENT ELEVATION POINT & ELEVATION


---- = GRADE REFERENCE LINE

1.00% SLOPE



at GRANT STREET

Point	Station	Offset FEET	Elevation FEET	Point t	o Point	Sidewalk Designation	Distance*	Δ Elevation	Slope %	Legally Acceptable Range Pos. or Neg.	Remarks
	GRANT STREE										
741	432+63.95	26.06	676.49	741	742	Crosswalk Cross Slope - Yield Condition	7.84	0.10	1.3%	0.0% to 2.0%	
742	432+57.63	30.97	676.59	742	743	Ramp Running Slope	4.45	0.33	7.4%	0.5% to 8.3%	
743	432+60.36	34.47	676.92	743	744	Ramp Running Slope	8.00	-0.09	-1.1%	0.5% to 8.3%	
744	432+66.68	29.57	676.83	744	745	Sidewalk Running Slope	6.00	0.27	4.5%	0.5% to 5.0%	
745	432+71.25	25.69	677.10	745	746	Landing/Turning Space	13.85	-0.04	-0.3%	0.1% to 2.0%	
746	432+84.86	23.07	677.06	746	747	Landing/Turning Space	5.00	-0.09	-1.8%	0.1% to 2.0%	
747	432+84.77	28.07	676.97	747	748	Landing/Turning Space	11.94	0.14	1.2%	0.1% to 2.0%	
748	432+73.12	30.32	677.11	748	749	Sidewalk Running Slope	5.76	-0.13	-2.3%	0.5% to 5.0%	
749	432+71.58	35.88	676.98	749	750	Landing/Turning Space	8.00	-0.08	-1.0%	0.1% to 2.0%	
750	432+65.31	40.84	676.90	750	751	Ramp Running Slope	12.92	0.78	6.0%	0.5% to 8.3%	
751	432+58.92	51.94	677.68	751	752	Sidewalk Running Slope	<b>12.00</b>	0.58	4.8%	0.5% to 5.0%	
752	432+55.57	63.45	678.26	752	753	Landing/Turning Space	8.00	-0.14	-1.7%	0.1% to 2.0%	
753	432+47.89	61.22	678.12	753	754	Sidewalk Running Slope	12.00	-0.56	-4.7%	0.5% to 5.0%	
754	432+51.24	49.70	677.56	754	743	Ramp Running Slope	17.94	-0.64	-3.6%	0.5% to 8.3%	
				744	741	Ramp Running Slope	4.45	-0.34	-7.6%	0.5% to 8.3%	
				749	744	Landing/Turning Space	8.00	-0.15	-1.9%	0.1% to 2.0%	
				748	745	Landing/Turning Space	5.00	-0.01	-0.2%	0.1% to 2.0%	
				750	743	Landing/Turning Space	8.07	0.02	0.2%	0.1% to 2.0%	
				751	754	Landing/Turning Space	8.00	-0.12	-1.5%	0.1% to 2.0%	

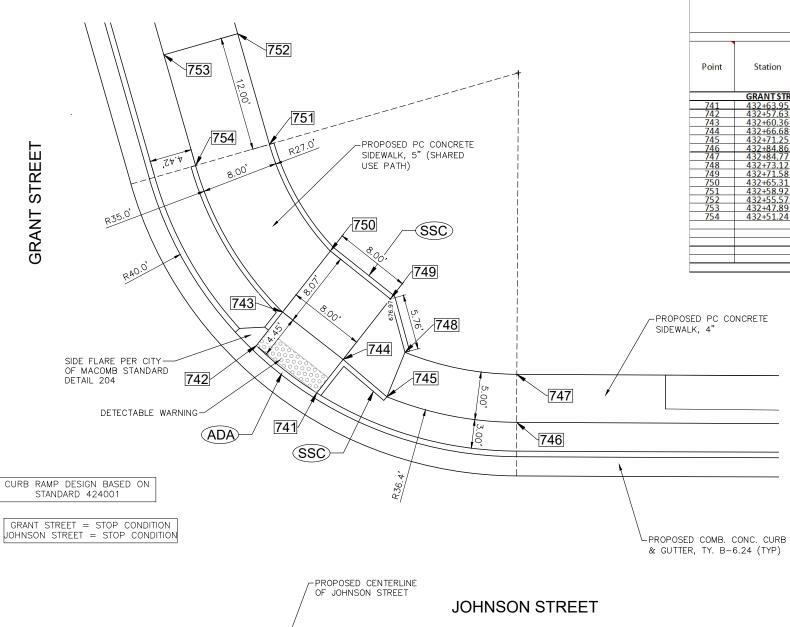

433+00

### **PAVEMENT & SIDEWALK ELEVATIONS** STA. 432+25, JOHNSON STREET & GRANT STREET INTERSECTION

<b>♦IM</b>	EG
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MACOMB, IL 61455	www.imegcorp.com
Illinois Design Firm Registratio	

	USER NAME = TAB	DESIGNED — LRR/MJC	REVISED — 09-06-2023	
EU		DRAWN — TAB	REVISED — ·	
PH: 309.833.4594 www.imegcorp.com	PLOT SCALE =	CHECKED — LRR	REVISED — ·	DEPARTM
#184.037537-0014 RIGHTS RESERVED	PLOT DATE = 09-06-2023	DATE - 01/11/2023	REVISED — ·	

_	STATE OF ILLINOIS
	DEPARTMENT OF TRANSPORTATION


ADA DETAILS									
JOHNSON STREET RECONSTRUCTION									
	SHEET NO	66	ΩE	104	SHEETS				

F.A.U. RTE.	SECTIO	N	COUNTY	TOTAL SHEETS	SHEI
6926	19-00155-00	-PV	McDONOUGH	104	66
JOH	NSON ST & GRAN	T ST	CONTRACT NO	D. 89809	
	ILL	INOIS PROJE	ECT NO. 11SC(152)		

### GRANT STREET SIDEWALK COMPLIANCE TABLE

at McARTHUR SCHOOL NORTH DRIVE

Point	Station	Offset FEET	Elevation FEET	Point to Point		Sidewalk Designation	Distance*	Δ Elevation	Slope %	Legally Acceptable Range	Remarks
	MA-CA DTILLID	CCUOOL NO	DELL DOUVE	LT CWC	NE.		FI	FI	%	Pos. or Neg.	
	McCARTHUR										
801	92+71.69	23.08	678.49	801	802	Crosswalk Cross Slope - Yield Condition	8.12	0.12	1.5%	0.0% to 2.0%	
802	92+78.03	28.08	678.61	802	803	Landing/Turning Space	6.34	-0.04	-0.6%	0.1% to 2.0%	
803	92+71.69	28.08	678.57	803	804	Ramp Running Slope	11.73	0.85	7.2%	0.5% to 8.3%	
804	92+59.96	28.08	679.42	804	805	Ramp Cross Slope	5.00	-0.07	-1.4%	0.1% to 2.0%	
805	92+59.96	23.08	679.35	805	801	Ramp Running Slope	11.73	-0.86	-7.3%	0.5% to 8.3%	
				803	801	Landing/Turning Space	5.00	-0.08	-1.6%	0.1% to 2.0%	
	McARTHUR S	CHHOOL NO	ORTH DRIVE	RT. SE SIC	E:						
821	93+21.89	31.68	678.39	821	822	Crosswalk Cross Slope - Yield Condition	8.53	-0.10	-1.2%	0.0% to 2.0%	
822	93+29.30	27.09	678.29	822	823	Sidewalk Running Slope	6.49	0.23	3.5%	0.5% to 5.0%	
823	93+35.72	25.22	678.52	823	824	Sidewalk Cross Slope	6.00	0.09	1.5%	0.5% to 2.0%	
824	93+37.19	31.05	678.61	824	825	Sidewalk Running Slope	4.51	-0.13	-2.9%	0.5% to 5.0%	
825	93+32.66	32.26	678.48	825	826	Sidewalk Running Slope	3.49	-0.10	-2.9%	0.5% to 5.0%	
826	93+29.03	32.08	678.38	826	821	Landing/Turning Space	6.86	0.01	0.2%	0.1% to 2.0%	
				826	822	Landing/Turning Space	5.00	-0.09	-1.8%	0.1% to 2.0%	

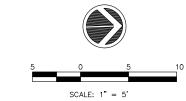

### LEGEND:

ADA = PROPOSED ADA
DEPRESSED CURB
SSC = PROPOSED 6" WIDE CONC

SIDEWALK SIDE CURB

R = PROPOSED RAMP

001 = SIDEWALK ELEVATION POINT LOCATION & NUMBER


L = PROPOSED LANDING

+ 682.73 = PAVEMENT ELEVATION POINT & ELEVATION

---- = GRADE REFERENCE LINE 1.00% SLOPE

### GENERAL NOTES:

- ALL SPOT GRADES ARE TOP / EDGE OF PAVEMENT, SIDEWALK BREAKS, TOP / EDGE OF SIDEWALK, AND TOP OF DRIVEWAYS UNLESS NOTED OTHERWISE.
- 2. ALL ADA RAMPS SHALL HAVE A 1/2" DEPRESSED CURB AND 5% MAX GUTTER SLOPE PER STANDARD 606001.
- 3. INCLUDE ALL COST FOR 6" WIDE CONCRETE SIDEWALK SIDE CURBS IN THE SIDEWALK UNIT PRICE BID AND NO ADDITIONAL COMPENSATION WILL BE ALLOWED.
- 4. LANDING (UPPER & LOWER) AND TURNING AREAS ARE DESIGNATED WITH A "L".

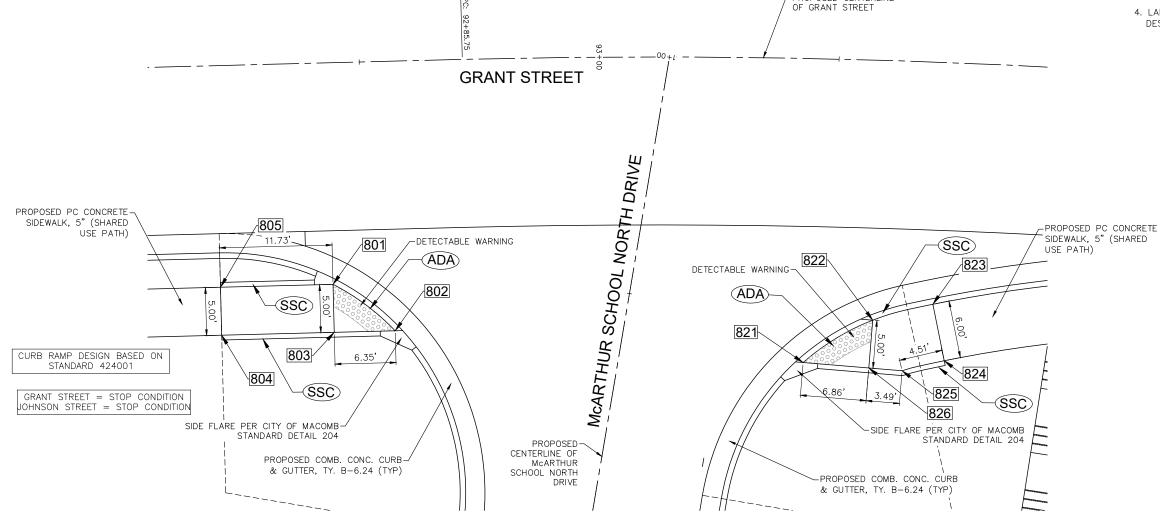

# PAVEMENT & SIDEWALK ELEVATIONS STA. 432+25, GRANT STREET & McARTHUR SCHOOL NORTH INTERSECTION




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PLOT DATE = 09-06-2023	DATE - 01/11/2023	REVISED — ·	


STATE OF ILLINOIS
DEPARTMENT OF TRANSPORTATION


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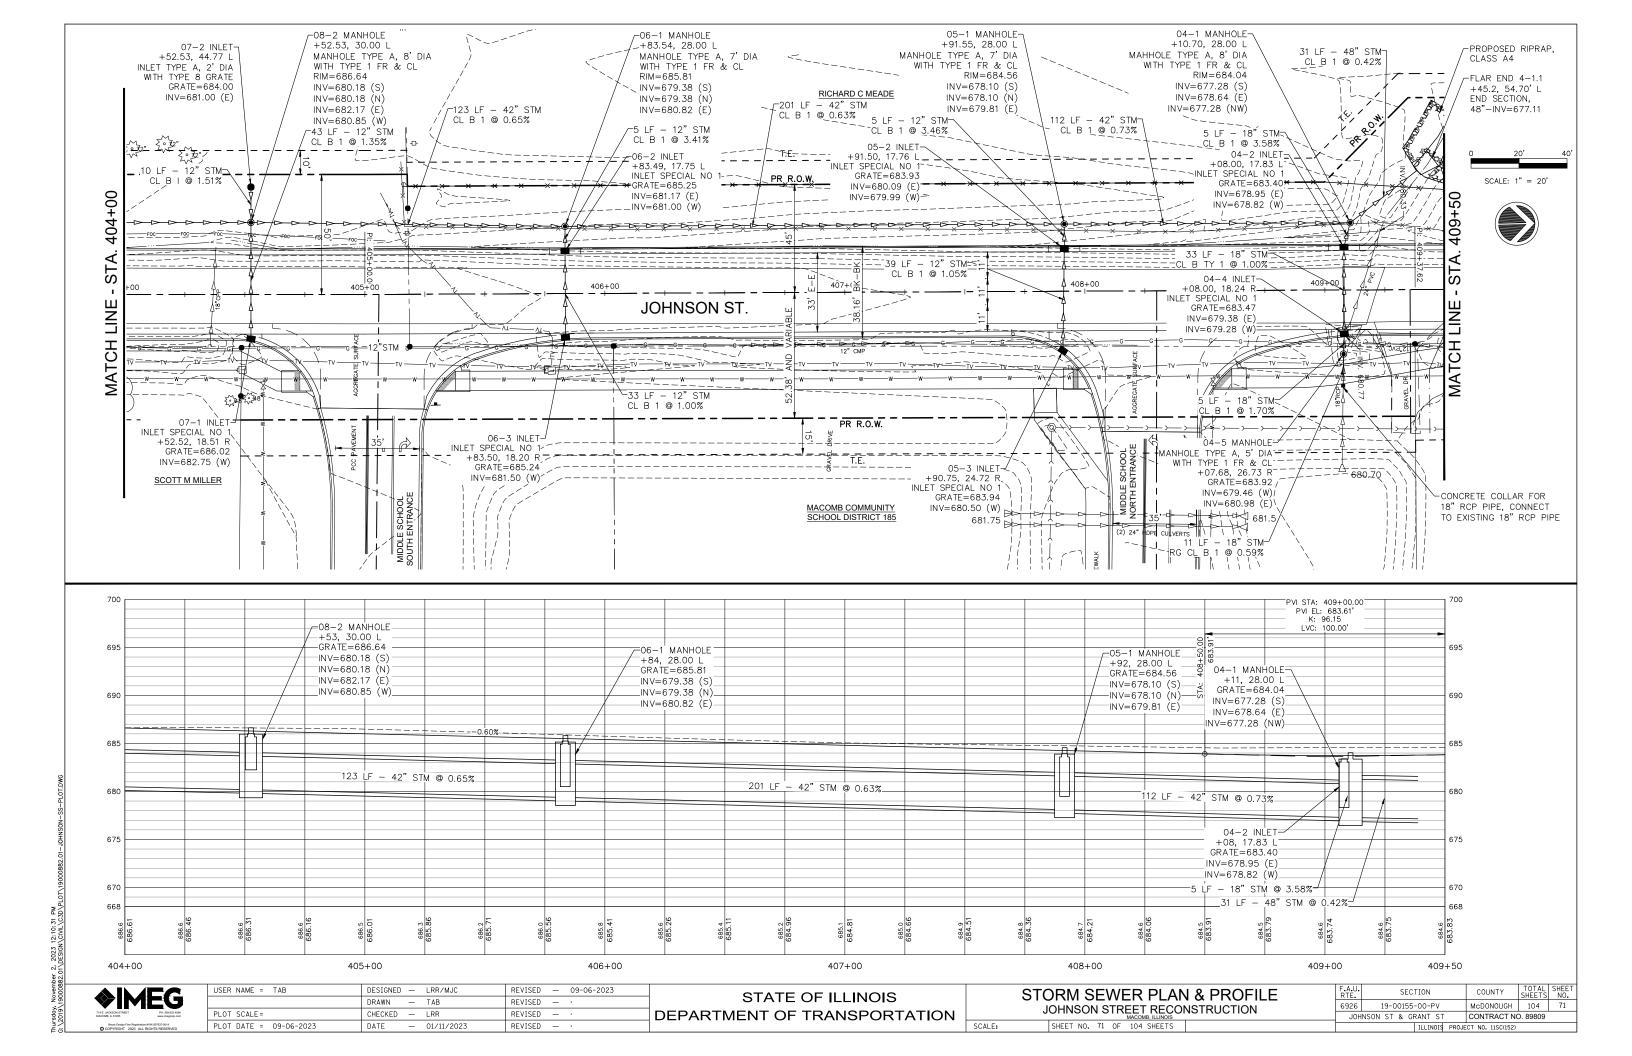
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J	JOHNSON STREET RECONSTRUCTION							
	CHEET	NO	67	ΛE	104	CHEETS		


F.A.U. RTE.	SEC.	TION	COUNTY	TOTAL SHEETS	SHEI	
6926	19-00155	-00-PV		McD0N0UGH	104	67
JOH	NSON ST & GF	RANT ST	CONTRACT NO	D. 89809		
		ILLINOIS	PROJE	CT NO. 11SC(152)		




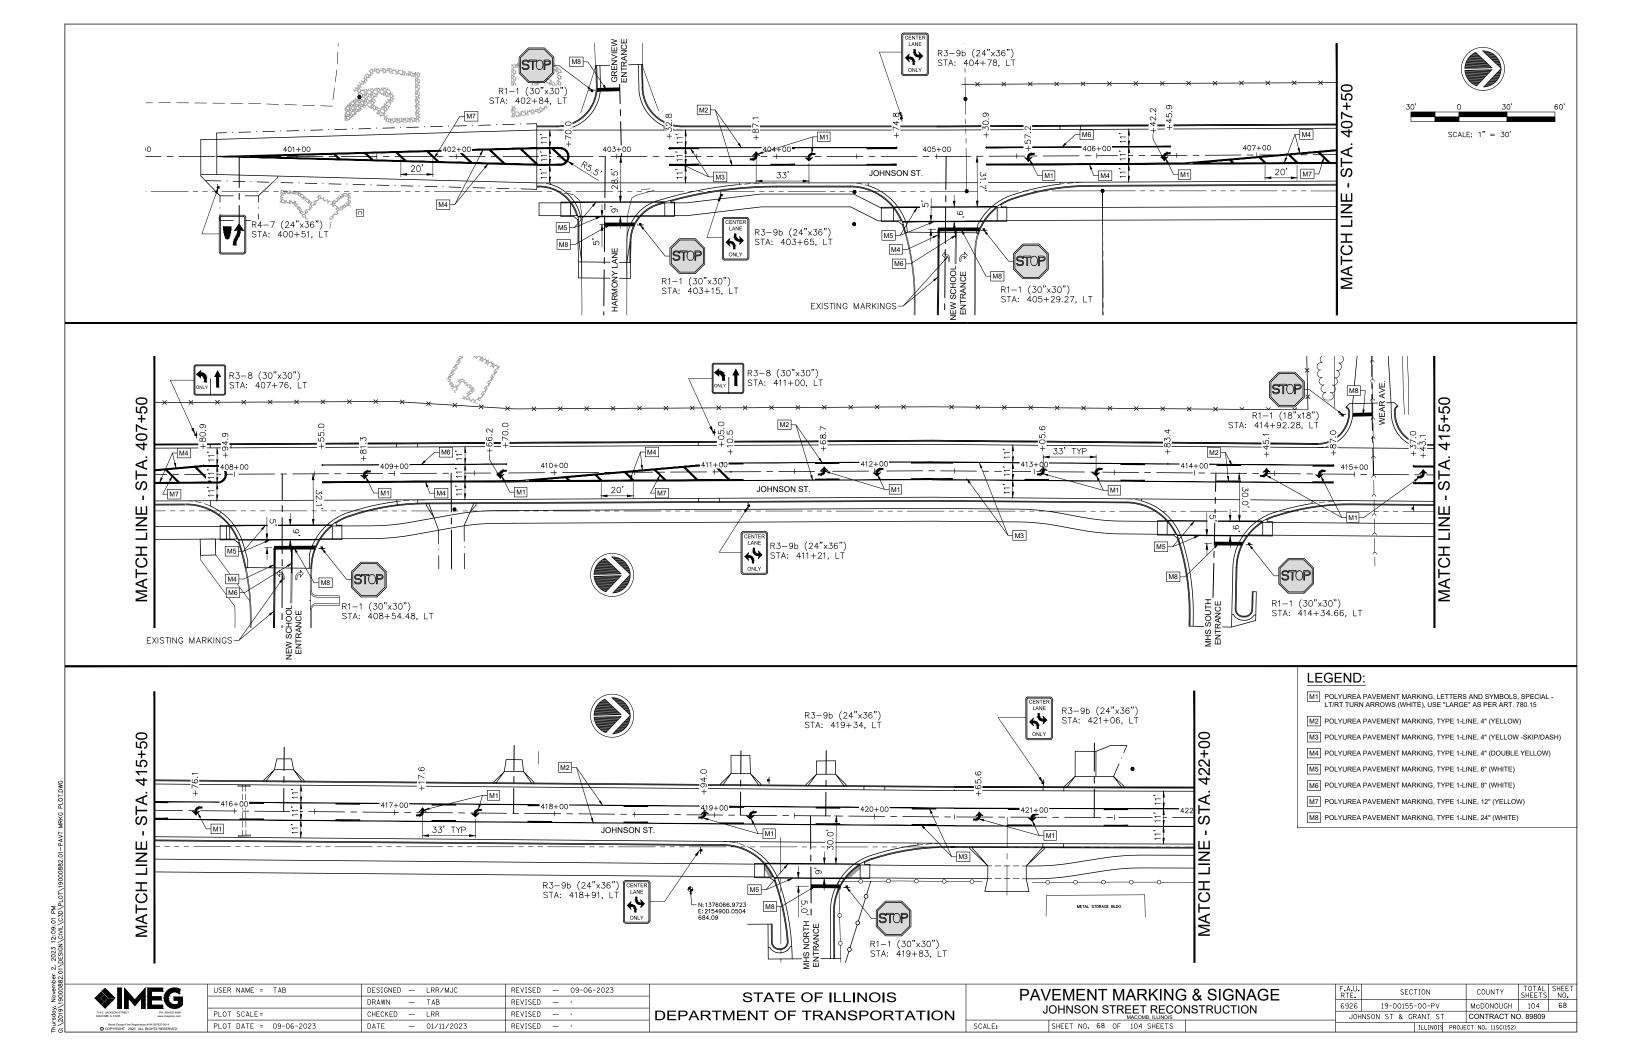


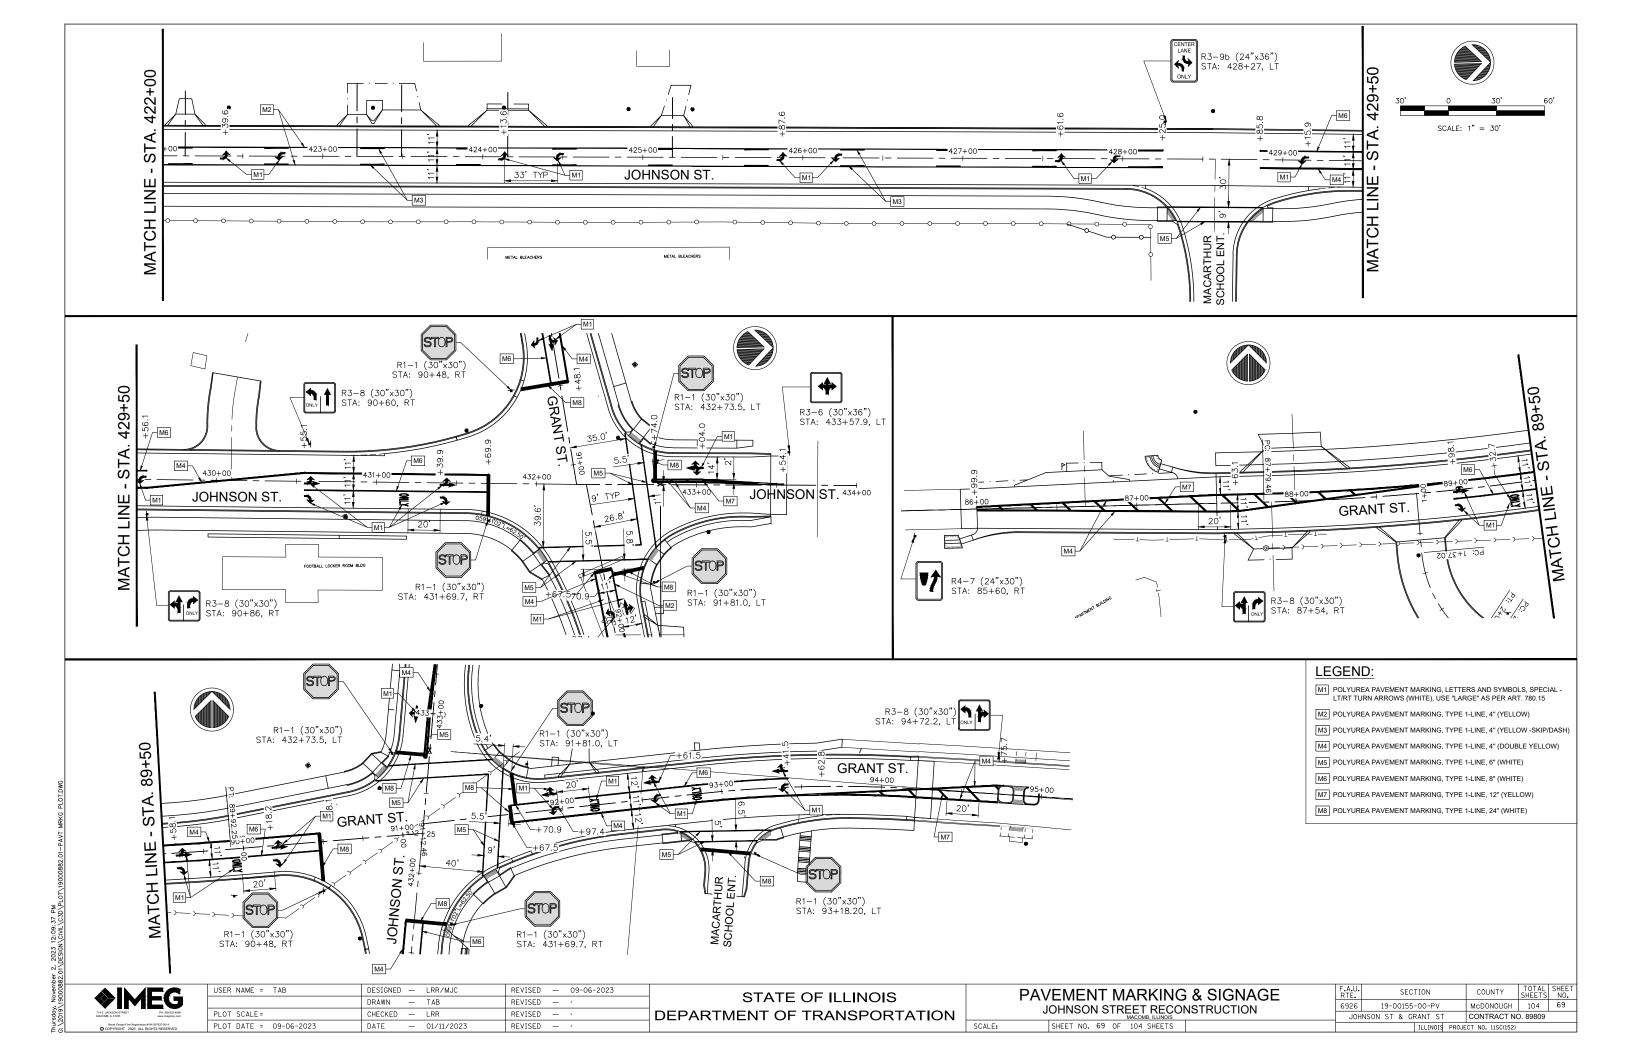


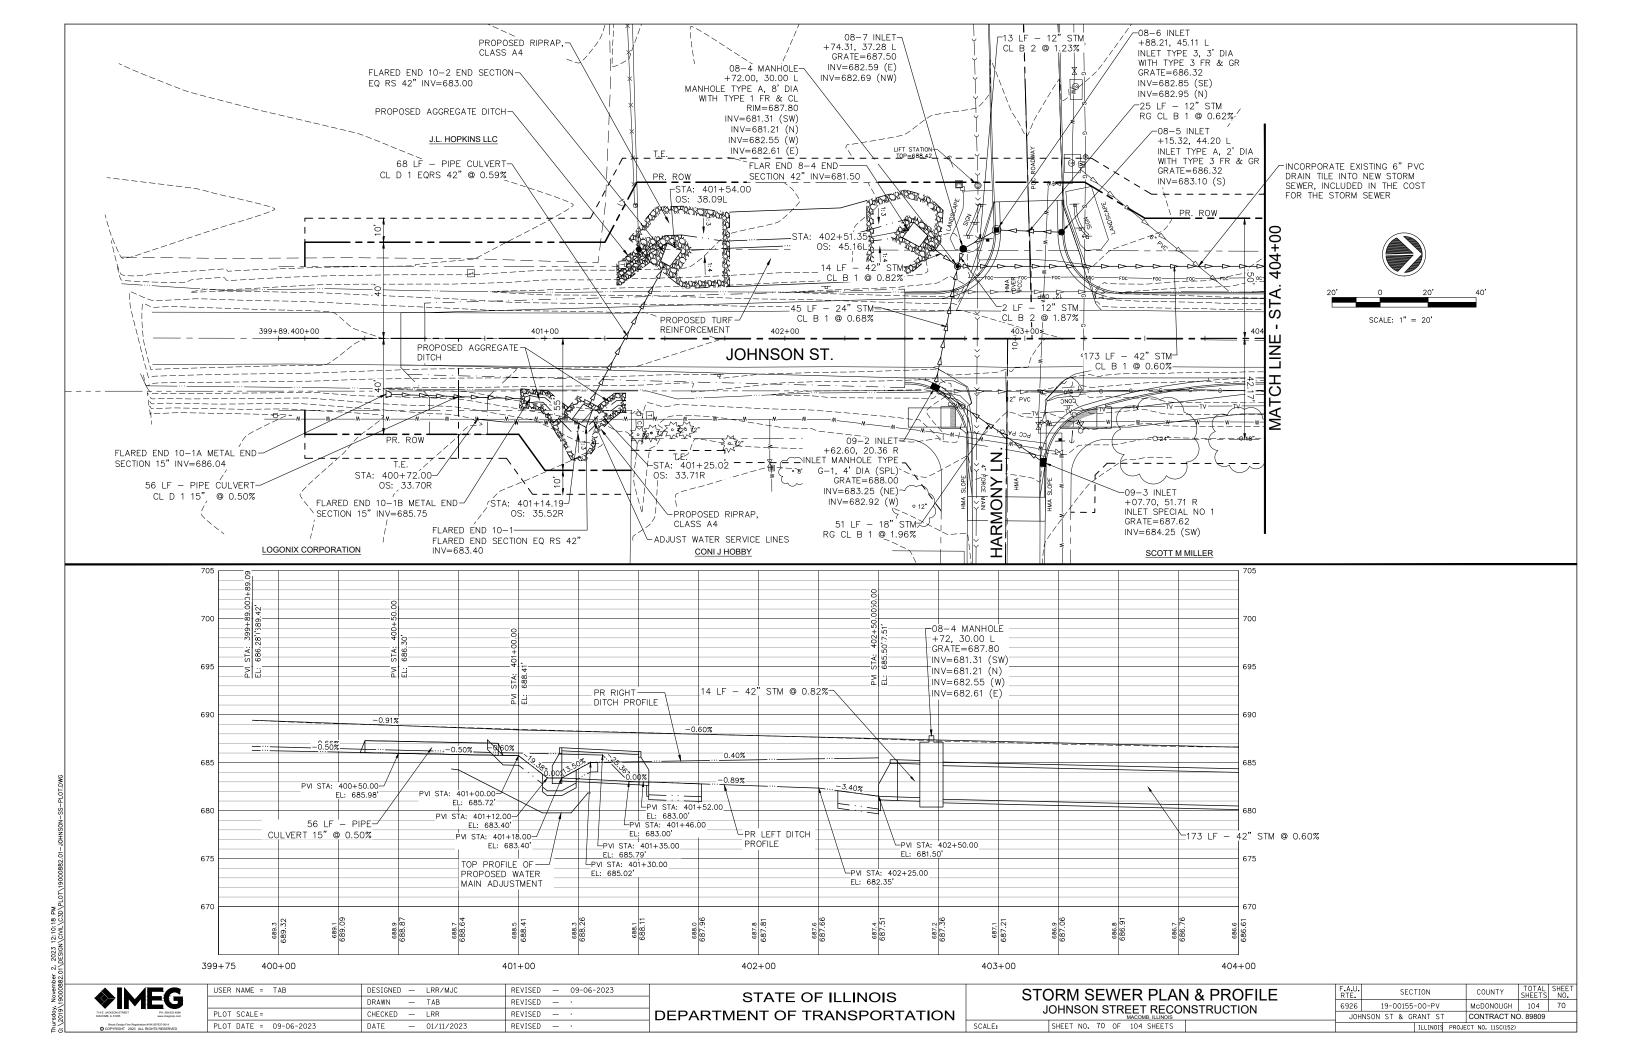


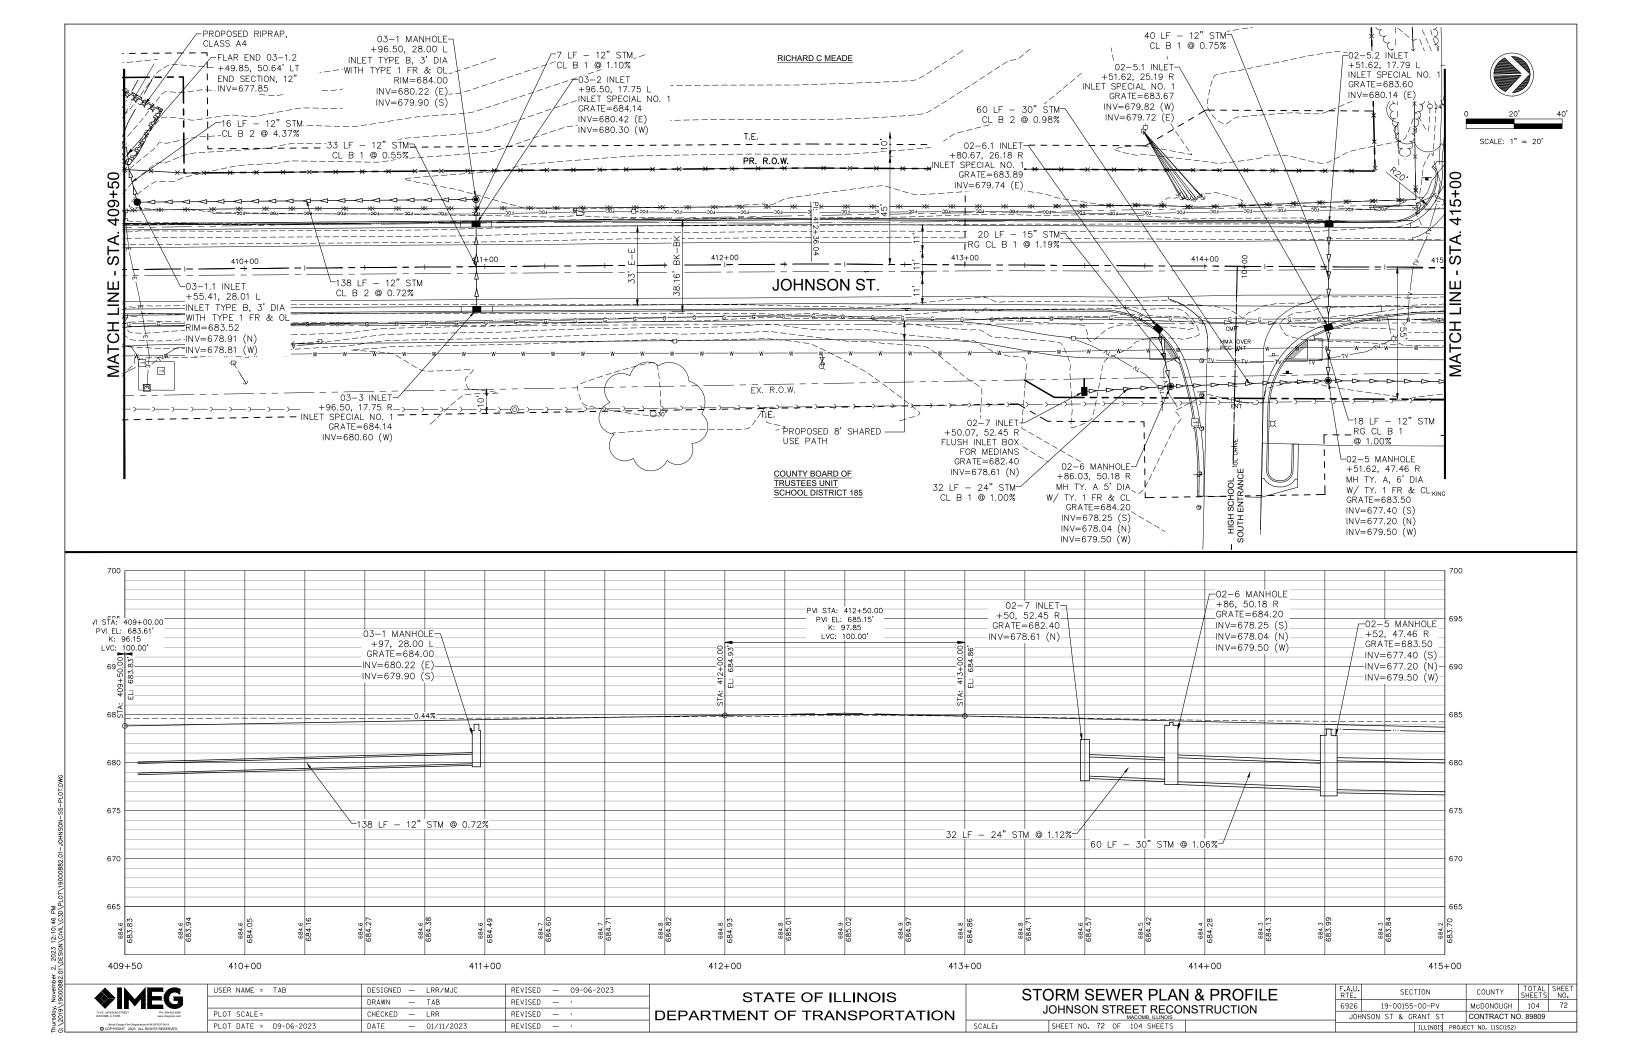


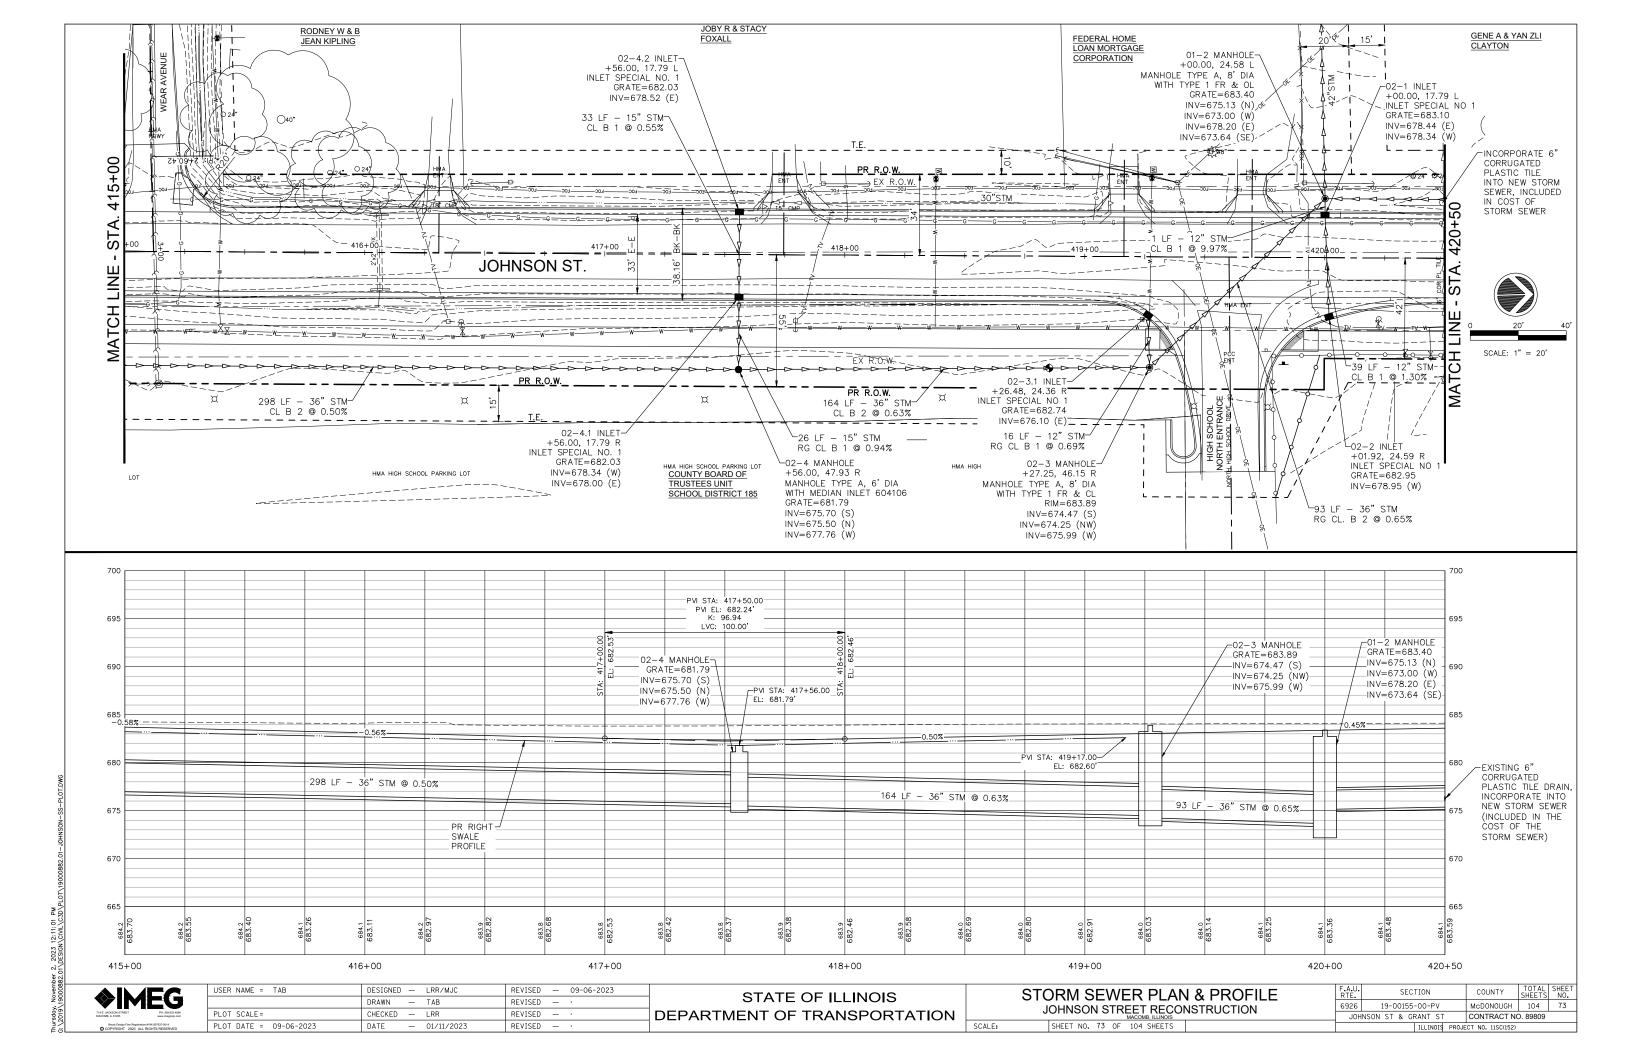


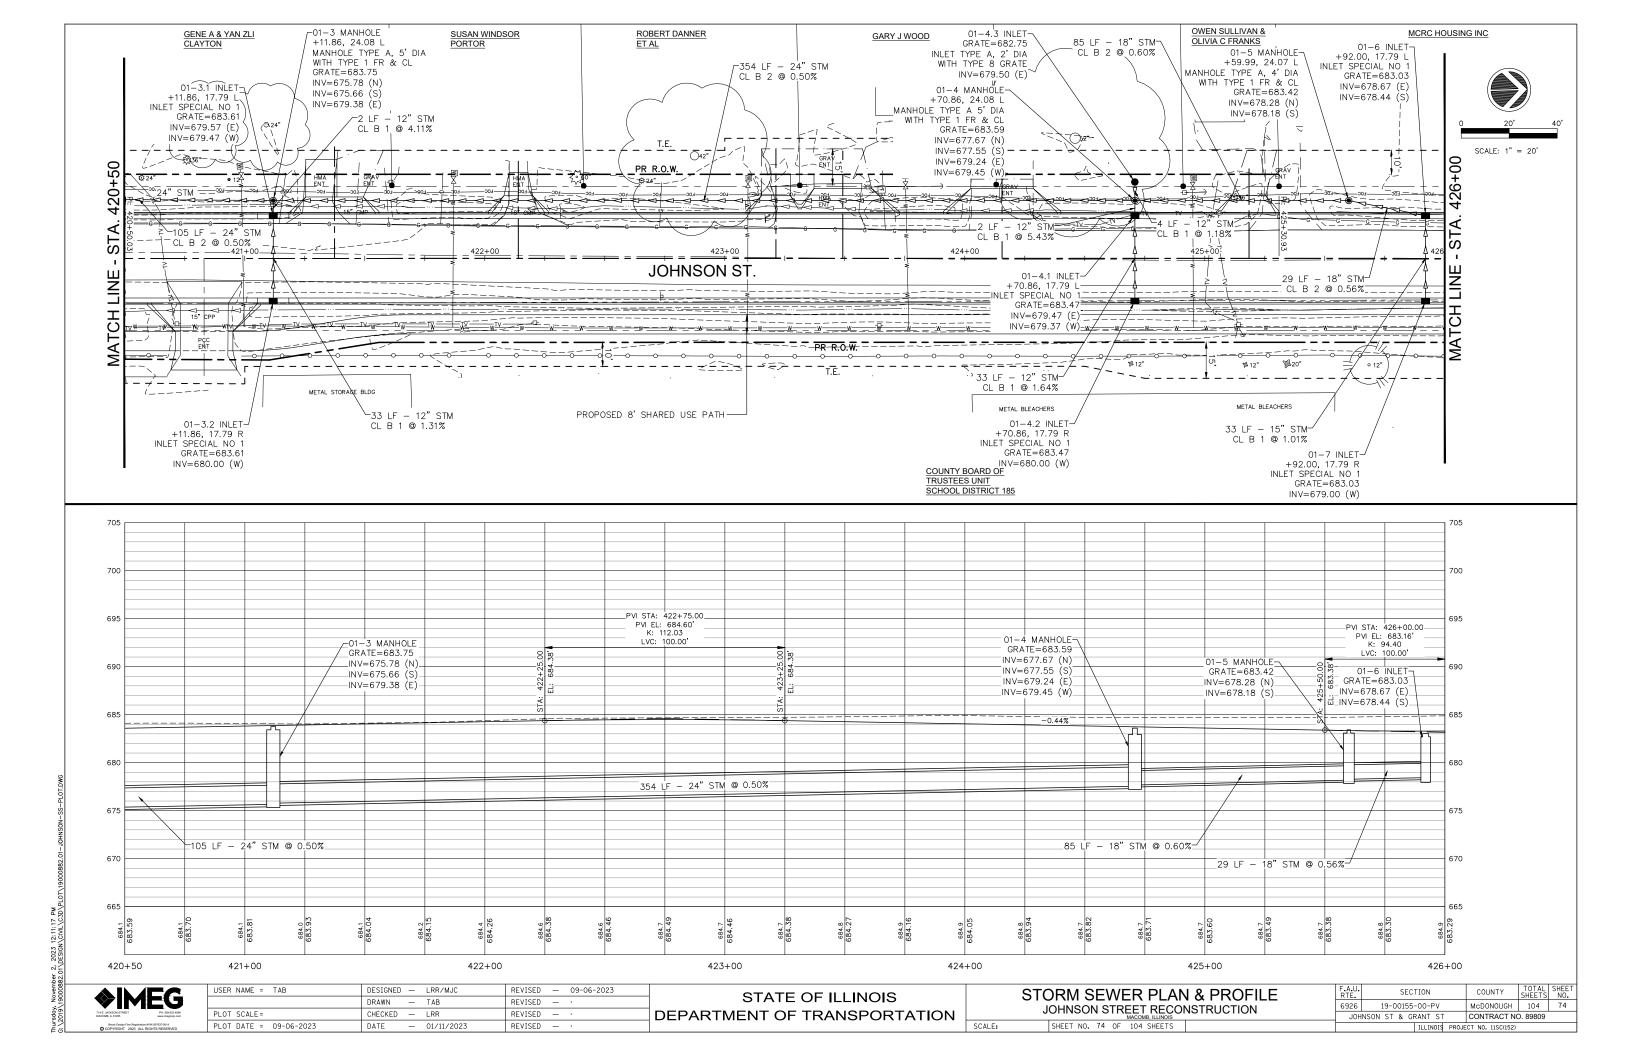

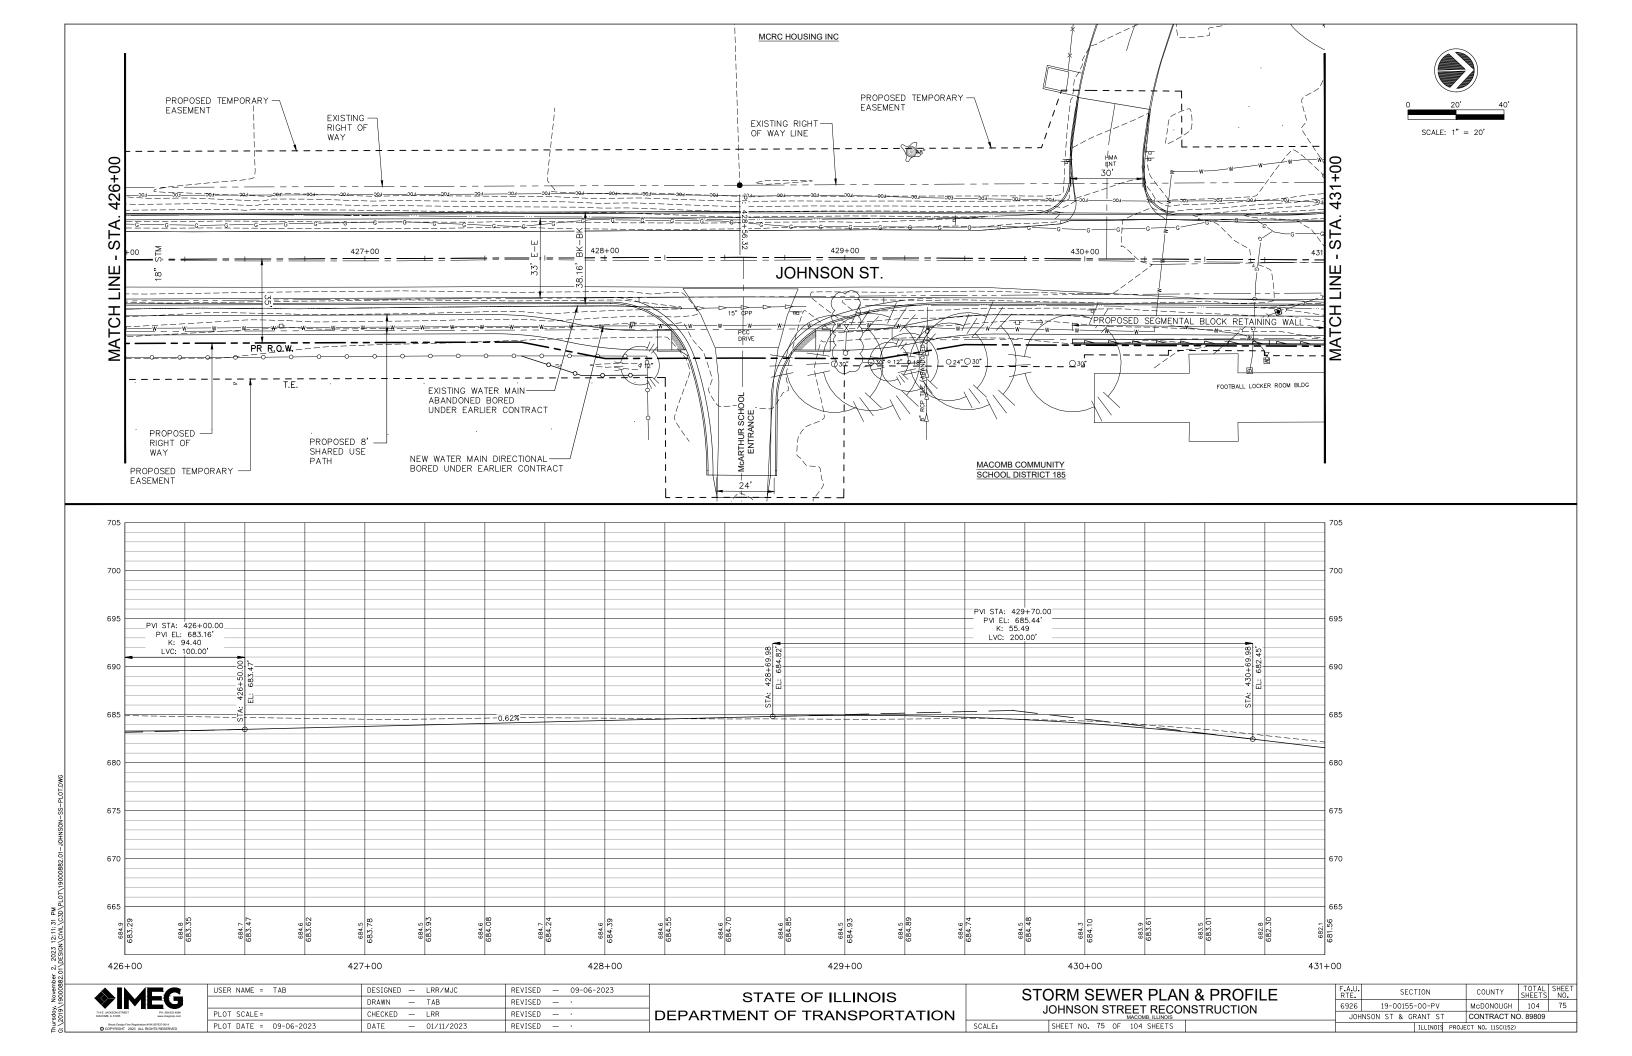

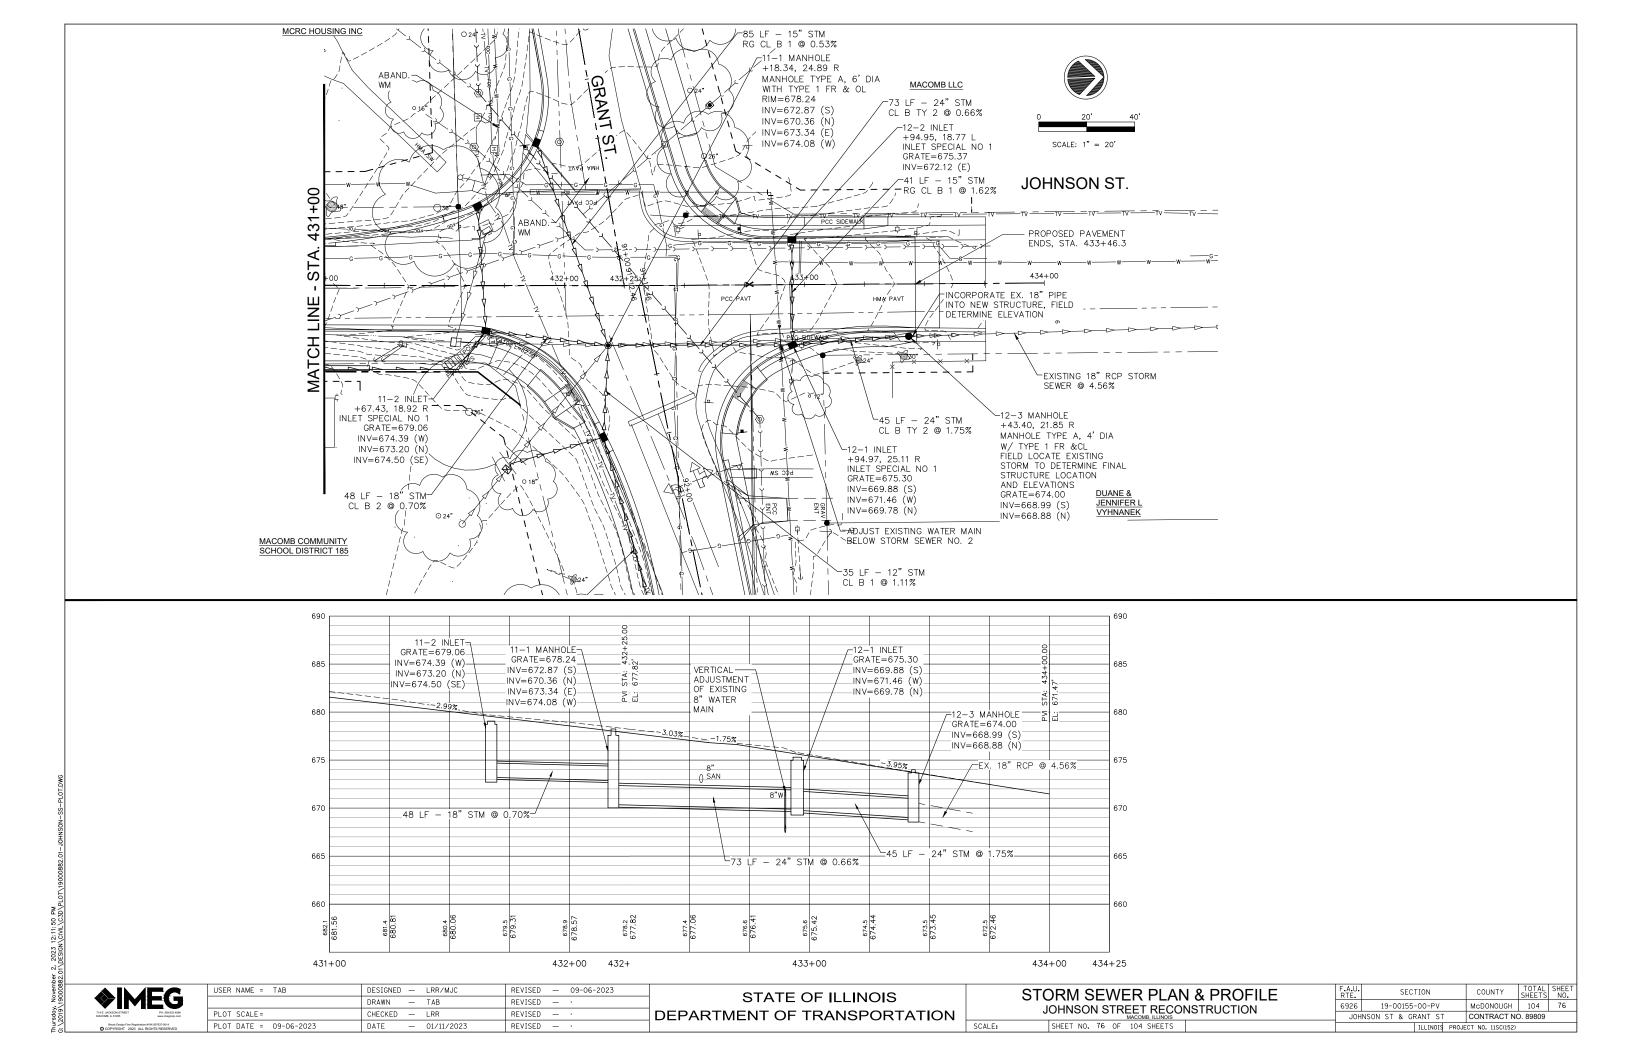

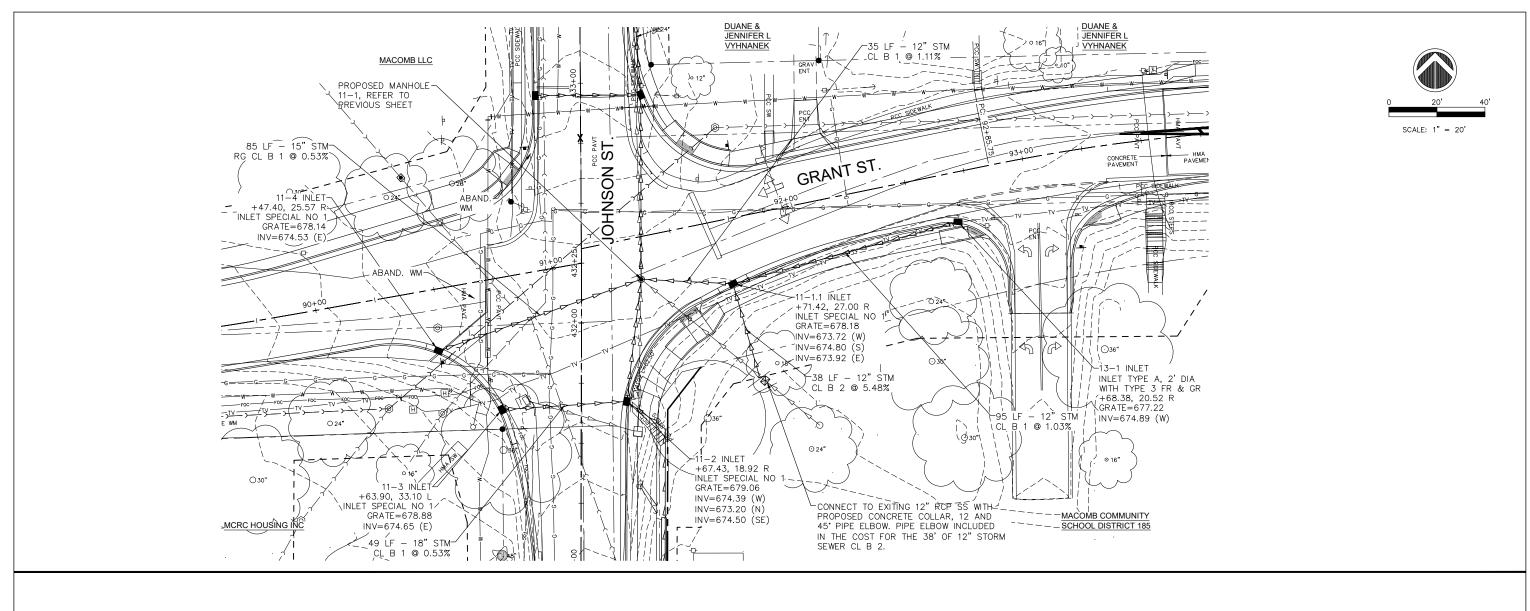

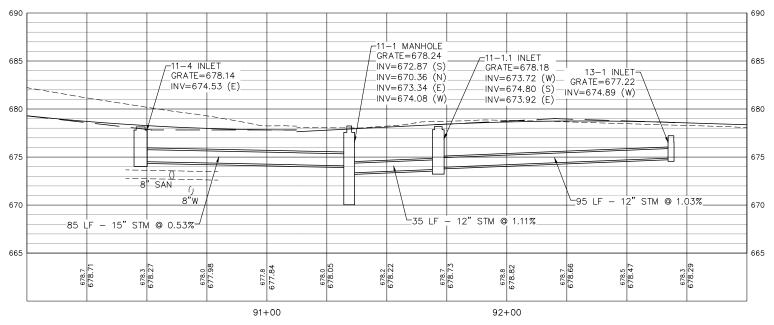


♦ IMEG

714.6.ACASSISTRET
MACCAR, 6.0465


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MACCAR, 6.0465

STORM SEWER PLAN AND PROFILE								
JOHNSON STREET RECONSTRUCTION MACOMB, ILLINOIS								
	SHEET NO. 77 OF 104	CHEETC						

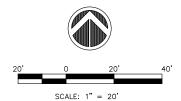

COUNTY BOARD OF TRUSTEES UNIT SCHOOL DISTRICT 185

STORM SEWER EASEMENT LT. STA. 420+00

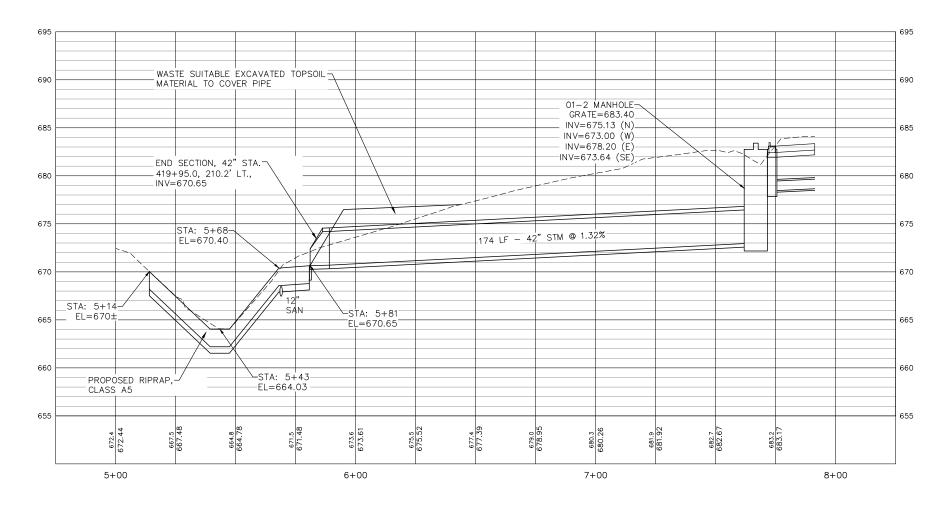


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MACOMB, IL 61455	www.imegcorp.com
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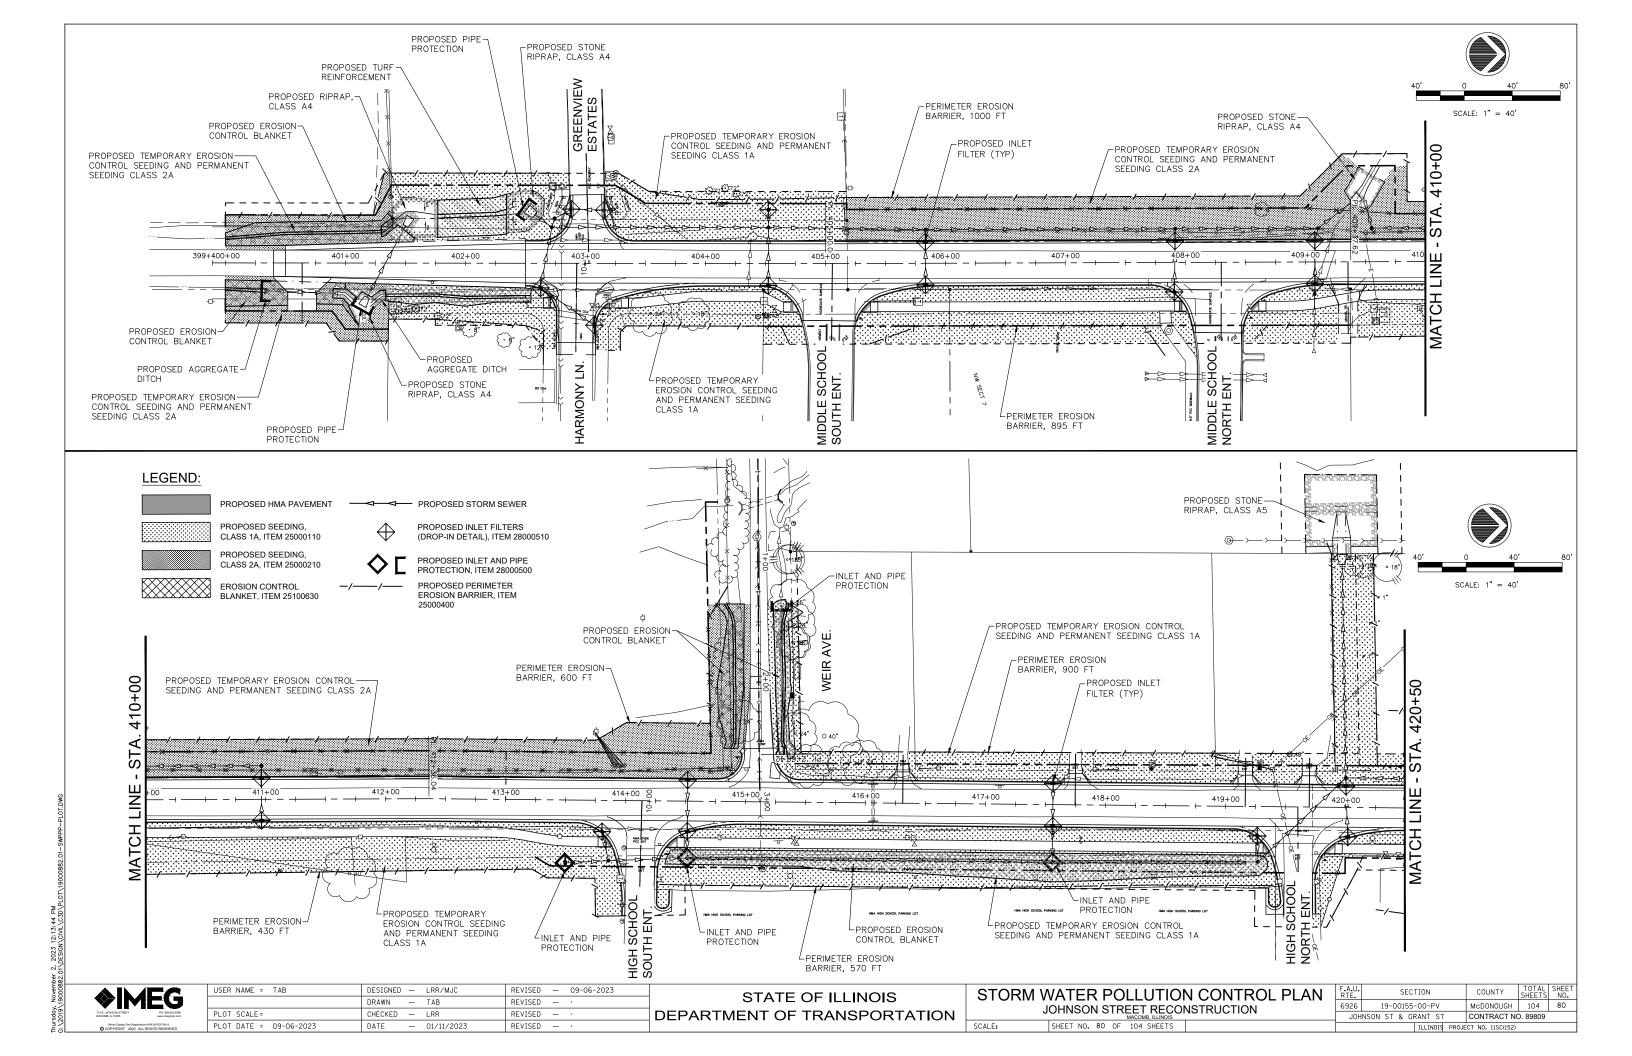
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PLOT DATE = 09-06-2023	DATE —	01/11/2023	REVISED —	•
	-			


STATE OF ILLINOIS	l
DEPARTMENT OF TRANSPORTATION	


OFFSITE STORM SEWER PLAN AND PROFILE								
JOHNSON STREET RECONSTRUCTION								
SCALE:	SHEET NO.	78 (	F 104	SHEETS				

_E	F.A.U. RTE.	SEC.	TION		COUNTY	SHEETS	SHEET NO.	
	6926	19-00155	-00-PV	McD0N0UGH	104	78		
	JOH	NSON ST & GF	RANT ST		CONTRACT NO. 89809			
			ILLINOIS	PROJE	CT NO. 11SC(152)			



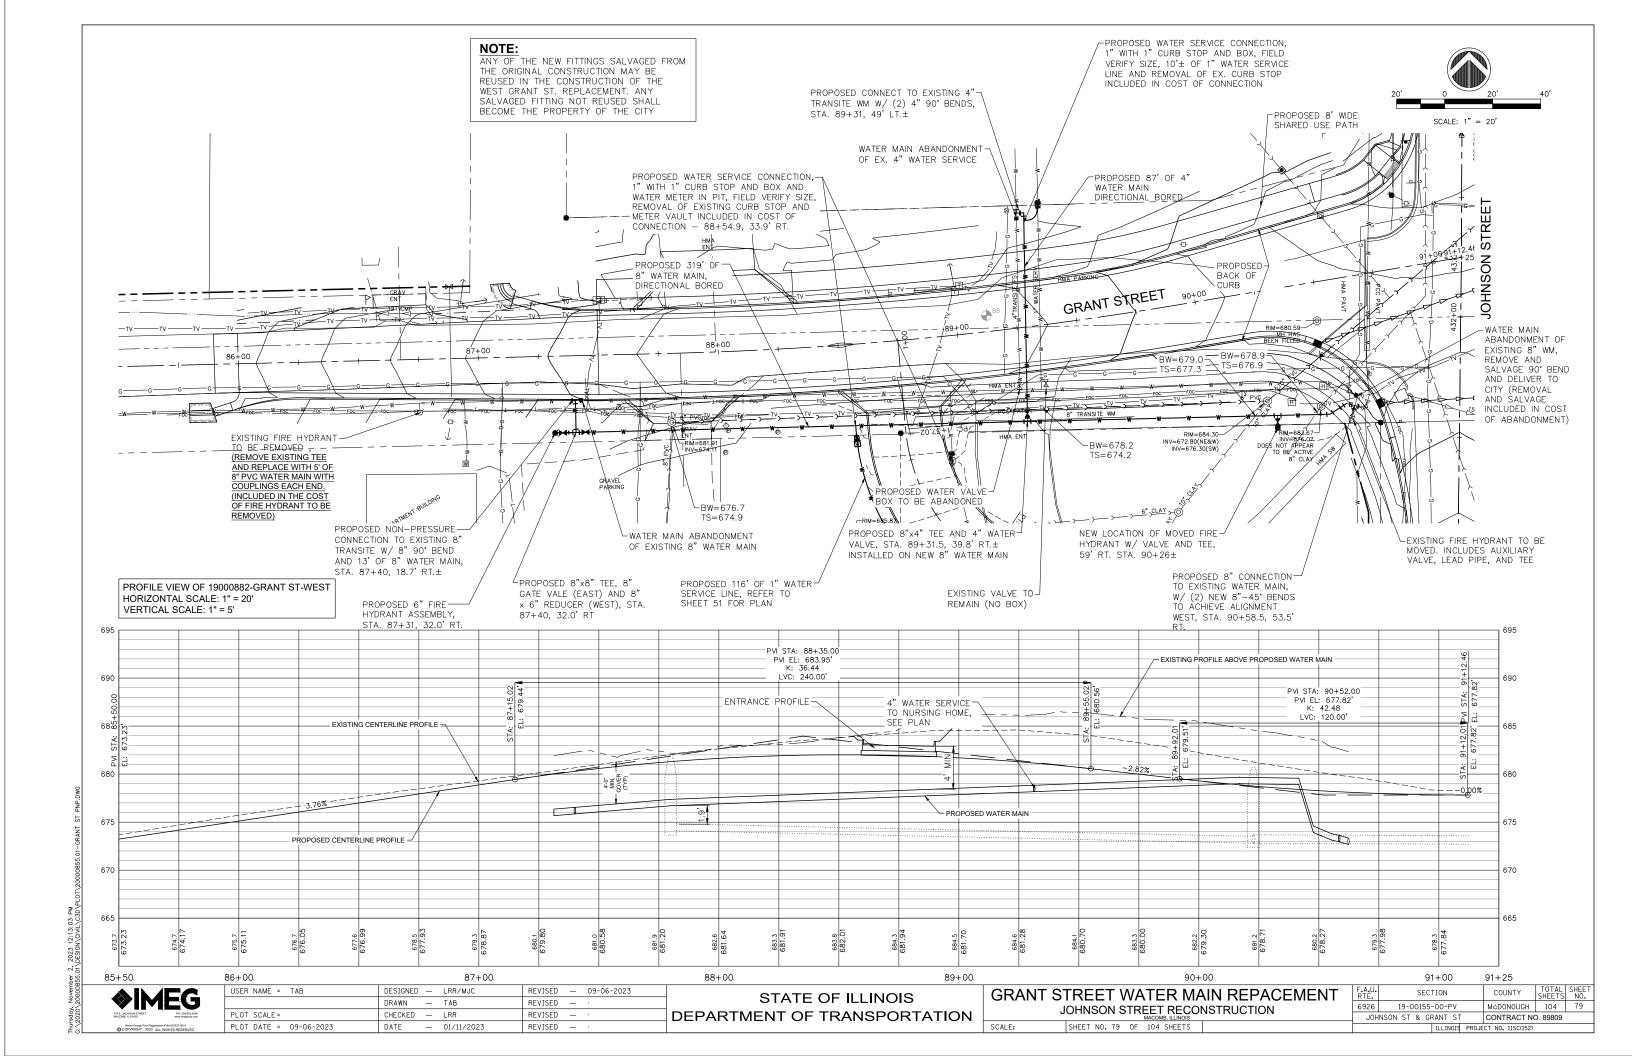


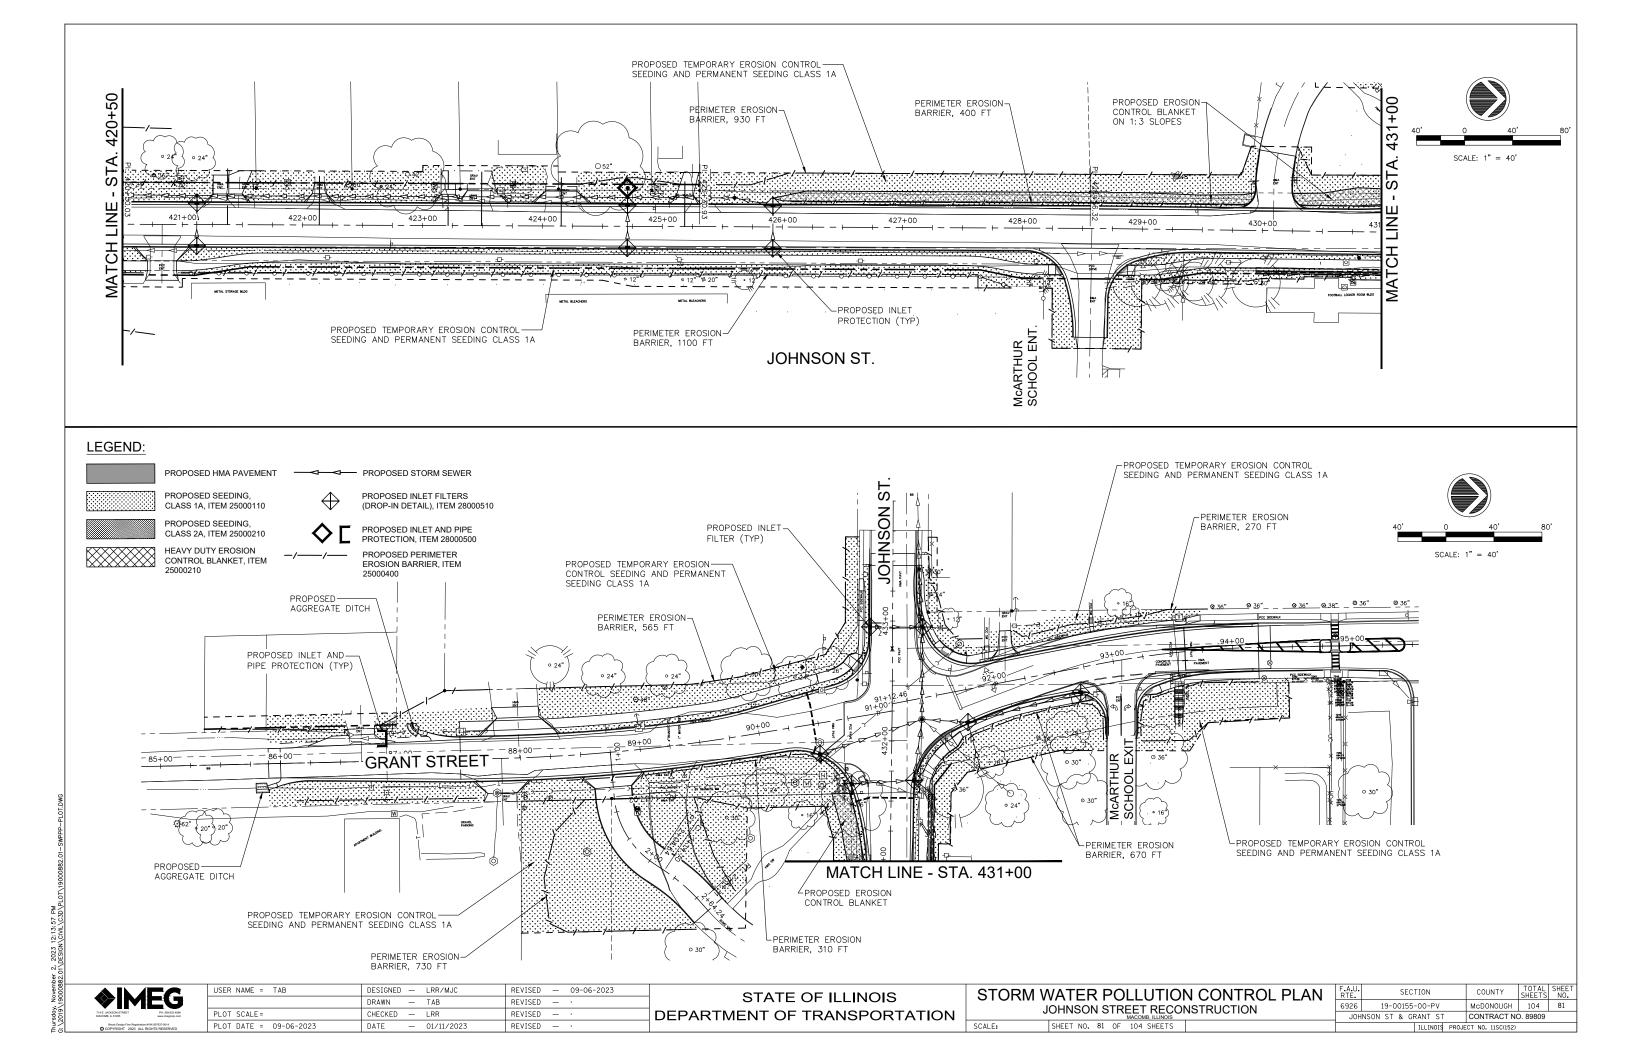

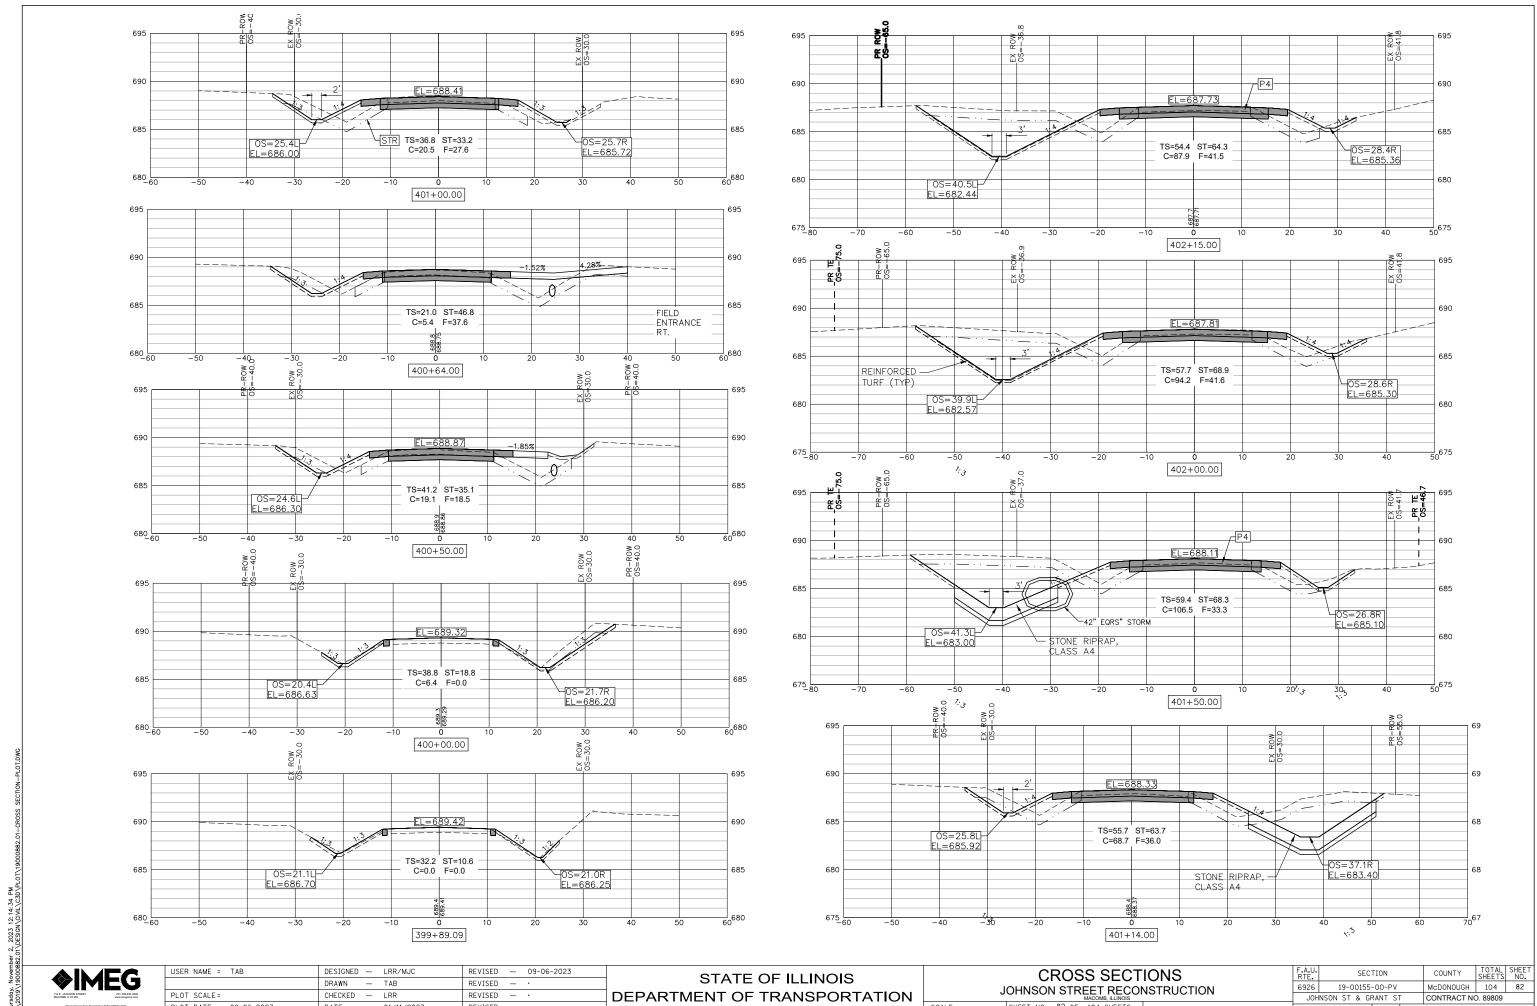

PLOT DATE = 09-06-2023 DATE - 01/11/2023 REVISED

SHEET NO. 82 OF 104 SHEETS

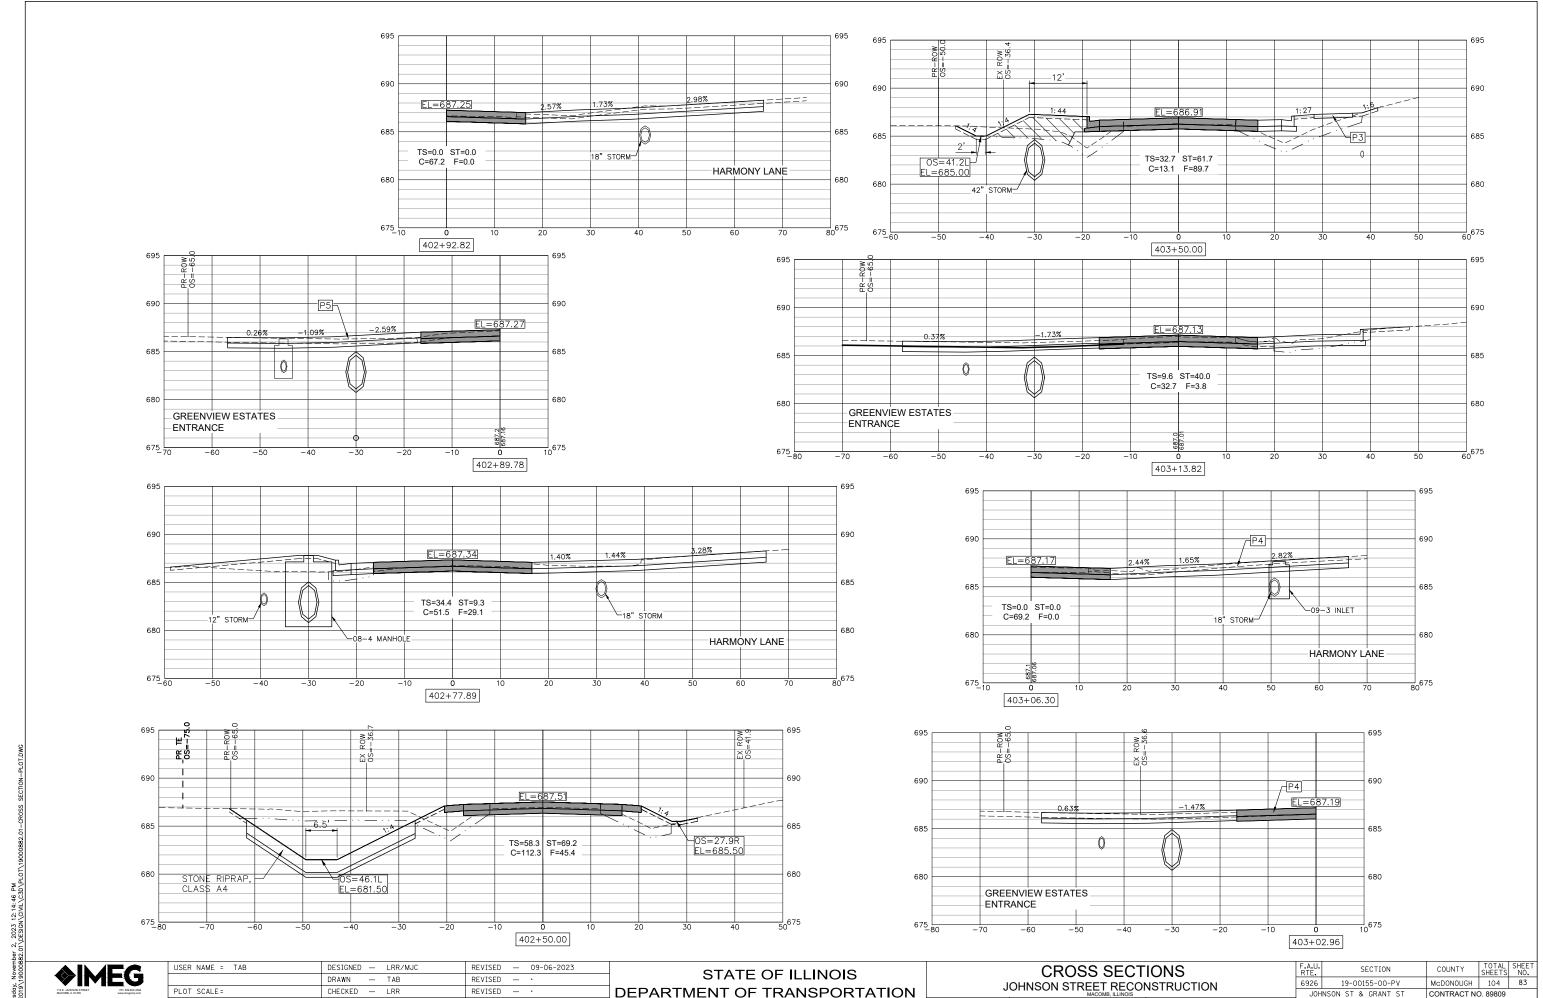



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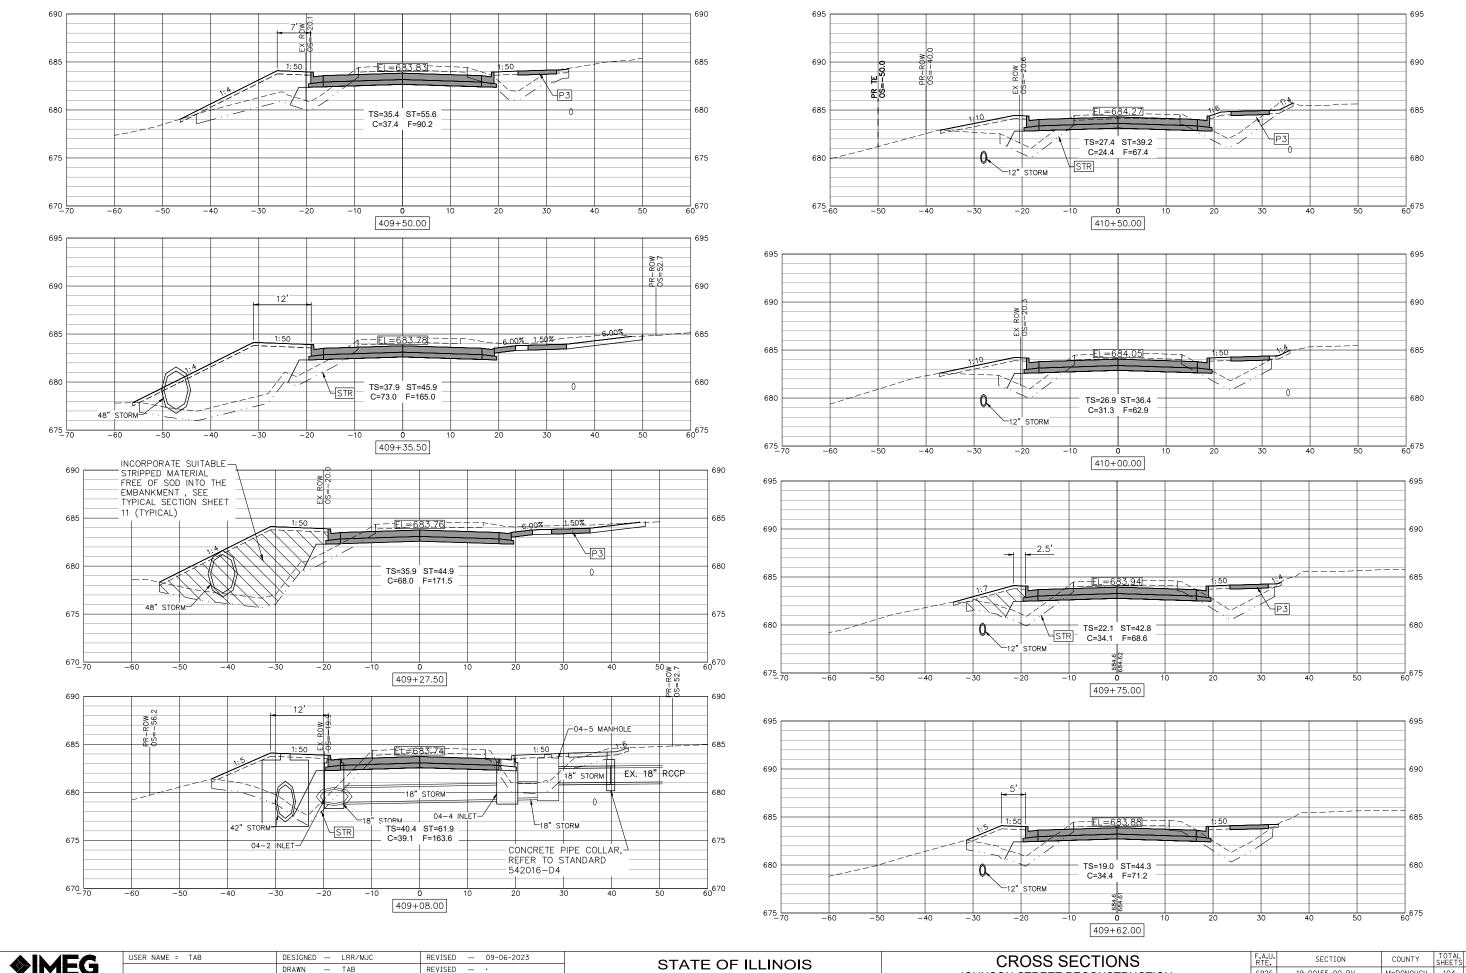
DEPARTMENT OF TRANSPORTATION

SHEET NO. 83 OF 104 SHEETS

CONTRACT NO. 89809 JOHNSON ST & GRANT ST



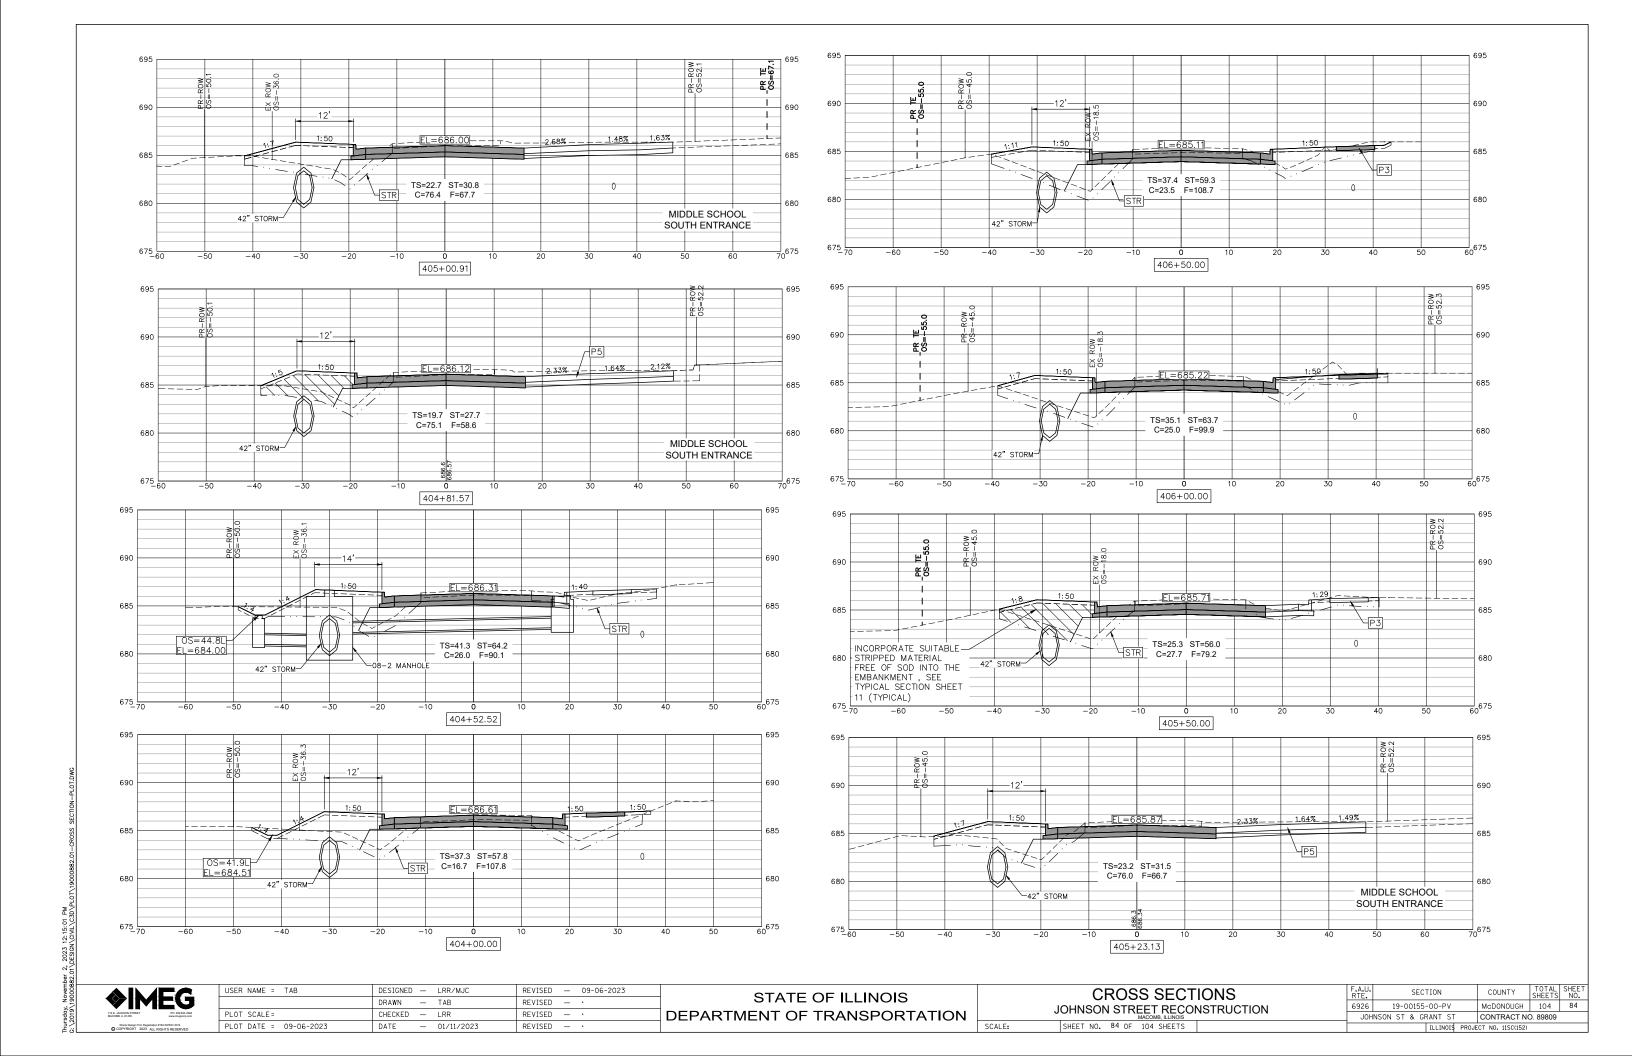

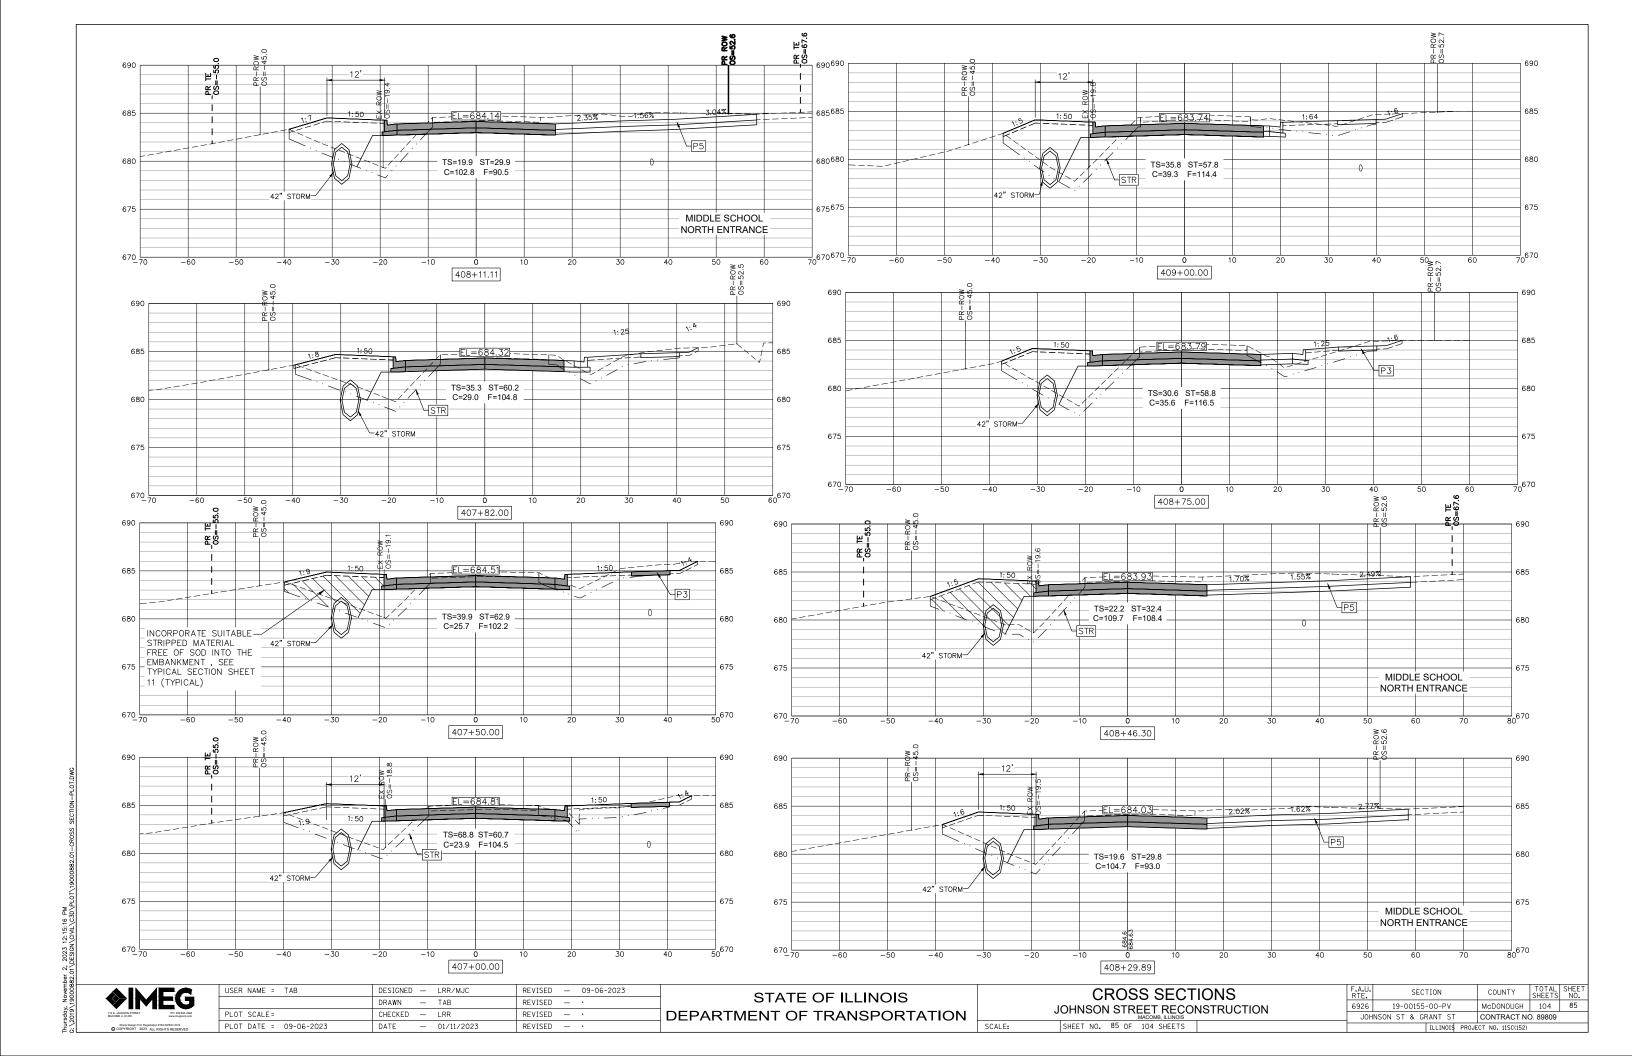



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STATE OF ILLINOIS
DEPARTMENT OF TRANSPORTATION

JOHNSON STREET RECONSTRUCTION

SHEET NO. 86 OF 104 SHEETS



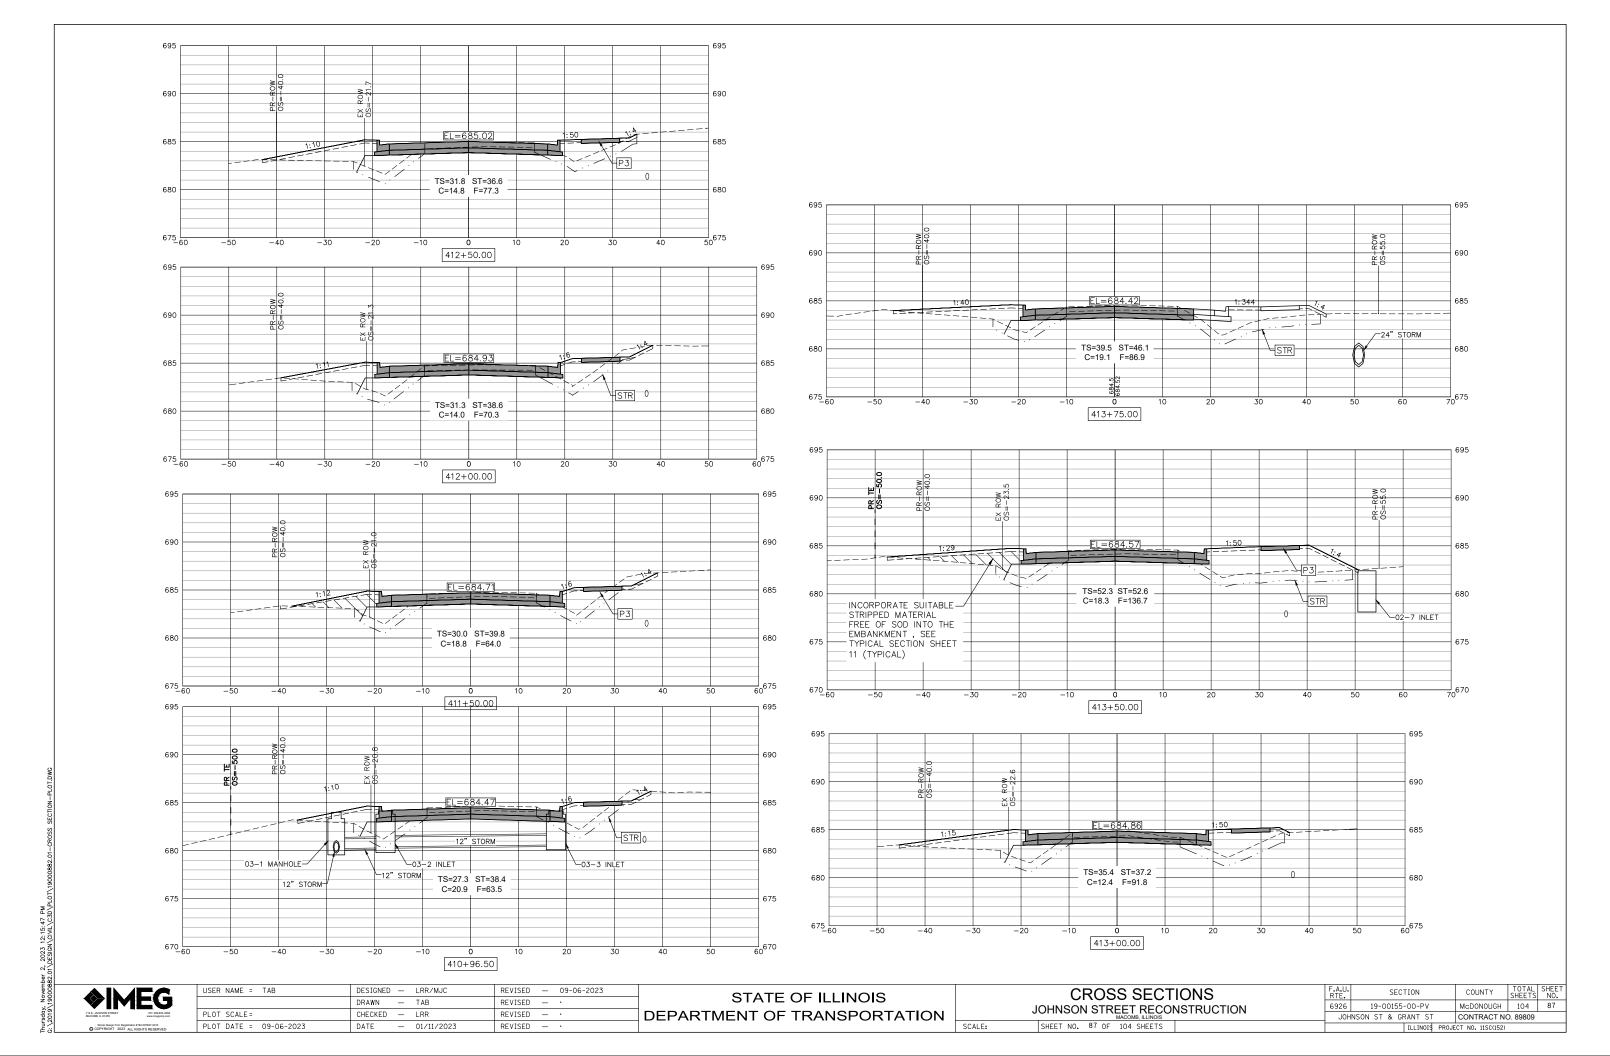

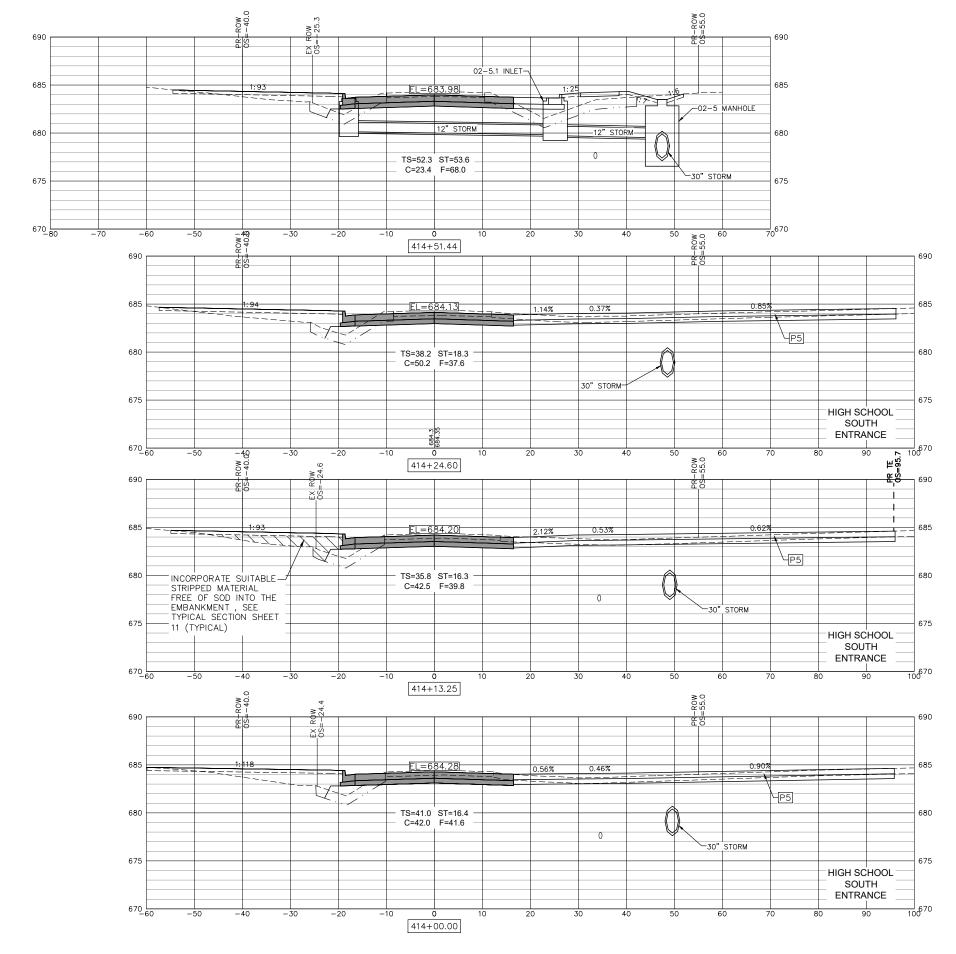
**♦IMEG** 


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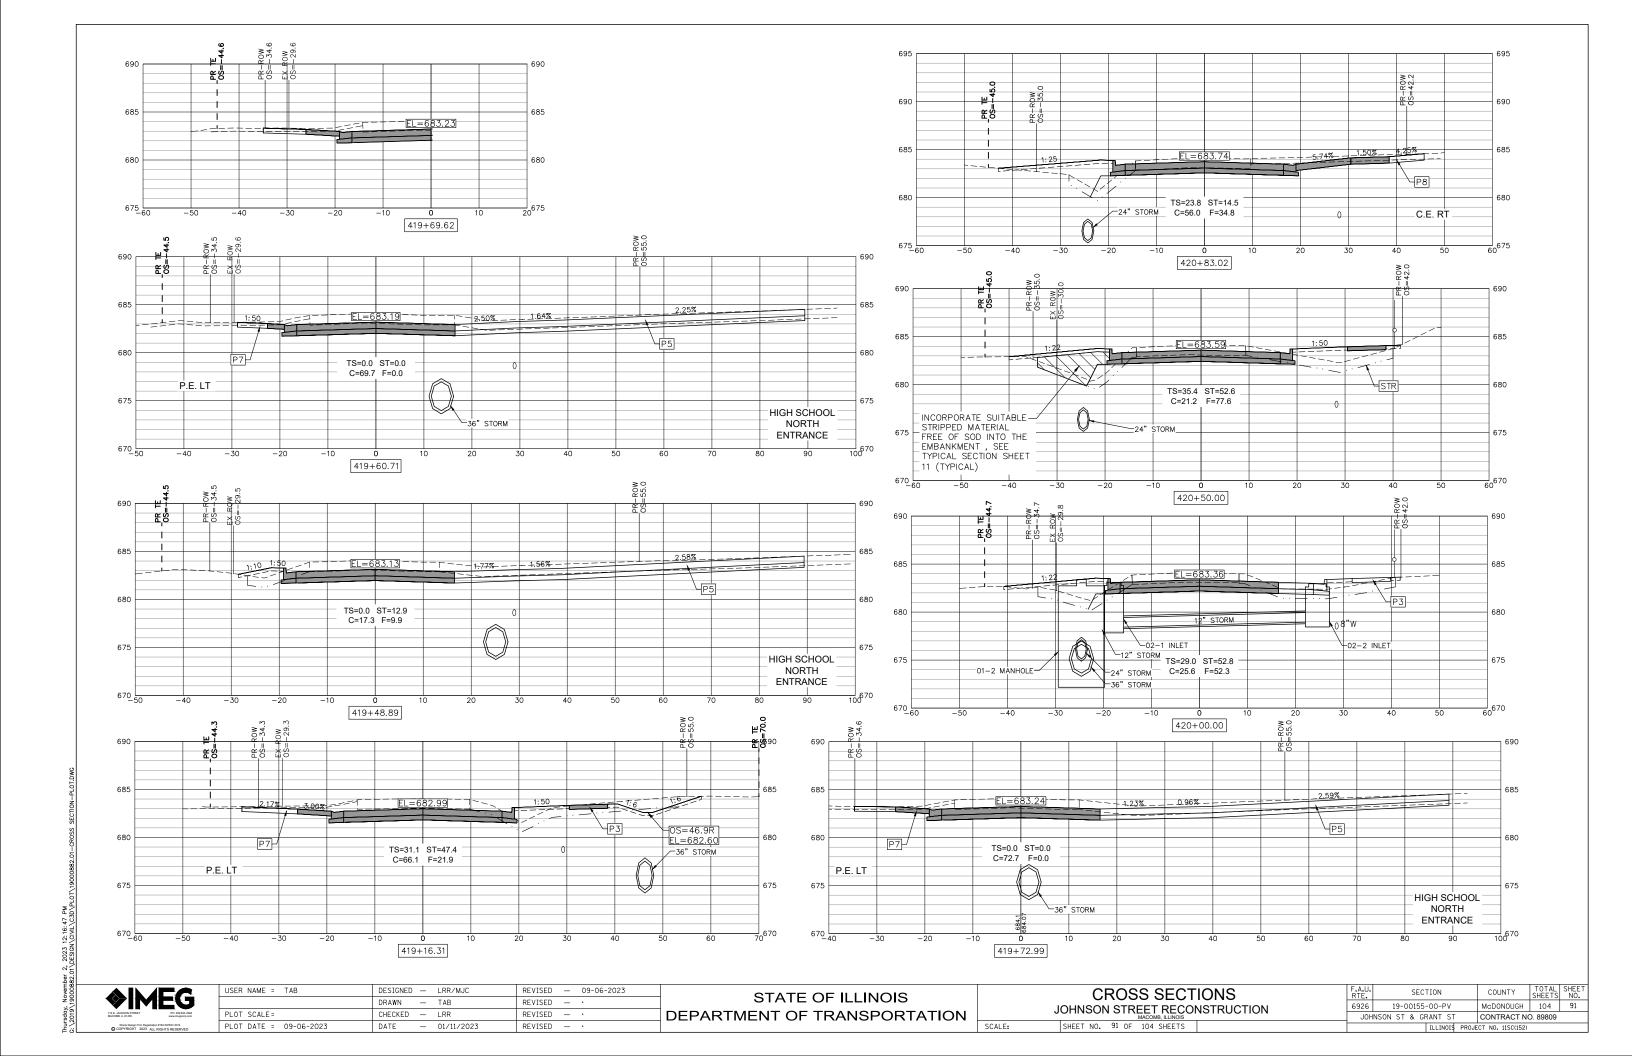
STATE OF ILLINOIS DEPARTMENT OF TRANSPORTATION


**CROSS SECTIONS** JOHNSON STREET RECONSTRUCTION SHEET NO. 88 OF 104 SHEETS

19-00155-00-PV McDONOUGH 104 88 JOHNSON ST & GRANT ST CONTRACT NO. 89809



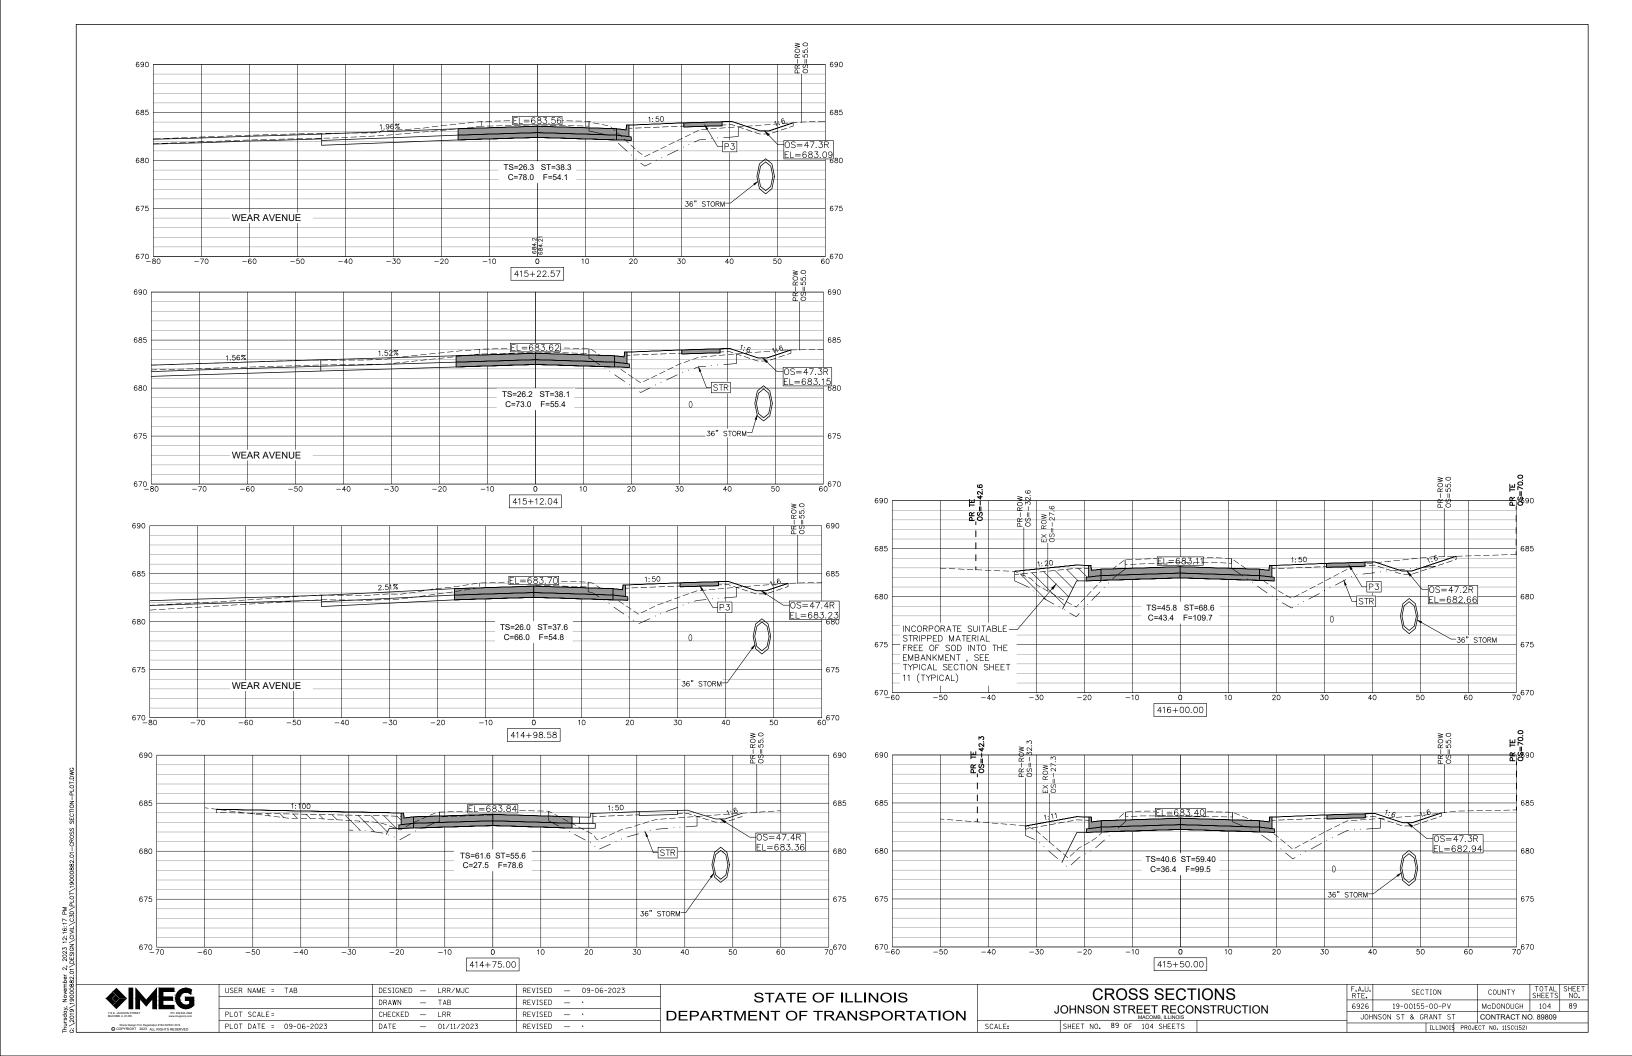

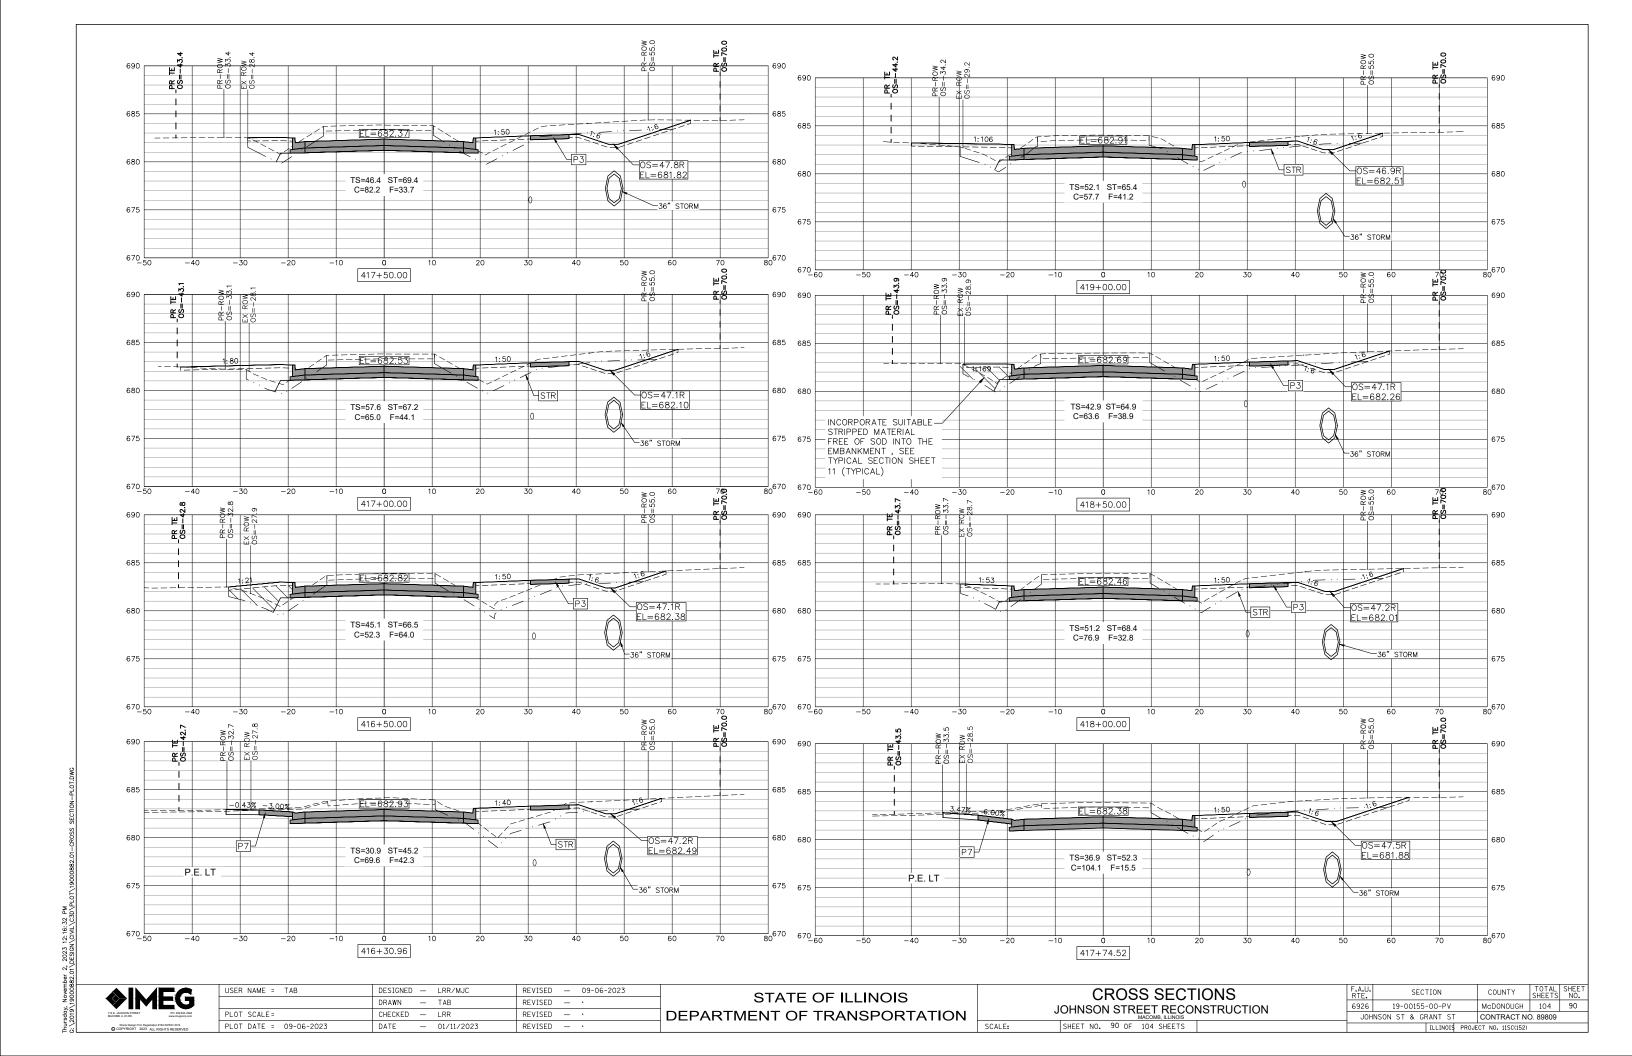


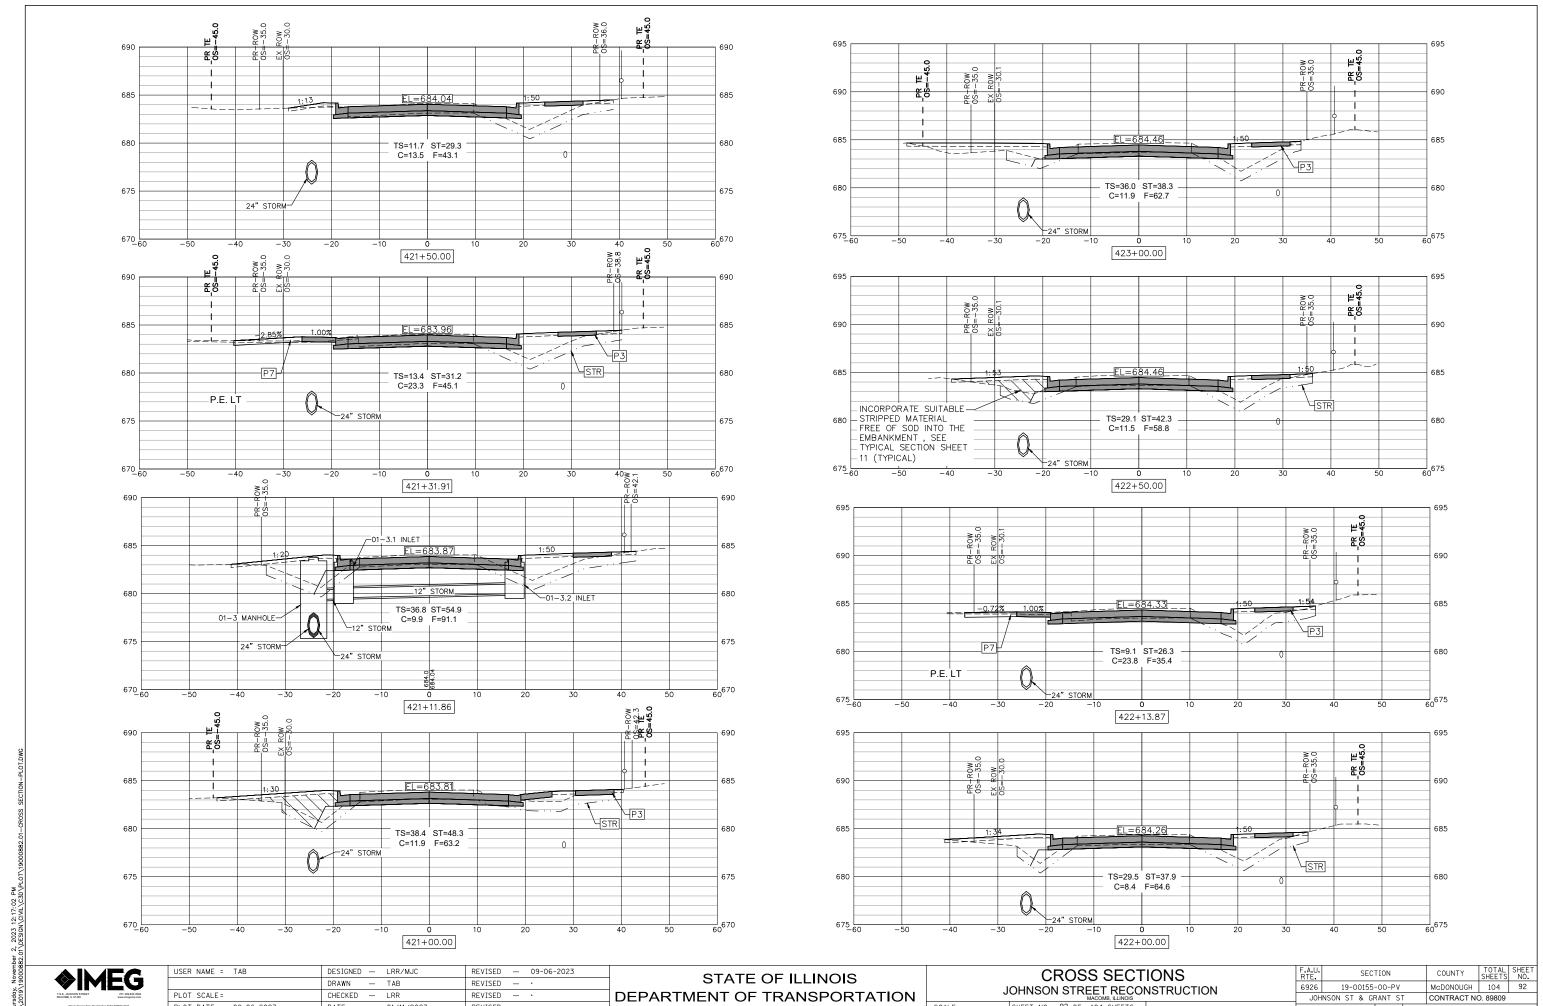


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SHEET NO. 92 OF 104 SHEETS

ILLINOIS PROJECT NO. 11SC(152)



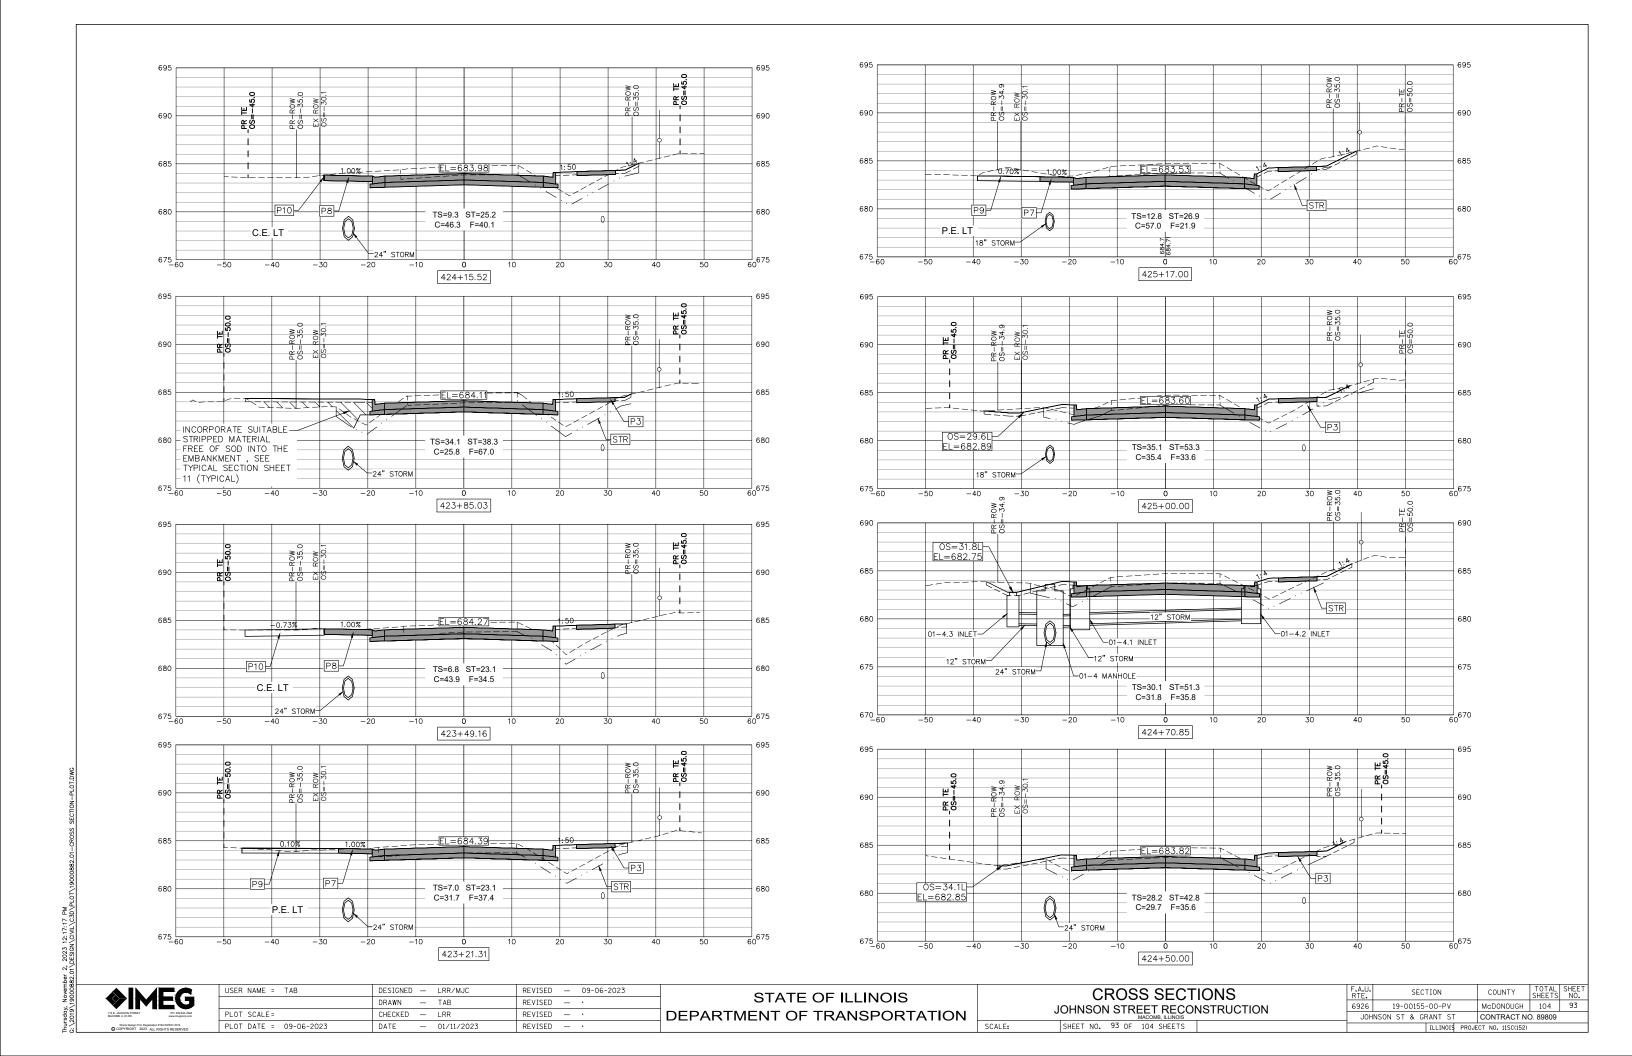

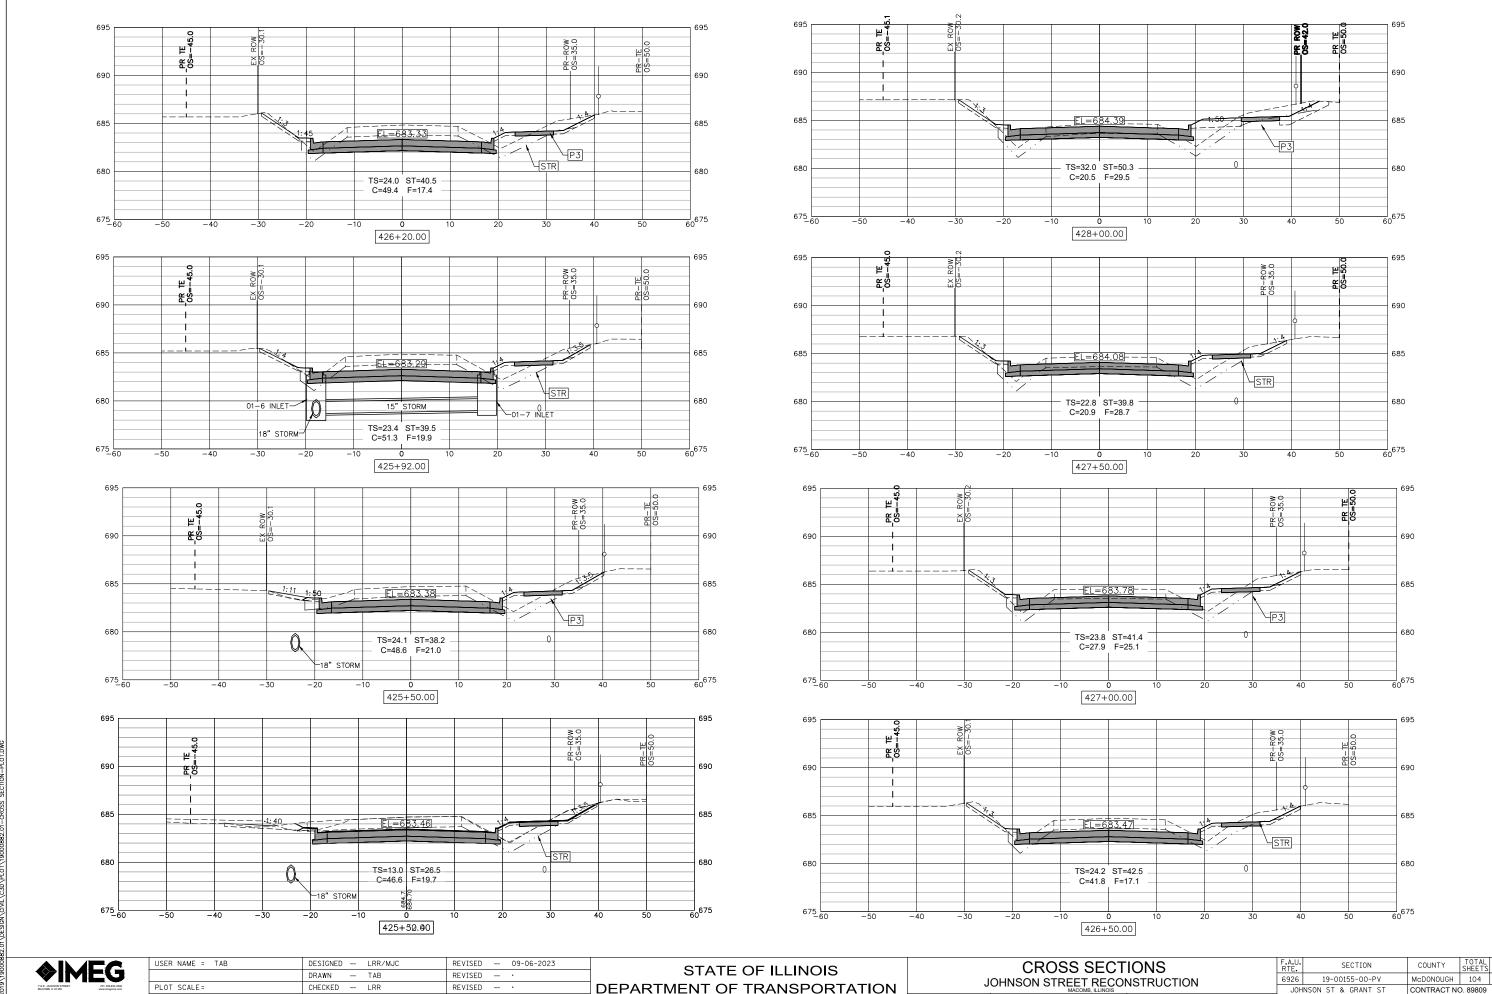
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DEPARTMENT OF TRANSPORTATION

SHEET NO. 94 OF 104 SHEETS

JOHNSON ST & GRANT ST CONTRACT NO. 89809

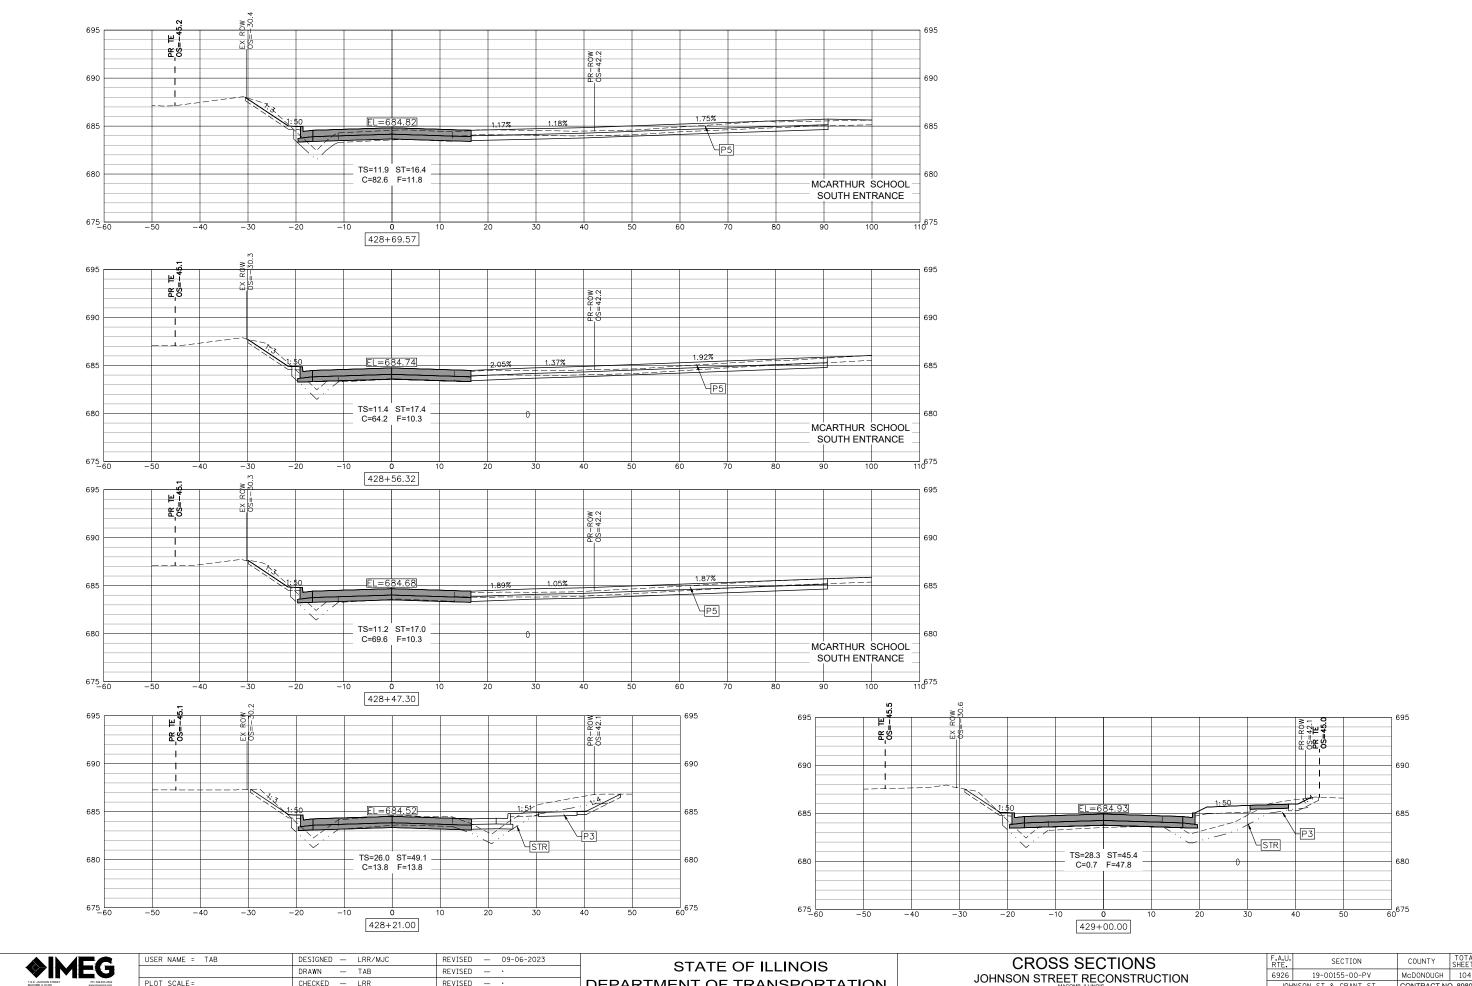


REVISED - · PLOT SCALE = CHECKED — LRR REVISED PLOT DATE = 09-06-2023 - 01/11/2023

DEPARTMENT OF TRANSPORTATION


SHEET NO. 95 OF 104 SHEETS

JOHNSON ST & GRANT ST CONTRACT NO. 89809

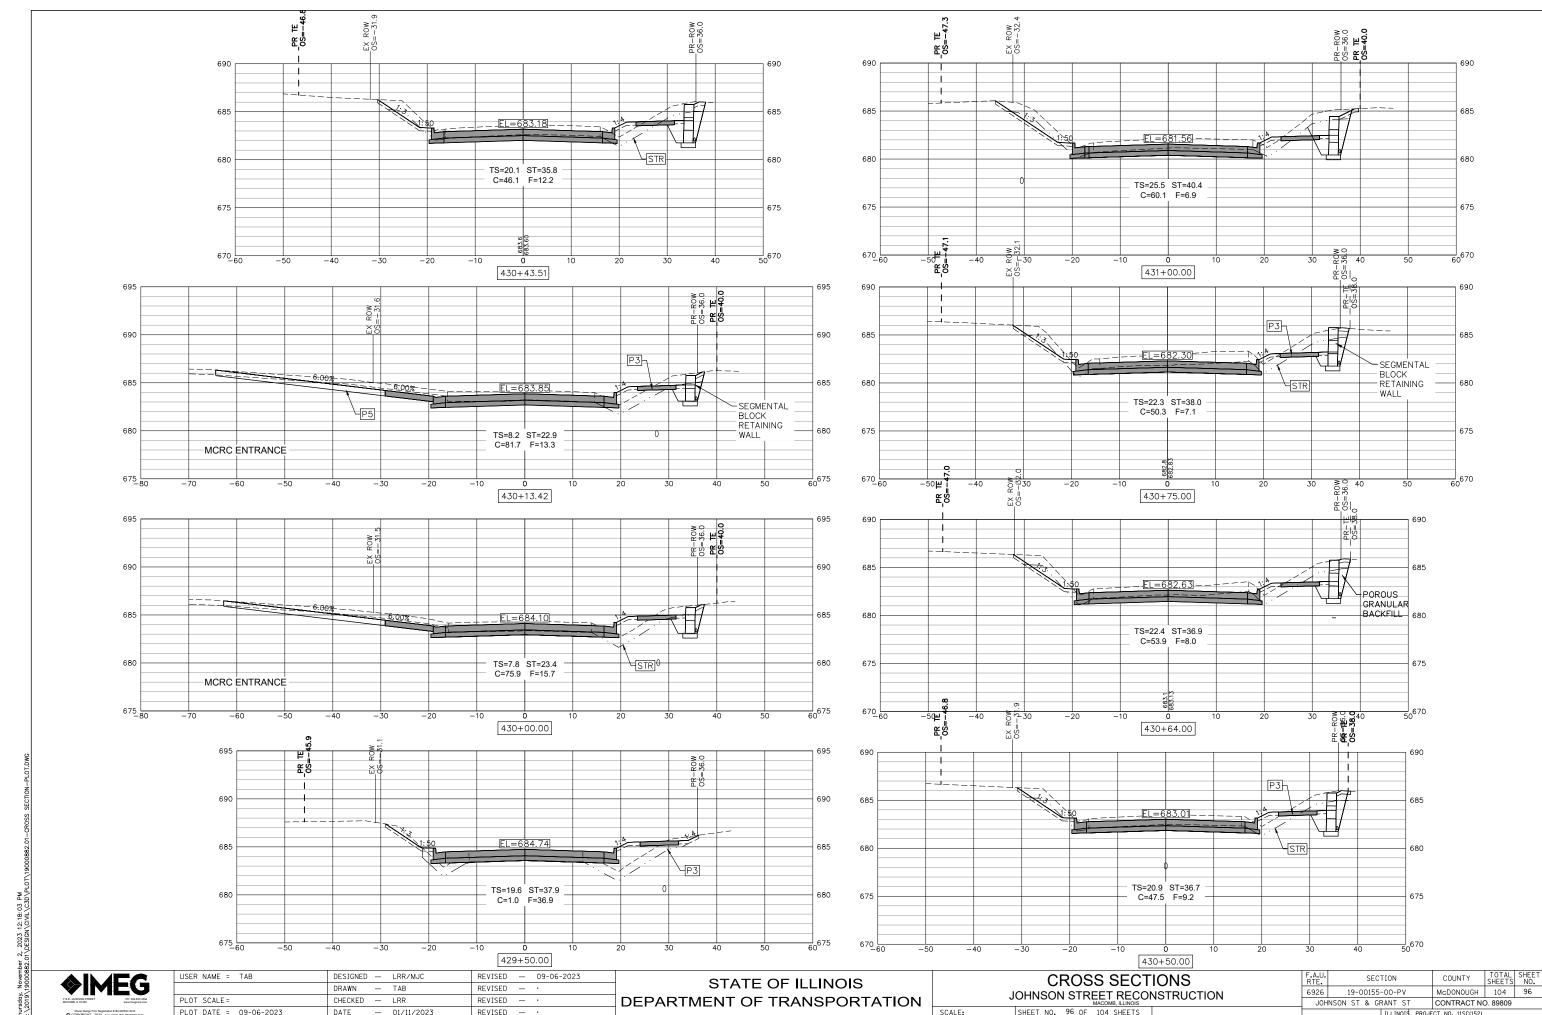

PLOT DATE = 09-06-2023 - 01/11/2023

SHEET NO. 96 OF 104 SHEETS

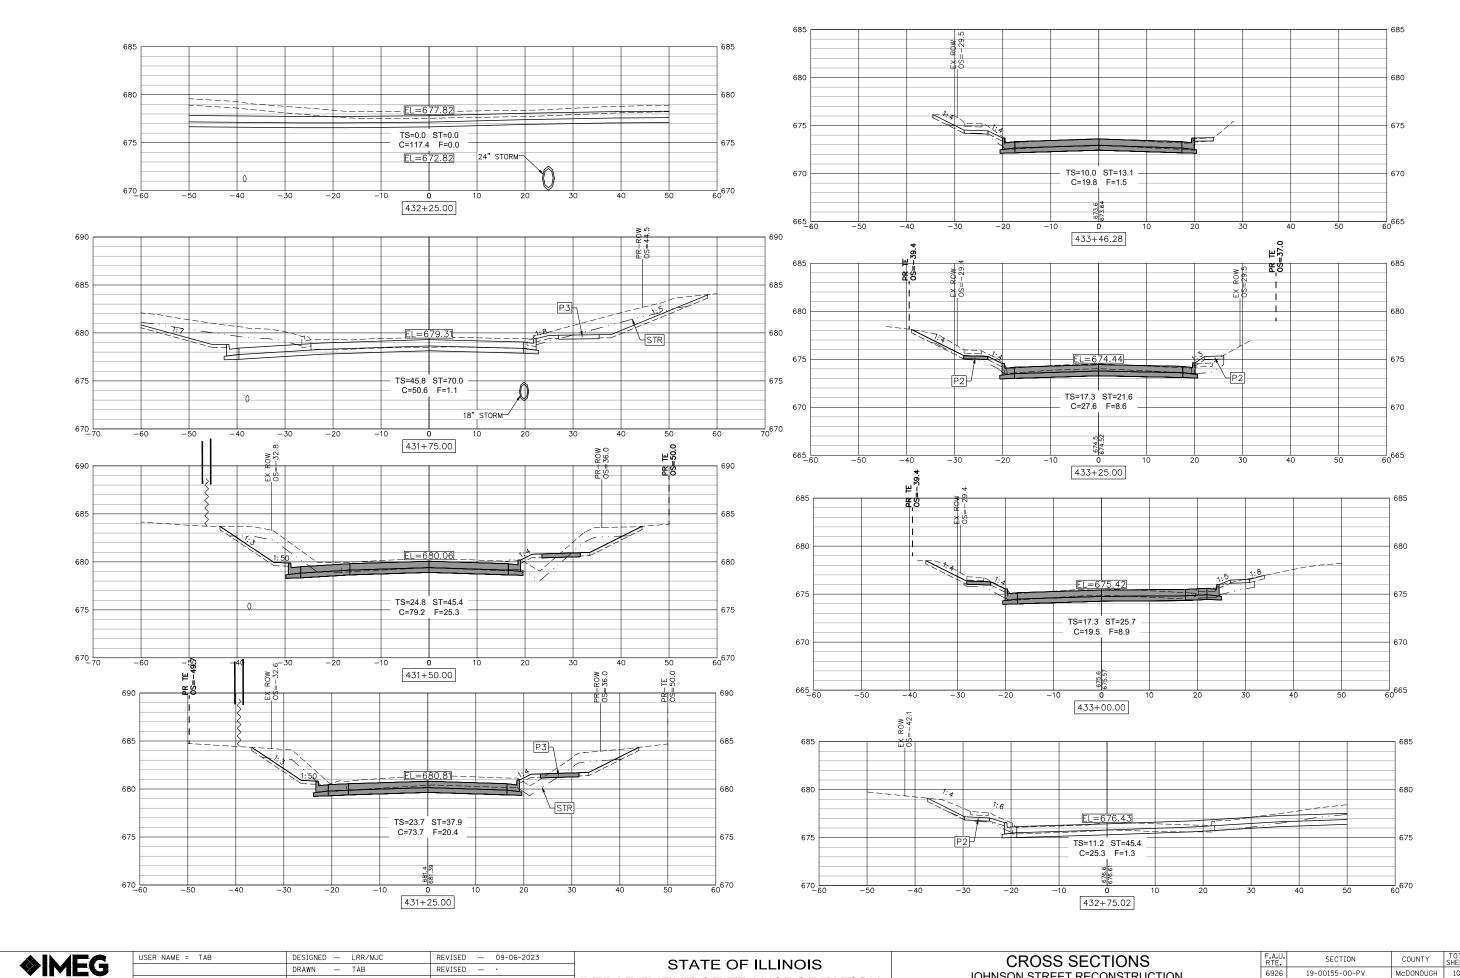


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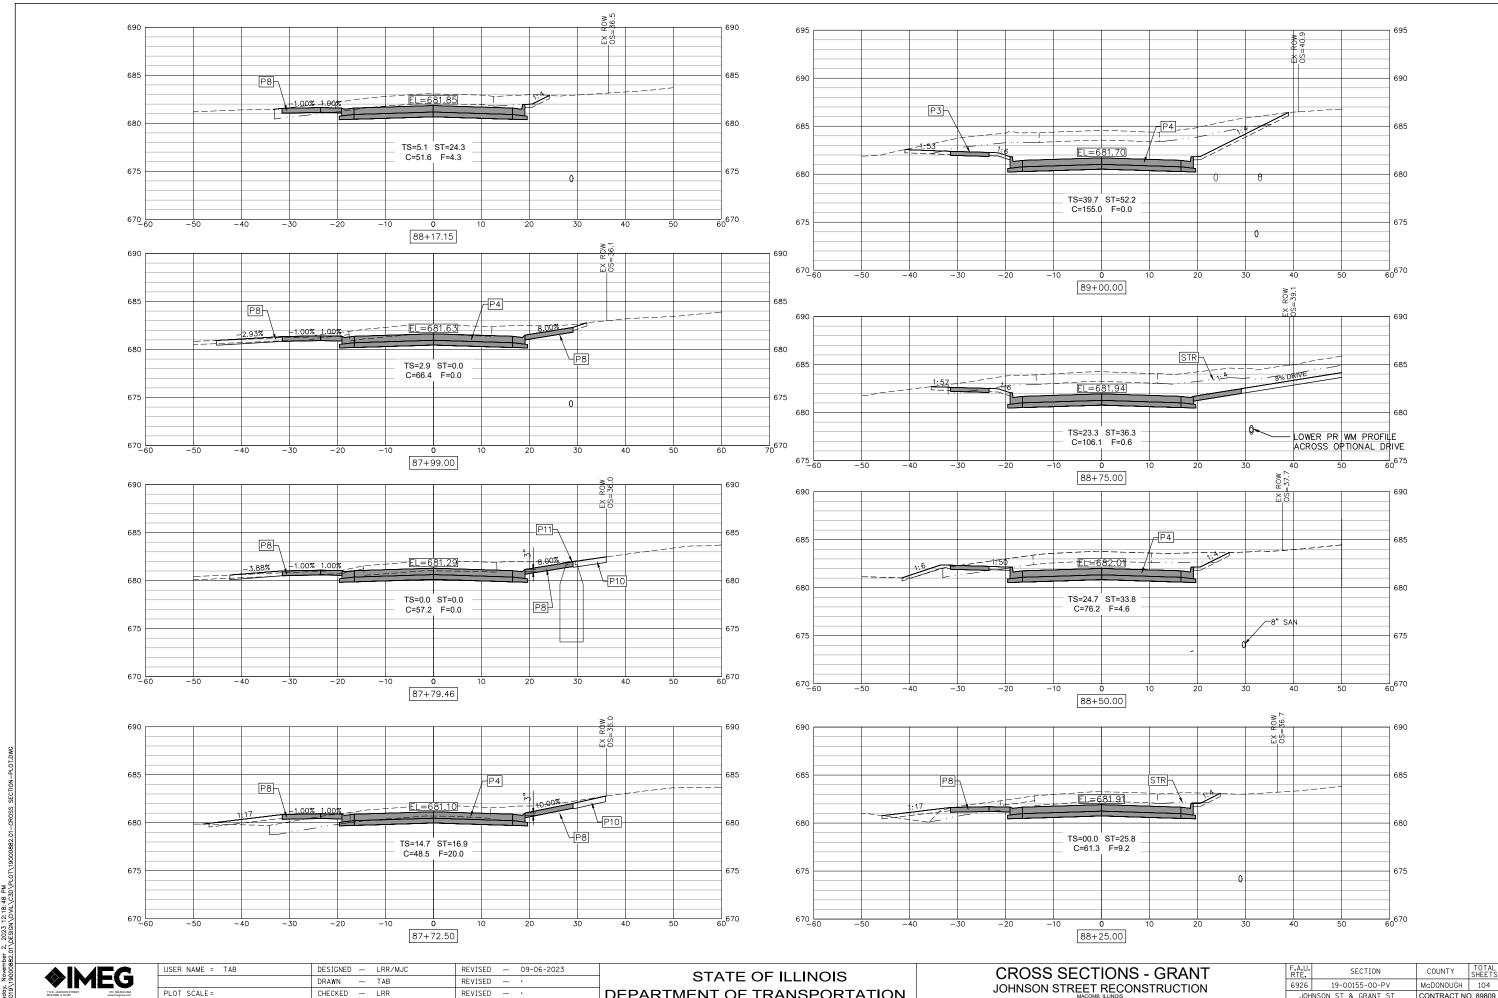
DEPARTMENT OF TRANSPORTATION

JOHNSON STREET RECONSTRUCTION

| SHEET NO. 97 OF 104 SHEETS |

19-00155-00-PV JOHNSON ST & GRANT ST CONTRACT NO. 89809



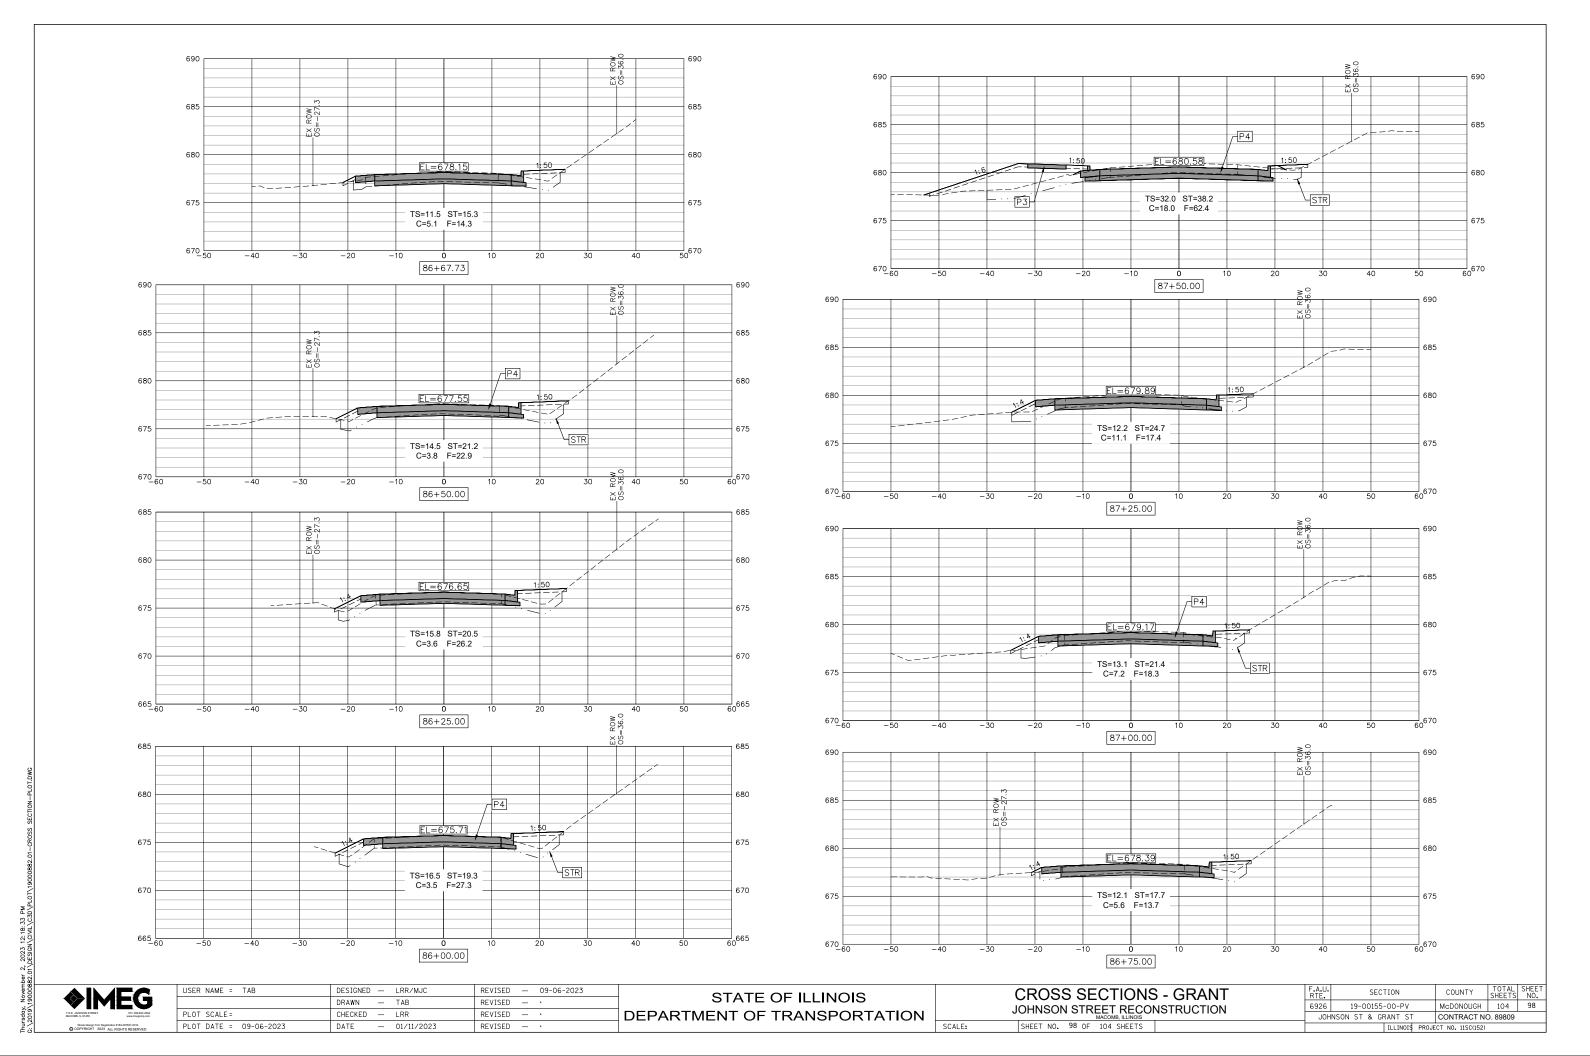



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DEPARTMENT OF TRANSPORTATION

SHEET NO. 99 OF 104 SHEETS


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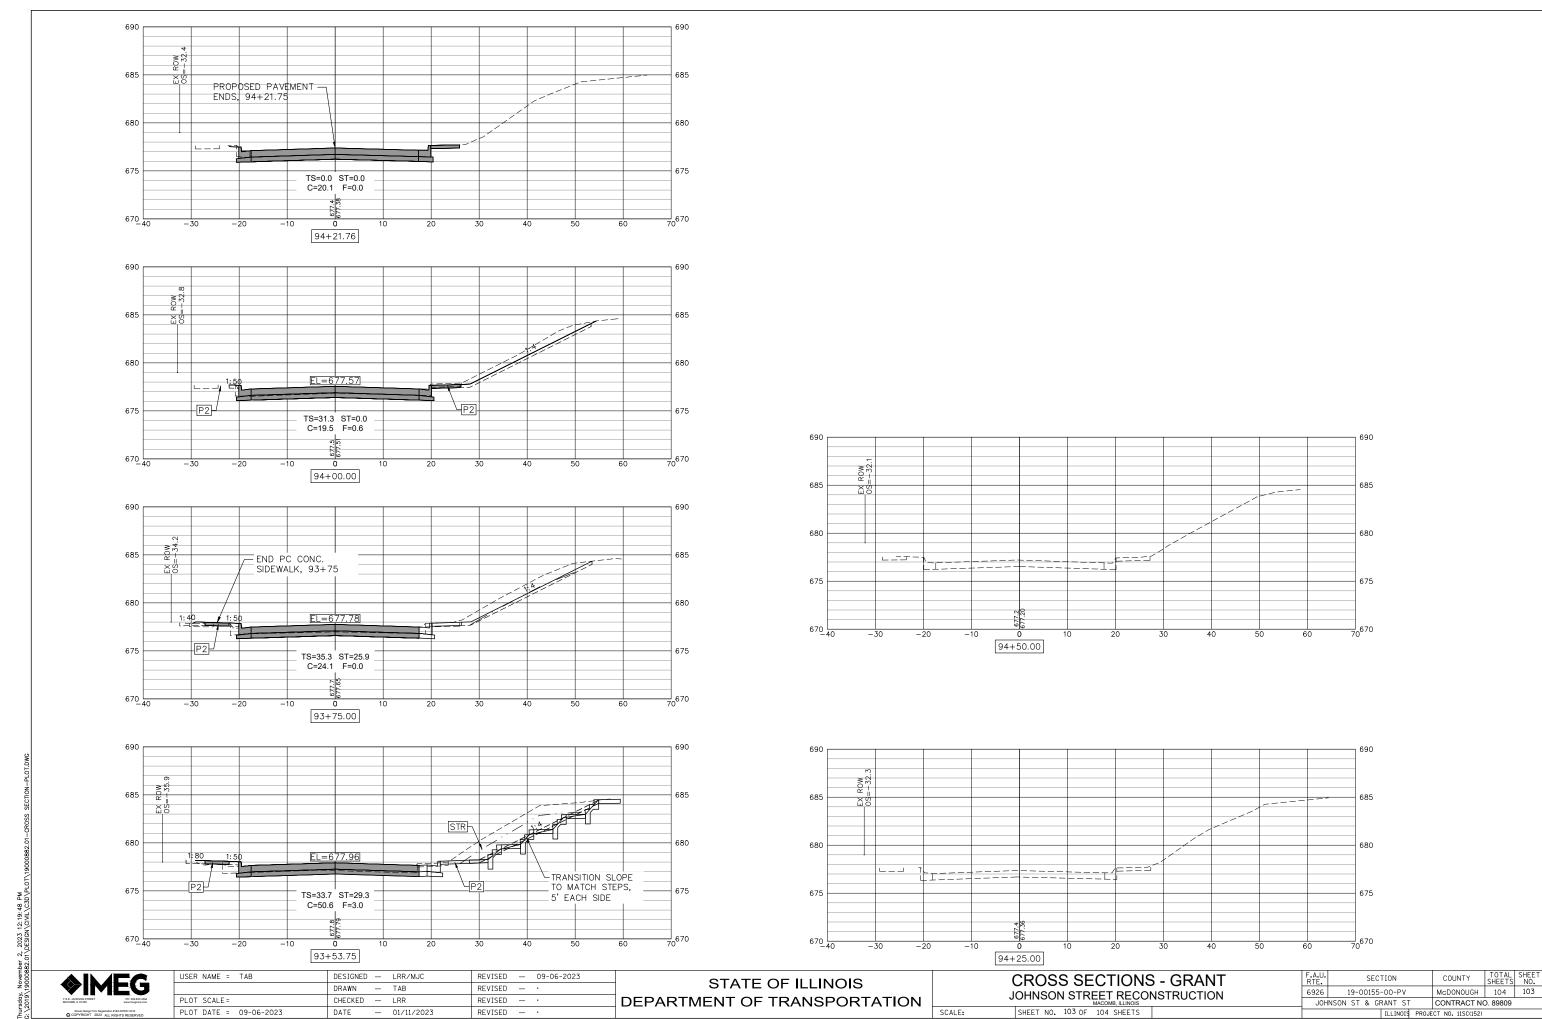


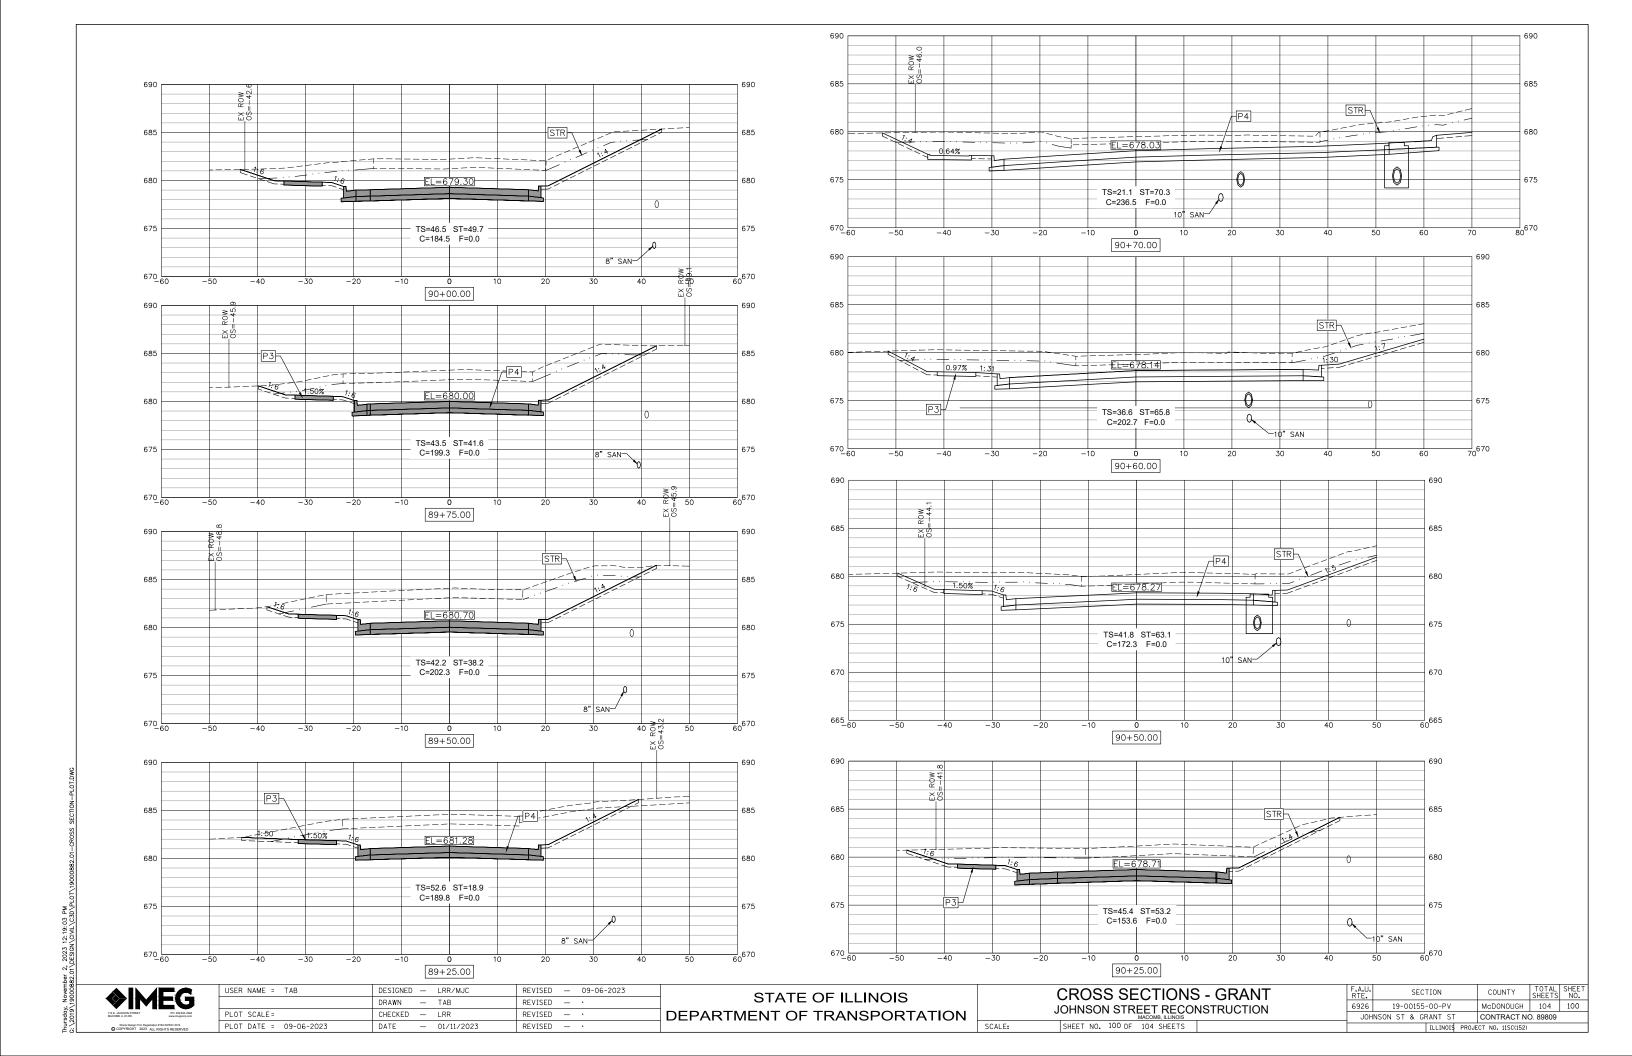


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STATE OF ILLINOIS DEPARTMENT OF TRANSPORTATION CROSS SECTIONS - GRANT
JOHNSON STREET RECONSTRUCTION
SHEET NO. 101 OF 104 SHEETS

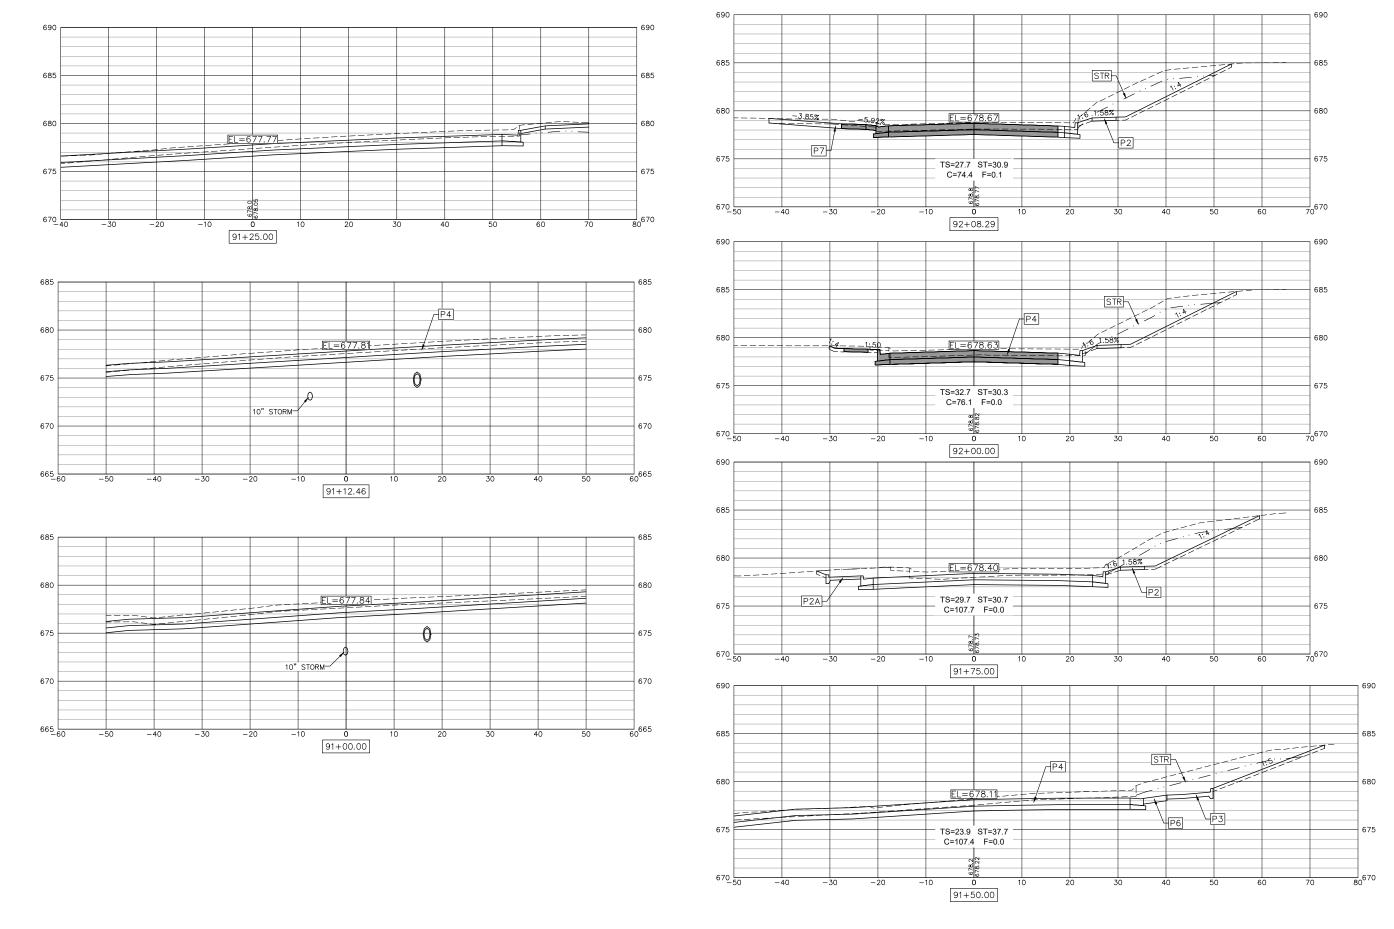



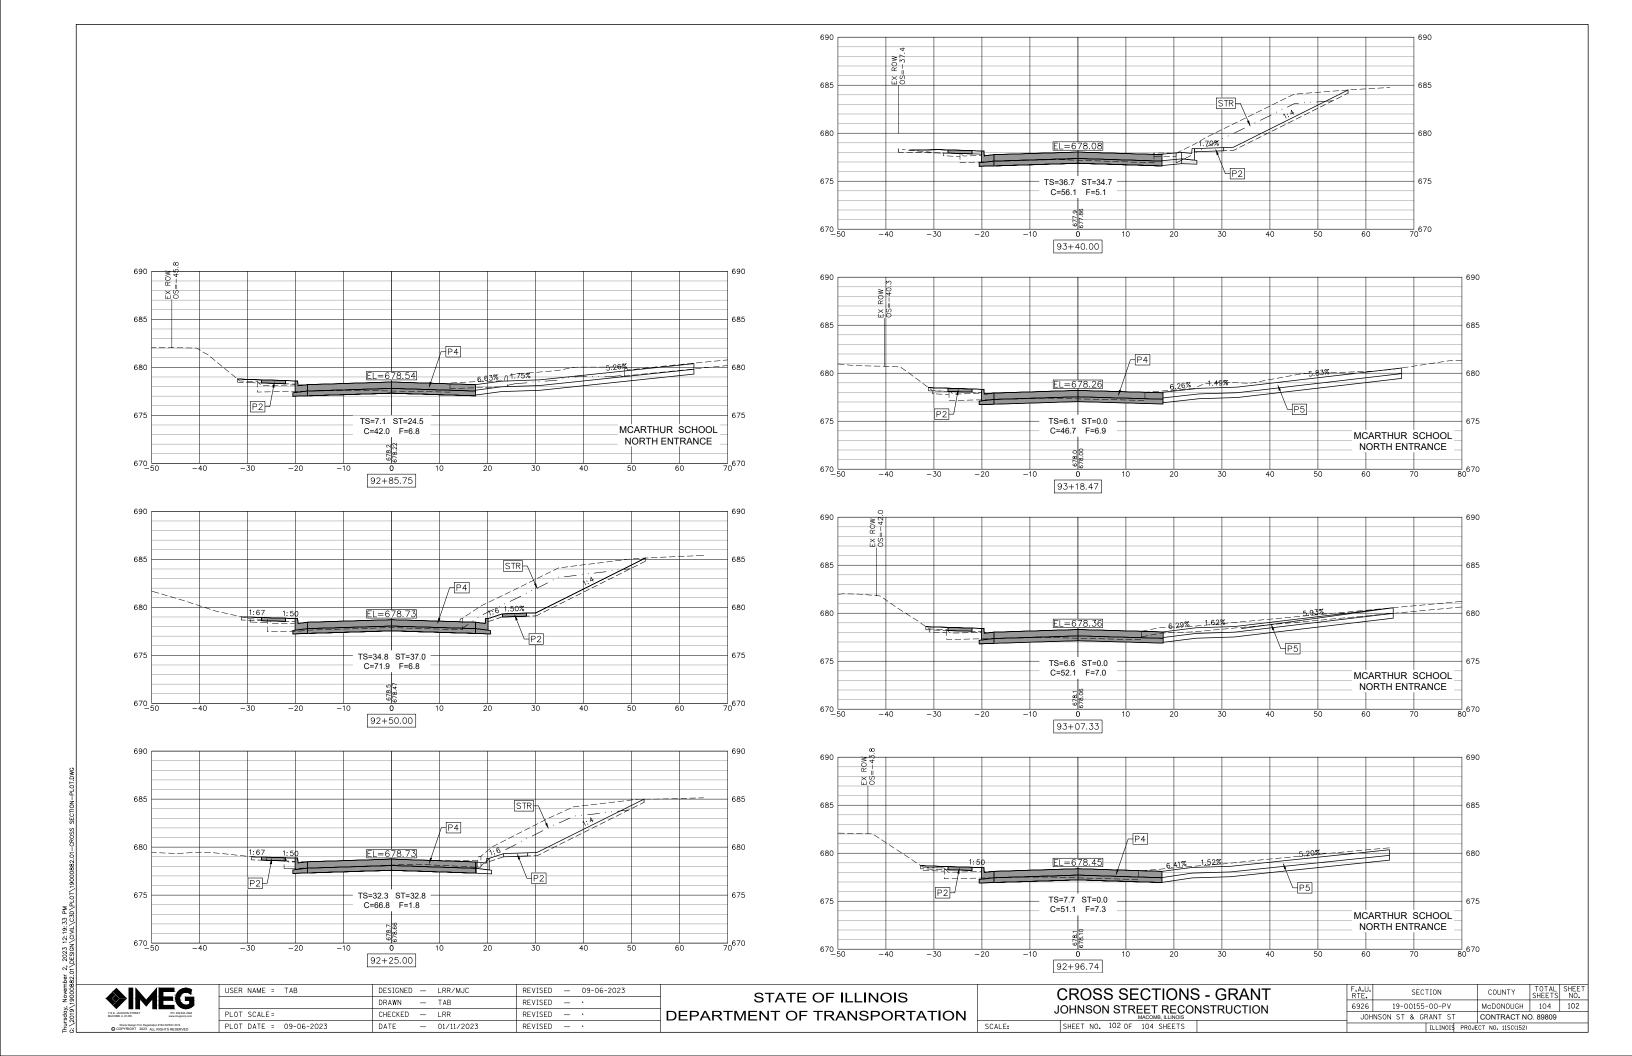

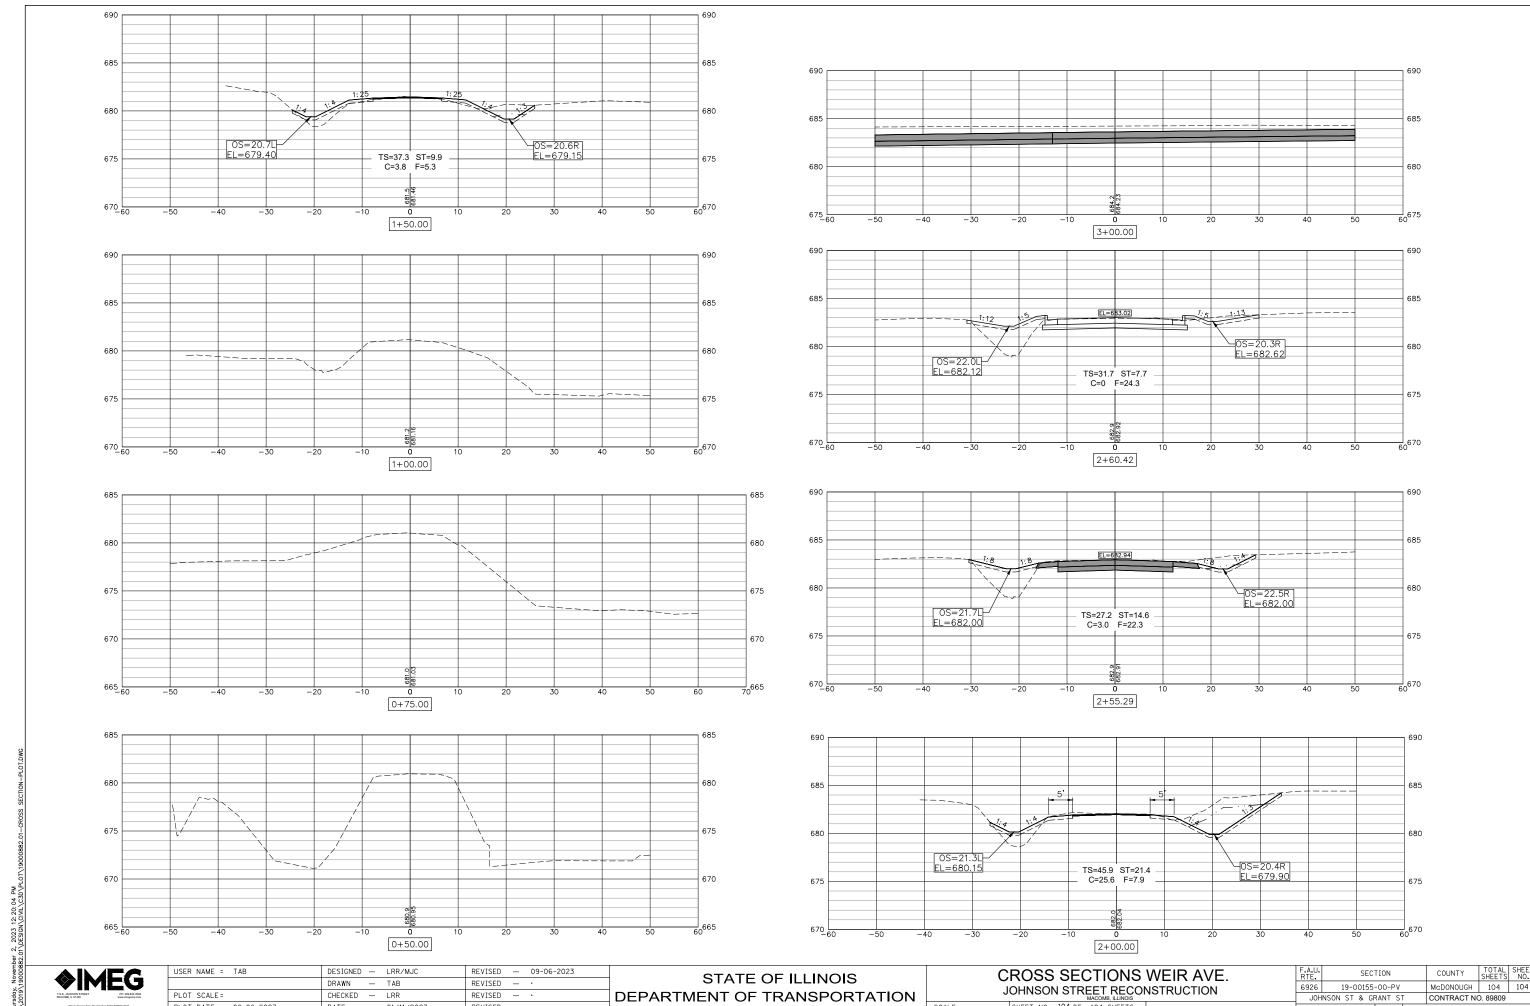REVISED - · PLOT DATE = 09-06-2023 - 01/11/2023

JOHNSON STREET RECONSTRUCTION

| SHEET NO. 104 OF 104 SHEETS |