

NOTES:


- TYPE 'E' INLET BOX SHALL BE 15' IN LENGTH ALONG THE EDGE OF PAVEMENT.
- CONTRACTOR SHALL REMOVE THE "CENTRAL AVE" SIGN PANEL BEFORE DEMOLITION AND STORE AND RE-ERECT THE PANEL AFTER THE DECK IS COMPLETE. THE COST OF STORAGE SHALL BE INCLUDED IN THE COST OF "RELOCATE SIGN PANEL -TYPE 2.
- FOR STORM SEWER CONSTRUCTED UNDER THE ROADWAY, BACKFILLING METHODS TWO AND THREE AUTHORIZED UNDER THE PROVISIONS OF ARTICLE 550.07 OF THE STANDARD SPECIFICATIONS WILL NOT BE ALLOWED.
- FOR WORK OUTSIDE THE LIMITS OF BRIDGE APPROACH PAVEMENT, ALL REFERENCES IN THE HIGHWAY STANDARDS AND STANDARD SPECIFICATIONS FOR REINFORCEMENT, DOWEL BARS AND TIES BARS IN PAVEMENT, SHOULDERS, CURB, GUTTER, COMBINATION CURB AND GUTTER AND MEDIAN, AND CHAIR SUPPORTS FOR CRC PAVEMENT, SHALL BE EPOXY COATED, UNLESS NOTED ON THE PLANS.

GUARDRAIL SCHEDULE			
	TRAFF. BAR. TERM., TY 6	S. P. B. G. R. TY A, 6' POST	TRAFF. BAR. TERM., TY 1 SPL., TANG.
LOCATION	EACH	FT	EACH
A	1	100'	1
B	1	125'	1
C	1	125'	1
D	1	100'	1

BENCH MARK:
DISK SET IN CONCRETE 50' EAST OF
CL CENTRAL AVE. & 31' NORTH OF
CL 183rd ST.
ELEV. 696.42



* CONSTRUCT BRIDGE APPROACH PAVEMENT WITH MONOLITHIC B-6 CURB TO MEET TYPE 'E' INLET BOX CURB. COST SHALL BE INCLUDED IN BRIDGE APPROACH PAVEMENT P.C.C.

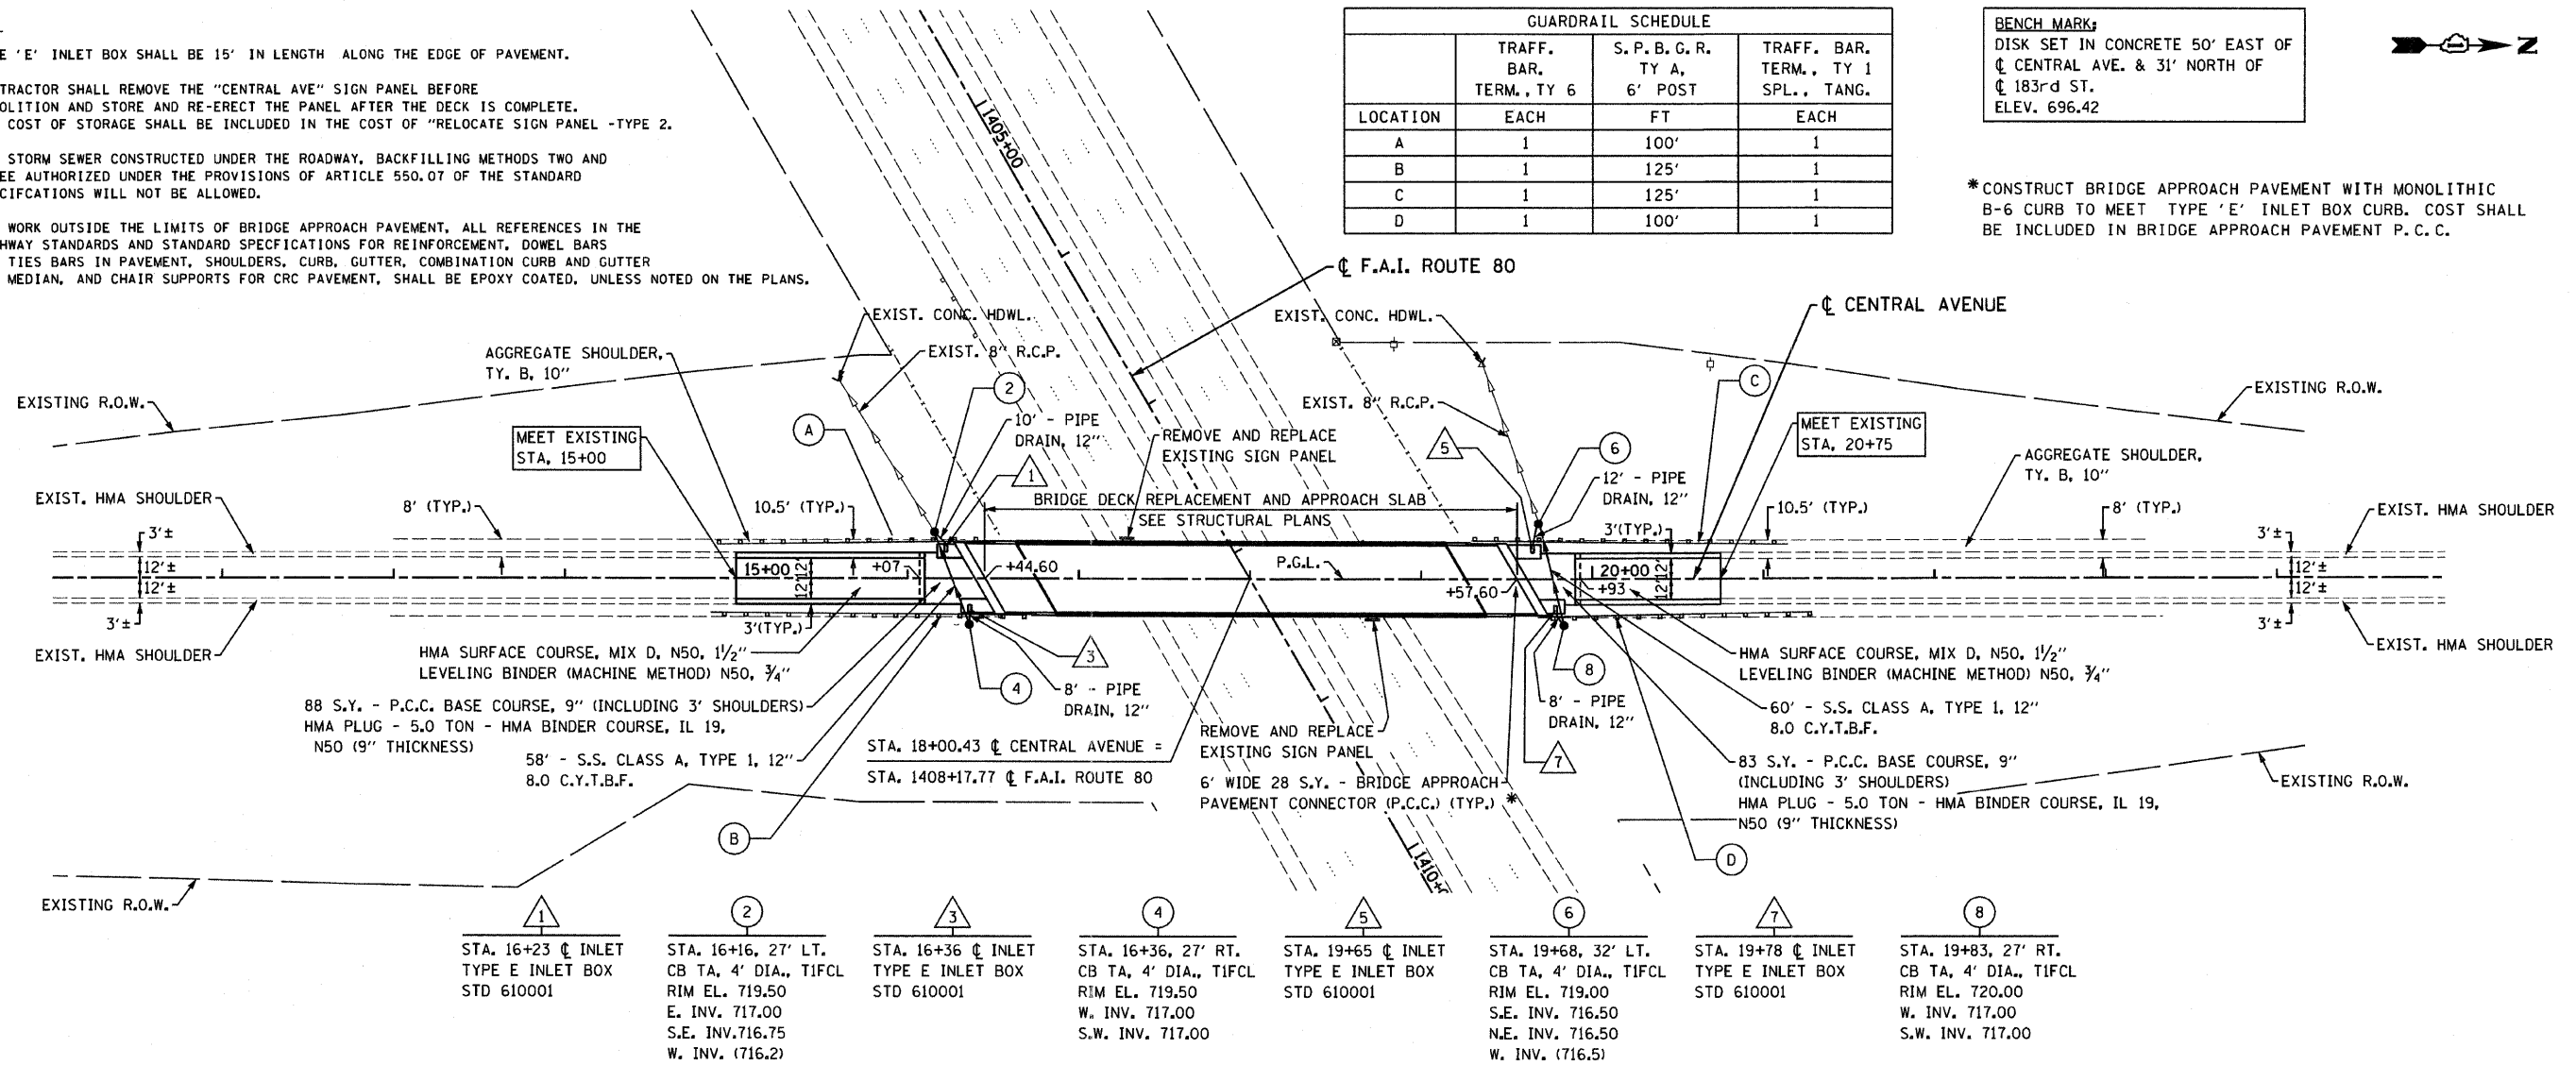

88 S.Y. - P.C.C. BASE COURSE, 9" (INCLUDING 3' SHOULDERS)
HMA PLUG - 5.0 TON - HMA BINDER COURSE, IL 19,
N50 (9" THICKNESS)
58' - S.S. CLASS A, TYPE 1, 12"
8.0 C.Y.T.B.F.

60' - S.S. CLASS A, TYPE 1, 12"
8.0 C.Y.T.B.F.
83 S.Y. - P.C.C. BASE COURSE, 9"
(INCLUDING 3' SHOULDERS)
HMA PLUG - 5.0 TON - HMA BINDER COURSE, IL 19,
N50 (9" THICKNESS)

STA. 16+23 CL INLET
TYPE E INLET BOX
STD 610001

STA. 16+16, 27' LT.
CB TA, 4' DIA., TIFCL
RIM EL. 719.50
E. INV. 717.00
S.E. INV. 716.75
W. INV. (716.2)

STA. 16+36 CL INLET
TYPE E INLET BOX
STD 610001


STA. 16+36, 27' RT.
CB TA, 4' DIA., TIFCL
RIM EL. 719.50
W. INV. 717.00
S.W. INV. 717.00

STA. 19+65 CL INLET
TYPE E INLET BOX
STD 610001

STA. 19+68, 32' LT.
CB TA, 4' DIA., TIFCL
RIM EL. 719.00
S.E. INV. 716.50
N.E. INV. 716.50
W. INV. (716.5)

STA. 19+78 CL INLET
TYPE E INLET BOX
STD 610001

STA. 19+83, 27' RT.
CB TA, 4' DIA., TIFCL
RIM EL. 720.00
W. INV. 717.00
S.W. INV. 717.00

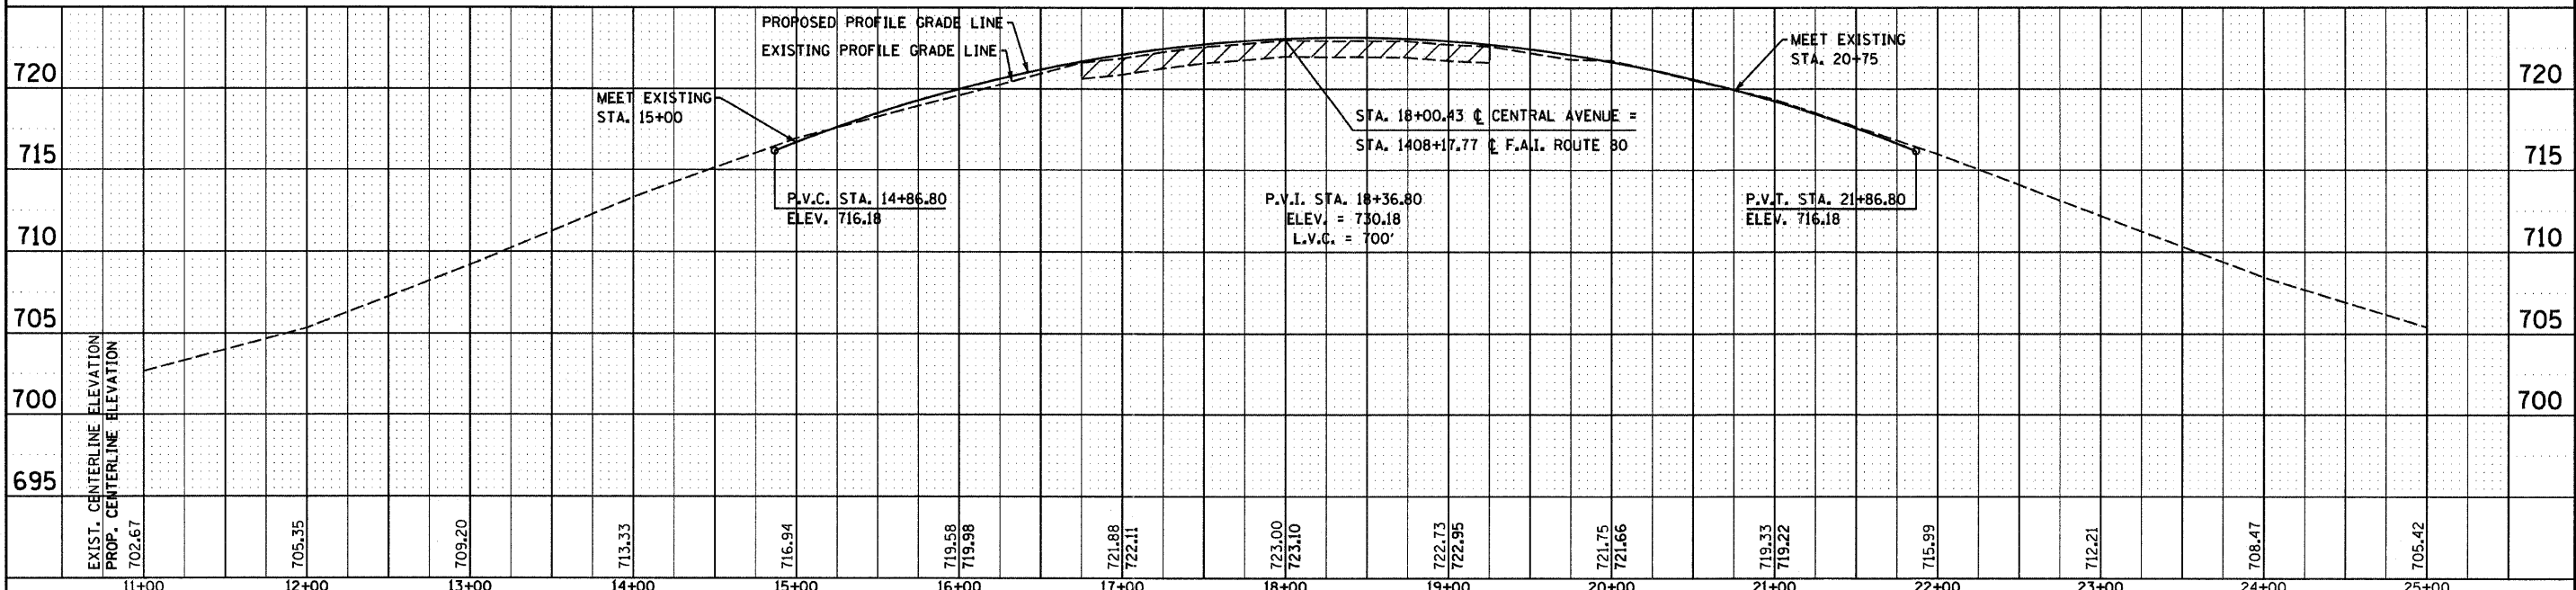

FILE NAME = D180P17-planpr0110.dgn	DESIGNED - S.J.P./K.R.K.	REVISED	STATE OF ILLINOIS DEPARTMENT OF TRANSPORTATION	ROADWAY PLAN AND PROFILE CENTRAL AVENUE OVER I-80		F.A.I. RTE. 80	SECTION 1415-803HB-R	COUNTY COOK	TOTAL SHEETS 51	SHEET NO. 11	
PLOT DATE = 12/18/2011	DRAWN - B.K.	REVISED -				SCALE: 1" = 50'	SHEET NO. 1 OF 1 SHEETS	STA. TO STA.	FED. ROAD DIST. NO. 1 (ILLINOIS) FED. AID PROJECT		CONTRACT NO. 60P17
PLOT SCALE = 50,0000' / IN.	CHECKED -	REVISED -									
	DATE - DECEMBER 9, 2011	REVISED -									

CHRISTIAN-ROGE & ASSOCIATES, INC.
ENGINEERS-PLANNERS-SURVEYORS
211 WEST WACKER DRIVE
CHICAGO, ILLINOIS 60606
PHONE: (312) 372-2023 FAX: (312) 372-5274

DATE	
BY	
FINAL SURVEY	
SURVEYED	
PLOTTED	
NOTE BOOK	
TEMPLATE	
AREAS CHECKED	
NO.	

DATE	
BY	
ORIGINAL SURVEY	
SURVEYED	
PLOTTED	
NOTE BOOK	
TEMPLATE	
AREAS CHECKED	
NO.	