

PERIMETER BARRIER LOCATIONS PERIMETER BARRIER LOCATIONS CONT. PERIMETER BARRIER LOCATIONS CONT. PERIMETER BARRIER LOCATIONS CONT. PERIMETER BARRIER LOCATIONS CONT.

POINT	STATION	OFFSET
1	3326+02.4	100.8' LT
2	3326+18.8	100.9' LT
3	3327+55.2	100.7' LT
4	3327+88.6	100.9' LT
5	3328+57.4	100.8' LT
6	3328+83.0	100.7' LT

POINT	STATION	OFFSET
7	3329+64.9	100.9' LT
8	3329+81.0	101.0' LT
9	3335+55.3	101.0' LT
10	3335+70.3	101.0' LT
11	3327+68.6	90.7' RT
12	3331+39.3	84.1' RT

POINT	STATION	OFFSET
13	3331+94.8	86.0' RT
14	3332+13.6	93.8' RT
15	3333+09.2	98.9' RT
16	3333+19.5	97.9' RT
17	3333+57.6	90.9' RT
18	3347+47.0	100.7' LT

POINT	STATION	OFFSET
19	3348+21.6	202.3' LT
20	3348+31.7	151.4' LT
21	3348+94.2	100.7' LT
22	3350+68.8	100.7' LT
23	3345+70.0	91.2' RT

POINT	STATION	OFFSET
24	3345+69.3	98.2' RT
25	3347+86.8	99.3' RT
26	3349+60.6	98.3' RT

F.A.P. RITE.	SECTION	COUNTY	TOTAL SHEETS	SHEET NO.
307	130 R-2	DUPAGE, KANE	647	157
STA. 3325+00		TO STA. 3351+00		
FED. ROAD DIST. NO.		ILLINOIS FED. AID PROJECT		

INLET AND PIPE PROTECTION 62410


STATION	DESCRIPTION	INLET AND PIPE PROTECTION EACH
3325+75, 15' LT	IN	1
3325+95, 80' LT	FES	1
3326+37, 79' LT	FES	1
3326+75, 15' LT	CB	1
3327+49, 79' LT	FES	1
3327+75, 15' LT	IN	1
3328+05, 79' LT	FES	1
3328+52, 80' LT	FES	1
3328+75, 15' LT	CB	1
3328+97, 81' LT	FES	1
3329+59, 80' LT	FES	1
3329+95, 79' LT	FES	1
3330+75, 15' LT	CB	1
3330+75, 15' RT	CB	1
3332+35, 80' RT	FES	1
3332+75, 15' LT	CB	1
3332+75, 15' RT	CB	1
3333+23, 80' RT	FES	1
3334+75, 15' LT	CB	1
3334+75, 15' RT	CB	1
3335+45, 79' LT	FES	1
3335+83, 79' LT	FES	1
3336+75, 15' LT	CB	1
3336+75, 15' RT	CB	1
3338+55, 15' LT	CB	1
3338+75, 15' RT	CB	1
3338+75, 78' LT	FES	1
3339+50, 15' LT	CB	1
3339+50, 15' RT	CB	1
3339+94, 15' LT	CB	1
3339+94, 15' RT	CB	1
3340+78, 79' LT	FES	1
3340+78, 79' RT	FES	1
3340+92, 79' RT	FES	1
3340+92, 80' LT	FES	1
3341+25, 15' LT	CB	1
3341+25, 15' RT	CB	1
3342+75, 15' RT	CB	1
3342+75, 80' LT	FES	1
3342+95, 15' LT	CB	1
3344+25, 15' LT	CB	1
3344+25, 8' RT	CB	1
3345+75, 15' LT	CB	1
3345+75, 3' RT	CB	1
3347+00, 14' LT	CB	1
3347+02, 89' LT	FES	1
3347+23, 66' RT	CB	1
3347+25, 3' RT	CB	1
3347+42, 92' RT	FES	1
3348+22, 186' LT	FES	1
3348+47, 94' LT	FES	1
3348+74, 165' RT	CB	1
3348+75, 87' RT	CB	1
3348+85, 99' RT	FES	1
3349+25, 15' RT	CB	1
3349+25, 7' LT	CB	1
3351+00, 15' RT	CB	1
3351+00, 63' RT	IN	1
3351+00, 66' LT	CB	1
3351+00, 7' RT	CB	1

MATCH LINE STA 3325+00
SEE SHEET EROS-03

MATCH LINE STA 3338+00
SEE BELOW

MATCH LINE STA 3338+00
SEE ABOVE

MATCH LINE STA 3351+00
SEE SHEET EROS-05

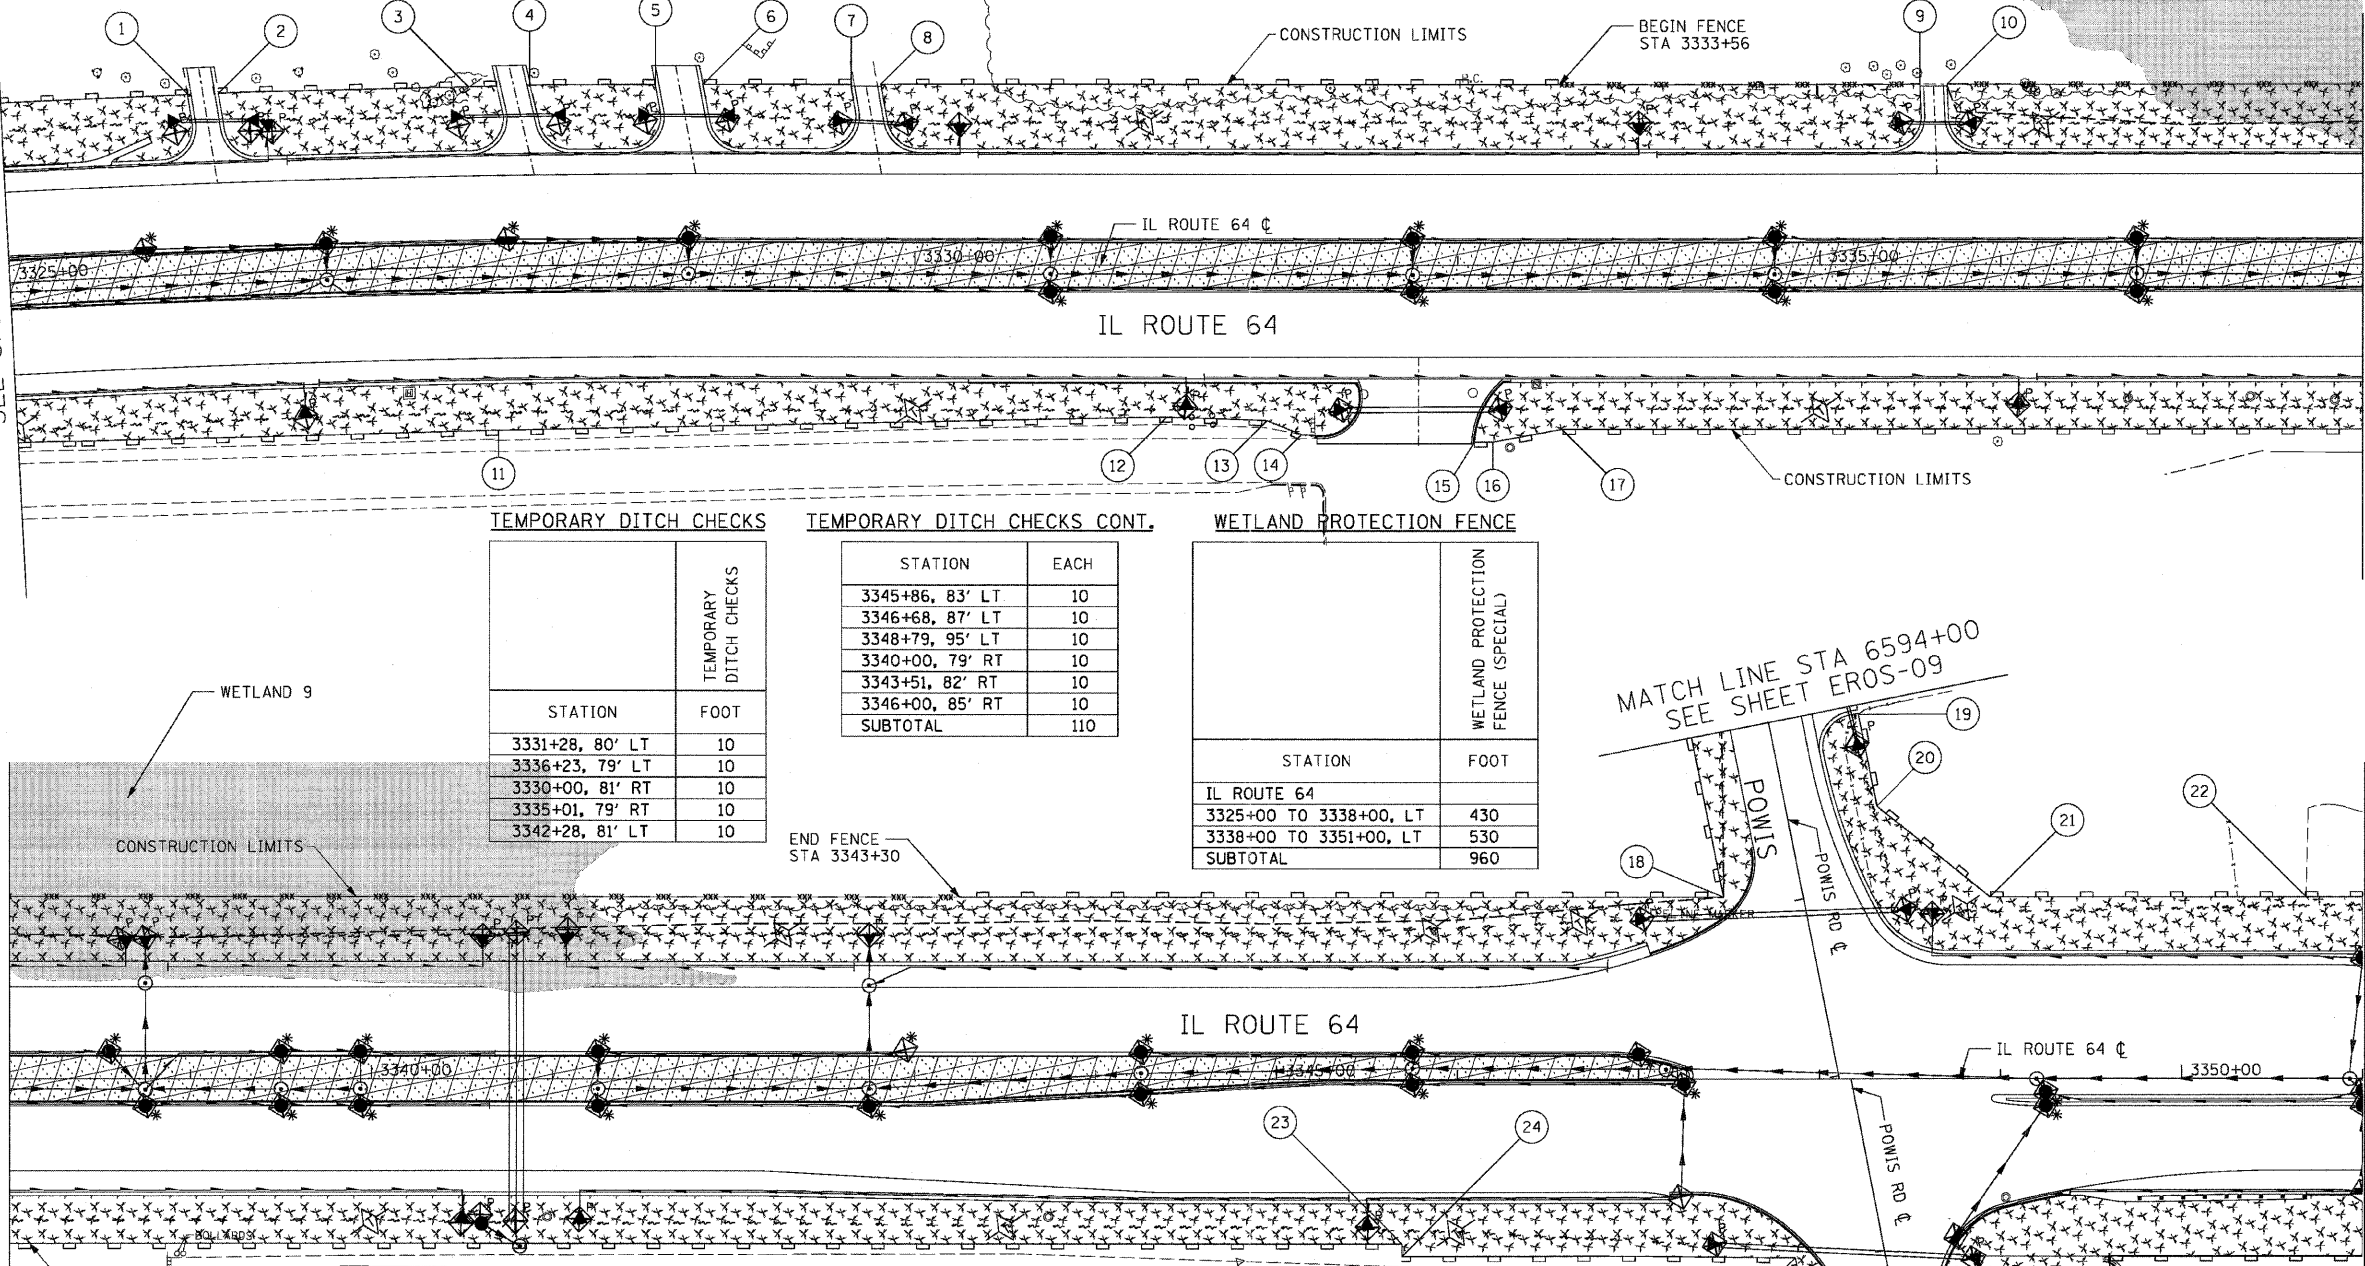

TEMPORARY DITCH CHECKS

STATION	FOOT	TEMPORARY DITCH CHECKS
3331+28, 80' LT	10	
3336+23, 79' LT	10	
3330+00, 81' RT	10	
3335+01, 79' RT	10	
3342+28, 81' LT	10	

TEMPORARY DITCH CHECKS CONT.

STATION	EACH
3345+86, 83' LT	10
3346+68, 87' LT	10
3348+79, 95' LT	10
3340+00, 79' RT	10
3343+51, 82' RT	10
3346+00, 85' RT	10
SUBTOTAL	110

WETLAND PROTECTION FENCE

STATION	FOOT	WETLAND PROTECTION FENCE (SPECIAL)
IL ROUTE 64		
3325+00 TO 3338+00, LT	430	
3338+00 TO 3351+00, LT	530	
SUBTOTAL	960	

EROSION CONTROL LEGEND

	STAGE 1	STAGE 2
INLET FILTER		
PIPE PROTECTION		
TEMPORARY DITCH CHECKS		
PERIMETER EROSION BARRIER		
WETLAND PROTECTION FENCE (SPECIAL)		
AGGREGATE (EROSION CONTROL)		
TEMPORARY EROSION CONTROL SEEDING / MULCH METHOD 2		

TEMPORARY EROSION CONTROL SEEDING

STATION	POUND	TEMPORARY EROSION CONTROL SEEDING
3325+00 TO 3338+00, LT	588	
3325+00 TO 3338+00, RT	864	
3338+00 TO 3351+00, LT	635	
3338+00 TO 3351+00, RT	830	
SUBTOTAL	2,917	

PERIMETER EROSION BARRIER

STATION	FOOT	PERIMETER EROSION BARRIER
3325+00 TO 3338+00, LT	784	
3325+00 TO 3338+00, RT	847	
3338+00 TO 3351+00, LT	1,211	
3338+00 TO 3351+00, RT	1,312	
SUBTOTAL	4,154	



REVISIONS

NAME	DATE

ILLINOIS DEPARTMENT OF TRANSPORTATION
 F.A.P. ROUTE 307 (ILLINOIS ROUTE 64)

EROSION CONTROL PLAN
 IL ROUTE 64
 STA. 3325+00 TO STA. 3351+00

SCALE: VERT: NONE
 HORIZ: 1"=50'
 DATE: NOVEMBER 1, 2011

DRAWN BY: AFC
 CHECKED BY: NJH