



TYPICAL SECTION A - 3.0' SEGMENTAL CONCRETE BLOCK WALL
NTS

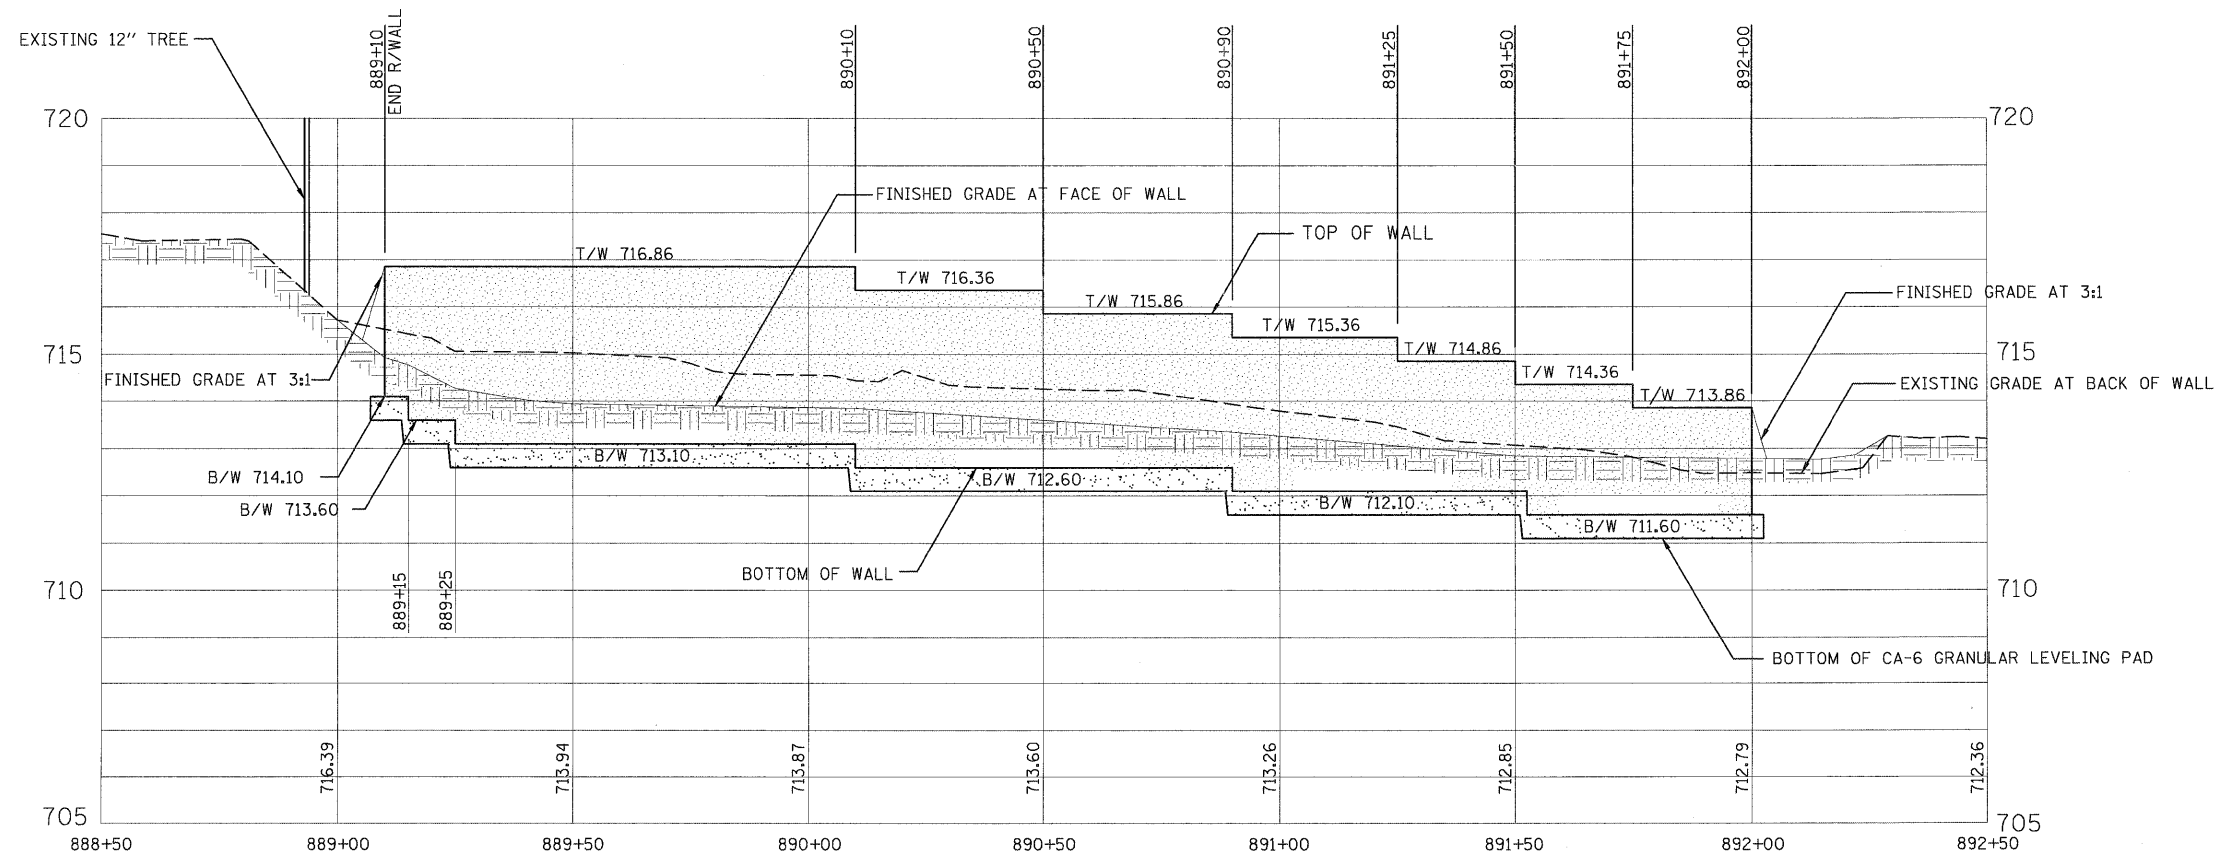

ELEVATION VIEW

NOTES:

- IT IS THE CONTRACTOR'S RESPONSIBILITY TO VERIFY EXISTING CONDITIONS AND DIMENSIONS BEFORE START OF THE WORK OR ORDERING MATERIALS.
- SEE GRADING PLANS FOR LOCATIONS, GRADING, LENGTH AND ELEVATIONS
- THE BASE FOUNDATION FOR THE GRANULAR LEVELING PAD SHALL BE APPROVED BY THE RESIDENT ENGINEER PRIOR TO PLACEMENT OF THE LEVELING PAD. MINIMUM SOIL PRESSURE UNDER PAD=2000 PSF.
- EACH COURSE OF THE MODULAR BLOCKS TO BE SET BACK 3/4" FROM THE COURSE BELOW.
- SEE SPECIAL PROVISION FOR SEGMENTAL CONCRETE BLOCK WALL.
- PIPE UNDERDRAINS FOR STRUCTURES SHALL INCLUDE THE 4" DIA. PERFORATED PIPE DRAIN, GEOTECHNICAL FABRIC FOR FRENCH DRAINS, CA-2 DRAINAGE AGGREGATE. PIPES SHALL OUTLET THROUGH WALL.
- USE SUITABLE NON-SPECIAL WASTE FROM DEMINIMUS SITES IN-LIEU OF FURNISHED EXCAVATION IN LOCATIONS THAT 2" COVER IS PRESENT.

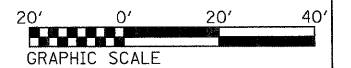

FILE NAME = 0163197-ahd-details.wall01.dgn	USER NAME IDOT	DESIGNED DA	REVISOR 10/24/2011	STATE OF ILLINOIS DEPARTMENT OF TRANSPORTATION	SEGMENTAL CONCRETE BLOCK WALL TYPICAL SECTION AND ELEVATION	F.A.P. RTE.	SECTION	COUNTY	TOTAL SHEETS	SHEET NO.
PLOT SCALE 28.0000' / IN.	CHECKED JJ	REVISOR	347			02-00077-00-SW	DUPAGE	73	53	
PLOT DATE 10/25/2011	DATE 06/08/2011	REVISOR	CONTRACT NO. 63197							
SCALE: AS SHOWN SHEET NO. 1 OF 2 SHEETS STA. 888+50.00 TO STA. 892+50.00						FED. ROAD DIST. NO. ILLINOIS FED. AID PROJECT				