





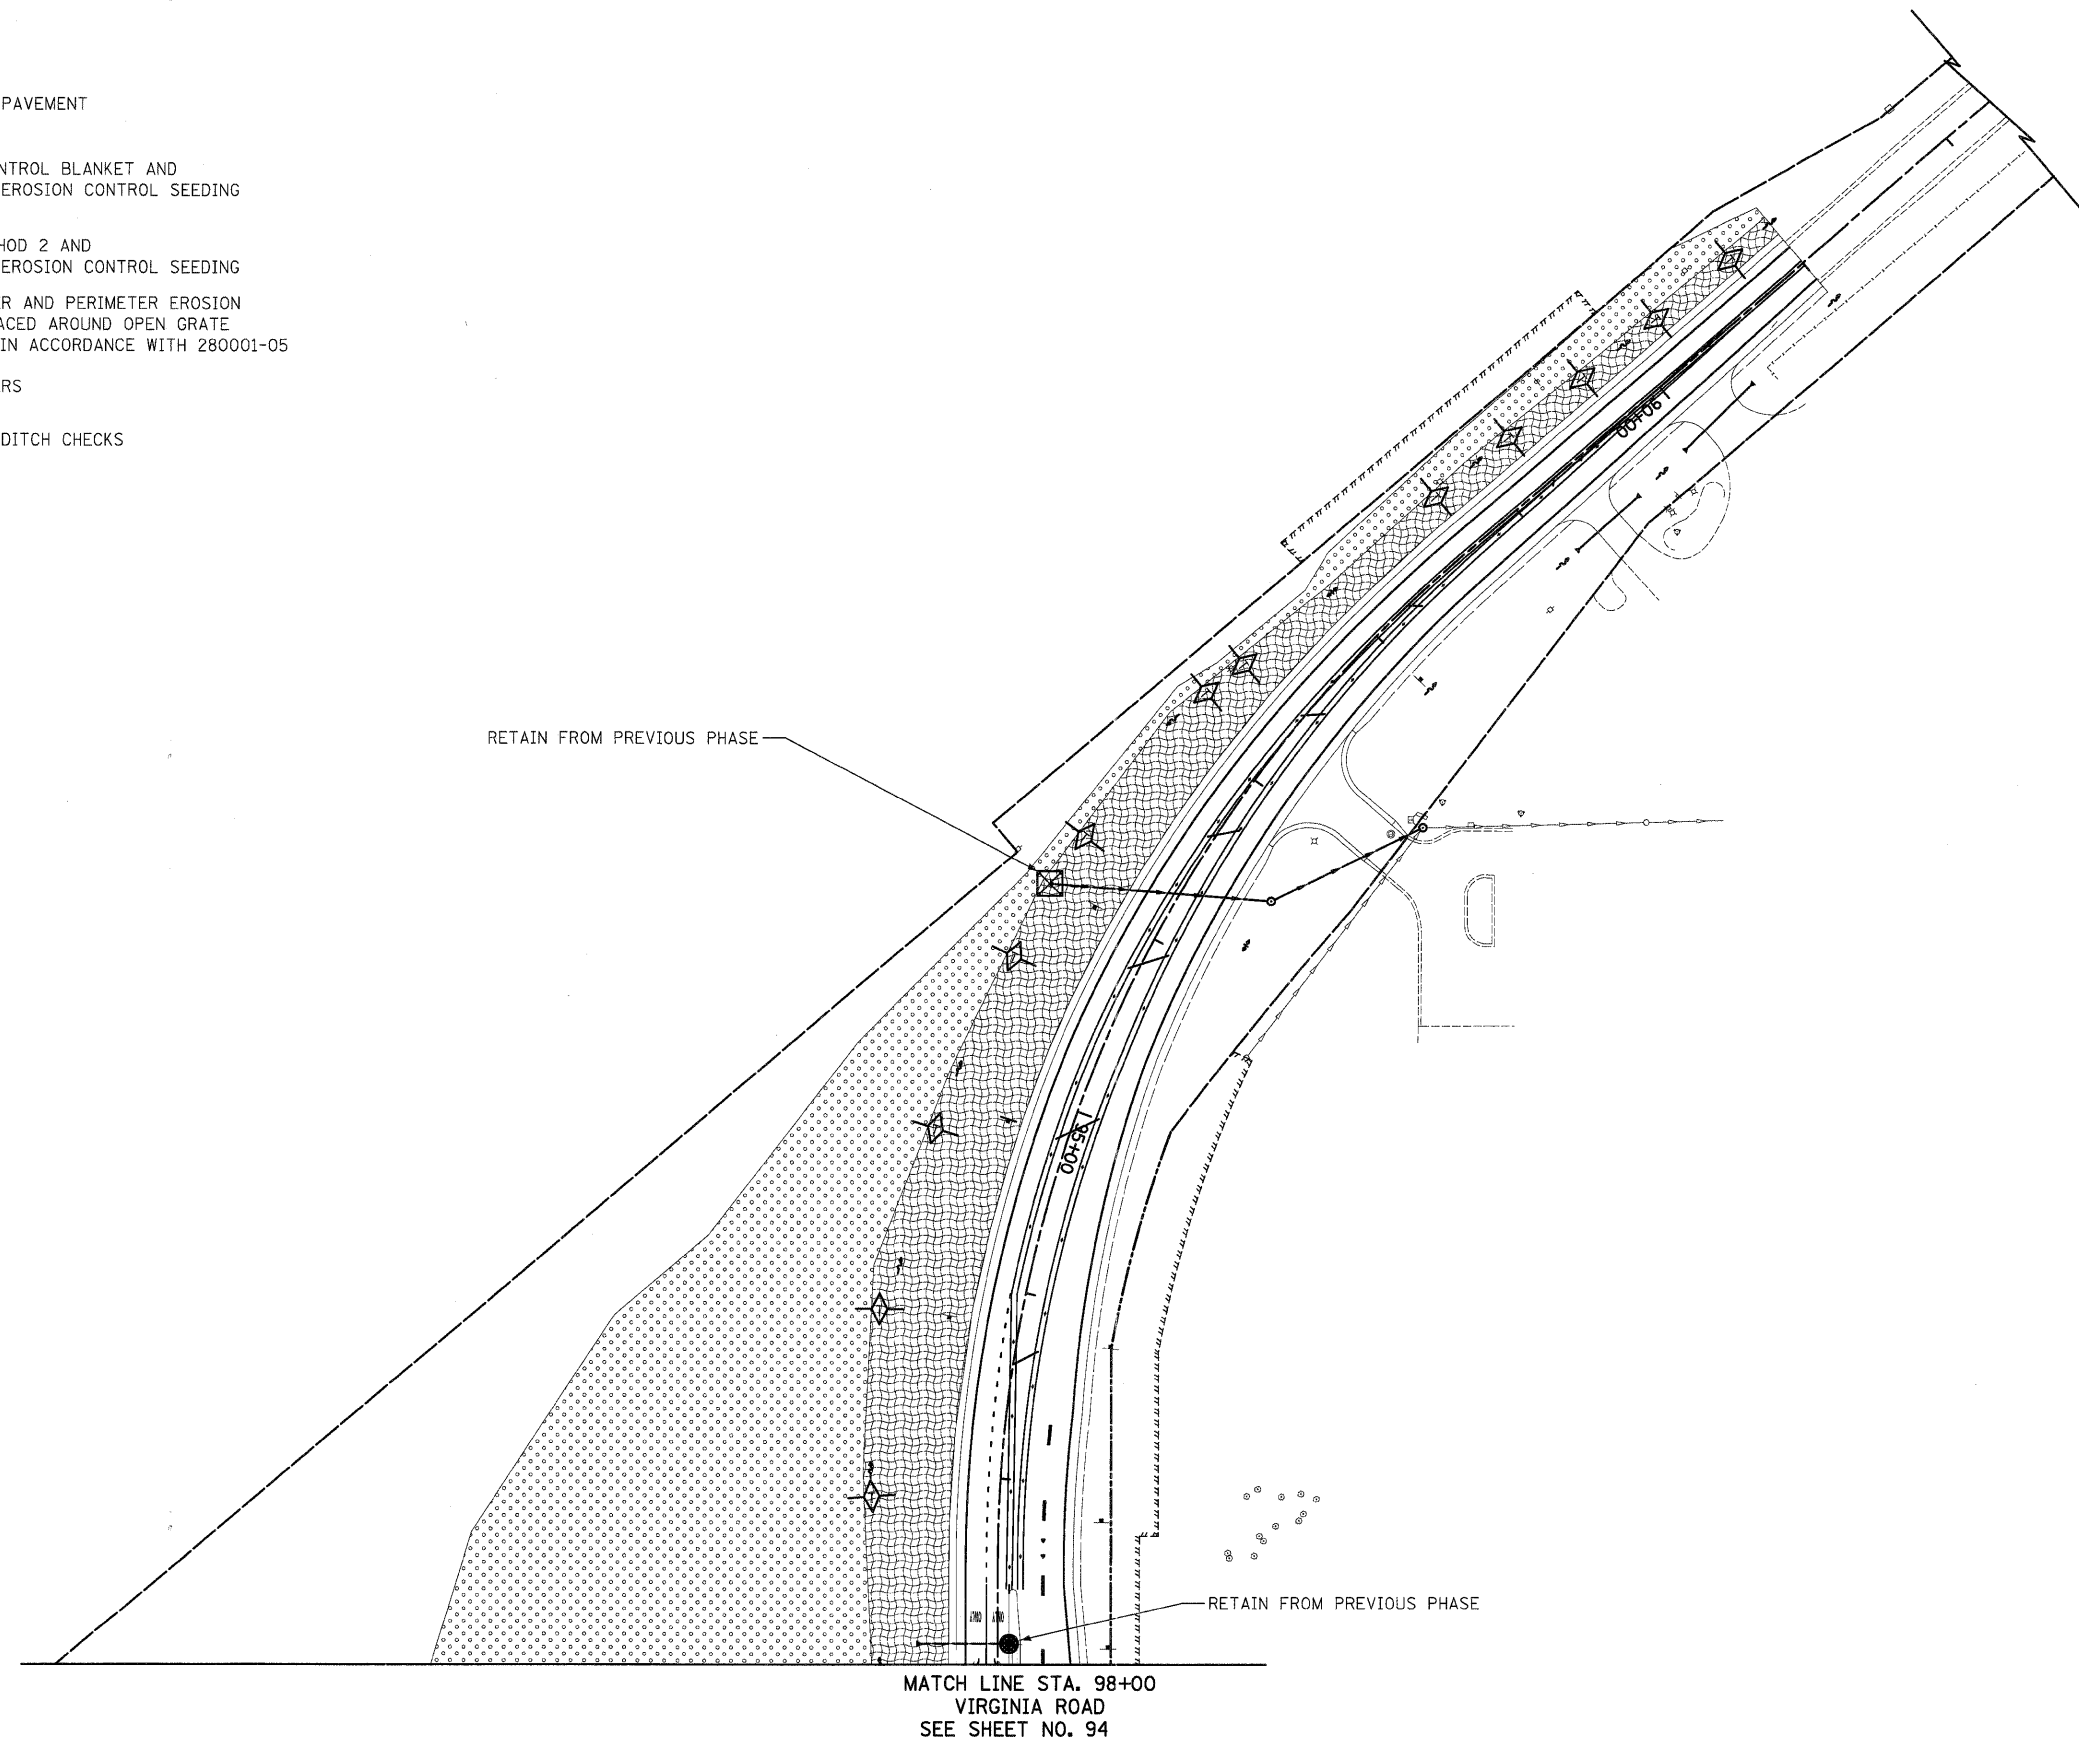
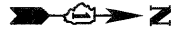


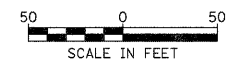
LEGEND

-  TEMPORARY PAVEMENT
-  EROSION CONTROL BLANKET AND TEMPORARY EROSION CONTROL SEEDING
-  MULCH, METHOD 2 AND TEMPORARY EROSION CONTROL SEEDING
-  INLET FILTER AND PERIMETER EROSION BARRIER PLACED AROUND OPEN GRATE STRUCTURE IN ACCORDANCE WITH 280001-05
-  INLET FILTERS
-  TEMPORARY DITCH CHECKS



NOTES:

1. ALL TEMPORARY DITCH CHECKS ARE 1 FOOT IN HEIGHT UNLESS OTHERWISE NOTED.



ILLINOIS ROUTE 31

FILE NAME =	USER NAME = dte	DESIGNED - DTE	REVISED -	STATE OF ILLINOIS DEPARTMENT OF TRANSPORTATION	EROSION AND SEDIMENT CONTROL - STAGE 2B, 2C & 3	F.A.U. RTE. 3887	SECTION 96-00209-01-PV	COUNTY MCHENRY	TOTAL SHEETS 271	SHEET NO. 96	
Y:\2278 Virginia Klassen\cad\sheet\10-ErosionControl\2278_ERD_09.dgn	PLOT SCALE = 50.0000' / 1"	CHECKED - GAB	REVISED -			SCALE: 1" = 50'		SHEET NO. 9 OF 9 SHEETS		STA. 89+00 TO STA. 98+00	
PLOT DATE = 10/24/2011	DATE = 10/24/11	REVISED -				FED. ROAD DIST. NO. 1 ILLINOIS FED. AID PROJECT HPP-4064(003)					
CONTRACT NO. 63553											