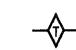

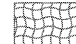
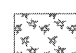
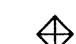
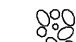
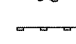
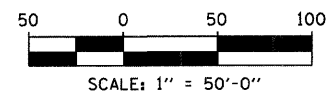
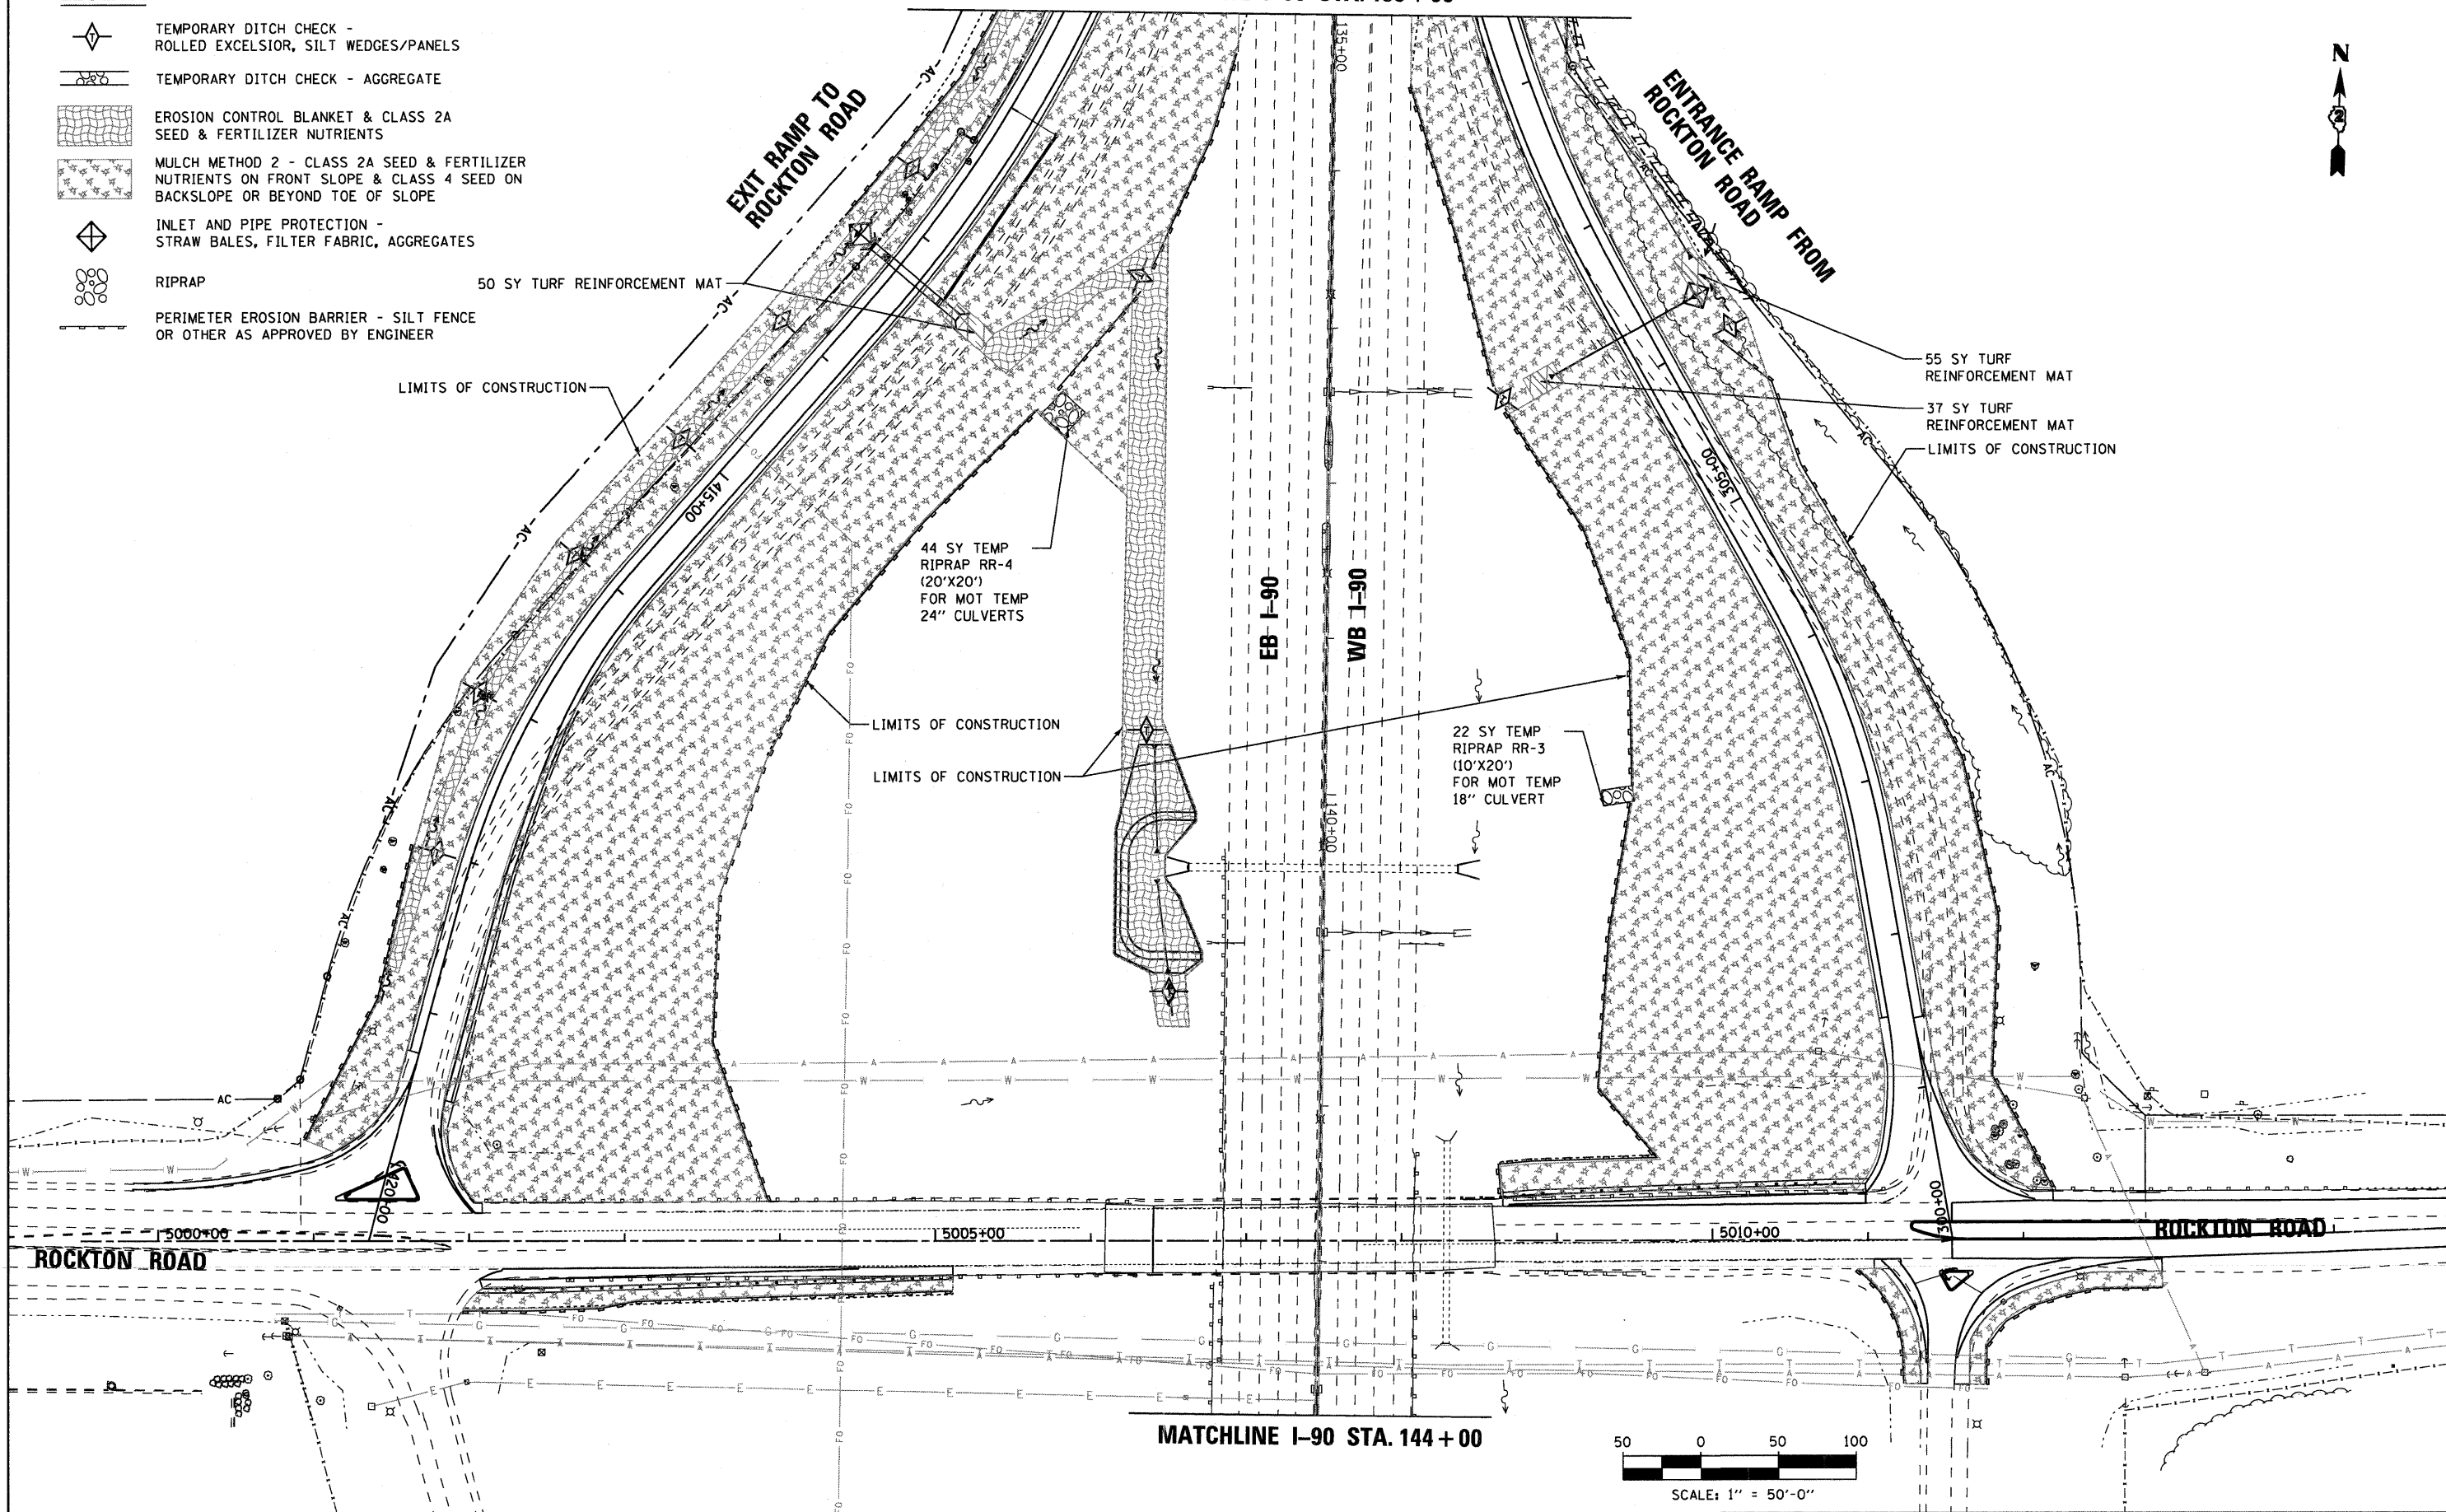


LEGEND:

-  TEMPORARY DITCH CHECK - ROLLED EXCELSIOR, SILT WEDGES/PANELS
-  TEMPORARY DITCH CHECK - AGGREGATE
-  EROSION CONTROL BLANKET & CLASS 2A SEED & FERTILIZER NUTRIENTS
-  MULCH METHOD 2 - CLASS 2A SEED & FERTILIZER NUTRIENTS ON FRONT SLOPE & CLASS 4 SEED ON BACKSLOPE OR BEYOND TOE OF SLOPE
-  INLET AND PIPE PROTECTION - STRAW BALES, FILTER FABRIC, AGGREGATES
-  RIPRAP
-  PERIMETER EROSION BARRIER - SILT FENCE OR OTHER AS APPROVED BY ENGINEER

MATCHLINE I-90 STA. 135 + 00



MATCHLINE I-90 STA. 144 + 00

McClure LOCHNER
Engineering Associates, Inc.
RWA
Rain Water & Associates, Inc.

USER NAME = .USERNAME.
PLOT SCALE = 50,0000' / IN.
PLOT DATE = 10/19/2011

DESIGNED -
DRAWN - JDH
CHECKED - DW
DATE - 10-21-2011

REVISED -
REVISED -
REVISED -
REVISED -

STATE OF ILLINOIS
DEPARTMENT OF TRANSPORTATION

STORM WATER POLLUTION PREVENTION PLAN
I-90 FROM WISCONSIN STATE LINE TO ROCKTON ROAD
SCALE: 1"=50'-0" SHEET NO. 11 OF 12 SHEETS STA. 135+00 TO STA. 144+00

F.A.I. RTE. 90	SECTION (K2-1) R	COUNTY WINNEBAGO	TOTAL SHEETS 510	SHEET NO. 229
CONTRACT NO. 64C29			ILLINOIS FED. AID PROJECT	