










LEGEND

-  INLET AND PIPE PROTECTION
-  PERIMETER EROSION BARRIER
-  EROSION CONTROL BLANKET/CLASS 2 SEEDING
-  SEDIMENTATION BASIN
-  RIP RAP
-  CLASS 2 SEEDING

NOTES:

1. TEMPORARY MULCH WILL BE PLACED ON ALL ERODIBLE EARTH AREAS AS DIRECTED BY THE ENGINEER AS PER THE SPECIFICATIONS.
2. TEMPORARY MULCH WILL MEET REQUIREMENTS OF AND BE PAID FOR AS "MULCH, METHOD 2".
3. ALL UNPAVED AREAS TO BE COVERED WITH CLASS 2 SEEDING EXCEPT WHERE CLASS 4B SEEDING IS SHOWN.

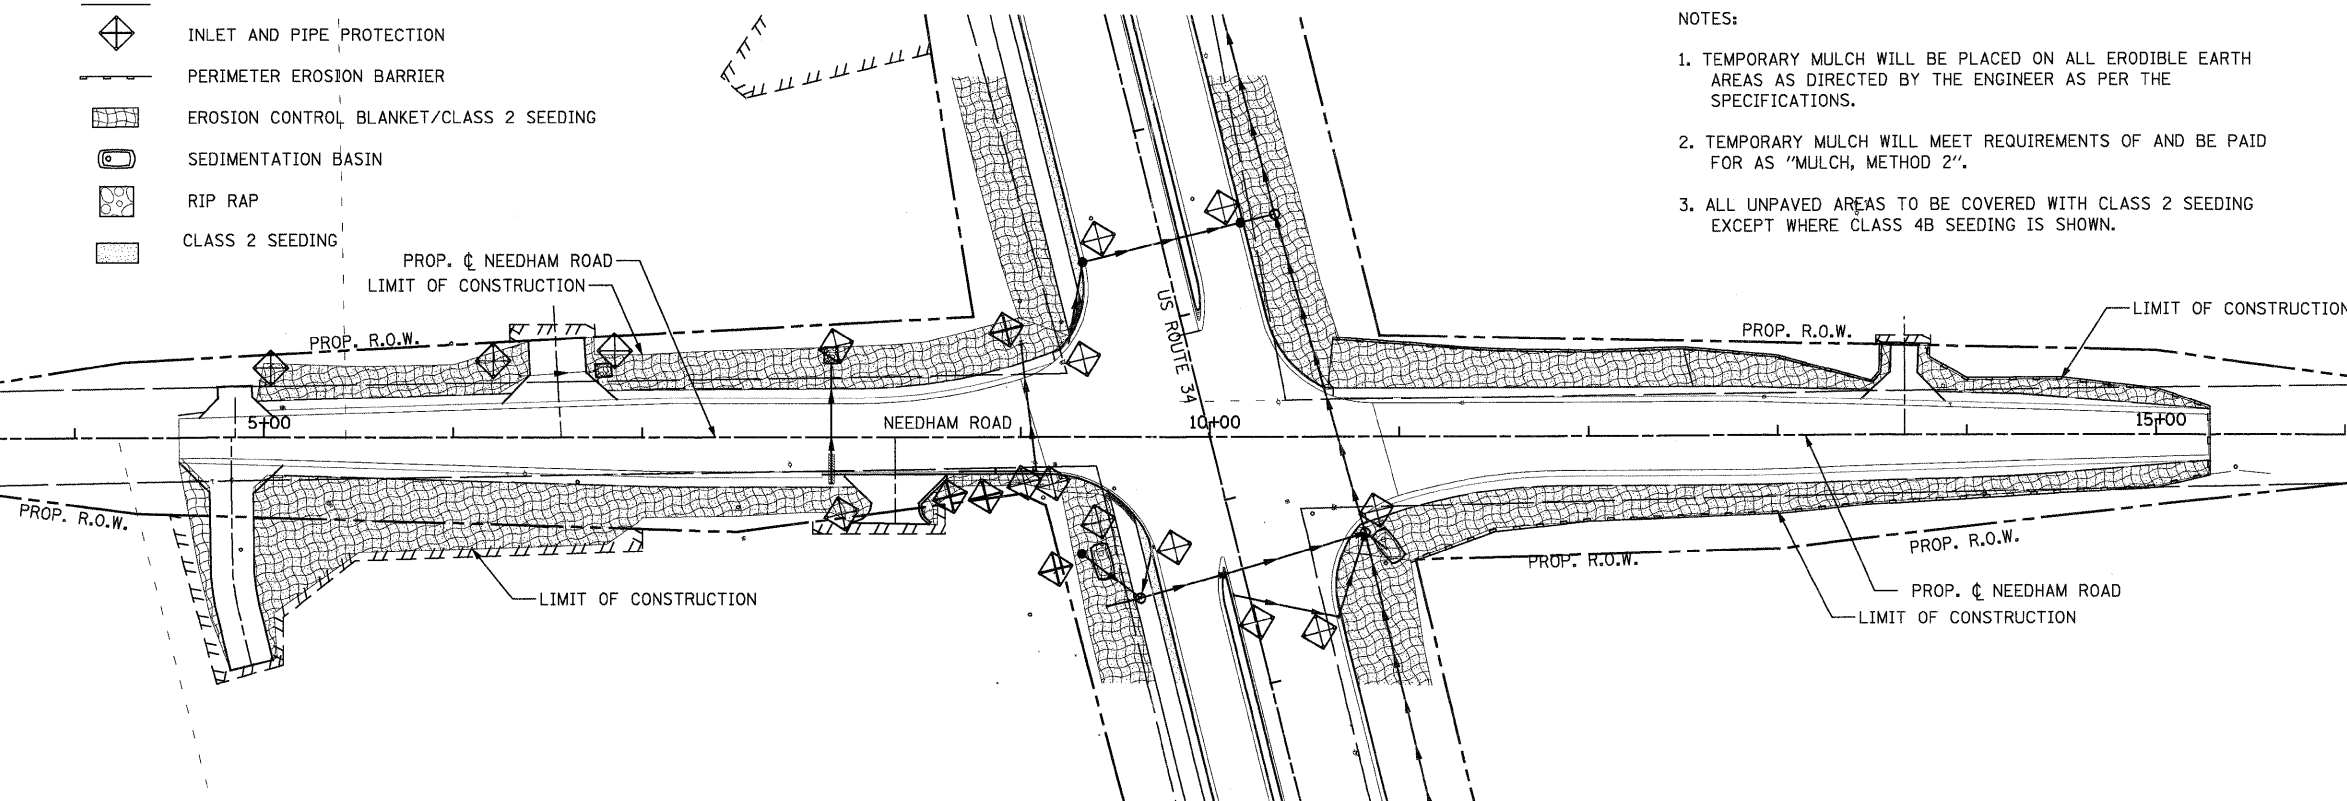

**STATE OF ILLINOIS
DEPARTMENT OF TRANSPORTATION**

**EROSION CONTROL & LANDSCAPING PLANS
NEEDHAM ROAD**

SCALE: 1" = 50' EROS - 5 OF 5 STA. TO STA.

F.A.P. RTE.	SECTION	COUNTY	TOTAL SHEETS	SHEET NO.
591	13R-2;14R-1 & BR-1(1);15R-1	KENDALL	429	207
FINAL SUBMITTAL			CONTRACT NO. 66985	
ILLINOIS FED. AID PROJECT				

PB Americas, Inc.
230 WEST MONROE STREET,
SUITE 900
CHICAGO, IL, 60606
312/782-8150

FILE NAME = D366985-eros05.dgn	DESIGNED - RJD	REVISED -
	DRAWN - RJD	REVISED -
PLOT SCALE = 50	CHECKED - PMK	REVISED -
PLOT DATE = 19-AUG-2011 08:24	DATE - 08-18-2011	REVISED -