

PROPOSED HIGHWAY PLANS

FAP ROUTE 998 (RELOCATED I-70)
SECTION 82-2-1K



ST. CLAIR COUNTY
C-98-093-10

PROPOSED RELOCATED
IL ROUTE 3 INTERCHANGE
AT RELOCATED I-70 AND
ITS COMMUNICATION

F.A.P. RTE.	SECTION	COUNTY	TOTAL SHEETS	SHEET NO.
998	82-2-1K	ST. CLAIR	353	1
FED. ROAD DIST. NO.	ILLINOIS	CONTRACT NO. 76E06		

#353+1 = 354

D-98-059-08

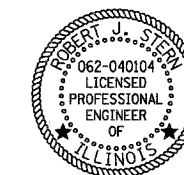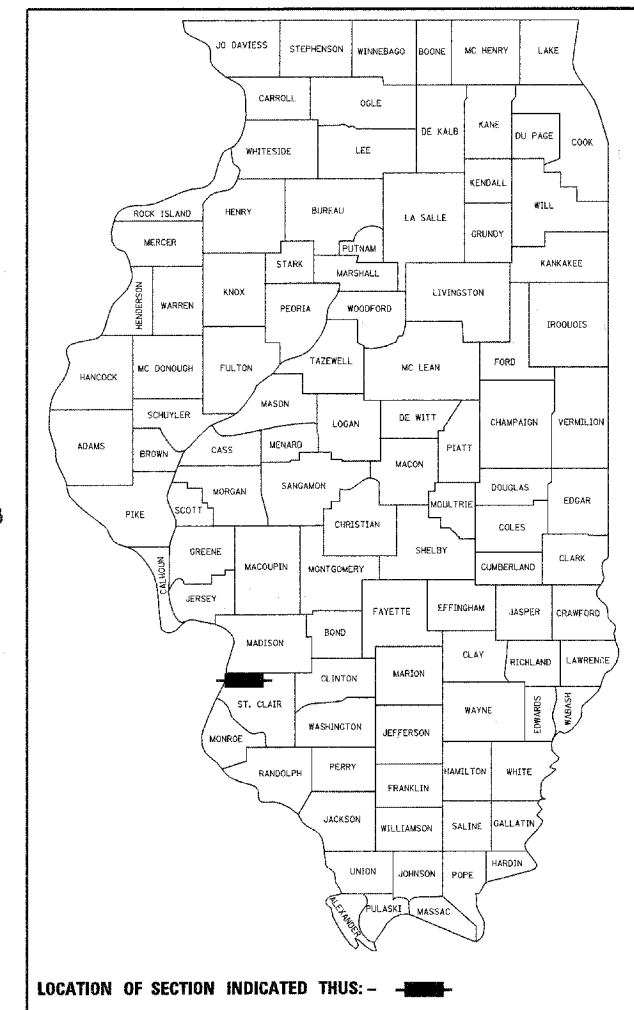


ROBERT J. STERN

EXPIRES: 11/30/2011
DATE: 10/17/2011
SHEETS: 1-79, 110-137, 175-193, 217, 227-260, 277-353




BYRON T. DANLEY

EXPIRES: 11/30/12
DATE: 10/17/11
SHEETS: 218-226, 271-276

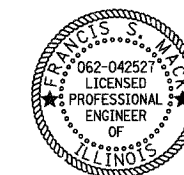

FRANCIS S. MACK

EXPIRES: 11/30/2011
DATE: 10/13/2011
SHEETS: 261-270

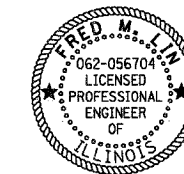

FRED M. LIN

EXPIRES: 11/30/2013
DATE: 10/14/2011
SHEETS: 80-109, 184-216

TENG

TENG & ASSOCIATES, INC.
ENGINEERS/ARCHITECTS/PLANNERS
205 N. MICHIGAN AVE., CHICAGO, IL 60601
TELEPHONE: 312/616-0000

LINE ENGINEERING, LTD.
Consulting Engineers
Chatham, Illinois
Westmont, Illinois

ABNA
engineering

STATE OF ILLINOIS
DEPARTMENT OF TRANSPORTATION
DIVISION OF HIGHWAYS

SUBMITTED Oct 25th 20 11

Deputy Director of Highways, Region Engineer
December 9, 20 11
acting ENGINEER OF DESIGN AND ENVIRONMENT
December 9, 20 11
Interim DIRECTOR OF HIGHWAYS, CHIEF ENGINEER

PRINTED BY THE AUTHORITY
OF THE STATE OF ILLINOIS

NORTH APPROACH SLAB ONLY
RELOCATED IL RTE 3 OVER I-70
STR. NO. 082-0328 PROPOSED RELOCATED IL RTE 3 BRIDGE
BACK OF ABUTMENT STA. 1684+40.93

SOUTH APPROACH SLAB ONLY
RELOCATED IL RTE 3 OVER TRRA AND ST. CLAIR AVE.
STR. NO. 082-0329 PROPOSED RELOCATED IL RTE 3 BRIDGE
BACK OF ABUTMENT STA. 1677+17.25

FOR INDEX OF SHEETS, SEE SHEET NO. 2

INTERSTATE 70
ADT = 59,940 (2030) 6,594 (30) INTERSTATE 48.96 (PCC-20)
DESIGN SPEED = 60 MPH
POSTED SPEED = 55 MPH

RELOCATED IL ROUTE 3
ADT = 34,760 (2030) 3,476 (30) PRINCIPAL ARTERIAL 18.46 (PCC-20)
DESIGN SPEED = 45 MPH
POSTED SPEED = 40 MPH

RAMPS A-D
DESIGN SPEED = 50 MPH AT GORE, 35 MPH AT END
POSTED SPEED = 30 MPH
RAMP A ADT = 12,610 (2030) 1,214(30) INTERSTATE RAMP 14.30 (PCC-20)
RAMP B ADT = 6,010 (2030) 443(30) INTERSTATE RAMP 7.13 (PCC-20)
RAMP C ADT = 16,940 (2030) 1,690 (30) INTERSTATE RAMP 17.20 (PCC-20)
RAMP D ADT = 16,940 (2030) 1,690 (30) INTERSTATE RAMP 17.20 (PCC-20)

CONNECTOR ROAD
ADT = 26,550 (2030) 2,655 (30) COLLECTOR 9.40 (PCC-20)
DESIGN SPEED = 35 MPH
POSTED SPEED = 30 MPH


EXCHANGE AVENUE
ADT = 16,940 (2030) 1,694 (30) COLLECTOR 7.26 (PCC-20)
DESIGN SPEED = 30 MPH
POSTED SPEED = 25 MPH

EXISTING IL ROUTE 3 (ST. CLAIR AVE.)
ADT = 9,000 (2008), 26,190 (2030) 2,619 (30) MINOR ARTERIAL 7.60 (FD-20)
DESIGN SPEED = 40 MPH (S. OF TRRA CROSSING)
DESIGN SPEED = 50 MPH (N. OF TRRA CROSSING)
POSTED SPEED = 35 MPH (S. OF TRRA CROSSING)
POSTED SPEED = 45 MPH (N. OF TRRA CROSSING)

1ST STREET
ADT = 1,350 (2008), 1,700 (2030)
DESIGN SPEED = 35 MPH
POSTED SPEED = 30 MPH

PROJECT LOCATED IN: FAIRMONT CITY, ILLINOIS
EAST ST. LOUIS, ILLINOIS

PLANS 1"=50'
PROFILES 1"=5'
X-SECTIONS 1"=10' H
1"=5' V

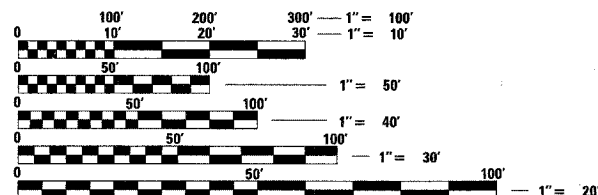

FULL SIZE PLANS HAVE BEEN PREPARED USING STANDARD
ENGINEERING SCALES. REDUCED SIZED PLANS WILL NOT
CONFORM TO STANDARD SCALES. IN MAKING MEASUREMENTS
ON REDUCED PLANS, THE ABOVE SCALES MAY BE USED.

J.U.L.I.E.
JOINT UTILITY LOCATION INFORMATION FOR EXCAVATION
1-800-892-0123
OR 811

PROJECT ENGINEER : MICHAEL D. PRITCHETT (618) 346-3180
PROJECT MANAGER : JANE CHASTAIN MERCER (618) 346-3206

CONTRACT NO. 76E06

RELOCATED I-70 &
SOUTHBOUND I-55
STA. 116+90 (I-70) TO
STA. 121+85 (I-55)

RAMP D
STA. 250+00.00 TO STA. 258+00.00



RAMP C
STA. 110+40.00 TO STA. 120+52.95

EXCHANGE AVE.
STA. 35+11.34 TO STA. 55+41.84

ST. CLAIR AVE.
STA. 107+15.07 TO STA. 125+36.55

ST. CLAIR AVE. CONNECTOR
STA. 20+01.00 TO STA. 32+54.37

RELOCATED IL ROUTE 3
STA. 1668+15.15 TO STA. 1693+28.38

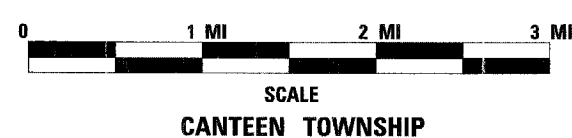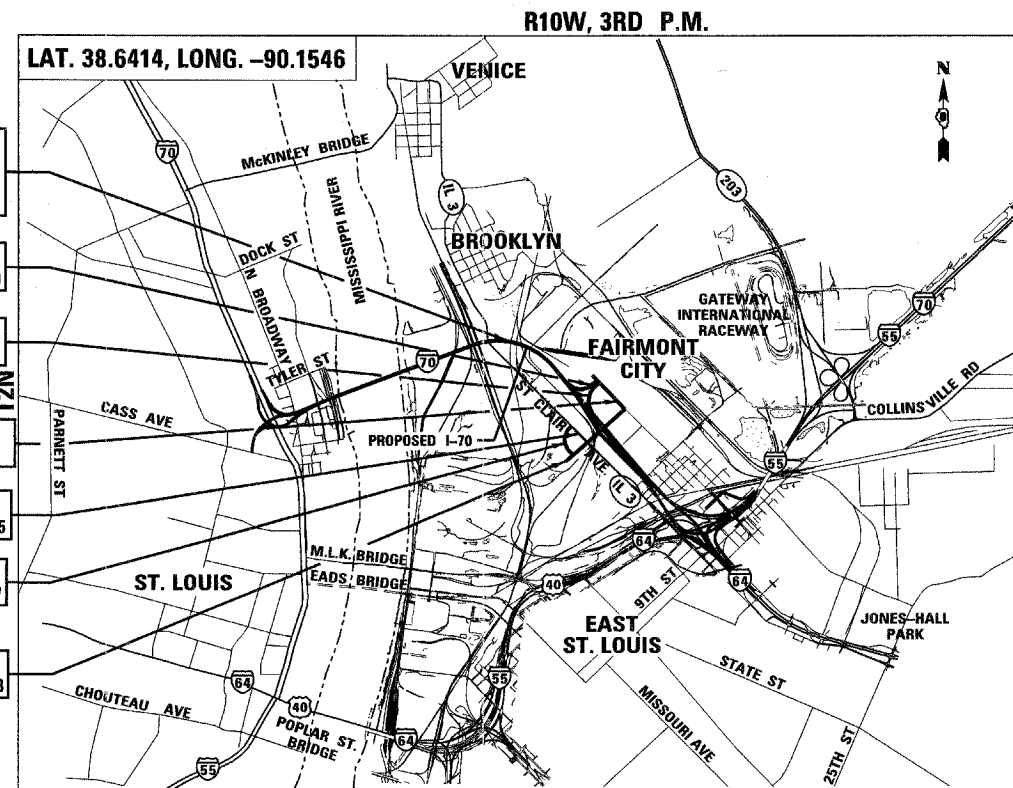

GROSS /NET LENGTH OF PROJECT:

I-70 /I-55	20,658' (3.91 MI)
EXCHANGE AVE.	11,462' (2.17 MI)
RAMP C	2,031' (0.385 MI)
RAMP D	1,013' (0.192 MI)
RAMP A	800' (0.152 MI)
ST. CLAIR AVE.	1,585' (0.300 MI)
ST. CLAIR AVE. CONNECTOR	1,254' (0.238 MI)
RELOCATED IL ROUTE 3	2,513' (0.476 MI)

EXISTING LEGEND

- (A) EXISTING BITUMINOUS PAVEMENT
- (B) EXISTING PCC PAVEMENT
- (C) AGGREGATE SHOULDER
- (D) CURB AND GUTTER
- (E) BITUMINOUS SHOULDER
- (F) TEMPORARY PAVEMENT
- (G) AGGREGATE SUBGRADE
- (H) EXISTING SIDEWALK
- [R] = REMOVAL


PROPOSED LEGEND

- (1) PORTLAND CEMENT CONCRETE PAVEMENT 11" (JOINTED)
- (2) PORTLAND CEMENT CONCRETE SHOULDERS 11"
- (3) RETAINING WALL (BY OTHERS)
- (4) AGGREGATE SUBGRADE 12"
- (5) CONCRETE BARRIER, DOUBLE FACE, 42 INCH HEIGHT
- (6) CONCRETE BARRIER BASE
- (7) AGGREGATE SURFACE COURSE, TYPE B, 12" (NOT USED)
- (8) EMBANKMENT
- (9) HOT-MIX ASPHALT SHOULDERS, 8"
- (10) SEEDING & LANDSCAPING BY OTHERS
- (11) HOT-MIX ASPHALT PAVEMENT (FULL-DEPTH), 15.75"
- (12) COMBINATION CONCRETE CURB AND GUTTER, TYPE B-6.12
- (13) COMBINATION CONCRETE CURB AND GUTTER, TYPE B-6.24
- (14) AGGREGATE SHOULDERS, TYPE B 6"
- (15) 42" CONCRETE BARRIER (BY OTHERS)
- (16) STEEL PLATE BEAM GUARDRAIL, TYPE A
- (17) CHAIN LINK FENCE, 6'
- (18) HOT-MIX ASPHALT SURFACE COURSE, MIX "D", N70
- (19) CONCRETE MEDIAN SURFACE, 6"
- (20) STABILIZED SUBBASE - HOT-MIX ASPHALT, 4"
- (21) COMBINATION CONCRETE CURB AND GUTTER, TYPE M-4.24
- (22) PORTLAND CEMENT CONCRETE PAVEMENT 10" (JOINTED)
- (23) PORTLAND CEMENT CONCRETE SHOULDERS 10"
- (24) LONGITUDINAL CONSTRUCTION JOINT WITH NO. 6 TIE BARS AT 24" CTS.
- (25) LONGITUDINAL SAWED JOINT WITH NO. 6 TIE BARS AT 18" CTS.
- (26) LONGITUDINAL SAWED JOINT WITH NO. 6 TIE BARS AT 30" CTS.
- (27) AGGREGATE BASE COURSE, TYPE B 6"
- (28) PORTLAND CEMENT CONCRETE PAVEMENT 12" (JOINTED)
- (29) ANCHORAGE SLAB (BY OTHERS)
- (30) POROUS GRANULAR BACKFILL
- (31) REMOVAL AND DISPOSAL OF UNSUITABLE MATERIAL OR NON-SPECIAL WASTE DISPOSAL
- (32) LIMITS OF ARCHAEOLOGICAL EXPLORATION EARTH EXCAVATION (SPECIAL) AS REQUIRED UNDER PROPOSED ROADWAY SECTION
- (33) PORTLAND CEMENT CONCRETE SHOULDERS 12"
- (34) CONTINUOUSLY REINFORCED PORTLAND CEMENT CONCRETE PAVEMENT 11 1/4" (BY OTHERS)
- (35) PIPE UNDERDRAINS 4"
- (36) PORTLAND CEMENT CONCRETE SIDEWALK 5 INCH
- (37) CONCRETE MEDIAN, TYPE SB-6.12
- (38) CONCRETE MEDIAN, TYPE SB-6.24


ALL TIE BARS SHALL BE EPOXY COATED

* = BY OTHERS
 [] = INDICATES PAYMENT INCLUDED IN COST OF ANOTHER ITEM

NOTE: THE COST OF THE ADDITIONAL THICKNESS OF AGGREGATE SUBGRADE 12" REQUIRED BENEATH THE SHOULDERS SHALL BE INCLUDED IN THE CONTRACT UNIT PRICE PER SQ YD FOR AGGREGATE SUBGRADE 12".

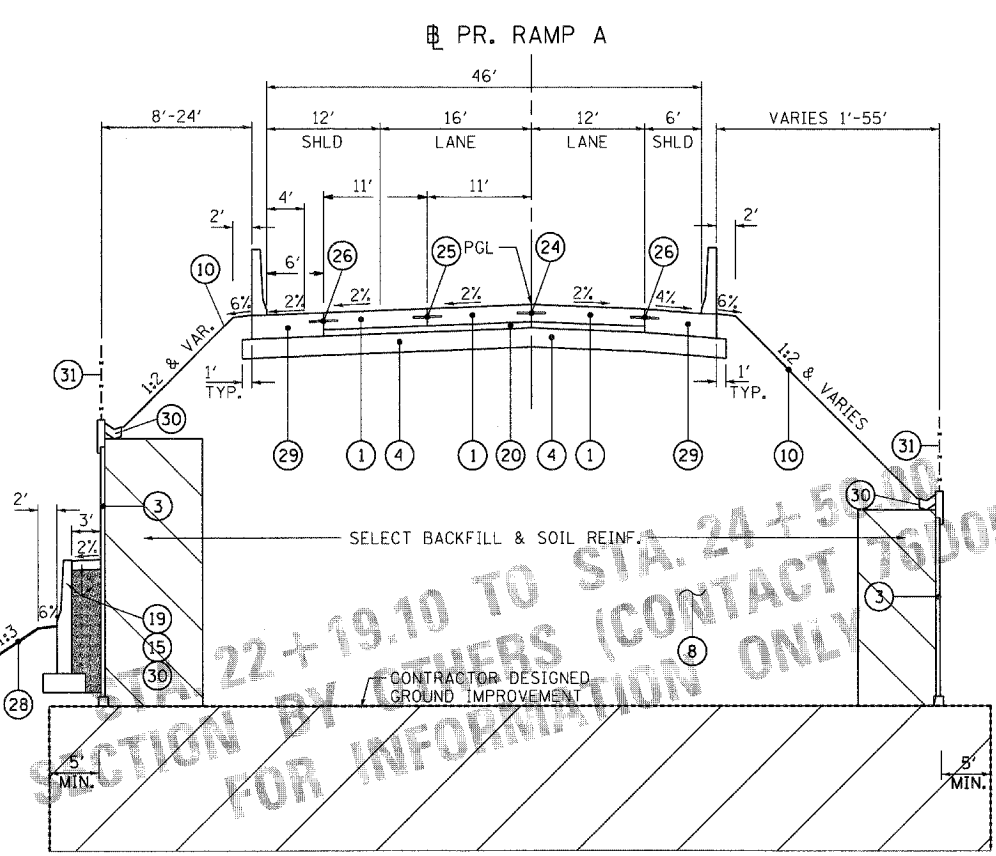

C PROPOSED RAMP A TYPICAL SECTION
 STA. 22+19.10 TO STA. 24+50.00
 SECTION BY OTHERS (CONTACT 76D05)
 FOR INFORMATION ONLY

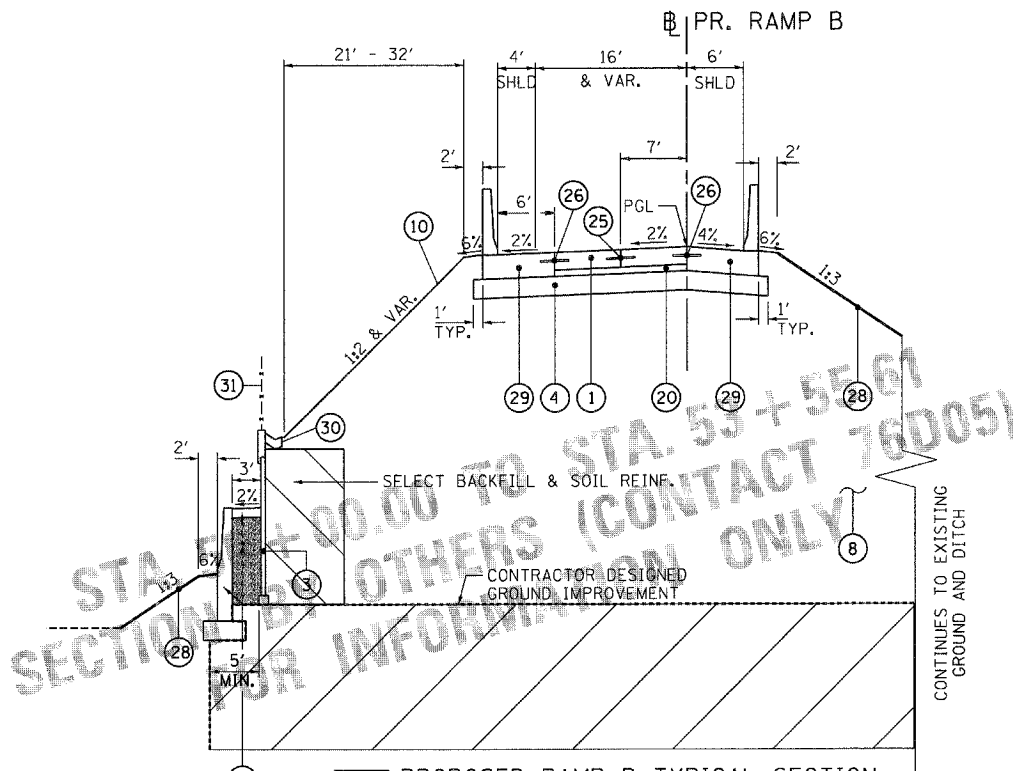

D PROPOSED RAMP B TYPICAL SECTION
 STA. 50+00.00 TO STA. 53+55.61
 SECTION BY OTHERS (CONTACT 76D05)
 FOR INFORMATION ONLY

FILE NAME = USER NAME = #USER# DESIGNED - JB REVISED -
 DRAWN - JB REVISED -
 CHECKED - ACL REVISED -
 DATE - 10/21/11 REVISED -
 PLOT SCALE = #SCALE#
 PLOT DATE = #DATE#
 TENG & ASSOCIATES, INC.
 ENGINEERS/ARCHITECTS/PLANNERS
 CHICAGO, ILLINOIS


STATE OF ILLINOIS
 DEPARTMENT OF TRANSPORTATION
 PROPOSED RELOCATED IL ROUTE 3 INTERCHANGE

PROPOSED RAMPS A & B
 TYPICAL SECTIONS
 SCALE: N.T.S. SHEET NO. 2 OF 9 SHEETS STA. TO STA.

F.A.P. RTE.	SECTION	COUNTY	TOTAL SHEETS	SHEET NO.
998	82-2-1K	ST. CLAIR	353	14
CONTRACT NO. 76E06				
FED. ROAD DIST. NO. ILLINOIS FED. AID PROJECT				

RAMP D



STRUCTURAL DESIGN TRAFFIC:	YEAR	2030
PV = 11,092	SU = NA	MU = 1,232
ROAD/STREET CLASSIFICATION:	CLASS	1
PERCENT OF STRUCTURAL DESIGN TRAFFIC IN DESIGN LANE:		
P = 100%	S = NA	M = 100%
TRAFFIC FACTOR	ACTUAL TF = 17.20	AC TYPE = 20
	MINIMUM TF = 6.70	
PG GRADE:	BINDER = NA	SURFACE = NA
SUBGRADE SUPPORT RATING:	SSR = POOR	

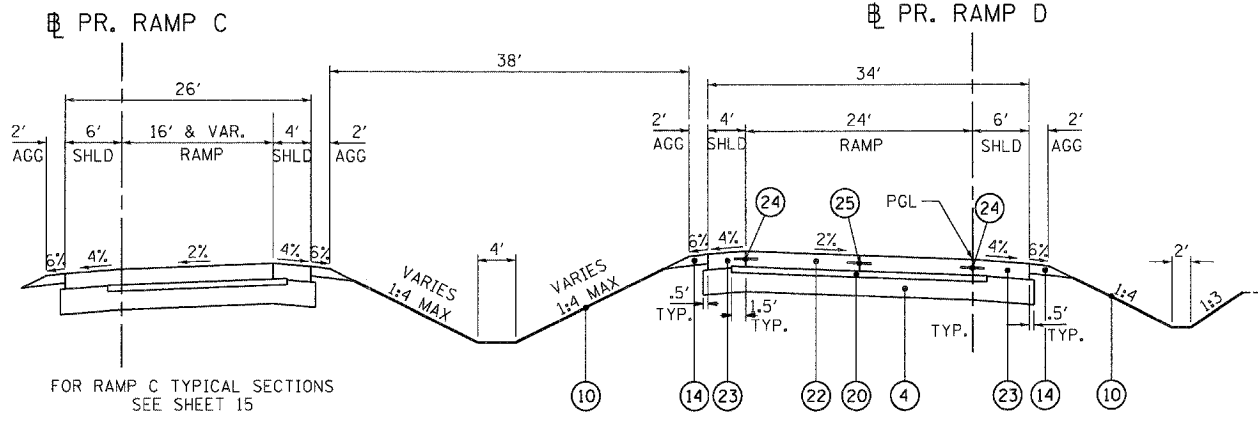

FOR RAMP C TYPICAL SECTIONS SEE SHEET 15


PROPOSED RAMP D TYPICAL SECTION
STA. 250+00.00 TO STA. 252+30.00

K

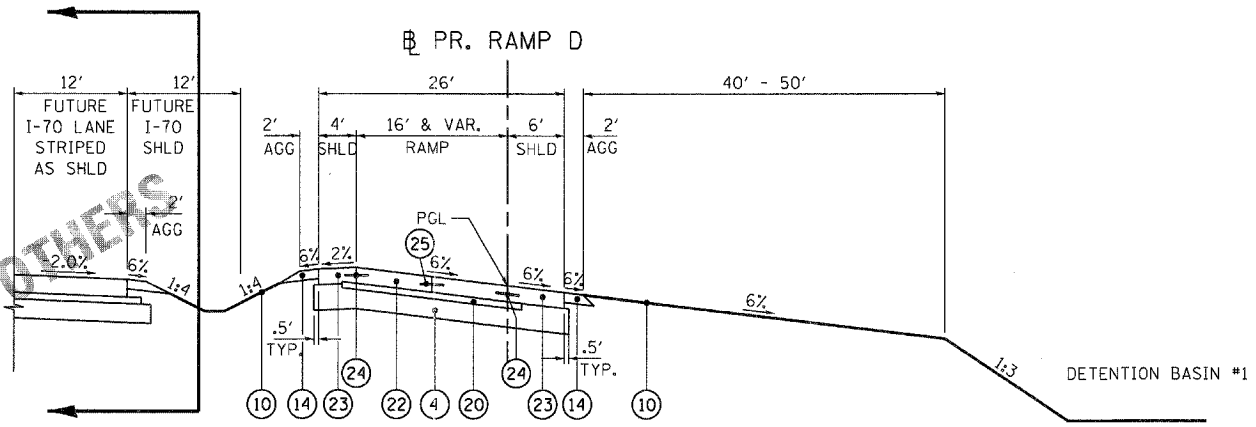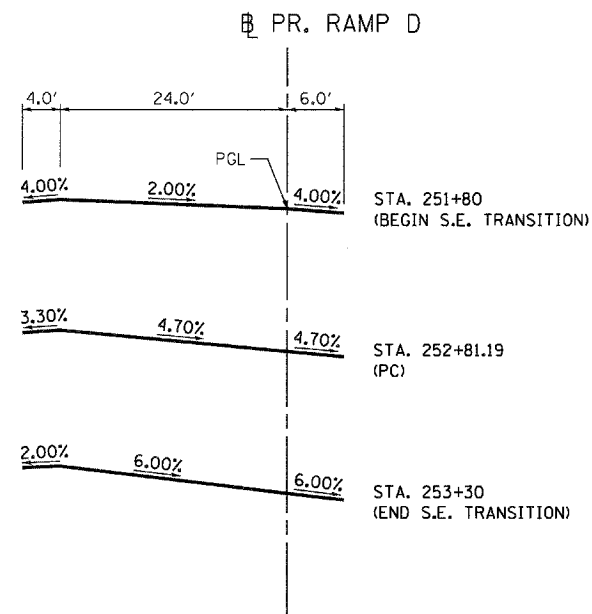


PROPOSED RAMP D TYPICAL SECTION
STA. 252+30.00 TO STA. 258+85.00
S.E. TRANSITION 251+80.00 (+2%) TO 253+30.00 (+6%)
PAVING LIMITS END AT STA. 258+00.00

L

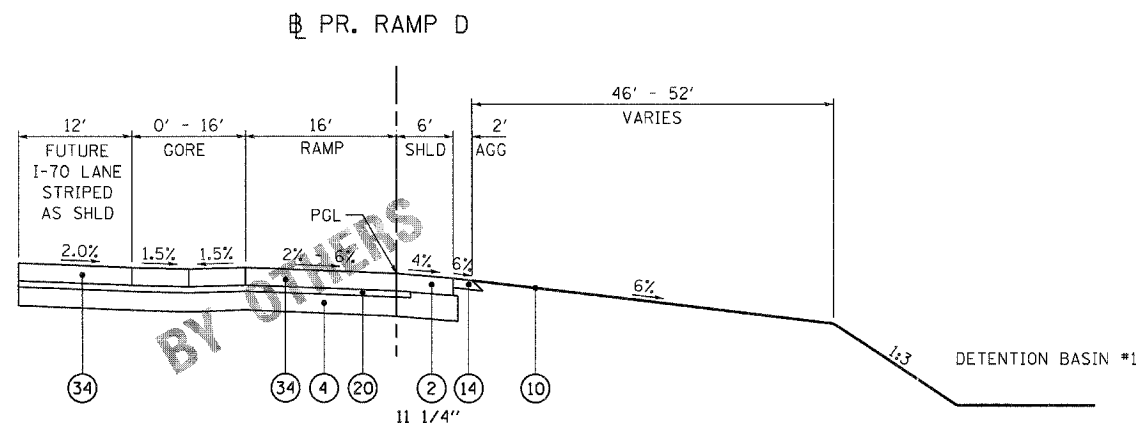

PROPOSED RAMP D TYPICAL SECTION
STA. 258+59.78 TO STA. 263+35.79
S.E. TRANSITION 258+85.00 (+6%) TO 260+15.00 (+2%)

M

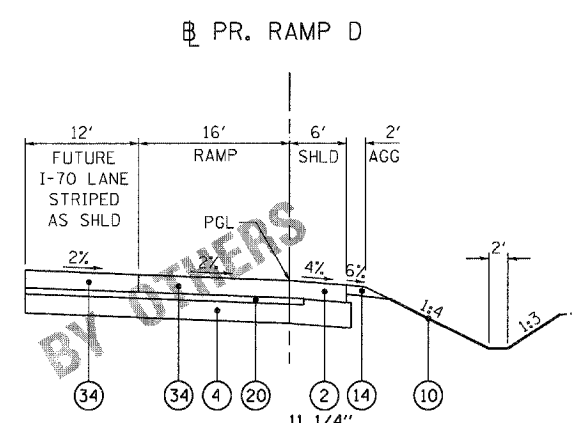

PROPOSED RAMP D TYPICAL SECTION
STA. 263+35.79 TO STA. 265+35.67

N

EXISTING LEGEND

- A EXISTING BITUMINOUS PAVEMENT
- B EXISTING PCC PAVEMENT
- C AGGREGATE SHOULDER
- D CURB AND GUTTER
- E BITUMINOUS SHOULDER
- F TEMPORARY PAVEMENT
- G AGGREGATE SUBGRADE
- H EXISTING SIDEWALK
- R = REMOVAL

PROPOSED LEGEND

- 1 PORTLAND CEMENT CONCRETE PAVEMENT 11" (JOINTED)
- 2 PORTLAND CEMENT CONCRETE SHOULDERS 11"
- 3 RETAINING WALL (BY OTHERS)
- 4 AGGREGATE SUBGRADE 12"
- 5 CONCRETE BARRIER, DOUBLE FACE, 42 INCH HEIGHT
- 6 CONCRETE BARRIER BASE
- 7 AGGREGATE SURFACE COURSE, TYPE B, 12" (NOT USED)
- 8 EMBANKMENT
- 9 HOT-MIX ASPHALT SHOULDERS, 8"
- 10 SEEDING & LANDSCAPING BY OTHERS
- 11 HOT-MIX ASPHALT PAVEMENT (FULL-DEPTH), 15.75"
- 12 COMBINATION CONCRETE CURB AND GUTTER, TYPE B-6.12
- 13 COMBINATION CONCRETE CURB AND GUTTER, TYPE B-6.24
- 14 AGGREGATE SHOULDERS, TYPE B 6"
- 15 42" CONCRETE BARRIER (BY OTHERS)
- 16 STEEL PLATE BEAM GUARDRAIL, TYPE A
- 17 CHAIN LINK FENCE, 6'
- 18 HOT-MIX ASPHALT SURFACE COURSE, MIX "D", N70
- 19 CONCRETE MEDIAN SURFACE, 6"
- 20 STABILIZED SUBBASE - HOT-MIX ASPHALT, 4"
- 21 COMBINATION CONCRETE CURB AND GUTTER, TYPE M-4.24
- 22 PORTLAND CEMENT CONCRETE PAVEMENT 10" (JOINTED)
- 23 PORTLAND CEMENT CONCRETE SHOULDERS 10"
- 24 LONGITUDINAL CONSTRUCTION JOINT WITH NO. 6 TIE BARS AT 24" CTS.
- 25 LONGITUDINAL SAWS JOINT WITH NO. 6 TIE BARS AT 18" CTS.
- 26 LONGITUDINAL SAWS JOINT WITH NO. 6 TIE BARS AT 30" CTS.
- 27 AGGREGATE BASE COURSE, TYPE B 6"
- 28 PORTLAND CEMENT CONCRETE PAVEMENT 12" (JOINTED)
- 29 ANCHORAGE SLAB (BY OTHERS)
- 30 POROUS GRANULAR BACKFILL
- 31 REMOVAL AND DISPOSAL OF UNSUITABLE MATERIAL OR NON-SPECIAL WASTE DISPOSAL
- LIMITS OF ARCHAEOLOGICAL EXPLORATION EARTH EXCAVATION (SPECIAL) AS REQUIRED UNDER PROPOSED ROADWAY SECTION
- 32 PORTLAND CEMENT CONCRETE SHOULDERS 12"
- 34 CONTINUOUSLY REINFORCED PORTLAND CEMENT CONCRETE PAVEMENT 11 1/4" (BY OTHERS)
- 35 PIPE UNDERDRAINS 4"
- 36 PORTLAND CEMENT CONCRETE SIDEWALK 5 INCH
- 37 CONCRETE MEDIAN, TYPE SB-6.12
- 38 CONCRETE MEDIAN, TYPE SB-6.24

ALL TIE BARS SHALL BE EPOXY COATED

* = BY OTHERS
[Symbol] = INDICATES PAYMENT INCLUDED IN COST OF ANOTHER ITEM

NOTE: THE COST OF THE ADDITIONAL THICKNESS OF AGGREGATE SUBGRADE 12" REQUIRED BENEATH THE SHOULDERS SHALL BE INCLUDED IN THE CONTRACT UNIT PRICE PER SQ YD FOR AGGREGATE SUBGRADE 12".

\\S-084\A\VAL\1.J - TRANS. 87-2282-28868-001\LEVEL 000\99 ALL CONTRACTS\CONNSHEETS CONTRACT 1\JOB\CONNS-11-SHT-TYPICAL-4.DGN
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FILE NAME =	USER NAME = #USER#	DESIGNED - JB	REVISED -	STATE OF ILLINOIS DEPARTMENT OF TRANSPORTATION PROPOSED RELOCATED IL ROUTE 3 INTERCHANGE	PROPOSED RAMP D TYPICAL SECTIONS	F.A.P. RTE.	SECTION	COUNTY	TOTAL SHEETS	SHEET NO.	
#FILE#		DRAWN - JB	REVISED -			998	82-2-1K	ST. CLAIR	353	16	
PLOT SCALE = #SCALE#		CHECKED - ACL	REVISED -			CONTRACT NO. 76E06					
PLOT DATE = #DATE#		DATE - 10/21/11	REVISED -			FED. ROAD DIST. NO. ILLINOIS FED. AID PROJECT					
SCALE: N.T.S. SHEET NO. 4 OF 9 SHEETS STA. TO STA.											

EXISTING LEGEND

- (A) EXISTING BITUMINOUS PAVEMENT
- (B) EXISTING PCC PAVEMENT
- (C) AGGREGATE SHOULDER
- (D) CURB AND GUTTER
- (E) BITUMINOUS SHOULDER
- (F) TEMPORARY PAVEMENT
- (G) AGGREGATE SUBGRADE
- (H) EXISTING SIDEWALK
- [R] = REMOVAL


PROPOSED LEGEND

- (1) PORTLAND CEMENT CONCRETE PAVEMENT 11" (JOINTED)
- (2) PORTLAND CEMENT CONCRETE SHOULDERS 11"
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- (16) STEEL PLATE BEAM GUARDRAIL, TYPE A
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- (19) CONCRETE MEDIAN SURFACE, 6"
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- (34) CONTINUOUSLY REINFORCED PORTLAND CEMENT CONCRETE PAVEMENT 11 1/4" (BY OTHERS)
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- (36) PORTLAND CEMENT CONCRETE SIDEWALK 5 INCH
- (37) CONCRETE MEDIAN, TYPE SB-6.12
- (38) CONCRETE MEDIAN, TYPE SB-6.24
- * = BY OTHERS


[] = INDICATES PAYMENT INCLUDED IN COST OF ANOTHER ITEM

NOTE: THE COST OF THE ADDITIONAL THICKNESS OF AGGREGATE SUBGRADE 12" REQUIRED BENEATH THE SHOULDERS SHALL BE INCLUDED IN THE CONTRACT UNIT PRICE PER 50 YD FOR AGGREGATE SUBGRADE 12".


PR. REL. IL ROUTE 3

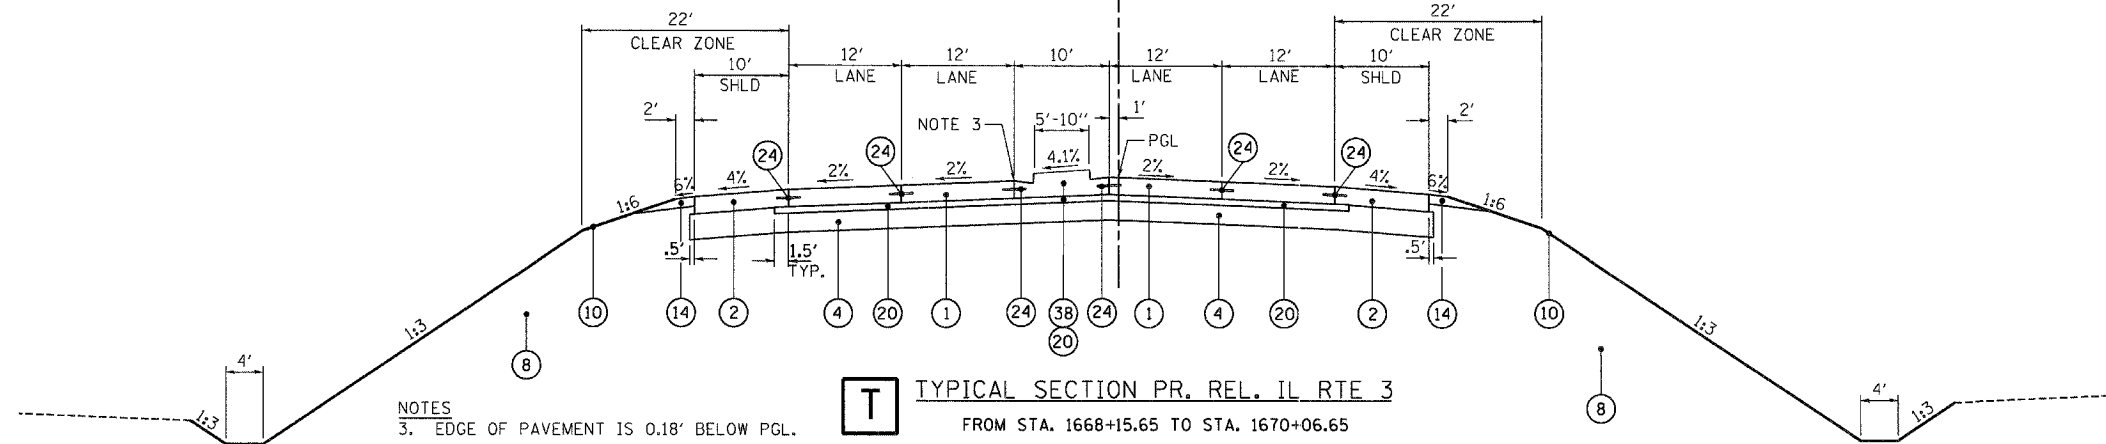


PR. REL. IL ROUTE 3

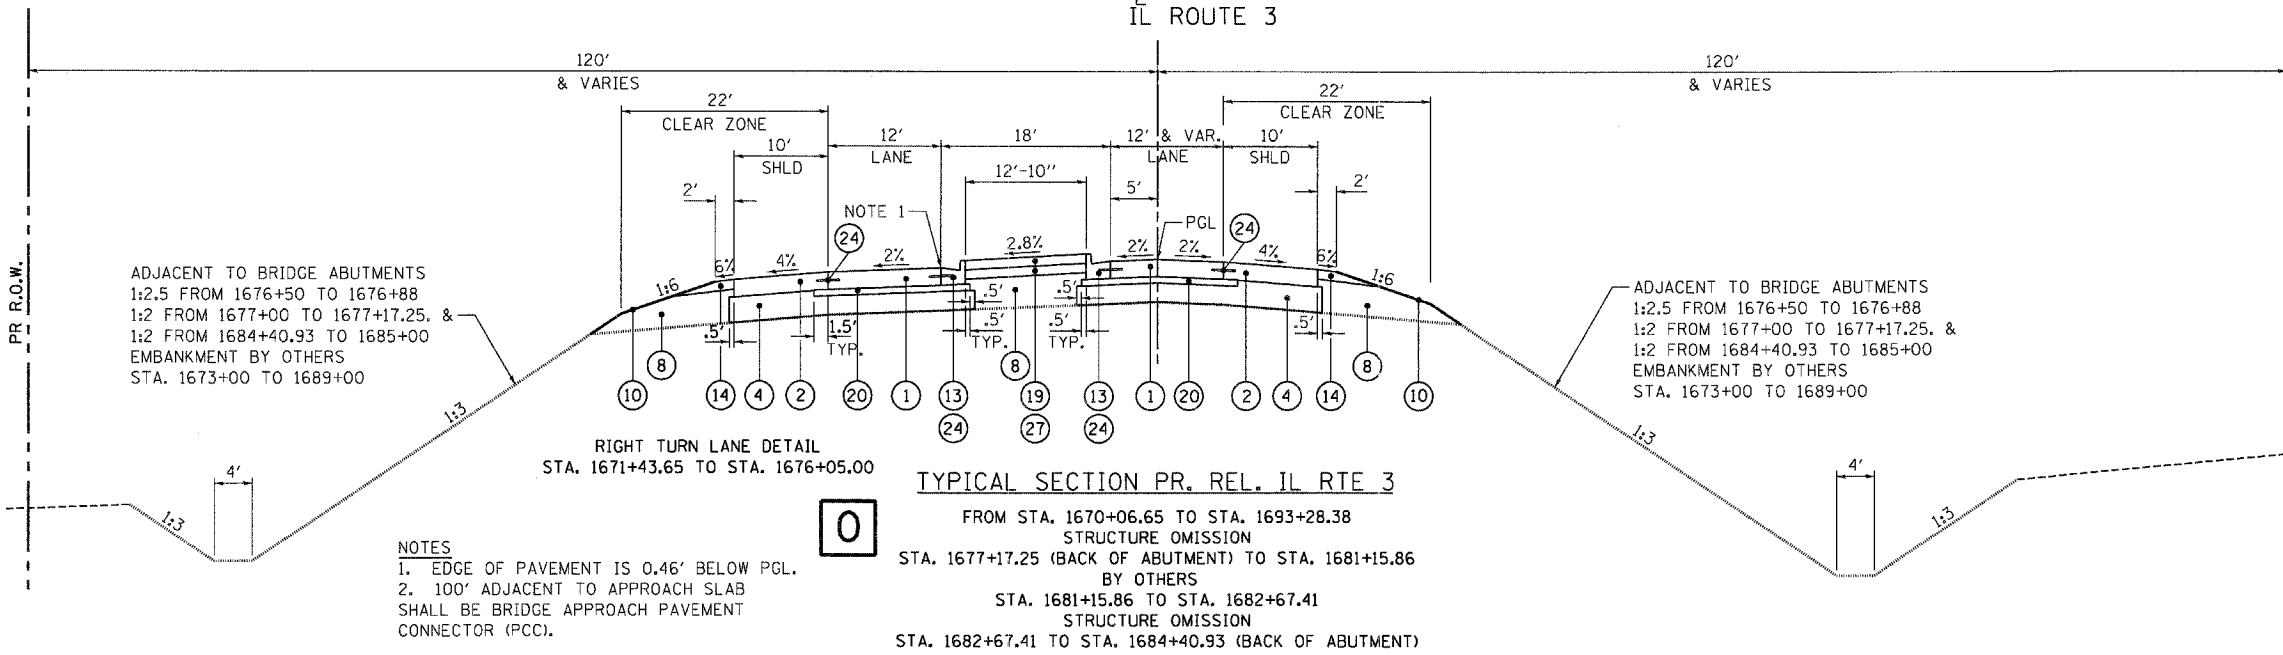


PR. REL. IL ROUTE 3

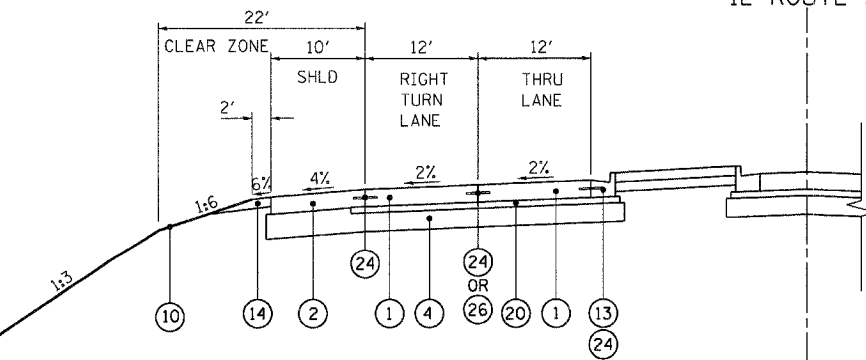

PR. REL. IL ROUTE 3

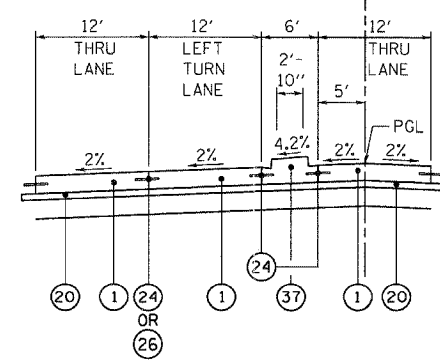

PR. REL. IL ROUTE 3

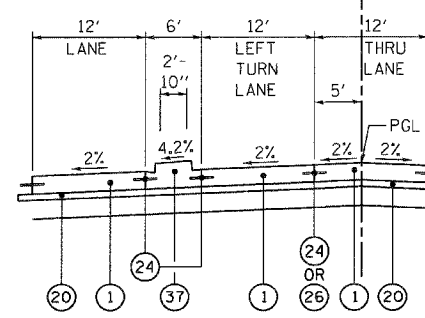

FILE NAME = USER NAME = #USER# DESIGNED - JB REVISIONS -
 #FILE# DRAWN - JB REVISIONS -
 PLOT SCALE = #SCALE# CHECKED - ACL REVISIONS -
 PLOT DATE = #DATE# DATE - 10/21/11 REVISIONS -




STATE OF ILLINOIS
DEPARTMENT OF TRANSPORTATION
PROPOSED RELOCATED IL ROUTE 3 INTERCHANGE

PROPOSED RELOCATED IL ROUTE 3
TYPICAL SECTIONS

SCALE: N.T.S. SHEET NO. 5 OF 9 SHEETS STA. TO STA.

F.A.P. RTE.	SECTION	COUNTY	TOTAL SHEETS	SHEET NO.
998	82-2-1K	ST. CLAIR	353	17
FED. ROAD DIST. NO. ILLINOIS FED. AID PROJECT			CONTRACT NO. 76E06	


EXCHANGE AVE.

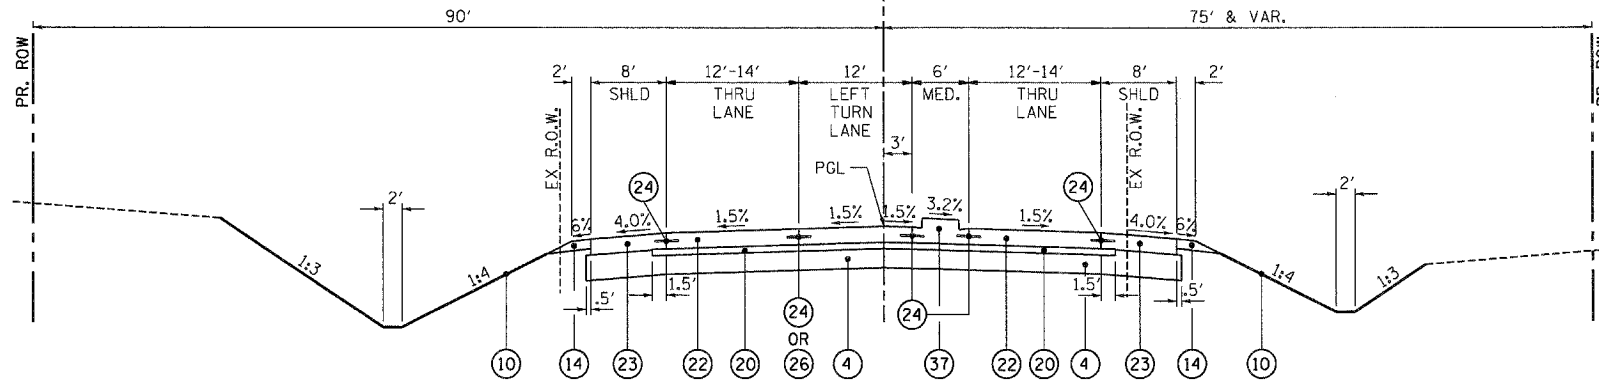

W PROPOSED TYPICAL SECTION EXCHANGE AVE.

FROM STA. 35+11.34 TO STA. 44+14.45


EXCHANGE AVE.

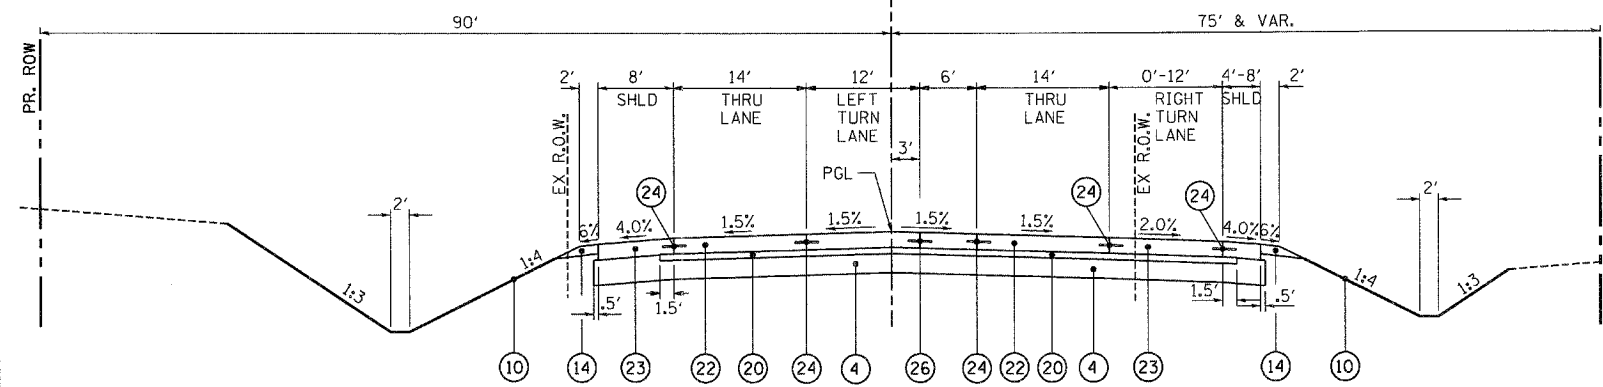

X PROPOSED TYPICAL SECTION EXCHANGE AVE.

FROM STA. 44+14.45 TO STA. 52+52.49


EXCHANGE AVE.

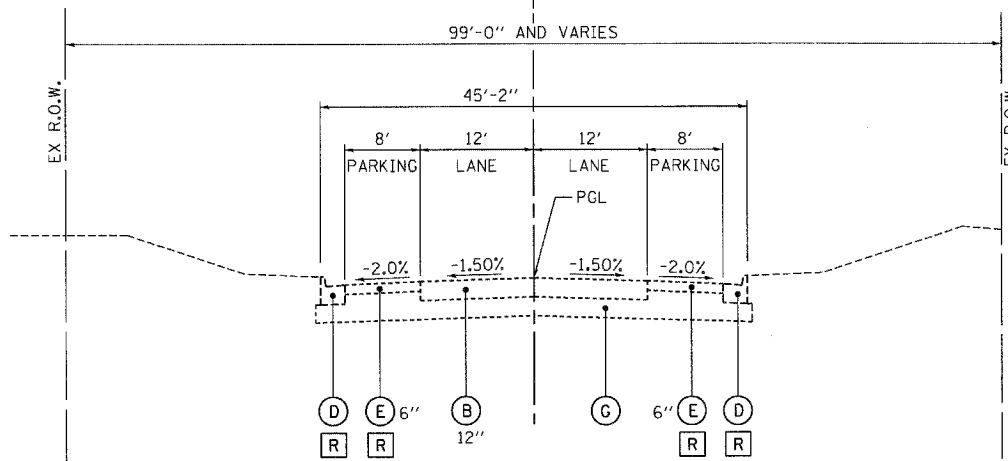

Y EXISTING TYPICAL SECTION EXCHANGE AVE.

FROM STA. 52+52.49 TO STA. 55+41.84
CONSTRUCTED IN CONTRACT 76C40

EXCHANGE AVE.

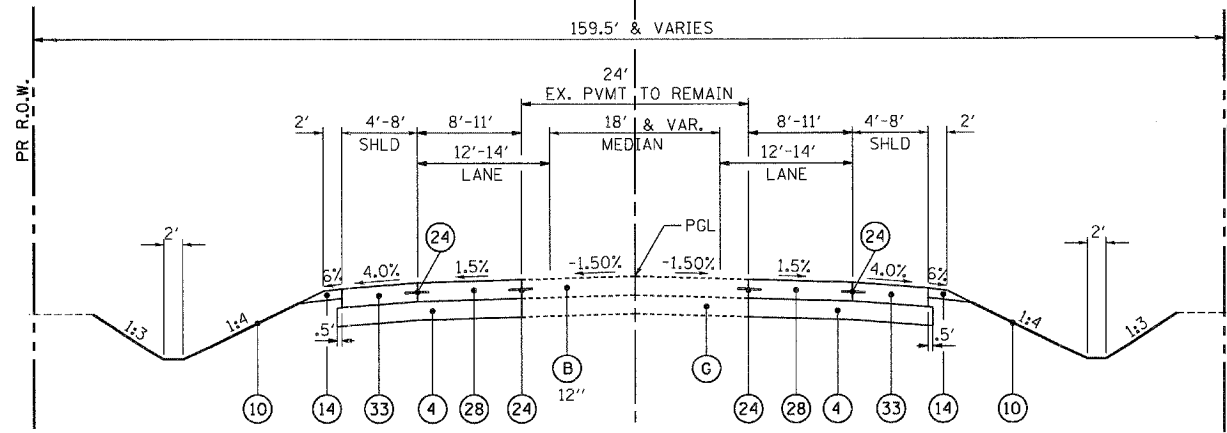

Z PROPOSED TYPICAL SECTION EXCHANGE AVE.

FROM STA. 52+52.49 TO STA. 55+41.84

EXISTING LEGEND

- (A) EXISTING BITUMINOUS PAVEMENT
- (B) EXISTING PCC PAVEMENT
- (C) AGGREGATE SHOULDER
- (D) CURB AND GUTTER
- (E) BITUMINOUS SHOULDER
- (F) TEMPORARY PAVEMENT
- (G) AGGREGATE SUBGRADE
- (H) EXISTING SIDEWALK
- [R] = REMOVAL

PROPOSED LEGEND

- (1) PORTLAND CEMENT CONCRETE PAVEMENT 11" (JOINTED)
- (2) PORTLAND CEMENT CONCRETE SHOULDERS 11"
- (3) RETAINING WALL (BY OTHERS)
- (4) AGGREGATE SUBGRADE 12"
- (5) CONCRETE BARRIER, DOUBLE FACE, 42 INCH HEIGHT
- (6) CONCRETE BARRIER BASE
- (7) AGGREGATE SURFACE COURSE, TYPE B, 12" (NOT USED)
- (8) EMBANKMENT
- (9) HOT-MIX ASPHALT SHOULDERS, 8"
- (10) SEEDING & LANDSCAPING BY OTHERS
- (11) HOT-MIX ASPHALT PAVEMENT (FULL-DEPTH), 15.75"
- (12) COMBINATION CONCRETE CURB AND GUTTER, TYPE B-6.12
- (13) COMBINATION CONCRETE CURB AND GUTTER, TYPE B-6.24
- (14) AGGREGATE SHOULDERS, TYPE B 6"
- (15) 42" CONCRETE BARRIER (BY OTHERS)
- (16) STEEL PLATE BEAM GUARDRAIL, TYPE A
- (17) CHAIN LINK FENCE, 6'
- (18) HOT-MIX ASPHALT SURFACE COURSE, MIX "D", N70
- (19) CONCRETE MEDIAN SURFACE, 6"
- (20) STABILIZED SUBBASE - HOT-MIX ASPHALT, 4"
- (21) COMBINATION CONCRETE CURB AND GUTTER, TYPE M-4.24
- (22) PORTLAND CEMENT CONCRETE PAVEMENT 10" (JOINTED)
- (23) PORTLAND CEMENT CONCRETE SHOULDERS 10"
- (24) LONGITUDINAL CONSTRUCTION JOINT WITH NO. 6 TIE BARS AT 24" CTS.
- (25) LONGITUDINAL SAWED JOINT WITH NO. 6 TIE BARS AT 18" CTS.
- (26) LONGITUDINAL SAWED JOINT WITH NO. 6 TIE BARS AT 30" CTS.
- (27) AGGREGATE BASE COURSE, TYPE B 6"
- (28) PORTLAND CEMENT CONCRETE PAVEMENT 12" (JOINTED)
- (29) ANCHORAGE SLAB (BY OTHERS)
- (30) POROUS GRANULAR BACKFILL
- (31) REMOVAL AND DISPOSAL OF UNSUITABLE MATERIAL OR NON-SPECIAL WASTE DISPOSAL
- (32) LIMITS OF ARCHAEOLOGICAL EXPLORATION EARTH EXCAVATION (SPECIAL) AS REQUIRED UNDER PROPOSED ROADWAY SECTION
- (33) PORTLAND CEMENT CONCRETE SHOULDERS 12"
- (34) CONTINUOUSLY REINFORCED PORTLAND CEMENT CONCRETE PAVEMENT 11 1/4" (BY OTHERS)
- (35) PIPE UNDERDRAINS 4"
- (36) PORTLAND CEMENT CONCRETE SIDEWALK 5 INCH
- (37) CONCRETE MEDIAN, TYPE SB-6.12
- (38) CONCRETE MEDIAN, TYPE SB-6.24
- * = BY OTHERS

ALL TIE BARS SHALL BE EPOXY COATED

[] = INDICATES PAYMENT INCLUDED IN COST OF ANOTHER ITEM

NOTE: THE COST OF THE ADDITIONAL THICKNESS OF AGGREGATE SUBGRADE 12" REQUIRED BENEATH THE SHOULDERS SHALL BE INCLUDED IN THE CONTRACT UNIT PRICE PER SQ YD FOR AGGREGATE SUBGRADE 12".

FILE NAME =	USER NAME = #USER#	DESIGNED - JB	REVISED -	STATE OF ILLINOIS DEPARTMENT OF TRANSPORTATION PROPOSED RELOCATED IL ROUTE 3 INTERCHANGE		PROPOSED EXCHANGE AVENUE TYPICAL SECTIONS		F.A.P. RTE.	SECTION	COUNTY	TOTAL SHEETS	SHEET NO.
#FILE#	PLOT SCALE = #SCALE#	DRAWN - JB	REVISED -					998	82-2-1K	ST. CLAIR	353	19
	PLOT DATE = #DATE#	CHECKED - ACL	REVISED -	SCALE: N.T.S.		SHEET NO. 7 OF 9 SHEETS		STA. TO STA.		CONTRACT NO. 76E06		
DATE - 10/21/11				REVISI				ILLINOIS FED. AID PROJECT				

\BDCONN-99-MOTIF.LDRN, \BDCONN-11-TYPSE.LDRN, \BDCONN-11-LEGEN.LDRN, \BDCONN-11-MOTIF.LDRN, \BDCONN-11-TYPSE.LDRN, \BDCONN-11-LEGEN.LDRN, \BDCONN-11-SHT-TYPICAL.ZDGN
 10-19-2011, 14:26:57
 \S:\9944\AVM\VALT.D-TRANS.07\2202\28858-081\CVL\CAD\99 ALL CONTRACTS\CONNSHEETS CONTRACT 11\BDCONN-11-SHT-TYPICAL.ZDGN



TENG & ASSOCIATES, INC.
ENGINEERS/ARCHITECTS/PLANNERS
CHICAGO, ILLINOIS

EXISTING LEGEND

- (A) EXISTING BITUMINOUS PAVEMENT
- (B) EXISTING PCC PAVEMENT
- (C) AGGREGATE SHOULDER
- (D) CURB AND GUTTER
- (E) BITUMINOUS SHOULDER
- (F) TEMPORARY PAVEMENT
- (G) AGGREGATE SUBGRADE
- (H) EXISTING SIDEWALK
- [R] = REMOVAL


PROPOSED LEGEND

- (1) PORTLAND CEMENT CONCRETE PAVEMENT 11" (JOINTED)
- (2) PORTLAND CEMENT CONCRETE SHOULDERS 11"
- (3) RETAINING WALL (BY OTHERS)
- (4) AGGREGATE SUBGRADE 12"
- (5) CONCRETE BARRIER, DOUBLE FACE, 42 INCH HEIGHT
- (6) CONCRETE BARRIER BASE
- (7) AGGREGATE SURFACE COURSE, TYPE B, 12" (NOT USED)
- (8) EMBANKMENT
- (9) HOT-MIX ASPHALT SHOULDERS, 8"
- (10) SEEDING & LANDSCAPING BY OTHERS
- (11) HOT-MIX ASPHALT PAVEMENT (FULL-DEPTH), 15.75"
- (12) COMBINATION CONCRETE CURB AND GUTTER, TYPE B-6.12
- (13) COMBINATION CONCRETE CURB AND GUTTER, TYPE B-6.24
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- * = BY OTHERS


ALL TIE BARS SHALL BE EPOXY COATED

[] = INDICATES PAYMENT INCLUDED IN COST OF ANOTHER ITEM

NOTE: THE COST OF THE ADDITIONAL THICKNESS OF AGGREGATE SUBGRADE 12" REQUIRED BENEATH THE SHOULDERS SHALL BE INCLUDED IN THE CONTRACT UNIT PRICE PER SQ YD FOR AGGREGATE SUBGRADE 12".

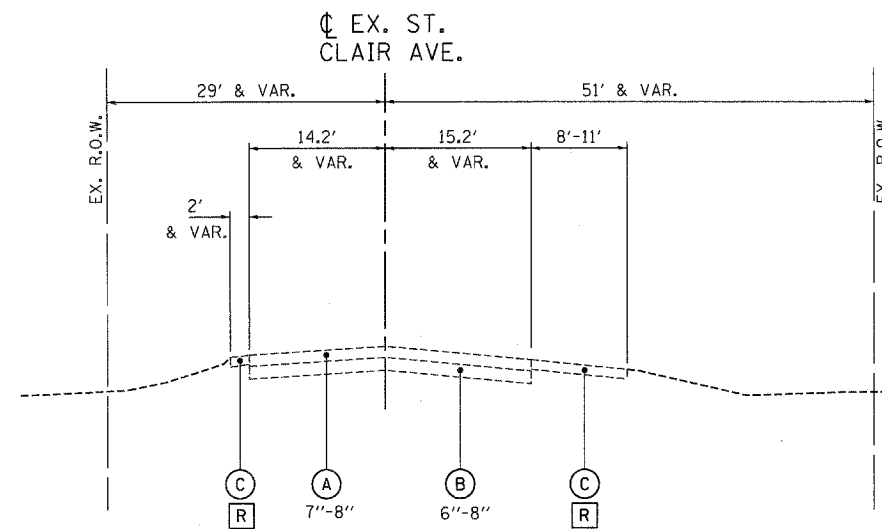

AA EXISTING TYPICAL SECTION ST. CLAIR AVE.
FROM STA. 107+15.09 TO STA. 119+42.50


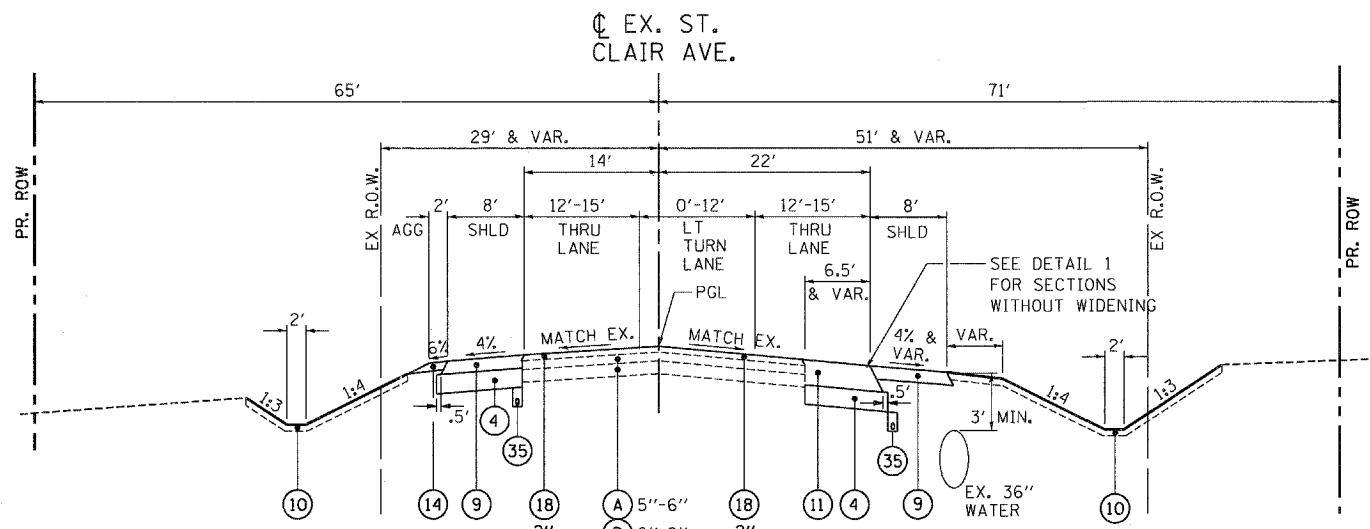


BB PROPOSED TYPICAL SECTION ST. CLAIR AVE.
FROM STA. 107+15.07 TO STA. 119+42.50
LONGITUDINAL UNDERDRAINS ARE REQUIRED ONLY BET. STA. 117+61 TO 119+42.50


2" HMA SC "D" N70
13.75" P HMA BC IL19.0 FG N90
HOT-MIX ASPHALT PAVEMENT (FULL DEPTH), 15.75"

EX. ST. CLAIR AVE.


STRUCTURAL DESIGN TRAFFIC:	YEAR	2030
PV = 17,677	SU = NA	MU = 1,964
ROAD/STREET CLASSIFICATION:	CLASS	2
PERCENT OF STRUCTURAL DESIGN TRAFFIC IN DESIGN LANE:		
P = 50%	S = NA	M = 50%
TRAFFIC FACTOR	ACTUAL TF = 7.60	AC TYPE = 20
	MINIMUM TF = 3.81	
PG GRADE:	BINDER = IL-19.0, N70	SURFACE = MIX "D", N70
SUBGRADE SUPPORT RATING:	SSR = POOR	

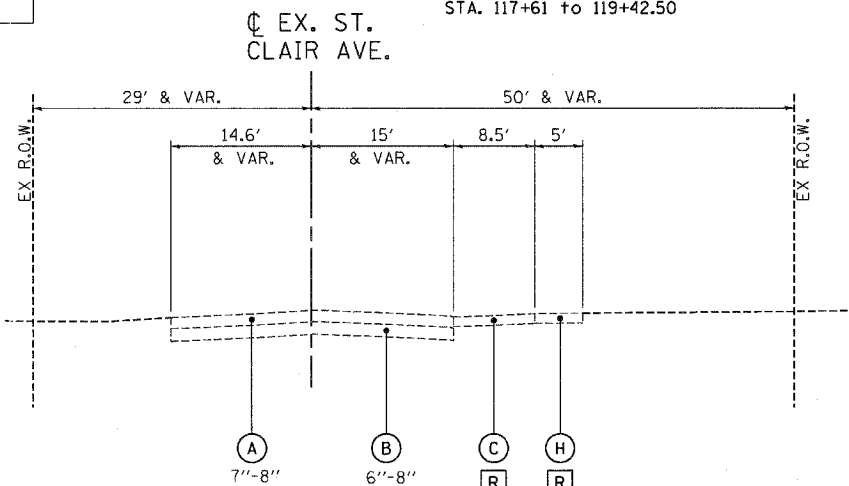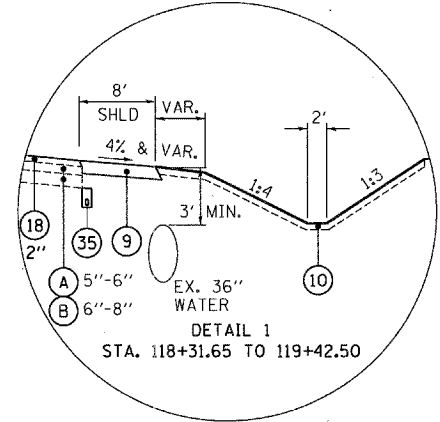

CC EXISTING TYPICAL SECTION ST. CLAIR AVE.
FROM STA. 119+42.50 TO STA. 125+36.55
EX. SIDEWALK BEGINS AT STA. 120+00.04

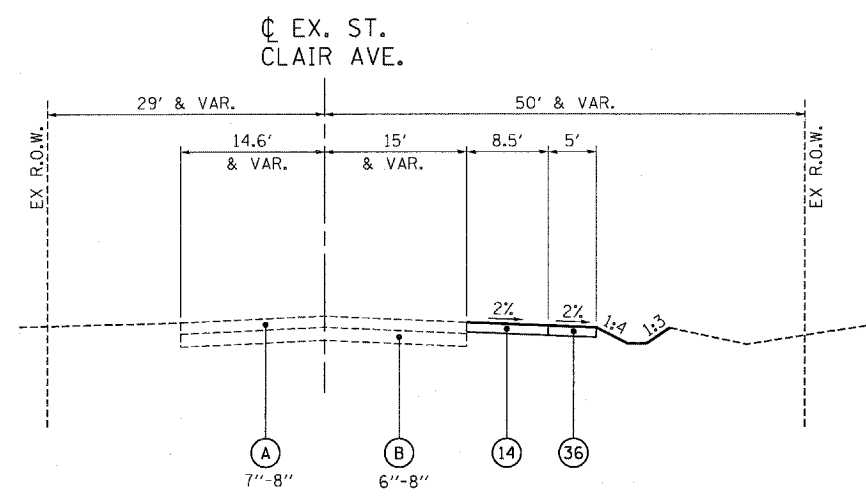

DD PROPOSED TYPICAL SECTION ST. CLAIR AVE.
FROM STA. 119+42.50 TO STA. 125+36.55
PR. SIDEWALK FROM STA. 120+00.04 TO STA. 125+36.55

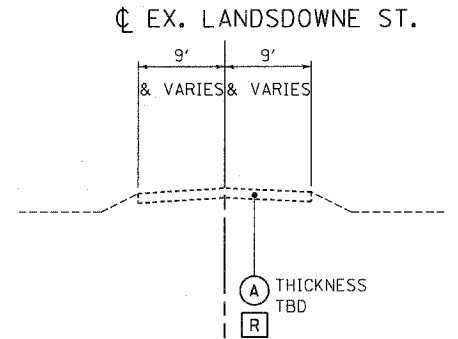

EE EXISTING TYPICAL SECTION LANDSDOWNE ST.

ILLINOIS STATE BOARD OF PROFESSIONAL ENGINEERS AND ARCHITECTS CONTRACT 11803000-11-SIT-TYPICAL-8.DGN
 11/24/2011 10:54:50
 ILLINOIS STATE BOARD OF PROFESSIONAL ENGINEERS AND ARCHITECTS CONTRACT 11803000-11-SIT-TYPICAL-8.DGN
 11/24/2011 10:54:50

11-04-2011 16:54:55 BONDHLJD \S\5-0044\AMVAULT\TRANS\07\2202\28688-001\CIVIL\CD\99 ALL CONTRACTS\CONNSHEETS CONTRACT 11\NBCONN-11-SHT-SCHEDULE2.DGN

CROSS SECTION EARTHWORK		EARTH EXCAVATION (CU YD)	REMOVAL & DISPOSAL OF UNSUITABLE MATERIAL (15% OF EARTH EXC.) (CU YD)	TOTAL SUITABLE EARTH EXCAVATION (85% OF EARTH EXCAVATION) (CU YD)	SUITABLE EARTH EXC. TO BE USED IN EMBANKMENT (25% SHRINKAGE) (CU YD)	EMBANKMENT REQUIRED (CU YD)	EARTHWORK BALANCE SEE NOTE 3 (CU YD)	NON-SPECIAL WASTE DISPOSAL (CU YD)	TOPSOIL REMOVAL, PAID AS REMOVAL & DISPOSAL OF UNSUITABLE MATERIAL (CU YD)
LOCATION STA.	TO STA.								
ST CLAIR AVE CONNECTOR									
21+15.00	21+50.00	0.0	0.0	0.0	0.0	2,406.7	-2,406.7	0.0	284.8
21+50.00	22+00.00	24.0	3.6	20.4	15.3	2,592.9	-2,577.6	0.0	361.0
22+00.00	22+50.00	25.0	3.8	21.3	15.9	2,208.2	-2,192.2	0.0	321.3
22+50.00	23+00.00	1.1	0.2	0.9	0.7	2,318.3	-2,317.6	0.0	309.1
23+00.00	23+50.00	0.1	0.0	0.0	0.0	2,201.8	-2,201.7	0.0	293.5
23+50.00	24+00.00	0.0	0.0	0.0	0.0	2,069.6	-2,069.6	0.0	252.7
24+00.00	24+50.00	0.0	0.0	0.0	0.0	1,499.9	-1,499.9	0.0	230.4
24+50.00	25+00.00	31.4	4.7	26.7	20.0	1,303.8	-1,283.8	0.0	280.2
25+00.00	25+50.00	31.4	4.7	26.7	20.0	1,583.6	-1,563.6	0.0	299.7
25+50.00	26+00.00	0.0	0.0	0.0	0.0	1,421.3	-1,421.3	0.0	243.5
26+00.00	26+50.00	0.0	0.0	0.0	0.0	1,193.7	-1,193.7	0.0	208.7
26+50.00	27+00.00	0.3	0.0	0.3	0.2	1,086.5	-1,086.3	0.0	208.3
27+00.00	27+50.00	5.9	0.9	5.0	3.8	971.3	-967.6	0.0	207.5
27+50.00	28+00.00	23.8	3.6	20.2	15.2	759.0	-743.8	0.0	204.9
28+00.00	28+50.00	44.2	6.6	37.6	28.2	545.9	-517.8	0.0	196.0
28+50.00	29+00.00	53.2	8.0	45.2	33.9	445.4	-411.5	0.0	184.6
29+00.00	29+50.00	53.3	8.0	45.3	34.0	416.0	-382.0	0.0	182.2
29+50.00	30+00.00	47.1	7.1	40.0	30.0	415.6	-385.6	0.0	186.9
30+00.00	30+50.00	35.9	5.4	30.5	22.9	447.0	-424.1	0.0	191.5
30+50.00	31+00.00	30.4	4.6	25.8	19.4	465.0	-445.7	0.0	195.9
31+00.00	31+50.00	34.9	5.2	29.7	22.3	482.2	-459.9	0.0	204.3
31+50.00	32+00.00	25.0	3.7	21.2	15.9	620.6	-604.7	0.0	244.3
32+00.00	END	0.0	0.0	0.0	0.0	0.0	0.0	0.0	0.0
SUBTOTAL		466.9	70.0	396.9	297.7	27,454.3	-27,156.6	0.0	5,291.6
EX. ST. CLAIR AVE									
107+16.00	107+50.00	11.9	1.8	10.1	7.6	3.0	4.6	0.0	17.2
107+50.00	108+00.00	35.4	5.3	30.1	22.6	13.2	9.4	0.0	48.7
108+00.00	108+50.00	48.9	7.3	41.5	31.1	37.4	-6.3	0.0	74.8
108+50.00	109+00.00	63.5	9.5	54.0	40.5	52.1	-11.7	0.0	83.3
109+00.00	109+50.00	86.7	13.0	73.7	55.3	49.1	6.2	0.0	85.6
109+50.00	110+00.00	107.8	16.2	91.7	68.7	31.6	37.1	0.0	77.9
110+00.00	110+50.00	120.1	18.0	102.1	76.6	13.2	63.4	0.0	70.8
110+50.00	111+00.00	113.6	17.0	96.5	72.4	8.4	64.0	0.0	66.0
111+00.00	111+50.00	118.0	17.7	100.3	75.2	4.3	71.0	0.0	48.5
111+50.00	112+00.00	104.6	15.7	88.9	66.7	12.9	53.7	0.0	48.1
112+00.00	112+50.00	84.5	12.7	71.9	53.9	28.8	25.1	0.0	64.0
112+50.00	113+00.00	87.4	13.1	74.2	55.7	25.3	30.4	0.0	62.3
113+00.00	113+50.00	128.8	19.3	109.5	82.1	22.7	59.4	0.0	68.4
113+50.00	114+00.00	158.6	23.8	134.8	101.1	48.1	53.1	0.0	82.2
114+00.00	114+50.00	109.8	16.5	93.4	70.0	106.8	-36.8	0.0	78.9
114+50.00	115+00.00	73.0	11.0	62.1	46.5	138.9	-92.3	0.0	71.2
115+00.00	115+50.00	73.8	11.1	62.7	47.1	88.3	-41.2	0.0	70.3
115+50.00	116+00.00	80.7	12.1	68.6	51.4	22.5	29.0	0.0	57.1
116+00.00	116+50.00	85.1	12.8	72.3	54.2	1.5	52.8	0.0	45.0
116+50.00	117+00.00	74.2	11.1	63.1	47.3	2.5	44.8	0.0	44.9
117+00.00	117+50.00	63.4	9.5	53.9	40.4	3.5	36.9	0.0	45.0
117+50.00	118+00.00	64.1	9.6	54.5	40.9	4.5	36.4	0.0	47.9
118+00.00	118+50.00	73.8	11.1	62.7	47.0	4.6	43.4	0.0	43.8
118+50.00	119+00.00	64.7	9.7	55.0	41.3	1.8	39.4	0.0	41.6
119+00.00	119+42.00	39.2	5.9	33.4	25.0	2.0	23.0	0.0	38.2
119+42.00	119+50.00	6.1	0.9	5.1	3.9	0.5	3.4	0.0	5.6
119+50.00	120+00.00	30.2	4.5	25.7	19.3	3.7	15.6	0.0	23.1
120+00.00	120+50.00	31.8	4.8	27.0	20.3	2.5	17.7	0.0	20.3
120+50.00	121+00.00	47.4	7.1	40.3	30.2	0.6	29.6	0.0	9.9
121+00.00	121+50.00	47.4	7.1	40.3	30.2	0.4	29.8	0.0	8.7
121+50.00	122+00.00	35.9	5.4	30.5	22.9	1.3	21.5	0.0	17.8
122+00.00	122+50.00	33.3	5.0	28.3	21.2	1.3	19.9	0.0	15.2

NOTES:
 1. EARTH EXCAVATION, STOCKPILE (IF REQUIRED) AND SUBSEQUENT PLACEMENT (WHEN APPLICABLE) SHALL ONLY BE MEASURED AND PAID FOR ONCE, AND NOT FOR EACH TRANSPORT.
 2. SUITABLE EARTH EXCAVATION SHALL REMAIN ON SITE WITHIN THE I-70 CORRIDOR AND BE PLACED AT THE DIRECTION OF THE ENGINEER.
 3. (-) INDICATES SHORTAGE. FURNISHED EXCAVATION OR EARTH EXCAVATION IS REQUIRED.
 (+) INDICATES SURPLUS. EARTH EXCAVATION TO BE USED ELSEWHERE WITHIN THE PROJECT LIMITS.

CROSS SECTION EARTHWORK		EARTH EXCAVATION (CU YD)	REMOVAL & DISPOSAL OF UNSUITABLE MATERIAL (15% OF EARTH EXC.) (CU YD)	TOTAL SUITABLE EARTH EXCAVATION (85% OF EARTH EXCAVATION) (CU YD)	SUITABLE EARTH EXC. TO BE USED IN EMBANKMENT (25% SHRINKAGE) (CU YD)	EMBANKMENT REQUIRED (CU YD)	EARTHWORK BALANCE SEE NOTE 3 (CU YD)	NON-SPECIAL WASTE DISPOSAL (CU YD)	TOPSOIL REMOVAL, PAID AS REMOVAL & DISPOSAL OF UNSUITABLE MATERIAL (CU YD)
LOCATION STA.	TO STA.								
EX. ST. CLAIR (CONT.)									
122+50.00	123+00.00	26.7	4.0	22.7	17.0	0.7	16.4	0.0	11.5
123+00.00	123+50.00	40.0	6.0	34.0	25.5	0.3	25.2	0.0	5.5
123+50.00	124+00.00	40.3	6.0	34.3	25.7	0.3	25.4	0.0	4.4
124+00.00	124+50.00	24.7	3.7	21.0	15.7	0.6	15.1	0.0	8.7
124+50.00	125+00.00	22.6	3.4	19.2	14.4	0.8	13.6	0.0	8.1
125+00.00	125+36.54	13.9	2.1	11.8	8.8	0.8	8.0	0.0	5.1
125+36.54	END	0.0	0.0	0.0	0.0	0.0	0.0	0.0	0.0
SUBTOTAL		2,472.0	370.8	2,101.2	1,575.9	739.7	836.2	0.0	1,625.4
W.T. DRIVE									
900+50.00	901+00.00	61.1	9.2	51.9	39.0	3.9	35.0	0.0	5.3
901+00.00	901+50.00	24.2	3.6	20.5	15.4	54.2	-38.8	0.0	20.8
901+50.00	902+00.00	0.0	0.0	0.0	0.0	295.8	-295.8	0.0	70.7
902+00.00	902+50.00	0.0	0.0	0.0	0.0	782.3	-782.3	0.0	124.0
902+50.00	END	0.0	0.0	0.0	0.0	0.0	0.0	0.0	0.0
SUBTOTAL		85.3	12.8	72.5	54.4	1,136.3	-1,081.9	0.0	220.8
EXCHANGE AVENUE									
35+12.00	35+50.00	107.4	16.1	91.3	68.4	0.7	67.7	0.0	29.9
35+50.00	36+00.00	178.6	26.8	151.8	113.9	2.9	110.9	0.0	63.8
36+00.00	36+50.00	183.2	27.5	155.7	116.8	8.3	108.5	0.0	75.8
36+50.00	37+00.00	166.7	25.0	141.7	106.3	15.5	90.7	0.0	87.0
37+00.00	39+00.00	652.9	97.9	554.9	416.2	158.7	257.5	0.0	431.8
39+00.00	39+50.00	159.9	24.0	135.9	102.0	69.1	32.8	0.0	114.0
39+50.00	40+00.00	145.2	21.8	123.4	92.5	69.0	23.5	0.0	102.7
40+00.00	40+50.00	137.4	20.6	116.8	87.6	51.8	35.9	0.0	101.4
40+50.00	41+00.00	113.1	17.0	96.1	72.1	39.9	32.2	0.0	100.4
41+00.00	41+50.00	84.8	12.7	72.1	54.1	37.0	17.0	0.0	96.6
41+50.00	42+00.00	122.4	18.4	104.0	78.0	30.4	47.6	0.0	98.1
42+00.00	42+50.00	126.4	19.0	107.4	80.6	30.8	49.8	0.0	95.3
42+50.00	43+00.00	115.8	17.4	98.4	73.8	35.3	38.5	0.0	88.9
43+00.00	43+50.00	149.4	22.4	126.9	95.2	30.4	64.8	0.0	89.3
43+50.00	44+00.00	158.4	23.8	134.6	101.0	28.7	72.3	0.0	87.9
44+00.00	44+75.84	327.9	49.2	278.7	209.0	87.5	121.6	0.0	158.4
44+75.84	45+00.00	336.4	50.5	285.9	214.5	74.7	139.7	0.0	150.3
45+00.00	46+00.00	220.4	33.1	187.3	140.5	11.7	128.8	0.0	81.9
46+00.00	46+50.00	243.5	36.5	207.0	155.3	6.4	148.8	0.0	81.5
46+50.00	47+00.00	242.6	36.4	206.2	154.7	2.8	151.9	0.0	80.2
47+00.00	47+50.00	279.0	41.8	237.1	177.9	1.4	176.5	0.0	80.9
47+50.00	48+00.00	311.3	46.7	264.6	198.5	1.3	197.1	0.0	81.4
48+00.00	48+50.00	321.9	48.3	273.6	205.2	1.4	203.9	0.0	80.9
48+50.00	49+00.00	306.2	45.9	260.3	195.2	1.3	193.9	0.0	82.1
49+00.00	49+50.00	294.2	44.1	250.1	187.5	1.4	186.2	0.0	79.9
49+50.00	50+00.00	339.3	50.9	288.4	216.3	1.0	215.2	0.0	71.3
50+00.00	51+00.00	1,454.0	218.1	1,235.9	926.9	3.3	923.6	0.0	243.1
51+00.00	52+00.00	563.1	84.5	478.6	359.0	1.4	357.5	0.0	86.7
52+00.00	52+50.00	508.5	76.3	432.2	324.2	1.4	322.8	0.0	77.7
52+50.00	53+00.00	502.6	75.4	427.2	320.4	1.5	318.9	0.0	79.2
53+00.00	53+50.00	498.5	74.8	423.7	317.8	1.4	316.4	0.0	79.5
53+50.00	54+00.00	444.7	66.7	378.0	283.5	1.4	282.1	0.0	75.5
54+00.00	54+50.00	360.5	54.1	306.4	229.8	1.4	228.4	0.0	68.2
54+50.00	55+00.00	239.4	35.9	203.5	152.6	3.9	148.8	0.0	55.6
55+00.00	55+41.84	71.5	10.7	60.7	45.6	2.6	42.9	0.0	19.9
55+41.84	END	0.0	0.0	0.0	0.0	0.0	0.0	0.0	0.0
SUBTOTAL		10,466.8	1,570.0	8,896.8	6,672.6	817.6	5,855.0	0.0	3,476.9
RETENTION BASIN									
		27,253	4,088	23,165	17,374	11,051	6,323	0	5,729
TRENCH BACKFILL									
		0	0	0	0	-852	852	0	0
NON-SPECIAL WASTE									

PROTECTIVE COAT				TOTAL 41,235 SQ YD
	LENGTH FT	WIDTH FT	SUBTOTALS	
FROM ITEM 42000501 PORTLND CEMENT CONCRETE PAVEMENT 10" (JOINTED)			18,509	
FROM ITEM 42000521 PORTLND CEMENT CONCRETE PAVEMENT 11" (JOINTED)			7,467	
FROM ITEM 42000541 PORTLND CEMENT CONCRETE PAVEMENT 12" (JOINTED)			651	
FROM ITEM 42001420 BRIDGE APPROACH PAVEMENT CONNECTOR (PCC)			662	
FROM ITEM 42300400 PORTLAND CEMENT CONCRETE DRIVEWAY PAVEMENT, 8 INCH			523	
FROM ITEM 42400200 PORTLAND CEMENT CONCRETE SIDEWALK 5 INCH			298	
FROM ITEM 48300500 PORTLAND CEMENT CONCRETE SHOULDERS 10"			5,572	
FROM ITEM 48300600 PORTLAND CEMENT CONCRETE SHOULDERS 11"			4,014	
FROM ITEM 48300600 PORTLAND CEMENT CONCRETE SHOULDERS 12"			387	
FROM ITEM 60603800 COMBINATION CONCRETE CURB & GUTTER, TYPE B-6.12	901	2	200	
FROM ITEM 60605000 COMBINATION CONCRETE CURB & GUTTER, TYPE B-6.24	1,214	3	405	
FROM ITEM 60608600 COMBINATION CONCRETE CURB & GUTTER, TYPE M-6.06	34	1.5	6	
FROM ITEM 60610400 COMBINATION CONCRETE CURB & GUTTER, TYPE M-6.24	255	3	85	
FROM ITEM 60618320 CONCRETE MEDIAN SURFACE, 6 INCH			1,348	
FROM ALL CONCRETE MEDIANS, TYPE B & TYPE M			805	
FROM ITEM 60600095 CLASS SI CONCRETE (OUTLET)	100	4	303	

BRIDGE APPROACH PAVEMENT CONNECTOR (PCC)						TOTAL 662 SQ YD
LOCATION	FROM STATION	TO STATION	NB / SB	AREA (SQ FT)	SUBTOTALS	
PR. REL. IL RTE 3	1684+70.43	1685+70.43	SB	2,331	259.0	
PR. REL. IL RTE 3	1684+70.43	1685+70.43	NB	1,216	135.1	
PR. REL. IL RTE 3	1675+87.75	1676+87.75	SB	1,209	134.3	
PR. REL. IL RTE 3	1675+87.75	1676+87.75	NB	1,200	133.3	

PORTLAND CEMENT CONCRETE DRIVEWAY PAVEMENT, 8 INCH					TOTAL 523 SQ YD
LOCATION	STATION	LT / RT	AREA SQ FT	SUBTOTALS	
EXCHANGE	44+75.84	RT	2,107	234	
EXCHANGE	44+75.84	LT	2,597	289	

PORTLAND CEMENT CONCRETE SIDEWALK 5 INCH						TOTAL 2,683 SQ FT
LOCATION	FROM STA.	OFFSET	TO STA.	OFFSET	WIDTH FEET	SUBTOTALS
EX. ST. CLAIR	120+00.0	22.94 RT	125+36.6	23.57 RT	5	2,683

PAVEMENT REMOVAL								TOTAL 8,598 SQ YD
LOCATION	STA.	OFF	TO STA.	TO OFF	TYPE	AREA (SF)	SUBTOTALS	
LANDSDOWNE ST.	111+45.62	14.00	LT 111+48.00	944.00	LT ASPHALT	17,038	1,893	
EXCHANGE	35+11.34	12.24	LT 43+00.00	19.35	RT ASPHALT	13,731	1,526	
	43+00.00	0.51	LT 49+30.36	16.00	RT ASPHALT	11,151	1,239	
	49+30.36	7.75	RT 52+52.49	12.00	LT CONCRETE	11,093	1,233	
PR REL IL ROUTE 3	1689+95.31	116.87	LT 1692+59.32	15.54	RT ASPHALT	18,967	2,107	
	1692+16.04	126.86	LT 1691+89.62	120.00	LT ASPHALT	205	23	
DARLING	1017+75.00	11.00	LT 1020+13.70	8.30	RT ASPHALT	5,200	578	

HOT-MIX ASPHALT SURFACE REMOVAL, 2"					TOTAL 3,988 SQ YD
LOCATION	STA	STA	AREA SQ FT	SUBTOTALS	
EX. ST. CLAIR	119+42.50	117+00.00	7,062	785	
EX. ST. CLAIR	117+00.00	109+00.00	23,346	2,594	
EX. ST. CLAIR	109+00.00	107+15.07	5,481	609	

DRIVEWAY PAVEMENT REMOVAL							TOTAL 147 SQ YD
LOCATION	STA.	OFF	STA.	OFF.	AREA SQ FT	SUBTOTALS	
EXCHANGE	49+98.84	25.24	LT 50+38.64	12.17	LT 534	59	
EXCHANGE	50+67.99	44.50	LT 51+03.86	13.00	LT 788	88	

COMBINATION CURB AND GUTTER REMOVAL							TOTAL 1,376 FOOT
LOCATION	STA.	OFF.	STA.	OFF.	AREA SQ FT	SUBTOTALS	
EXCHANGE	49+30.26	7.75	LT 55+41.60	22.02	LT 623	623	
	49+30.36	18.00	RT 50+63.19	70.00	RT 164	164	
	49+88.98	11.79	LT 50+22.84	28.29	LT 47	47	
	50+52.74	13.87	LT 50+88.86	44.50	LT 78	78	
	50+97.19	70.00	RT 55+41.50	22.08	RT 464	464	

SIDEWALK REMOVAL							TOTAL 2,683 SQ FT
LOCATION	FROM STA.	OFFSET	TO STA.	OFFSET	AREA SQ FT	SUBTOTALS	
EX. ST. CLAIR	120+00.0	22.94 RT	125+36.6	28.57 RT	2,683	2,683	

PAVED SHOULDER REMOVAL								TOTAL 674 SQ YD
LOCATION	STATION	OFFSET	STATION	OFFSET	AREA SQ FT	TYPE	SUBTOTALS	
EXCHANGE	51+76.38	-12	55+41.84	-20	2,935	ASPHALT	326	
EXCHANGE	51+45.19	12	55+41.84	20	3,130	ASPHALT	348	

CLASS D PATCHES, TYPE I, 14 INCH					TOTAL 10 SQ YD
LOCATION	STA.	OFF	AREA SQ FT	SUBTOTALS	
EX. ST. CLAIR	119+41.50	LT	44	4.89	
EX. ST. CLAIR	119+41.50	RT	45.1	5.01	

SAW CUTS								TOTAL 2,449 FOOT
LOCATION	STATION	OFFSET	STATION	OFFSET	TYPE	AREA SQ FT	SUBTOTALS	
EX. ST. CLAIR	107+15.07	15.79	RT 109+00.00	15.58	RT LONGITUDINAL X2	370	370	
EX. ST. CLAIR	109+00.00	15.58	RT 117+00.00	15.23	RT LONGITUDINAL X2	1,600	1,600	
EX. ST. CLAIR	117+00.00	15.23	RT 119+39.50	15.17	RT LONGITUDINAL X2	479	479	

AGGREGATE SHOULDERS, TYPE B 6"						TOTAL 3,540 SQ YD
LOCATION	STATION	STATION	AREA SQ FT	SUBTOTALS		
CONNECTOR	20+99.7	22+50.0	RT 300	33		
CONNECTOR	22+50.0	32+26.7	RT 1,991	221		
CONNECTOR	21+15.0	22+50.0	LT 274	30		
CONNECTOR	22+50.0	24+11.3	LT 360	40		
CONNECTOR	24+42.8	32+30.4	LT 1,661	185		

EX. ST. CLAIR	107+15.1	109+00.0	LT 370	41		
EX. ST. CLAIR	109+00.0	113+75.6	LT 941	105		
EX. ST. CLAIR	115+43.5	117+00.0	LT 318	35		
EX. ST. CLAIR	117+00.0	118+37.3	LT 273	30		
EX. ST. CLAIR	118+62.3	119+42.5	LT 158	18		
EX. ST. CLAIR	119+42.5	125+36.6	RT 5,019	558		

EXCHANGE	35+11.3	36+67.2	RT 312	35		
EXCHANGE	39+39.4	43+00.0	RT 714	79		
EXCHANGE	35+11.3	43+00.0	LT 1,578	175		
EXCHANGE	43+00.0	44+38.3	RT 274	30		
EXCHANGE	45+13.3	49+50.6	RT 872	97		
EXCHANGE	51+48.7	52+52.5	RT 210	23		
EXCHANGE	43+00.0	44+35.5	LT 274	30		
EXCHANGE	45+16.2	52+52.5	LT 1,476	164		
EXCHANGE	52+52.5	54+61.1	LT 424	47		
EXCHANGE	52+52.5	54+53.3	RT 393	44		

RAMP C	110+40.0	110+68.7	RT 57	6		
RAMP C	110+40.0	110+67.7	LT 57	6		
RAMP C	110+68.7	116+40.0	RT 1,126	125		
RAMP C	110+67.7	116+40.0	LT 1,193	133		
RAMP C	116+40.0	119+45.9	LT 618	69		
RAMP C	116+40.0	119+61.0	RT 634	70		

RAMP D	250+94.6	254+00.0	LT 628	70		
RAMP D	250+32.4	254+00.0	RT 825	92		
RAMP D	254+00.0	258+00.0	LT 853	95		
RAMP D	254+00.0	258+00.0	RT 785	87		

PR. REL. IL RTE 3	1668+15.7	1670+26.7	LT 485	54		
PR. REL. IL RTE 3	1670+83.6	1676+87.8	LT 1,161	129		
PR. REL. IL RTE 3	1668+15.7	1676+87.8	RT 1,350	150		
PR. REL. IL RTE 3	1684+67.8	1687+40.0	RT 461	51		
PR. REL. IL RTE 3	1684+72.8	1687+40.0	LT 265	29		
PR. REL. IL RTE 3	1687+40.0	1692+77.8	LT 1,068	119		
PR. REL. IL RTE 3	1687+40.0	1692+84.6	RT 1,131	126		

WT DRIVE	900+50.0	902+74.4	LT 495	55		
WT DRIVE	900+50.0	902+69.4	RT 478	53		

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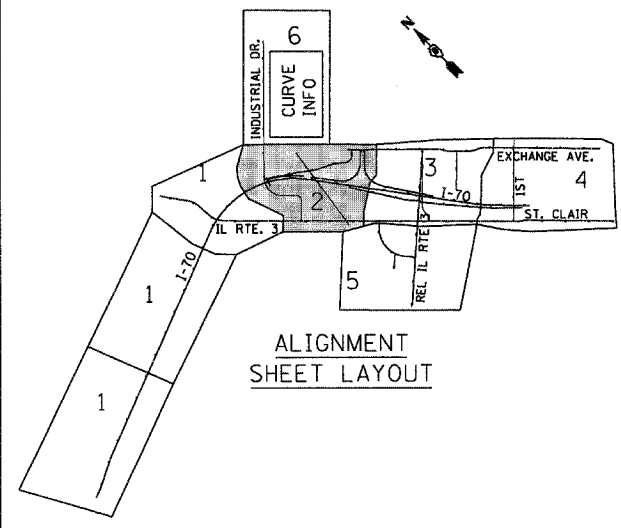
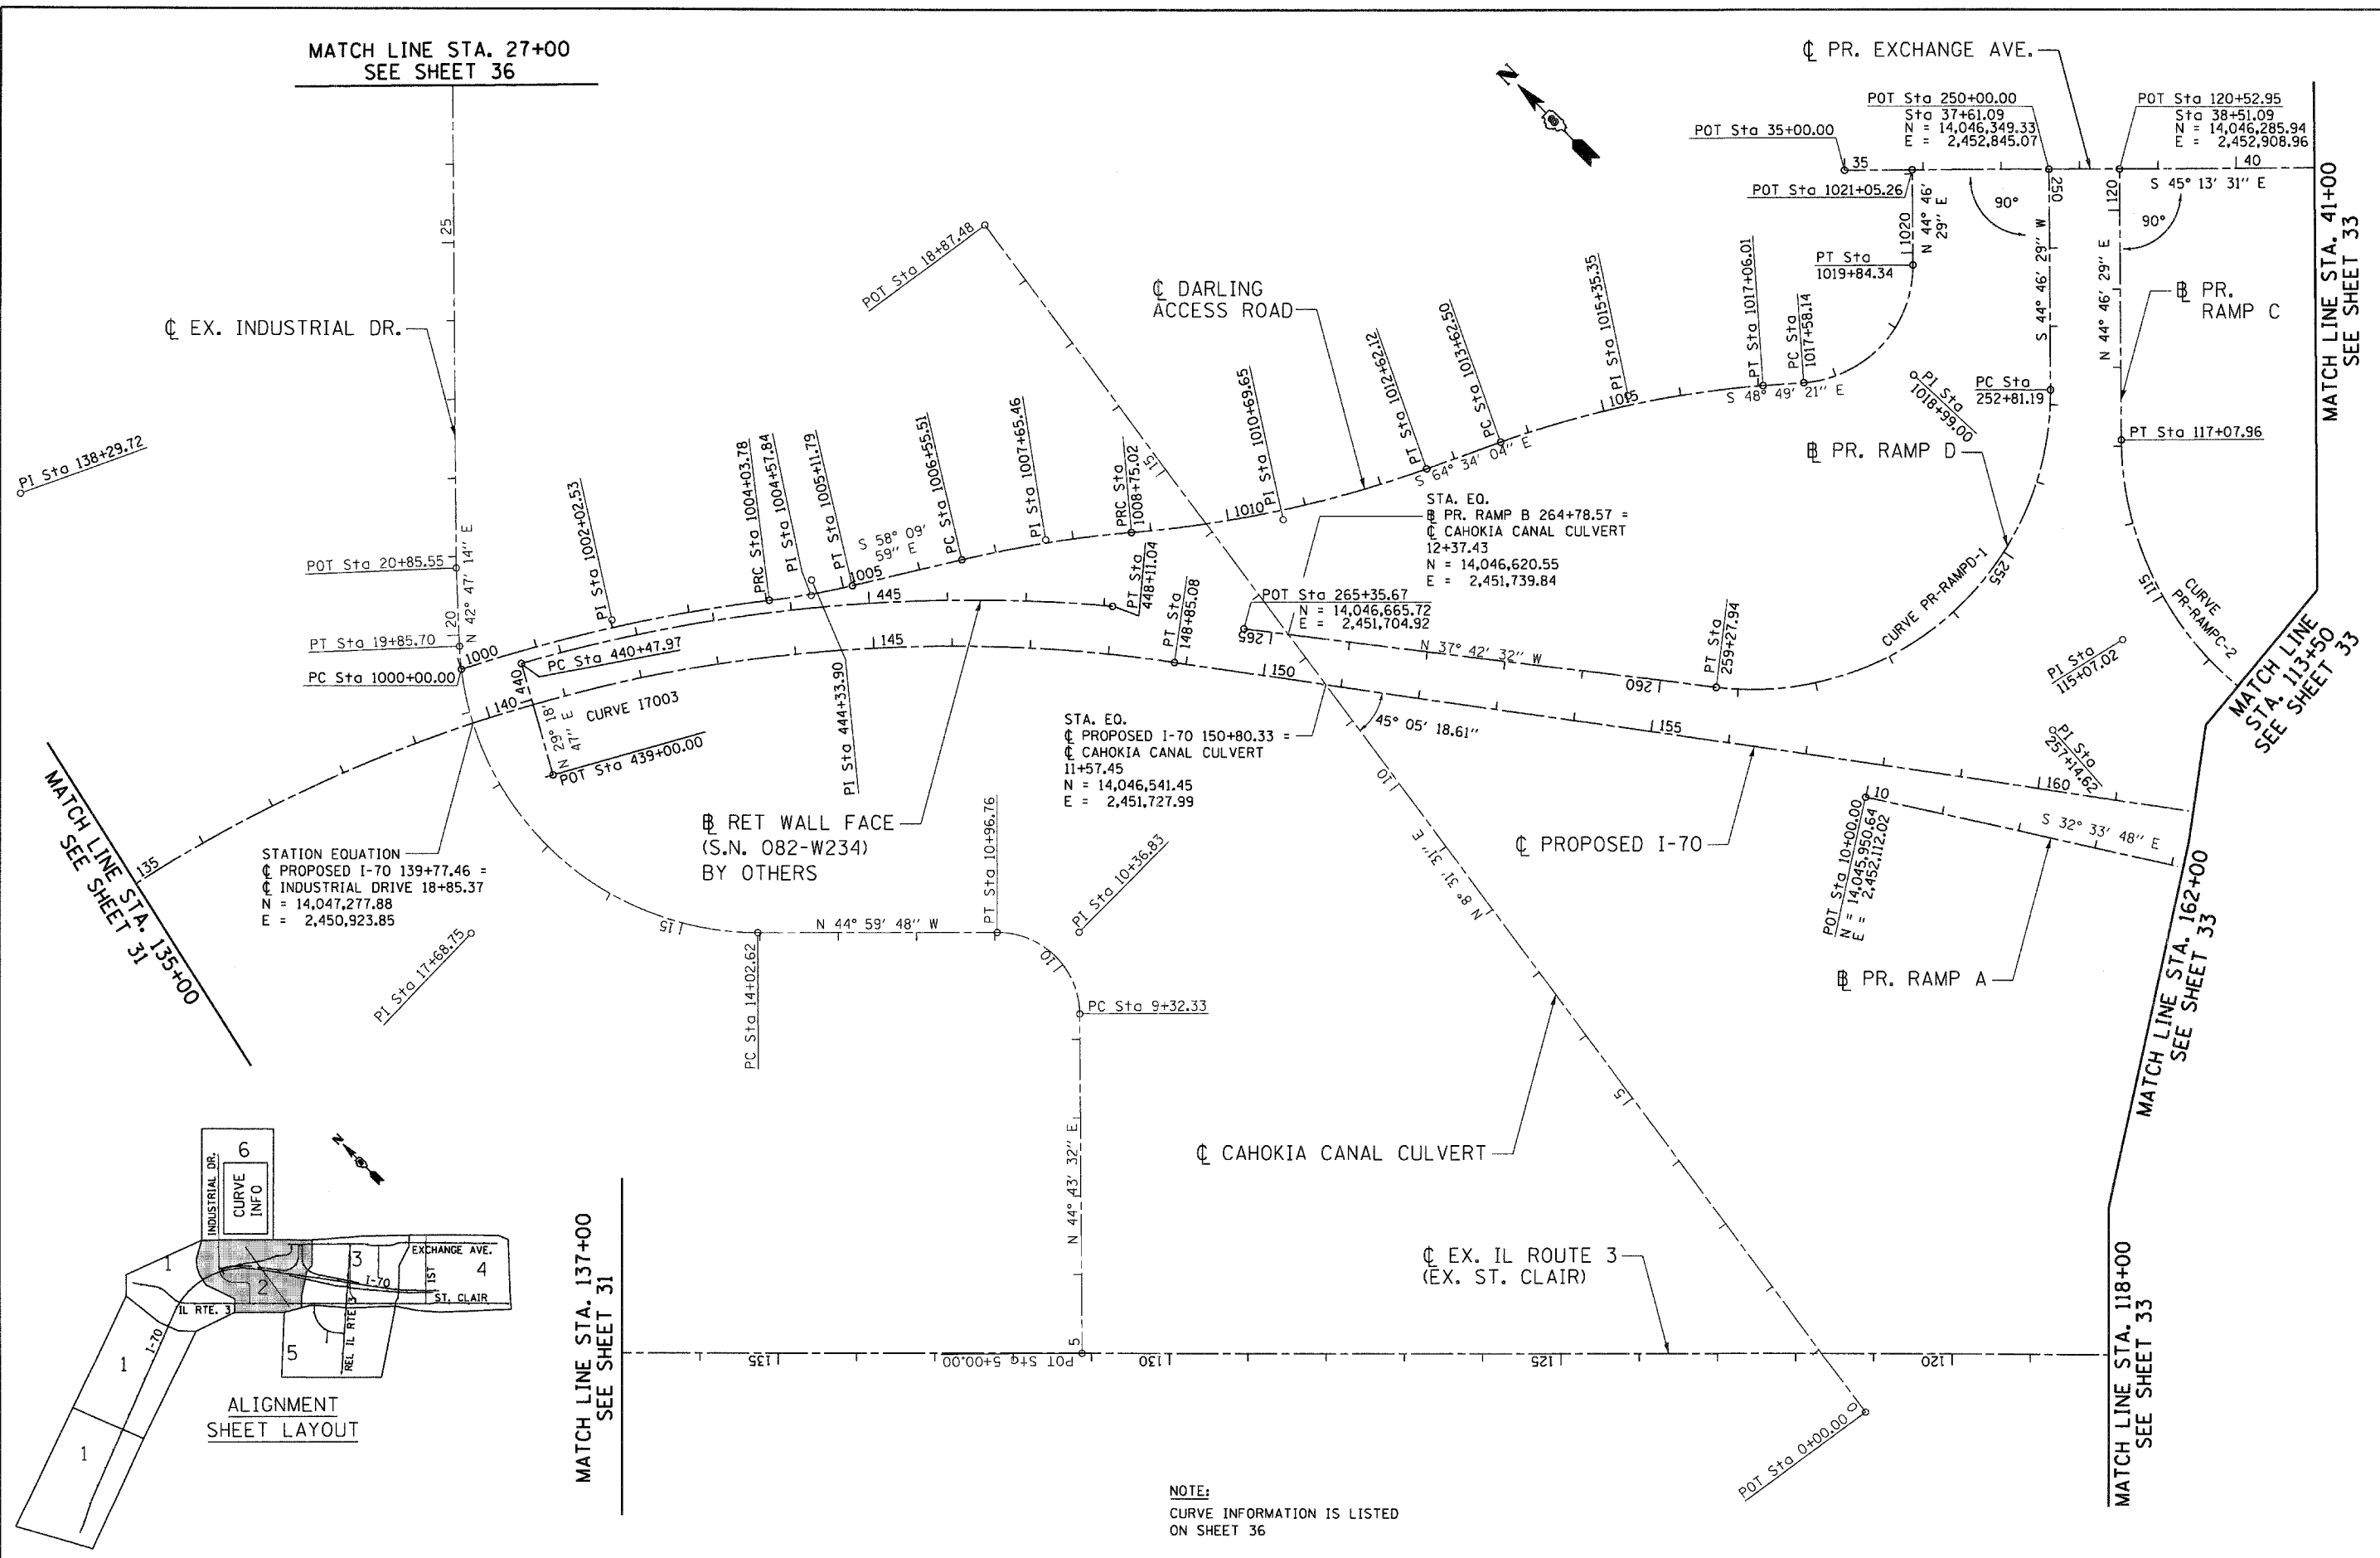
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STATE OF ILLINOIS
DEPARTMENT OF TRANSPORTATION
 PROPOSED RELOCATED IL ROUTE 3 INTERCHANGE

SCHEDULE OF QUANTITIES 5
 SCALE: N.T.S. SHEET NO. 5 OF 9 SHEETS STA. TO STA.

F.A.P. RTE.	SECTION	COUNTY	TOTAL SHEETS	SHEET NO.
998	82-2-1K	ST. CLAIR	353	26
FED. ROAD DIST. NO.			ILLINOIS FED. AID PROJECT	
			CONTRACT NO. 76E06	



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NOTE:
 CURVE INFORMATION IS LISTED
 ON SHEET 36

FILE NAME =	USER NAME = #USER#	DESIGNED - JB	REVISED -	STATE OF ILLINOIS DEPARTMENT OF TRANSPORTATION PROPOSED RELOCATED IL ROUTE 3 INTERCHANGE	ALIGNMENTS, TIES & BENCHMARKS 2		F.A.P. RTE. 998	SECTION 82-2-1K	COUNTY ST. CLAIR	TOTAL SHEETS 353	SHEET NO. 32	
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TENG & ASSOCIATES, INC. ENGINEERS/ARCHITECTS/PLANNERS CHICAGO, ILLINOIS	PLOT DATE = #DATE#	CHECKED - ACL	REVISED -									
		DATE - 10/21/11	REVISED -									

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MATCH LINE STA. 118+00
SEE SHEET 32

MATCH LINE STA. 162+00
SEE SHEET 32

MATCH LINE STA. 113+50
SEE SHEET 32

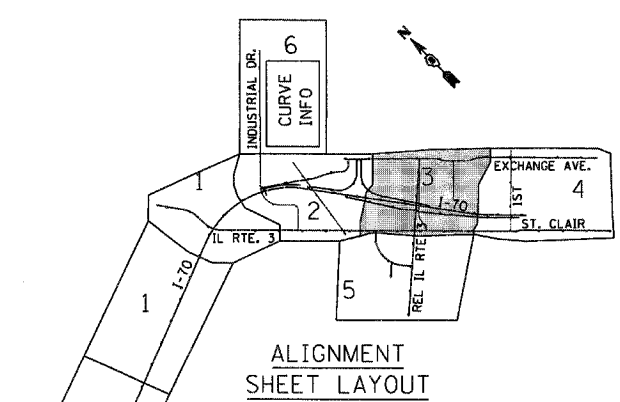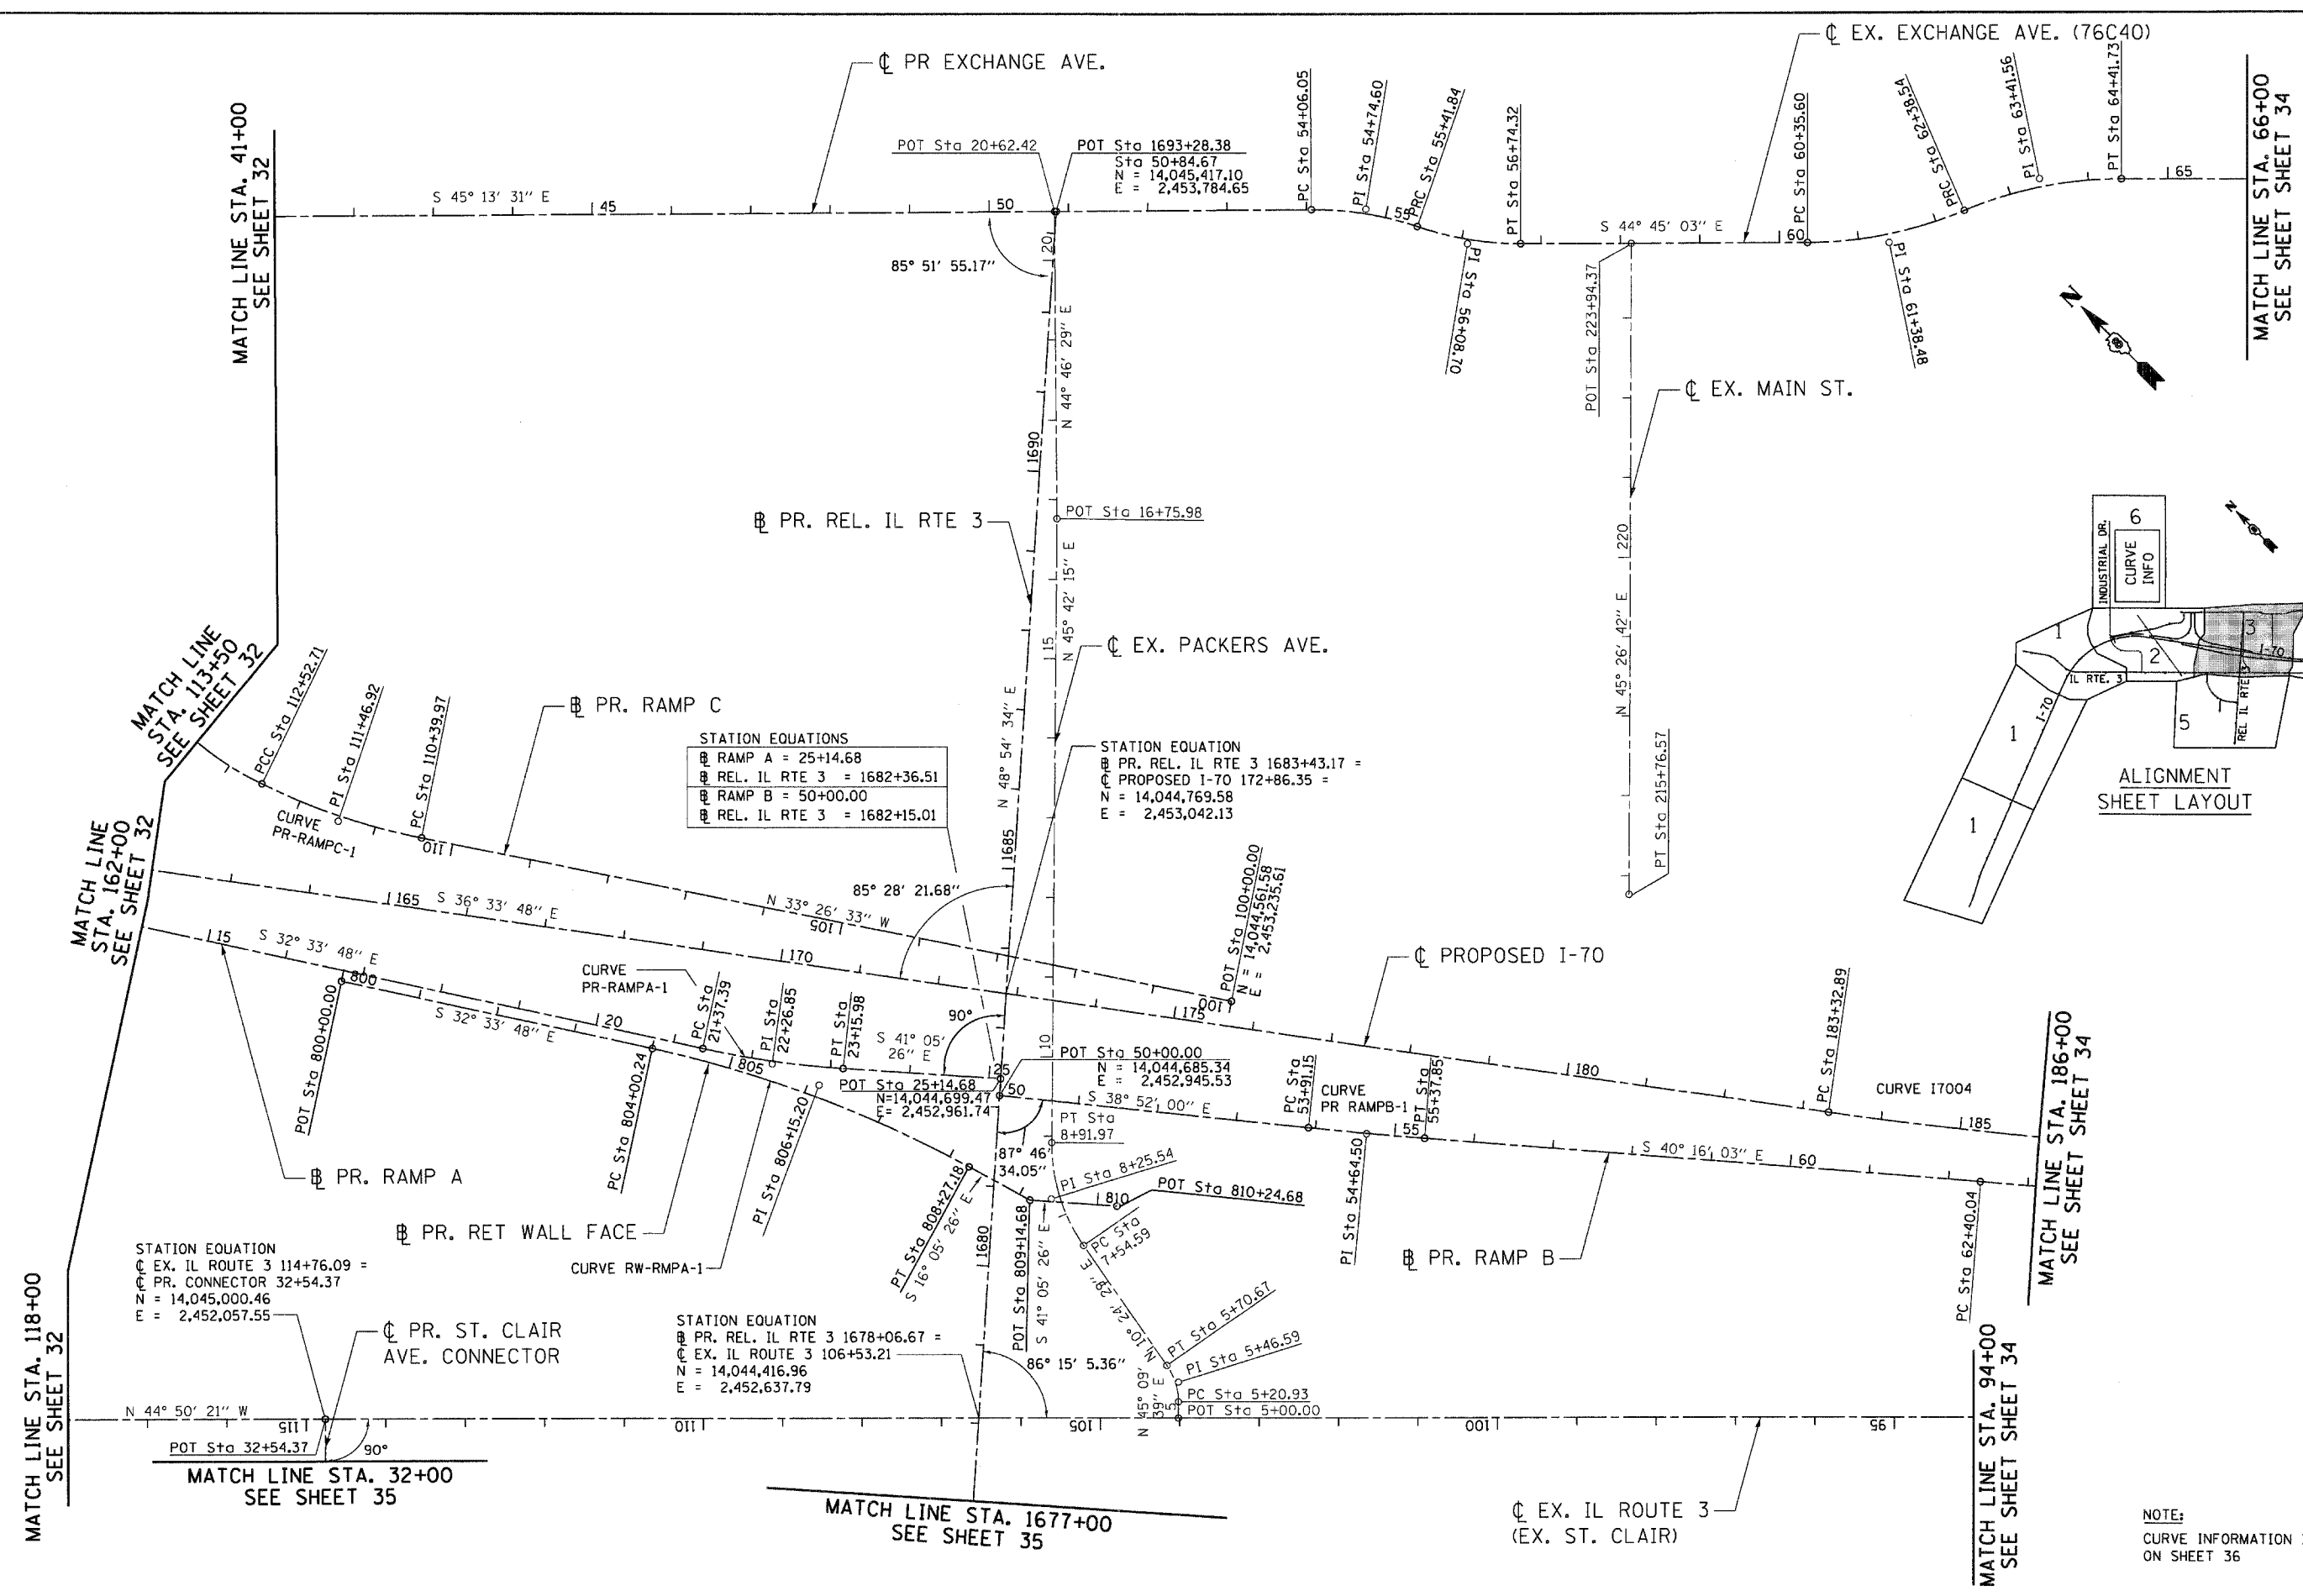MATCH LINE STA. 32+00
SEE SHEET 35

MATCH LINE STA. 1677+00
SEE SHEET 35

MATCH LINE STA. 94+00
SEE SHEET 34



MATCH LINE STA. 186+00
SEE SHEET 34

NOTE:
CURVE INFORMATION IS LISTED
ON SHEET 36

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		CHECKED - ACL	REVISED -			FED. ROAD DIST. NO. ILLINOIS FED. AID PROJECT						
		DATE - 10/21/11	REVISED -									



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MATCH LINE STA. 94+00
 SEE SHEET 33

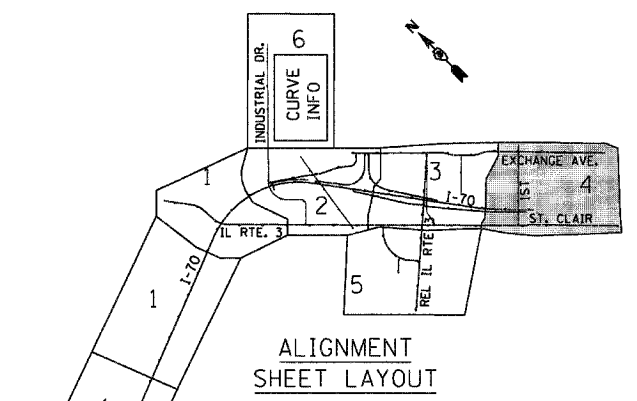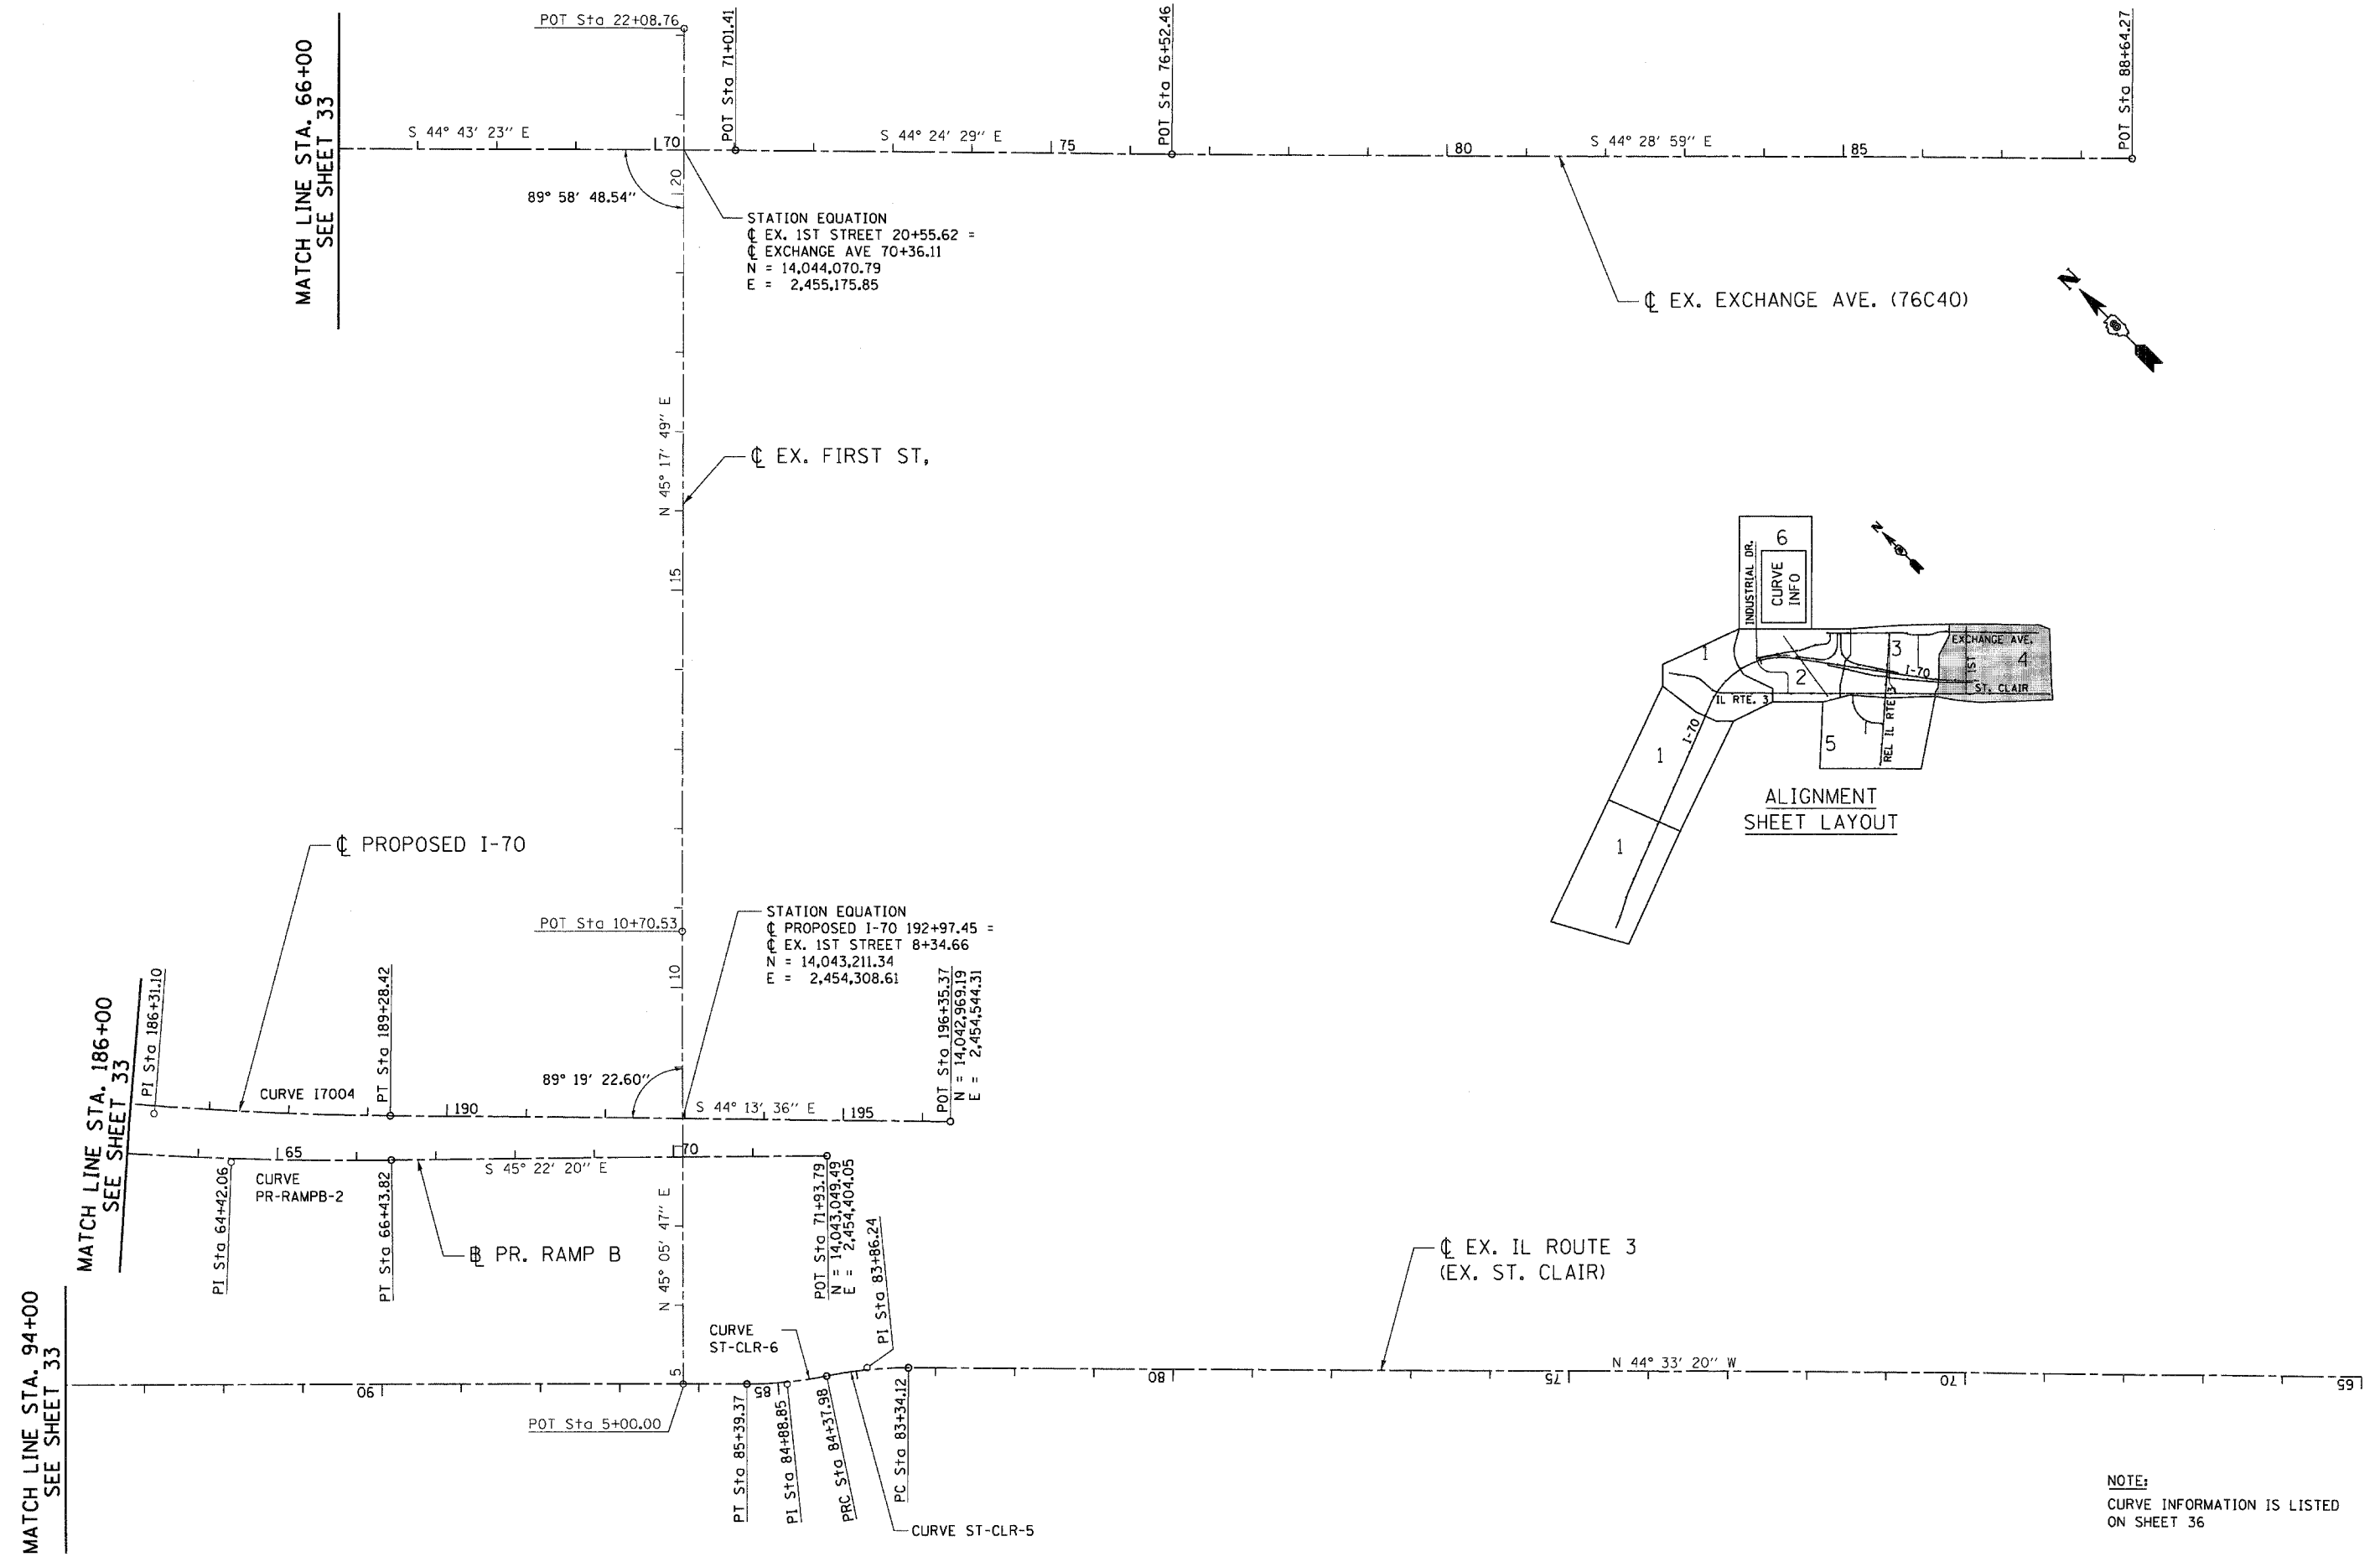MATCH LINE STA. 186+00
 SEE SHEET 33

MATCH LINE STA. 66+00
 SEE SHEET 33

NOTE:
 CURVE INFORMATION IS LISTED
 ON SHEET 36

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TENG	PLOT DATE = #DATE#	CHECKED - ACL	REVISED -						CONTRACT NO. 76E06			
		DATE - 10/21/11	REVISED -						ILLINOIS FED. AID PROJECT			

MATCH LINE STA. 32+00
SEE SHEET 33

MATCH LINE STA. 1677+00
SEE SHEET 33

PR. ST. CLAIR
AVE. CONNECTOR

PI Sta 27+15.38

POT Sta 900+00.00
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E = 2,451,583.82

POT Sta 902+80.27
N = 14,044,263.98
E = 2,451,821.67


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WT DRIVE

POT Sta 20+00.00
Sta. 1670+54.65
N = 14,043,922.70
E = 2,452,071.01

POT Sta 1660+00.00
N = 14,043,229.53
E = 2,451,276.15

NOTE:
CURVE INFORMATION IS LISTED
ON SHEET 36

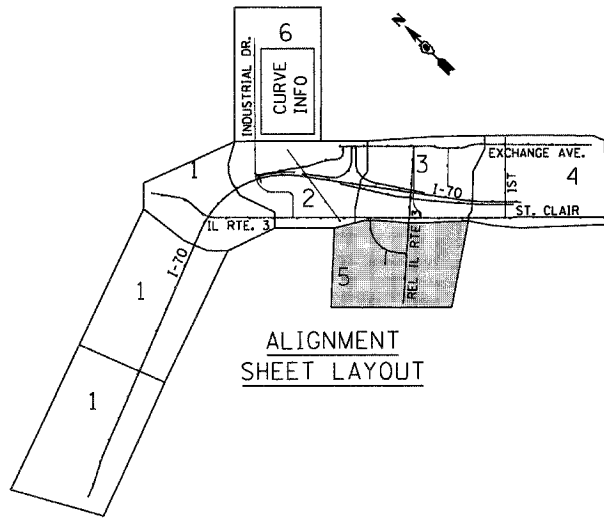

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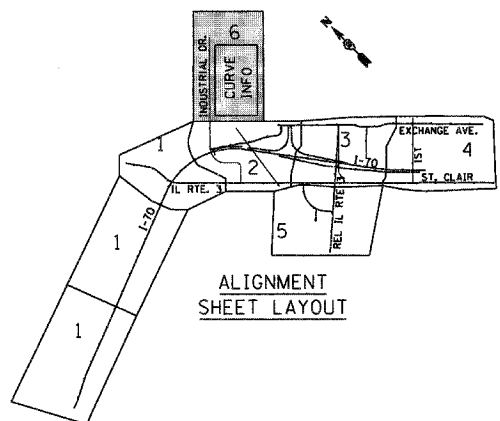
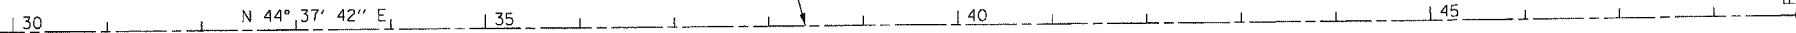
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#FILEL#		DRAWN - JB	REVISED -		998	02-2-1K	ST. CLAIR	353	35			
PLOT SCALE = #SCALE#		CHECKED - ACL	REVISED -		CONTRACT NO. 76E06							
PLOT DATE = #DATE#		DATE - 10/21/11	REVISED -		ILLINOIS FED. AID PROJECT							
				SCALE: 1"=100'		SHEET NO. 5 OF 8 SHEETS		STA. TO STA.				



TENGA & ASSOCIATES, INC.
ENGINEERS/ARCHITECTS/PLANNERS
CHICAGO, ILLINOIS


MATCH LINE STA. 27+00
SEE SHEET 32

EX. INDUSTRIAL DRIVE



PROPOSED I-70				RAMP A	RAMP B	RAMP C	RAMP D	RET WALL RAMP A		
PROP. CURVE I7001 PI STA. = 64+29.43 N = 14,045,143.80 E = 2,443,857.63 Δ = 7° 48' 56" (LT) D = 3° 01' 26" R = 1,894.74' T = 129.43' L = 258.46' E = 4.42' e = N/A T.R. = N/A S.E. RUN = N/A P.C. STA. = 63+00.00 N = 14,045,100.50 E = 2,443,735.66 P.T. STA. = 65+58.46 N = 14,045,203.30 E = 2,443,972.57	PROP. CURVE I7002-1 PI STA. = 71+40.36 N = 14,045,470.77 E = 2,444,489.36 Δ = 6° 07' 13" (RT) D = 3° 01' 38" R = 1,892.60' T = 101.18' L = 202.16' E = 2.70' e = N/A T.R. = N/A S.E. RUN = N/A P.C. STA. = 70+39.19 N = 14,045,424.27 E = 2,444,399.51 P.T. STA. = 72+41.35 N = 14,045,507.43 E = 2,444,583.66	PROP. CURVE I7003 PI STA. = 138+29.72 N = 14,047,894.72 E = 2,450,724.31 Δ = 74° 40' 52" (RT) D = 2° 56' 04" R = 1,952.60' T = 1,489.60' L = 2,544.95' E = 5.402' e = 5.402' T.R. = 107' S.E. RUN = 360' P.C. STA. = 123+40.13 N = 14,047,354.97 E = 2,449,335.94 P.T. STA. = 148+85.08 N = 14,046,698.27 E = 2,451,611.67	PROP. CURVE I7004 PI STA. = 186+31.10 N = 14,043,689.47 E = 2,453,843.21 Δ = 7° 39' 48" (LT) D = 1° 17' 13" R = 4,452.50' T = 298.21' L = 595.53' E = 503.34' e = 3.302' T.R. = 75' S.E. RUN = 180' P.C. STA. = 183+32.89 N = 14,043,929.00 E = 2,453,665.57 P.T. STA. = 189+28.42 N = 14,043,475.78 E = 2,454,051.21	PROP. CURVE PR_RAMP A-1 PI STA. = 22+26.85 N = 14,044,916.65 E = 2,452,772.34 Δ = 8° 31' 38" (LT) D = 4° 46' 29" R = 1,200.00' T = 89.46' L = 178.60' E = 9.98' e = R.C. T.R. = 83.33' S.E. RUN = 66.67' P.C. STA. = 21+37.39 N = 14,044,992.05 E = 2,452,724.19 P.T. STA. = 23+15.98 N = 14,044,849.22 E = 2,452,831.14	PROP. CURVE PR_RAMP B-1 PI STA. = 54+64.50 N = 14,044,323.67 E = 2,453,237.02 Δ = 1° 24' 03" (LT) D = 0° 57' 18" R = 6,000.00' T = 73.35' L = 146.70' E = 0.45' e = N.C. T.R. = N/A S.E. RUN = N/A P.C. STA = 53+91.15 N = 14,044,380.79 E = 2,453,190.99 P.T. STA = 55+37.85 N = 14,044,267.70 E = 2,453,284.43	PROP. CURVE PR_RAMP B-2 PI STA. = 64+42.06 N = 14,043,577.76 E = 2,453,868.87 Δ = 5° 06' 17" (LT) D = 1° 15' 51" R = 4,532.00' T = 202.02' L = 403.77' E = 6.82' e = 3.32' T.R. = 0' S.E. RUN = 126.43' P.C. STA = 62+40.04 N = 14,043,731.91 E = 2,453,738.30 P.T. STA = 66+43.82 N = 14,043,435.84 E = 2,454,012.65	PROP. CURVE PR_RAMP C-1 PI STA. = 111+46.92 N = 14,045,518.62 E = 2,452,603.55 Δ = 14° 35' 50" (RT) D = 6° 51' 42" R = 835.00' T = 106.95' L = 212.73' E = 6.02' e = 6.02' T.R. = 0' S.E. RUN = 150' P.C. STA = 110+39.97 N = 14,045,429.38 E = 2,452,662.48 P.T. STA = 112+52.71 N = 14,045,619.83 E = 2,452,569.00	PROP. CURVE PR_RAMP C-2 PI STA. = 115+07.02 N = 14,045,860.51 E = 2,452,486.86 Δ = 63° 37' 12" (RT) D = 13° 58' 28" R = 410.00' T = 254.31' L = 455.25' E = 72.47' e = 6.02' T.R. = 0' S.E. RUN = 100' P.C. STA = 112+52.71 N = 14,045,619.83 E = 2,452,569.00 P.T. STA = 117+07.96 N = 14,046,041.04 E = 2,452,665.97	PROP. CURVE PR_RAMP D-1 PI STA. = 257+14.62 N = 14,045,842.03 E = 2,452,341.74 Δ = 97° 30' 58" (RT) D = 15° 04' 40" R = 380.00' T = 433.43' L = 646.75' E = 196.42' e = 6.02' T.R. = 0' S.E. RUN = 150' P.C. STA = 252+81.19 N = 14,046,149.72 E = 2,452,647.02 P.T. STA = 259+27.94 N = 14,046,184.93 E = 2,452,076.63	PROP. CURVE RW_RAMP A-1 PI STA. = 806+15.20 N = 14,044,855.95 E = 2,452,794.99 Δ = 16° 28' 22" (RT) D = 3° 51' 30" R = 1,485.00' T = 214.95' L = 426.94' E = 15.48' e = N/A T.R. = N/A S.E. RUN = N/A P.C. STA = 804+00.24 N = 14,045,037.12 E = 2,452,679.30 P.T. STA = 808+27.18 N = 14,044,649.42 E = 2,452,854.57
PR. ST. CLAIR AVE. CONNECTOR		WT DRIVE		PACKERS AVE.		EXCHANGE AVE.		INDUSTRIAL DRIVE		
PROP. CURVE PR_CNECT-1 PI STA. = 27+75.38 N = 14,044,507.08 E = 2,451,561.39 Δ = 86° 15' 05" (RT) D = 9° 32' 57" R = 600.00' T = 561.98' L = 903.22' E = 222.08' e = 3.82' T.R. = 30' S.E. RUN = 75' P.C. STA = 22+13.40 N = 14,044,083.53 E = 2,451,930.75 P.T. STA = 31+16.63 N = 14,044,903.34 E = 2,451,959.88	PROP. CURVE PR_WTOR-1 PI STA. = 902+49.34 N = 14,044,242.97 E = 2,451,761.12 Δ = 23° 58' 54" (RT) D = 38° 11' 50" R = 150.00' T = 31.86' L = 62.78' E = 3.35' e = N/A T.R. = N/A S.E. RUN = N/A P.C. STA = 902+17.48 N = 14,044,220.57 E = 2,451,738.47 P.T. STA = 902+80.27 N = 14,044,254.23 E = 2,451,790.92	EXIST. CURVE EX_PACK-1 PI STA. = 5+46.59 N = 14,044,271.33 E = 2,452,848.31 Δ = 34° 45' 10" (LT) D = 69° 52' 22" R = 82.00' T = 25.66' L = 49.74' E = 3.92' e = NC T.R. = N/A S.E. RUN = N/A P.C. STA. = 5+20.93 N = 14,044,253.23 E = 2,452,830.12 P.T. STA. = 5+70.67 N = 14,044,296.57 E = 2,452,852.95	EXIST. CURVE EX_PACK-2 PI STA. = 8+25.54 N = 14,044,547.24 E = 2,452,898.99 Δ = 35° 17' 45" (RT) D = 25° 41' 35" R = 223.00' T = 70.95' L = 137.37' E = 11.01' e = NC T.R. = N/A S.E. RUN = N/A P.C. STA. = 7+54.59 N = 14,044,477.46 E = 2,452,886.18 P.T. STA. = 8+91.97 N = 14,044,596.78 E = 2,452,949.77	PROP. CURVE PR_EXCH-1 PI STA. = 54+74.60 N = 14,045,142.47 E = 2,454,061.46 Δ = 19° 27' 04" (RT) D = 14° 19' 26" R = 400.00' T = 68.56' L = 135.80' E = 5.83' e = NC T.R. = N/A S.E. RUN = N/A P.C. STA. = 54+06.05 N = 14,045,190.75 E = 2,454,012.79 P.T. STA. = 55+41.84 N = 14,045,080.73 E = 2,454,091.27	PROP. CURVE PR_EXCH-2 PI STA. = 56+08.70 N = 14,045,020.53 E = 2,454,120.34 Δ = 18° 58' 37" (LT) D = 14° 19' 26" R = 400.00' T = 66.85' L = 132.48' E = 5.55' e = NC T.R. = N/A S.E. RUN = N/A P.C. STA. = 55+41.84 N = 14,045,080.73 E = 2,454,091.27 P.T. STA. = 56+74.32 N = 14,044,973.05 E = 2,454,167.40	PROP. CURVE PR_EXCH-3 PI STA. = 61+38.48 N = 14,044,643.41 E = 2,454,494.18 Δ = 23° 15' 21" (LT) D = 11° 27' 33" R = 500.00' T = 102.89' L = 202.95' E = 10.48' e = NC T.R. = N/A S.E. RUN = N/A P.C. STA. = 60+35.60 N = 14,044,716.48 E = 2,454,421.75 P.T. STA. = 62+38.54 N = 14,044,604.88 E = 2,454,589.58	PROP. CURVE PR_EXCH-4 PI STA. = 63+41.56 N = 14,044,566.30 E = 2,454,685.10 Δ = 23° 17' 01" (RT) D = 11° 27' 33" R = 500.00' T = 103.02' L = 203.91' E = 10.50' e = NC T.R. = N/A S.E. RUN = N/A P.C. STA. = 62+38.54 N = 14,044,604.88 E = 2,454,589.58 P.T. STA. = 64+41.73 N = 14,044,493.11 E = 2,454,757.59	EXIST. CURVE INDRD01 PI STA. = 10+36.83 N = 14,046,541.81 E = 2,451,281.88 Δ = 89° 43' 20" (LT) D = 54° 34' 03" R = 105.00' T = 104.49' L = 164.42' E = 43.13' e = NC T.R. = N/A S.E. RUN = N/A P.C. STA. = 9+32.33 N = 14,046,467.57 E = 2,451,208.35 P.T. STA. = 10+96.76 N = 14,046,615.70 E = 2,451,208.00	EXIST. CURVE INDRD02 PI STA. = 17+68.75 N = 14,047,090.90 E = 2,450,732.86 Δ = 87° 47' 02" (RT) D = 15° 03' 19" R = 380.57' T = 366.13' L = 583.08' E = 147.52' e = NC T.R. = N/A S.E. RUN = N/A P.C. STA. = 14+02.62 N = 14,046,831.99 E = 2,450,991.73 P.T. STA. = 19+85.70 N = 14,047,359.59 E = 2,450,981.56	
EX. IL RTE 3 (ST. CLAIR AVE.)				DARLING ACCESS ROAD				DARLING RET WALL		
PROP. CURVE ST_CLR-5 PI STA. = 83+86.24 N = 14,042,825.09 E = 2,454,249.99 Δ = 11° 54' 06" (LT) D = 11° 27' 33" R = 500.00' T = 52.12' L = 103.86' E = 2.71' e = NC T.R. = N/A S.E. RUN = N/A P.C. STA. = 83+34.12 N = 14,042,787.95 E = 2,454,286.56 P.T. STA. = 84+37.98 N = 14,042,853.89 E = 2,454,206.55	PROP. CURVE ST_CLR-6 PI STA. = 84+88.85 N = 14,042,881.99 E = 2,454,164.16 Δ = 11° 37' 06" (RT) D = 11° 27' 33" R = 500.00' T = 50.87' L = 101.39' E = 2.58' e = NC T.R. = N/A S.E. RUN = N/A P.C. STA. = 84+37.98 N = 14,042,853.89 E = 2,454,206.55 P.T. STA. = 85+39.37 N = 14,042,918.06 E = 2,454,128.29	PROP. CURVE ST_CLR-7 PI STA. = 149+38.21 N = 14,047,455.42 E = 2,449,616.35 Δ = 41° 34' 53" (RT) D = 12° 19' 18" R = 465.00' T = 176.55' L = 337.46' E = 32.39' e = N/A T.R. = N/A S.E. RUN = N/A P.C. STA. = 147+61.66 N = 14,047,330.23 E = 2,449,740.84 P.T. STA. = 150+99.13 N = 14,047,631.69 E = 2,449,606.32	PROP. CURVE ST_CLR-8 PI STA. = 155+22.88 N = 14,048,054.76 E = 2,449,582.24 Δ = 32° 24' 12" (LT) D = 11° 27' 33" R = 500.00' T = 145.28' L = 282.77' E = 20.68' e = N/A T.R. = N/A S.E. RUN = N/A P.C. STA. = 153+77.60 N = 14,047,909.71 E = 2,449,590.49 P.T. STA. = 156+60.38 N = 14,048,172.79 E = 2,449,497.54	PROP. CURVE PR_DRLG-1 PI STA. = 1002+02.53 N = 14,047,245.24 E = 2,451,142.76 Δ = 11° 06' 01" (RT) D = 2° 44' 57" R = 2,084.17' T = 202.53' L = 403.78' E = 9.82' e = N.C. T.R. = N/A S.E. RUN = N/A P.C. STA = 1000+00.00 N = 14,047,336.94 E = 2,450,962.18 P.T. STA = 1004+03.78 N = 14,047,120.49 E = 2,451,302.30	PROP. CURVE PR_DRLG-2 PI STA. = 1004+57.84 N = 14,047,087.19 E = 2,451,344.89 Δ = 6° 11' 18" (LT) D = 3° 49' 11" R = 1,000.00' T = 54.06' L = 108.01' E = 1.46' e = N.C. T.R. = N/A S.E. RUN = N/A P.C. STA = 1004+03.78 N = 14,047,120.49 E = 2,451,512.91 P.T. STA = 1005+11.79 N = 14,047,058.68 E = 2,451,390.81	PROP. CURVE PR_DRLG-3 PI STA. = 1007+65.46 N = 14,046,924.88 E = 2,451,606.32 Δ = 8° 23' 05" (RT) D = 3° 49' 11" R = 1,500.00' T = 109.95' L = 219.51' E = 4.02' e = N.C. T.R. = N/A S.E. RUN = N/A P.C. STA = 1006+55.51 N = 14,046,982.88 E = 2,451,512.91 P.T. STA = 1008+75.02 N = 14,046,853.88 E = 2,451,690.28	PROP. CURVE PR_DRLG-4 PI STA. = 1010+69.65 N = 14,046,728.21 E = 2,451,838.90 Δ = 14° 47' 10" (LT) D = 3° 49' 11" R = 1,500.00' T = 194.63' L = 387.10' E = 12.57' e = N/A T.R. = N/A S.E. RUN = N/A P.C. STA = 1008+75.02 N = 14,046,601.52 E = 2,451,690.28 P.T. STA = 1012+62.12 N = 14,046,644.63 E = 2,452,014.67	PROP. CURVE PR_DRLG-5 PI STA. = 1015+35.35 N = 14,046,527.29 E = 2,452,261.42 Δ = 15° 44' 44" (RT) D = 3° 35' 01" R = 1,250.00' T = 172.85' L = 343.51' E = 11.89' e = N.C. T.R. = N/A S.E. RUN = N/A P.C. STA = 1013+62.50 N = 14,046,379.17 E = 2,452,105.32 P.T. STA = 1017+06.01 N = 14,046,413.49 E = 2,452,391.52	PROP. CURVE PR_DRLG-6 PI STA. = 1018+99.00 N = 14,046,286.43 E = 2,452,536.77 Δ = 86° 24' 10" (LT) D = 2° 46' 14" R = 150.00' T = 140.87' L = 226.20' E = 55.77' e = N.C. T.R. = 32' S.E. RUN = 19' P.C. STA = 1017+58.14 N = 14,046,379.17 E = 2,452,430.75 P.T. STA = 1019+84.34 N = 14,046,386.43 E = 2,452,635.99	PROP. CURVE RW_DRLG-1 PI STA. = 444+33.90 N = 14,047,100.74 E = 2,451,359.12 Δ = 21° 08' 30" (RT) D = 2° 46' 14" R = 2,068.00' T = 385.92' L = 763.07' E = 35.70' e = N/A T.R. = N/A S.E. RUN = N/A P.C. STA = 440+47.97 N = 14,047,287.85 E = 2,451,021.59 P.T. STA = 448+11.04 N = 14,046,804.48 E = 2,451,606.45

\D:\CONNS\99-MOTIF.LDN, \D:\CONNS\11-BRIDGE.LDN, \D:\CONNS\11-ALIGNMENT\2.DGN, \D:\CONNS\10-MOTIF.LDN, \D:\CONNS\06-MOTIF.LDN, \D:\CONNS\05-MOTIF.LDN, \D:\CONNS\11-ALIGNMENTS.DGN, \D:\CONNS\11-MOTIF.LDN, \D:\CONNS\11-ALIGN.DGN
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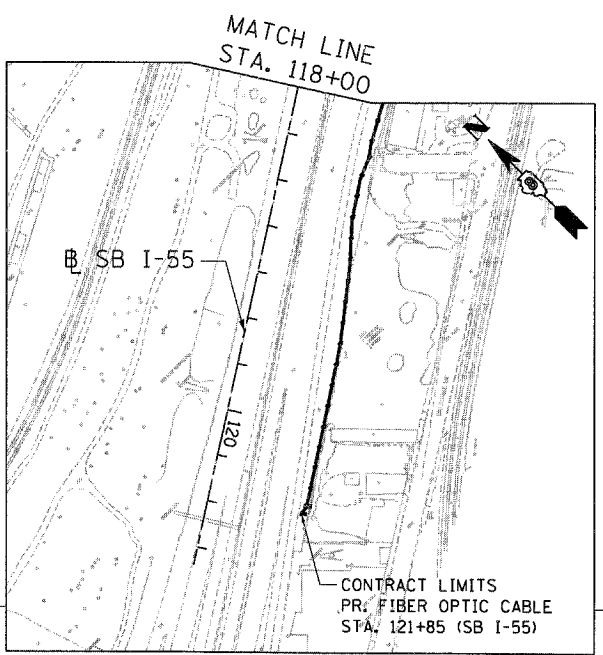


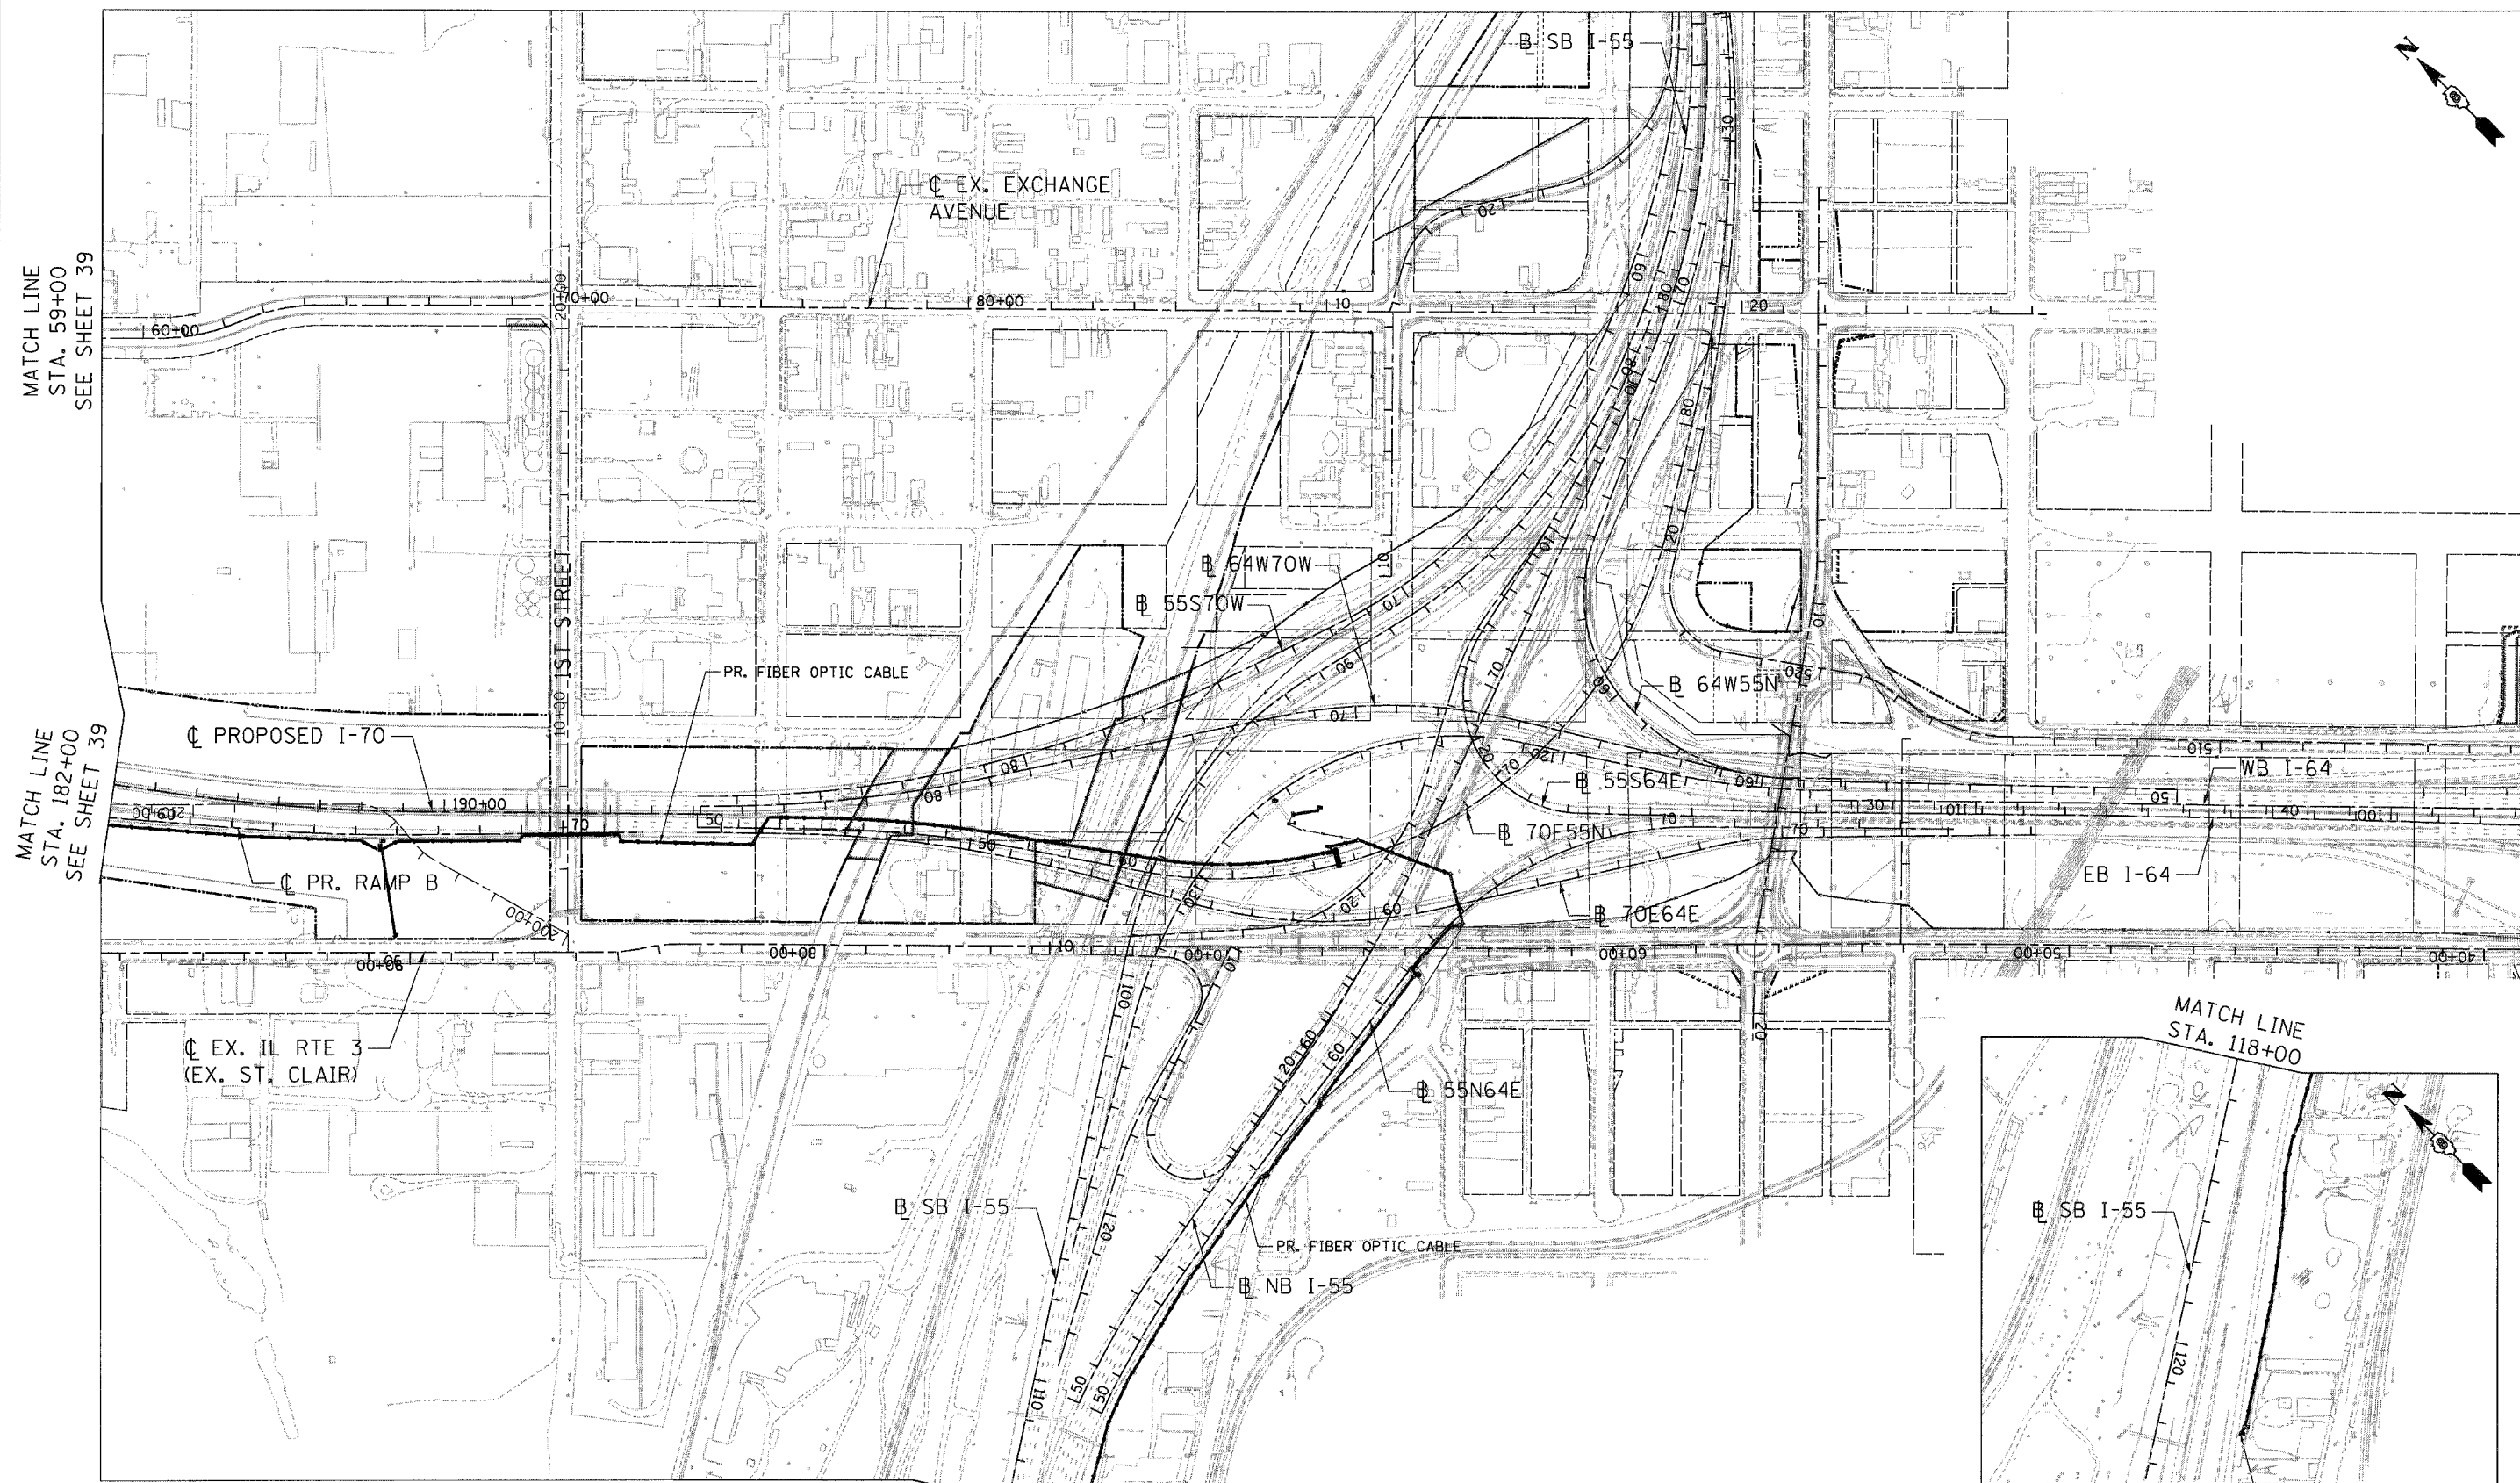MATCH LINE
STA. 59+00
SEE SHEET 39

MATCH LINE
STA. 182+00
SEE SHEET 39









CONTRACT LIMITS & WORK AREA

MATCH LINE
STA. 118+00
SEE RIGHT DETAIL



FILE NAME = #FILE#		USER NAME = #USER#		DESIGNED - JB	REVISED -	STATE OF ILLINOIS DEPARTMENT OF TRANSPORTATION PROPOSED RELOCATED IL ROUTE 3 INTERCHANGE				CONSTRUCTION LIMITS 2				F.A.P. RTE.	SECTION	COUNTY	TOTAL SHEETS	SHEET NO.	
		PLOT SCALE = #SCALE#		DRAWN - JB	REVISED -									998	82-2-1K	ST. CLAIR	353	40	
PLOT DATE = #DATE#		CHECKED - ACL		DATE - 10/21/11	REVISED -									SCALE: 1"=200' SHEET NO. 2 OF 2 SHEETS STA. TO STA.				CONTRACT NO. 76E06	
														FED. ROAD DIST. NO. ILLINOIS FED. AID PROJECT					

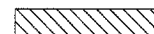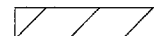LEGEND

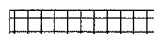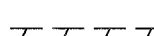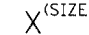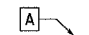-  PAVEMENT REMOVAL - (ASPHALT)
-  CONCRETE REMOVAL (SPECIAL) PAVEMENT REMOVAL - CONCRETE
-  TREE REMOVAL, ACRES
-  HOT-MIX ASPHALT SURFACE REMOVAL, 2"
-  DRIVEWAY PAVEMENT REMOVAL
-  LINEAR REMOVALS
-  TREE REMOVAL (SIZE")
-  TREE REMOVAL, ACRES DELINEATION POINTS

STA. 126+00

CONTRACT LIMITS
STA. 125+36.55

EX. IL RTE 3
(EX. ST. CLAIR)

CAHOKIA
CANAL
CULVERT

EXISTING MCT BUS STOP. CONTRACTOR SHALL CONTACT MARK STEYER AT MADISON COUNTY TRANSIT (MCT) 618.874.7433 TWO WEEKS PRIOR TO SIDEWALK REMOVAL.

PAVEMENT REMOVAL INCLUDED IN PATCHING QUANTITY SEE SHEET 60.

SIDEWALK REMOVAL 2,682 SQ FT.

RESURFACING LIMITS
STA. 119+42.50

NOTE:
AGGREGATE SHOULDER REMOVAL WITHIN THE LIMITS OF REGRADEING INCLUDED IN THE COST OF EARTH EXCAVATION.


MATCH LINE "A"
SEE SHEET 41

MATCH LINE STA. 117+00
SEE SHEET 46

\ORCONN-99-MOTIF.LDGN, \ORCONN-11-BURFER.LDGN, \ORCONN-11-LEGEND.LDGN, \ORCONN-11-1-0YUTL.DGN, \ORCONN-95-MOTIF.LDGN, \ORCONN-96-MOTIF.LDGN, \ORCONN-98-MOTIF.LDGN, \ORCONN-11-CIVIL.CAD\99 ALL CONTRACTS\CONNSHEETS CONTRACT 11\ORCONN-11-SHT-REMOVAL1-11700.LDGN
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FILE NAME = #FILEL#	USER NAME = #USER#	DESIGNED - JB	REVISED -	STATE OF ILLINOIS DEPARTMENT OF TRANSPORTATION PROPOSED RELOCATED IL ROUTE 3 INTERCHANGE	EXISTING ST. CLAIR AVENUE EXISTING PLAN & REMOVALS STA. 117+00 TO 126+00	F.A.P. RTE. 998	SECTION 82-2-1K	COUNTY ST. CLAIR	TOTAL SHEETS 353	SHEET NO. 45	
PLOT SCALE = #SCALE#		DRAWN - JB	REVISED -		SCALE: 1"=50'	SHEET NO. 5 OF 7 SHEETS	STA.	TO STA.	CONTRACT NO. 76E06		
PLOT DATE = #DATE#		CHECKED - ACL	REVISED -				ILLINOIS FED. AID PROJECT				
		DATE - 10/21/11	REVISED -								



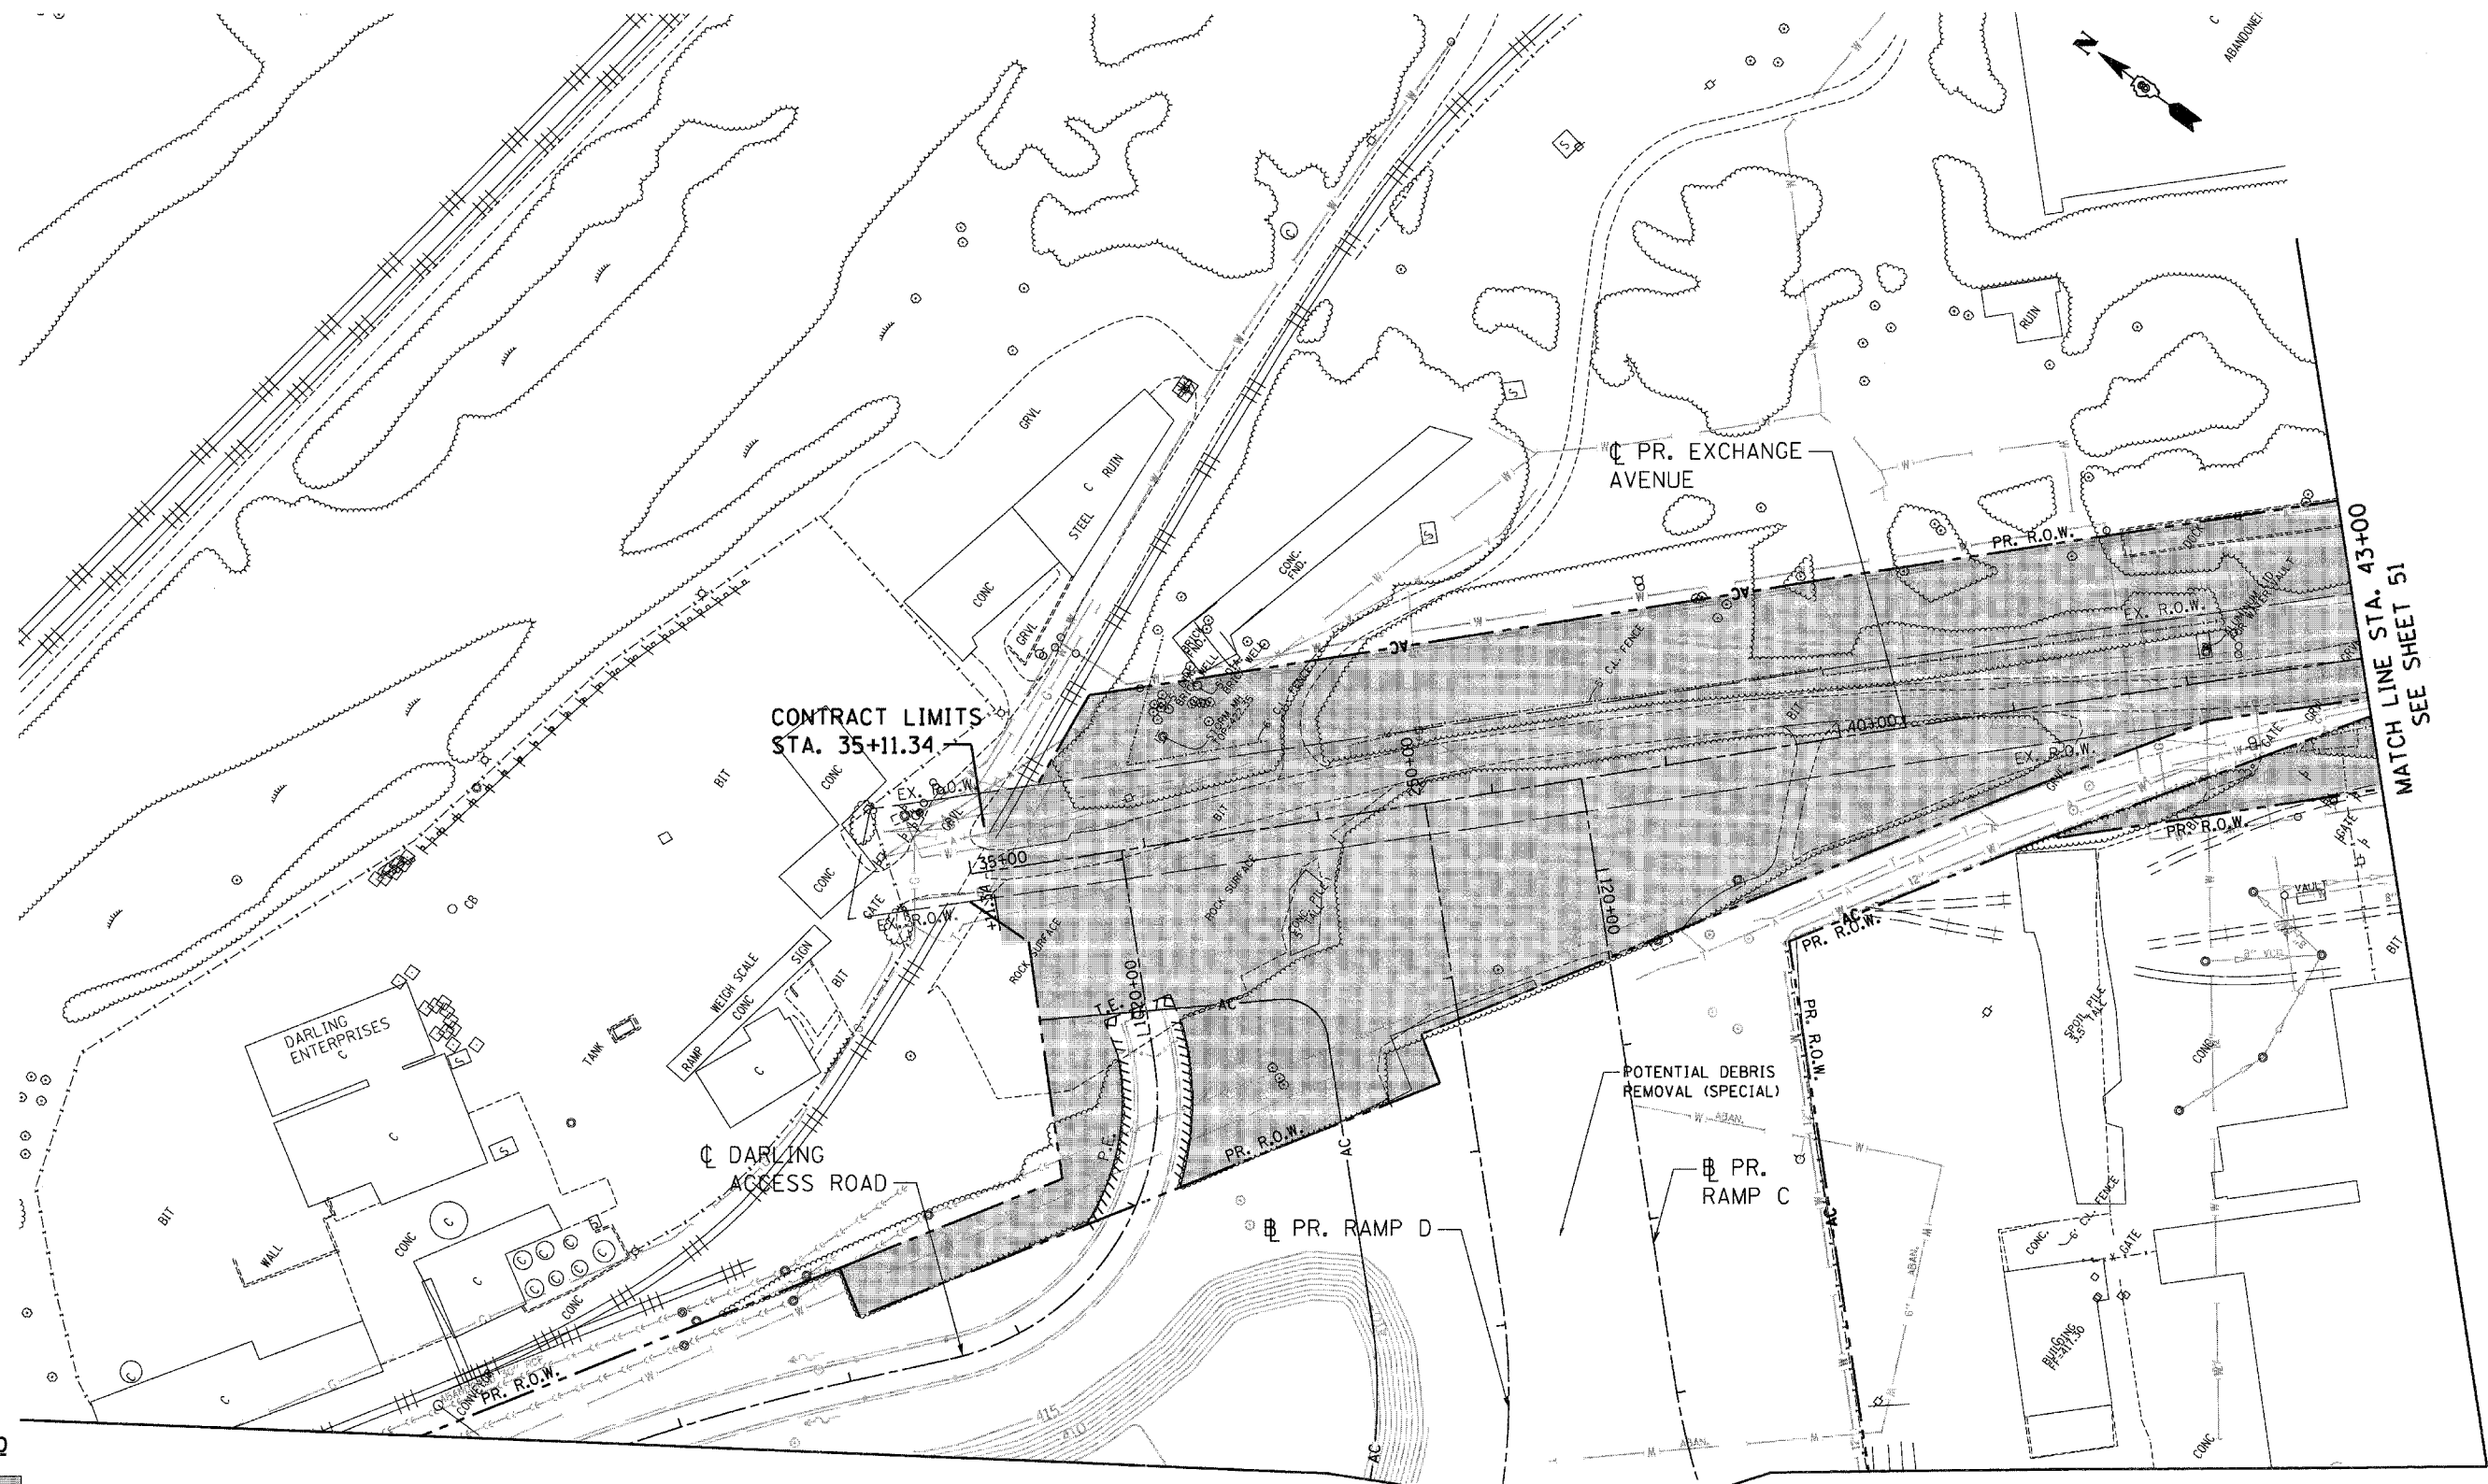


MATCH LINE STA. 43+00
SEE SHEET 51

MATCH LINE STA. 254+00
SEE SHEET 48A

LEGEND



CLEARING, SPECIAL





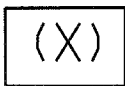


NON-SPECIAL WASTE DISPOSAL
LIMITS. SEE SPECIAL PROVISIONS
FOR CONTAMINANTS OF CONCERN.

\BDCONN-99-MOTIF.LDN, \BDCONN-11-MOTIF.LDN, \BDCONN-11-LEVER.LDN, \BDCONN-11-AYOUT.LDN, \BDCONN-85-MOTIF.LDN, \BDCONN-86-MOTIF.LDN, \BDCONN-88-MOTIF.LDN
 \BDCONN-11-BORDER.LDN, \BDCONN-11-TRANS.87-2222-22888-881.CIVIL, \BDCONN-11-CONTRACTS\CONNSHEET15.CONTRACT, \BDCONN-11-SHT-482\481-582.LDN
 \S-8844\481\482.LDN

FILE NAME =	USER NAME = #USER#	DESIGNED - JB	REVISED -	STATE OF ILLINOIS DEPARTMENT OF TRANSPORTATION PROPOSED RELOCATED IL ROUTE 3 INTERCHANGE	PROPOSED EXCHANGE AVENUE CLEARING PLAN STA. 35+00 TO STA. 43+00		F.A.P. RTE. 998	SECTION 82-2-1K	COUNTY ST. CLAIR	TOTAL SHEETS 353	SHEET NO. 50
#FILE#		DRAWN - MDN	REVISED -		SCALE: 1"=50'	SHEET NO. 3 OF 7 SHEETS	STA. TO STA.	FED. ROAD DIST. NO.	ILLINOIS FED. AID PROJECT	CONTRACT NO. 76E06	
PLOT SCALE = #SCALE#		CHECKED - ACL	REVISED -								
PLOT DATE = #DATE#		DATE - 10/21/11	REVISED -								



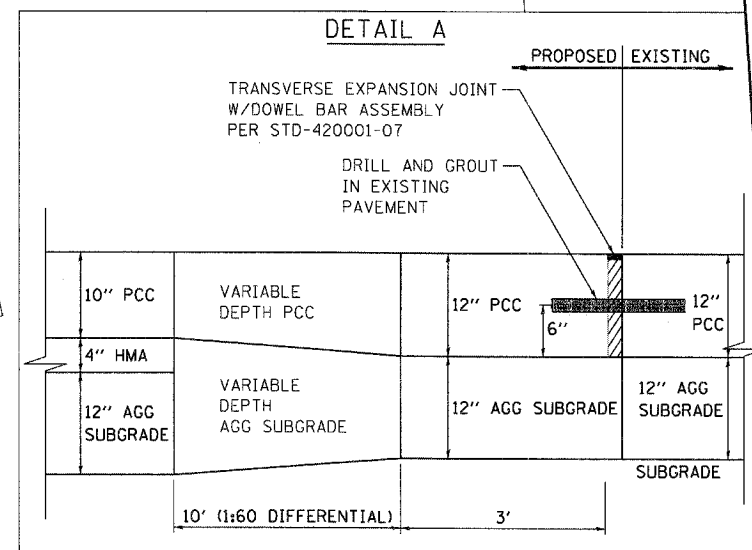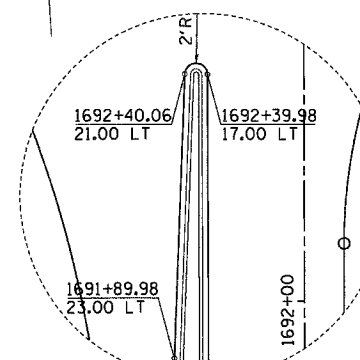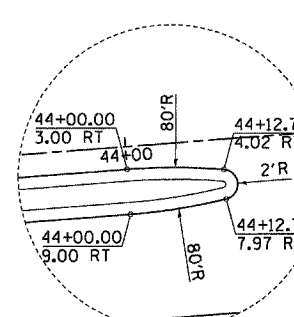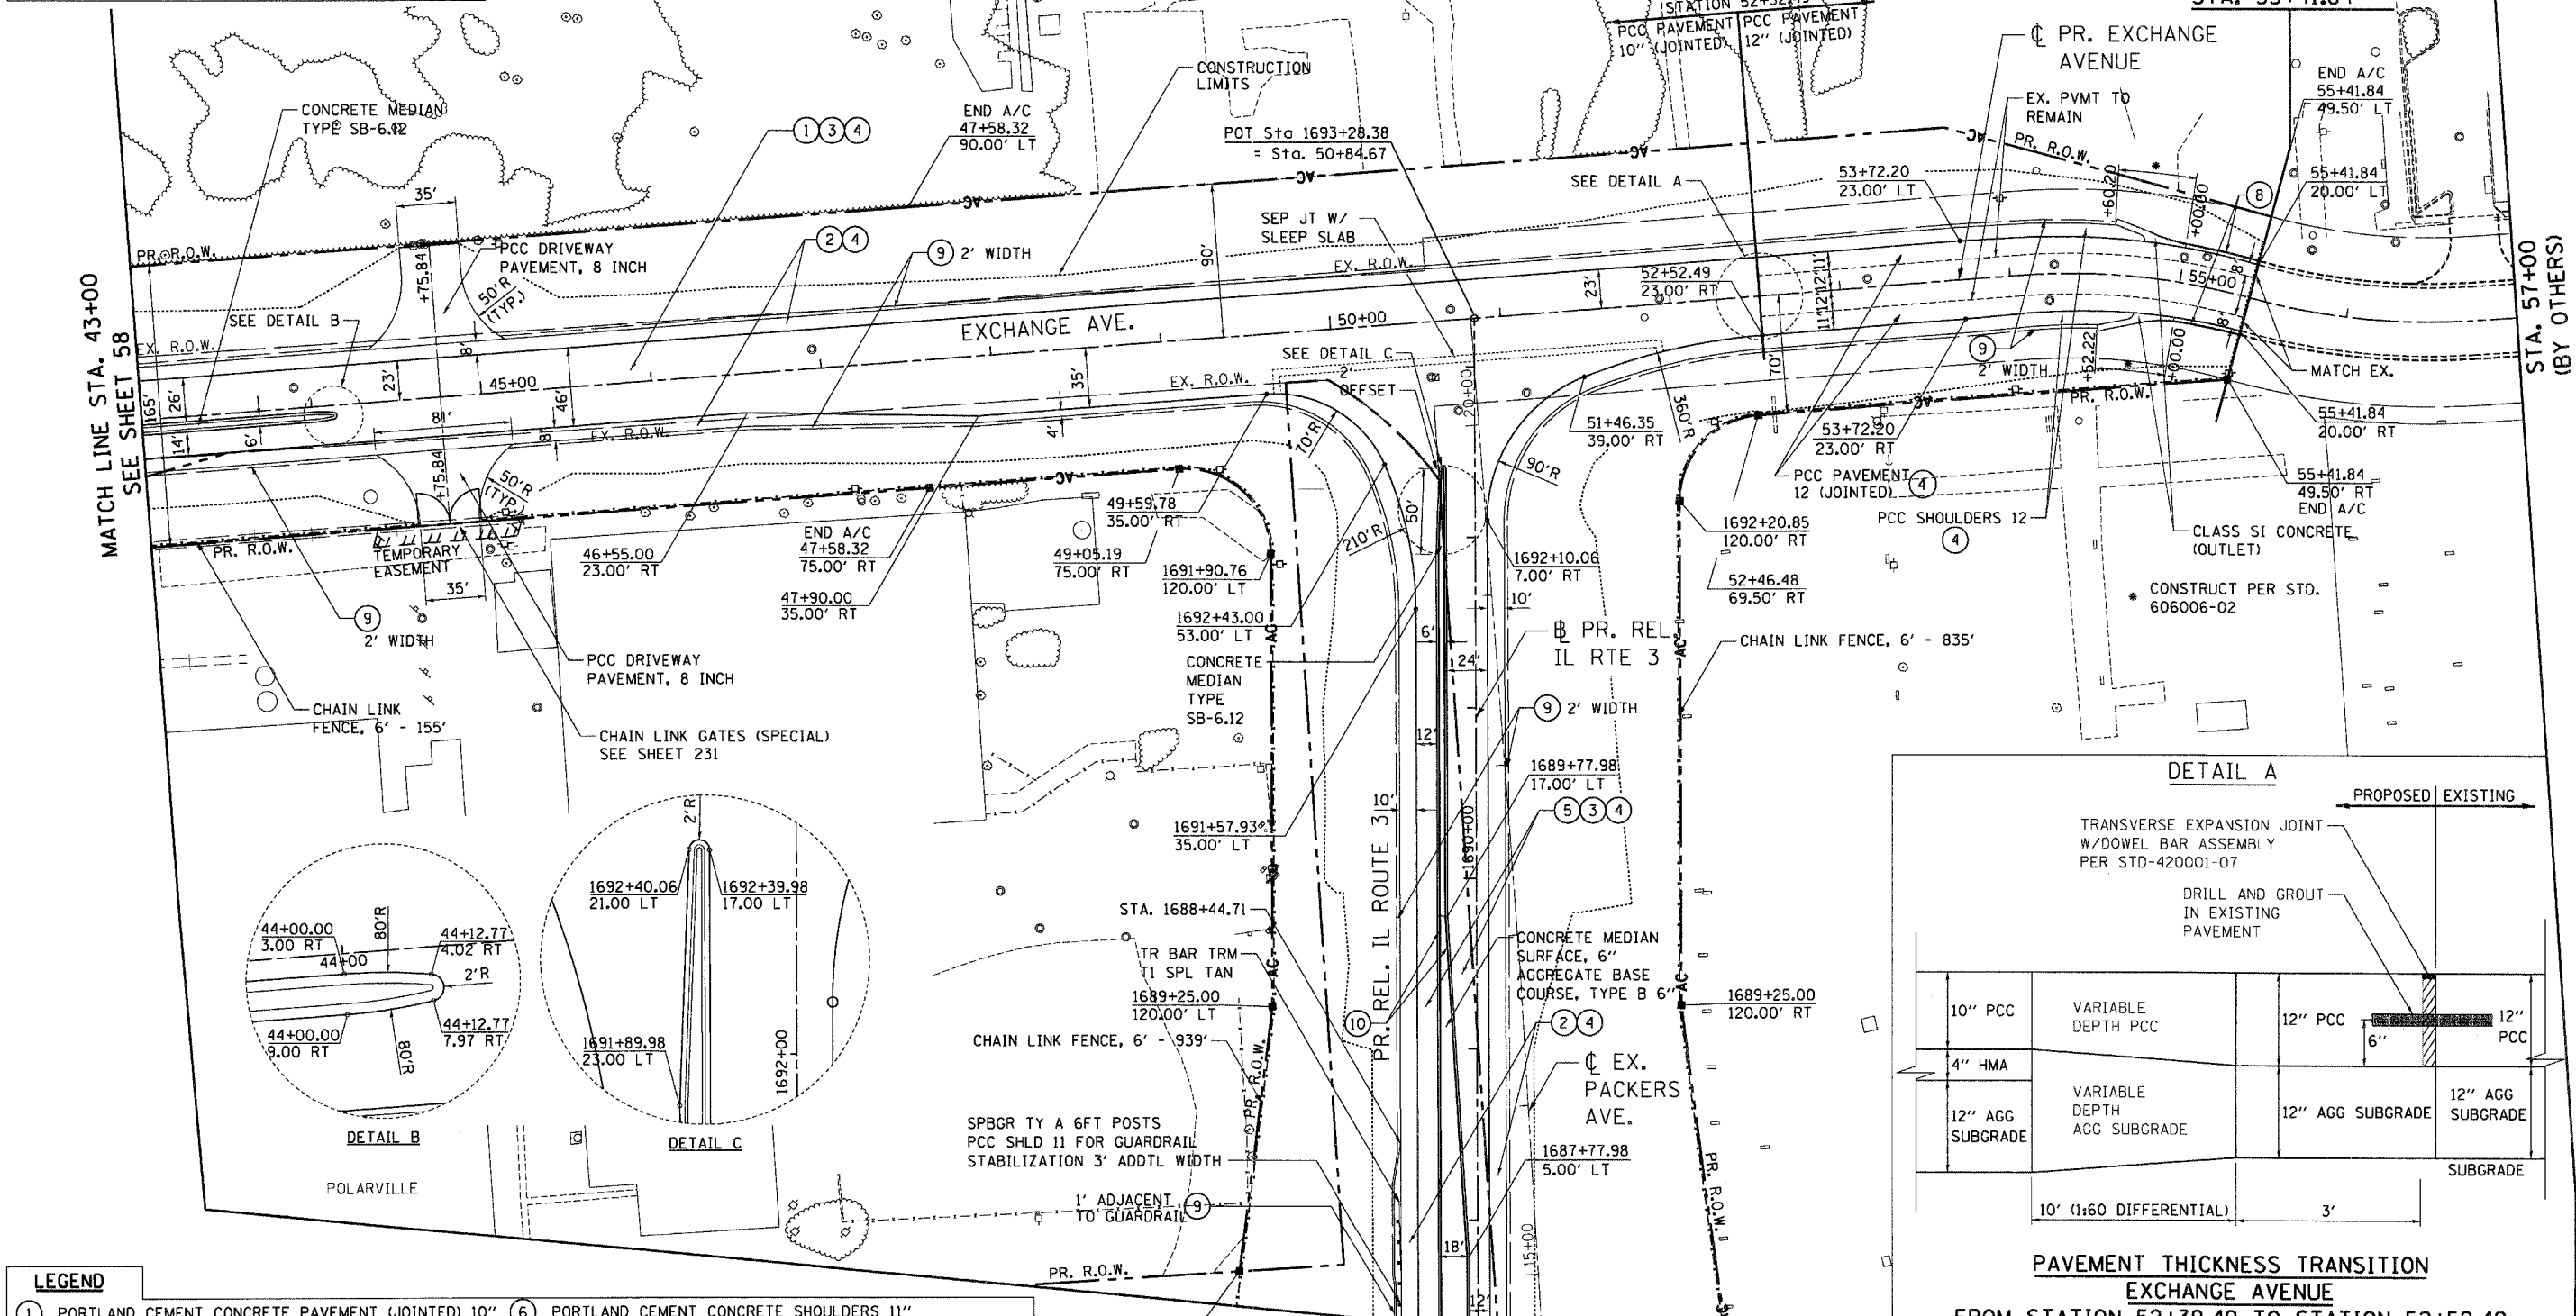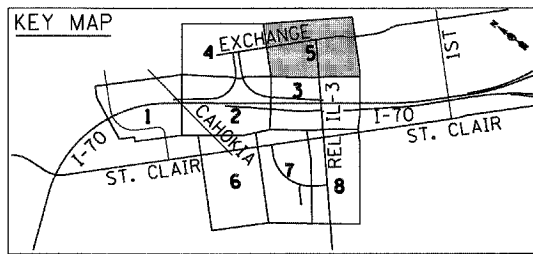

- LEGEND**
- ① PORTLAND CEMENT CONCRETE PAVEMENT (JOINTED) 10"
 - ② PORTLAND CEMENT CONCRETE SHOULDERS 10"
 - ③ STABILIZED SUBBASE - HOT-MIX ASPHALT, 4"
 - ④ AGGREGATE SUBGRADE 12"
 - ⑤ PORTLAND CEMENT CONCRETE PAVEMENT (JOINTED) 11"
 - ⑥ PORTLAND CEMENT CONCRETE SHOULDERS 11"
 - ⑦ HOT-MIX ASPHALT SHOULDERS, 8"
 - ⑧ COMBINATION CONCRETE CURB AND GUTTER, TYPE B-6.24
 - ⑨ AGGREGATE SHOULDERS, TYPE B 6"
 - ⑩ COMBINATION CONCRETE CURB AND GUTTER, TYPE B-6.12

NOTE:
ALL UTILITIES ARE SHOWN ON THE EXISTING & PROPOSED DRAINAGE & UTILITIES PLAN SHEETS.

NOTE:
ALL MATERIALS AND WORK ASSOCIATED WITH THE CONSTRUCTION OF THE PAVEMENT TRANSITION AND TRANSVERSE EXPANSION JOINT SHALL BE INCLUDED IN THE COST OF THE PROPOSED P.C.C. PAVEMENT 10" (JOINTED) AND AGGREGATE SUBGRADE 12"

MATCH LINE STA. 1687+40
SEE SHEET 57

CONTRACT LIMITS
STA. 55+41.84

STA. 57+00
(BY OTHERS)

STATE OF ILLINOIS
DEPARTMENT OF TRANSPORTATION
PROPOSED RELOCATED IL ROUTE 3 INTERCHANGE

PROPOSED EXCHANGE AVENUE
ROADWAY PLAN
STA. 43+00 TO STA. 57+00


F.A.P. RTE.	SECTION	COUNTY	TOTAL SHEETS	SHEET NO.
998	82-2-1K	ST. CLAIR	353	59
FED. ROAD DIST. NO.		ILLINOIS FED. AID PROJECT		

SCALE: 1"=50'
SHEET NO. 5 OF 8 SHEETS
STA. TO STA.


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#FILEL#

TENG TENG & ASSOCIATES, INC.
ENGINEERS/ARCHITECTS/PLANNERS
CHICAGO, ILLINOIS

USER NAME = #USER#	DESIGNED - JB	REVISED -
PLOT SCALE = #SCALE#	DRAWN - JB	REVISED -
PLOT DATE = #DATE#	CHECKED - ACL	REVISED -
	DATE - 10/21/11	REVISED -

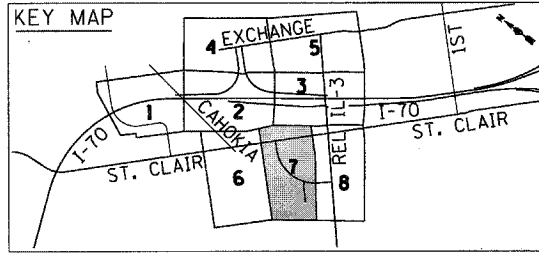

LEGEND	
①	PORTLAND CEMENT CONCRETE PAVEMENT (JOINTED) 10"
②	PORTLAND CEMENT CONCRETE SHOULDERS 10"
③	STABILIZED SUBBASE - HOT-MIX ASPHALT, 4"
④	AGGREGATE SUBGRADE 12"
⑤	PORTLAND CEMENT CONCRETE PAVEMENT (JOINTED) 11"
⑥	PORTLAND CEMENT CONCRETE SHOULDERS 11"
⑦	HOT-MIX ASPHALT SHOULDERS, 8"
⑧	COMBINATION CONCRETE CURB AND GUTTER, TYPE B-6.24
⑨	AGGREGATE SHOULDERS, TYPE B 6"
⑩	COMBINATION CONCRETE CURB AND GUTTER, TYPE B-6.12

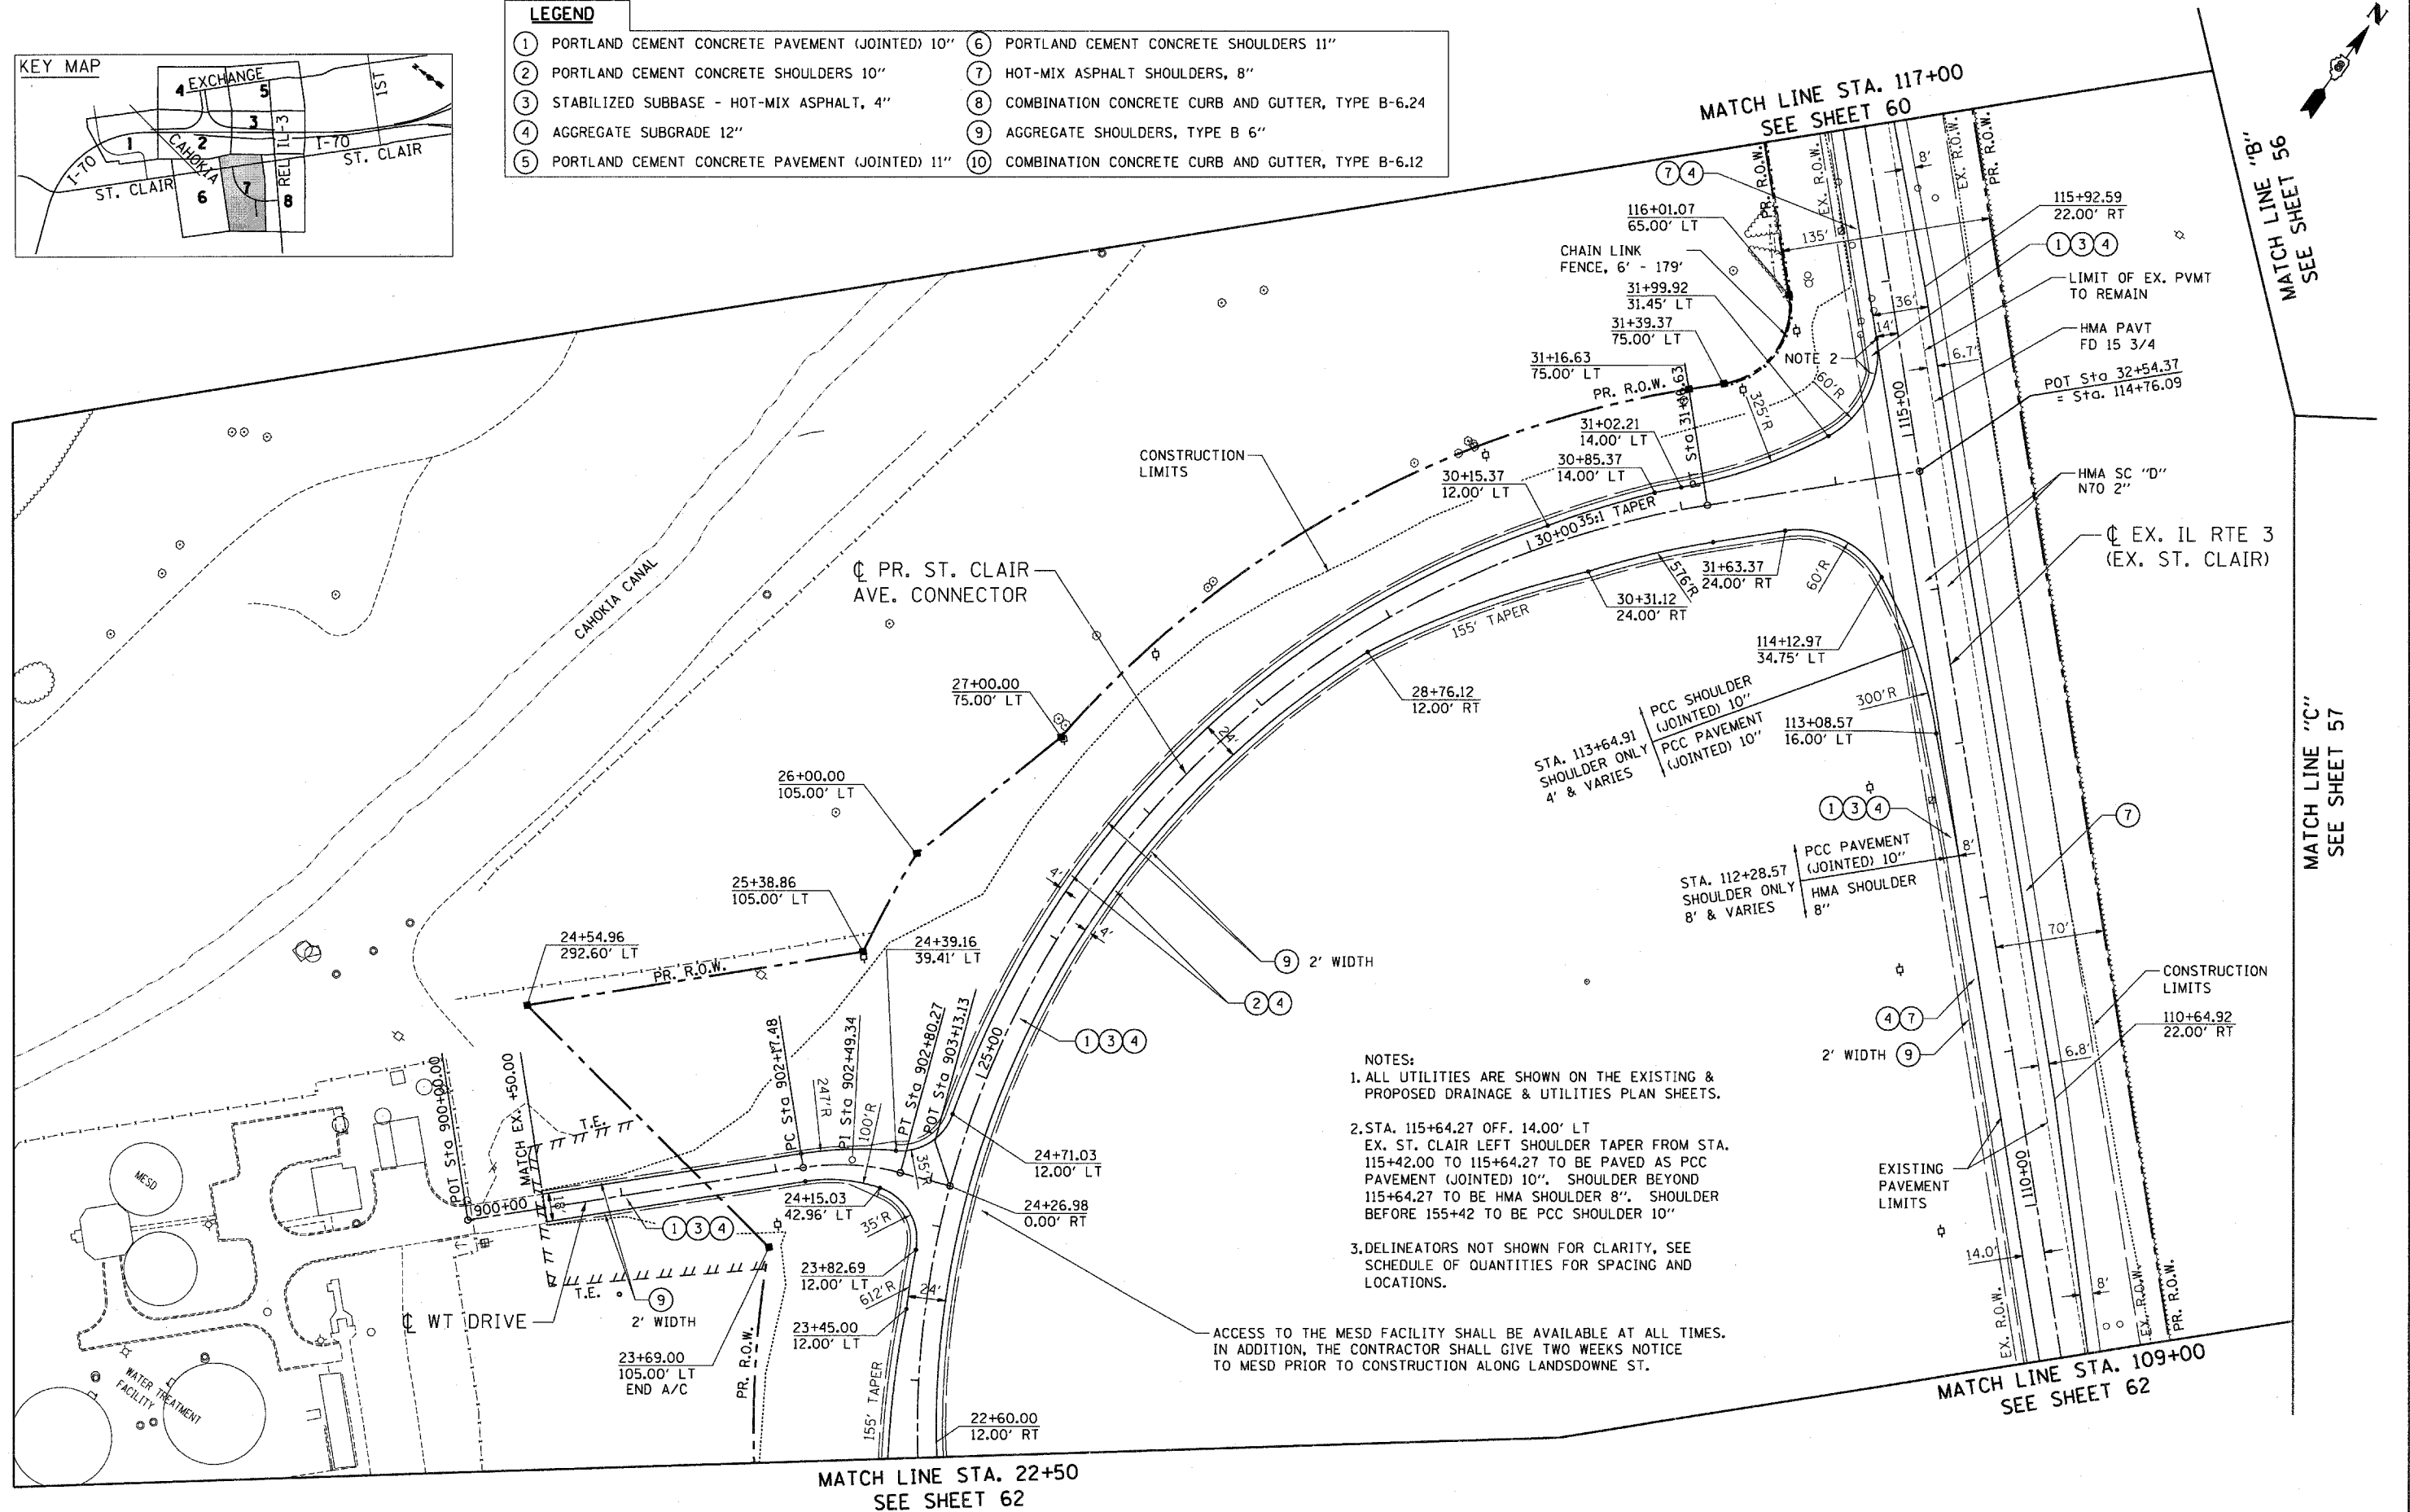

- NOTES:
- ALL UTILITIES ARE SHOWN ON THE EXISTING & PROPOSED DRAINAGE & UTILITIES PLAN SHEETS.
 - STA. 115+64.27 OFF. 14.00' LT EX. ST. CLAIR LEFT SHOULDER TAPER FROM STA. 115+42.00 TO 115+64.27 TO BE PAVED AS PCC PAVEMENT (JOINTED) 10". SHOULDER BEYOND 115+64.27 TO BE HMA SHOULDER 8". SHOULDER BEFORE 115+42 TO BE PCC SHOULDER 10"
 - DELINTEATORS NOT SHOWN FOR CLARITY, SEE SCHEDULE OF QUANTITIES FOR SPACING AND LOCATIONS.

MATCH LINE STA. 22+50
SEE SHEET 62

MATCH LINE STA. 117+00
SEE SHEET 60

MATCH LINE STA. 109+00
SEE SHEET 62

MATCH LINE "B"
SEE SHEET 56


MATCH LINE "C"
SEE SHEET 57

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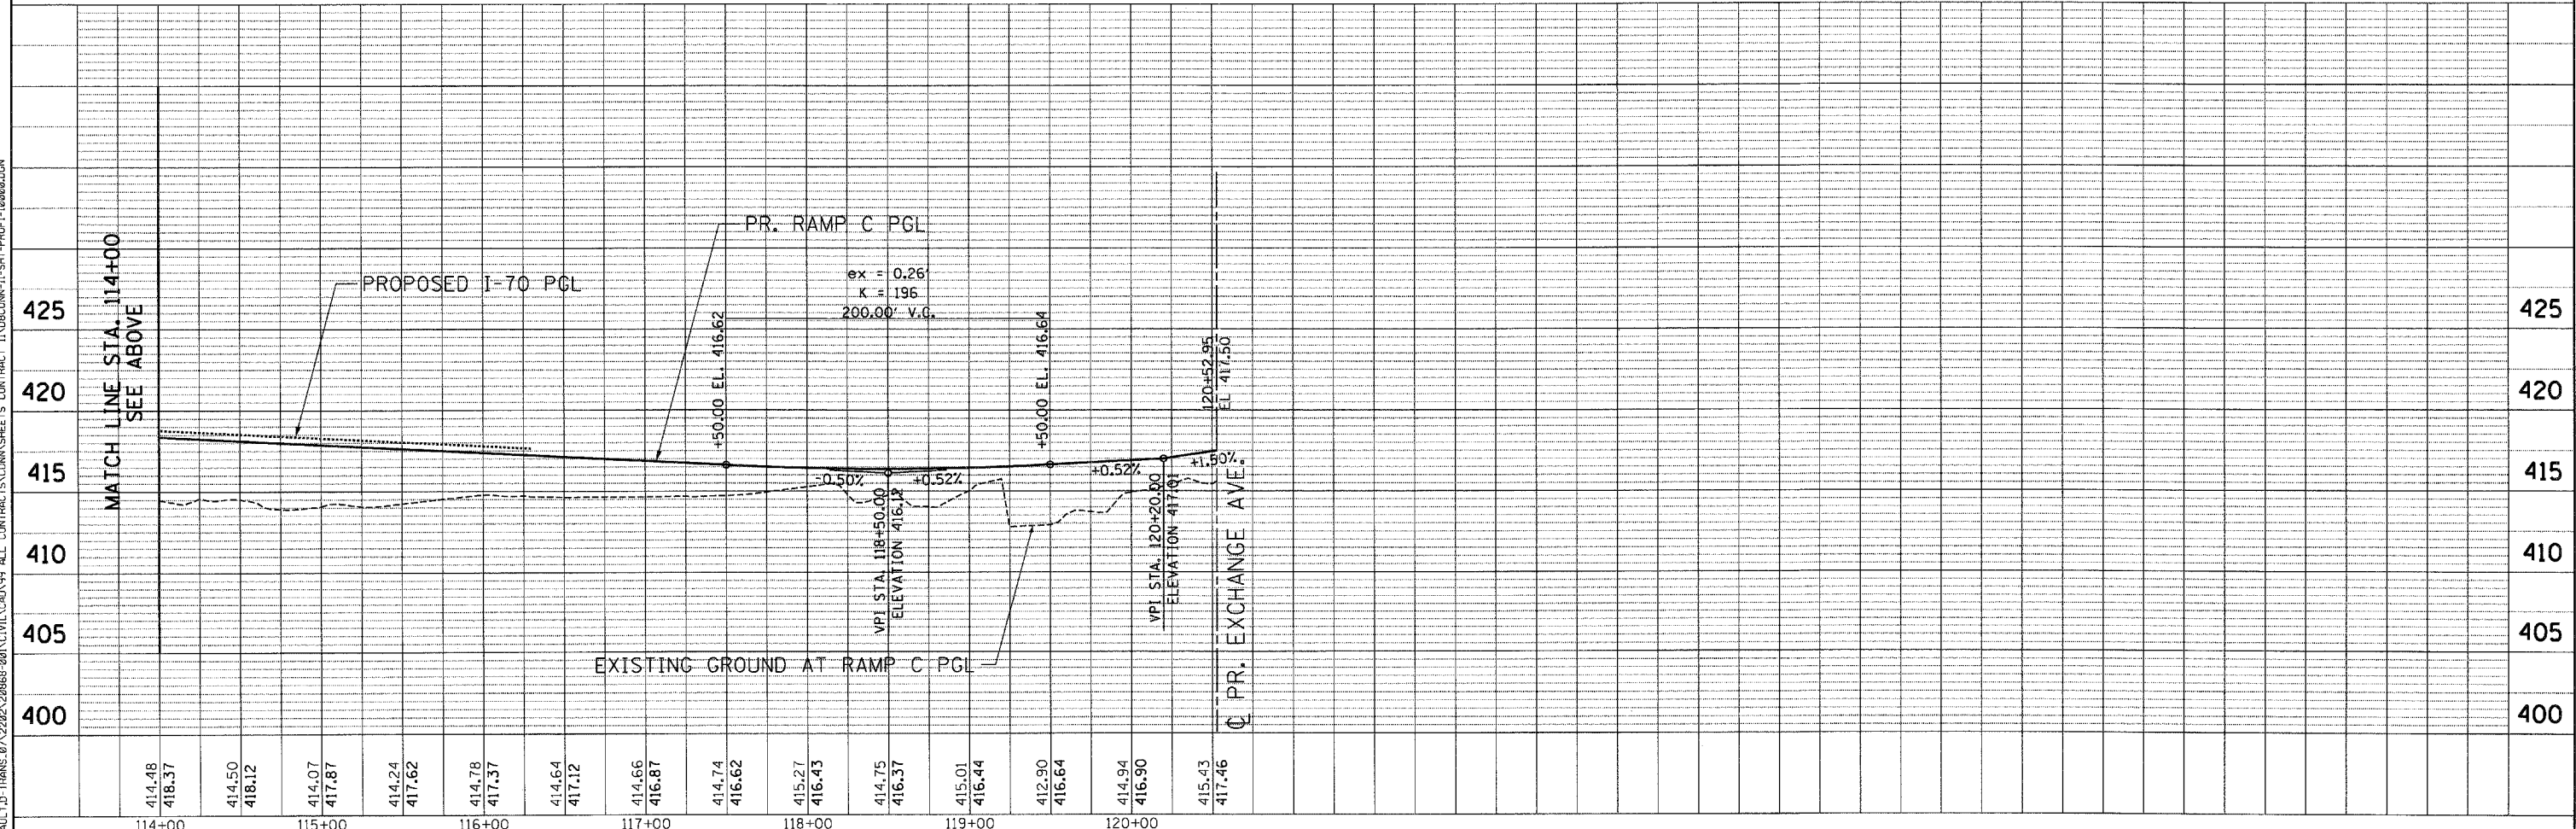
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		CHECKED - ACL	REVISED -									
		DATE - 10/21/11	REVISED -									



PLAN	SURVEYED	BY	DATE
	PLOTTED		
	CHECKED		
	PT. OF WAY CHECKED		
	NOTE BOOK		
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	SAID FILE NAME		

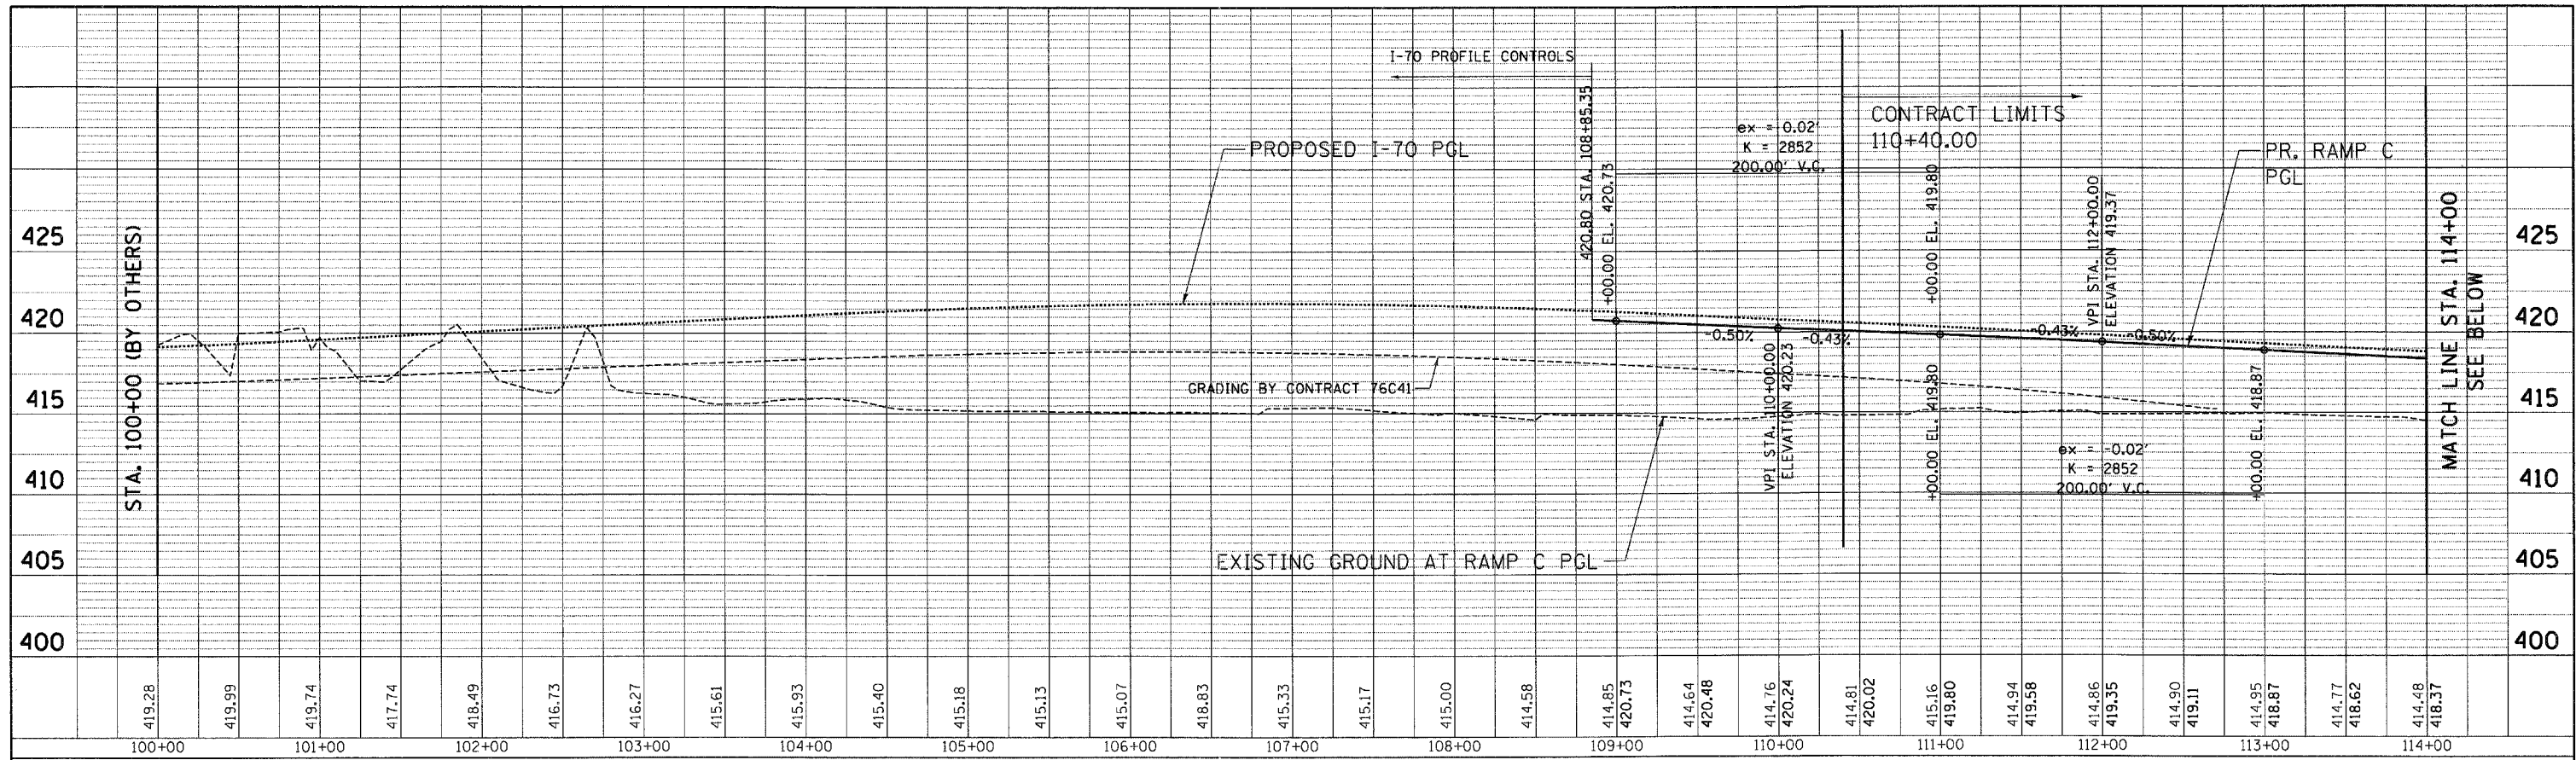

PROFILE	SURVEYED	BY	DATE
	PLOTTED		
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	SAID FILE NAME		





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		DATE - 10/21/11	REVISED -									

PLAN SURVEYED BY DATE
 PLOTTED BY DATE
 NOTE BOOK NO. OF WAY CHECKED
 NO. DDD FILE NAME

PROFILE SURVEYED BY DATE
 PLOTTED BY DATE
 NOTE BOOK NO. OF WAY CHECKED
 NO. DDD FILE NAME

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 11-25-2011 144329
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 PLOT DATE = #DATE#

DESIGNED - JB
 DRAWN - JB
 CHECKED - ACL
 DATE - 10/21/11

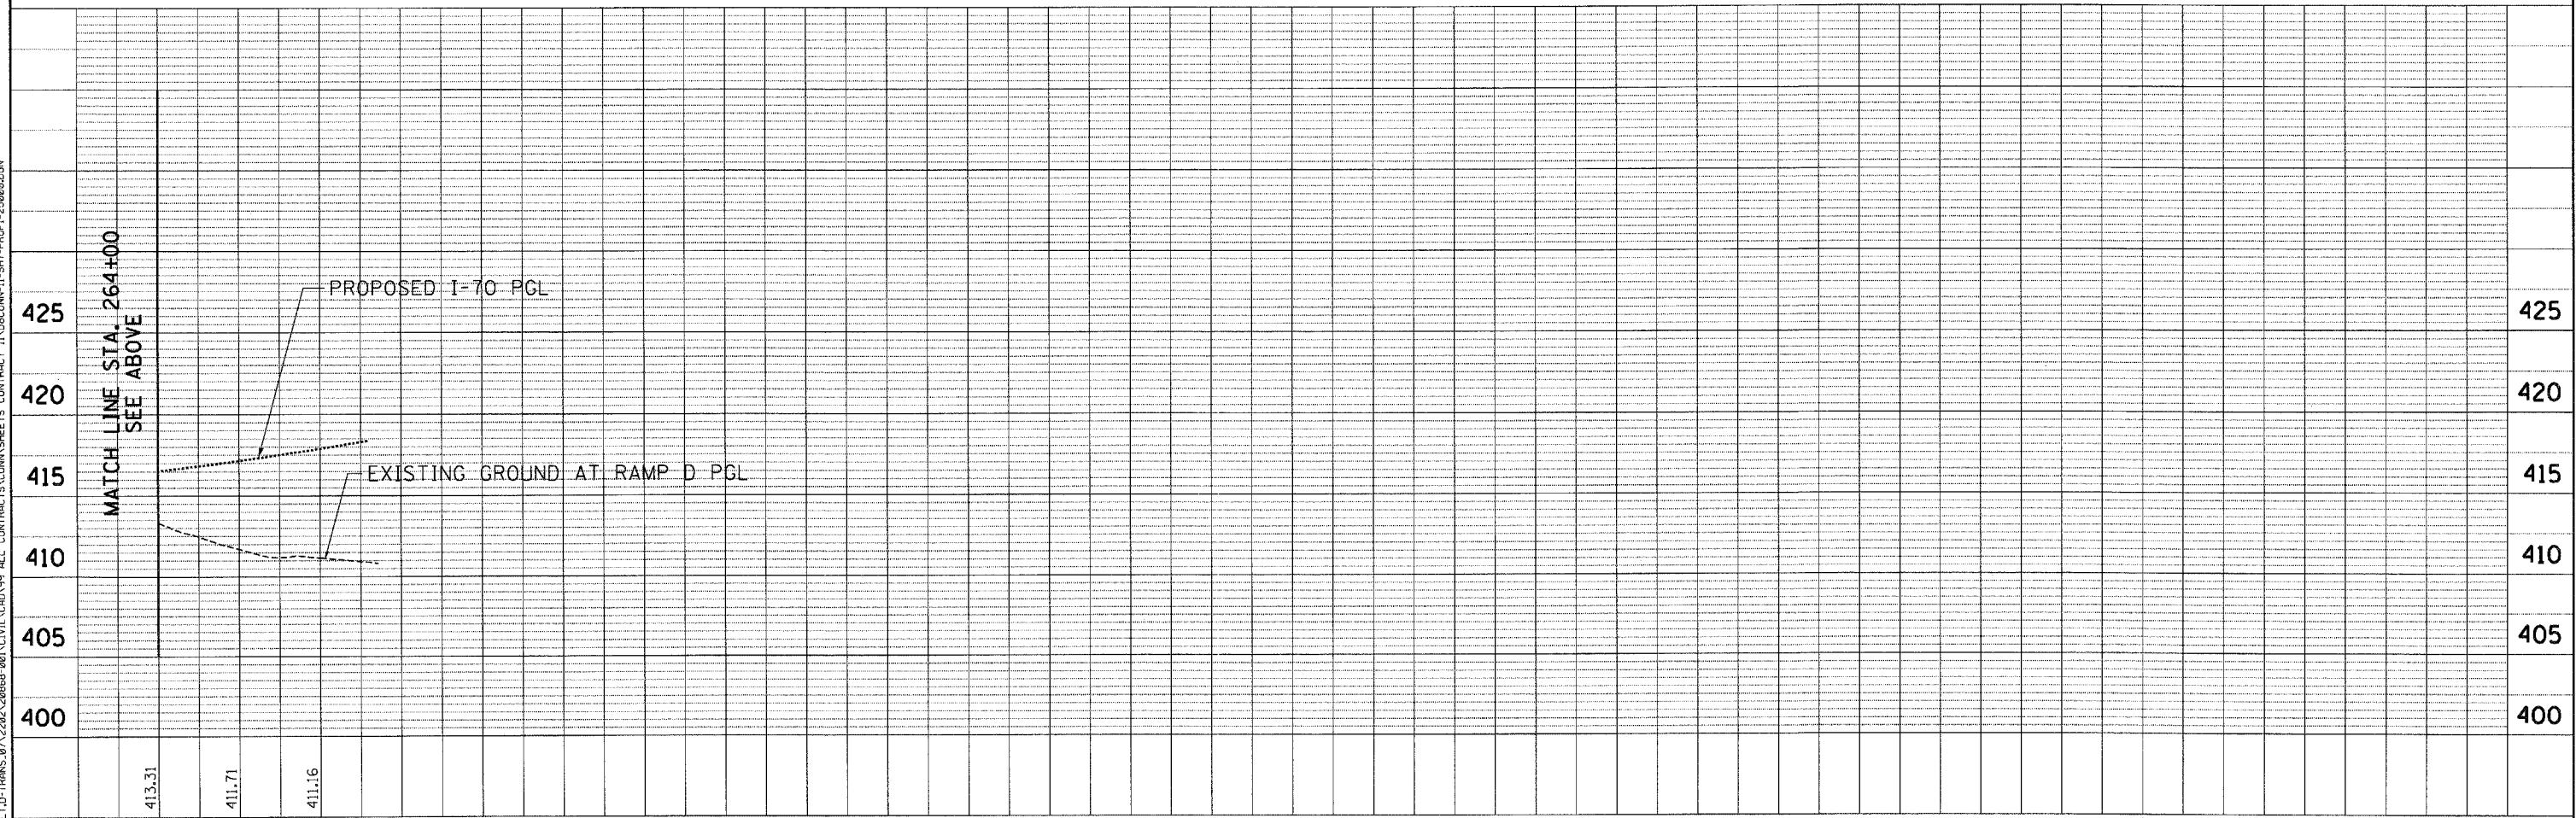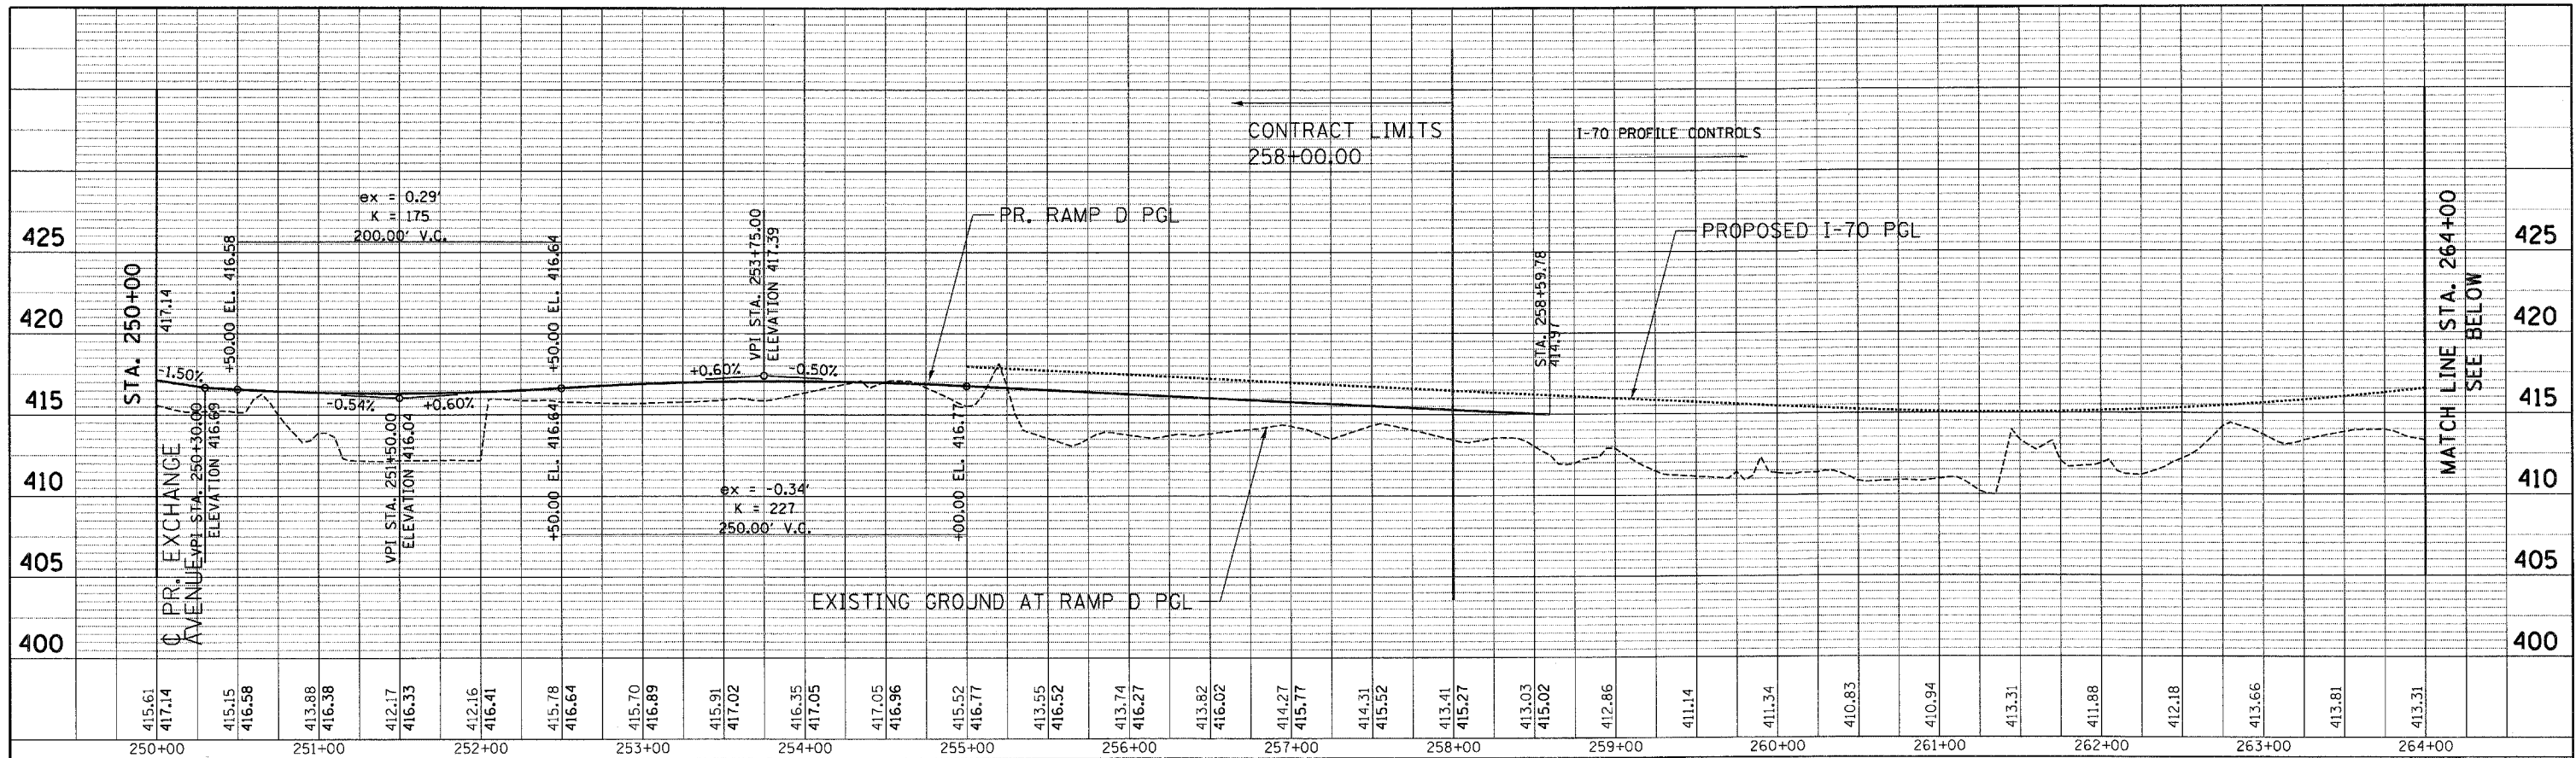REVISED -
 REVISED -
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 REVISED -

STATE OF ILLINOIS
DEPARTMENT OF TRANSPORTATION
 PROPOSED RELOCATED IL ROUTE 3 INTERCHANGE


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ROADWAY PROFILE
STA. 250 + 00 TO STA. 265 + 56
 SCALE: HORIZ. 1"=50' VERT. 1"=5' STA. TO STA.

F.A.P. RTE.	SECTION	COUNTY	TOTAL SHEETS	SHEET NO.
998	82-2-1K	ST. CLAIR	353	64
CONTRACT NO. 76E06				
FED. ROAD DIST. NO. ILLINOIS FED. AID PROJECT				

PLAN	NO.	DATE
BY		
REVISIONS		
PLOTTED		
ALIGNED		
CHECKED		
DATE		


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BY		
REVISIONS		
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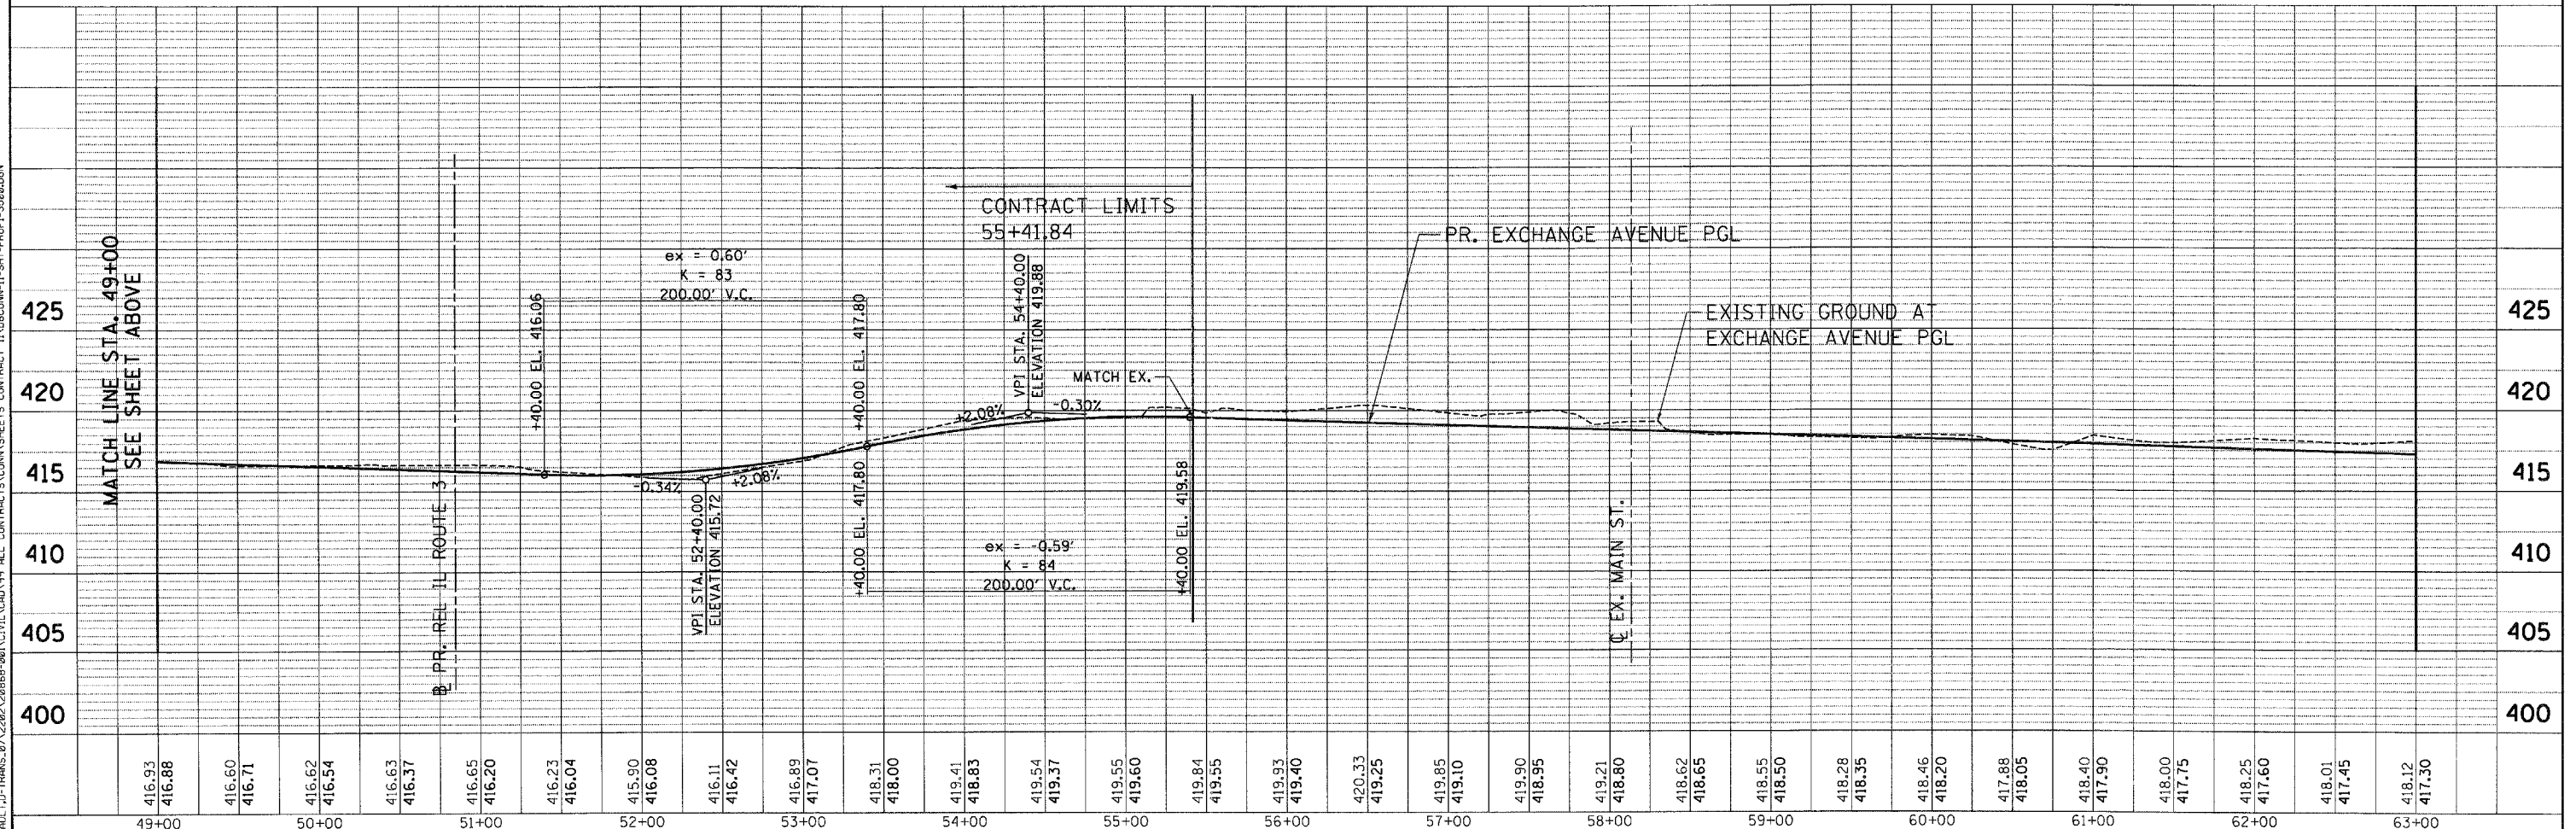


FILE NAME =	USER NAME = #USER#	DESIGNED - JB	REVISED -	STATE OF ILLINOIS DEPARTMENT OF TRANSPORTATION PROPOSED RELOCATED IL ROUTE 3 INTERCHANGE				PROPOSED RELOCATED ILLINOIS ROUTE 3 ROADWAY PROFILE STA. 1679 + 50 TO STA. 1693 + 50				F.A.P. RTE. 998	SECTION 82-2-1K	COUNTY ST. CLAIR	TOTAL SHEETS 353	SHEET NO. 66
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PLOT DATE = #DATE#		CHECKED - ACL	REVISED -													
		DATE - 10/21/11	REVISED -													

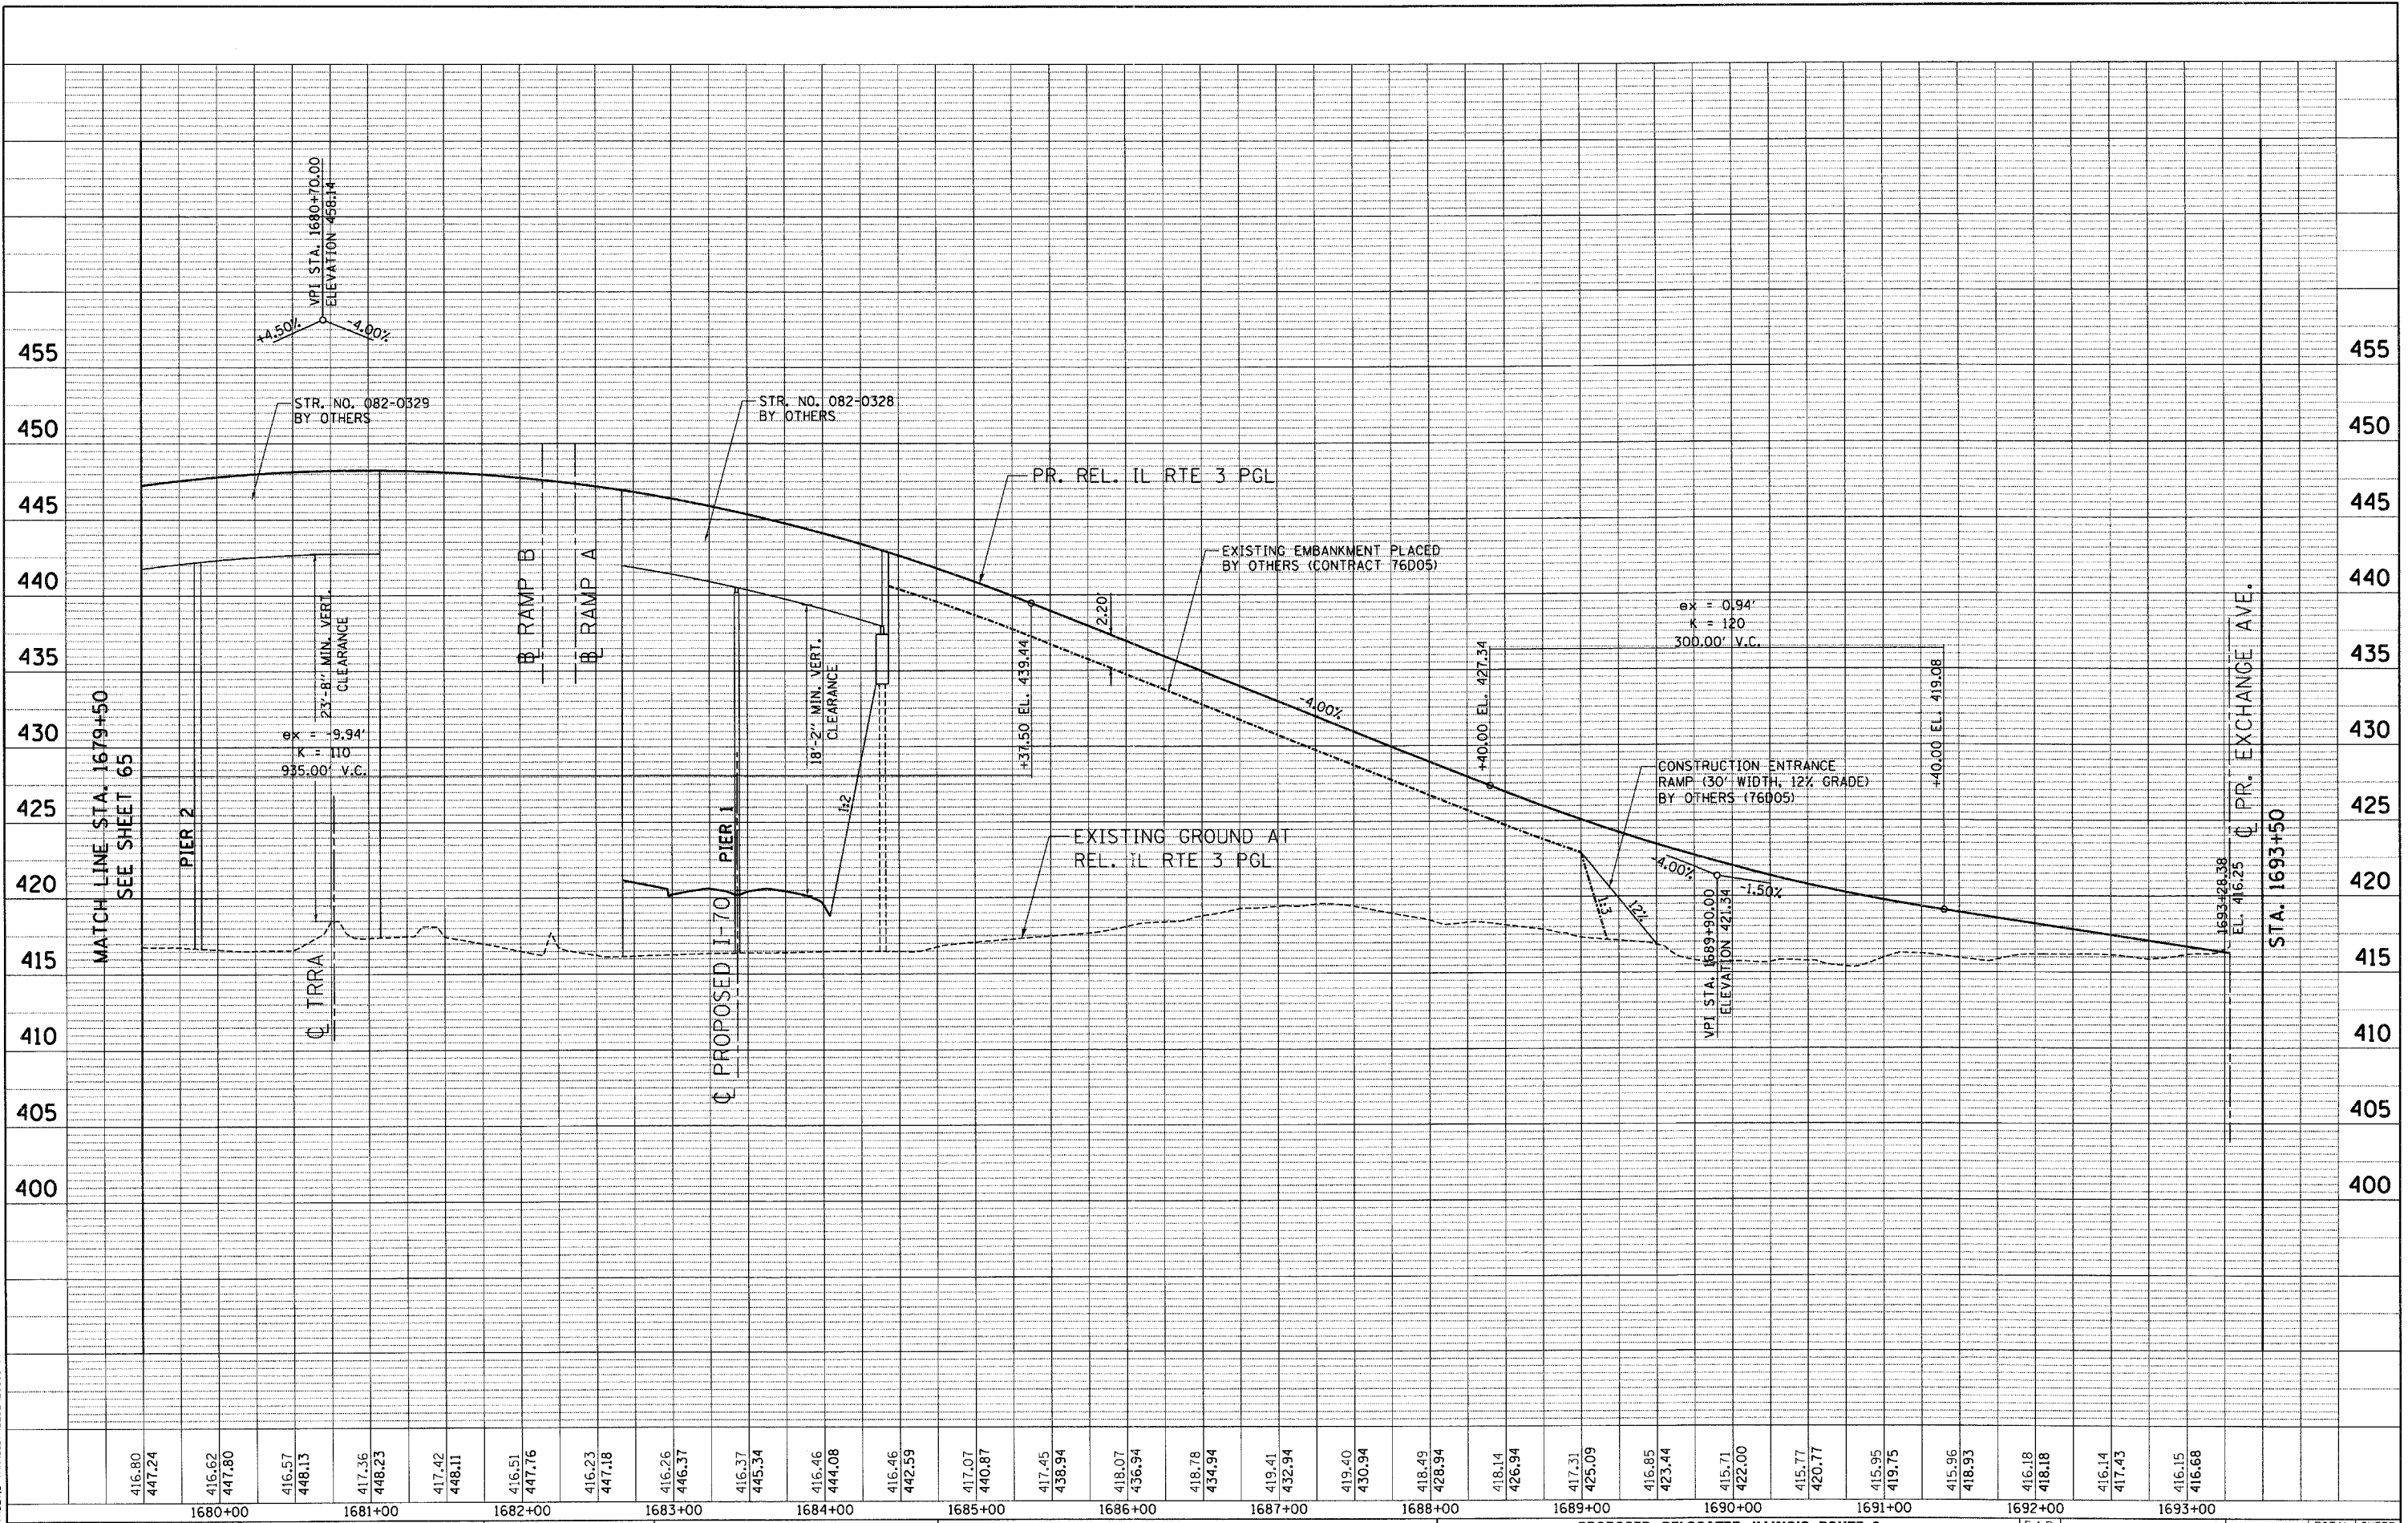PLAN	REVISED	DATE
NO.	BY	
NOTE BOOK	FILED	
CHECKED	ALIGNED	
DATE	DATE	
FILE NAME	FILE NAME	



PROFILE	REVISED	DATE
NO.	BY	
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DATE	DATE	
FILE NAME	FILE NAME	

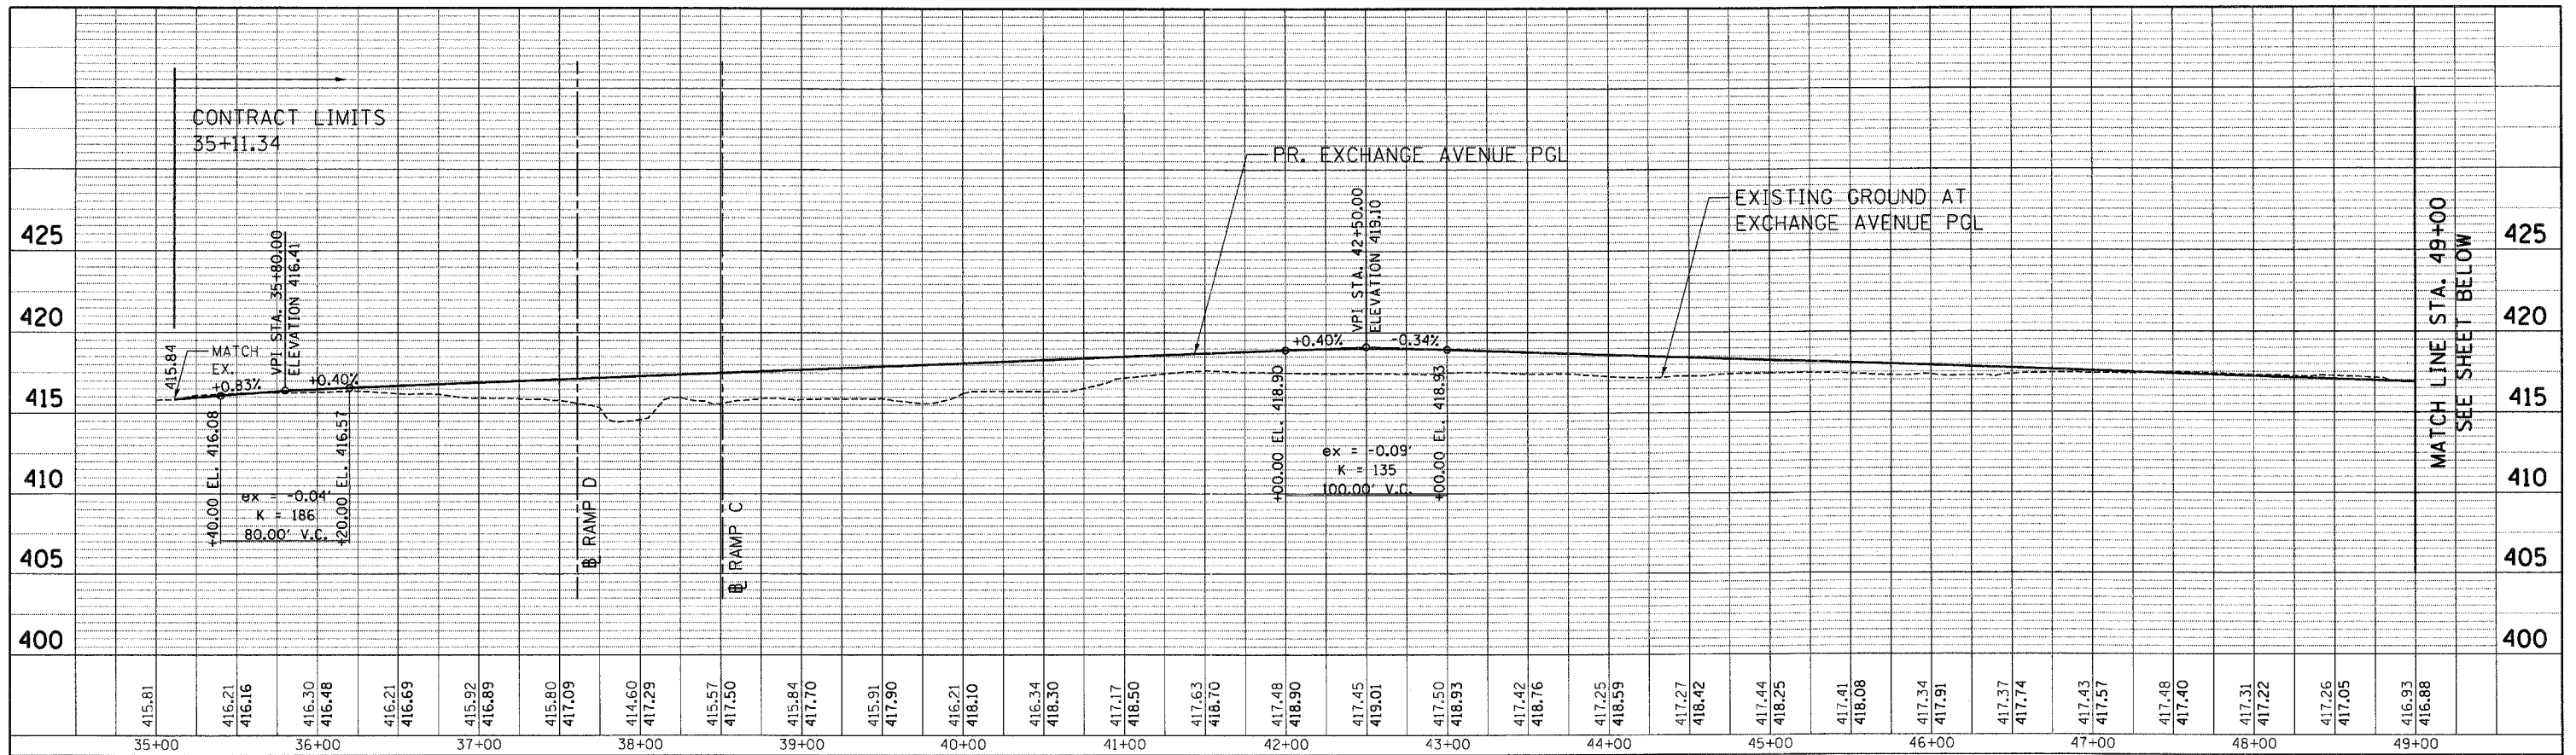



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FILE NAME =	USER NAME = \$USER\$	DESIGNED - JB	REVISED -	STATE OF ILLINOIS DEPARTMENT OF TRANSPORTATION PROPOSED RELOCATED IL ROUTE 3 INTERCHANGE	PROPOSED EXCHANGE AVENUE EXTENSION ROADWAY PROFILE STA. 35+00 TO STA. 63+00		F.A.P. RTE. 998	SECTION 82-2-1K	COUNTY ST. CLAIR	TOTAL SHEETS 353	SHEET NO. 67
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PLOT DATE = \$DATE\$		DATE - 10/21/11	REVISED -								





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	PAID FILE NAME		
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PROFILE	SURVEYED	BY	DATE
	PLOTTED		
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	NOTATIONS		
	CHKD		
	NO.		



FILE NAME =	USER NAME = #USER#	DESIGNED - JB	REVISED -	STATE OF ILLINOIS		F.A.P. RTE.	SECTION	COUNTY	TOTAL SHEETS	SHEET NO.
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MAINTENANCE OF TRAFFIC LEGEND

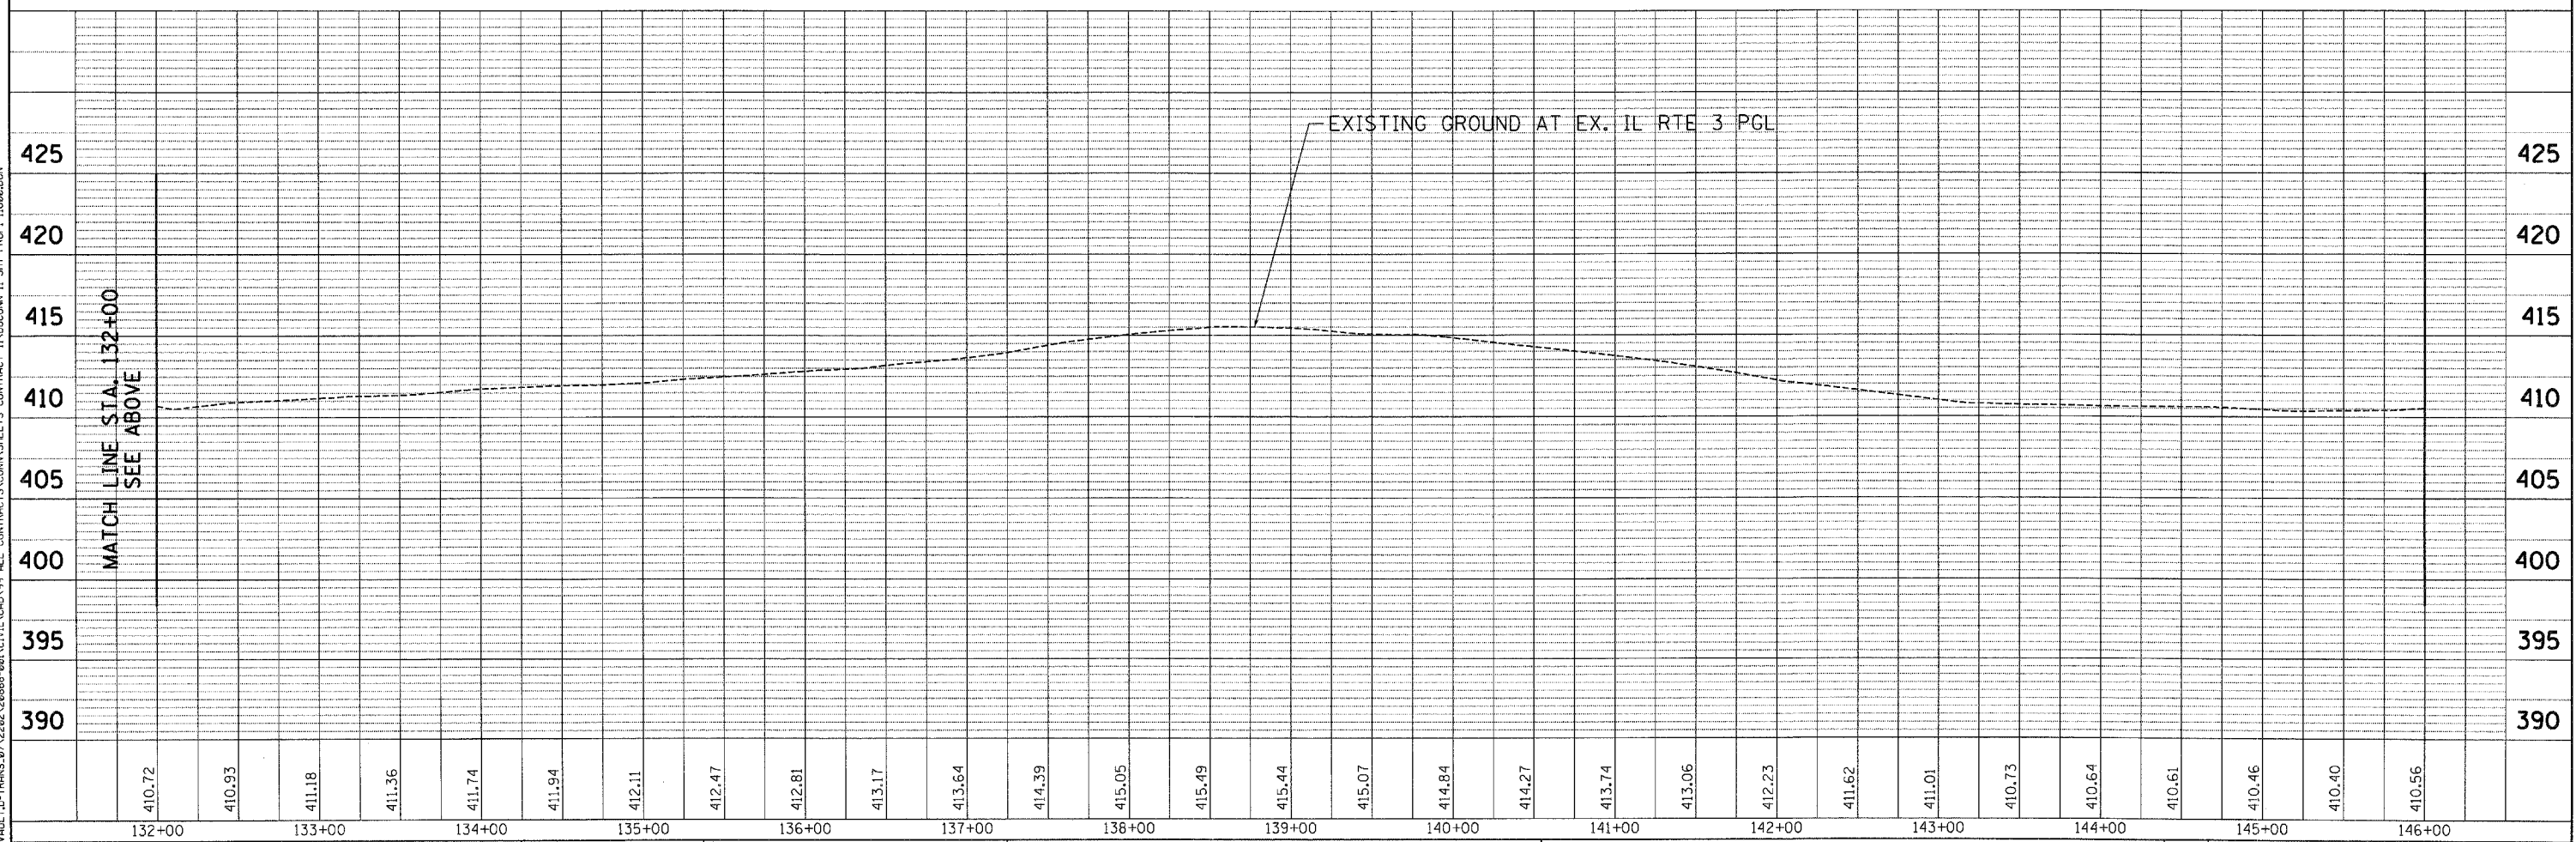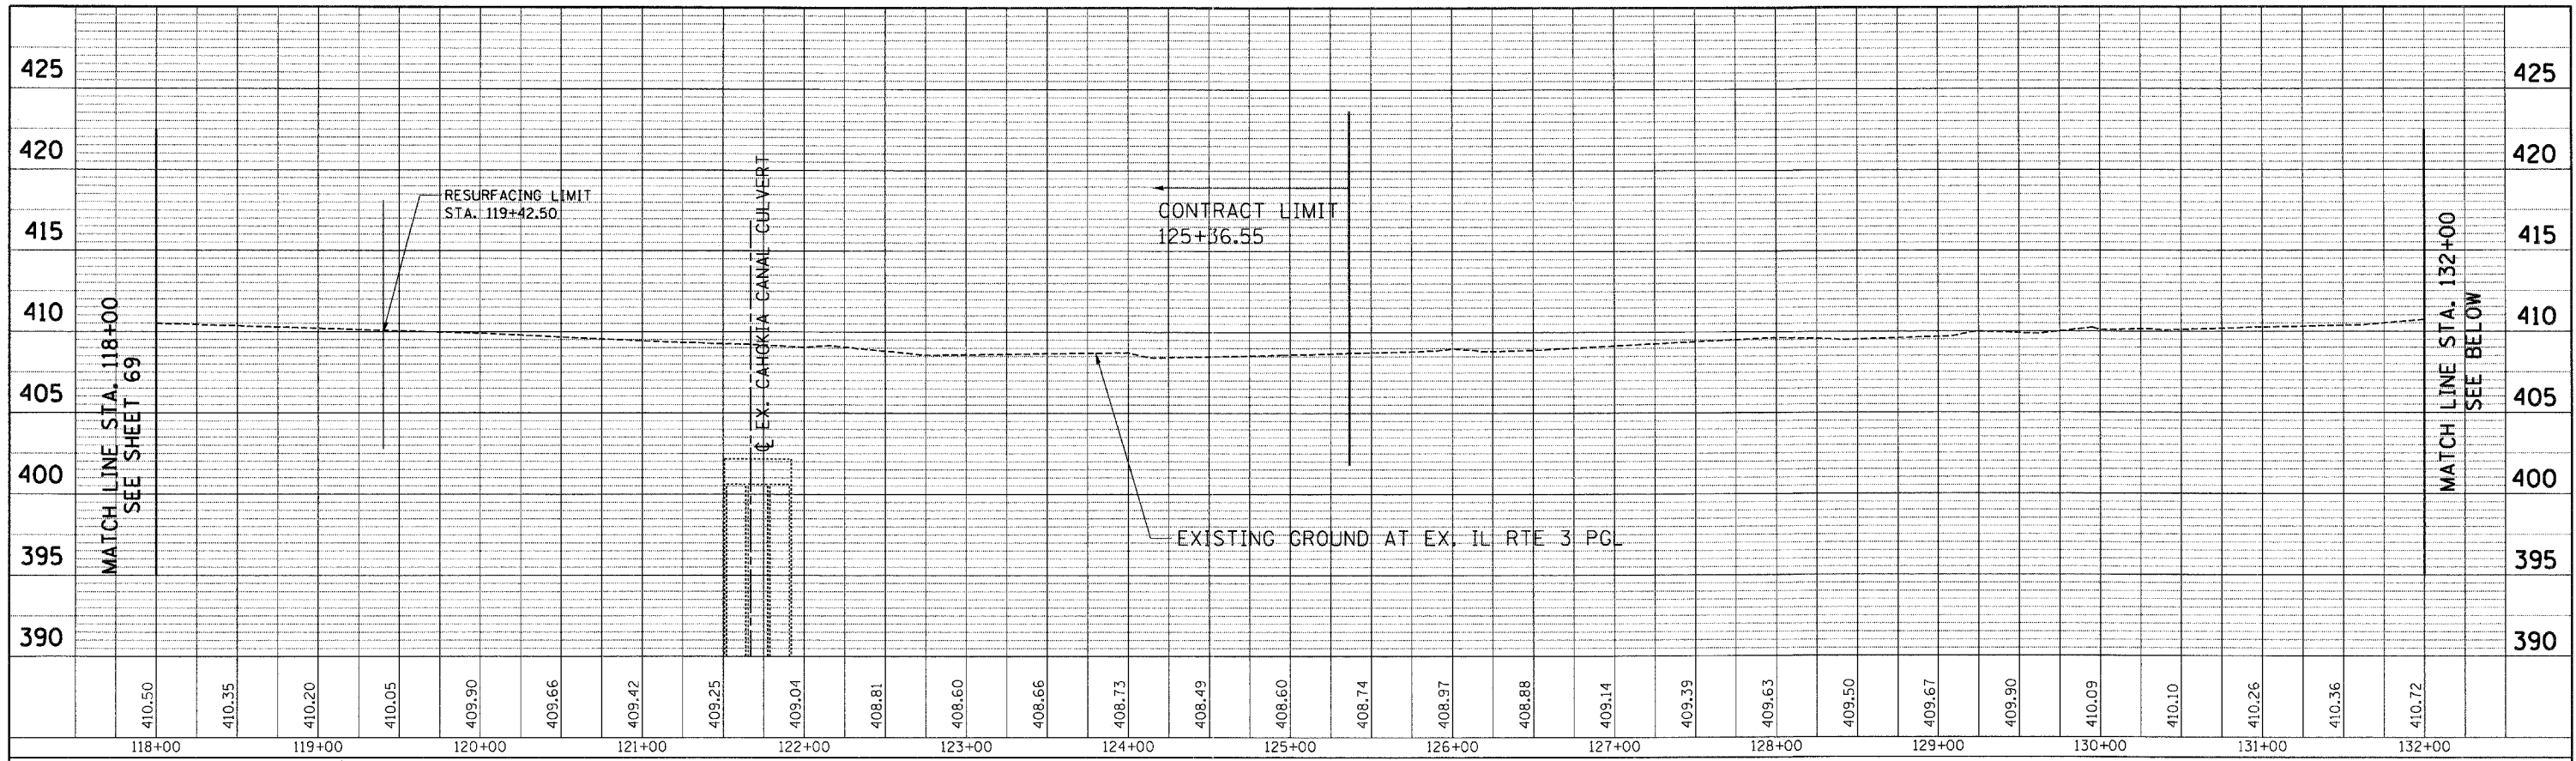- WORK ZONE
- TRAFFIC FLOW
- EXISTING SIGN
- BARRICADE, TYPE III
- PROPOSED SIGN
- BARRELS/DRUMS (SPACED AT 25' CENTERS)

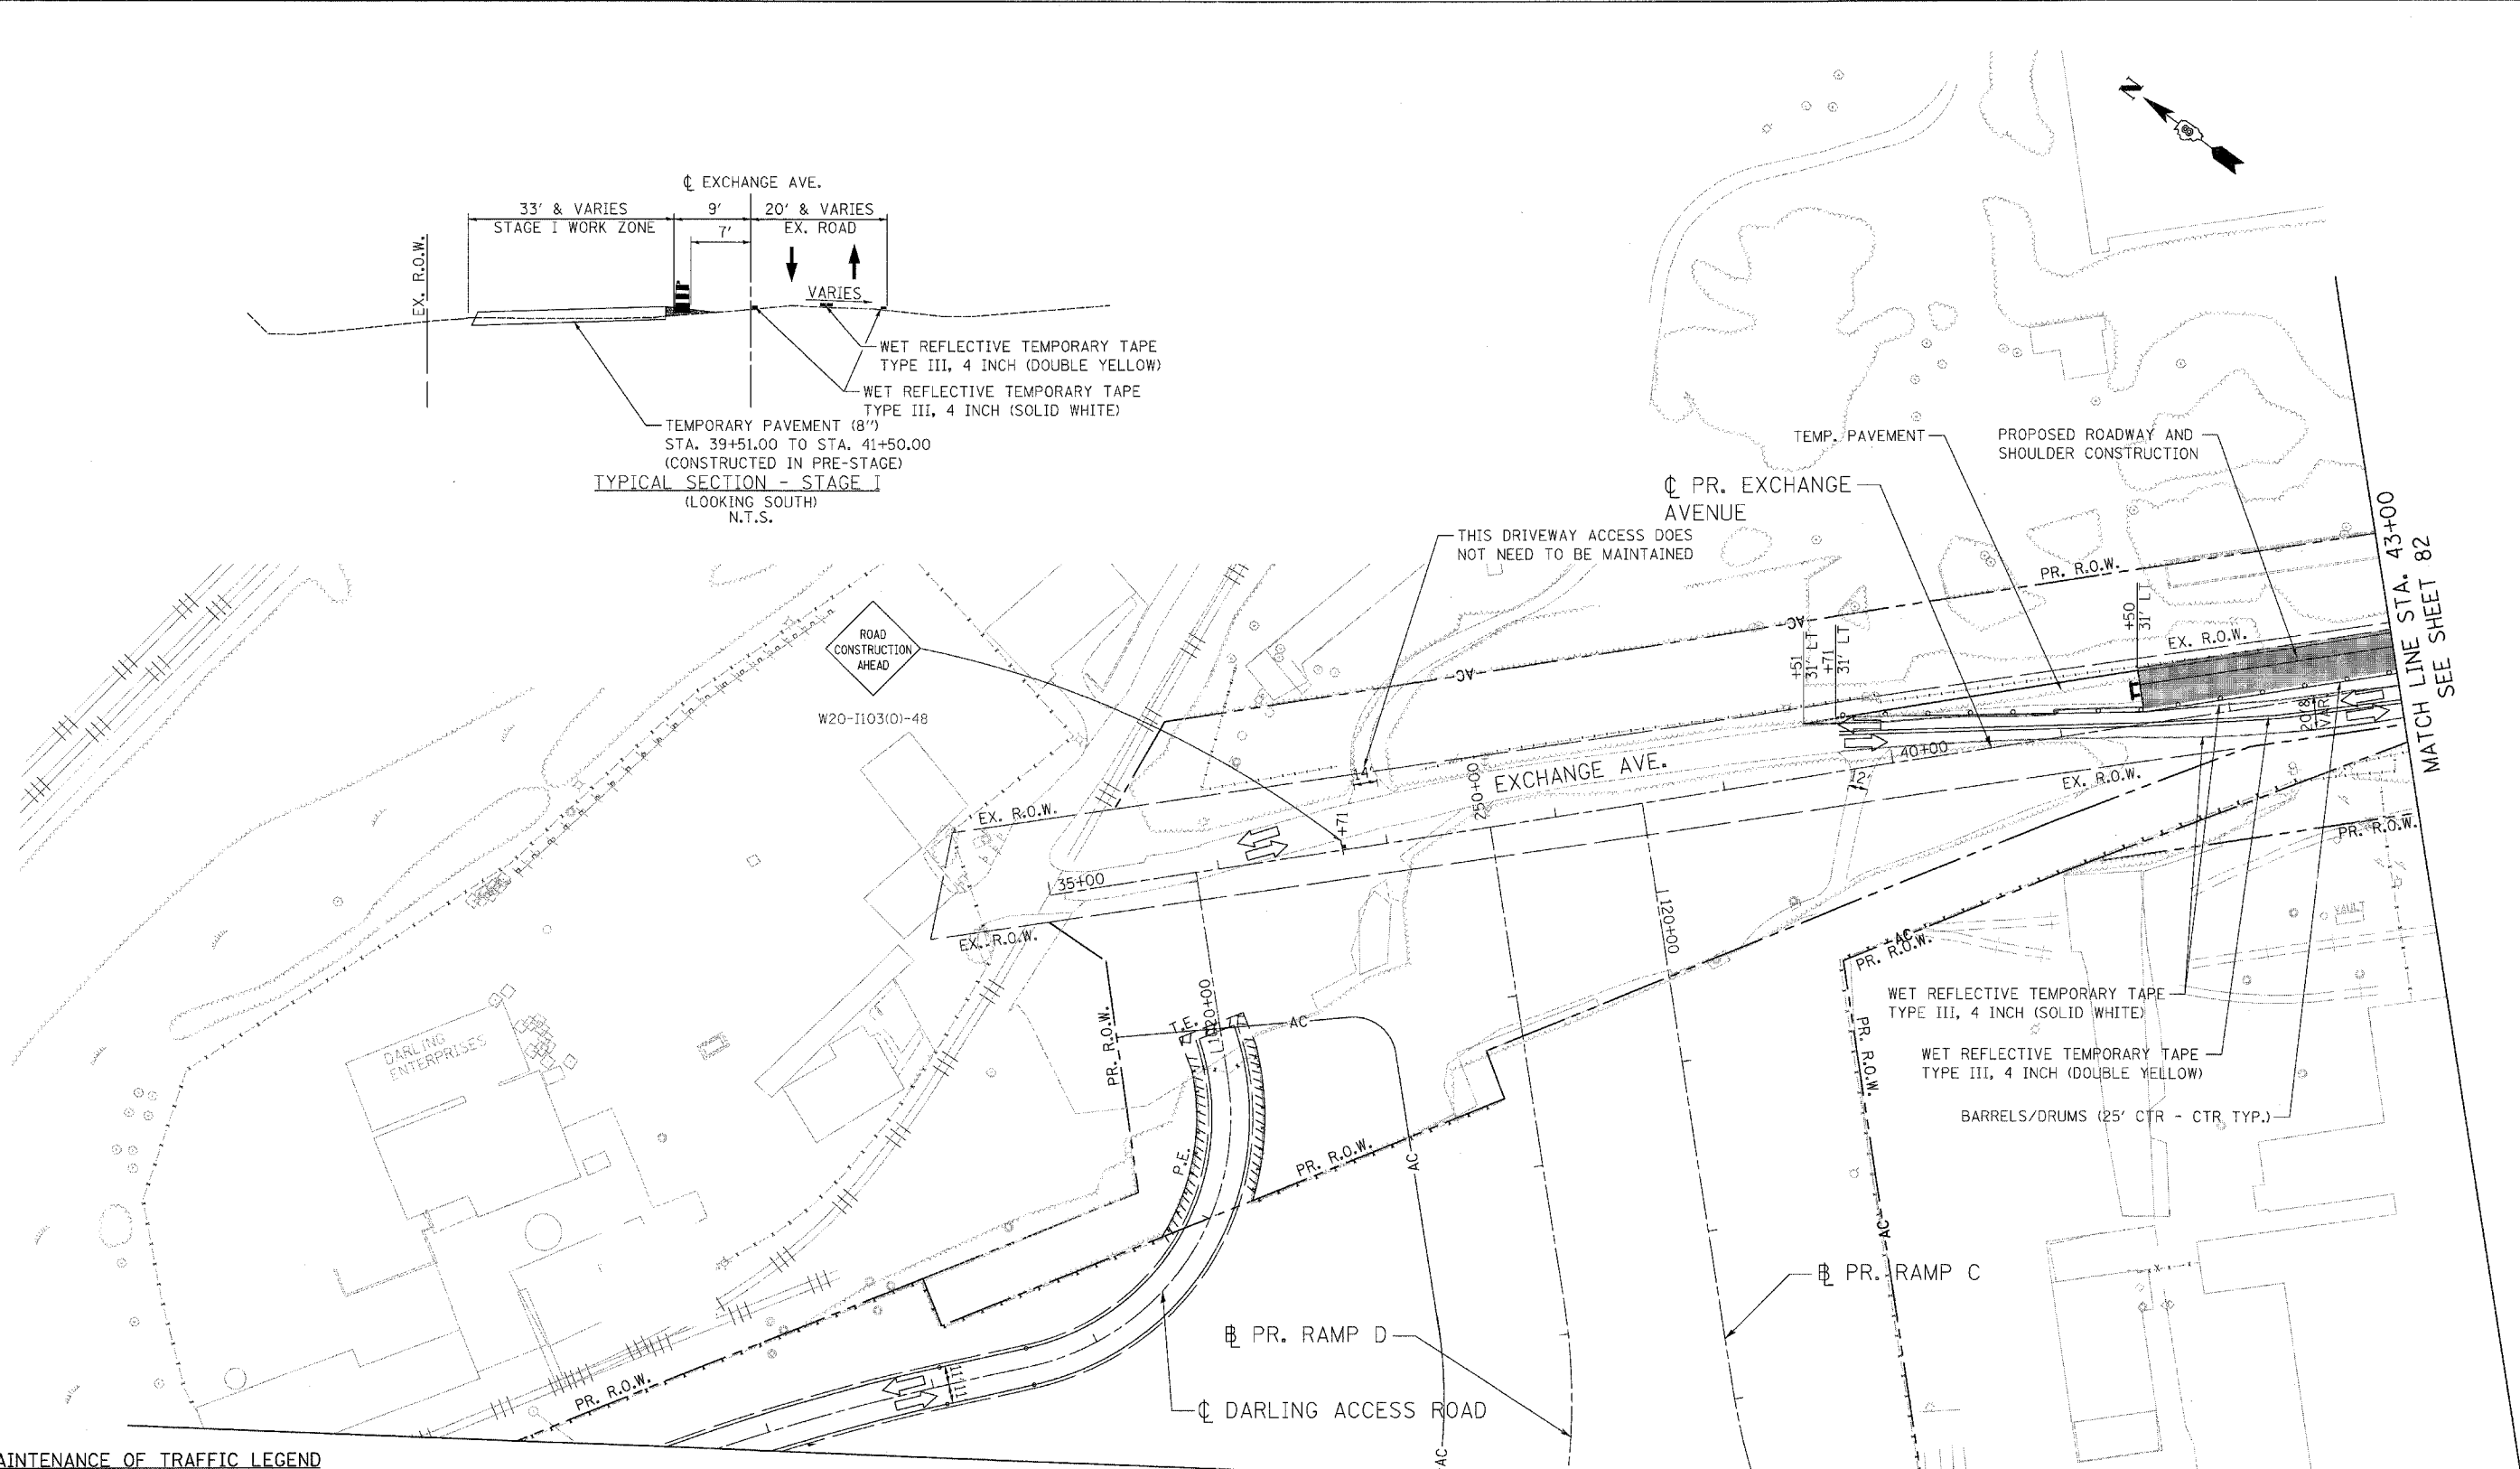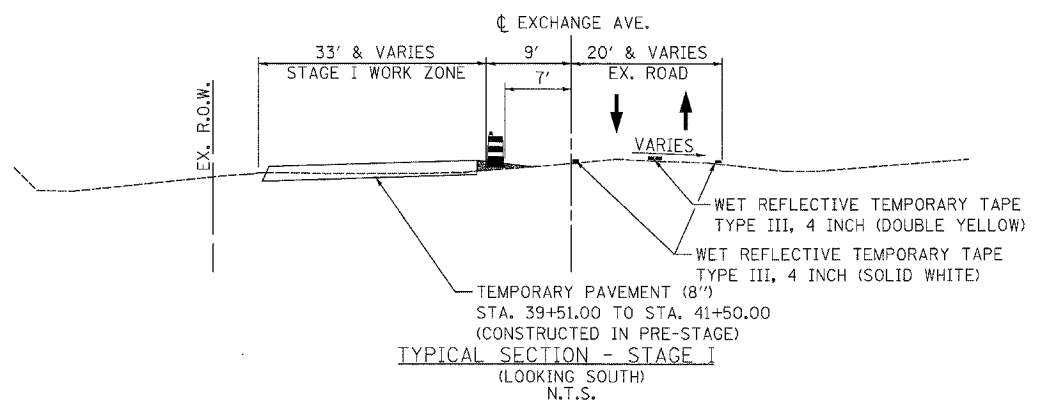

USER NAME = Plotted by Scott Wilkerson	DESIGNED - SEW	REVISED -
DRAWN - RK	REVISIED -	
CHECKED - ST	REVISIED -	
DATE - 10/21/11	REVISIED -	



**STATE OF ILLINOIS
DEPARTMENT OF TRANSPORTATION**
PROPOSED RELOCATED ILLINOIS ROUTE 3 INTERCHANGE

**PR. EXCHANGE AVE., RAMPS C AND D
MAINTENANCE OF TRAFFIC - STAGE 1
STA. 35+00 TO STA. 43+00**

SCALE: 1"=50' SHEET NO. 2 OF 15 SHEETS STA. TO STA.


F.A.P. RTE. 998	SECTION 82-2-1K	COUNTY ST. CLAIR	TOTAL SHEETS 353	SHEET NO. 81
FED. ROAD DIST. NO.			ILLINOIS FED. AID PROJECT CONTRACT NO. 76E06	

MATCH LINE STA. 43+00
SEE SHEET 81

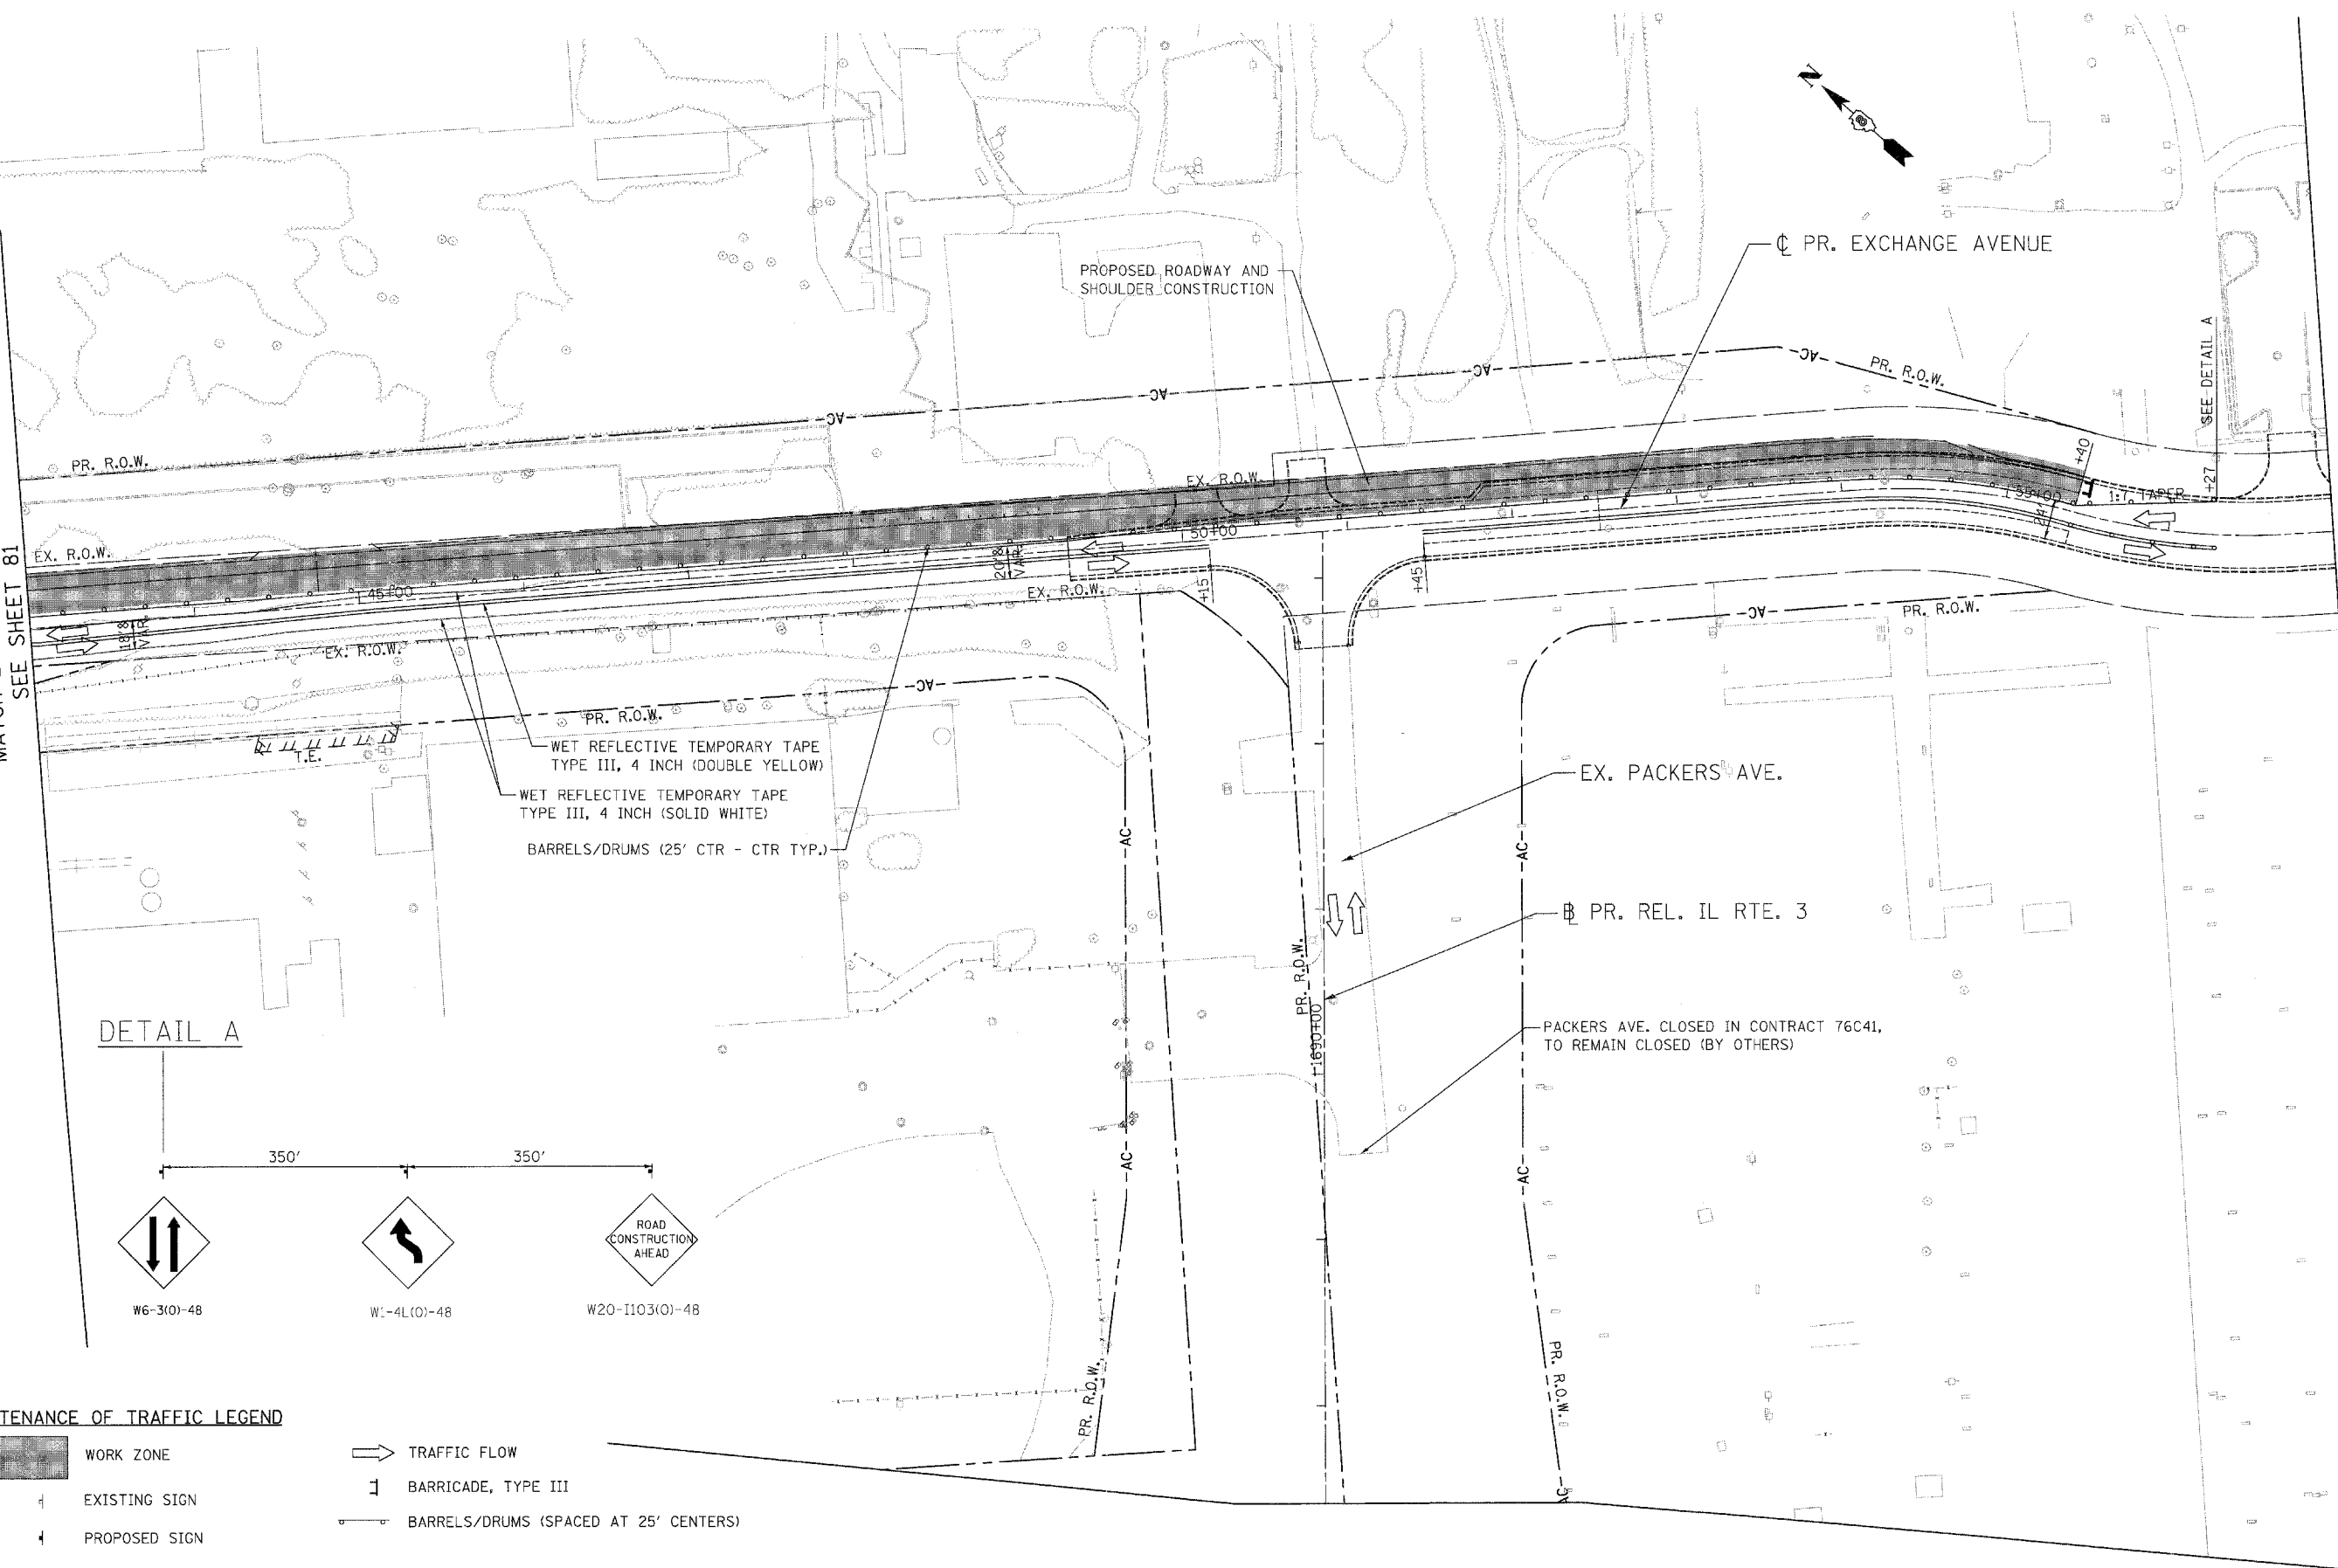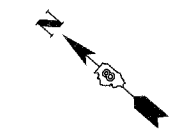

WET REFLECTIVE TEMPORARY TAPE
TYPE III, 4 INCH (DOUBLE YELLOW)
WET REFLECTIVE TEMPORARY TAPE
TYPE III, 4 INCH (SOLID WHITE)
BARRELS/DRUMS (25' CTR - CTR TYP.)


DETAIL A

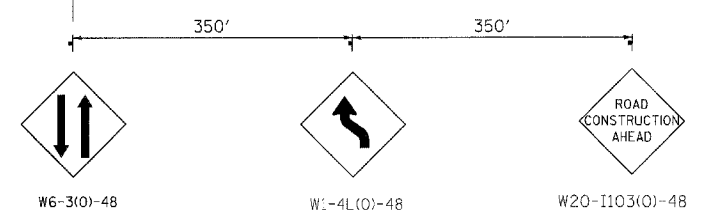

MAINTENANCE OF TRAFFIC LEGEND

- WORK ZONE
- TRAFFIC FLOW
- BARRICADE, TYPE III
- EXISTING SIGN
- PROPOSED SIGN
- BARRELS/DRUMS (SPACED AT 25' CENTERS)

484646.dwg, last modified: 10/21/11 10:17:20 AM
 484646.dwg, last modified: 10/21/11 10:17:20 AM
 484646.dwg, last modified: 10/21/11 10:17:20 AM

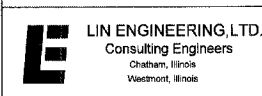

USER NAME = Plotted by Scott Wilkinson
 DESIGNED - SEW
 DRAWN - RK
 CHECKED - ST
 PLOT DATE = 10/17/2011
 DATE - 10/21/11

REVISED -
 REVISED -
 REVISED -
 REVISED -


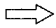

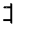


STATE OF ILLINOIS
DEPARTMENT OF TRANSPORTATION
 PROPOSED RELOCATED ILLINOIS ROUTE 3 INTERCHANGE



PR. EXCHANGE AVE. AND PR. REL. IL RTE. 3
MAINTENANCE OF TRAFFIC - STAGE 1
STA. 43+00 TO STA. 57+00
 SCALE: 1"=50' SHEET NO. 3 OF 15 SHEETS STA. TO STA.

F.A.P. RTE.	SECTION	COUNTY	TOTAL SHEETS	SHEET NO.
998	82-2-1K	ST. CLAIR	353	82
FED. ROAD DIST. NO.			ILLINOIS FED. AID PROJECT	

CONTRACT NO. 76E06

MAINTENANCE OF TRAFFIC LEGEND

-  WORK ZONE
-  TRAFFIC FLOW
-  EXISTING SIGN
-  BARRICADE, TYPE III
-  PROPOSED SIGN
-  BARRELS/DRUMS (SPACED AT 25' CENTERS)

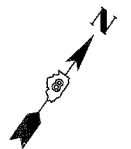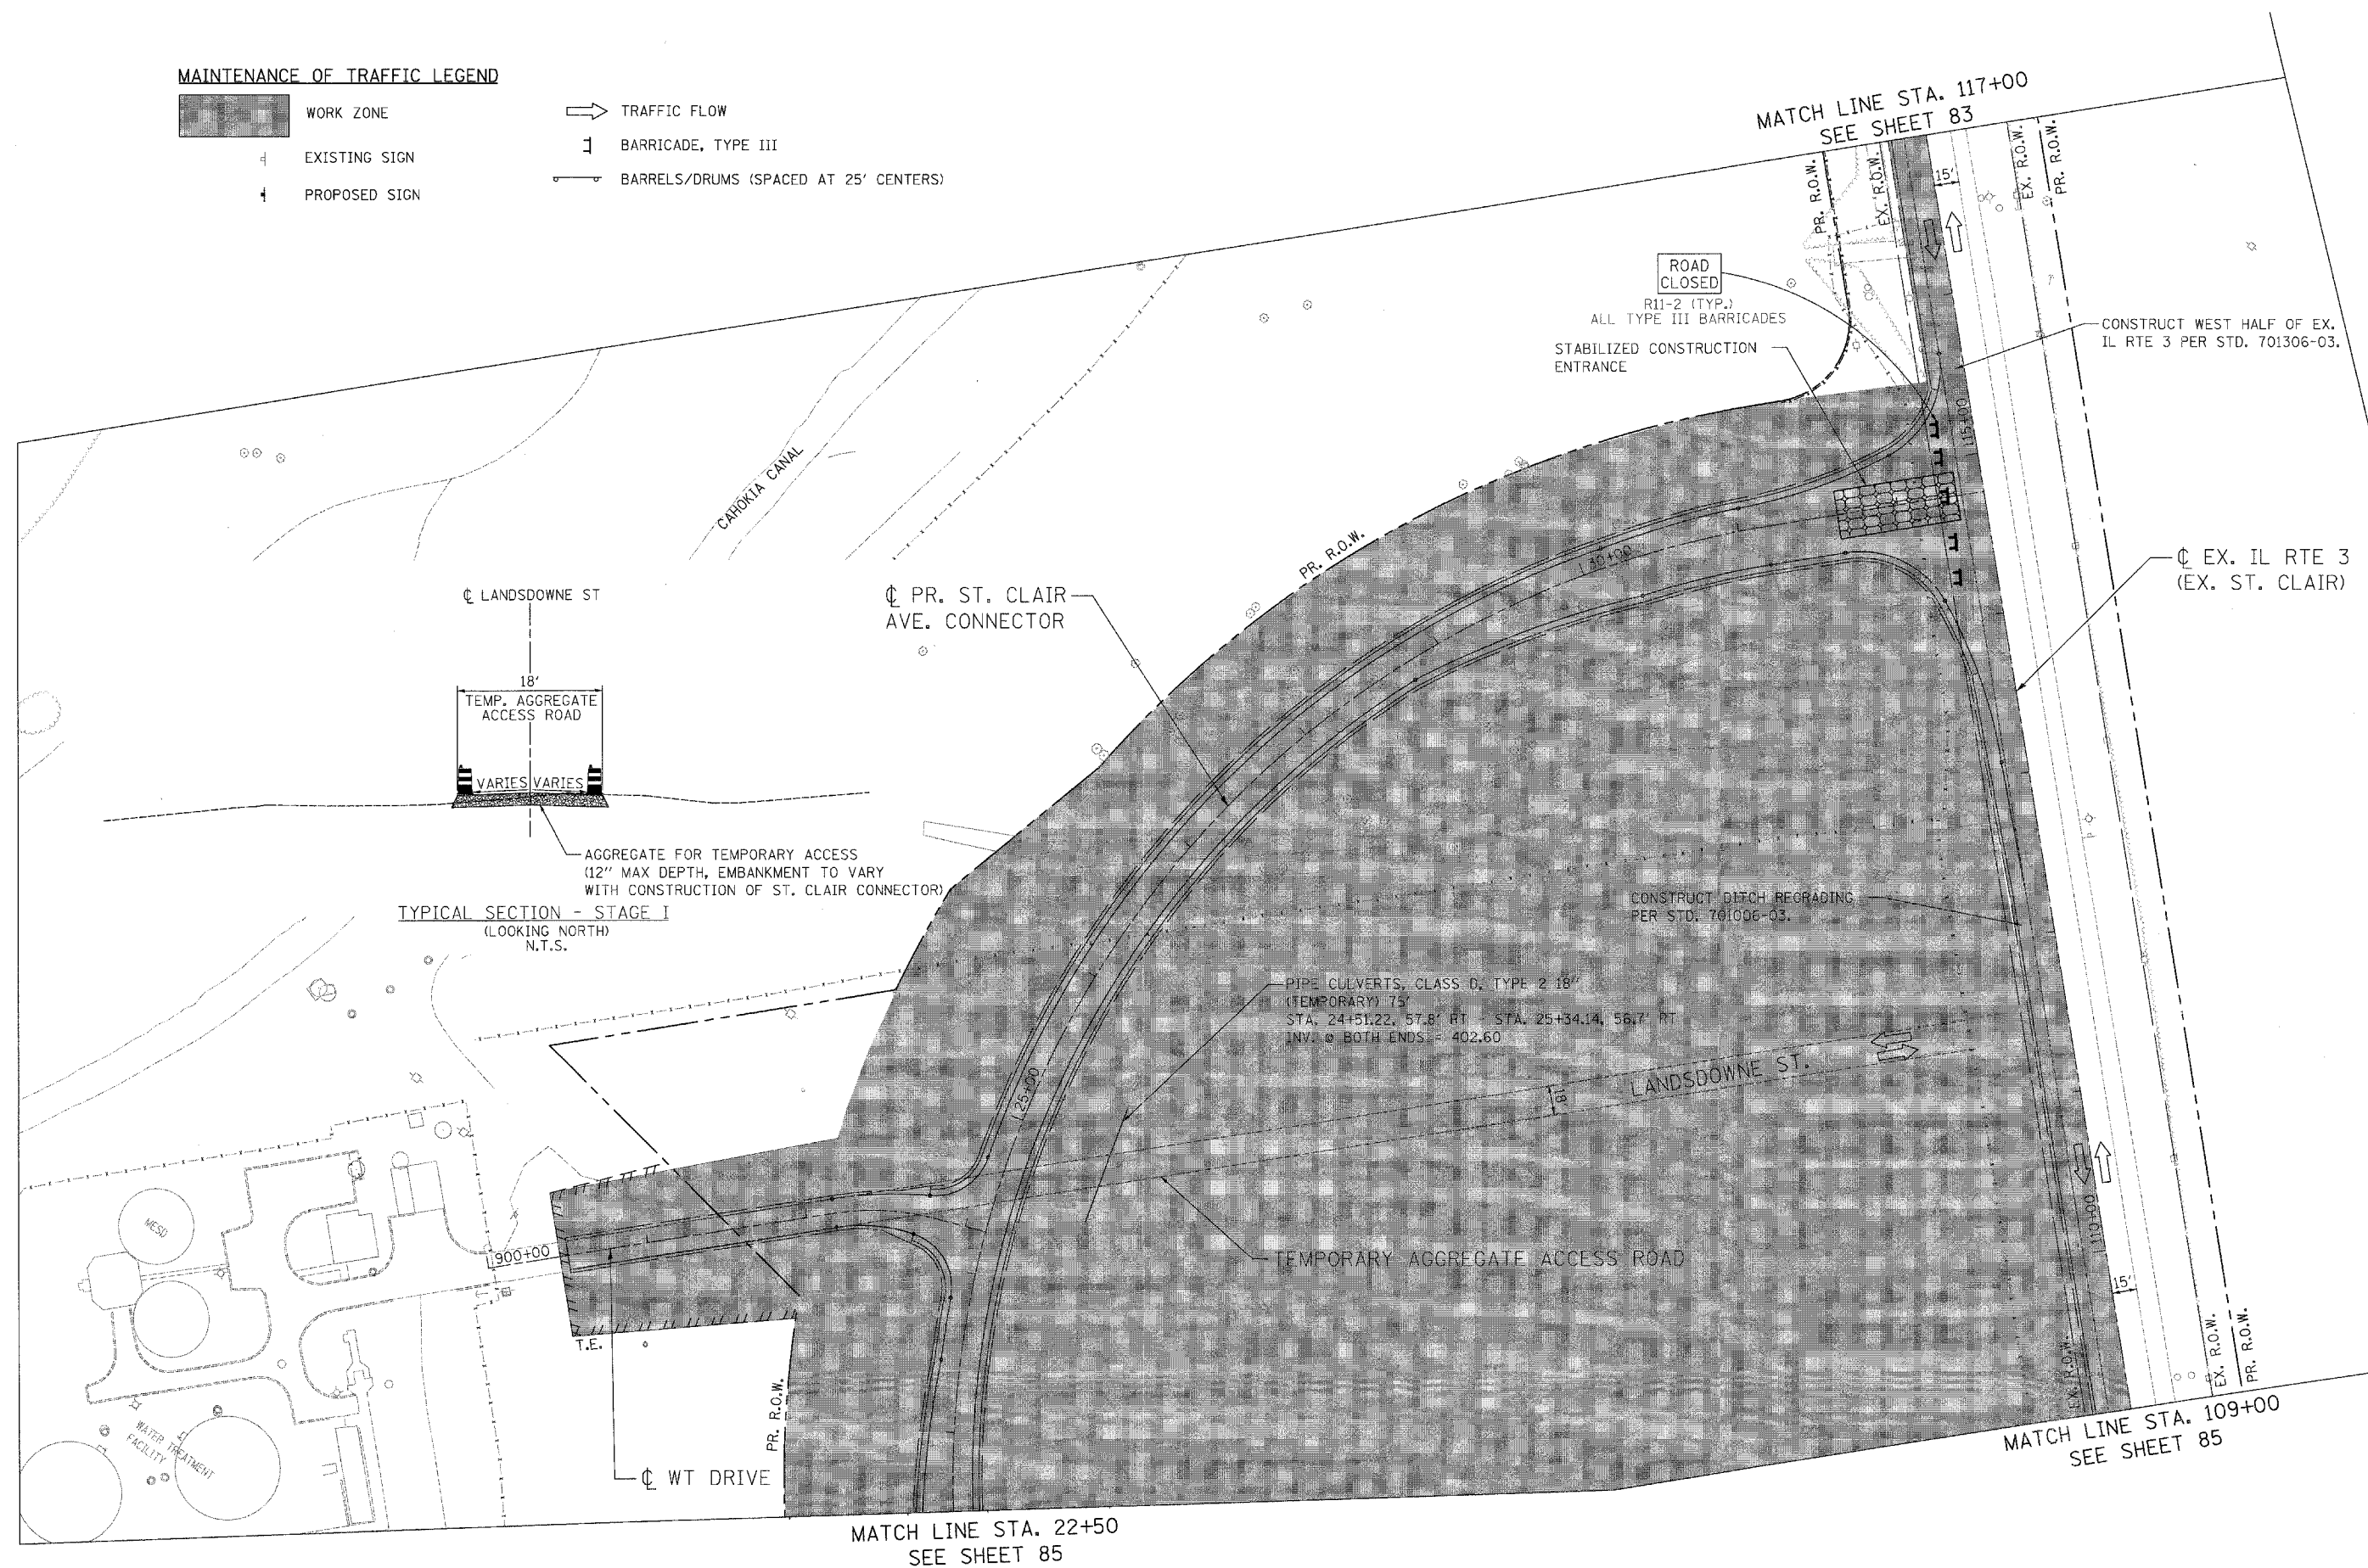

USER NAME = Plotted by Scott Wilkinson	DESIGNED - SEW	REVISED -
PLOT SCALE = 50,0000' / IN.	DRAWN - RK	REVISED -
PLOT DATE = 10/17/2011	CHECKED - ST	REVISED -
	DATE - 10/21/11	REVISED -


STATE OF ILLINOIS
DEPARTMENT OF TRANSPORTATION
 PROPOSED RELOCATED ILLINOIS ROUTE 3 INTERCHANGE

PR. ST. CLAIR AVE. CONNECTOR AND EX. IL RTE. 3 (ST. CLAIR AVE.)
MAINTENANCE OF TRAFFIC - STAGE 1
STA. 109+00 TO STA. 117+00


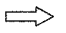
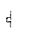



F.A.P. RTE.	SECTION	COUNTY	TOTAL SHEETS	SHEET NO.
998	82-2-1K	ST. CLAIR	353	84
FED. ROAD DIST. NO.			ILLINOIS FED. AID PROJECT	

SCALE: 1"=50' SHEET NO. 5 OF 15 SHEETS STA. TO STA.

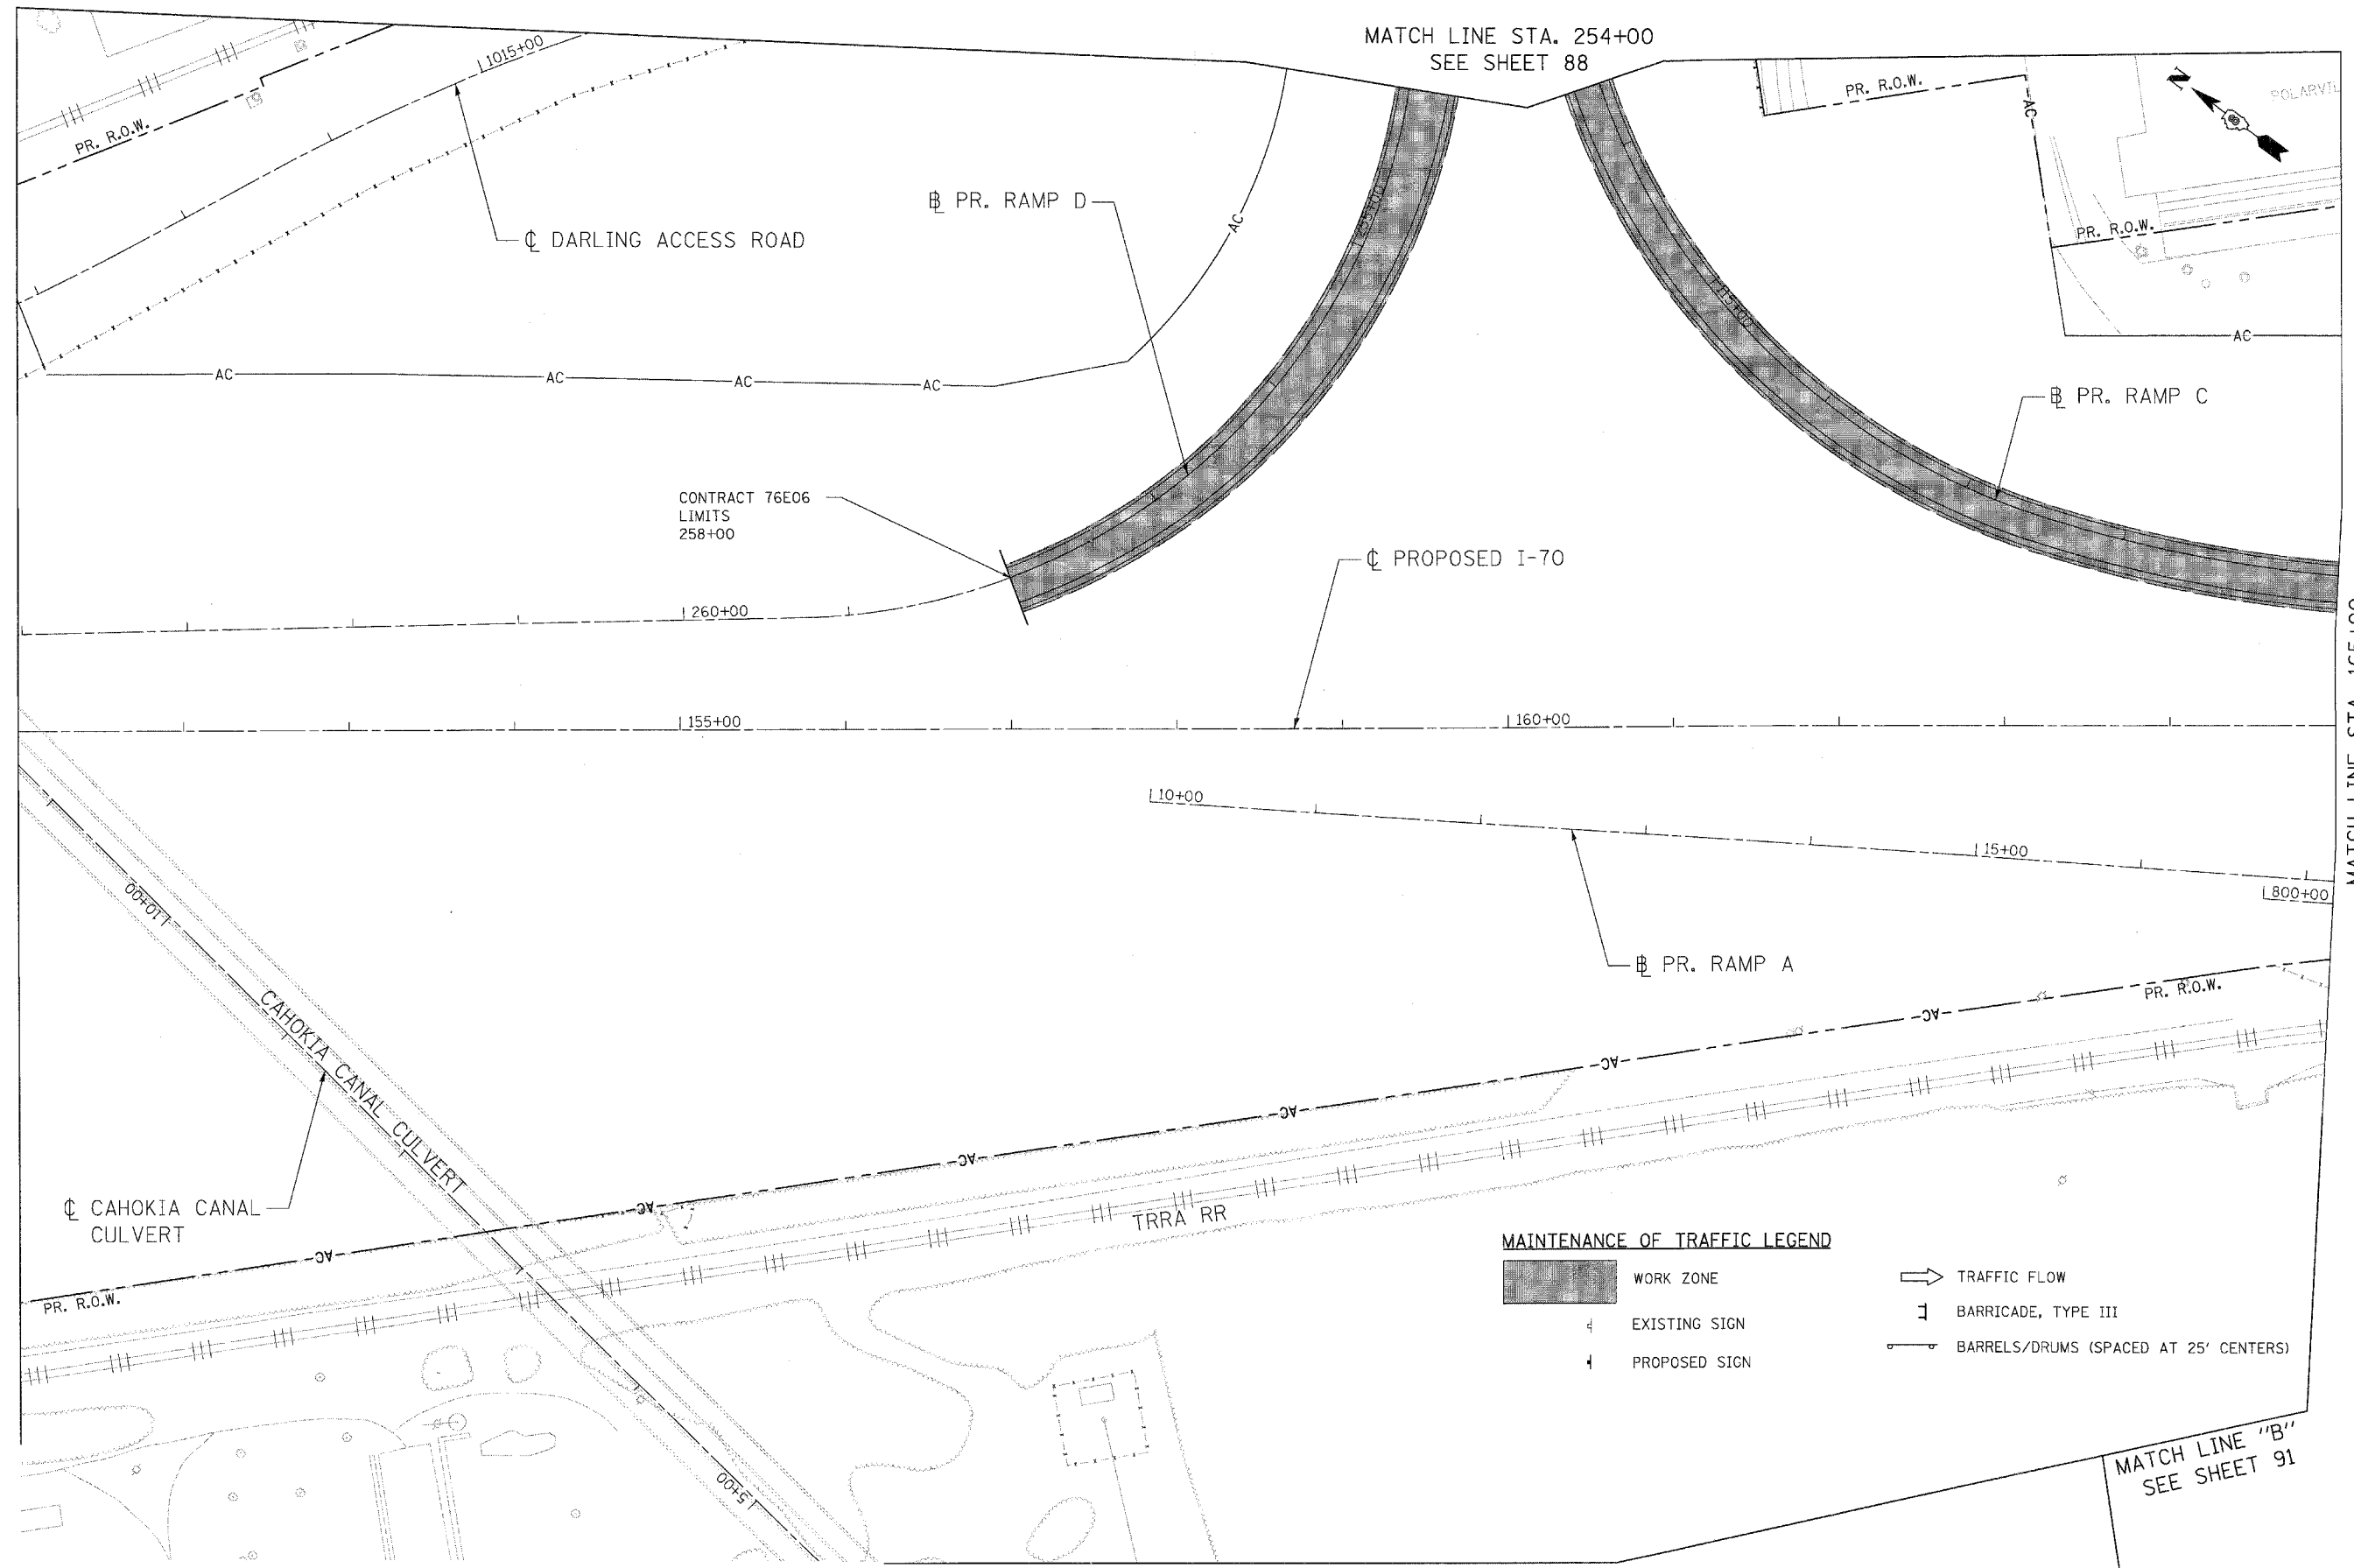
CONTRACT NO. 76E06



MAINTENANCE OF TRAFFIC LEGEND

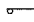-  WORK ZONE
-  TRAFFIC FLOW
-  EXISTING SIGN
-  PROPOSED SIGN
-  BARRICADE, TYPE III
-  BARRELS/DRUMS (SPACED AT 25' CENTERS)

MATCH LINE "A" SEE SHEET 90

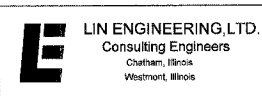

USER NAME = Plotted by Scott Wilkinson
 PLOT SCALE = 50,0000' / IN.
 PLOT DATE = 12/17/2011

DESIGNED - SEW
 DRAWN - RK
 CHECKED - ST
 DATE - 10/21/11

REVISED -
 REVISED -
 REVISED -
 REVISED -

STATE OF ILLINOIS
DEPARTMENT OF TRANSPORTATION
 PROPOSED RELOCATED ILLINOIS ROUTE 3 INTERCHANGE


RAMPS C AND D
MAINTENANCE OF TRAFFIC - STAGE 2
STA. 254 + 00 TO STA. 258 + 00, STA. 110 + 69 TO STA. 116 + 40
 SCALE: 1"=50' SHEET NO. 7 OF 15 SHEETS STA. TO STA.

F.A.P. RTE.	SECTION	COUNTY	TOTAL SHEETS	SHEET NO.
998	82-2-1K	ST. CLAIR	353	86
FED. ROAD DIST. NO.		ILLINOIS FED. AID PROJECT		

CONTRACT NO. 76E06

MATCH LINE STA. 1687+40
SEE SHEET 89

MATCH LINE STA. 165+00
SEE SHEET 86

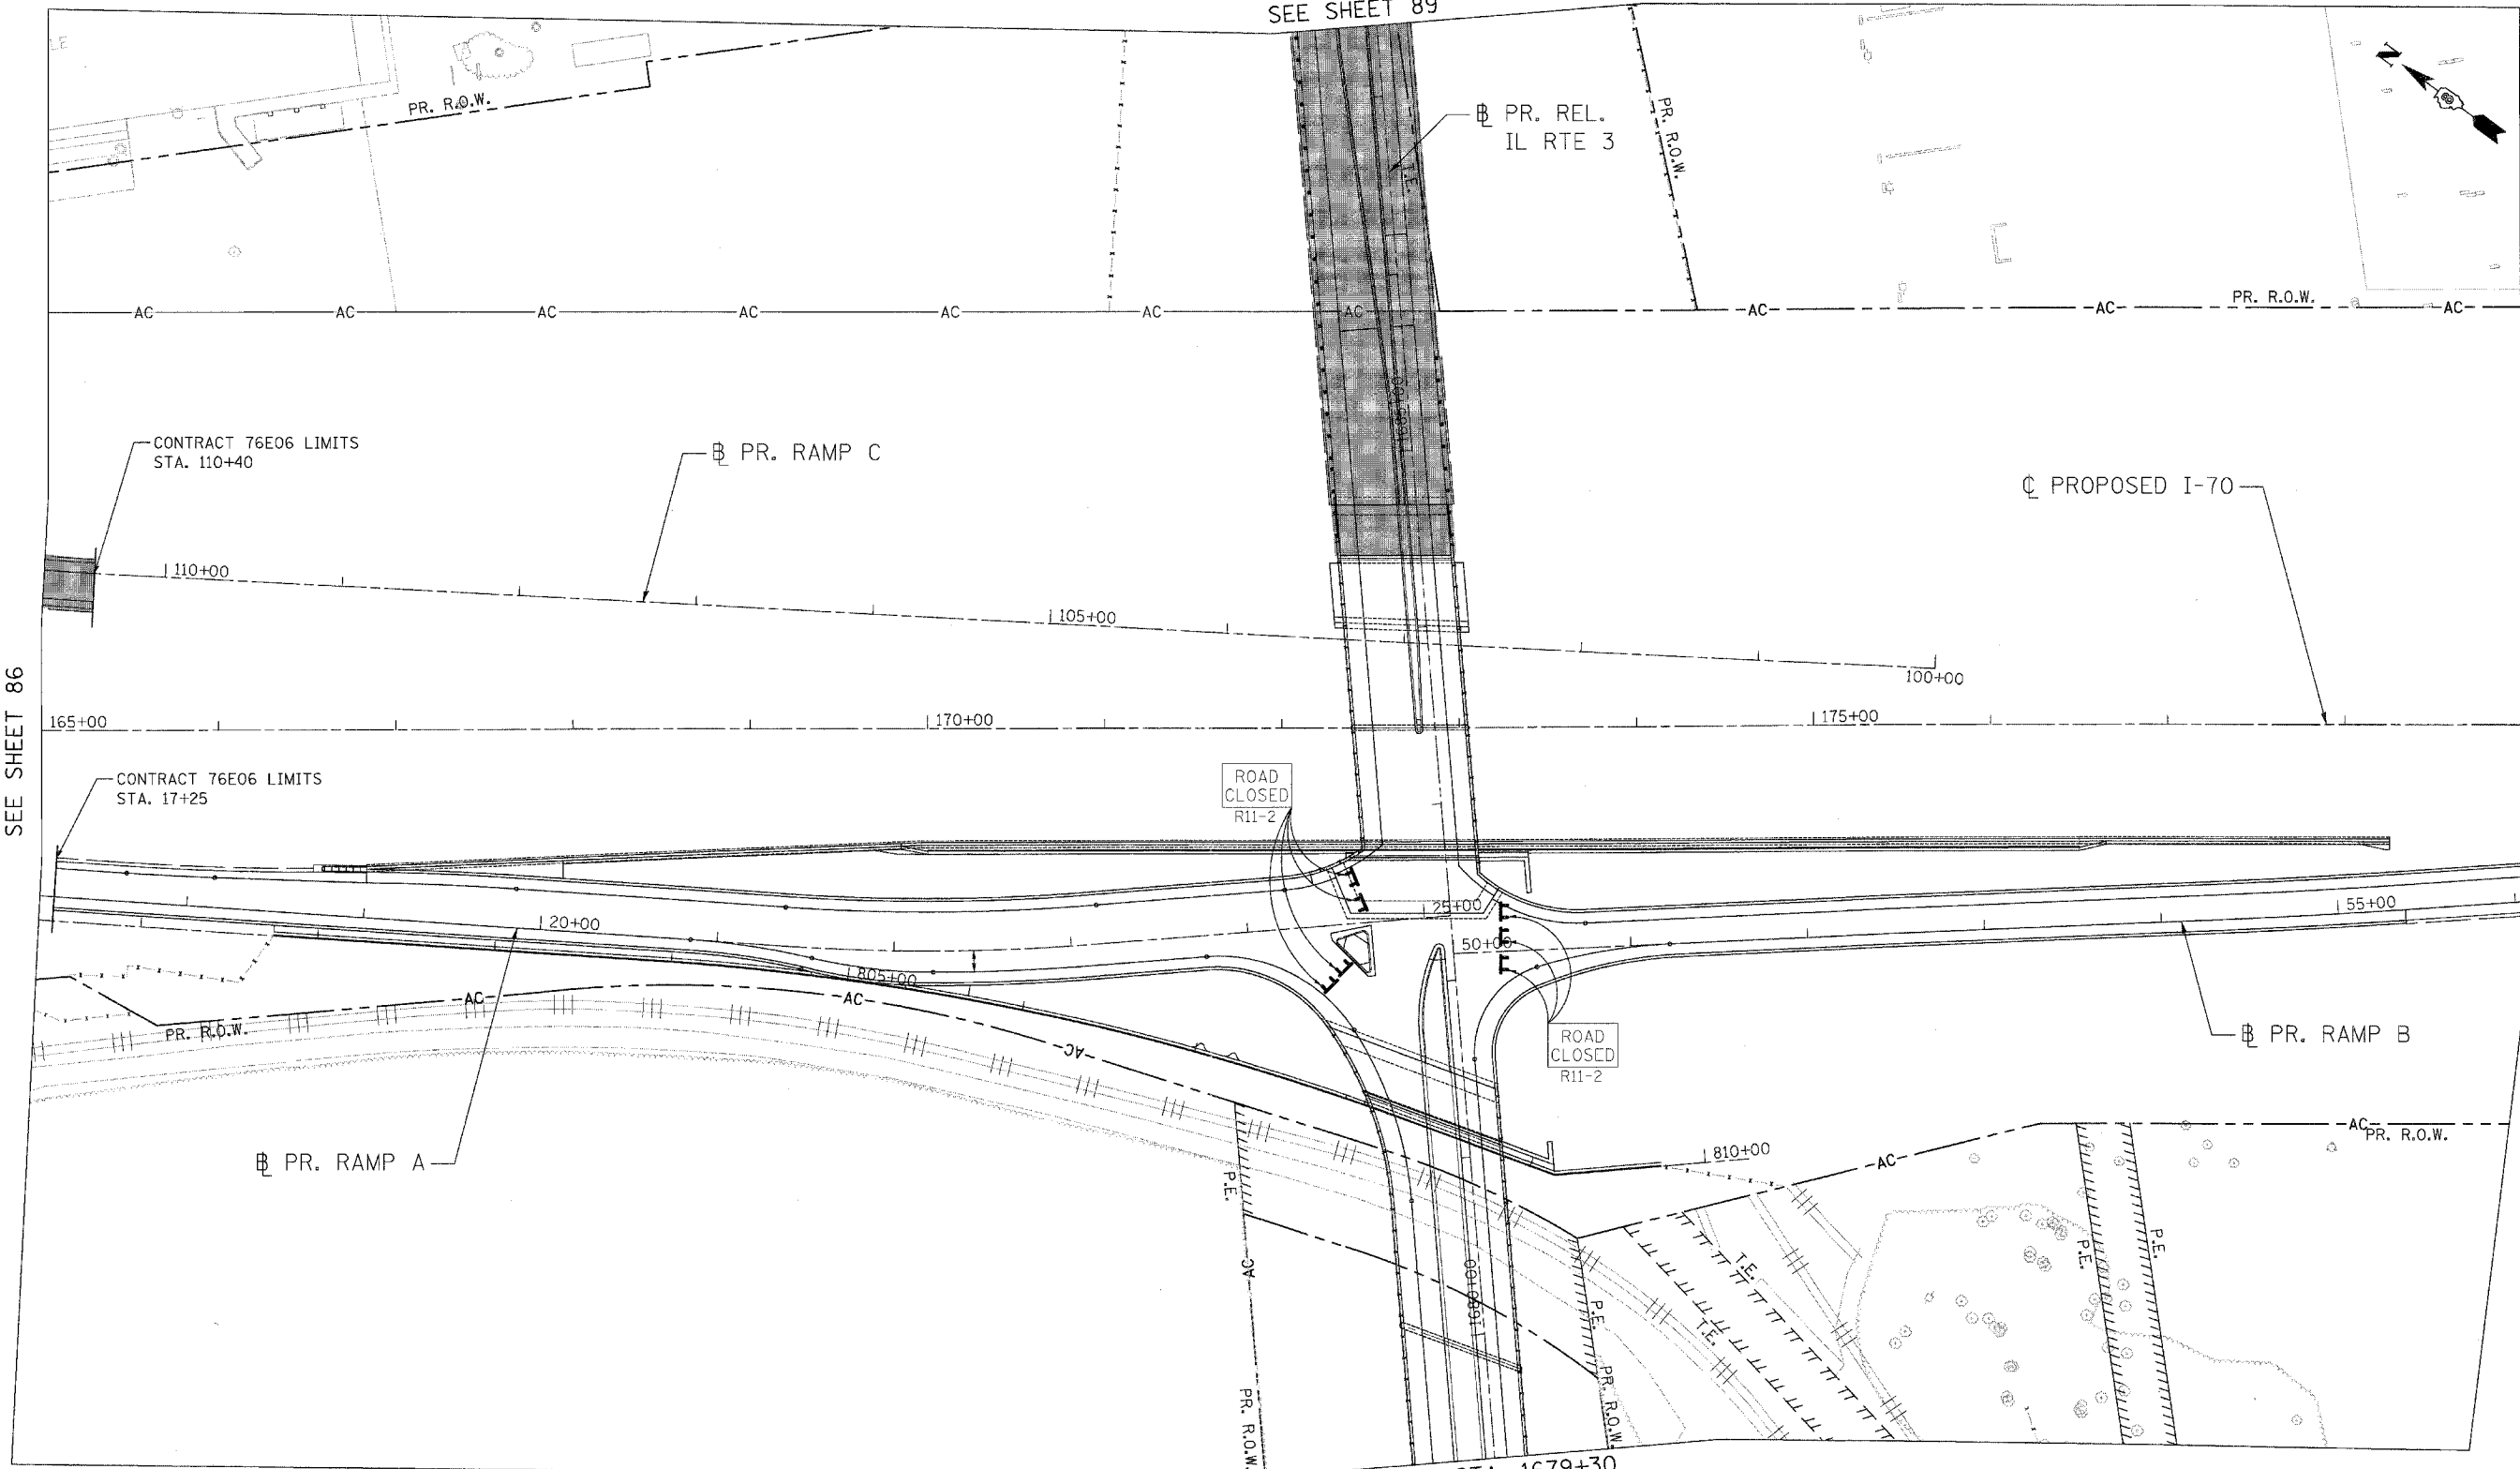

MAINTENANCE OF TRAFFIC LEGEND

- WORK ZONE
- TRAFFIC FLOW
- EXISTING SIGN
- BARRICADE, TYPE III
- PROPOSED SIGN
- BARRELS/DRUMS (SPACED AT 25' CENTERS)

MATCH LINE "C"
SEE SHEET 91

MATCH LINE STA. 1679+30
SEE SHEET 92



USER NAME = Plotted by Scott Wilkinson	DESIGNED - SEW	REVISED -
PLOT SCALE = 50.0000' / IN.	DRAWN - RK	REVISED -
PLOT DATE = 10/17/2011	CHECKED - ST	REVISED -
	DATE - 10/21/11	REVISED -

STATE OF ILLINOIS
DEPARTMENT OF TRANSPORTATION
PROPOSED RELOCATED ILLINOIS ROUTE 3 INTERCHANGE

REL. IL RTE. 3, RAMPS A AND B
MAINTENANCE OF TRAFFIC - STAGE 2
STA. 1679+30 TO STA. 1687+40

SCALE: 1"=50' SHEET NO. 8 OF 15 SHEETS STA. TO STA.


F.A.P. RTE.	SECTION	COUNTY	TOTAL SHEETS	SHEET NO.
998	B2-2-1K	ST. CLAIR	353	87
FED. ROAD DIST. NO.			ILLINOIS FED. AID PROJECT	

CONTRACT NO. 76E06

NOTES

1. PR. REL. IL RTE 3 WILL NOT BE OPEN UNTIL STAGE 3
2. FOR ALL SIGNS TO REMAIN, THE SIGNS SHALL REMAIN AFTER CONSTRUCTION IS COMPLETE UNLESS OTHERWISE DIRECTED BY THE ENGINEER.

* SIGNS SHOULD HAVE ZZ SHEETING

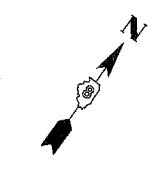


MATCH LINE STA. 22+50
SEE SHEET 91

MATCH LINE STA. 109+00
SEE SHEET 91

CONSTRUCT EAST HALF OF EX. IL RTE 3 PER STD. 701306-03.

CONSTRUCT DITCH REGRADING PER STD. 701006-03.

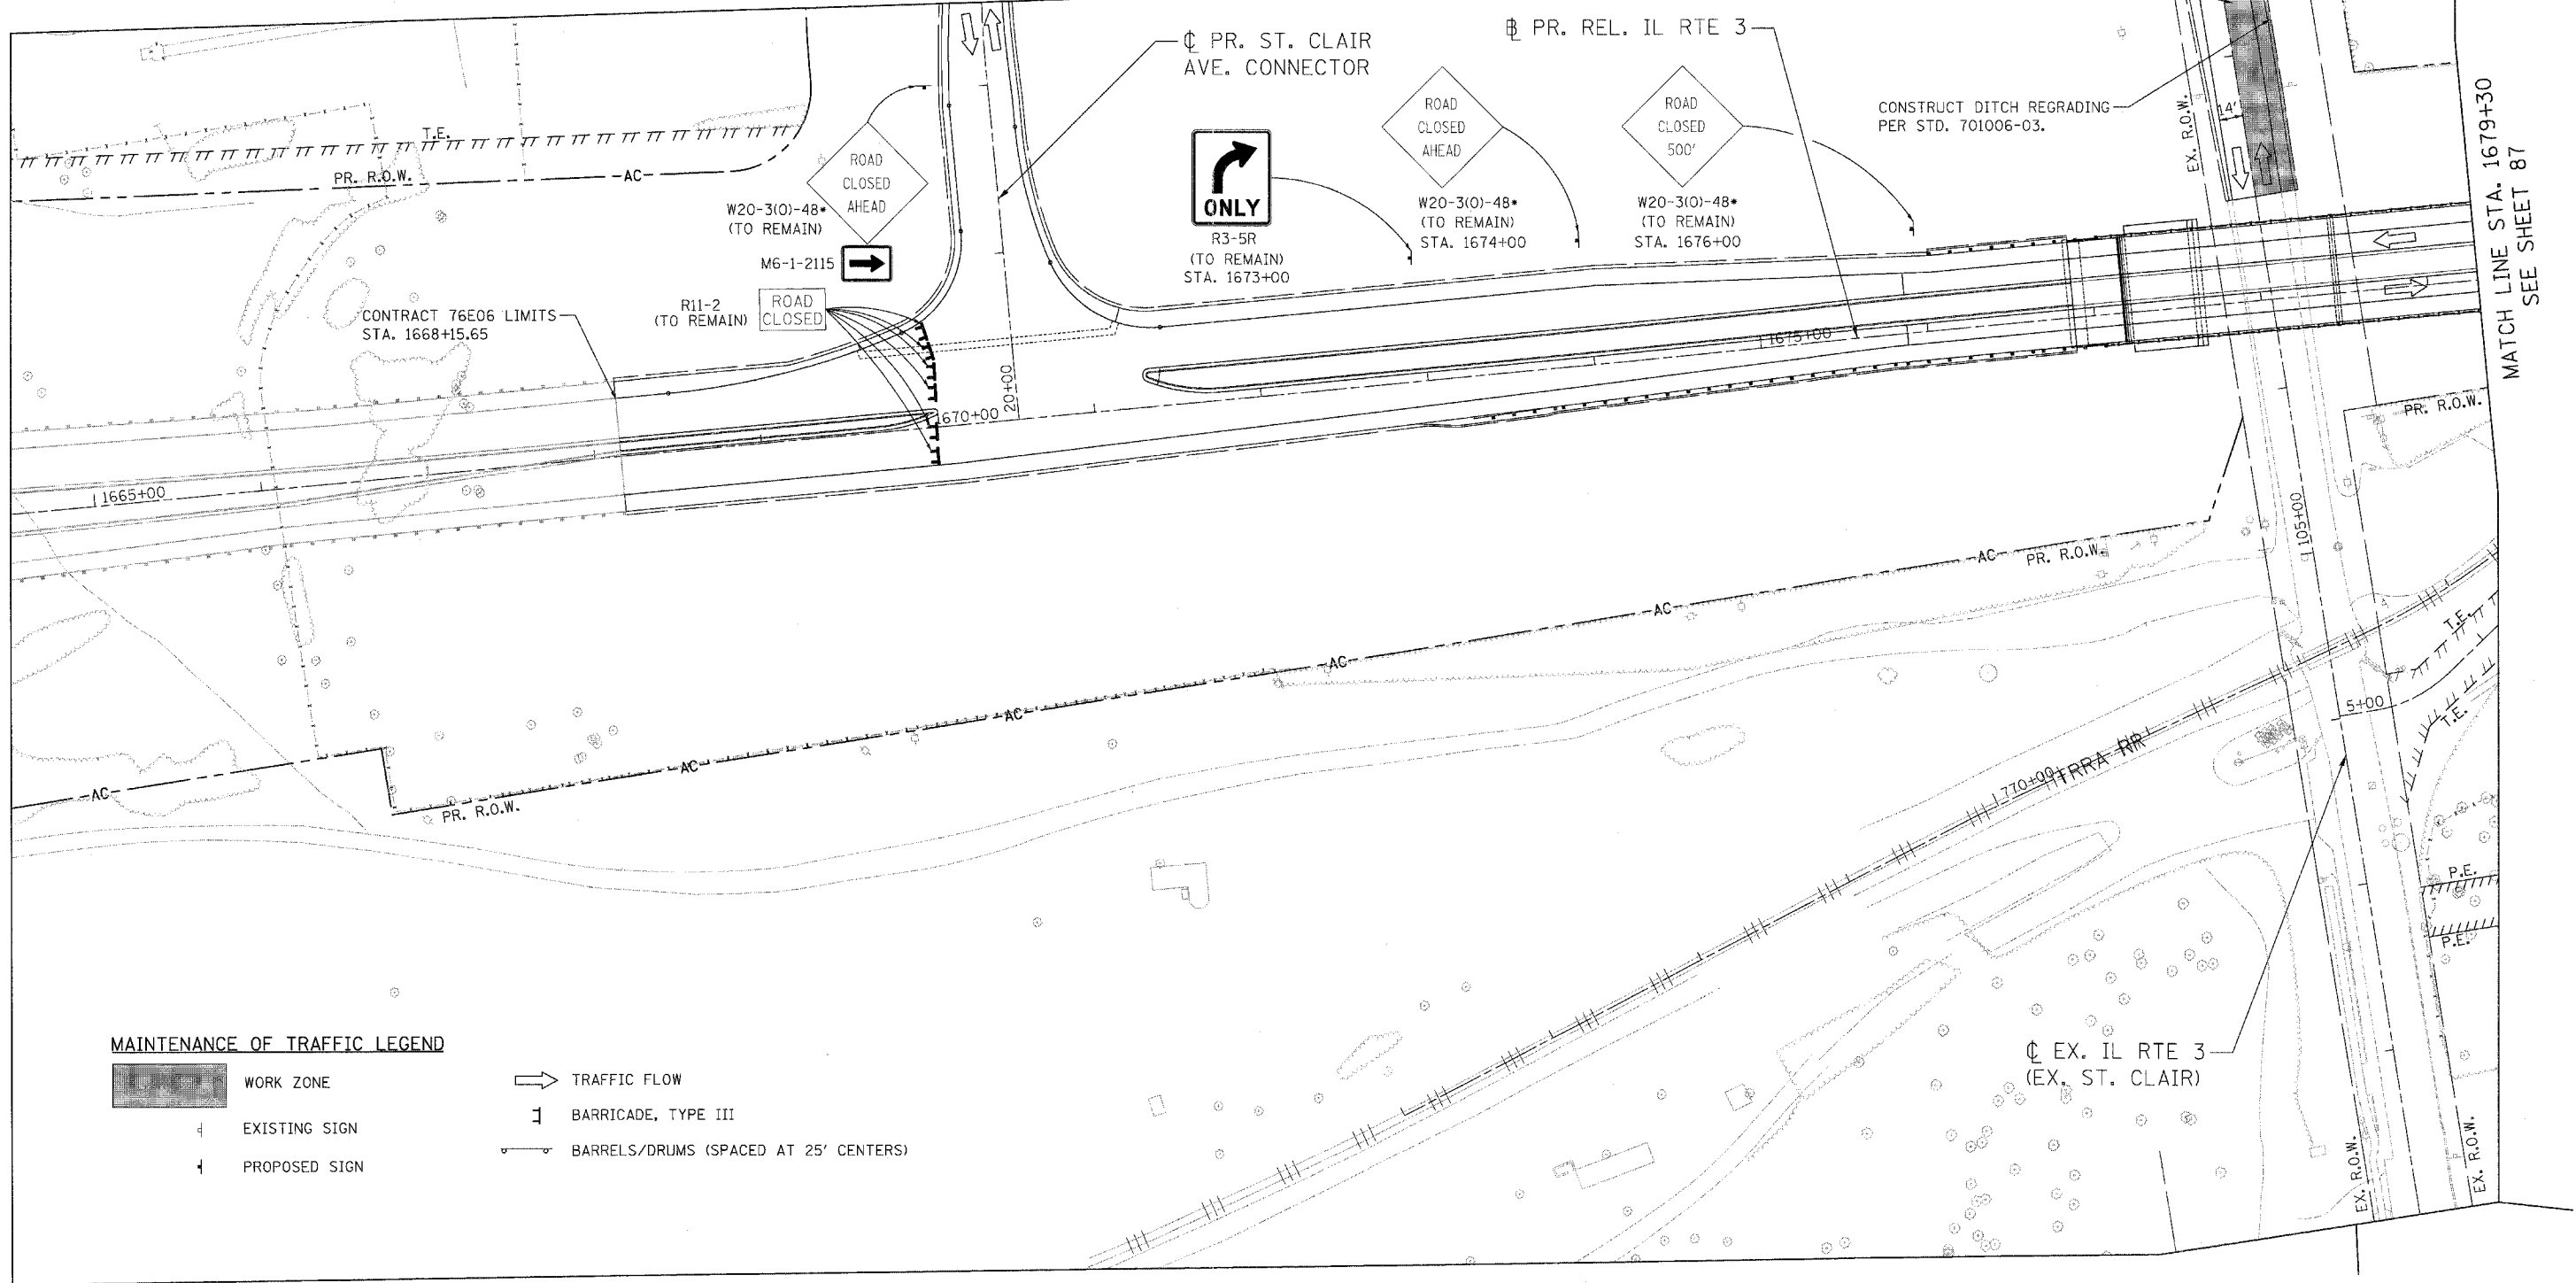

MAINTENANCE OF TRAFFIC LEGEND

- WORK ZONE
- TRAFFIC FLOW
- EXISTING SIGN
- PROPOSED SIGN
- BARRICADE, TYPE III
- BARRELS/DRUMS (SPACED AT 25' CENTERS)

11/18/2011 10:58:58 AM C:\Users\scottwilkinson\Documents\11182011\11182011.dwg 11/18/2011 10:58:58 AM




USER NAME = Plotted by Scott Wilkinson	DESIGNED - SEW	REVISED -
DRAWN - RK	CHECKED - ST	REVISED -
DATE - 10/21/11	REVISIONS	

STATE OF ILLINOIS
DEPARTMENT OF TRANSPORTATION
PROPOSED RELOCATED ILLINOIS ROUTE 3 INTERCHANGE

PR. REL. IL RTE. 3, PR. ST. CLAIR AVE. CONNECTOR AND EX. IL RTE. 3
MAINTENANCE OF TRAFFIC - STAGE 2
STA. 1665+00 TO STA. 1679+30

F.A.P. RTE.	SECTION	COUNTY	TOTAL SHEETS	SHEET NO.
998	82-2-1K	ST. CLAIR	353	92
FED. ROAD DIST. NO.			ILLINOIS FED. AID PROJECT	

SCALE: 1"=50' SHEET NO. 13 OF 15 SHEETS STA. TO STA. CONTRACT NO. 76E06

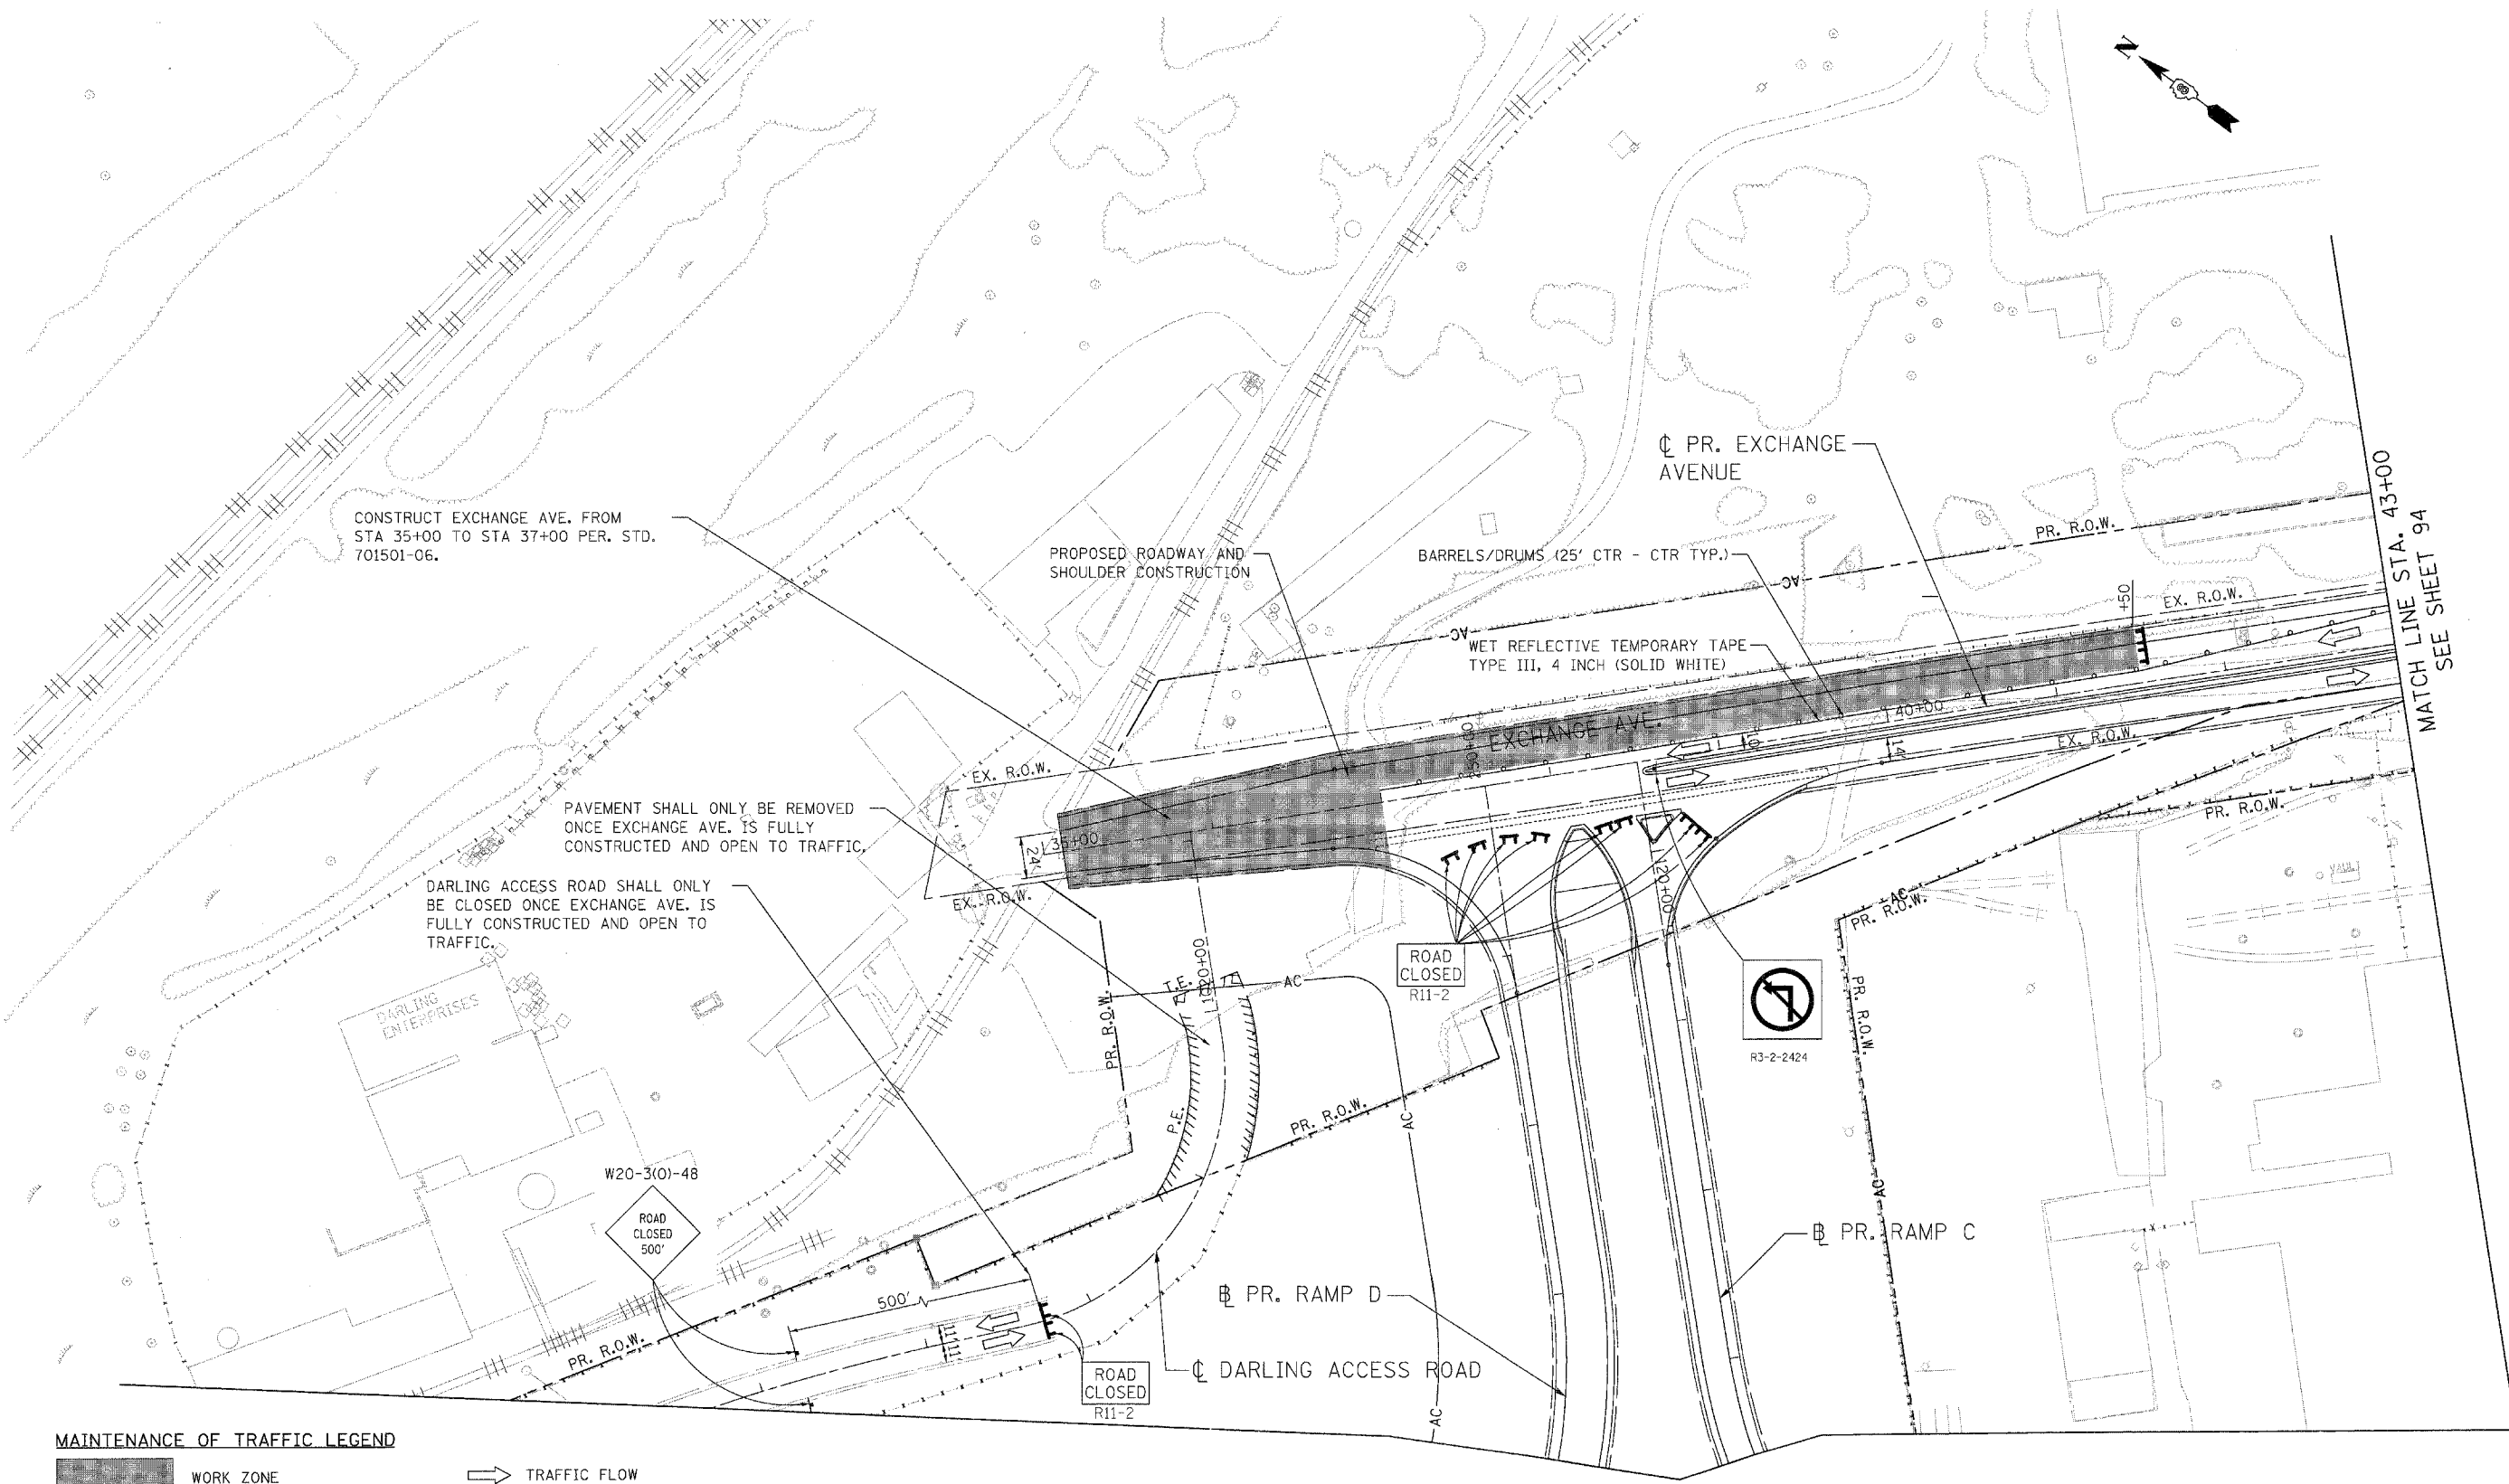

MAINTENANCE OF TRAFFIC LEGEND

- WORK ZONE
- TRAFFIC FLOW
- EXISTING SIGN
- PROPOSED SIGN
- BARRICADE, TYPE III
- BARRELS/DRUMS (SPACED AT 25' CENTERS)

LIN ENGINEERING, LTD.
 Consulting Engineers
 Chatham, Illinois
 Westmont, Illinois

USER NAME = Plotted by Scott Wilkinson	DESIGNED - SEW	REVISED -
--	----------------	-----------

AGGREGATE FOR TEMPORARY ACCESS

DESCRIPTION	VOLUME (CU YD)	VOLUME (TON)
TEMP ACCESS DRIVE STAGE 1	900	1701
EXCHANGE AVE ACCESS	250	473
TOTAL		2174

UNIT WEIGHT: 1.89TON/CY

PIPE CULVERTS, CLASS D, TYPE 2 18" (TEMPORARY)

ALIGNMENT	STATION	OFFSET	RT/LT	LENGTH (FT)
CONNECTOR	24+51	62	RT/LT	75
TOTAL				75

TRAFFIC CONTROL AND PROTECTION, STANDARD 701306

STAGES 1 & 2 EX. IL RTE. 3		L SUM
1		

TRAFFIC CONTROL AND PROTECTION, STANDARD 701501

STAGE 3 PR. EXCHANGE STA. 35+11 TO STA. 37+00		L SUM
1		

TRAFFIC CONTROL SURVEILLANCE

PROJECT LENGTH	30	CAL DA
ONCE PER WORK WEEK		

CHANGEABLE MESSAGE SIGN

JOB SITE	30	CAL MO
2 SIGNS AT 15 MONTHS EACH		

WORK ZONE PAVEMENT MARKING REMOVAL

PAY ITEM	LENGTH	WIDTH	AREA
	FT	FT	FT ²
70300210	N/A	N/A	478
70300220	39359	0.33	13120
70300250	460	0.66	304
70300260	1566	1	1566
70300280	371	2	742
X7030030	14326.52	0.33	4776
TOTAL			20985

DETOUR SIGNING

STAGES 1 & 2	1	L SUM

TEMPORARY PAVEMENT MARKING LETTERS AND SYMBOLS

AREA	DESC
15.6	ARROW
25.9	THRU AND TURN ARROW

ALIGNMENT	STATION	TYPE	AREA (SQ FT)
PR. EXCHANGE	38+87	LT	15.6
PR. EXCHANGE	41+34	LT	15.6
PR. EXCHANGE	43+86	LT	15.6
PR. EXCHANGE	45+58	LT	15.6
PR. EXCHANGE	48+00	RT	15.6
PR. EXCHANGE	49+76	RT	15.6
PR. EXCHANGE	51+27	LT	15.6
PR. EXCHANGE	52+80	LT	15.6
PR. REL. IL RTE. 3	1671+59	RT	15.6
PR. REL. IL RTE. 3	1672+27	RT	15.6
PR. REL. IL RTE. 3	1683+50	LT	15.6
PR. REL. IL RTE. 3	1685+18	LT	15.6
PR. REL. IL RTE. 3	1689+90	LT	15.6
PR. REL. IL RTE. 3	1689+90	RT	15.6
PR. REL. IL RTE. 3	1692+24	LT	15.6
PR. REL. IL RTE. 3	1692+24	RT	15.6
EX. IL RTE. 3	112+32	LT	15.6
EX. IL RTE. 3	114+32	LT	15.6
RAMP A	22+44	RT	15.6
RAMP A	22+44	LT	15.6
RAMP A	24+42	LT	15.6
RAMP A	24+35	RT	15.6
RAMP C	119+93	LT	15.6
CONNECTOR	31+12	RT	15.6
CONNECTOR	31+12	LT	15.6
CONNECTOR	31+87	RT	15.6
CONNECTOR	31+87	LT	15.6
CONNECTOR	20+85	LT	15.6
CONNECTOR	21+65	LT	15.6
TOTAL			452

WET REFLECTIVE TEMPORARY TAPE TYPE III, 4 INCH

TYPE	DESC
4SW	4" SOLID WHITE
4SY	4" SOLID YELLOW
4SDW	4" SKIP-DASH WHITE
4DY	4" DOUBLE YELLOW LINE

STAGE 1						
ALIGNMENT	STATION	OFFSET	STATION	OFFSET	TYPE	LENGTH (FT)
PR. EXCHANGE	39+69	LT	43+00	RT	4SW	330.50
PR. EXCHANGE	39+69	RT	50+15	LT	4DY	2092.00
PR. EXCHANGE	39+71	LT	43+00	RT	4SW	330.97
PR. EXCHANGE	43+00	RT	49+30	RT	4SW	630.50
PR. EXCHANGE	43+00	LT	55+00	LT	4SW	1328.56
PR. EXCHANGE	51+45	LT	55+39	LT	4DY	787.34
SUBTOTAL						5499.87

STAGE 2						
ALIGNMENT	STATION	OFFSET	STATION	OFFSET	TYPE	LENGTH (FT)
PR. EXCHANGE	35+55	LT	43+00	LT	4SW	746.09
PR. EXCHANGE	35+65	RT	43+00	LT	4SW	736.80
PR. EXCHANGE	35+65	RT	43+00	LT	4DY	1473.60
PR. EXCHANGE	43+00	LT	55+79	LT	4SW	1285.38
PR. EXCHANGE	43+00	LT	55+79	LT	4DY	2570.76
PR. EXCHANGE	43+00	LT	56+68	RT	4SW	1371.46
SUBTOTAL						8184.09

STAGE 3						
ALIGNMENT	STATION	OFFSET	STATION	OFFSET	TYPE	LENGTH (FT)
PR. EXCHANGE	37+00	LT	43+00	LT	4SW	599.92
PR. EXCHANGE	43+00	LT	43+42	LT	4SW	42.64
SUBTOTAL						642.56
TOTAL						14327

TEMPORARY PAVEMENT MARKING - LINE 12"

TYPE	DESC
12SW	12" SOLID WHITE
12SY	12" SOLID YELLOW

ALIGNMENT	STATION	OFFSET	RT/LT	STATION	OFFSET	RT/LT	TYPE	LENGTH (FT)
PR. EXCHANGE	35+42	N/A	N/A	37+78	N/A	N/A	12SY	140
PR. EXCHANGE	45+43	N/A	N/A	49+95	N/A	N/A	12SY	158
PR. EXCHANGE	51+19	N/A	N/A	56+11	N/A	N/A	12SY	152
PR. REL. IL RTE. 3	1671+35	N/A	N/A	1676+05	N/A	N/A	12SY	212
EX. IL RTE. 3	108+15	N/A	N/A	109+00	N/A	N/A	12SY	19
EX. IL RTE. 3	109+00	N/A	N/A	112+00	N/A	N/A	12SY	96
EX. IL RTE. 3	115+25	N/A	N/A	117+00	N/A	N/A	12SY	67
EX. IL RTE. 3	117+00	N/A	N/A	119+43	N/A	N/A	12SY	40
RAMP A	23+00	N/A	N/A	24+80	N/A	N/A	12SY	176
RAMP A	23+97	N/A	N/A	24+80	N/A	N/A	12SW	234
RAMP C	119+86	N/A	N/A	120+30	N/A	N/A	12SW	132
CONNECTOR	20+66	N/A	N/A	22+50	N/A	N/A	12SW	118
CONNECTOR	22+50	N/A	N/A	23+45	N/A	N/A	12SW	11
CONNECTOR	22+50	N/A	N/A	23+00	N/A	N/A	12SW	11
TOTAL								1566

TEMPORARY PAVEMENT MARKING - LINE 24"

TYPE	DESC
24SW	24" SOLID WHITE

ALIGNMENT	STATION	OFFSET	RT/LT	STATION	OFFSET	RT/LT	TYPE	LENGTH (FT)
PR. EXCHANGE	38+68	3.00	RT	38+68	23.00	LT	24SW	26
PR. EXCHANGE	49+89	9	RT	49+89	41.85	RT	24SW	33
PR. EXCHANGE	51+19	7.05	RT	51+19	23	LT	24SW	30
PR. REL. IL RTE. 3	1671+35	23	LT	1671+35	47.65	LT	24SW	25
PR. REL. IL RTE. 3	1681+19	20	RT	1682+07	5	LT	24SW	30
PR. REL. IL RTE. 3	1683+28	23.00	LT	1683+28	35.00	LT	24SW	12
PR. REL. IL RTE. 3	1683+41	11.00	LT	1683+41	23.00	LT	24SW	12
PR. REL. IL RTE. 3	1692+39	17	LT	1692+39	13.39	N/A	24SW	30
RAMP A	24+47	46.68	RT	24+56	20.64	RT	24SW	18
RAMP A	24+56	0	CL	24+56	22	LT	24SW	17
RAMP C	120+06	26.57	LT	120+15	10.47	LT	24SW	16
RAMP D	250+10	22	RT	250+44	37	RT	24SW	40
CONNECTOR	20+66	0	CL	20+77	37.91	LT	24SW	42
CONNECTOR	32+10	0	CL	32+00	36.77	RT	24SW	40
TOTAL								371

TEMPORARY PAVEMENT MARKING - LINE 8"

TYPE	DESC
8SW	8" SOLID WHITE

ALIGNMENT	STATION	OFFSET	RT/LT	STATION	OFFSET	RT/LT	TYPE	LENGTH (FT)
RAMP C	119+86	0.42	LT	120+30	50.20	RT	8SW	202
RAMP A	23+97	0	CL	24+60	23	RT	8SW	137
PR. REL. IL RTE. 3	1681+62	35	LT	1682+36	35	LT	8SW	121
TOTAL								460


TEMPORARY PAVEMENT

ALIGNMENT	STATION	OFFSET	RT/LT	STATION	OFFSET	RT/LT	AREA (SQ YD)
PR. EXCHANGE	39+76	N/A	LT	41+50	N/A	N/A	253.46
TOTAL							253


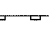

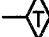
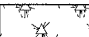

TEMPORARY PAVEMENT MARKING - LINE 4"

TYPE	DESC
4SW	4" SOLID WHITE
4SY	4" SOLID YELLOW
4SDW	4" SKIP-DASH WHITE
4DY	4" DOUBLE YELLOW LINE

ALIGNMENT	STATION	OFFSET	RT/LT	STATION	OFFSET	RT/LT	TYPE	LENGTH (FT)
EX. IL RTE. 3	107+15	0	CL	112+20	5	RT	4DY	1010
EX. IL RTE. 3	107+15	14	LT	112+29	14	LT	4SW	514
EX. IL RTE. 3	107+15	0	CL	114+50	2	LT	4DY	1470
EX. IL RTE. 3	107+15	15	RT	119+43	15	RT	4SW	1228
EX. IL RTE. 3	110+65	11	RT	112+21	10	RT	4SDW	38
EX. IL RTE. 3	112+21	10	RT	114+50	10	RT	4SW	229
EX. IL RTE. 3	115+26	2	RT	119+43	0	CL	4DY	834
EX. IL RTE. 3	115+26	2	LT	119+43	0	LT	4DY	348
EX. IL RTE. 3	115+64	14	LT	119+43	14.68	LT	4SW	379
PR. EXCHANGE	35+14	0	LT	37+78	6	RT	4DY	528
PR. EXCHANGE	35+14	12	LT	55+44	23	LT	4SW	2030
PR. EXCHANGE	35+14	12	RT	254+00	22	RT	4SW	869
PR. EXCHANGE	35+44	0	RT	37+78	6	RT	4DY	468
PR. EXCHANGE	38+55	4	RT	43+00	4	RT	4SY	445
PR. EXCHANGE	38+55	8	RT	43+00	8	RT	4SY	445
PR. EXCHANGE	38+68	9	LT	44+00	9	LT	4SW	532
PR. EXCHANGE	43+00	3	RT	44+15	3	RT	4SY	115
PR. EXCHANGE	43+00	9	RT	44+15	9	RT	4SY	115
PR. EXCHANGE	43+00	23	RT	1692+39	5	LT	4SW	503
PR. EXCHANGE	45+43	9	LT	46+58	9	LT	4SW	115
PR. EXCHANGE	45+43	6	RT	49+95	5	RT	4DY	904
PR. EXCHANGE	45+43	6	RT	49+95	5	RT	4DY	904
PR. EXCHANGE	45+43	23	RT	1687+40	35	LT	4SW	1009
PR. EXCHANGE	46+54	23	RT	47+90	23	RT	4SDW	34
PR. EXCHANGE	46+58	9	LT	47+91	10	LT	4SDW	32
PR. EXCHANGE	47+90	23	RT	49+89	23	RT	4SW	199
PR. EXCHANGE	51+19	9	LT	52+93	9	LT	4SW	174
PR. EXCHANGE	51+19	9	RT	56+11	1	RT	4DY	984
PR. EXCHANGE	51+19	9	RT	56+11	1	LT	4DY	984
PR. EXCHANGE	52+93	9	LT	54+00	10	LT	4SDW	27
PR. REL. IL RTE. 3	1669+89	23	RT	56+00	0	CL	4SW	1796
PR. REL. IL RTE. 3	1671+35	35	LT	1676+05	23	LT	4SY	470
PR. REL. IL RTE. 3	1671+35	5	LT	1682+21	5	LT	4SY	1086
PR. REL. IL RTE. 3	1671+35	23	LT	1682+21	23	LT	4SY	1086
PR. REL. IL RTE. 3	1682+64	7	RT	55+40	20	RT	4SW	1444
PR. REL. IL RTE. 3	1682+75	35	LT	1687+40	35	LT	4SW	465
PR. REL. IL RTE. 3	1683+28	23	LT	1685+28	23	LT	4SW	200
PR. REL. IL RTE. 3	1685+28	23	LT	1687+28	23	LT	4SDW	50
PR. REL. IL RTE. 3	1683+43	11	LT	1692+42	23	LT	4SY	899
PR. REL. IL RTE. 3	1683+43	7	LT	1692+42	5	LT	4SY	899
PR. REL. IL RTE. 3	1687+78	5	LT	1689+78	5	LT	4SDW	50

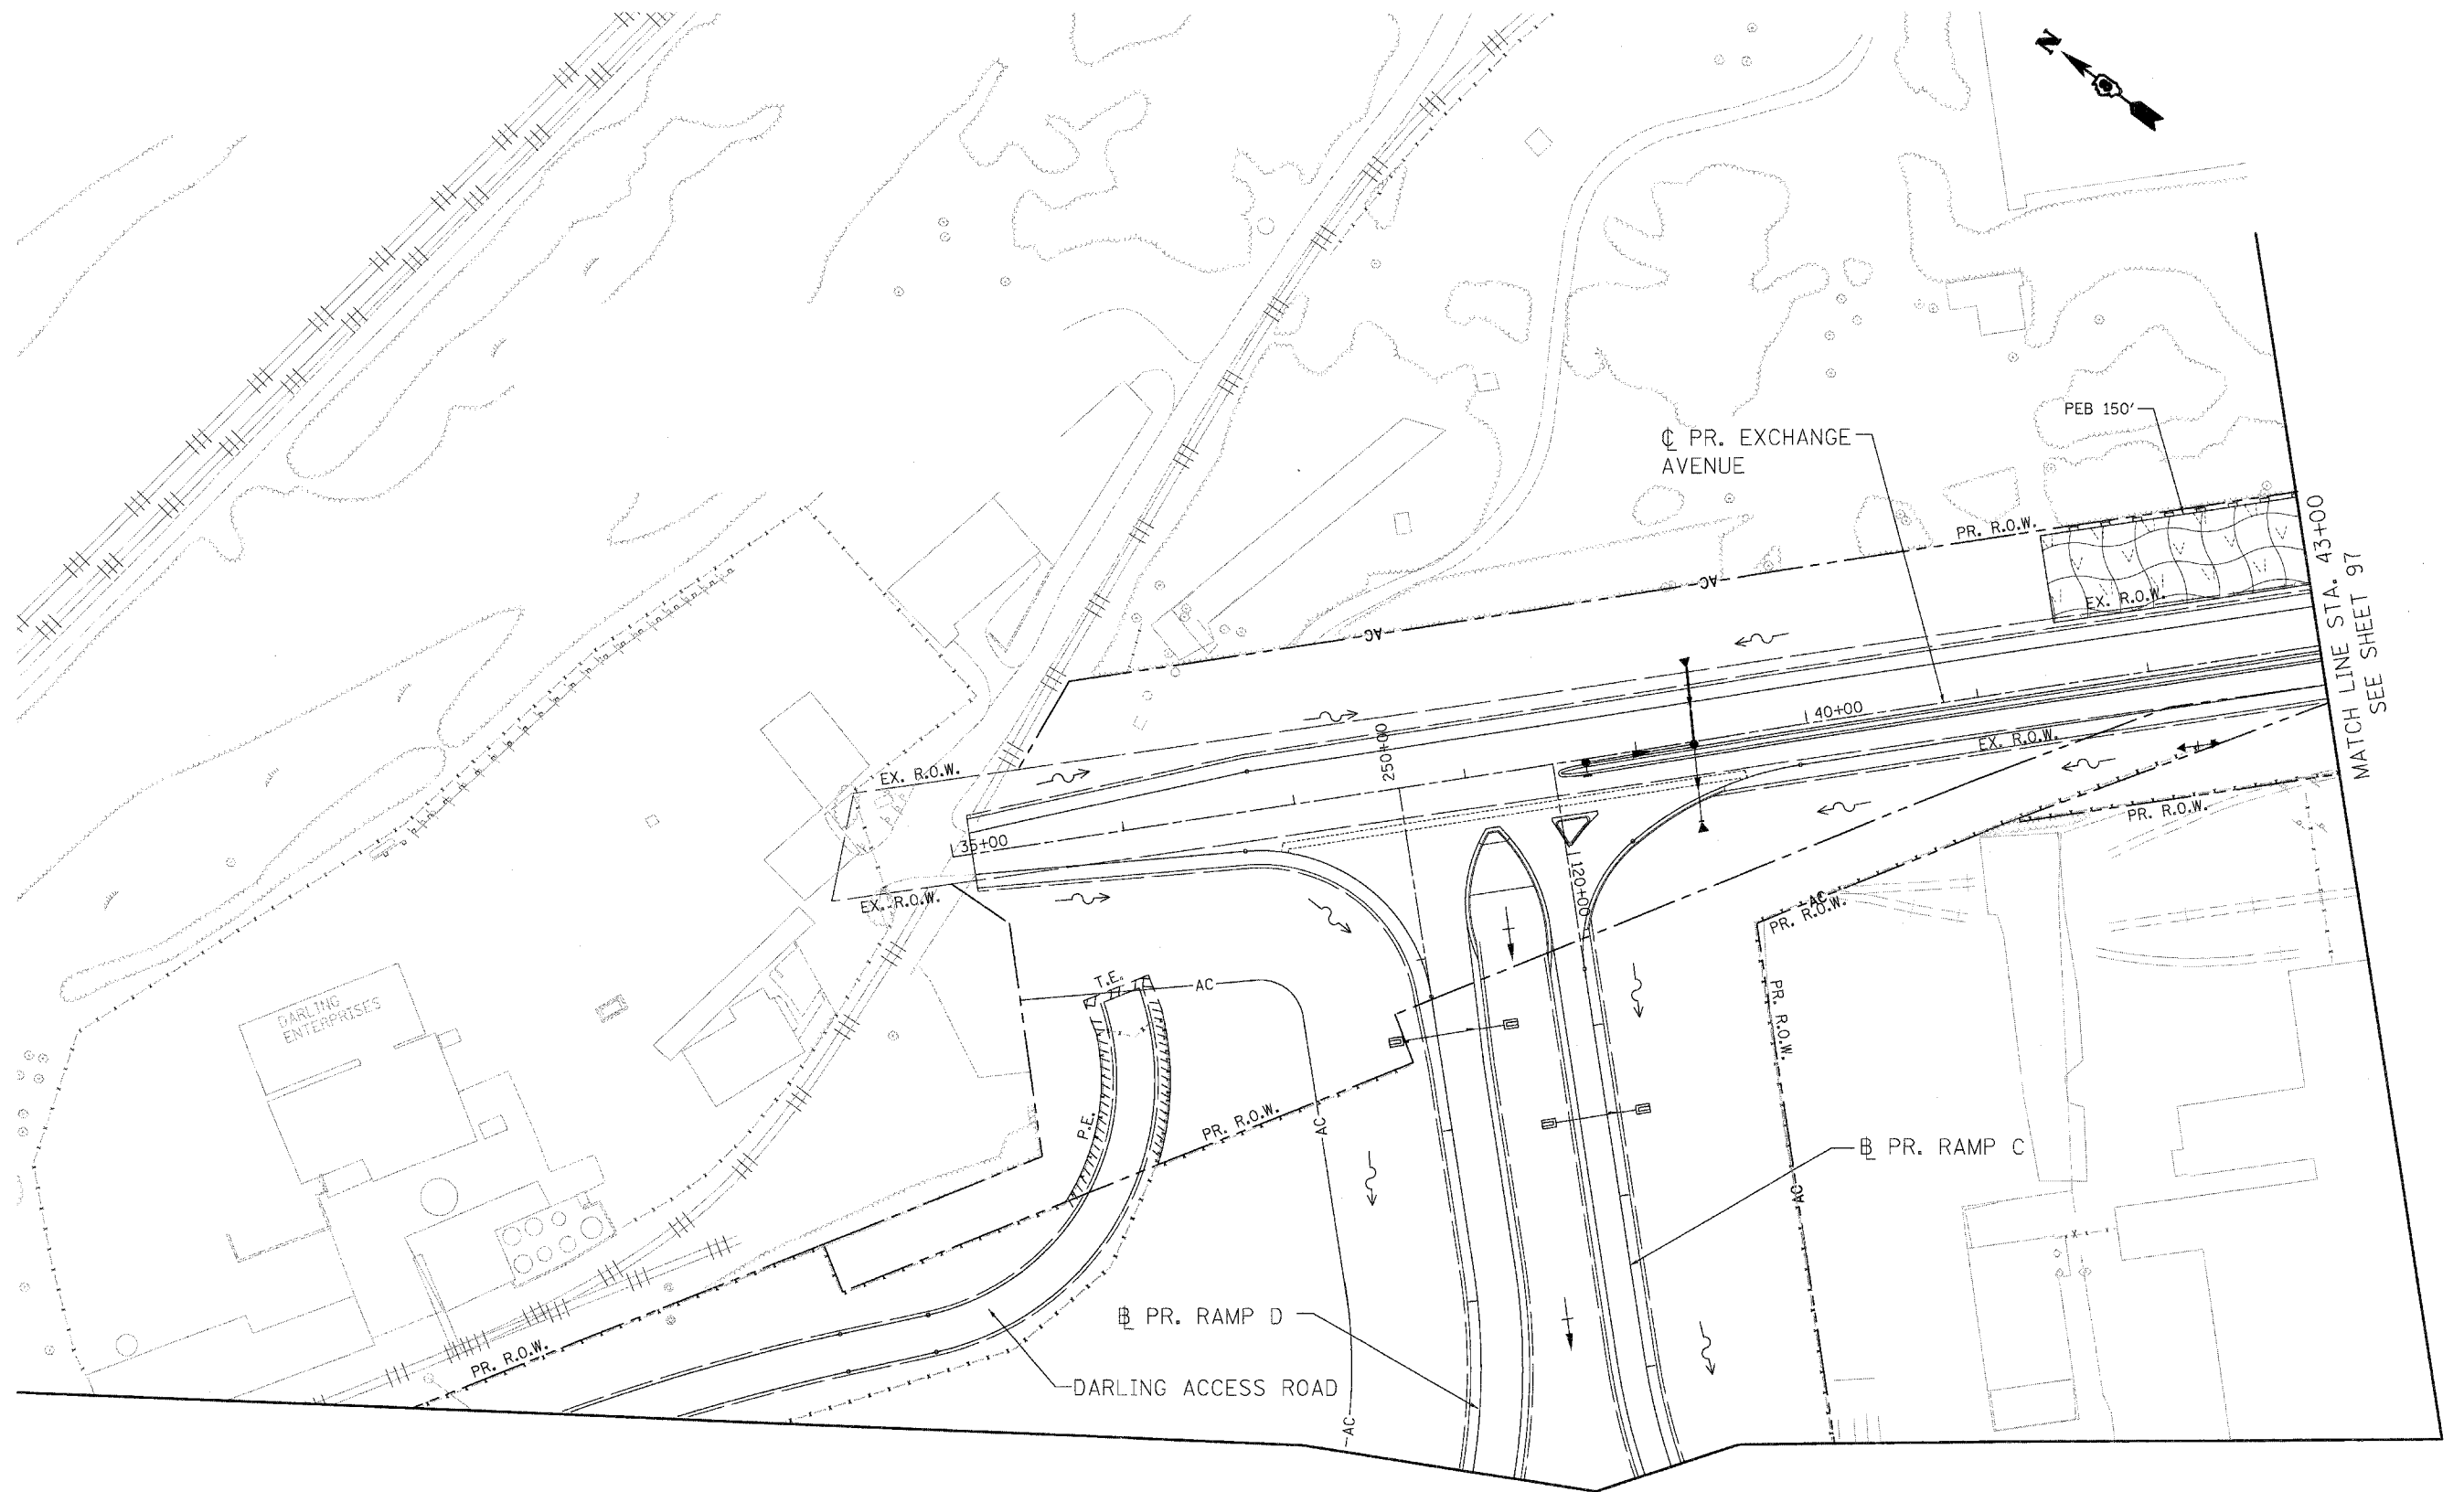

EROSION CONTROL LEGEND

- 
INLET FILTERS/INLET & PIPE PROTECTION
 PERIMETER EROSION BARRIER (PEB)
- 
TEMPORARY EROSION CONTROL SEEDING/
EROSION CONTROL BLANKET
 TEMPORARY DITCH CHECK
- 
TEMPORARY EROSION CONTROL SEEDING/
MULCH, METHOD 2
 STABILIZED CONSTRUCTION ENTRANCE

GENERAL NOTE:

1. ONCE TEMPORARY EROSION CONTROL IS PLACED FOR A STAGE IT SHALL REMAIN IN PLACE UNTIL COMPLETION OF CONSTRUCTION OR UNTIL PERMANENT LANDSCAPING MEASURES ARE INSTALLED (BY OTHERS). INLET FILTERS SHALL REMAIN IN PLACE UNTIL PERMANENT LANDSCAPING ITEMS ARE INSTALLED.

LIN ENGINEERING, LTD.
 Consulting Engineers
 Chatham, Illinois
 Westmont, Illinois

USER NAME = Plotted by Scott Wilkinson	DESIGNED - AS	REVISED -
PLOT SCALE = 50.0000' / 1" =	DRAWN - AS	REVISED -
PLOT DATE = 10/17/2011	CHECKED - ST	REVISED -
	DATE - 10/21/11	REVISED -

**STATE OF ILLINOIS
 DEPARTMENT OF TRANSPORTATION**
 PROPOSED RELOCATED ILLINOIS ROUTE 3 INTERCHANGE


**PR. EXCHANGE AVE., RAMPS C AND D
 EROSION CONTROL PLANS - STAGE 1
 STA. 35+00 TO STA. 43+00**

SCALE: 1"=50' SHEET NO. 1 OF 13 SHEETS STA. TO STA.


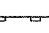
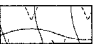
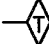
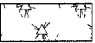

F.A.P. RTE.	SECTION	COUNTY	TOTAL SHEETS	SHEET NO.
998	82-2-1K	ST. CLAIR	353	96
FED. ROAD DIST. NO. ILLINOIS FED. AID PROJECT			CONTRACT NO. 76E06	

MATCH LINE STA. 43+00
SEE SHEET 97

MATCH LINE STA. 43+00
SEE SHEET 96

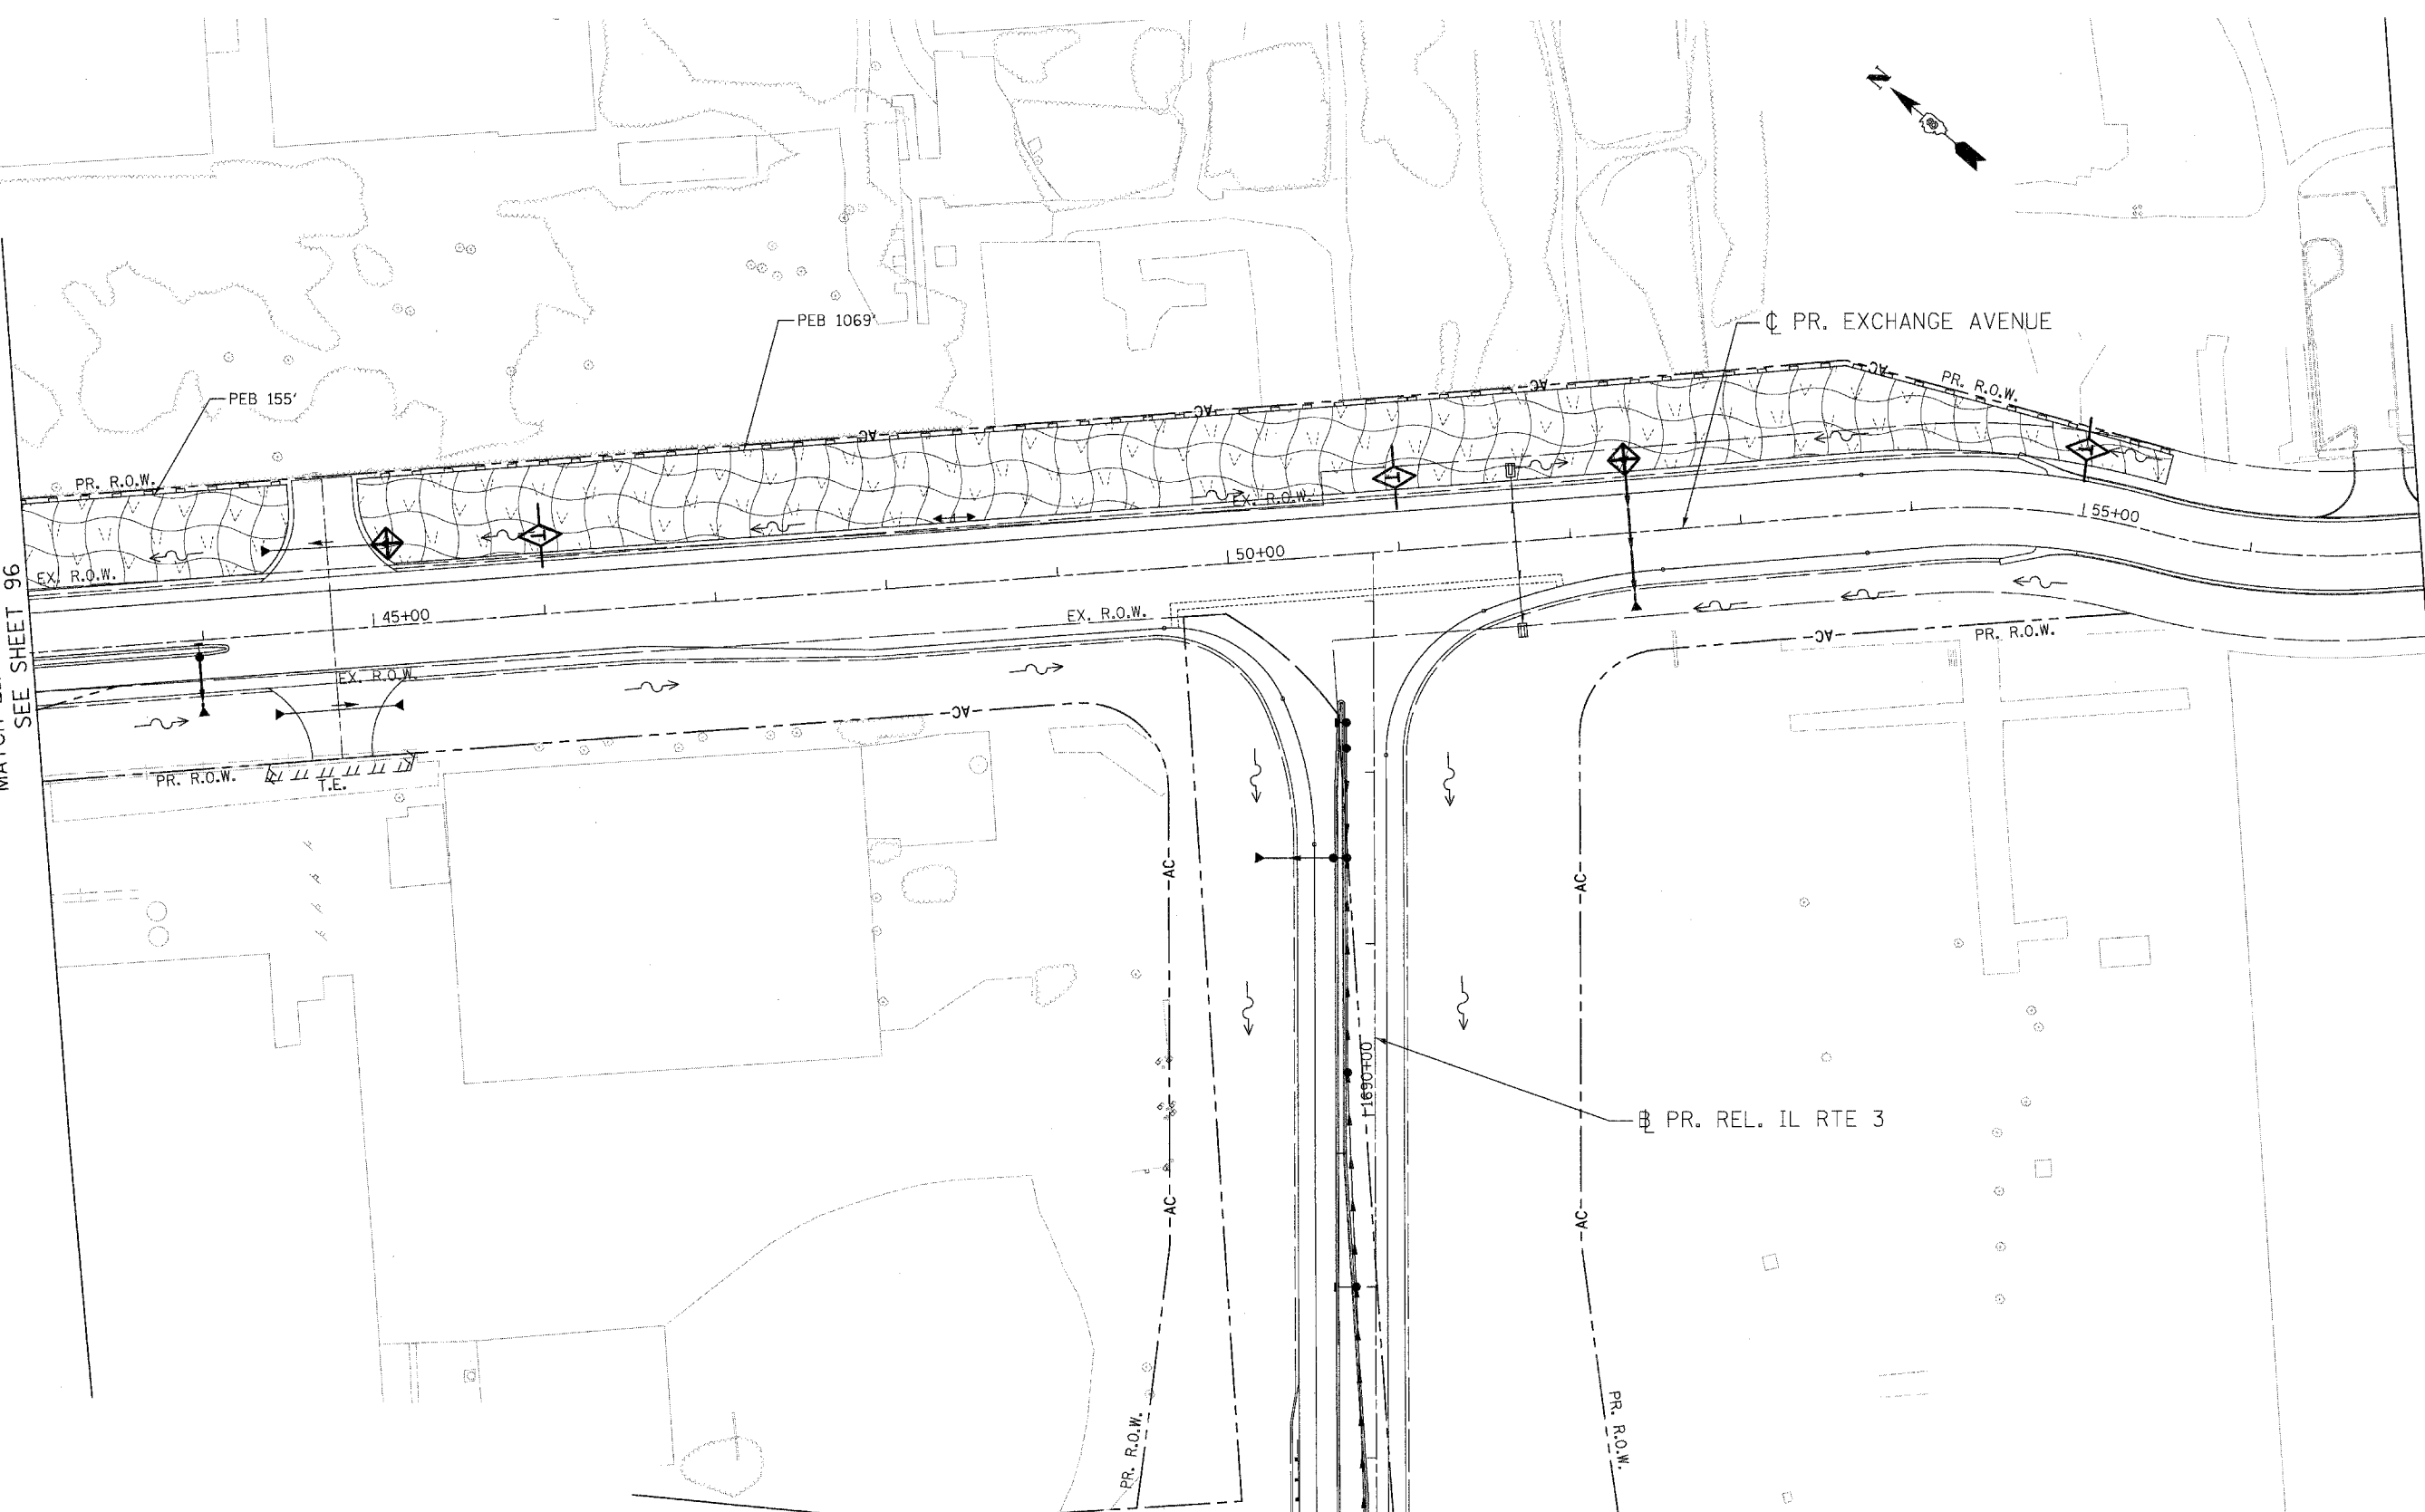

EROSION CONTROL LEGEND

-  INLET FILTERS/INLET & PIPE PROTECTION
-  PERIMETER EROSION BARRIER (PEB)
-  TEMPORARY EROSION CONTROL SEEDING/
EROSION CONTROL BLANKET
-  TEMPORARY DITCH CHECK
-  TEMPORARY EROSION CONTROL SEEDING/
MULCH, METHOD 2
-  STABILIZED CONSTRUCTION ENTRANCE

Lin Engineering Ltd.
Consulting Engineers
Chatham, Illinois
Westmont, Illinois

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	DATE - 10/21/11	REVISED -







STATE OF ILLINOIS
DEPARTMENT OF TRANSPORTATION
PROPOSED RELOCATED ILLINOIS ROUTE 3 INTERCHANGE


PR. EXCHANGE AVE. AND PR. REL. IL RTE. 3		
EROSION CONTROL PLANS - STAGE 1		
STA. 43+00 TO STA. 57+00		
SCALE: 1"=50'	SHEET NO. 2 OF 13 SHEETS	STA. TO STA.

F.A.P. RTE.	SECTION	COUNTY	TOTAL SHEETS	SHEET NO.
998	82-2-1K	ST. CLAIR	353	97
FED. ROAD DIST. NO.			ILLINOIS FED. AID PROJECT	

CONTRACT NO. 76E06

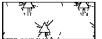EROSION CONTROL LEGEND

-  INLET FILTERS/INLET & PIPE PROTECTION
-  TEMPORARY EROSION CONTROL SEEDING/
EROSION CONTROL BLANKET
-  TEMPORARY EROSION CONTROL SEEDING/
MULCH, METHOD 2
-  PERIMETER EROSION BARRIER (PEB)
-  TEMPORARY DITCH CHECK
-  STABILIZED CONSTRUCTION ENTRANCE

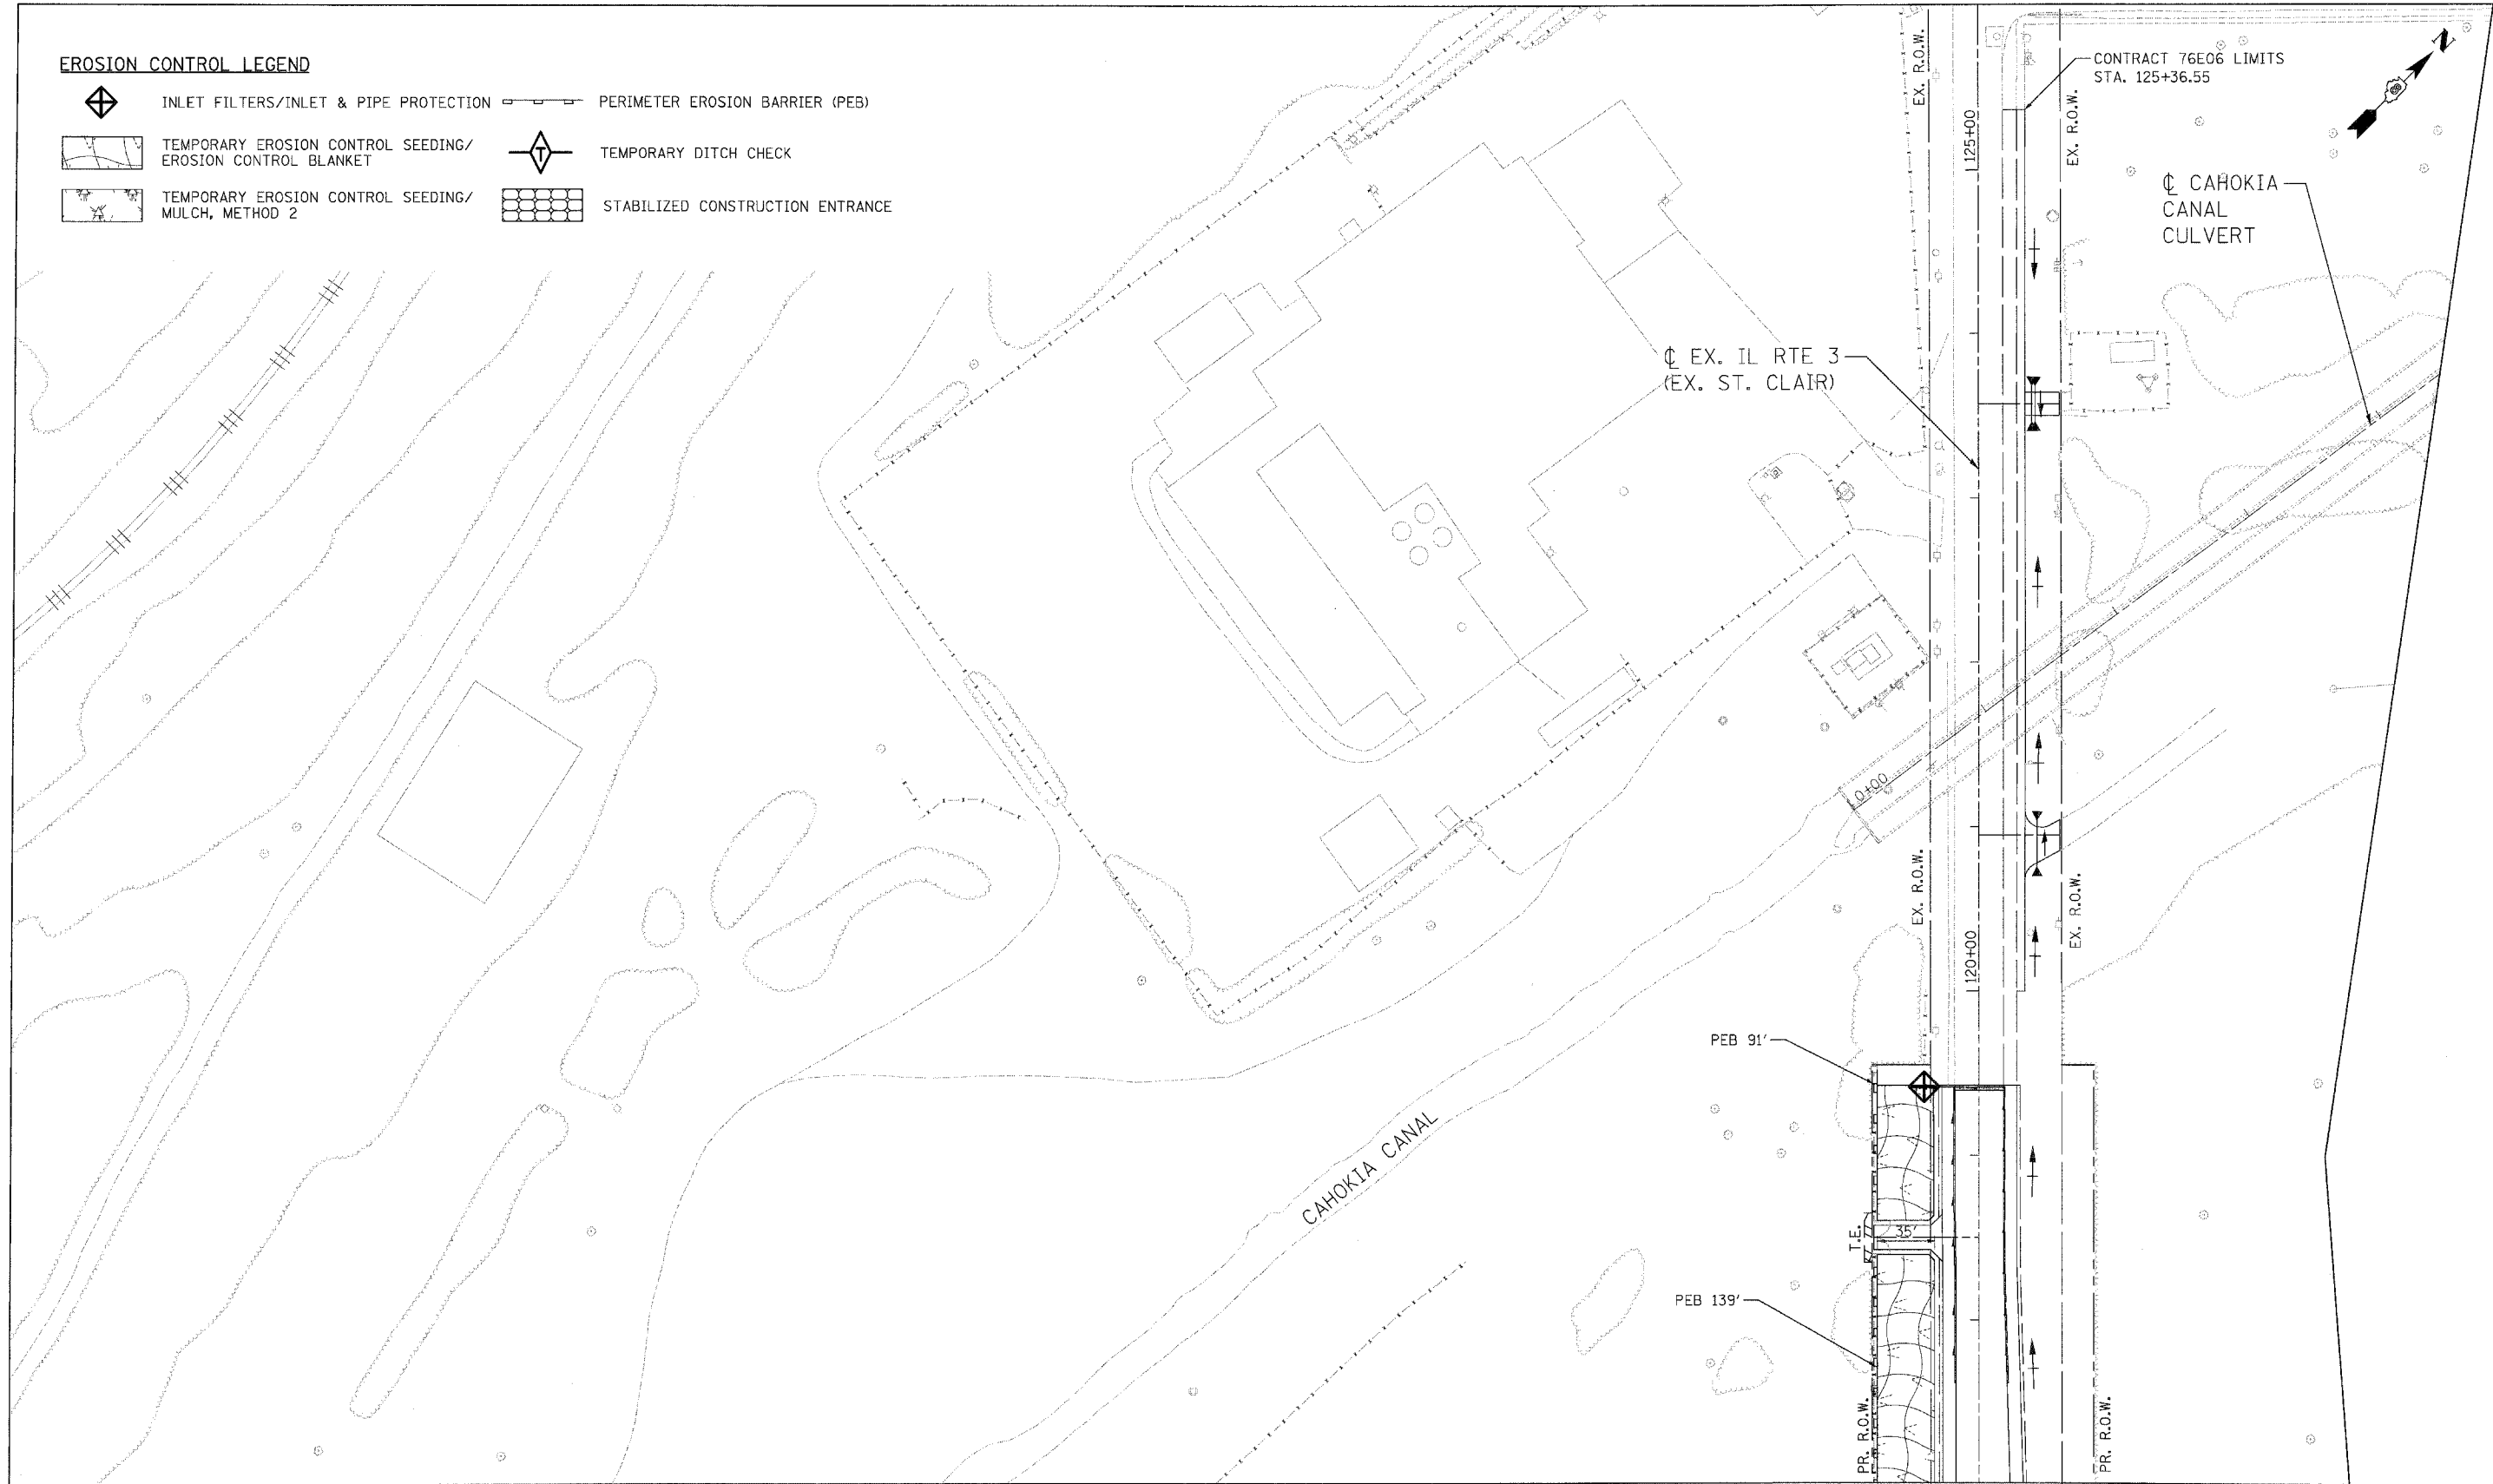

MATCH LINE STA. 117+00
SEE SHEET 99

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Westmont, Illinois

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PLOT DATE = 10/17/2011	CHECKED - ST	REVISED -
	DATE - 10/21/11	REVISED -

STATE OF ILLINOIS
DEPARTMENT OF TRANSPORTATION
PROPOSED RELOCATED ILLINOIS ROUTE 3 INTERCHANGE

EX. IL RTE. 3 (ST. CLAIR AVE.)
EROSION CONTROL PLANS - STAGE 1
STA. 117+00 TO 126+00

SCALE: 1"=50'
SHEET NO. 3 OF 13 SHEETS
STA. TO STA.

F.A.P. RTE.	SECTION	COUNTY	TOTAL SHEETS	SHEET NO.
998	82-2-1K	ST. CLAIR	353	98
FED. ROAD DIST. NO.			ILLINOIS FED. AID PROJECT	
			CONTRACT NO. 76E06	

