



PLAN	SURVEYED	DATE
	BY	
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	NOTE BOOK	
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	RT. OF WAY CHECKED	
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	BY	
	FILE NAME	
	NO.	

PROFILE	SURVEYED	DATE
	BY	
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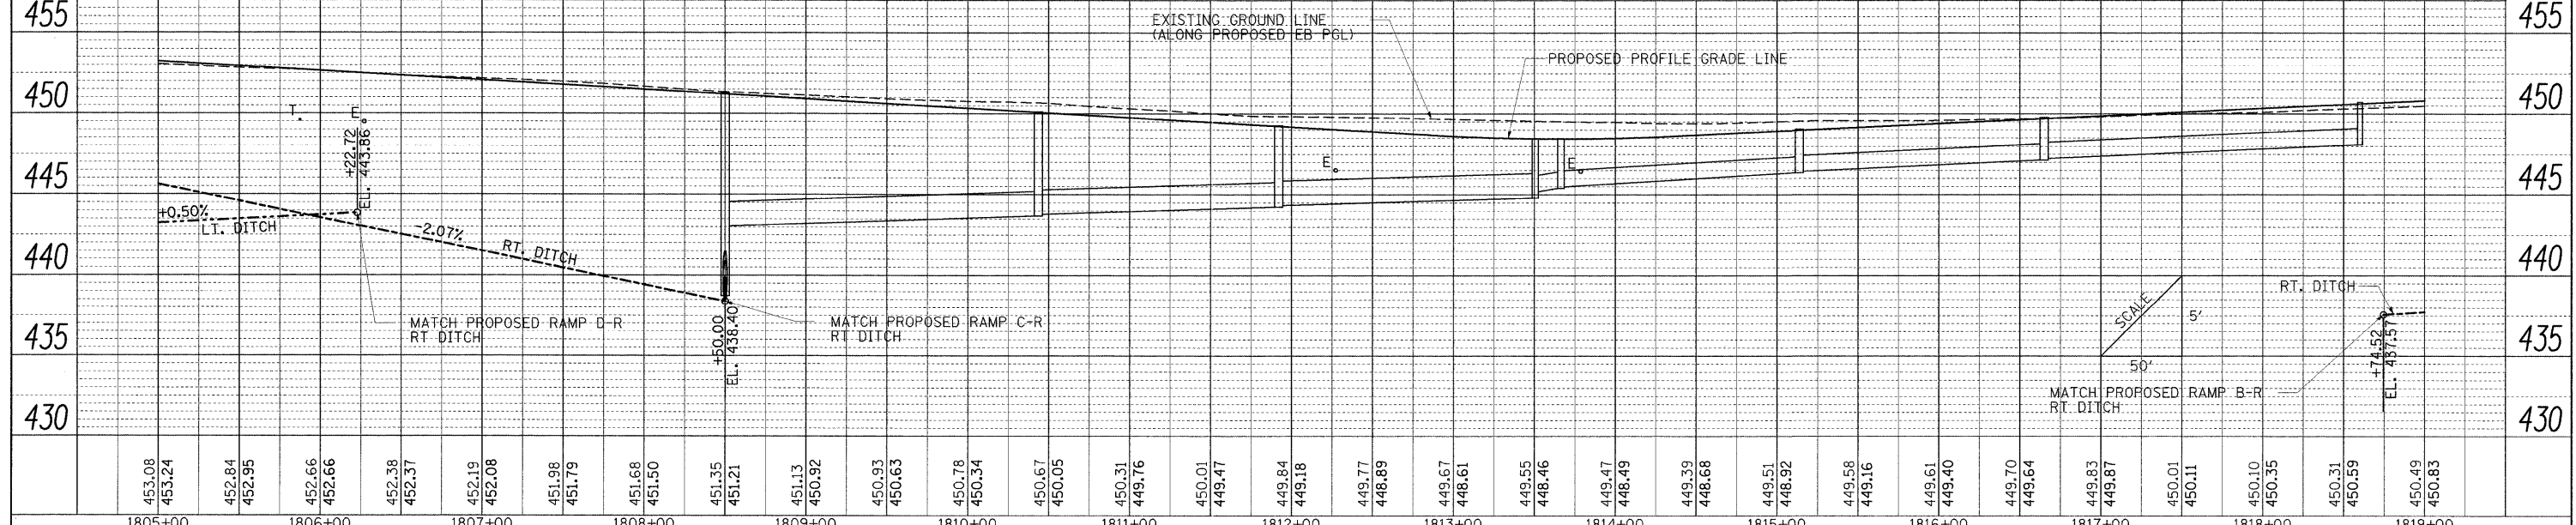


NOTE: SEE JOINTING PLANS FOR ADDITIONAL DETAIL

470	① • STA. 1808+50.00, 12.00' LT. INLETS, SPECIAL, NO. 1 (TYPE 3, 5 FEET) E.O.P. ELEV. = 450.85 TOP OF INLET ELEV. (S) = 451.29 TOP OF INLET ELEV. (N) = 451.75 INV. ELEV. (E) = 443.05 INV. ELEV. (N) = 438.74 INV. ELEV. (S) = 438.74	③ • STA. 1811+92.00, 12.00' LT. INLETS, SPECIAL, NO. 1 (TYPE 3, 5 FEET) E.O.P. ELEV. = 448.87 TOP OF INLET ELEV. (S) = 449.31 TOP OF INLET ELEV. (N) = 449.77 INV. ELEV. (E) = 444.35 INV. ELEV. (W) = 444.25	⑤ STA. 1813+50.72, 0.37' LT. INLET, TYPE A, TYPE 15 FRAME AND LID FLOWLINE = 448.00 TOP OF INLET ELEV. = 448.50 INV. ELEV. (N) = 445.20	⑦ STA. 1813+65.98, 1.19' LT. MANHOLE, TYPE A, 4'-DIAMETER FLOWLINE = 447.98 TOP OF INLET ELEV. = 448.48 INV. ELEV. (S) = 445.00 INV. ELEV. (E) = 445.20 INV. ELEV. (W) = 444.80	⑧ • STA. 1815+13.68, 4.00' RT. INLETS, SPECIAL, NO. 1 (TYPE 3, 5 FEET) E.O.P. ELEV. = 448.64 TOP OF INLET ELEV. (N) = 449.08 TOP OF INLET ELEV. (S) = 449.52 INV. ELEV. (E) = 446.45 INV. ELEV. (W) = 446.35	⑨ • STA. 1816+65.00, 4.00' RT. INLETS, SPECIAL, NO. 1 (TYPE 3, 5 FEET) E.O.P. ELEV. = 449.35 TOP OF INLET ELEV. (N) = 449.79 TOP OF INLET ELEV. (S) = 450.25 INV. ELEV. (E) = 447.25 INV. ELEV. (W) = 447.15	470
465	② • STA. 1810+43.50, 12.00' LT. INLETS, SPECIAL, NO. 1 (TYPE 3, 5 FEET) E.O.P. ELEV. = 449.73 TOP OF INLET ELEV. (S) = 450.17 TOP OF INLET ELEV. (N) = 450.63 INV. ELEV. (E) = 443.80 INV. ELEV. (W) = 443.70	④ STA. 1813+51.07, 6.80' LT. MANHOLE, TYPE A, 4'-DIAMETER FLOWLINE = 447.98 TOP OF INLET ELEV. = 448.48 INV. ELEV. (S) = 445.00 INV. ELEV. (E) = 445.20 INV. ELEV. (W) = 444.80	⑥ STA. 1813+66.35, 7.62' LT. INLET, TYPE A, TYPE 15 FRAME AND LID FLOWLINE ELEV. = 447.99 TOP OF INLET ELEV. = 448.49 INV. ELEV. (S) = 445.70	⑩ • STA. 1818+60.02, 4.00' RT. INLETS, SPECIAL, NO. 1 (TYPE 3, 5 FEET) E.O.P. ELEV. = 450.28 TOP OF INLET ELEV. (N) = 450.72 TOP OF INLET ELEV. (S) = 451.18 INV. ELEV. (W) = 448.10	465		

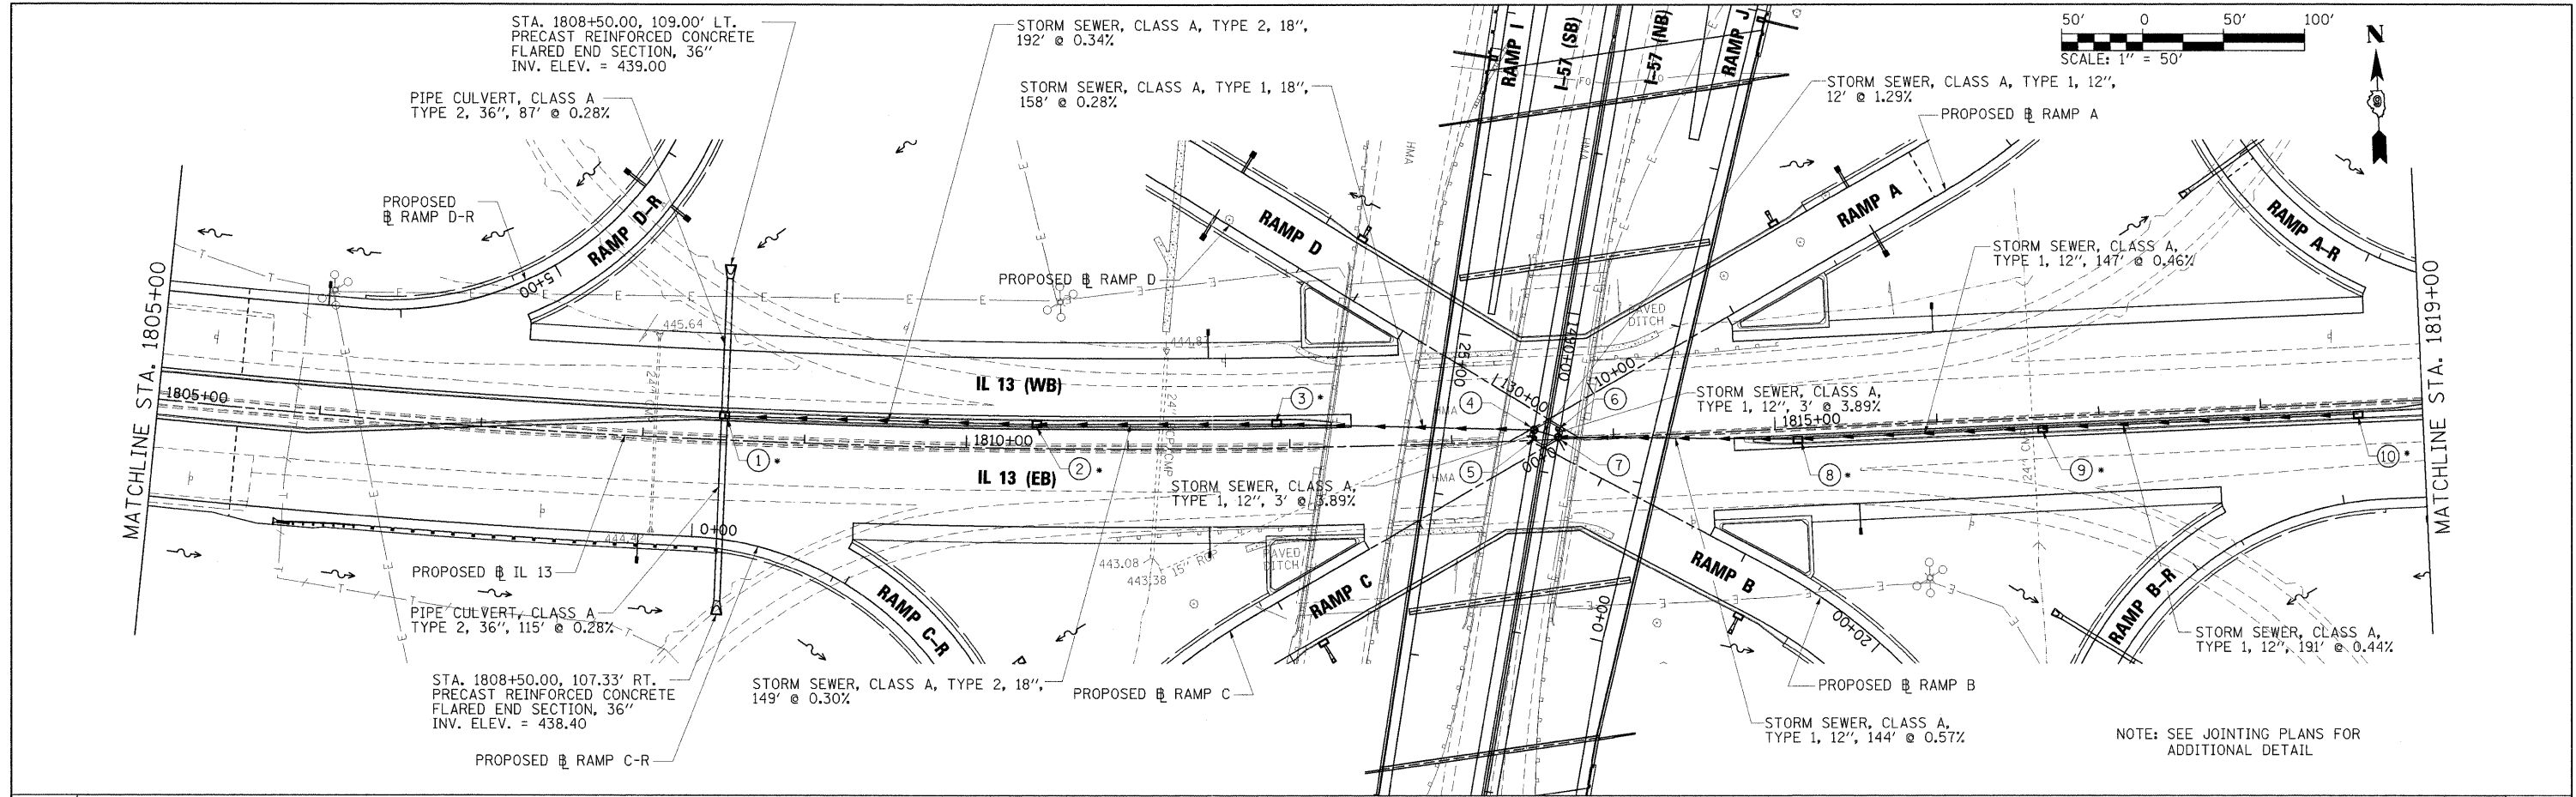

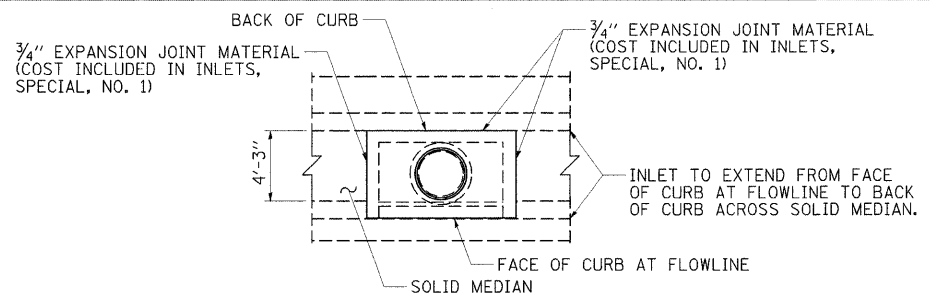\* DETAIL FOR INLETS, SPECIAL, NO. 1 (TYPE 3, 5 FEET)



FILE NAME =	USER NAME = Brad Downen	DESIGNED = SCD / BMB	REVISED =	<b>STATE OF ILLINOIS DEPARTMENT OF TRANSPORTATION</b>	<b>DRAINAGE PLAN AND PROFILE ILLINOIS ROUTE 13</b>	F.A. RTE.	SECTION	COUNTY	TOTAL SHEETS	SHEET NO.
...:\0978182-sht-drainIL13-012.dgn	PLOT SCALE = 50.0000' / IN.	DRAWN = JEB / RAH	REVISED =			• 0X1-6-2HBK-2, HB-1,2; 0X-1R-1	WILLIAMSON	968	313	
	PLOT DATE = 10/12/2011	CHECKED = SCD / BJD	REVISED =			• F.A.I. 57 AND F.A.P. 331	CONTRACT NO. 78182			
		DATE = 10/07/11	REVISED =			ILLINOIS FED. AID PROJECT				

SCALE: 1" = 50' SHEET NO. OF SHEETS STA. 1805+00 TO STA. 1819+00