

F.A.U. RTE.	SECTION	COUNTY	TOTAL SHEETS	SHEET NO.
1632	49R-RS	COOK	48	1
FED. ROAD DIST. NO. 1		ILLINOIS	CONTRACT NO. 60X38	

DEPARTMENT OF TRANSPORTATION

# PROPOSED HIGHWAY PLANS

F.A.U. 1632 (SAUK TRAIL)  
 SECTION 49R-RS  
 1) AT BURNHAM AVE.  
 2) TORRENCE AVE TO US 30 (LINCOLN HIGHWAY)  
 LEFT TURN LANES, RESURFACING, GUARDRAIL, ADA  
 PROJECT: ACHSIP-1632(004)  
 COOK COUNTY  
 C-91-086-14



FOR INDEX OF SHEETS, SEE SHEET NO. 2

PROJECT IS LOCATED  
 WITHIN SAUK VILLAGE AND  
 UNINCORPORATED BLOOM TOWNSHIP

**TRAFFIC DATA**

SAUK TRAIL  
 2014 ADT - 10,900  
 POSTED SPEED LIMIT - 45 MPH  
 DESIGN SPEED LIMIT - 50 MPH

BURNHAM AVE.  
 2014 ADT - 1,800

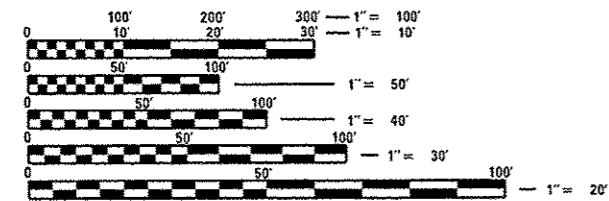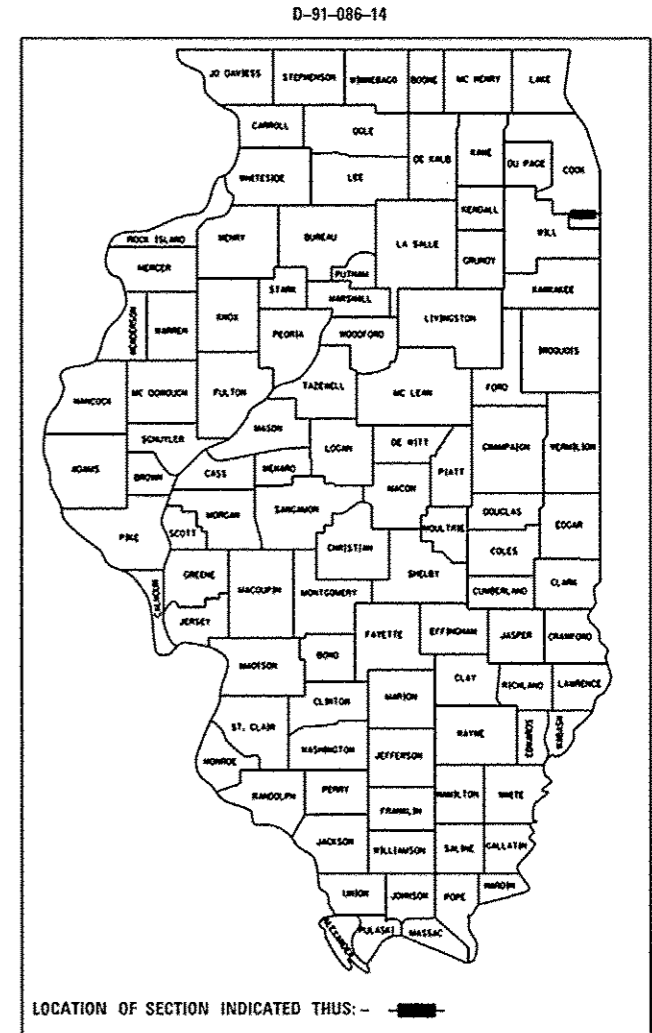


FULL SIZE PLANS HAVE BEEN PREPARED USING STANDARD ENGINEERING SCALES. REDUCED SIZED PLANS WILL NOT CONFORM TO STANDARD SCALES. IN MAKING MEASUREMENTS ON REDUCED PLANS, THE ABOVE SCALES MAY BE USED.


J.U.L.I.E.  
 JOINT UTILITY LOCATION INFORMATION FOR EXCAVATION  
 1-800-892-0123  
 OR 811

PROJECT ENGINEER: JENPAI CHANG (847) 705-4432  
 PROJECT MANAGER: FAWAD AQUEEL (847) 702-4247

CONTRACT NO. 60X38

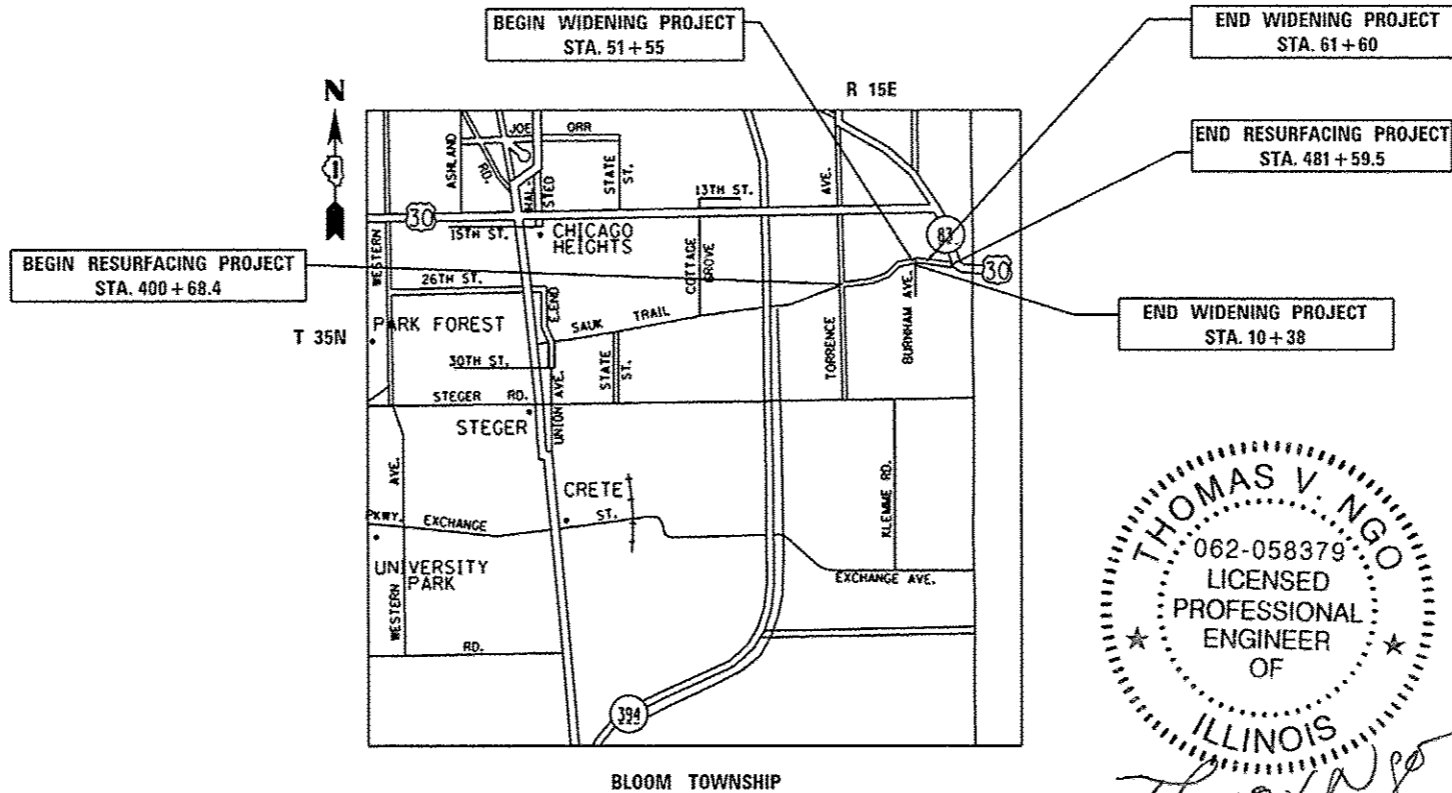

GROSS AND NET LENGTH OF PROJECT = 8,091 FT = 1.53 MI.

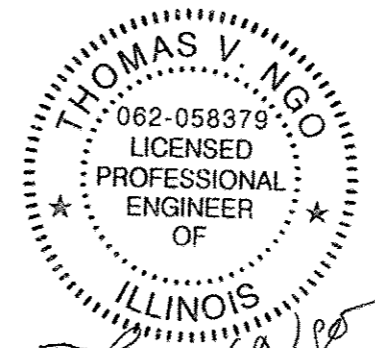

Thomas V. Ngo  
 10-14-16  
 SHEET NO. 9, 10, 15-19

STATE OF ILLINOIS  
 DEPARTMENT OF TRANSPORTATION

SUBMITTED October 25, 2016  
John Fortman Jr. REGIONAL ENGINEER

Dec 9, 2016  
Maureen M. Addis, P.E. ENGINEER OF DESIGN AND ENVIRONMENT

Dec 9, 2016  
Onor Benam, P.E. DIRECTOR OF HIGHWAYS, CHIEF ENGINEER

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000001-06	STANDARD SYMBOLS, ABBREVIATIONS AND PATTERNS
280001-07	TEMPORARY EROSION CONTROL SYSTEMS
420001-08	PAVEMENT JOINTS
442201-03	CLASS C AND D PATCHES
482001-02	HMA SHOULDERS ADJACENT TO FLEXIBLE PAVEMENT
482011-03	HMA SHOULDER STRIPS/ SHOULDER WITH RESURFACING OR WIDENING AND RESURFACING PROJECTS
601001-05	PIPE UNDERDRAINS
602001-02	CATCH BASIN, TYPE A
602401-03	MANHOLE, TYPE A
604001-04	FRAME AND LIDS, TYPE 1
604036-03	GRATE TYPE B
606001-06	CONCRETE CURB AND COMBINATION CONCRETE CURB AND GUTTER
606306-04	CORRUGATED PC CONCRETE MEDIANS
642006	SHOULDER RUMBLE STRIPS, 8 IN.
630101-10	GUARDRAIL MOUNTED ON EXISTING CULVERTS
630201-07	PCC/HMA STABILIZATION AT STEEL PLATE BEAM GUARDRAIL
666001-01	RIGHT-OF-WAY MARKERS
667101-02	PERMANENT SURVEY MARKERS
701001-02	OFF ROAD OPERATIONS, 2L, 2W, MORE THAN 15' AWAY
701006-05	OFF ROAD OPERATIONS, 2L, 2W, 15' TO 24" FROM PAVEMENT EDGE
701201-04	LANE CLOSURE, 2L, 2W, DAY ONLY, FOR SPEEDS > 45 MPH
701301-04	LANE CLOSURE, 2L, 2W, SHORT TIME OPERATIONS
701306-03	LANE CLOSURE, 2L, 2W, SLOW MOVING OPERATIONS DAY ONLY, FOR SPEEDS > 45 MPH
701311-03	LANE CLOSURE, 2L, 2W, MOVING OPERATIONS - DAY ONLY
701326-04	LANE CLOSURE, 2L, 2W, PAVEMENT WIDENING, FOR SPEEDS > 45 MPH
701336-06	LANE CLOSURE, 2L, 2W, WORK AREAS IN SERIES, FOR SPEEDS > OR = 45 MPH
701427-05	LANE CLOSURE, MULTILANE, INTERMITTENT OR MOVING OPER., FOR SPEEDS < OR = 40 MPH
701501-06	URBAN LANE CLOSURE, 2L, 2W, UNDIVIDED
701606-10	URBAN LANE CLOSURE, MULTILANE, 2W WITH MOUNTABLE MEDIUM
701701-10	URBARN LANE CLOSURE, MULTILANE INTERSECTION
701901-06	TRAFFIC CONTROL DEVICES
725001-01	OBJECT AND TERMINAL MARKERS
782006	GUARDRAIL BARRIER WALL REFLECTOR MOUNTING DETAILS

STATE OF ILLINOIS  
DEPARTMENT OF TRANSPORTATION

INDEX OF SHEETS

FILE NAME : c:\pwork\pwork\qureshiga\0283041\FI11	USER NAME : qureshiga	DESIGNED : _____	REVISER : _____	SCALE: _____	SHEET NO. 1 OF 2 SHEETS	STA. _____ TO STA. _____	F.A.U. RTE. 1632	SECTION 49R-RS	COUNTY COOK	TOTAL SHEETS 48	SHEET NO. 2
	0112-shl-typical.dgn	DRAWN : _____	REVISER : _____							CONTRACT NO. 60X38	
	PLOT SCALE : 1/8" = 1'-0"	CHECKED : _____	REVISER : _____								
	PLOT DATE : 12/5/2018	DATE : _____	REVISER : _____								

**GENERAL NOTES**

BEFORE STARTING ANY EXCAVATION, THE CONTRACTOR SHALL CALL "J.U.L.I.E." AT 1-800-892-0123 FOR FIELD LOCATIONS OF BURIED ELECTRIC, TELEPHONE, AND GAS FACILITIES. (48 HOURS NOTIFICATION IS REQUIRED)

10 FEET (3 METER) TRANSITIONS SHALL BE USED TO MATCH PROPOSED CURB AND GUTTER AND MEDIAN ITEMS OF WORK TO EXISTING CURBS & GUTTERS AND MEDIANS IN THE FIELD, UNLESS OTHERWISE SHOWN. THE TRANSITIONS SHALL BE PAID FOR AT THE CONTRACT UNIT PRICE FOR THE PROPOSED ITEMS OF WORK SPECIFIED.

THE CONTRACTOR SHALL COORDINATE CONSTRUCTION ACTIVITIES WITH UTILITY COMPANIES AND SAUK VILLAGE.

THE CONTRACTOR WILL NOT BE ALLOWED TO SET UP A YARD OR FIELD OFFICE ON STATE PROPERTY WITHOUT WRITTEN PERMISSION FROM THE DEPARTMENT.

WHEN MILLED PAVEMENT IS OPEN TO TRAFFIC THE MAXIMUM GRADE DIFFERENTIAL BETWEEN PASSES OF THE MILLING MACHINE SHALL NOT EXCEED 1 1/2 INCHES (40 MM) WHERE THE SPEED LIMIT IS 45 MPH (80 KM/H) OR LESS AND 1 INCH (25 MM) WHERE THE SPEED LIMIT IS GREATER THAN 45 MPH (80KM/H), WITH WRITTEN APPROVAL FROM THE ENGINEER, A MAXIMUM GRADE DIFFERENTIAL OF 3 INCHES (75MM) MAY BE ALLOWED IF THE EDGE OF THE MILLING IS SLOPED A MINIMUM 1:3 (V:H).

BUTT JOINTS WILL BE INSTALLED AT THE ENDS OF ALL RESURFACING (WHERE RESURFACING MEETS EXISTING PAVEMENT), IN ACCORDANCE WITH THE "BUTT JOINT AND HMA TAPER DETAILS" SHEET INCLUDED IN THE PLANS, UNLESS OTHERWISE SPECIFIED.

UNLESS OTHER CONDITIONS WARRANT EXTENDED LANE CLOSURE AS DETERMINED AND APPROVED IN WRITING BY THE ENGINEER OR AS PROVIDED IN THE CONTRACT SPECIFICATIONS, OVERNIGHT CLOSURES SHALL NOT BE ALLOWED FOR REHABILITATION PROJECTS INVOLVING DAYTIME MILLING AND RESURFACING OPERATIONS AND CLASS D PATCHING.

PRIOR TO EMBANKMENT PLACEMENT, ALL VEGETATION, LOOSE MATERIAL, AND UNSTABLE MATERIAL SHOULD BE REMOVED TO DEPTH ENCOUNTERED AND REPLACED WITH SUITABLE EMBANKMENT MATERIAL. ANY EMBANKMENT WIDENING ON EXISTING SLOPES SHOULD BE BENCHED IN ACCORDANCE WITH ARTICLE 205.03 OF THE STANDARD SPECIFICATIONS FOR ROAD AND BRIDGE CONSTRUCTION.

THE CONTRACTOR SHALL TAKE ALL NECESSARY PRECAUTIONS FOR THE PROTECTION OF THE EXISTING PLANT MATERIAL FOR WHICH THE CONTRACT DOES NOT PROVIDE REMOVAL. THE PROTECTION OF EXISTING PLANT MATERIAL AND THE REPAIR OR REPLACEMENT OF THE EXISTING PLANT MATERIAL DAMAGED BY THE CONTRACTOR SHALL BE DONE IN ACCORDANCE WITH THE REQUIREMENT OF SECTION 201 OF THE STANDARD SPECIFICATIONS AT THE CONTRACTORS OWN EXPENSE.

PERMANENT PAVEMENT MARKINGS SHALL BE THERMOPLASTIC (OF THE EXTRUDED TYPE) AND SHOULD BE PLACED IN ACCORDANCE WITH THE "DISTRICT ONE TYPICAL PAVEMENT MARKINGS" DETAIL. (TC-13)

RAISED REFLECTIVE PAVEMENT MARKERS SHALL BE IN ACCORDANCE WITH THE DISTRICT ONE "TYPICAL APPLICATION RAISED REFLECTIVE PAVEMENT MARKERS DETAIL."

THE RESIDENT ENGINEER SHALL VERIFY THE LOCATIONS OFF ALL EXISTING PAVEMENT MARKINGS PRIOR TO MILLING OR RESURFACING.

IT IS THE CONTRACTOR'S RESPONSIBILITY TO PROVIDE A FIELD LABORATORY FOR USE FOR ANY ON SITE TESTING BY THE ENVIRONMENTAL FIRM. NO TESTING OF ANY KIND, CONTAMINATED OR NON-CONTAMINATED FLUID OR SOLID SHALL BE PERMITTED IN THE ENGINEER'S FIELD OFFICE.

ALL PAVEMENT PATCHING LOCATIONS WILL BE DETERMINED IN THE FIELD BY THE ENGINEER

THE RESIDENT ENGINEER SHALL CONTACT THE AREA TRAFFIC FIELD TECHNICIAN, MS. PATRICE HARRIS, AT PATRICE.HARRIS@ILLINOIS.GOV TWO WEEKS PRIOR TO PLACING PERMANENT PAVEMENT MARKINGS.

THE CONTRACTOR SHALL CONTACT THE TRAFFIC CONTROL SUPERVISOR AT (847) 705-4470 A MINIMUM OF 72 HOURS IN ADVANCE OF BEGINNING WORK.

THE DEPARTMENT HAS NOT OBTAINED ANY PERMITS FOR OFFSITE BORROW, WASTE, USE (BWU) AREAS. PRIOR TO WORKING IN BWU AREAS, IF THE CONTRACTOR CHOOSES TO USE ACTIVITIES REQUIRING PERMITS IT IS THE CONTRACTOR'S RESPONSIBILITY TO SECURE THE PROPER PERMITS. IN ADDITION TO THE BORROW REVIEW (BDE 2289) AND USE/WASTE REVIEW(BDE 2290) SUBMITTALS, THE CONTRACTOR SHALL SUBMIT AN EROSION AND SEDIMENT CONTROL (ESC) PLAN FOR EVERY BWU SITE TO THE DEPARTMENT FOR ACCEPTANCE. GUIDELINES FOR ACCEPTABLE BWU PRACTICES CAN BE FOUND IN SECTION II.G.1 AND 2 OF THE SWPPP. THE COST OF ALL MATERIALS AND LABOR NECESSARY TO COMPLY WITH THE ABOVE PROVISIONS TO PREPARE AND IMPLEMENT ESC PLANS WILL NOT BE PAID FOR SEPARATELY, BUT SHALL BE CONSIDERED AS INCLUDED IN THE UNIT BID PRICES OF THE CONTRACT AND NO ADDITIONAL COMPENSATION WILL BE ALLOWED.

THE CONTRACTOR'S ATTENTION IS CALLED TO THE FACT THAT THE PRESERVATION OF EXISTING TREES IS OF UTMOST IMPORTANCE TO THE VILLAGE OF SAUK. IT WILL BE THE RESPONSIBILITY OF THE CONTRACT TO ARRANGE TREE PROTECTION WITH THE ROADSIDE DEVELOPMENT UNIT (847.705.4171) PRIOR TO SCHEDULING TREE REMOVAL. ALL TREE PROTECTION, TREE REMOVAL, PRUNING AND ROOT PRUNING SHALL BE COMPLETED BEFORE CONSTRUCTION OPERATIONS COMMENCE IN ANY AREA. AT NO TIME SHALL THE CONTRACTOR PRUNE OR REMOVE ANY TREES UNLESS SPECIFICALLY DIRECTED BY THE ROADSIDE DEVELOPMENT UNIT.

SUPPLEMENTAL WATERING IS SPECIFIED FOR TREES AND SHRUBS THAT WILL BE DISTURBED BY CONSTRUCTION BUT WILL REMAIN. NOTE THAT WATERING SHOULD BEGIN IMMEDIATELY AFTER ROOT PRUNING, TOP PRUNING OR OTHER CONSTRUCTION DISTURBANCE.

AGGREGATE SUBGRADE IMPROVEMENT (CU YD) HAS BEEN PROVIDED FOR USE AT THE LOCATIONS INDICATED FOR THE SOILS THAT TEND TO BE UNSTABLE AND/OR UNSUITABLE. THE ACTUAL NEED FOR REMOVAL AND REPLACEMENT WITH AS1 WILL BE DETERMINED IN THE FIELD AT THE TIME OF CONSTRUCTION BY THE GEOTECHNICAL ENGINEER. ALL POTENTIALLY UNSTABLE SOILS SHOULD BE TESTED WITH STATIC OR DYNAMIC CONE PENETROMETER AND TREATED IN ACCORDANCE WITH ARTICLE 301.04 OF THE SSRBC AND IDOT SUBGRADE STABILITY MANUAL. IF UNSTABLE AND/OR UNSUITABLE SOILS ARE NOT ENCOUNTERED, THEN THE QUANTITY SHALL BE DEDUCTED AND NO ADDITIONAL COMPENSATION WILL BE DUE TO THE CONTRACTOR.

PIPE UNDERDRAINS TYPE 2 SHALL BE INSTALLED ACCORDING TO SECTION 601 OF THE SSRBC AND STANDARD 601001-05. TOP OF PIPE UNDERDRAINS SHALL BE PLACED 6" BELOW THE SUBGRADE OR UNDERCUT. THE COST OF MAKING PIPE UNDERDRAINS CONNECTIONS TO DRAINAGE STRUCTURES SHALL BE INCLUDED IN THE COST OF THE PIPE UNDERDRAINS.

RESTORATION OF WORK AREA, RESTORATION OF THE TRAFFIC SIGNAL WORK AREA SHALL BE INCIDENTAL TO THE RELATED PAY ITEMS SUCH AS FOUNDATION, CONDUIT, HANDHOLE, TRENCH AND BACKFILL, ETC. AND NO EXTRA COMPENSATION SHALL BE ALLOWED. ALL ROADWAY SURFACES SUCH AS SHOULDERS, MEDIANS, SIDEWALKS, PAVEMENT, ETC SHALL BE REPLACED IN KIND. ALL DAMAGE TO MOWED LAWNS SHALL BE REPLACED WITH AN APPROVED SOD, AND ALL DAMAGE TO UNMOWED FIELDS SHALL BE SEEDED IN ACCORDANCE WITH STANDARD SPECIFICATIONS 252 AND 250 RESPECTIVELY.

EXISTING VEGETATED AREAS (TREES, SHRUBS, VEGETATIVE BUFFERS, TURF AREAS, ETC.) WHERE DISTURBANCE IS NOT OCCURRING (INCLUDING AREAS OUTSIDE THE PROJECT LIMITS) SHALL NOT BE DISTURBED TO ENSURE THAT EXISTING VEGETATION IS PRESERVED TO MINIMIZE SOIL EROSION AND TO ELIMINATE SOIL COMPACTION. NO MATERIAL ARE TO BE STORED OR VEHICLES DRIVEN OR PARKED WITHIN THESE UNDISTURBED AREAS AT ANY TIME.

PRUNE TREE LIMBS THAT MIGHT BE DAMAGED BY EQUIPMENT OPERATIONS AT LEAST ONE WEEK PRIOR TO THE START OF CONSTRUCTION BY A CERTIFIED ARBORIST. ANY TREE LIMBS THAT ARE BROKEN BY CONSTRUCTION EQUIPMENT AFTER THE INITIAL PRUNING MUST BE PRUNED CORRECTLY WITHIN 72 HOURS.

THE CONTRACTOR SHALL TAKE EXTRA CARE IN GRADING AND EXCAVATING NEAR TREES WHICH ARE NOT MARKED FOR REMOVAL SO AS NOT TO CAUSE INJURY TO THE ROOT SYSTEM OR TRUNKS. ROOTS OF A TREE THAT ARE TO REMAIN IN PLACE EXTENDING INTO THE EXCAVATION AREAS AT AN ELEVATION THAT WOULD INTERFERE WITH ANY PORTION OF THE PLANNED CONSTRUCTION SHALL BE SEVERED AT A POINT IMMEDIATELY OUTSIDE OF THE EXCAVATION AREA IN A MANNER THAT WILL CAUSE THE LEAST AMOUNT OF SYSTEMIC DAMAGE TO THE REMAINING TREE STRUCTURE. ANY DAMAGE DONE TO EXISTING ITEMS BY THE CONTRACTOR SHALL BE REPAIRED BY THE CONTRACTOR AT THE CONTRACTOR'S OWN EXPENSE.

THE CONTRACTOR SHALL ERECT A TEMPORARY FENCE AROUND ALL TREES WITHIN THE CONSTRUCTION AREA TO ESTABLISH A "TREE PROTECTION ZONE" AND AROUND EXISTING WETLANDS TO ESTABLISH A "WETLAND PROTECTION ZONE" BEFORE ANY WORK BEGINS OR ANY MATERIAL IS DELIVERED TO THE JOBSITE. NO WORK IS TO BE PERFORMED (OTHER THAN ROOT PRUNING), MATERIALS STORED OR VEHICLES DRIVEN OR PARKED WITHIN THE "TREE PROTECTION ZONE" AND "WETLAND PROTECTION ZONE". REMOVE TEMPORARY FENCE ONLY AFTER ALL CONSTRUCTION WORK HAS BEEN COMPLETED.

THE CONTRACTOR SHALL ATTACH AN ALUMINUM SIGN WITH THE FOLLOWING TEXT: "PROTECTED WETLAND - NO INTRUSION". THE SIGN(S) SHALL BE ATTACHED TO THE STAKES BY A METHOD APPROVED BY THE ENGINEER. THE SIGN(S) WILL BE PROVIDED BY THE DEPARTMENT AND SHALL BE PICKED UP BY THE CONTRACTOR FROM THE DISTRICT ONE ROADSIDE DEVELOPMENT ARCHITECT IN SCHAUMBURG, ILLINOIS. SCHEDULING THE PICKUP OF THE SIGNS CAN BE ARRANGED BY CONTACTING THE DISTRICT ONE ROADSIDE DEVELOPMENT UNIT AT 847.705.4171. WHEN WORK HAS BEEN COMPLETED, THE SIGN(S) SHALL BE RETURNED TO THE DISTRICT ONE ROADSIDE DEVELOPMENT UNIT. THE COST OF PICKING UP, ATTACHING THE SIGN(S) TO THE TEMPORARY FENCE STAKES AND RETURNING THE SIGN(S) WILL NOT BE PAID FOR SEPERATELY, BUT SHALL BE INCLUDED IN THE CONTRACT UNIT PRICE FOR TEMPORARY FENCE.

FILE NAME =	USER NAME = qureshiya	DESIGNED - ____	REVISED - ____	<b>STATE OF ILLINOIS DEPARTMENT OF TRANSPORTATION</b>	<b>GENERAL NOTES</b>	F.A.U. RTE.	SECTION	COUNTY	TOTAL SHEETS	SHEET NO.	
es:\pw_work\p1dot\qureshiya\d0283041\PI100112-sht-typic01.dgn	0112-sht-typic01.dgn	DRAWN - ____	REVISED - ____			1632	49R-RS	COOK	48	3	
PLOT SCALE = 100.0000' / in.		CHECKED - ____	REVISED - ____			<b>CONTRACT NO. 60X38</b>					
PLOT DATE = 11/22/2016		DATE - ____	REVISED - ____			FED. ROAD DIST. NO. _   ILLINOIS   FED. AID PROJECT					
					SCALE: _____	SHEET NO. 2 OF 2 SHEETS		STA. _____ TO STA. _____			



URBAN 90% FED 10% STATE

URBAN 90% FED 10% STATE

SUMMARY OF QUANTITIES				CONSTRUCTION TYPE CODE					
CODE NO	ITEM	UNIT	TOTAL QUANTITIES	ROADWAY 0004					
40600985	PORTLAND CEMENT CONCRETE SURFACE	SO YD	316	316					
	REMOVAL - BUTT JOINT								
40601005	HOT-MIX ASPHALT REPLACEMENT OVER	TON	250	250					
	PATCHES								
40603085	HOT-MIX ASPHALT BINDER COURSE, IL-19, 0,	TON	51	51					
	N70								
40603335	HOT-MIX ASPHALT SURFACE COURSE, MIX	TON	85	85					
	"D", N50								
40603565	POLYMERIZED HOT-MIX ASPHALT SURFACE	TON	3134	3134					
	COURSE, MIX "E", N70								
42400200	PORTLAND CEMENT CONCRETE SIDEWALK 5	SO FT	428	428					
	INCH								
42400800	DETECTABLE WARNINGS	SO FT	26	26					
44000158	HOT-MIX ASPHALT SURFACE REMOVAL, 2	SO YD	400	400					
	1/4"								
44000159	HOT-MIX ASPHALT SURFACE REMOVAL, 2	SO YD	24470	24470					
	1/2"								
44000500	COMBINATION CURB AND GUTTER REMOVAL	FOOT	1450	1450					
44000600	SIDEWALK REMOVAL	SO FT	337	337					

SUMMARY OF QUANTITIES				CONSTRUCTION TYPE CODE					
CODE NO	ITEM	UNIT	TOTAL QUANTITIES	ROADWAY 0004					
44002210	HOT-MIX ASPHALT REMOVAL OVER PATCHES, 2	SO YD	1850	1850					
	1/2"								
44003100	MEDIAN REMOVAL	SO FT	960	960					
44003510	MEDIAN REMOVAL PARTIAL DEPTH	SO FT	910	910					
44201753	CLASS D PATCHES, TYPE II, 9 INCH	SO YD	650	650					
44201757	CLASS D PATCHES, TYPE III, 9 INCH	SO YD	525	525					
44201759	CLASS D PATCHES, TYPE IV, 9 INCH	SO YD	435	435					
44213204	TIE BARS 3/4"	EACH	587	587					
48102100	AGGREGATE WEDGE SHOULDER, TYPE B	TON	500	500					
54213657	PRECAST REINFORCED CONCRETE FLARED END	EACH	1	1					
	SECTIONS 12"								
550A0050	STORM SEWERS, CLASS A, TYPE I 12"	FOOT	925	925					
55100500	STORM SEWER REMOVAL 12"	FOOT	900	900					
60100060	CONCRETE HEADWALLS FOR PIPE DRAINS	EACH	7	7					
60108100	PIPE UNDERDRAINS 4" (SPECIAL)	FOOT	250	250					
60108204	PIPE UNDERDRAINS, TYPE 2, 4"	FOOT	1700	1700					

\* SPECIALITY ITEMS  
NP - NON-PARTICIPATING ITEMS

11

FILE NAME	USER NAME	DESIGNED	REVISED	STATE OF ILLINOIS DEPARTMENT OF TRANSPORTATION		SUMMARY OF QUANTITIES		SCALE	SHEET NO.	OF	SHEETS	STA.	TO STA.	F.A.U. R.T.C.	SECTION	COUNTY	TOTAL SHEETS	SHEET NO.
		DRAWN	REVISED					1632	49R-RS	COOK	48	5						
		CHECKED	REVISED					CONTRACT NO. 60X38										
		DATE	REVISED					FED. ROAD DIST. NO. 1 ILLINOIS FED. AID PROJECT										

SUMMARY OF QUANTITIES				CONSTRUCTION TYPE CODE				
CODE NO	ITEM	UNIT	TOTAL QUANTITIES	ROADWAY				
60200805	CATCH BASINS, TYPE A, 4'-DIAMETER, TYPE B GRATE	EACH	5	5				
60219000	MANHOLES, TYPE A, 4'-DIAMETER, TYPE B GRATE	EACH	4	4				
60262700	INLETS TO BE RECONSTRUCTED	EACH	1	1				
60300105	FRAMES AND GRATES TO BE ADJUSTED	EACH	7	7				
60300305	FRAMES AND LIDS TO BE ADJUSTED	EACH	3	3				
60605000	COMBINATION CONCRETE CURB AND GUTTER, TYPE B-6.24	FOOT	140	140				
60608300	COMBINATION CONCRETE CURB AND GUTTER, TYPE M-2.12	FOOT	1083	1083				
* 63100167	TRAFFIC BARRIER TERMINAL, TYPE 1 (SPECIAL) TANGENT	EACH	3	3				
63200310	GUARDRAIL REMOVAL	FOOT	150	150				
64200108	SHOULDER RUMBLE STRIPS, 8 INCH	FOOT	1598	1598				
* 66900200	NON-SPECIAL WASTE DISPOSAL	CU YD	19	19				
* 66900450	SPECIAL WASTE PLANS AND REPORTS	LSUM	1	1				
* 66900530	SOIL DISPOSAL ANALYSIS	EACH	2	2				
	* SPECIALTY ITEM							

SUMMARY OF QUANTITIES				CONSTRUCTION TYPE CODE				
CODE NO	ITEM	UNIT	TOTAL QUANTITIES	ROADWAY				
67000400	ENGINEER'S FIELD OFFICE, TYPE A	CAL MO	6	6				
67100100	MOBILIZATION	LSUM	1	1				
70100450	TRAFFIC CONTROL AND PROTECTION, STANDARD 701201	LSUM	1	1				
70100460	TRAFFIC CONTROL AND PROTECTION, STANDARD 701306	L SUM	1	1				
70100500	TRAFFIC CONTROL AND PROTECTION, STANDARD 701326	LSUM	1	1				
70100600	TRAFFIC CONTROL AND PROTECTION, STANDARD 701336	L SUM	1	1				
70102620	TRAFFIC CONTROL AND PROTECTION, STANDARD 701501	LSUM	1	1				
70102625	TRAFFIC CONTROL AND PROTECTION, STANDARD 701606	L SUM	1	1				
70106800	CHANGEABLE MESSAGE SIGN	CAL MO	6	6				
70102635	TRAFFIC CONTROL AND PROTECTION, STANDARD 701701	L SUM	1	1				
70300100	SHORT TERM PAVEMENT MARKING	FOOT	6450	6450				
70300150	SHORT TERM PAVEMENT MARKING REMOVAL	SQ FT	2150	2150				
70300210	TEMPORARY PAVEMENT MARKING LETTERS AND SYMBOLS	SQ FT	200	200				
70300220	TEMPORARY PAVEMENT MARKING - LINE 4"	FOOT	35500	35500				
70300240	TEMPORARY PAVEMENT MARKING - LINE 6"	FOOT	250	250				
70300260	TEMPORARY PAVEMENT MARKING - LINE 12"	FOOT	120	120				
70300280	TEMPORARY PAVEMENT MARKING - LINE 24"	FOOT	60	60				
<del>70301000</del>	<del>WORK ZONE PAVEMENT MARKING REMOVAL</del>	<del>SQ FT</del>	<del>200</del>	<del>200</del>				
72000100	SIGN PANEL - TYPE 1	SQ FT	16	16				

P1100112-ent\ppl\cpl\10262016\_12\_52\_02 PM User:qshy

URBAN 90% FED 10% STATE

URBAN 90% FED 10% STATE

SUMMARY OF QUANTITIES				CONSTRUCTION TYPE CODE				
CODE NO	ITEM	UNIT	TOTAL QUANTITIES	ROADWAY 0004				
*78000100	THERMOPLASTIC PAVEMENT MARKING - LETTERS AND SYMBOLS	SO FT	200	200				
72800100	TELESCOPING STEEL SIGN SUPPORT	Foot	30	30				
*78000200	THERMOPLASTIC PAVEMENT MARKING - LINE 4"	FOOT	35500	35500				
*78000400	THERMOPLASTIC PAVEMENT MARKING - LINE 6"	FOOT	250	250				
*78000600	THERMOPLASTIC PAVEMENT MARKING - LINE 12"	FOOT	120	120				
*78000650	THERMOPLASTIC PAVEMENT MARKING - LINE 24"	FOOT	60	60				
*78100100	RAISED REFLECTIVE PAVEMENT MARKER	EACH	392	392				
78300200	RAISED REFLECTIVE PAVEMENT MARKER REMOVAL	EACH	350	350				
*85000200	MAINTENANCE OF EXISTING TRAFFIC SIGNAL INSTALLATION	EACH	1	1				
*88600600	DETECTOR LOOP REPLACEMENT	FOOT	260	260				
*89502376	REBUILD EXISTING HANDHOLE	EACH	1	1				
*89502378	REBUILD EXISTING HANDHOLE TO HEAVY-DUTY HANDHOLE	EACH	1	1				
K1005863	TREE ROOT PRUNING	EACH	5	5				
*X0322936	REMOVE EXISTING FLARED END SECTION	EACH	2	2				

SUMMARY OF QUANTITIES				CONSTRUCTION TYPE CODE				
CODE NO	ITEM	UNIT	TOTAL QUANTITIES	ROADWAY 0004				
X2020110	GRADING AND SHAPING SHOULDERS	UNIT	125	125				
X0327980	PAVEMENT MARKING REMOVAL - WATER BLASTING	SQ FT	600	600				
X4400100	PORTLAND CEMENT CONCRETE SURFACE REMOVAL (VARIABLE DEPTH)	SO YD	1137	1137				
X5537800	STORM SEWERS TO BE CLEANED 12"	FOOT	1328	1328				
X7010216	TRAFFIC CONTROL AND PROTECTION (SPECIAL)	LSUM	1	1				
X2043900	PREFORMED JOINT FILLER REMOVAL	FOOT	2346	2346				
Z0013798	CONSTRUCTION LAYOUT	LSUM	1	1				
Z0018500	DRAINAGE STRUCTURES TO BE CLEANED	EACH	22	22				
Z0018700	DRAINAGE STRUCTURE TO BE REMOVED	EACH	7	7				
Z0030850	TEMPORARY INFORMATION SIGNING	SO FT	104	104				
Z0064800	SELECTIVE CLEARING	UNIT	7	7				

FILE NAME	USER NAME	DESIGNED	REVISED
		DRAWN	REVISED
		CHECKED	REVISED
		DATE	REVISED


STATE OF ILLINOIS  
DEPARTMENT OF TRANSPORTATION

SUMMARY OF QUANTITIES


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F.A.L. REC.	SECTION	COUNTY	TOTAL SHEETS	SHEET NO.
1632	498-RS	COOK	48	7
FED. ROAD DIST. NO. 1 ILLINOIS FED. AID PROJECT			CONTRACT NO. 60X38	


\* SPECIALTY ITEM    □ NON-PART. (100% STATE)

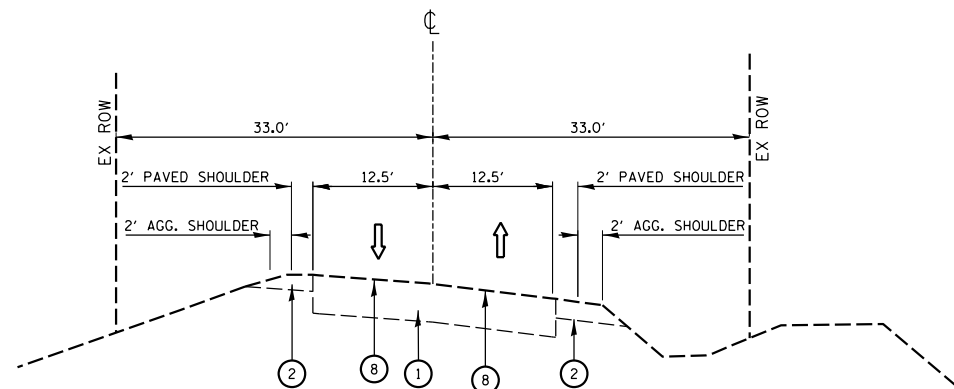


**EXISTING TYPICAL SECTION**  
SAUK TRAIL  
STA. 51+85 TO STA. 55+00

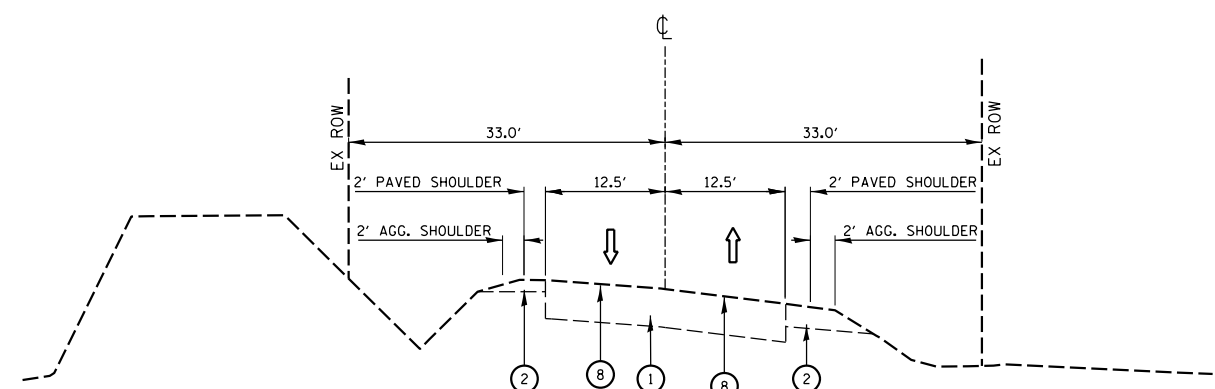

**EXISTING TYPICAL SECTION**  
SAUK TRAIL  
STA. 55+00 TO STA. 61+60

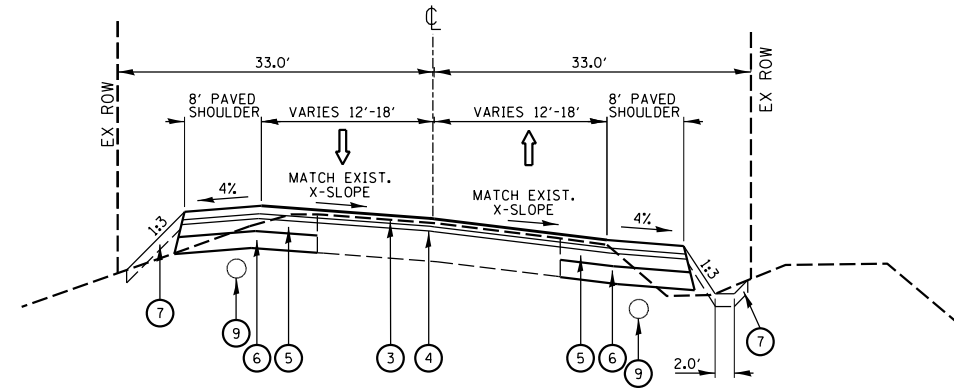

**PROPOSED TYPICAL SECTION**  
SAUK TRAIL  
STA. 51+85 TO STA. 55+00

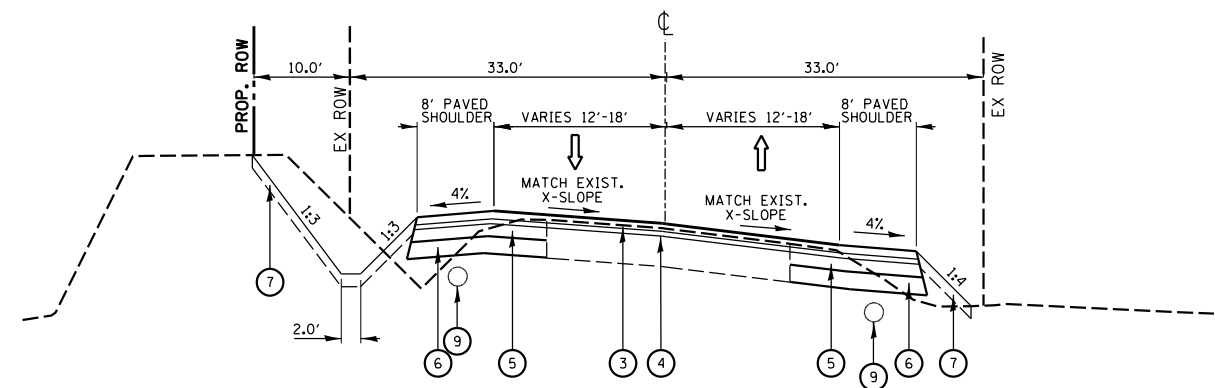

**PROPOSED TYPICAL SECTION**  
SAUK TRAIL  
STA. 55+00 TO STA. 61+60

- ① EXISTING HMA SURFACE
- ② EXISTING SHOULDER
- ③ PROPOSED POLY. HMA SURFACE COURSE, MIX "E", N70, 1 3/4"
- ④ PROPOSED POLYMERIZED LEVELING BINDER (MM), IL-4.75, N50, 3/4"
- ⑤ PROPOSED HMA BASE COURSE, 6 1/2"
- ⑥ PROPOSED AGGREGATE SUBGRADE IMPROVEMENT, 12"
- ⑦ PROPOSED TOPSOIL, 6"
- ⑧ PROPOSED HMA SURFACE REMOVAL, 2 1/2"
- ⑨ PROPOSED PIPE UNDERDRAINS

**NOTE:**

THE UNIT WEIGHT USED TO CALCULATE ALL HOT-MIX ASPHALT QUANTITIES IS 112 LBS./SQ. YD./ IN.

THE "AC TYPE" FOR POLYMERIZED HMA MIXES SHALL BE "SBS/SBR PG 76-22" AND FOR NON-POLYMERIZED HMA THE "AC TYPE" SHALL BE "PG 64-22" UNLESS MODIFIED BY DISTRICT ONE SPECIAL PROVISIONS

FOR THE USE OF RECYCLED MATERIALS SEE SPECIAL PROVISIONS

QUALITY MANAGEMENT PROGRAM (QMP) IDENTIFIES THE PARTICULAR QUALITY CONTROL SPECIFICATION THAT APPLIES TO THE HMA MIXTURE

CONTRACTOR SHALL PATCH FIRST BEFORE MILLING

**MIXTURE REQUIREMENTS**

MIXTURE PURPOSE	MIXTURE USE	AIR VOIDS @ND5	QMP
PATCHING	HOT-MIX ASPHALT REPLACEMENT OVER PATCHES, (HMA BINDER IL-19MM)	4% @ 70 GYR	OC/OA
PATCHING	CLASS "D" PATCHES, (HMA BINDER IL-19MM)	4% @ 70 GYR	OC/OA
RESURFACING/WIDENING/SHOULDER	POLYMERIZED HOT-MIX ASPHALT SURFACE COURSE, MIX "E", N70, IL-9.5MM	4% @ 70 GYR	OCP
RESURFACING/WIDENING/SHOULDER	POLYMERIZED LEVELING BINDER (MACHINE METHOD), IL-4.75MM, N50	3.5% @ 50 GYR	OCP
WIDENING/SHOULDER	HMA BASE COURSE, 6 1/2" (HMA BINDER IL-19.0)	4% @ 70 GYR	OCP
DRIVEWAYS	HOT-MIX ASPHALT BASE COURSE, PE - 6" & CE - 8", (HMA BINDER IL-19MM)	4% @ 50 GYR	OC/OA
DRIVEWAYS	HOT-MIX ASPHALT SURFACE COURSE, MIX "D", N50, IL-9.5MM	4% @ 50 GYR	OC/OA
MEDIAN	HOT-MIX ASPHALT SURFACE COURSE, MIX "D", N50 (IL-9.5 MM) - 2"	4% @ 50 GYR	OC/OA
MEDIAN	HOT-MIX ASPHALT BASE COURSE (HMA BINDER IL-19 MM) - 10"	4% @ 50 GYR	OC/OA
SHOULDER REPAIR	HOT-MIX ASPHALT BINDER COURSE, IL-19.0, N70	4% @ 70 GYR	OC/OA

QMP DESIGNATIONS: QUALITY CONTROL/QUALITY ASSURANCE (OC/OA); QUALITY CONTROL FOR PERFORMANCE (OCP); PAY FOR PERFORMANCE (PFP)

FILE NAME =	USER NAME = qureshiya	DESIGNED -	REVISED -
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	PLOT DATE = 11/22/2016	DATE -	REVISED -


**STATE OF ILLINOIS**  
**DEPARTMENT OF TRANSPORTATION**

**SAUK TRAIL at BURNHAM AVE.**  
**TYPICAL SECTIONS**


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F.A.U. RTE.	SECTION	COUNTY	TOTAL SHEETS	SHEET NO.
1632	49B-RS	COOK	48	8
CONTRACT NO. 60X38			ILLINOIS FED. AID PROJECT	




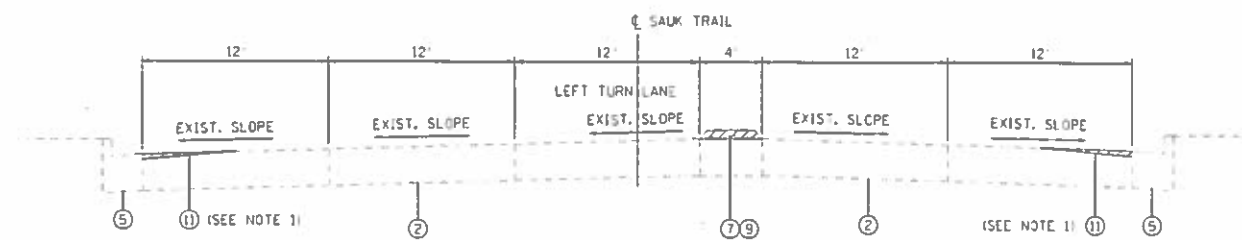


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SAUK TRAIL  
STA. 400+74 TO STA. 403+01

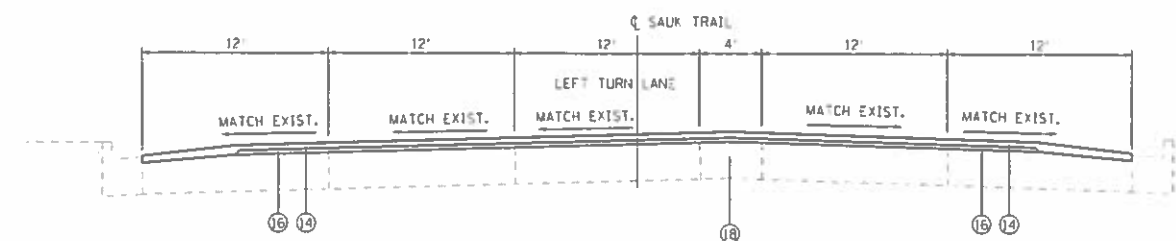


**PROPOSED TYPICAL SECTION**  
SAUK TRAIL  
STA. 400+74 TO STA. 403+01

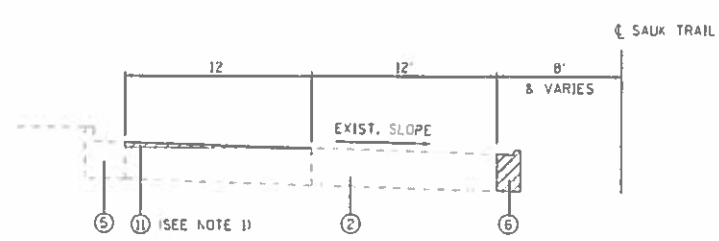

**EXISTING TYPICAL SECTION**  
STA. 405+25 TO STA. 408+43

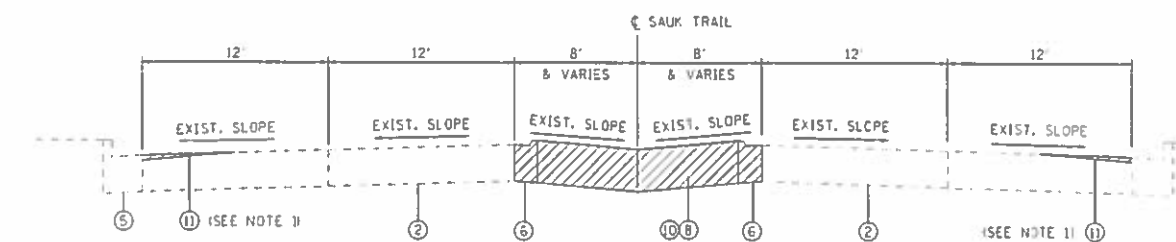


**EXISTING TYPICAL SECTION**  
SAUK TRAIL  
STA. 403+01 TO STA. 408+43

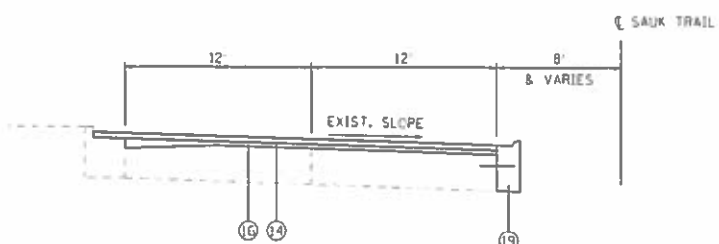

**PROPOSED TYPICAL SECTION**  
STA. 405+25 TO STA. 408+43

**SUPERELEVATION SECTION (WB)**

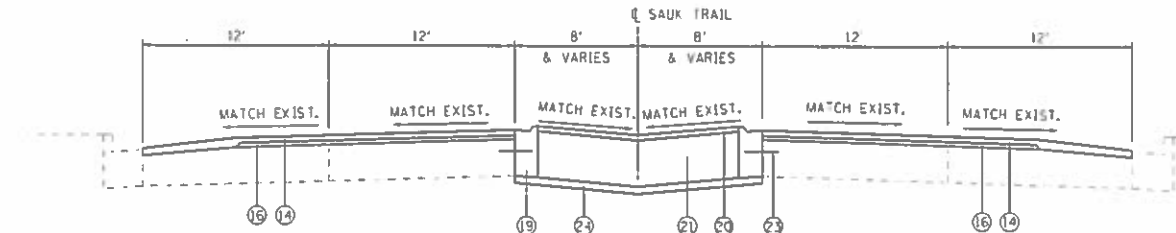

**PROPOSED TYPICAL SECTION**  
SAUK TRAIL  
STA. 403+01 TO STA. 408+43

**LEGEND**

- ① EXISTING BITUMINOUS SURFACE +/-5"
- ② EXISTING P.C.C. PAVEMENT +/-9"
- ③ EXISTING BITUMINOUS SHOULDER
- ④ EXISTING AGGREGATE SHOULDER
- ⑤ EXISTING B-6.24 CURB AND GUTTER
- ⑥ EXISTING M-2.12 CURB AND GUTTER
- ⑦ EXISTING CORRUGATED MEDIAN
- ⑧ EXISTING HMA 12"
- ⑨ MEDIAN REMOVAL PARTIAL DEPTH
- ⑩ PAVEMENT REMOVAL 12"
- ⑪ PORTLAND CEMENT CONCRETE SURFACE REMOVAL VARIABLE DEPTH, 2 1/4"
- ⑫ HMA SURFACE REMOVAL - 2 1/2" (SEE NOTE 2)
- ⑬ HMA SURFACE REMOVAL - 2 1/4" (SEE NOTE 2)
- ⑭ POLYMERIZED HOT-MIX ASPHALT SURFACE COURSE, MIX "E", N70-13 1/4"
- ⑮ POLYMERIZED LEVELING BINDER (MACHINE METHOD), IL-4.75, NS0-3 1/4"
- ⑯ POLYMERIZED LEVELING BINDER (MACHINE METHOD), IL-4.75, NS0-1"
- ⑰ HMA BINDER COURSE, IL-19.0, N70 - 2 1/4"
- ⑱ PROPOSED MEDIAN
- ⑲ PROPOSED M-2.12 CURB AND GUTTER
- ⑳ PROPOSED HOT MIX ASPHALT SURFACE COURSE, MIX "D", NS0-2"
- ㉑ PROPOSED HOT MIX ASPHALT BASE COURSE, 10"
- ㉒ GRADING AND SHAPING SHOULDERS & AGGREGATE WEDGE SHOULDER, TYPE B
- ㉓ TIE BARS 3/4" @ 24" CENTERS
- ㉔ AGGREGATE BASE COURSE, TYPE B 2"

**NOTES**

- 1. SEE DISTRICT ONE DETAIL (BD33) HMA TAPER AT EDGE OF P.C.C. PAVEMENT
- 2. THE CONTRACTOR SHALL PERFORM THE PAVEMENT PATCHING OPERATIONS PRIOR TO THE HMA SURFACE REMOVAL OPERATION. SEE IDOT DISTRICT 1 DETAIL PAVEMENT PATCHING FOR HMA SURFACE PAVEMENT BD-400-04 (BD-22) FOR ADDITIONAL INFORMATION.

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 PLOT SCALE: 1/8"=1'-0"  
 USER NAME: Millennium Professional Services

2400 Warranville Road, Suite 203, Downers Grove, IL 60515  
 630.785.0110 voice, 630.239.2566 fax  
 www.mps-ill.com  
**MILLENNIA PROFESSIONAL SERVICES**



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DRAWN - JP	REVISED -
CHECKED - TVN	REVISED -
DATE - 9/12/2016	REVISED -

**STATE OF ILLINOIS**  
**DEPARTMENT OF TRANSPORTATION**

<b>MAINLINE TYPICAL SECTIONS</b>			
<b>SAUK TRAIL</b>			
SCALE:	SHEET NO.	OF	SHEETS

F.A.P. RTE.	SECTION	COUNTY	TOTAL SHEETS	SHEET NO.
1632	49R-RS	COOK	48	9
CONTRACT NO. 60438				

TYP-01





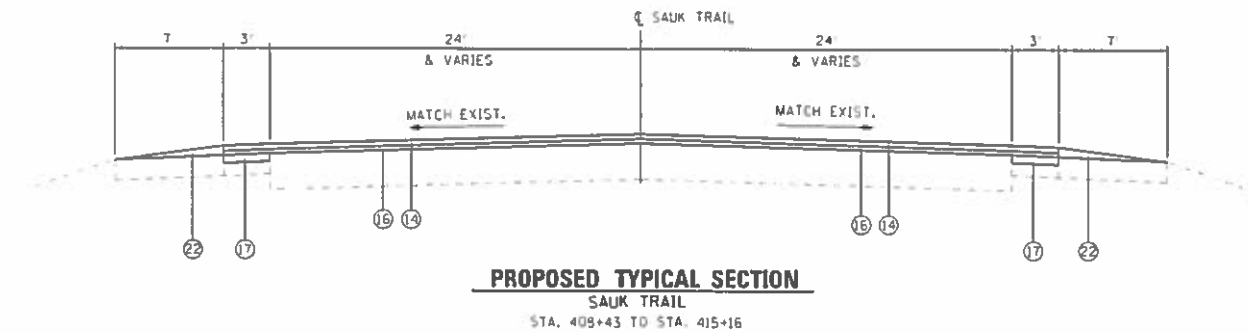
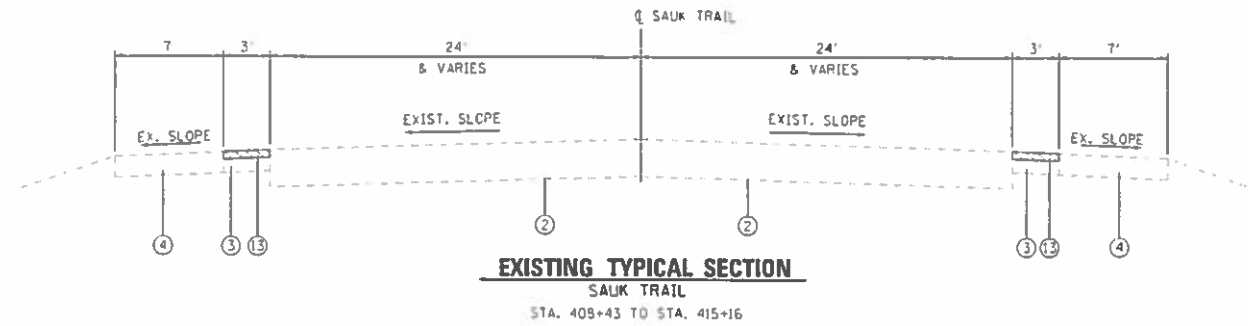


**LEGEND**

- ① EXISTING BITUMINOUS SURFACE +/-6"
- ② EXISTING P.C.C. PAVEMENT +/-9"
- ③ EXISTING BITUMINOUS SHOULDER
- ④ EXISTING AGGREGATE SHOULDER
- ⑤ EXISTING B-6.24 CURB AND GUTTER
- ⑥ EXISTING M-2.12 CURB AND GUTTER
- ⑦ EXISTING CORRUGATED MEDIAN
- ⑧ EXISTING HMA 12"
- ⑨ MEDIAN REMOVAL PARTIAL DEPTH
- ⑩ PAVEMENT REMOVAL 12"
- ⑪ PORTLAND CEMENT CONCRETE SURFACE REMOVAL VARIABLE DEPTH
- ⑫ HMA SURFACE REMOVAL - 2 1/2" (SEE NOTE 2)
- ⑬ HMA SURFACE REMOVAL - 2 1/4" (SEE NOTE 2)
- ⑭ POLYMERIZED HOT-MIX ASPHALT SURFACE COURSE, MIX "E", N70-13 1/4"
- ⑮ POLYMERIZED LEVELING BINDER (MACHINE METHOD), IL-4.75, NS0-3/4"
- ⑯ POLYMERIZED LEVELING BINDER (MACHINE METHOD), IL-4.75, NS0-1"
- ⑰ HMA BINDER COURSE, IL-19.0, N70 - 2 1/4"
- ⑱ PROPOSED MEDIAN
- ⑲ PROPOSED M-2.12 CURB AND GUTTER
- ⑳ PROPOSED HOT MIX ASPHALT SURFACE COURSE, MIX "D", NS0-2"
- ㉑ PROPOSED HOT MIX ASPHALT BASE COURSE, 10"
- ㉒ GRADING AND SHAPING SHOULDERS & AGGREGATE WEDGE SHOULDER, TYPE B
- ㉓ TIE BARS 3/4" @ 24" CENTERS

**NOTES**

1. SEE DISTRICT ONE DETAIL (BD33) HMA TAPER AT EDGE OF P.C.C. PAVEMENT
2. THE CONTRACTOR SHALL PERFORM THE PAVEMENT PATCHING OPERATIONS PRIOR TO THE HMA SURFACE REMOVAL OPERATION. SEE IDOT DISTRICT 1 DETAIL PAVEMENT PATCHING FOR HMA SURFACED PAVEMENT BD-400-04 (BD-22) FOR ADDITIONAL INFORMATION.

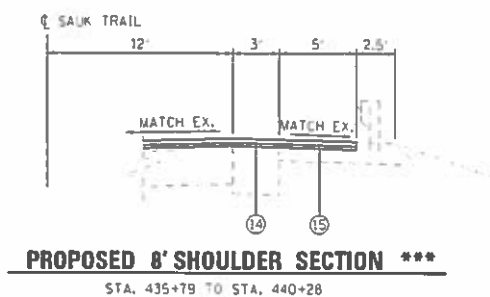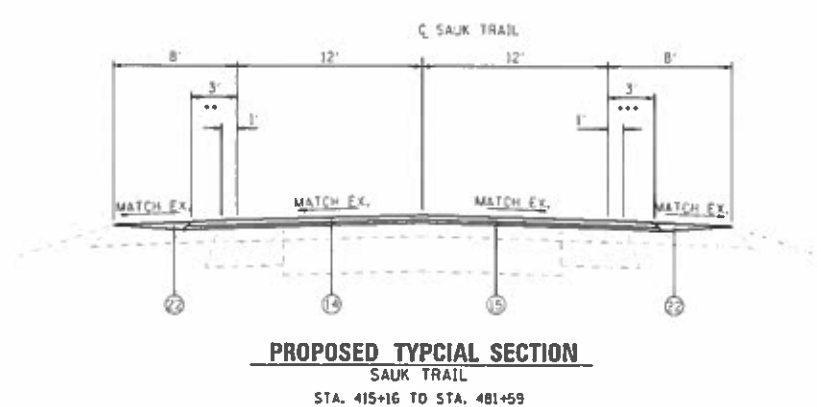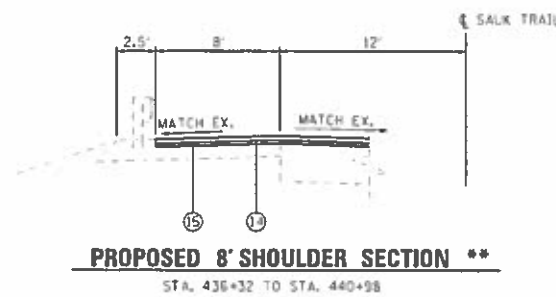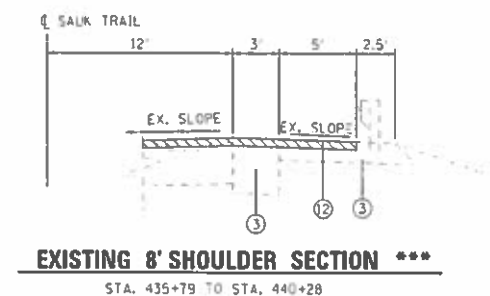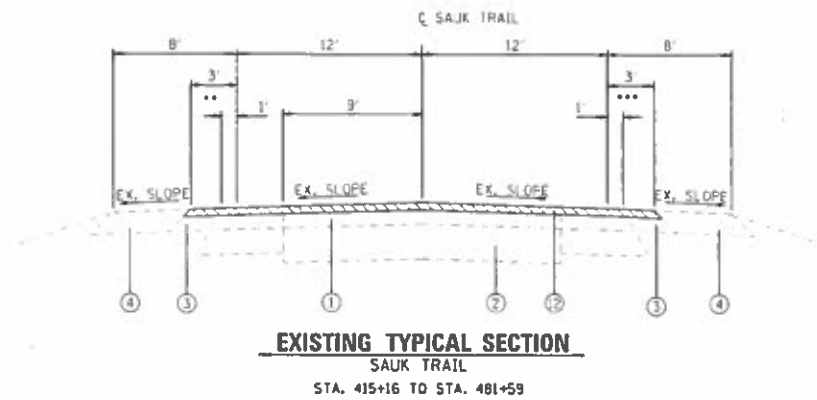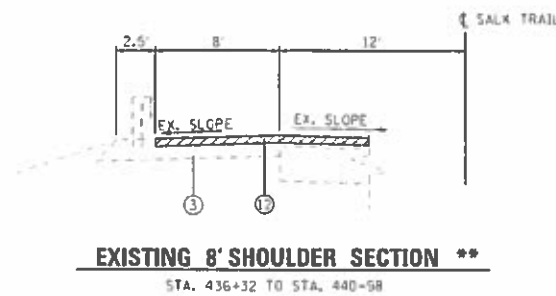

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 PLOT DATE: 12/22/2016 11:45:00 AM  
 MILLENIA PROFESSIONAL SERVICES

2400 Warneville Road, Suite 103, Downers Grove, IL 60515  
 630.795.8310 voice, 630.839.2566 fax  
 www.mps-ill.com  
**MILLENNIA PROFESSIONAL SERVICES**

DESIGNED - TVN	REVISED -
DRAWN - JP	REVISED -
CHECKED - TVN	REVISED -
DATE - 9/12/2016	REVISED -

**STATE OF ILLINOIS**  
**DEPARTMENT OF TRANSPORTATION**

<b>MAINLINE TYPICAL SECTIONS</b>			
<b>SAUK TRAIL</b>			
SCALE:	SHEET NO.	OF SHEETS	STA. TO STA.


F.A.P. RTE.	SECTION	COUNTY	TOTAL SHEETS	SHEET NO.
1632	49R-RS	COOK	45	10
FED. ROAD DIST. NO. 1 (IL-3H015) FED. AID PROJECT			CONTRACT NO. 60X38	

**TYP-02**

P:\2014\ME14027\_Ver-Vor-Phil\W016\_Sauk\_Trail\Updates\CADD\Shk\04-DIGBP22-ent-typ01a.dgn

SCHEDULE OF QUANTITIES (EARTHWORK)						
1	2	3	4	5	6	7
THORNTON-LANSING RD. AT STONY ISLAND AVE.	EARTH EXCAVATION (CU YD)	UNSUITABLE MATERIAL (CU YD)	EMBANKMENT (CU YD)	ADJUSTMENT FOR SHRINKAGE (CU YD)	FURNISHED EXCAVATION (CU YD)	TOP SOIL FURNISH AND PLACE (SQ YD)
SAUK TRAIL	1376	767	178	207	29	400
<b>TOTAL</b>	<b>1376</b>	<b>767</b>	<b>178</b>	<b>207</b>	<b>29</b>	<b>400</b>
<p>COLUMN 1: LOCATION FROM PLANS  COLUMN 2: CUT QUANTITIES AFTER UNSUITABLE MATERIAL IS REMOVED  COLUMN 3: MATERIAL THAT IS DETERMINED TO BE EITHER UNSTABLE OR UNSUITABLE FOR USE IN EMBANKMENT (TOP SOIL EXCAVATED AT 12" (150 MM) AVERAGE DEPTH)  COLUMN 4: FILL QUANTITIES AFTER UNSUITABLE MATERIAL IS REMOVED  COLUMN 5: EARTH EXCAVATION THAT IS TO BE USED AS FILL MATERIAL IN THE EMBANKMENT, SHRINKAGE FACTOR WAS DETERMINED TO BE 15%  COLUMN 6: COLUMN 5 - COLUMN 4, POSITIVE QUANTITY= FURNISHED EXCAVATION, NEGATIVE QUANTITY= BORROW EXCAVATION  COLUMN 7: TOPSOIL FURNISH AND PLACE= AREA OF SODDING</p>						

**NOTE:** THE TOP 6" OF TOPSOIL IS TO BE REMOVED AND PAID FOR AS REMOVAL AND DISPOSAL OF UNSUITABLE MATERIAL.

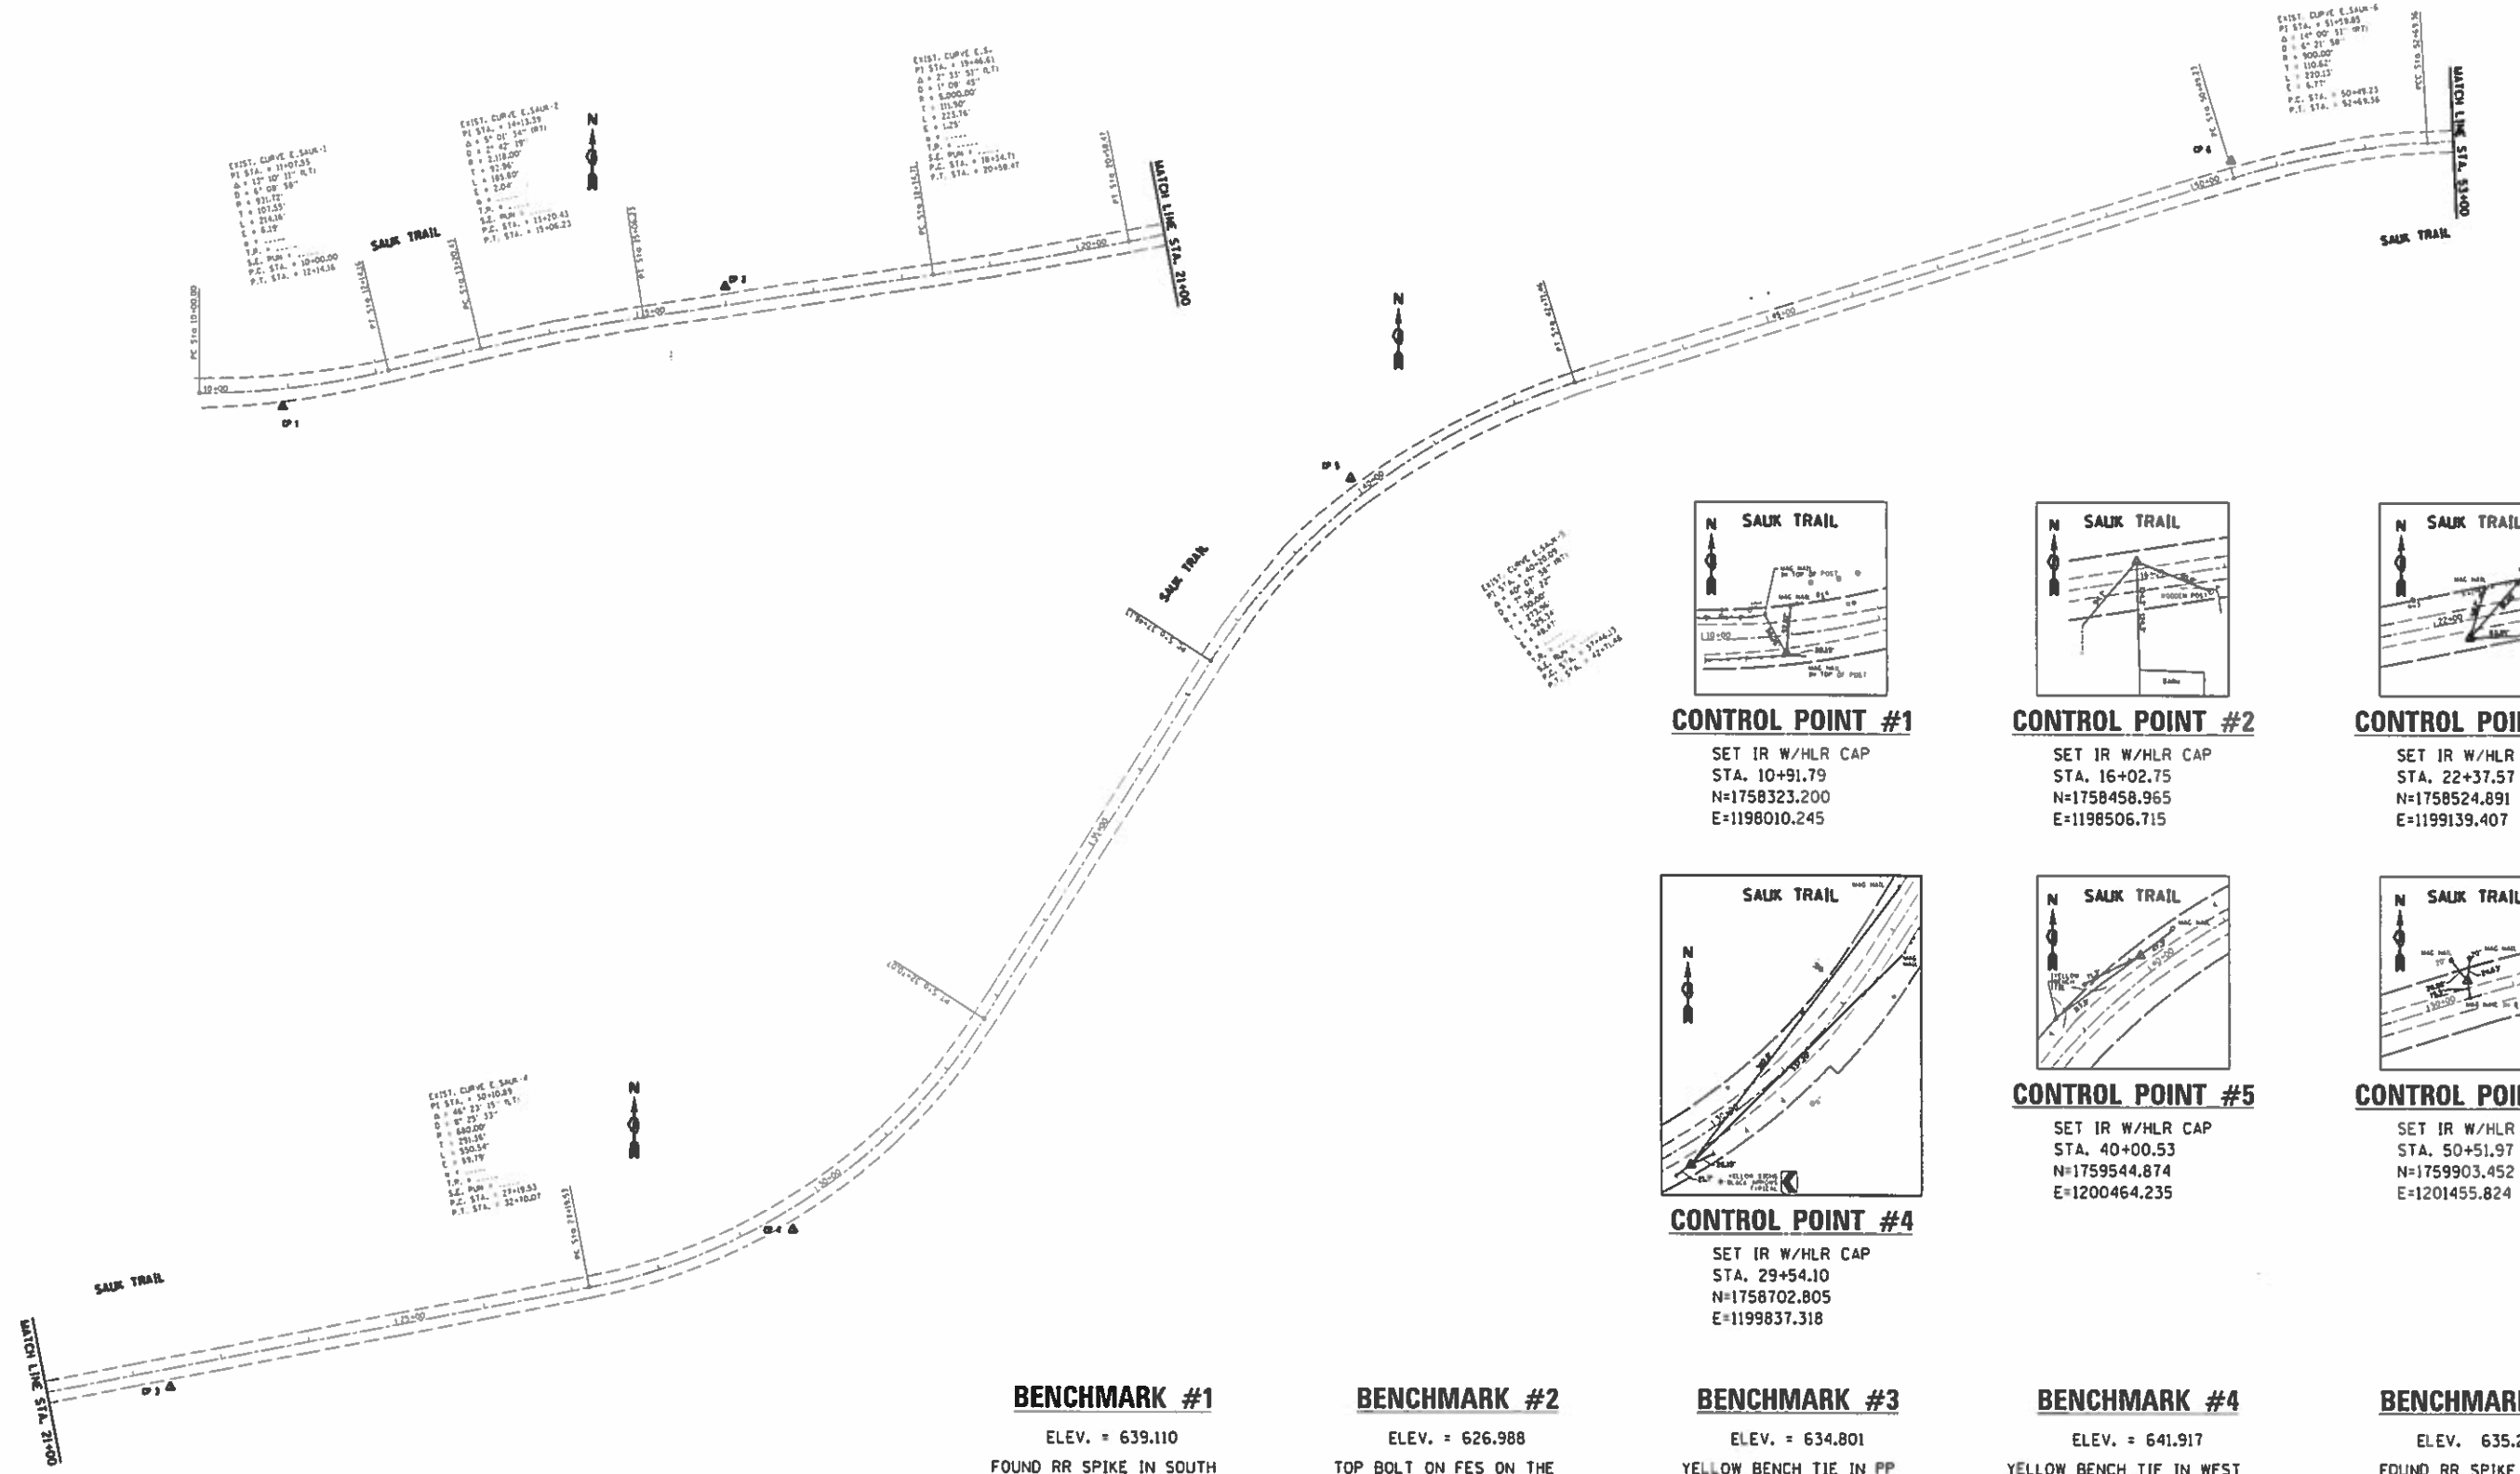

EXIST. CURVE E. SAUK-1  
 P.I. STA. = 11+07.33  
 Δ = 17° 00' 38"  
 D = 67.21  
 R = 931.72  
 T = 101.55  
 L = 314.38  
 E = 6.29  
 P.C. STA. = 10+00.00  
 P.T. STA. = 12+14.26

EXIST. CURVE E. SAUK-2  
 P.I. STA. = 14+13.39  
 Δ = 5° 01' 34"  
 D = 27.42  
 R = 6200.00  
 T = 238.00  
 L = 188.00  
 E = 2.04  
 P.C. STA. = 12+00.00  
 P.T. STA. = 14+06.23

EXIST. CURVE E.S.  
 P.I. STA. = 19+46.61  
 Δ = 2° 33' 37"  
 D = 17.09  
 R = 6200.00  
 T = 111.90  
 L = 223.16  
 E = 4.23  
 P.C. STA. = 18+14.17  
 P.T. STA. = 20+58.47

EXIST. CURVE E. SAUK-6  
 P.I. STA. = 51+15.83  
 Δ = 14° 00' 31"  
 D = 67.21  
 R = 900.00  
 T = 110.62  
 L = 270.33  
 E = 4.75  
 P.C. STA. = 50+49.23  
 P.T. STA. = 52+49.36

EXIST. CURVE E. SAUK-4  
 P.I. STA. = 30+00.00  
 Δ = 46° 23' 33"  
 D = 87.25  
 R = 640.00  
 T = 270.26  
 L = 300.54  
 E = 59.19  
 P.C. STA. = 27+18.53  
 P.T. STA. = 32+18.07

EXIST. CURVE E. SAUK-3  
 P.I. STA. = 15+00.00  
 Δ = 10° 00' 00"  
 D = 100.00  
 R = 572.96  
 T = 173.21  
 L = 314.16  
 E = 10.00  
 P.C. STA. = 14+00.00  
 P.T. STA. = 16+00.00


**BENCHMARK #1**  
 ELEV. = 639.110  
 FOUND RR SPIKE IN SOUTH FACE OF PP. NORTH SIDE OF SAUK TRAIL. EAST OF BIT. FIELD ENTRANCE. ±400' WEST OF ENTRANCE TO \*2730 SAUK TRAIL

**BENCHMARK #2**  
 ELEV. = 626.988  
 TOP BOLT ON FES ON THE SOUTH OF SAUK TRAIL ±50' WEST OF THE GUARDRAIL END AND ±800' WEST OF THE MOOSE LODGE ENTRANCE.


**BENCHMARK #3**  
 ELEV. = 634.801  
 YELLOW BENCH TIE IN PP W/LIGHT S.W. SIDE OF ENTRANCE TO MOOSE LODGE

**BENCHMARK #4**  
 ELEV. = 641.917  
 YELLOW BENCH TIE IN WEST FACE OF PP S.E. CORNER OF SAUK TRAIL AND BURNHAM AVE.


**BENCHMARK #5**  
 ELEV. = 635.235  
 FOUND RR SPIKE IN PP AT THE S.W. CORNER OF SUNSET LANE AND SAUK TRAIL.

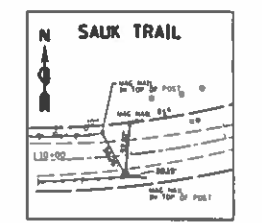


**CONTROL POINT #1**  
 SET IR W/HLR CAP  
 STA. 10+91.79  
 N=1758323.200  
 E=1198010.245

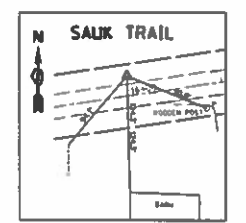


**CONTROL POINT #2**  
 SET IR W/HLR CAP  
 STA. 16+02.75  
 N=1758458.965  
 E=1198506.715

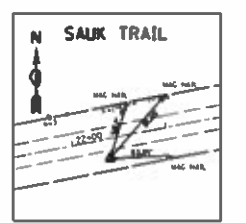

**CONTROL POINT #3**  
 SET IR W/HLR CAP  
 STA. 22+37.57  
 N=1758524.891  
 E=1199139.407

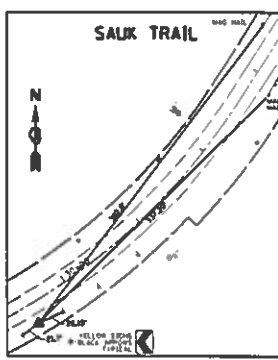

**CONTROL POINT #4**  
 SET IR W/HLR CAP  
 STA. 29+54.10  
 N=1758702.805  
 E=1199837.318


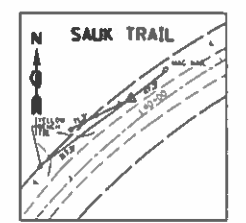


**CONTROL POINT #5**  
 SET IR W/HLR CAP  
 STA. 40+00.53  
 N=1759544.874  
 E=1200464.235




**CONTROL POINT #6**  
 SET IR W/HLR CAP  
 STA. 50+51.97  
 N=1759903.452  
 E=1201455.824

FILE NAME =	USER NAME = qureshiya	DESIGNED =	REVISED =	<b>STATE OF ILLINOIS DEPARTMENT OF TRANSPORTATION</b>	<b>ALIGNMENTS, TIES AND BENCHMARKS SAUK TRAIL AT BURNHAM AVENUE</b>	F.A.U. RTE.	SECTION	COUNTY	TOTAL SHEETS	SHEET NO.	
Default	10/26/2016	DRAWN =	REVISED =			1632	49-N	COOK	12	12	
		CHECKED =	REVISED =			CONTRACT NO. 60X38					
		DATE =	REVISED =			[ILLINOIS] FED. AID PROJECT					

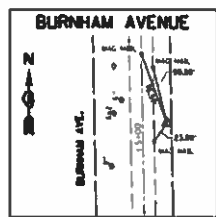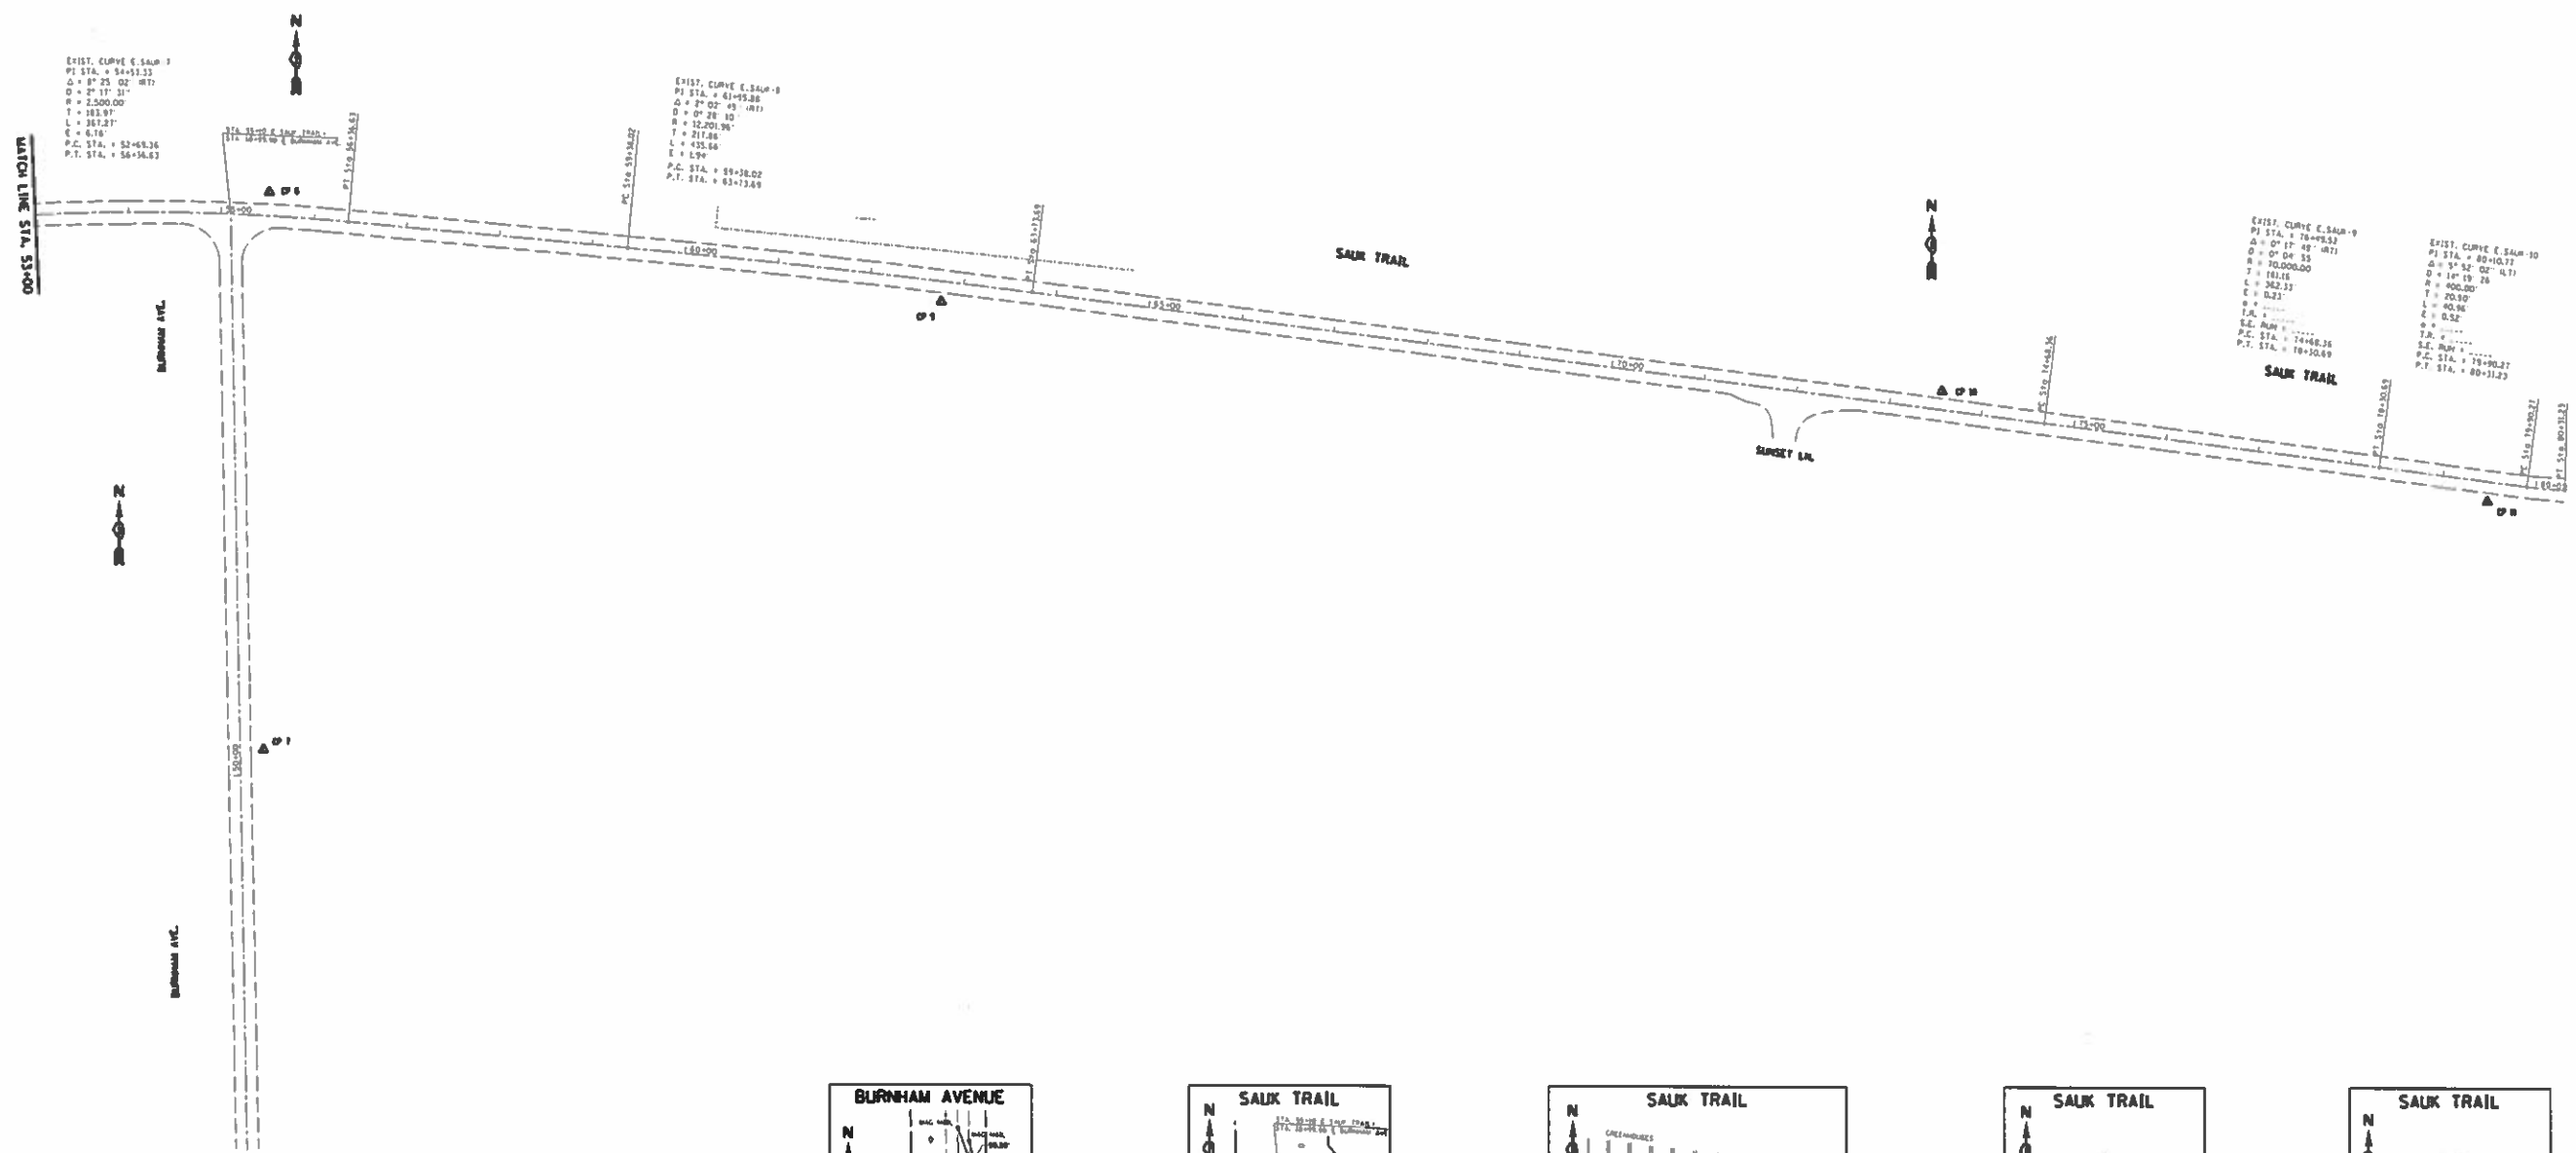


**CONTROL POINT #7**

SET IR W/HLR CAP  
 STA. 5+27.75  
 N=1759354.099  
 E=1201950.766

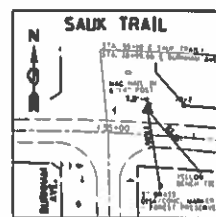


**CONTROL POINT #8**

SET IR W/HLR CAP  
 STA. 55+50.57  
 N=1759949.871  
 E=1201957.456

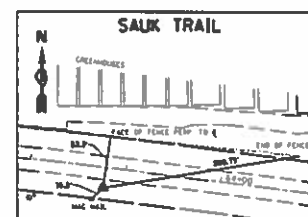

**CONTROL POINT #9**

SET IR W/HLR CAP  
 STA. 62+78.20  
 N=1759834.824  
 E=1202677.915

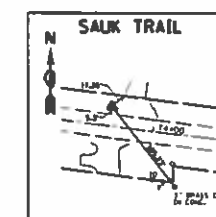

**CONTROL POINT #10**

SET IR W/HLR CAP  
 STA. 73+54.43  
 N=1759742.174  
 E=1203750.820



**CONTROL POINT #11**


SET IR W/HLR CAP  
 STA. 79+50.67  
 N=1759625.414  
 E=1204336.945

FILE NAME =	USER NAME = qureshiya	DESIGNED =	REVISED =	<b>STATE OF ILLINOIS DEPARTMENT OF TRANSPORTATION</b>	<b>ALIGNMENTS, TIES AND BENCHMARKS SAUK TRAIL AT BURNHAM AVENUE</b>	F.A.U. RTE.	SECTION	COUNTY	TOTAL SHEETS	SHEET NO.	
Default	012-ah-ATB.dgn	DRAWN =	REVISED =			1632	49-N	COOK	13	13	
	PLOT SCALE = 200.0000 / in.	CHECKED =	REVISED =			CONTRACT NO. 60X38					
	PLOT DATE = 10/26/2016	DATE =	REVISED =			ILLINOIS FED. AID PROJECT					



**DRAINAGE LEGEND**

- [A] FRAMES AND GRATES TO BE ADJUSTED
- [C] STRUCTURE TO BE CLEANED
- [SP] FRAMES AND LIDS TO BE ADJUSTED SPECIAL
- [REC] STRUCTURE TO BE RECONSTRUCTED
- [H] REBUILD EXISTING HANDHOLE
- [H+] REBUILD EXISTING HANDHOLE TO HEAVY-DUTY HANDHOLE

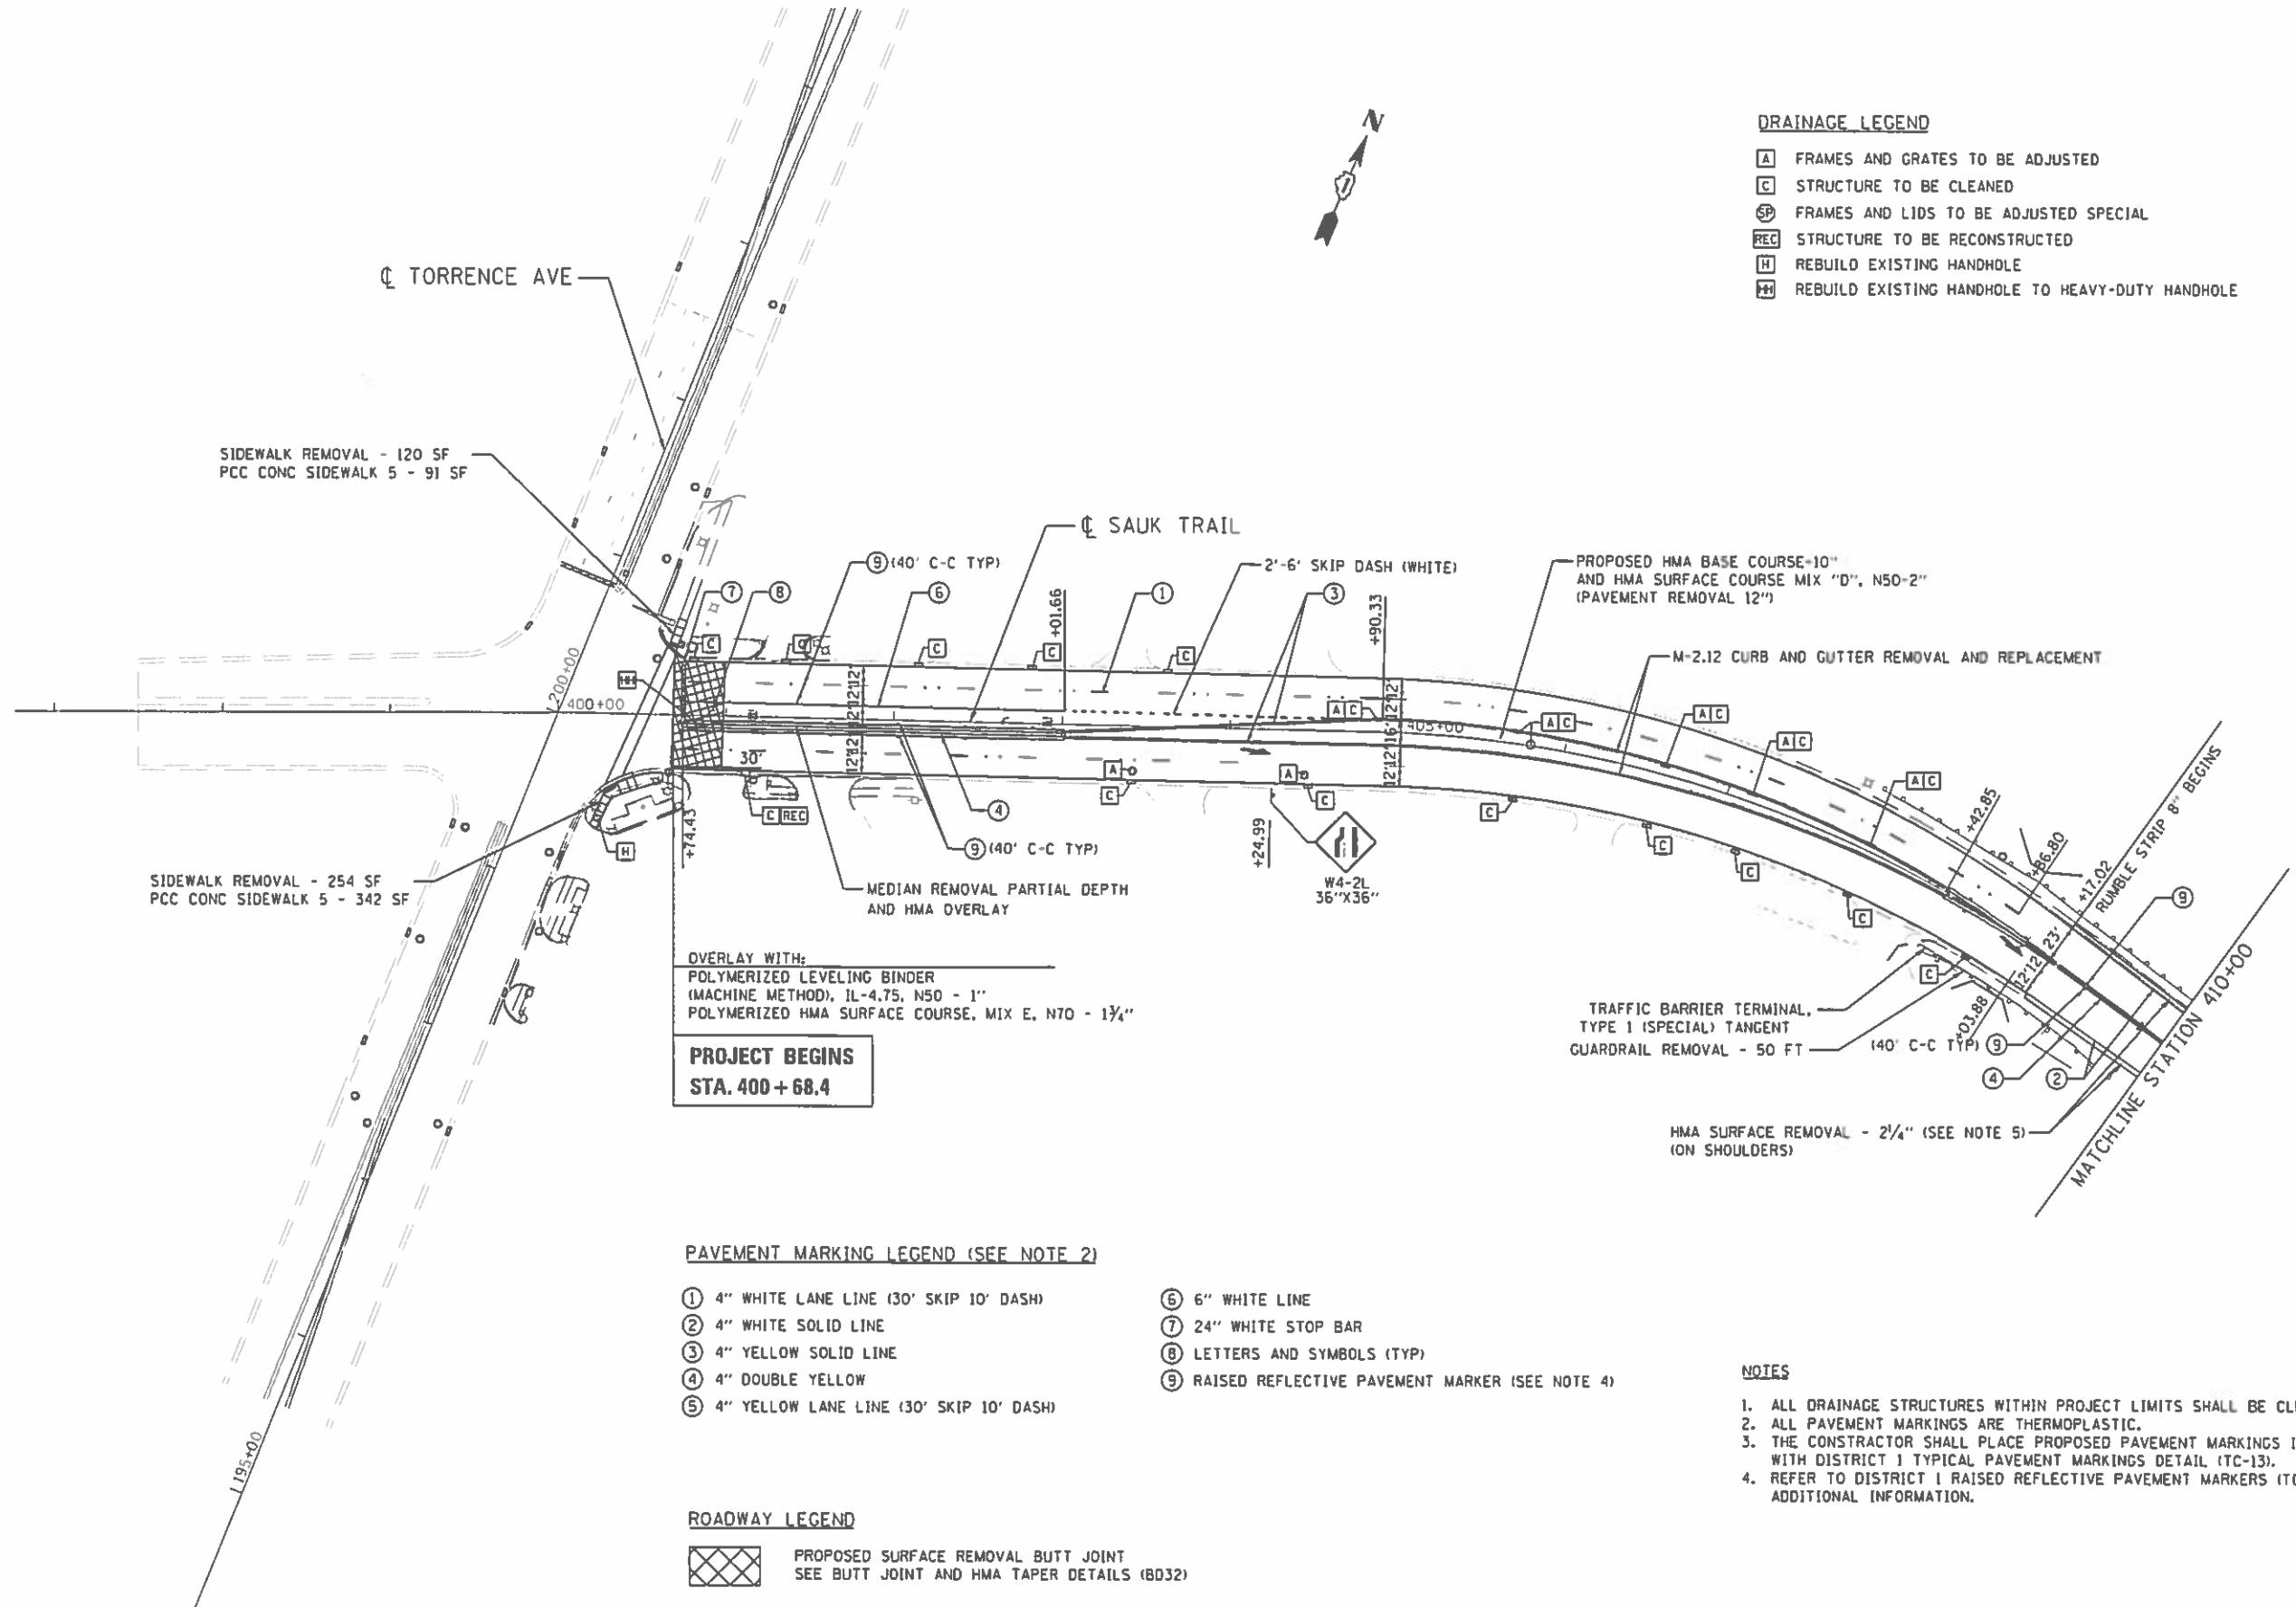

**PAVEMENT MARKING LEGEND (SEE NOTE 2)**

- ① 4" WHITE LANE LINE (30' SKIP 10' DASH)
- ② 4" WHITE SOLID LINE
- ③ 4" YELLOW SOLID LINE
- ④ 4" DOUBLE YELLOW
- ⑤ 4" YELLOW LANE LINE (30' SKIP 10' DASH)
- ⑥ 6" WHITE LINE
- ⑦ 24" WHITE STOP BAR
- ⑧ LETTERS AND SYMBOLS (TYP)
- ⑨ RAISED REFLECTIVE PAVEMENT MARKER (SEE NOTE 4)

**ROADWAY LEGEND**

[Hatched Box] PROPOSED SURFACE REMOVAL BUTT JOINT  
SEE BUTT JOINT AND HMA TAPER DETAILS (BD32)

**NOTES**

1. ALL DRAINAGE STRUCTURES WITHIN PROJECT LIMITS SHALL BE CLEANED.
2. ALL PAVEMENT MARKINGS ARE THERMOPLASTIC.
3. THE CONSTRUCTOR SHALL PLACE PROPOSED PAVEMENT MARKINGS IN ACCORDANCE WITH DISTRICT 1 TYPICAL PAVEMENT MARKINGS DETAIL (TC-13).
4. REFER TO DISTRICT 1 RAISED REFLECTIVE PAVEMENT MARKERS (TC-11) FOR ADDITIONAL INFORMATION.

FILE NAME: P:\2814\14827\_VerVar\_Phil\016\_Sauk Trail\Updates\TAD\Skus\016BP22-ht-plan-Bldgn  
 USER: phil  
 MILL: phil



1600 Warrsville Road, Suite 103, Downers Grove, IL 60515  
 630.705.8118 voice, 630.839.2566 fax  
 www.mps-ill.com  
**MILLENNIA PROFESSIONAL SERVICES**

DESIGNED	TYN	REVISED	
DRAWN	JP	REVISED	
CHECKED	TYN	REVISED	
DATE	11/4/2016	REVISED	


**STATE OF ILLINOIS  
DEPARTMENT OF TRANSPORTATION**

**ROADWAY PLAN  
SAUK TRAIL**

SCALE: 1"=50' SHEET NO. OF 1 SHEETS STA. 398+50 TO STA. 410+00

F.A.P. RTE.	SECTION	COUNTY	TOTAL SHEETS	SHEET NO.
1632	49R-RS	COOK	48	15
FED. ROAD DIST. NO. 1   ILLINOIS FED. AID PROJECT			CONTRACT NO. 60X38	

PLN-01

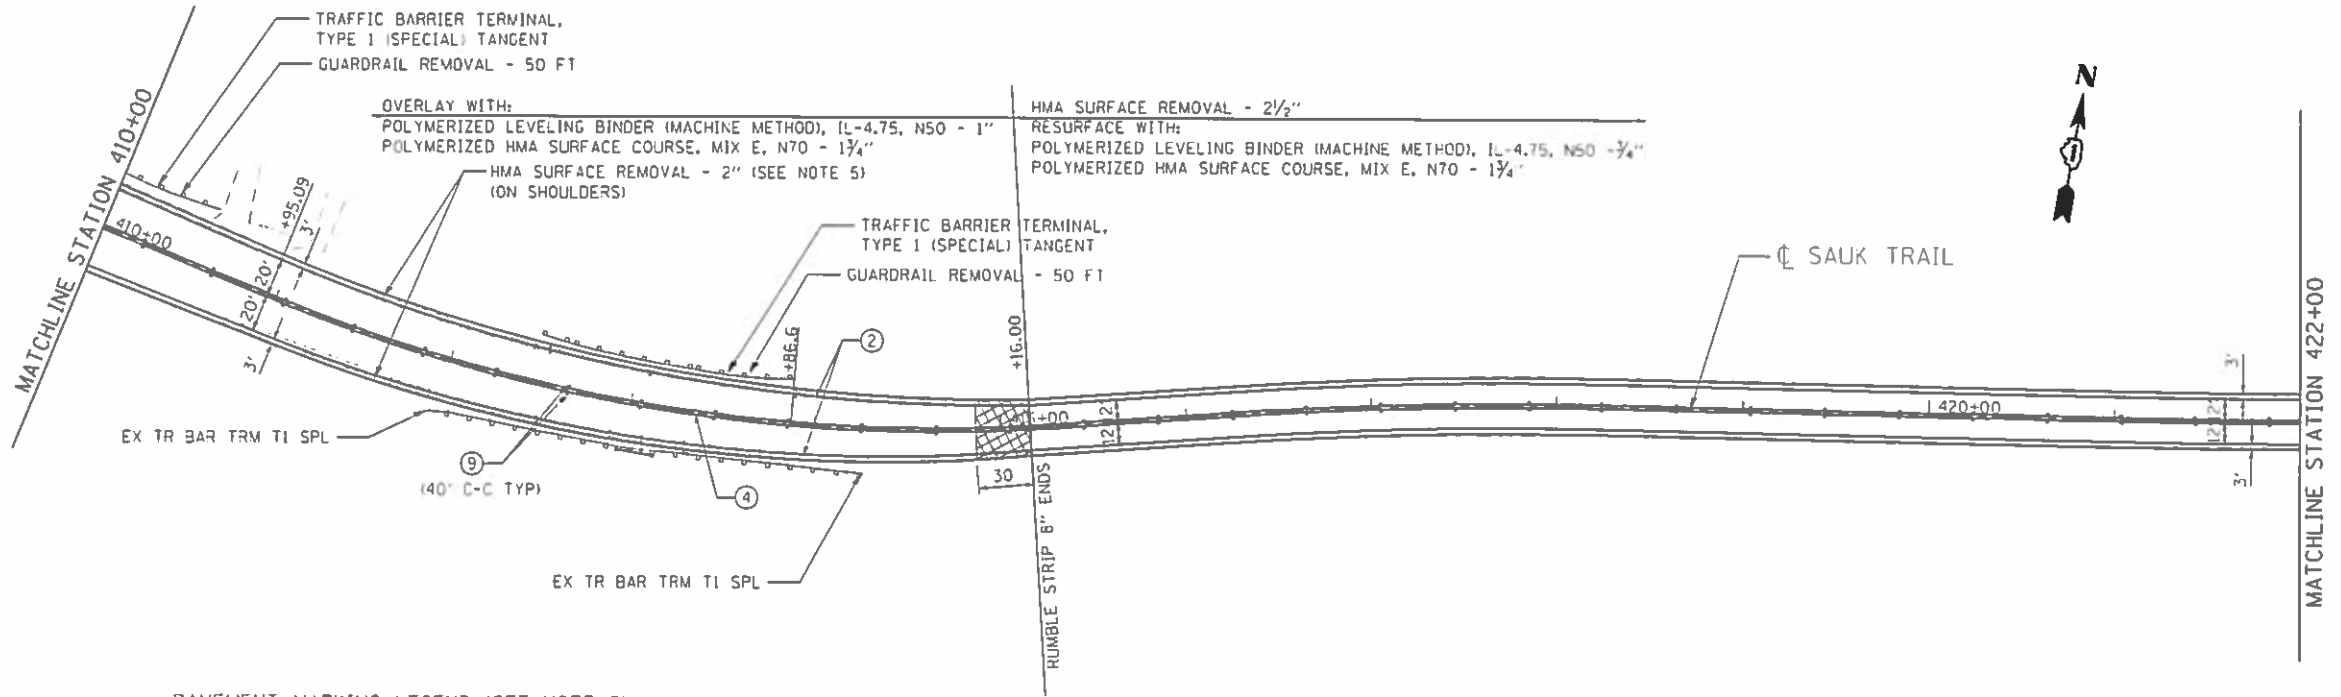


**PAVEMENT MARKING LEGEND (SEE NOTE 2)**

- ① 4" WHITE LANE LINE (30' SKIP 10' DASH)
- ② 4" WHITE SOLID LINE
- ③ 4" YELLOW SOLID LINE
- ④ 4" DOUBLE YELLOW
- ⑤ 4" YELLOW LANE LINE (30' SKIP 10' DASH)
- ⑥ 6" WHITE LINE
- ⑦ 24" WHITE STOP BAR
- ⑧ LETTERS AND SYMBOLS (TYP)
- ⑨ RAISED REFLECTIVE PAVEMENT MARKER (SEE NOTE 4)

**ROADWAY LEGEND**

- PROPOSED SURFACE REMOVAL BUTT JOINT  
SEE BUTT JOINT AND HMA TAPER DETAILS (BD32)

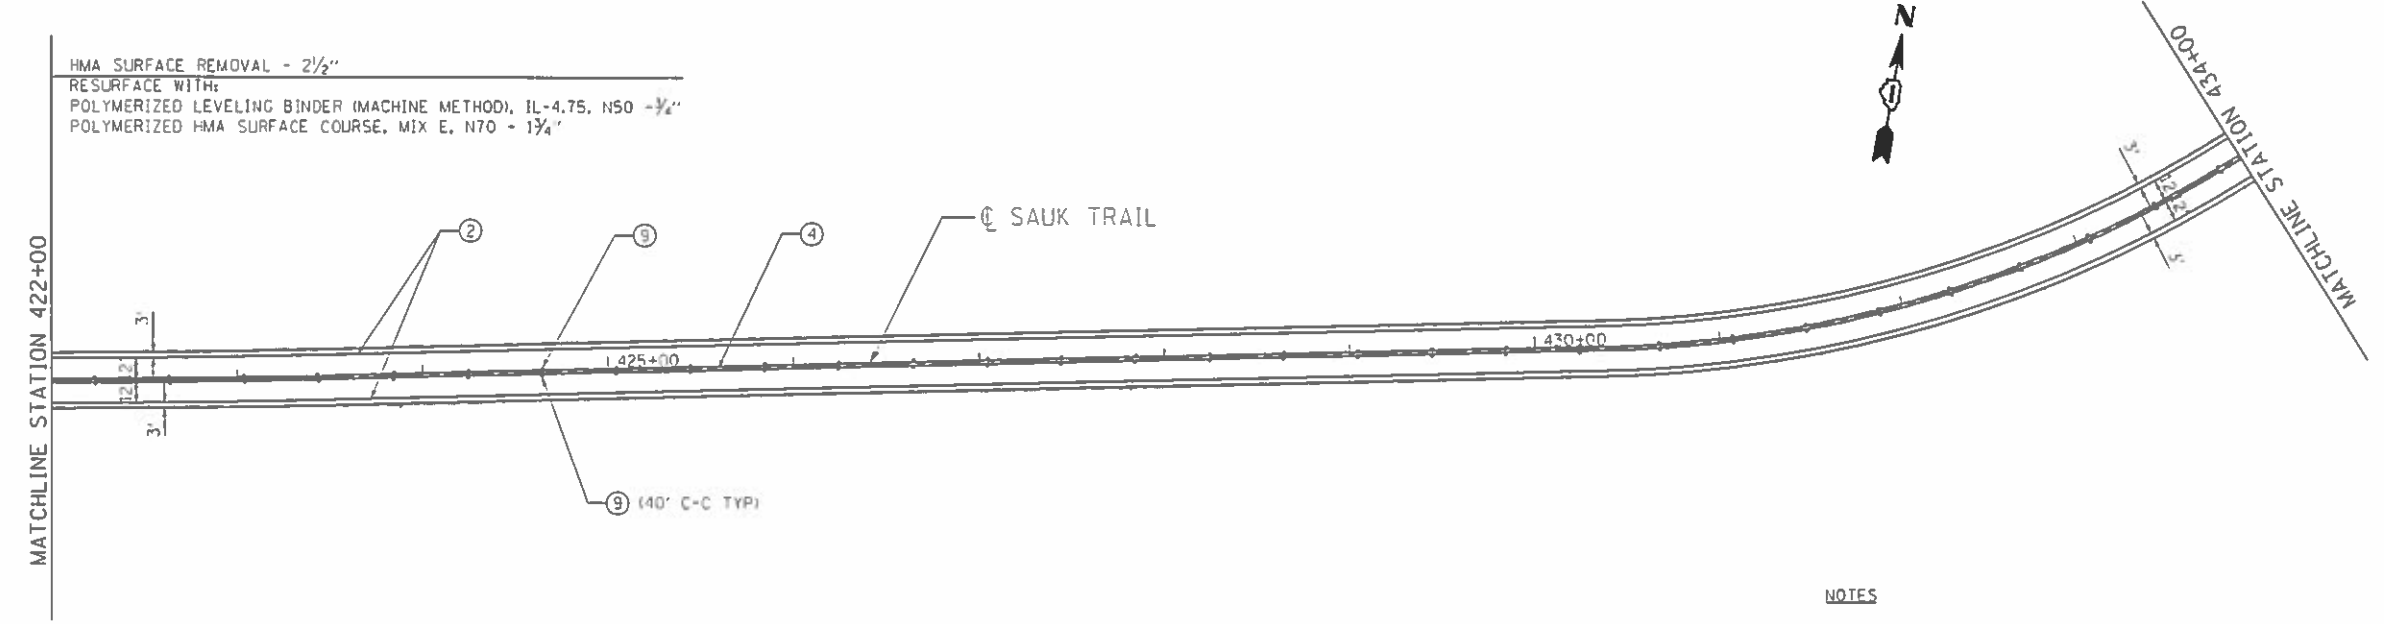

**NOTES**

1. ALL DRAINAGE STRUCTURES WITHIN PROJECT LIMITS SHALL BE CLEANED.
2. ALL PAVEMENT MARKINGS ARE THERMOPLASTIC.
3. THE CONSTRUCTOR SHALL PLACE PROPOSED PAVEMENT MARKINGS IN ACCORDANCE WITH DISTRICT I TYPICAL PAVEMENT MARKINGS DETAIL (TC-13).
4. REFER TO DISTRICT I RAISED REFLECTIVE PAVEMENT MARKERS (TC-11) FOR ADDITIONAL INFORMATION.
5. REPLACE WITH HMA BINDER COURSE, IL-19, N70 - 2 1/4", POLYMERIZED LEVELING BINDER (MM), N50 - 1", AND HOT MIX ASPHALT SURFACE COURSE, MIX E, N70 - 1 3/4"

FILE NAME: P:\2014\ME\4827\_VerVer\_Phi\MCIG\_Sauk\_Trail\Updates\CADD\Sheet\DI6BP22-shi-plan-02.dgn  
 PLOT SCALE: 1/4" = 1'-0"  
 USER NAME: Nijlermie Professional Services

2400 Warrenville Road, Suite 203, Downers Grove, IL 60515  
 630.785.8110 voice, 630.839.2444 fax  
 www.mps-ll.com  
**MILLENNIA PROFESSIONAL SERVICES**

DESIGNED - TVN	REVISED -
DRAWN - JP	REVISED -
CHECKED - TVN	REVISED -
DATE - 9/12/2016	REVISED -

**STATE OF ILLINOIS  
DEPARTMENT OF TRANSPORTATION**


**PROPOSED PLAN  
SAUK TRAIL**

SCALE: 1"=50'    SHEET NO. OF 2 SHEETS    STA. 410+00 TO STA. 434+00

F.A.P. RTE. 1632	SECTION 49R-RS	COUNTY COOK	TOTAL SHEETS 48	SHEET NO. 16
FED. ROAD DIST. NO. 1 (ILLINOIS) FED. AID PROJECT			CONTRACT NO. 60X3B	

PLN-02



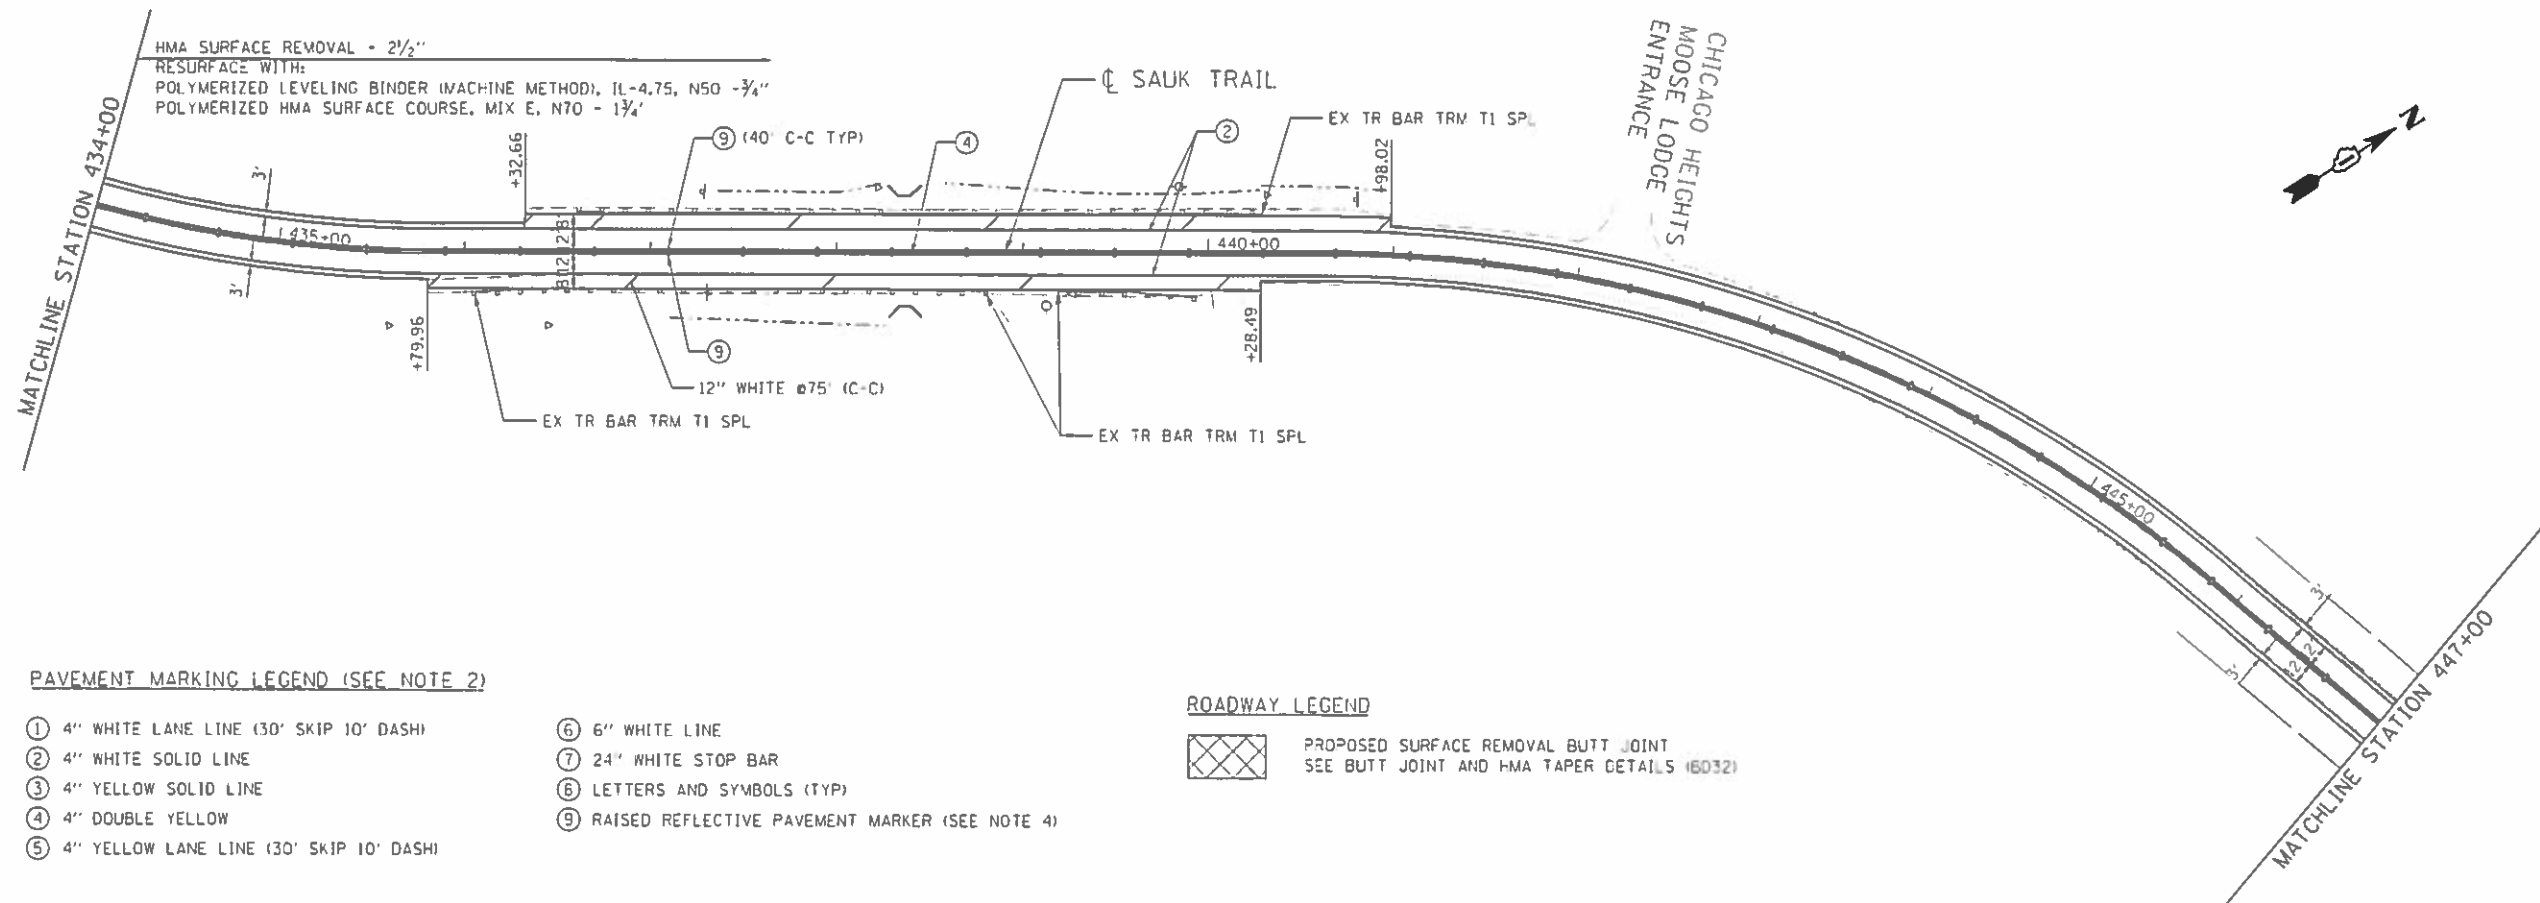


**PAVEMENT MARKING LEGEND (SEE NOTE 2)**

- |   |  |
|---|--|
| ① 4" WHITE LANE LINE (30' SKIP 10' DASH)  | ⑥ 6" WHITE LINE                                  |
| ② 4" WHITE SOLID LINE                     | ⑦ 24" WHITE STOP BAR                             |
| ③ 4" YELLOW SOLID LINE                    | ⑧ LETTERS AND SYMBOLS (TYP)                      |
| ④ 4" DOUBLE YELLOW                        | ⑨ RAISED REFLECTIVE PAVEMENT MARKER (SEE NOTE 4) |
| ⑤ 4" YELLOW LANE LINE (30' SKIP 10' DASH) |  |

**ROADWAY LEGEND**

- |  |  |
|--|--|
|  | PROPOSED SURFACE REMOVAL BUTT JOINT<br>SEE BUTT JOINT AND HMA TAPER DETAILS (6032) |
|--|--|

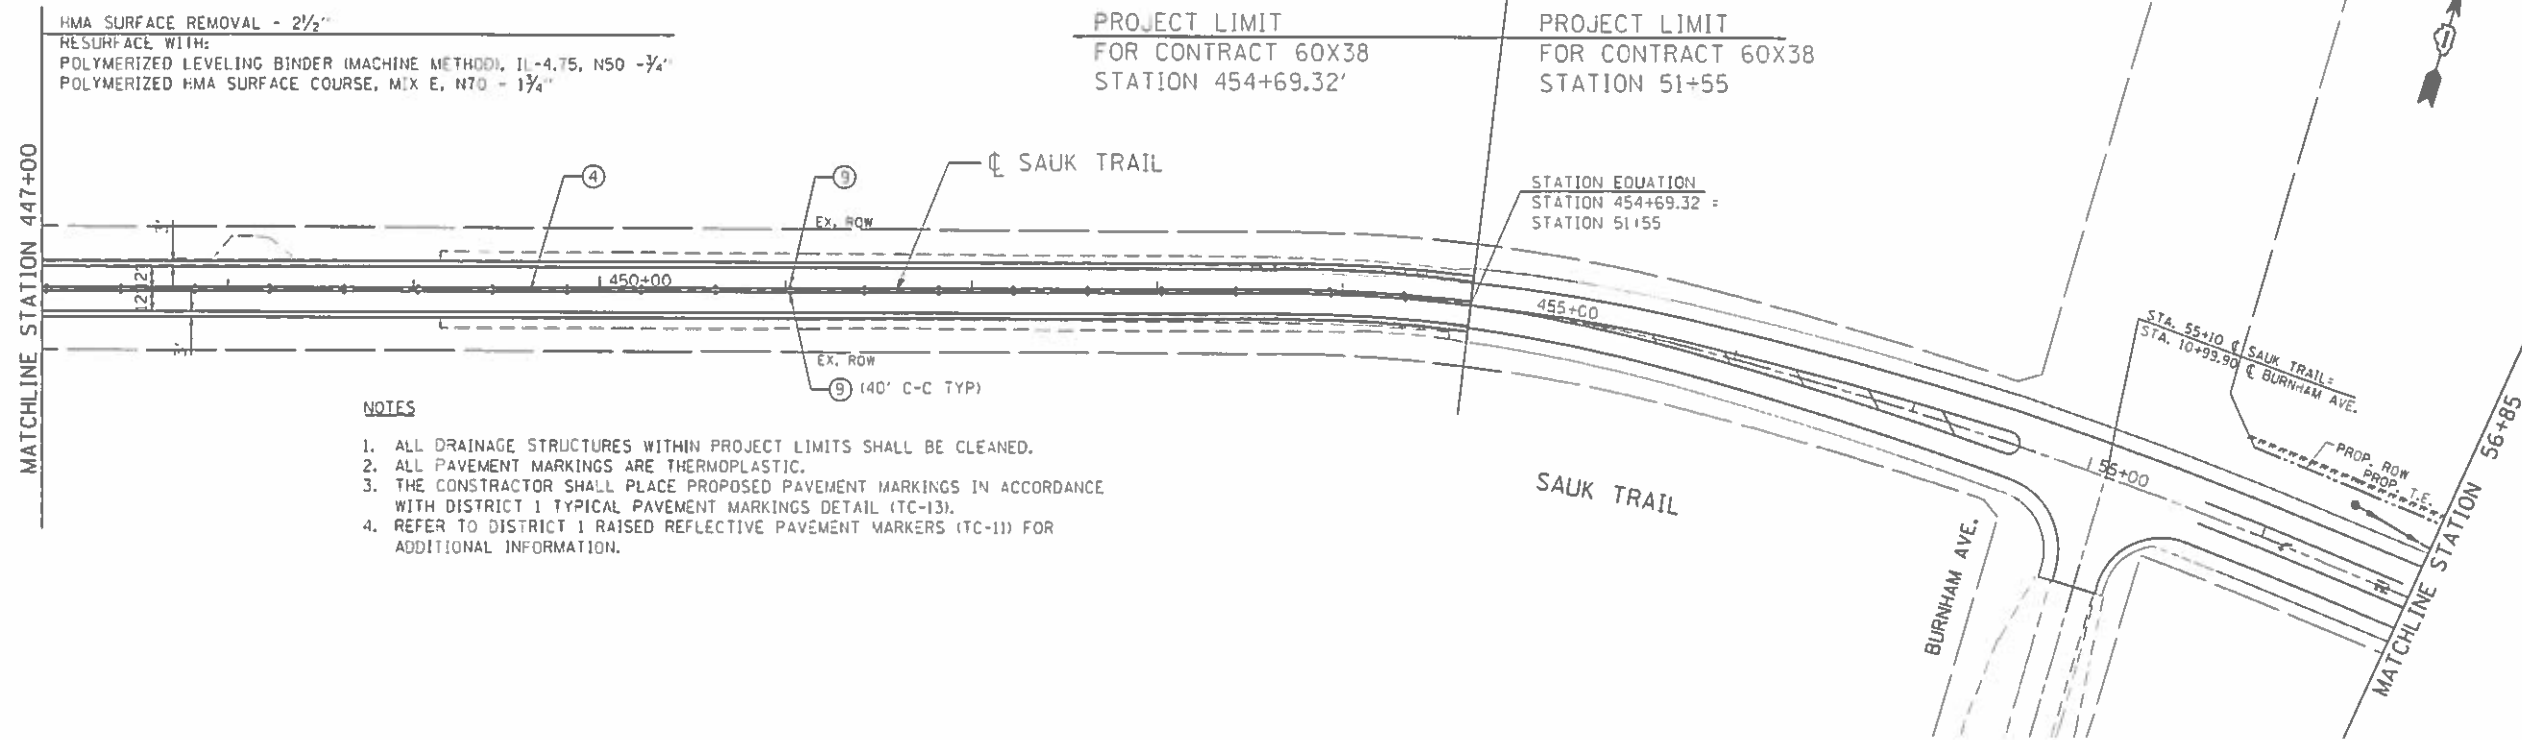

**NOTES**

- ALL DRAINAGE STRUCTURES WITHIN PROJECT LIMITS SHALL BE CLEANED.
- ALL PAVEMENT MARKINGS ARE THERMOPLASTIC.
- THE CONSTRUCTOR SHALL PLACE PROPOSED PAVEMENT MARKINGS IN ACCORDANCE WITH DISTRICT 1 TYPICAL PAVEMENT MARKINGS DETAIL (TC-13).
- REFER TO DISTRICT 1 RAISED REFLECTIVE PAVEMENT MARKERS (TC-11) FOR ADDITIONAL INFORMATION.

FILE NAME : P:\2804\ME14027\_VerVer\_Phi\1\016\_Sou Trail.Update\CAD\Sheet\160922-shi-plan03.dgn  
 PLOT SCALE : 1/8"=1'-0" / in.  
 USER NAME : Millennium Professional Services


 2600 Wauzaville Road, Suite 203, Downers Grove, IL 60515  
 630.785.0110 voice, 630.839.2566 fax  
 www.mps-ill.com  
**MILLENNIA PROFESSIONAL SERVICES**

DESIGNED - TVN	REVISED -
DRAWN - JP	REVISED -
CHECKED - TVN	REVISED -
DATE - 9/12/2016	REVISED -


**STATE OF ILLINOIS**  
**DEPARTMENT OF TRANSPORTATION**

**ROADWAY PLAN**  
**SAUK TRAIL**

SCALE: 1"=50'    SHEET NO. 3 OF 4 SHEETS    STA. 434+00 TO STA. 460+00    F.A.P. 1632    SECTION 49R-R5    COUNTY COOK    TOTAL SHEETS 48    SHEET NO. 17    CONTRACT NO. 60X38


PLN-03

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**PAVEMENT MARKING LEGEND (SEE NOTE 2)**

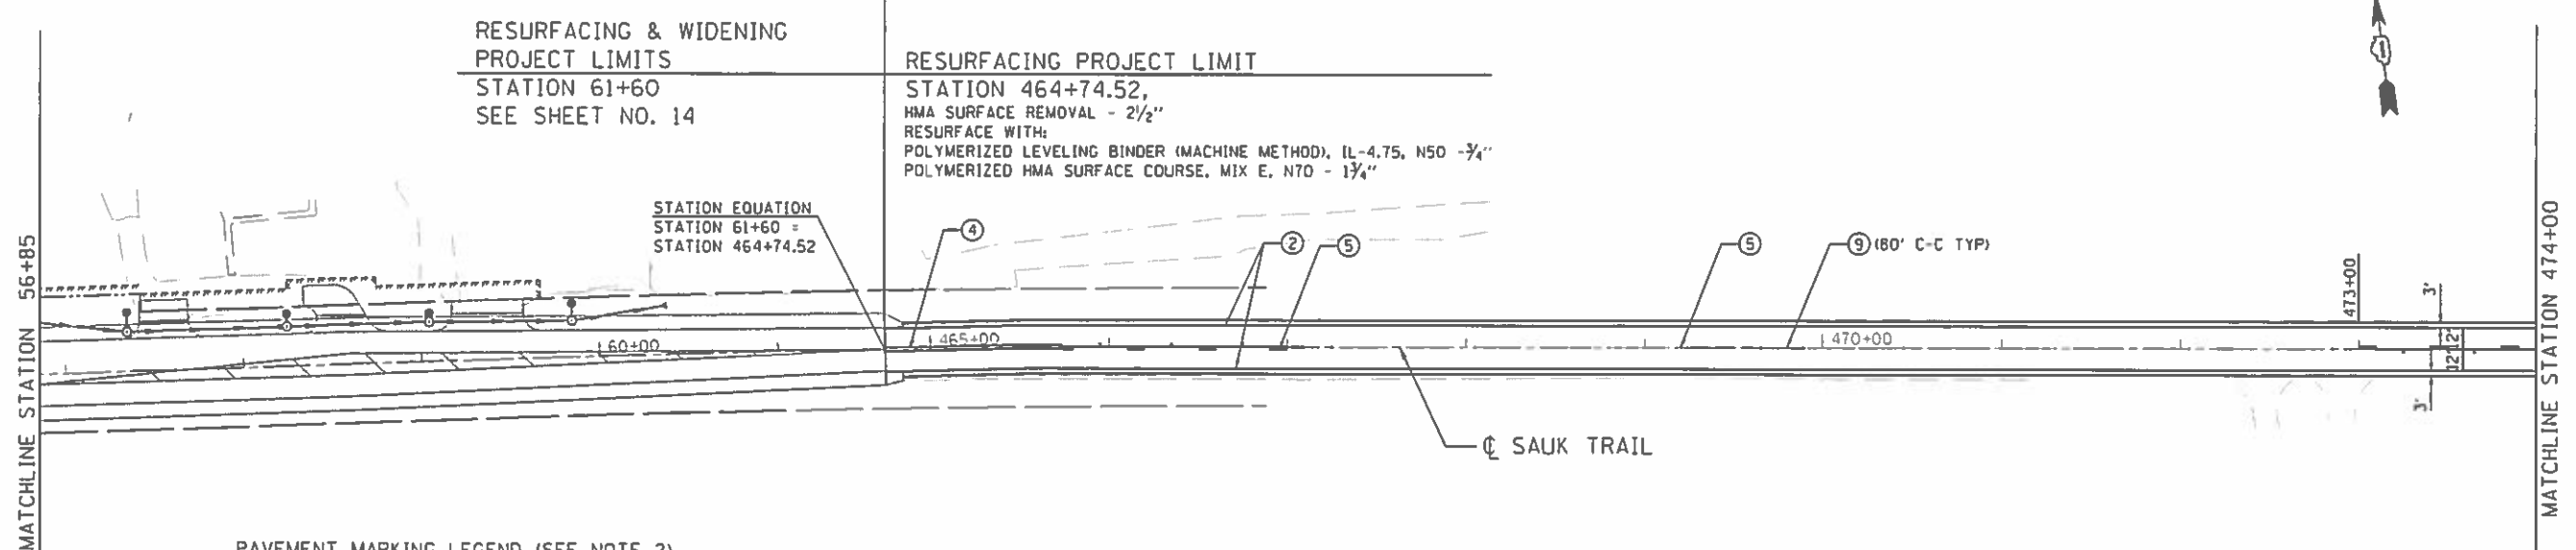- ① 4" WHITE LANE LINE (30' SKIP 10' DASH)
- ② 4" WHITE SOLID LINE
- ③ 4" YELLOW SOLID LINE
- ④ 4" DOUBLE YELLOW
- ⑤ 4" YELLOW LANE LINE (30' SKIP 10' DASH)
- ⑥ 6" WHITE LINE
- ⑦ 24" WHITE STOP BAR
- ⑧ LETTERS AND SYMBOLS (TYP)
- ⑨ RAISED REFLECTIVE PAVEMENT MARKER (SEE NOTE 4)



**ROADWAY LEGEND**

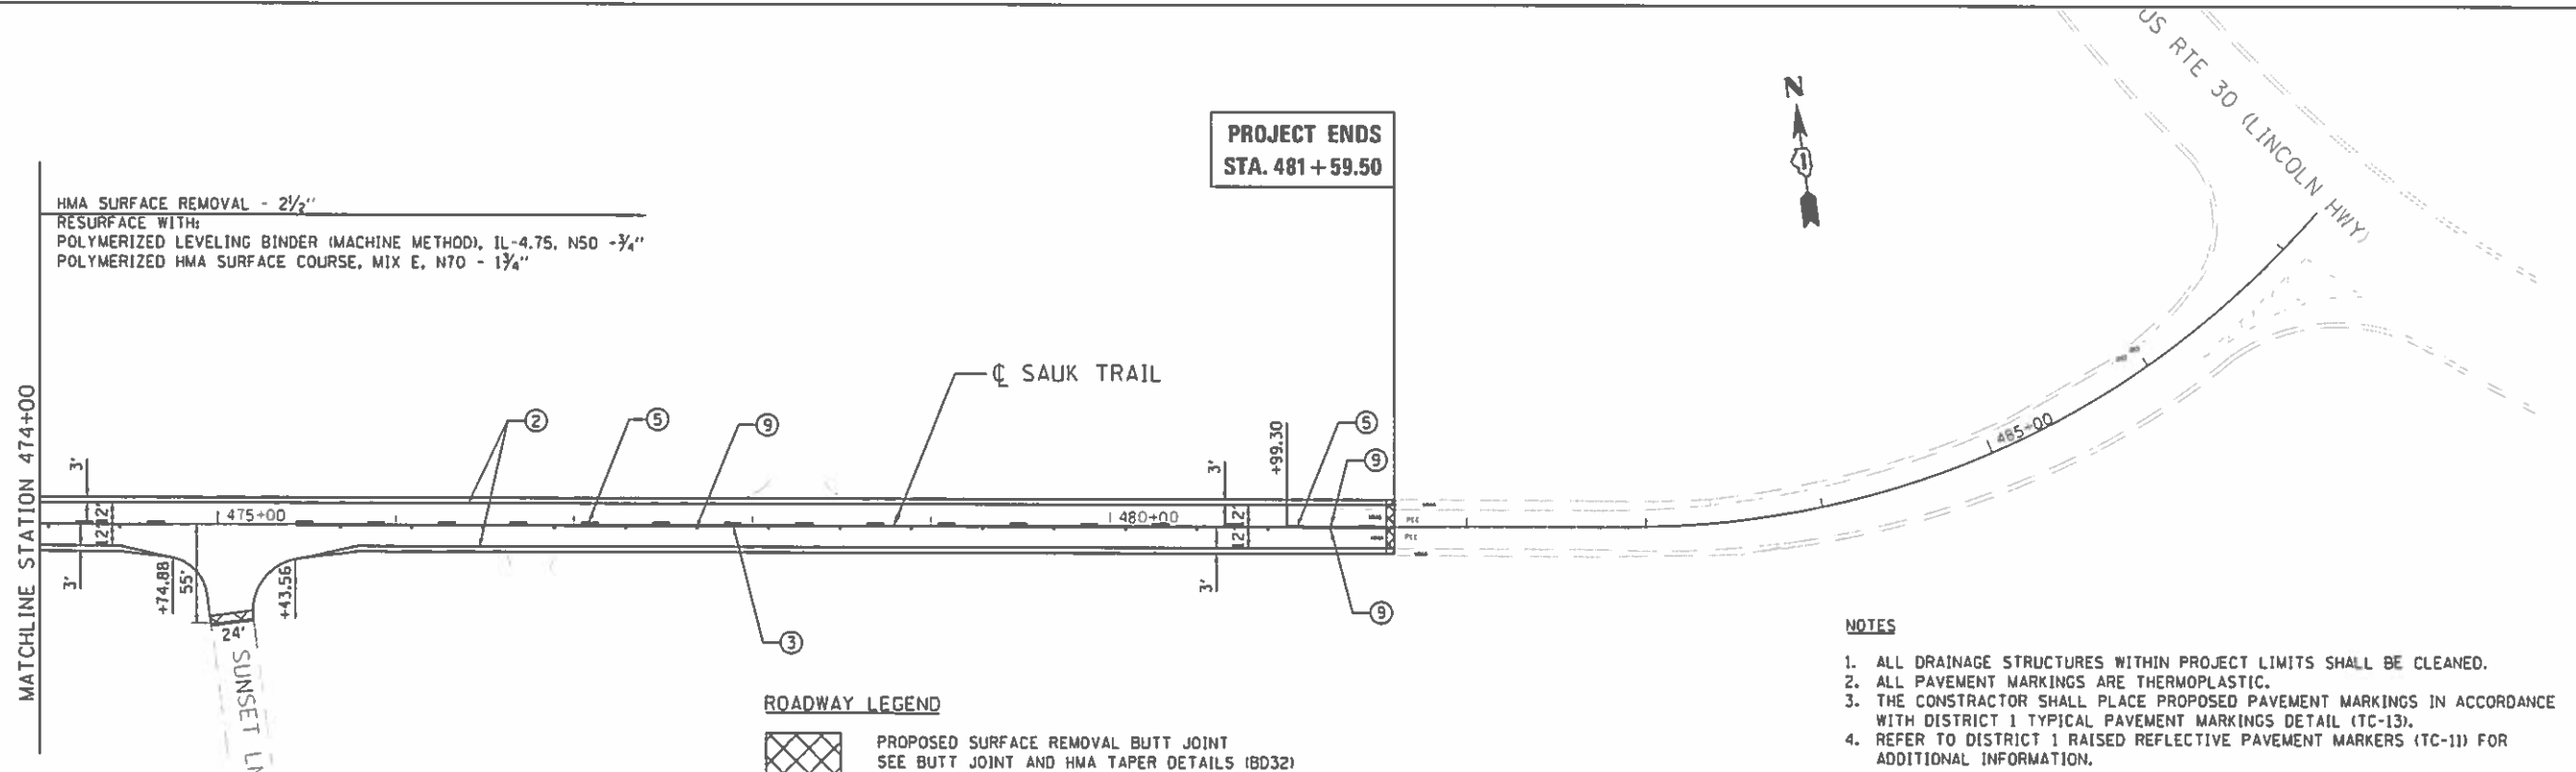- PROPOSED SURFACE REMOVAL BUTT JOINT  
SEE BUTT JOINT AND HMA TAPER DETAILS (BD32)

**NOTES**

1. ALL DRAINAGE STRUCTURES WITHIN PROJECT LIMITS SHALL BE CLEANED.
2. ALL PAVEMENT MARKINGS ARE THERMOPLASTIC.
3. THE CONSTRUCTOR SHALL PLACE PROPOSED PAVEMENT MARKINGS IN ACCORDANCE WITH DISTRICT 1 TYPICAL PAVEMENT MARKINGS DETAIL (TC-13).
4. REFER TO DISTRICT 1 RAISED REFLECTIVE PAVEMENT MARKERS (TC-11) FOR ADDITIONAL INFORMATION.

FILE NAME: P:\2014\ME\4027\_VerVar\_PNL\016\_Sauk Trail\_Updates\CADD\Shets\016R22-shet-pln-04.dgn  
 USER NAME: Millennium Professional Services



3600 Hazelville Road, Suite 103, Downers Grove, IL 60515  
 630.785.8110 voice, 630.839.1566 fax  
 www.mps-ill.com  
**MILLENNIA PROFESSIONAL SERVICES**

DESIGNED	TVN	REVISED	
DRAWN	JP	REVISED	
CHECKED	TVN	REVISED	
DATE	11/4/2016	REVISED	

**STATE OF ILLINOIS**  
**DEPARTMENT OF TRANSPORTATION**

**ROADWAY PLAN**  
**SAUK TRAIL**

SCALE: 1"=50'    SHEET NO. 4 OF 4 SHEETS    STA. 460+00    TO STA. 481+58.61


F.A.P. RTE.	SECTION	COUNTY	TOTAL SHEETS	SHEET NO.
1632	49R-RS	COOK	48	18
FED. ROAD DIST. NO. 1   ILLINOIS FED. AID PROJECT			CONTRACT NO. 60X3B	

PLN-04

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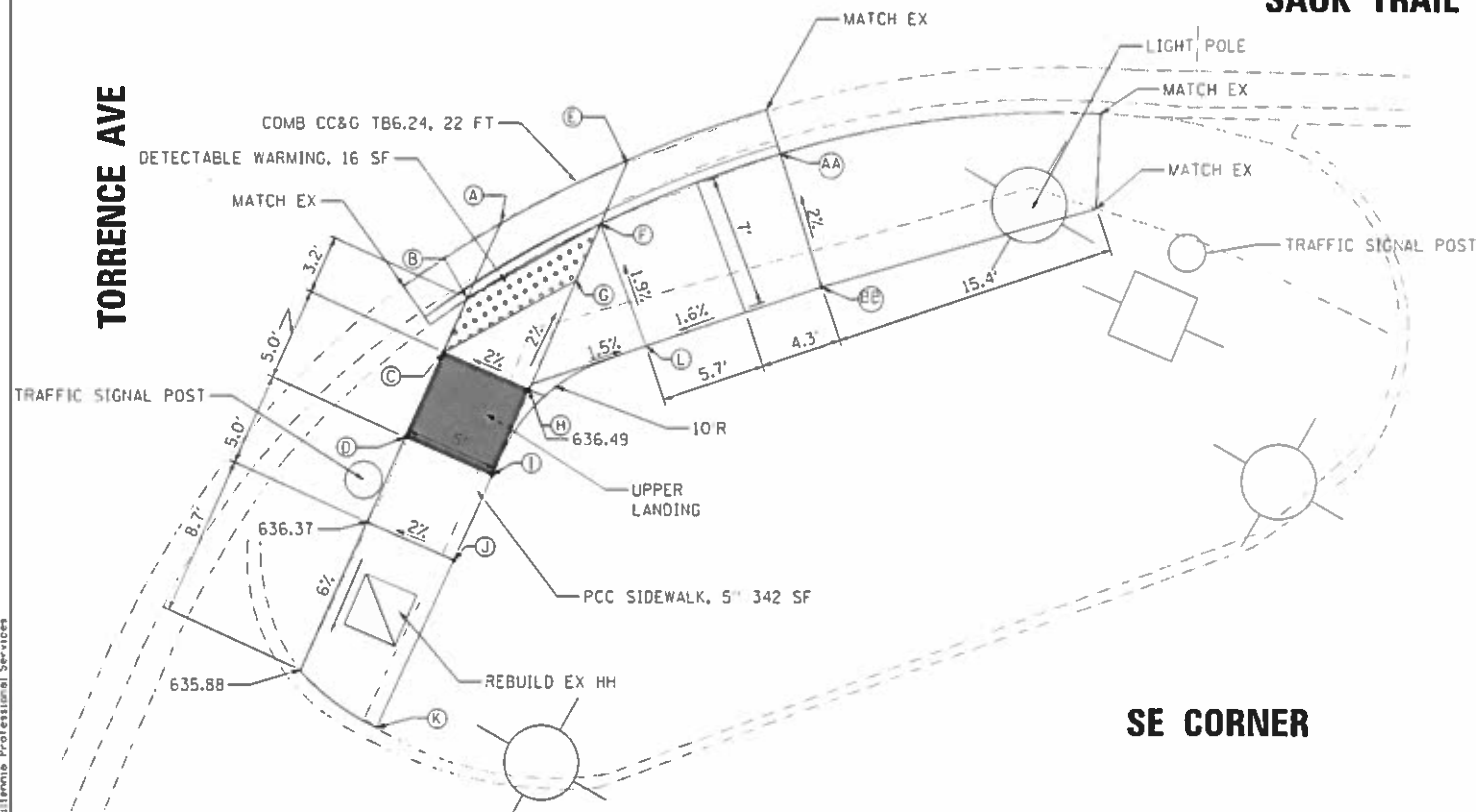
**NE CORNER**

POINT	STA	OFFSET	ELEV
A			635.89
B	400+67.78	48.06 LT	636.17
C			636.22
D			ME
E			635.86
F	400+72.50	46.42 LT	636.23
G	400+74.15	51.14 LT	636.30
H			ME

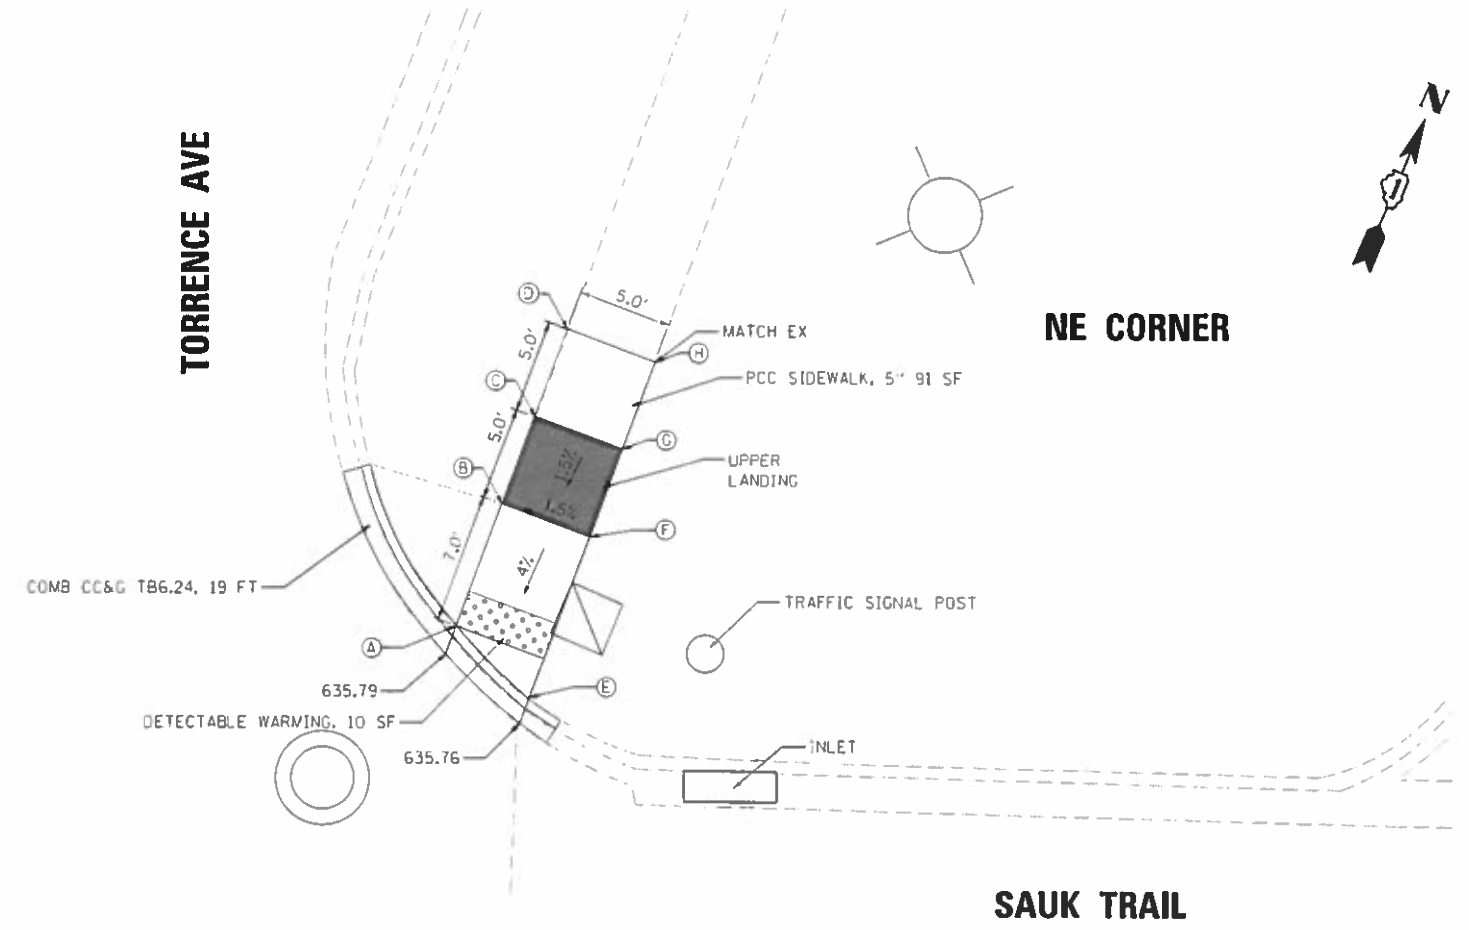

**SAUK TRAIL**

**SAUK TRAIL**



**SE CORNER**

POINT	STA	OFFSET	ELEV
A			636.13
B			636.30
C			636.36
D	400+25.84	52.78 RT	636.46
E			636.10
F			636.27
G			636.34
H	400+32.47	50.08 RT	636.46
I	400+30.58	54.72 RT	636.46
J	400+28.62	59.32 RT	636.47
K			635.88
L	400+38.72	47.60 RT	636.40
AA			636.42
BB	400+48.13	44.21 RT	636.56

FILE NAME: P:\2014\16322\_Ver\_Ver\_Phi\16322\_Sauk\_Trail\_Updates\CADD\Shits\16322-akt-SaukTrail\16322.dgn  
 PLOT SCALE: 1/8"=1'-0"  
 USER NAME: J.Miller@mps-ill.com



2600 Warrsville Road, Suite 203, Downers Grove, IL 60515  
 630-785-8110 voice, 630-839-2544 fax  
 www.mps-ill.com

**MILLENNIA PROFESSIONAL SERVICES**

DESIGNED - TVN	REVISED -
DRAWN - JP	REVISED -
CHECKED - TVN	REVISED -
DATE - 9/12/2016	REVISED -

**STATE OF ILLINOIS  
 DEPARTMENT OF TRANSPORTATION**

**ADA SIDEWALK DETAILS  
 SAUK TRAIL**


SCALE: SHEET NO. OF SHEETS STA. TO STA.

F.A.P. RTE.	SECTION	COUNTY	TOTAL SHEETS	SHEET NO.
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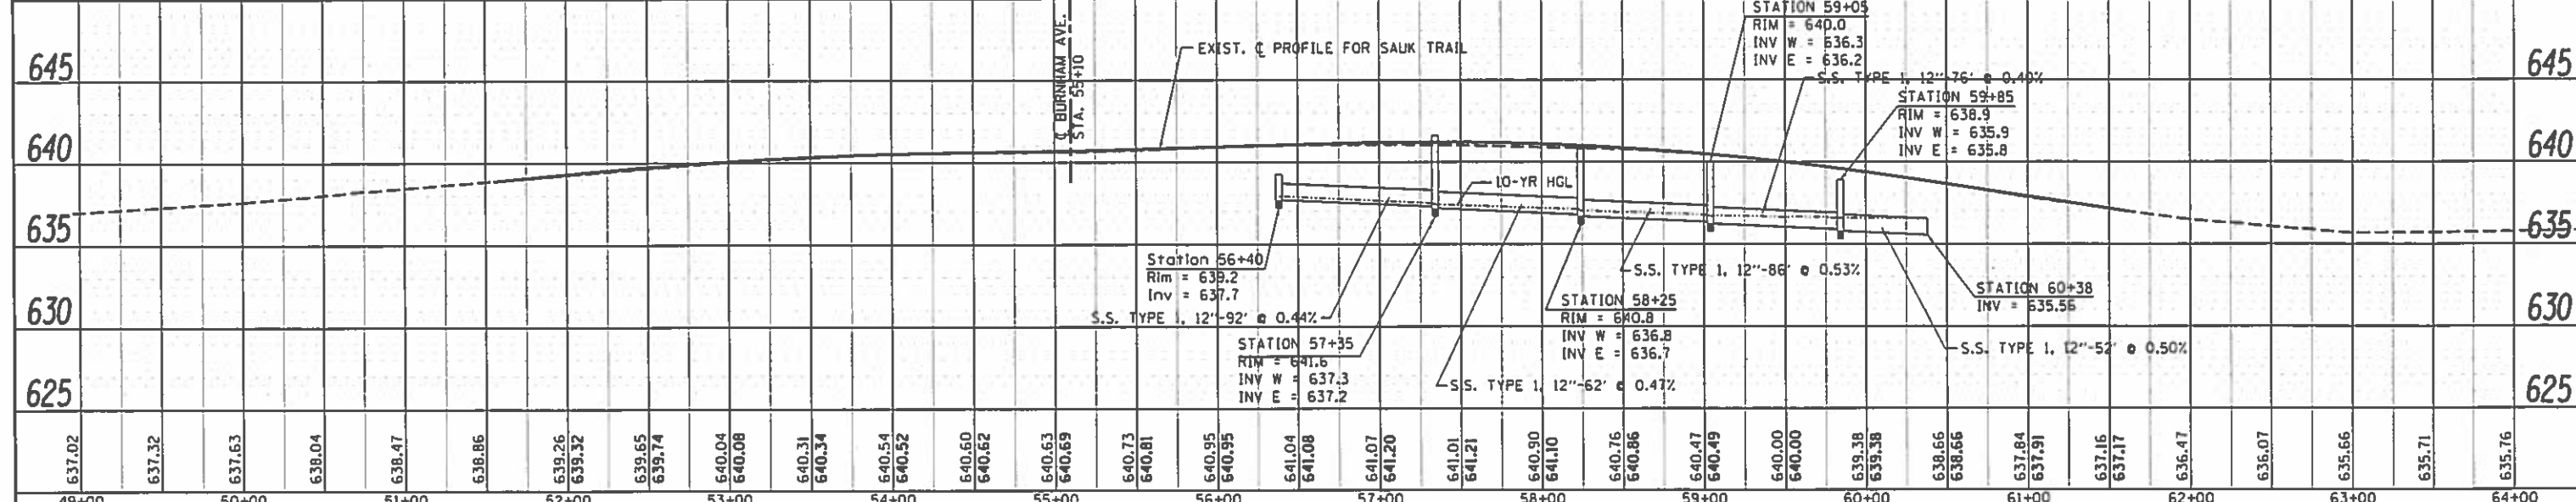
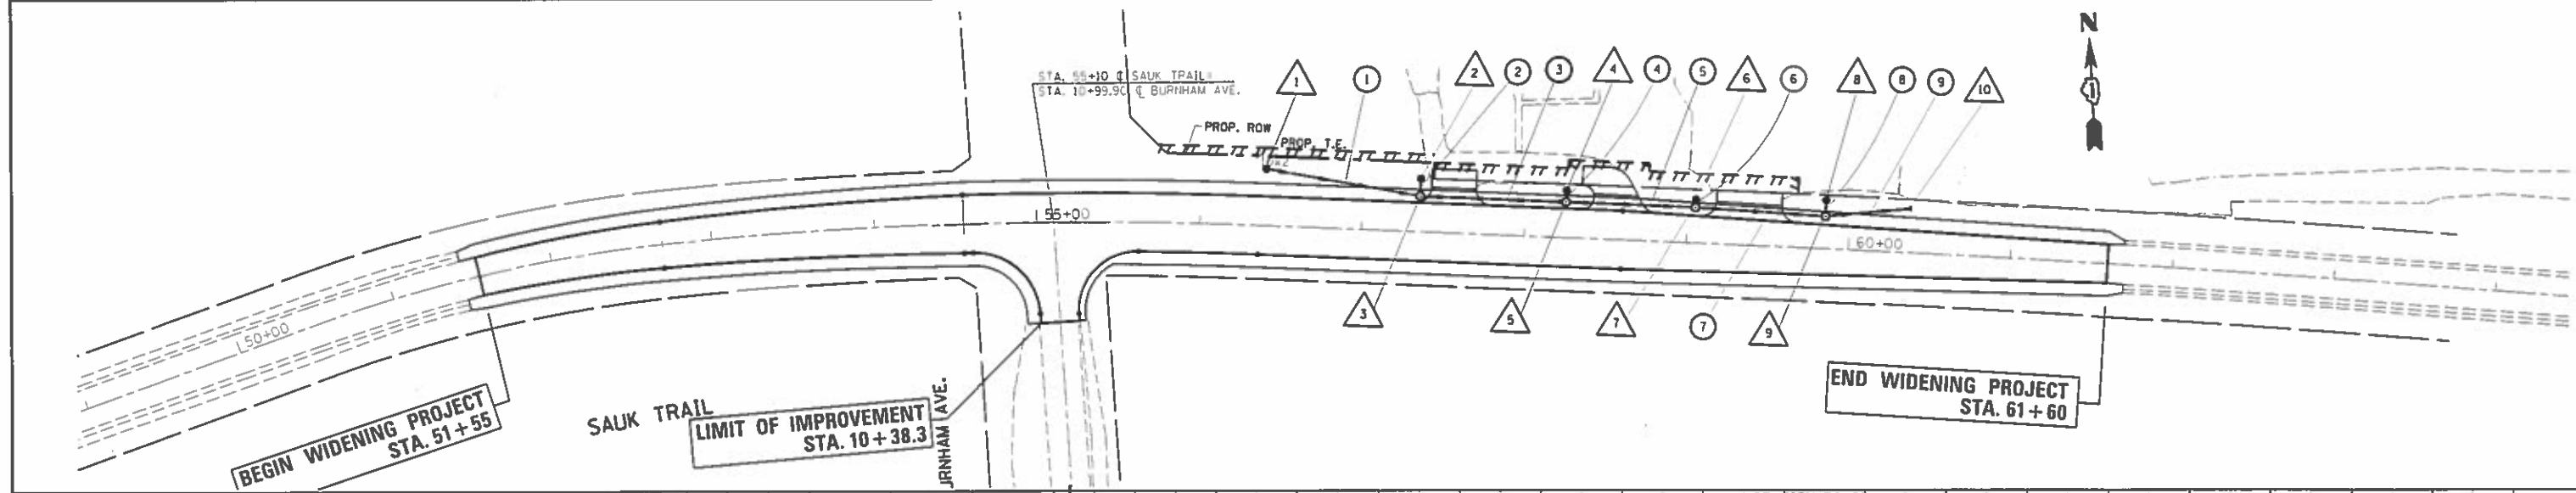
FED. ROAD DIST. NO. 1 (ILLINOIS) FED. AID PROJECT CONTRACT NO. 60X38

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DATE	
BY	
PROJECT NO.	
ALPHABETICALLY CHECKED	
NOTE BOOK NO.	
FILE NAME	
PLAN	
NO.	



DATE	
BY	
PROJECT NO.	
ALPHABETICALLY CHECKED	
NOTE BOOK NO.	
FILE NAME	
PROFILE	
NO.	

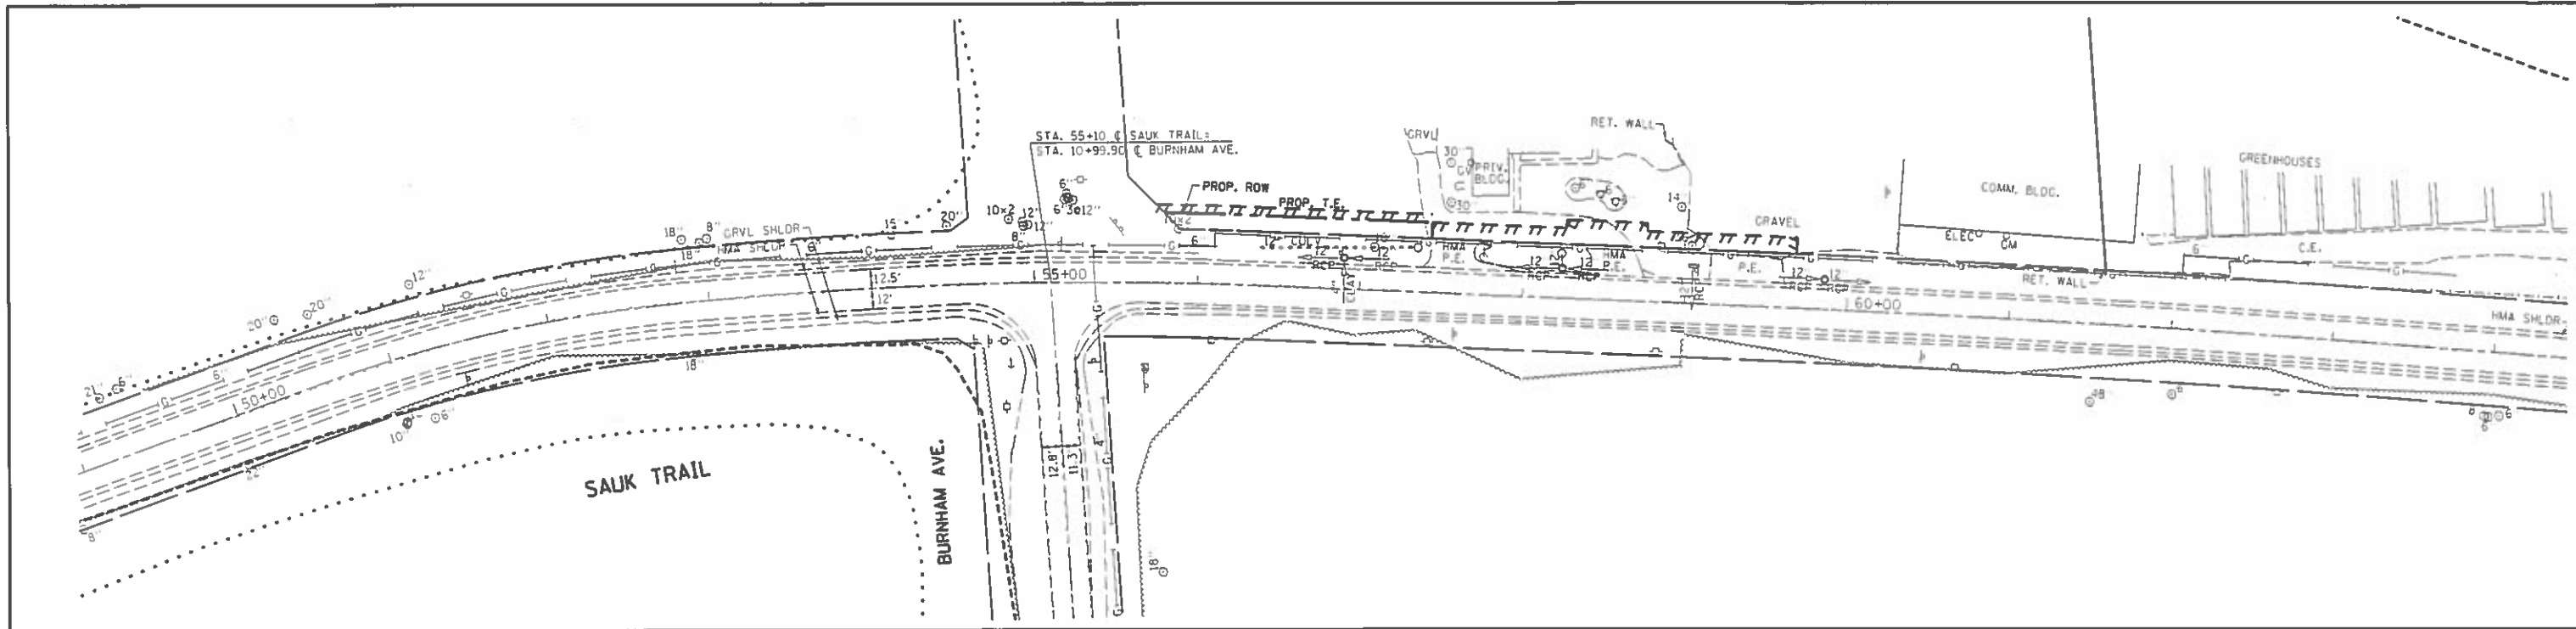

637.02	637.32	637.63	638.04	638.47	638.86	639.26	639.32	639.65	639.74	640.04	640.08	640.31	640.34	640.54	640.52	640.60	640.62	640.63	640.69	640.73	640.81	640.95	640.95	641.04	641.08	641.07	641.20	641.01	641.21	640.90	641.10	640.76	640.86	640.47	640.49	640.00	640.00	639.38	639.38	638.66	638.66	637.84	637.91	637.16	637.17	636.47	636.07	635.66	635.71	635.76
49+00	50+00	51+00	52+00	53+00	54+00	55+00	56+00	57+00	58+00	59+00	60+00	61+00	62+00	63+00	64+00																																			

FILE NAME	
USER NAME	bauerd
DESIGNED	
REVISOR	
DRAWN	CAD
CHECKED	
DATE	10/27/2016

REVISOR	
REVISOR	
REVISOR	
REVISOR	

STATE OF ILLINOIS  
DEPARTMENT OF TRANSPORTATION

DRAINAGE PLAN & PROFILE  
SAUK TRAIL AT BURNHAM AVE.  
SCALE: 1"=50' SHEET OF SHEETS STA. TO STA.

F.A.U. RTE.	SECTION	COUNTY	TOTAL SHEETS	SHEET NO.
1632	49R-RS	COOK	48	20
CONTRACT NO. 60X38			ILLINOIS FED. AID PROJECT	

DRAINAGE STRUCTURES TABLE												
NO.	STATION	OFFSET	STRUCTURE TYPE			DIA.	FRAME	TOP OF FRAME	INVERT (W)	INVERT (E)	INVERT (S)	INVERT (N)
			MH	CB	INL							
1	56+40	35' LT.	_____	TA	_____	4'	T8	639.2		637.2		
2	57+35	33' LT.	_____	TA	_____	4'	T8	639.7		637.36		
3	57+35	22' LT.	IA		_____	4'	T8	641.6	637.3	637.2	637.3	
4	58+25	29' LT.	_____	TA	_____	4'	T8	639.9		636.84		
5	58+25	22' LT.	IA		_____	4'	T8	640.8	636.8	636.7	636.8	
6	59+05	27' LT.	_____	TA	_____	4'	T8	639.5		636.33		
7	59+05	22' LT.	IA		_____	4'	T8	640.0	636.3	636.2	636.3	
8	59+85	30' LT.	_____	TA	_____	4'	T8	636.6		635.95		
9	59+85	20' LT.	IA		_____	4'	T8	638.9	635.9	635.8	635.9	
10	60+38	27' LT.	FLARED_END_SECTION			12''			635.56			


NOTES

1. STATION AND OFFSETS ARE BASED UPON EXISTING CENTERLINE

PIPE TABLE					
NO.	STATION - STATION	TYPE	DIA.	LIN. FT.	SLOPE
1	56+40, 35' LT. - 57+35, 22' LT.	1	12''	92	0.44%
2	57+35 -	1	12''	11	0.50%
3	57+35, 22' LT. - 58+25, 22' LT.	1	12''	86	0.47%
4	58+25 -	1	12''	7	0.50%
5	58+25, 22' LT. - 59+05, 22' LT.	1	12''	76	0.53%
6	59+05 -	1	12''	5	0.50%
7	59+05, 22' LT. - 59+85, 20' LT.	1	12''	76	0.40%
8	59+85 -	1	12''	10	0.50%
9	59+85, 20' LT. - 60+38, 27' LT.	1	12''	52	0.50%
	-				
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	-				

WM=WATER MAIN REQUIREMENTS

P1100112-sht-typical.dgn 10/26/2016 8:32:54 AM User=qureshiya

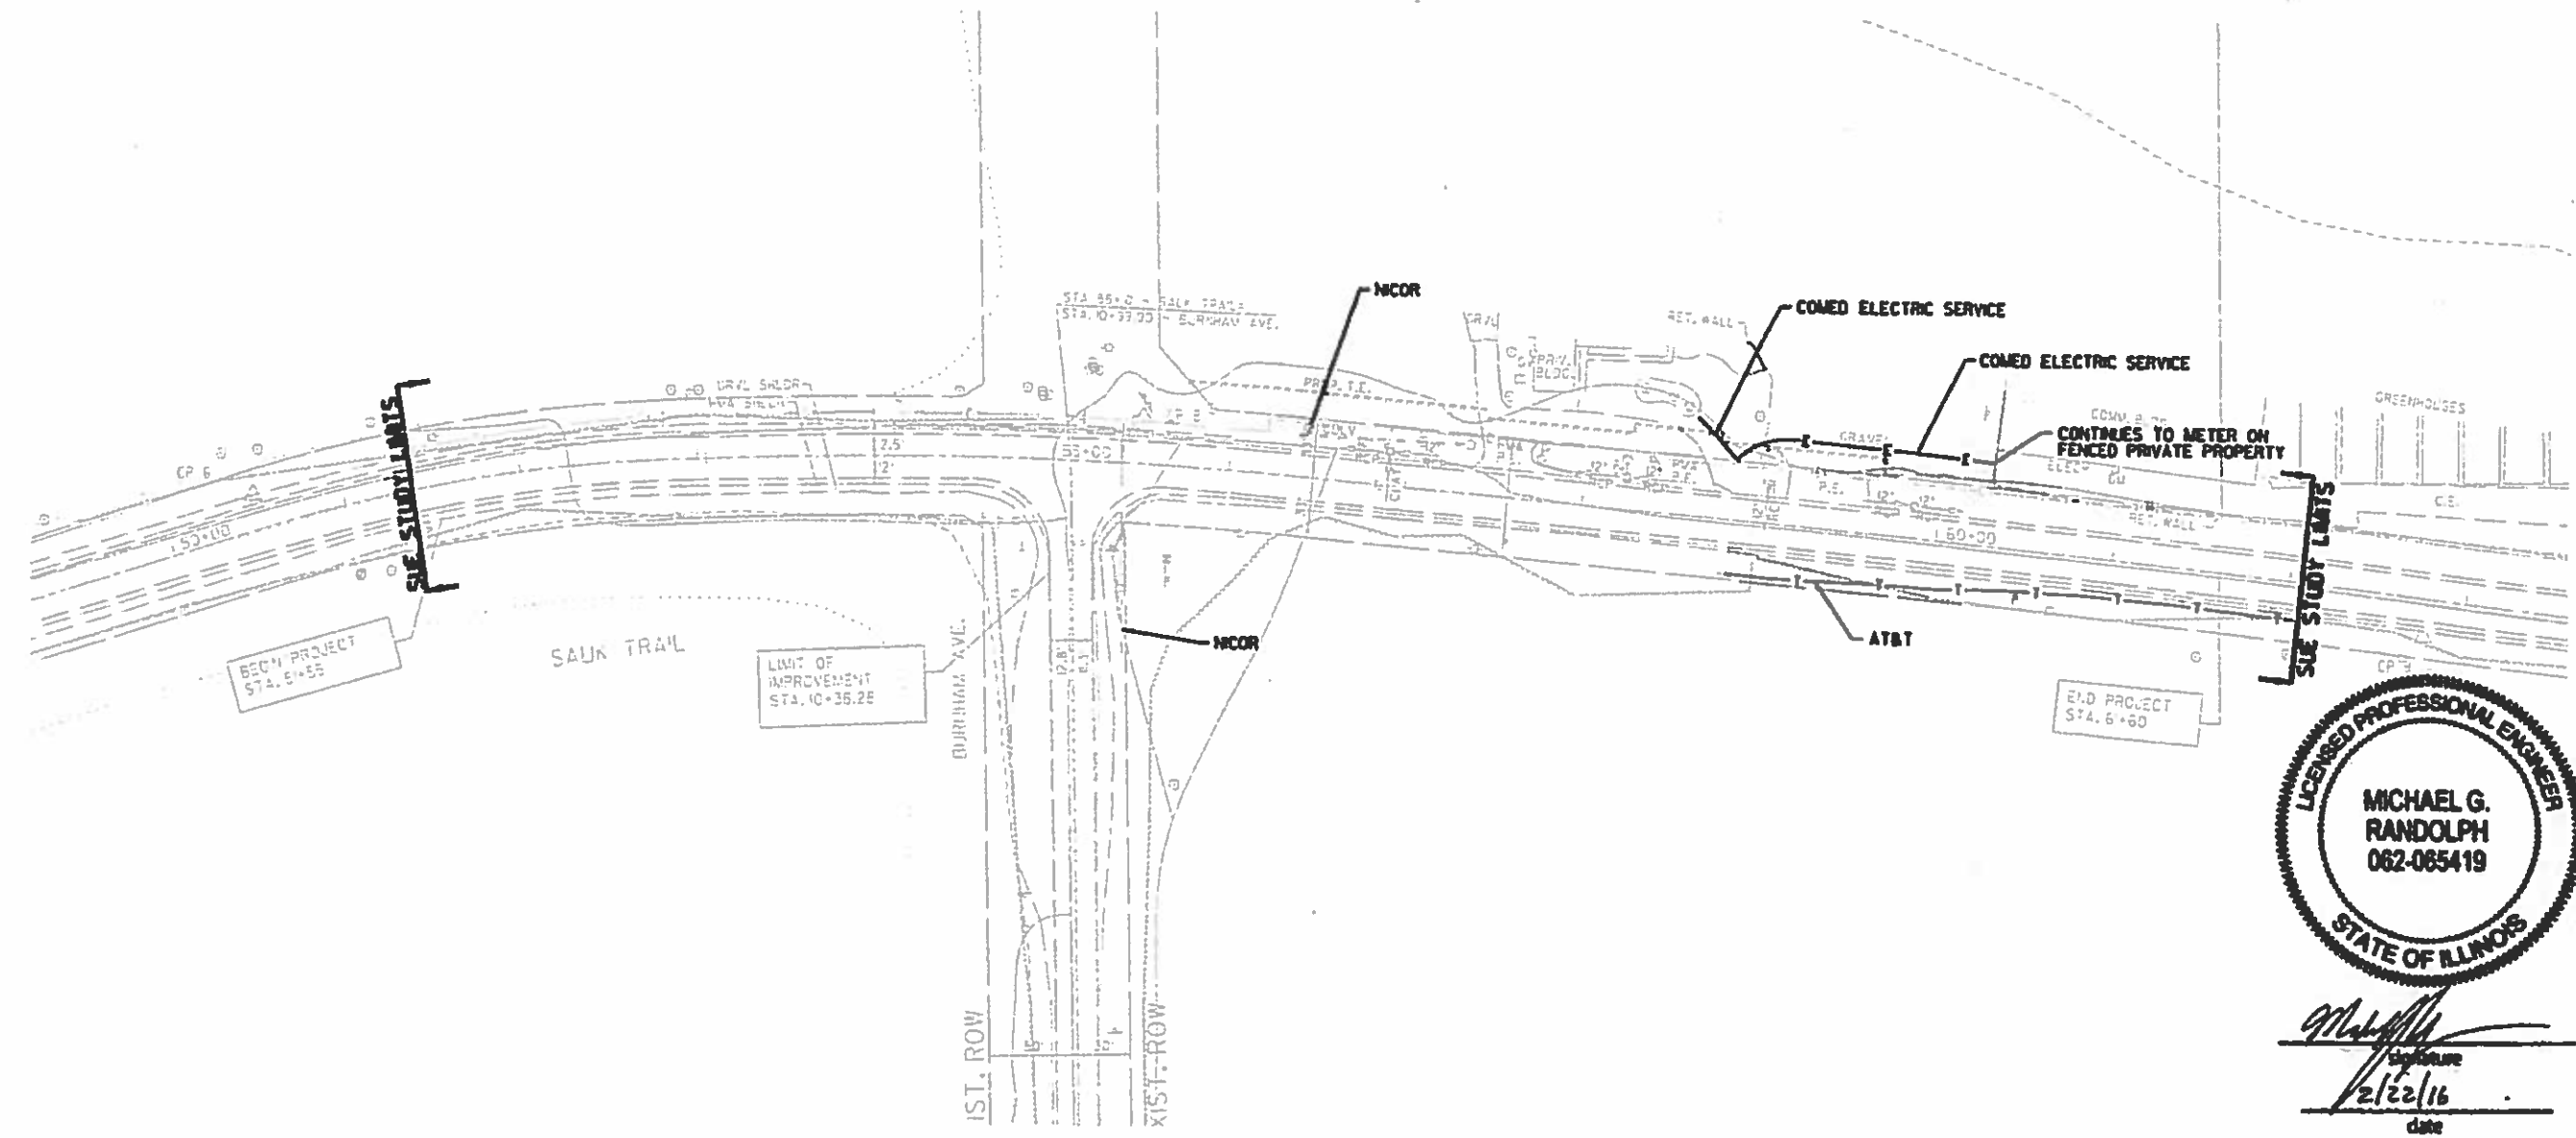

*Michael G. Randolph*  
 Signature  
 2/22/16  
 date

license expires 11-30-2017

—▲—▲—▲—	AERIAL UNKNOWN
—○—○—○—	OIL
—CTV—CTV—CTV—	CABLE TV
—T—T—T—	TELEPHONE
—E—E—E—	GAS
—E—E—E—	ELECTRIC
—T—T—T—	TRAFFIC SIGNAL/LIGHTING
—W—W—W—	WATER
—FM—FM—FM—	FORCE MAIN
—FO—FO—FO—	FIBER OPTIC
⊕	TBE TEST HOLE
—EOI	END OF INFORMATION

UTILITY OWNERS	
NCOR	- GAS
AT&T	- TELEPHONE
COMED	- ELECTRIC

Utilities shown on these plans as depicted in the legend have been investigated by Cardno in accordance with SUE Industry Standards. All other information shown has been provided to Cardno by others. Cardno's SUE field investigation was performed 2/1/16 through 2/12/16. Changes to utilities after 2/12/16 may have been made and therefore may result in variances from this plan. Consideration should be given to updating this plan if deemed advisable prior to final design and construction.

ALL UTILITIES SHOWN QUALITY LEVEL "B" UNLESS NOTED OTHERWISE.



**CWA**  
 CLASSEN, WHITE & ASSOCIATES, P.C.  
 LAND SURVEYORS  
 10 HUNTERS HILL, SUITE 1, JOLIET, ILLINOIS 60438  
 (815) 744-5200 cwa@cwaland.com

Utility Quality Level "A": Visually Verified Test Hole	DESIGNED	EG	REVISED
Utility Quality Level "B": Designating/non Visually Verified Test Hole	DRAWN	KLC	REVISED
Utility Quality Level "C": Research with Survey	CHECKED	MGR	REVISED
Utility Quality Level "D": Records Research	DATE	2/19/16	REVISED

STATE OF ILLINOIS
DEPARTMENT OF TRANSPORTATION

Sauk Trail & Burnham Ave.  
 Chicago Heights, Illinois




THE Job No. L0950709 SUE Plan Page 1 of 1			
P.A. RTE.	SECTION	COUNTY	TOTAL SHEETS
	6013B	Cook	22
Contract No. 49N		SHEET NO. 22	
FED. ROAD DIST. NO.	ILLINOIS DOT Project No.		

STATE OF ILLINOIS  
 DEPARTMENT OF TRANSPORTATION  
 DIVISION OF HIGHWAYS  
**PLAT OF HIGHWAYS**

**ROUTE: SAUK TRAIL**  
**SECTION:**  
**COUNTY: COOK**  
**LIMITS: AT BURNHAM AVENUE**  
**JOB NO.: R-90-025-13**

PARCEL NUMBER	OWNER	SHEET NUMBER	PROPERTY ACQUIRED BY
0KE0001 0KE001E-A 0KE001E-B	Carl A. Smits, a bachelor	2	

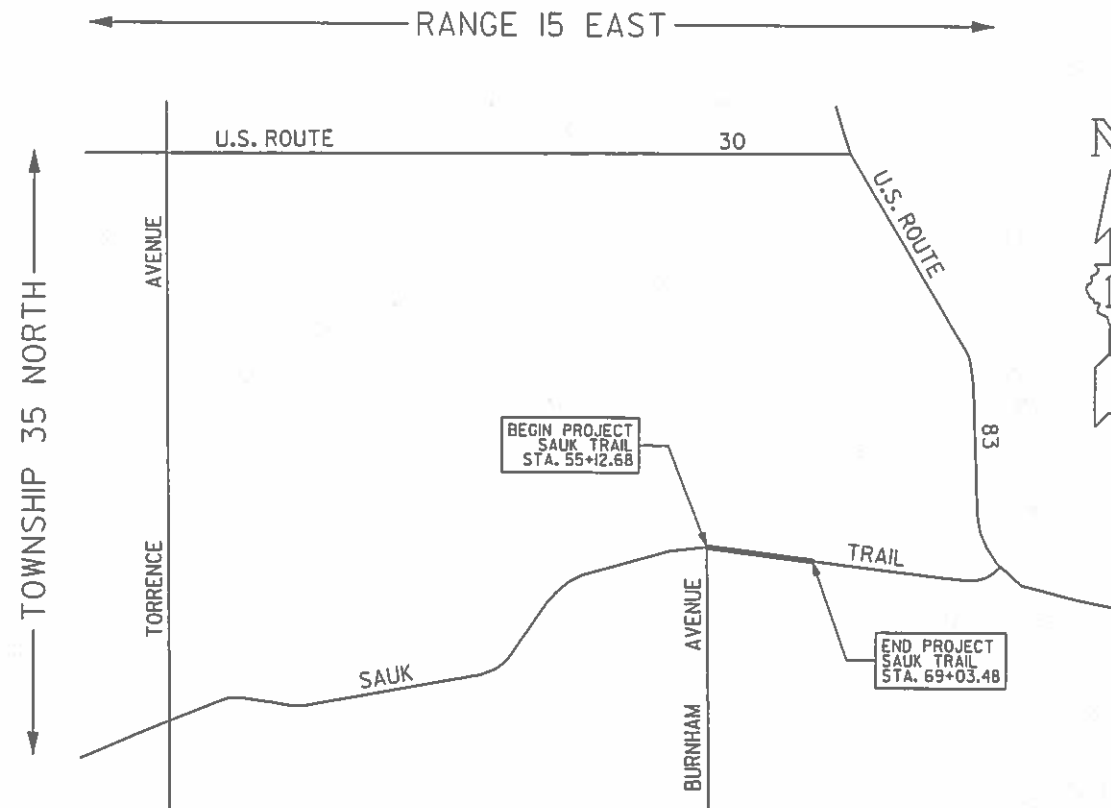

**LOCATION MAP**

PROJECT LENGTH = 1391.2 FT. = 0.263 MILES, SAUK TRAIL

DISTRICT HEADQUARTERS: - \*  
 LOCATION OF SECTION INDICATED THUS: - **█**

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 OF THE STATE OF ILLINOIS**

**Robinson**  
 ENGINEERING  
 17000 SOUTH PARK AVENUE  
 SOUTH HOLLAND, IL 60473  
 (708) 331-6700

RECEIVED  
 APR 25 2014 *fk*  
 PLATS & LEGALS

PART OF SECTION 29, TWP. 35 N., R. 15 E. OF THE 3RD. P.M., IN COOK COUNTY, ILLINOIS.

PARCEL NUMBER	TOTAL HOLDINGS ACRES	PART TAKEN		AREA IN EXISTING R.O.W. ACRES	REMAINDER AREA ACRES	EASEMENT AREA		PARCEL INDEX NUMBER
		ACRES	SQUARE FEET			ACRES	SQUARE FEET	
OKED001 OKED001E-A OKED001E-B	29.712	0.485		0.476	29.227	TE-A=0.019 TE-B=0.026		33-29-100-023 33-29-100-014

PROJECT COORDINATES FOR PROPOSED CENTERLINE				
POINT NUMBER	STATION	OFFSET	NORTHING	EASTING
2002	STA=52+69.36	0.00' RIGHT	1759923.4786'	1201674.9229'
2003	STA=56+36.83	0.00' RIGHT	1759917.6455'	1202041.8167'
2004	STA=59+38.01	0.00' RIGHT	1759890.7519'	1202342.0033'
2005	STA=63+73.68	0.00' RIGHT	1759844.1391'	1202775.1424'
2006	STA=74+68.35	0.00' RIGHT	1759707.6012'	1203661.2611'

PROJECT COORDINATES FOR PROPOSED R.O.W.				
POINT NUMBER	STATION	OFFSET	NORTHING	EASTING
3000	STA=55+83.96	43.00' LEFT	1759964.6918'	1201992.2518'
3001	STA=56+36.63	43.00' LEFT	1759960.4740'	1202045.6525'
3002	STA=57+43.00	43.00' LEFT	1759950.9820'	1202151.6023'
3003	STA=57+43.00	41.69' LEFT	1759949.8804'	1202151.4857'
3014	STA=61+36.27	31.32' LEFT	1759902.6024'	1202542.6169'

**LEGEND**

SECTION / QUARTER SECTION LINE  
 PLATTED LOT LINES  
 PROPERTY (DEED) LINE  
 APPARENT PROPERTY LINE  
 EXISTING CENTERLINE  
 PROPOSED CENTERLINE  
 EXISTING RIGHT OF WAY LINE  
 PROPOSED RIGHT OF WAY LINE  
 EXISTING EASEMENT  
 PROPOSED EASEMENT  
 EXISTING ACCESS CONTROL LINE  
 PROPOSED ACCESS CONTROL LINE  
 MEASURED DIMENSION  
 COMPUTED DIMENSION  
 RECORDED DIMENSION  
 EXISTING BUILDING

BEARINGS ARE REFERENCED TO THE ILLINOIS STATE PLANE COORDINATE SYSTEM, (NAD'83 (2007 ADJUSTMENT)), EAST ZONE.

IRON PIPE OR ROD FOUND  
 CUT CROSS FOUND OR SET  
 THESE STAKES REFERENCE FOUND OR SET MONUMENTATION. SET 5/8 INCH IRON ROD FLUSH WITH GROUND TO THE FOUND IRON STAKE IDENTIFIED BY COLORED PLASTIC CAP BEARING SURVEYORS REGISTRATION NUMBER.  
 THESE STAKES, IN CULTIVATED AREAS, REFERENCE FOUND OR SET MONUMENTATION. BURIED 5/8 INCH IRON ROD 20 INCHES BELOW GROUND TO THE FOUND IRON STAKE, IDENTIFIED BY COLORED PLASTIC CAP BEARING SURVEYORS REGISTRATION NUMBER.  
 STAKING OF PROPOSED RIGHT OF WAY. SET DIVISION OF HIGHWAYS SURVEY MARKER TO MONUMENT THE POSITION SHOWN, IDENTIFIED BY INSCRIPTION DATA AND SURVEYORS REGISTRATION NUMBER.  
 STAKING OF PROPOSED RIGHT OF WAY IN CULTIVATED AREAS. BURIED 5/8 INCH METAL ROD 20 INCHES BELOW GROUND TO MARK FUTURE SURVEY MARKER POSITION IDENTIFIED BY COLORED PLASTIC CAP BEARING SURVEYORS REGISTRATION NUMBER.  
 PERMANENT SURVEY MARKER, I.D.O.T. STANDARD 2035 (TO BE SET BY OTHERS)  
 RIGHT OF WAY STAKING PROPOSED TO BE SET

STATE OF ILLINOIS )  
 COUNTY OF COOK )

THIS IS TO CERTIFY THAT I, RANDELL E. GANN, AN ILLINOIS PROFESSIONAL LAND SURVEYOR, (WE, ROBINSON ENGINEERING, LTD., AN ILLINOIS PROFESSIONAL DESIGN FIRM LAND SURVEYING CORPORATION, NUMBER 18400128,) HAVE SURVEYED THE PLAT OF HIGHWAYS SHOWN HEREON IN SECTION 29, TOWNSHIP 35 NORTH, RANGE 15 EAST OF THE THIRD PRINCIPAL MERIDIAN, COOK COUNTY, THAT THE SURVEY IS TRUE AND COMPLETE AS SHOWN TO THE BEST OF MY KNOWLEDGE AND BELIEF, THAT THE PLAT CORRECTLY REPRESENTS SAID SURVEY, THAT ALL MONUMENTS FOUND AND ESTABLISHED ARE OF PERMANENT QUALITY AND OCCUPY THE POSITIONS SHOWN THEREON AND THAT THE MONUMENTS ARE SUFFICIENT TO ENABLE THE SURVEY TO BE RETRACED, MADE FOR THE DEPARTMENT OF TRANSPORTATION, STATE OF ILLINOIS.

DATED AT SOUTH HOLLAND, ILLINOIS THIS 6TH DAY OF NOVEMBER, 2013 A.D.

ILLINOIS PROFESSIONAL LAND SURVEYOR NO. 035-003241  
 LICENSE EXPIRATION DATE: NOVEMBER 30, 2014

THIS PROFESSIONAL SERVICE CONFORMS TO THE CURRENT ILLINOIS MINIMUM STANDARDS FOR A BOUNDARY SURVEY.


RECEIVED APR 25 2014  
 PLATS & LEGALS

**Robinson ENGINEERING**  
 17000 SOUTH PARK AVENUE  
 SOUTH HOLLAND, IL 60473  
 (708) 331-6700

**PLAT OF HIGHWAYS**  
 STATE OF ILLINOIS  
 DEPARTMENT OF TRANSPORTATION  
 SAUK TRAIL AT BURNHAM AVENUE

LIMITS: COUNTY: COOK  
 STATION: BURNHAM AVENUE JOB NO.: R-90-025-13  
 SCALE: 1"=100' TO STATION 69+03.84  
 SHEET 02 OF 03

BUREAU OF LAND ACQUISITION  
 201 WEST CENTER COURT  
 SCHAUMBURG, ILLINOIS 60196

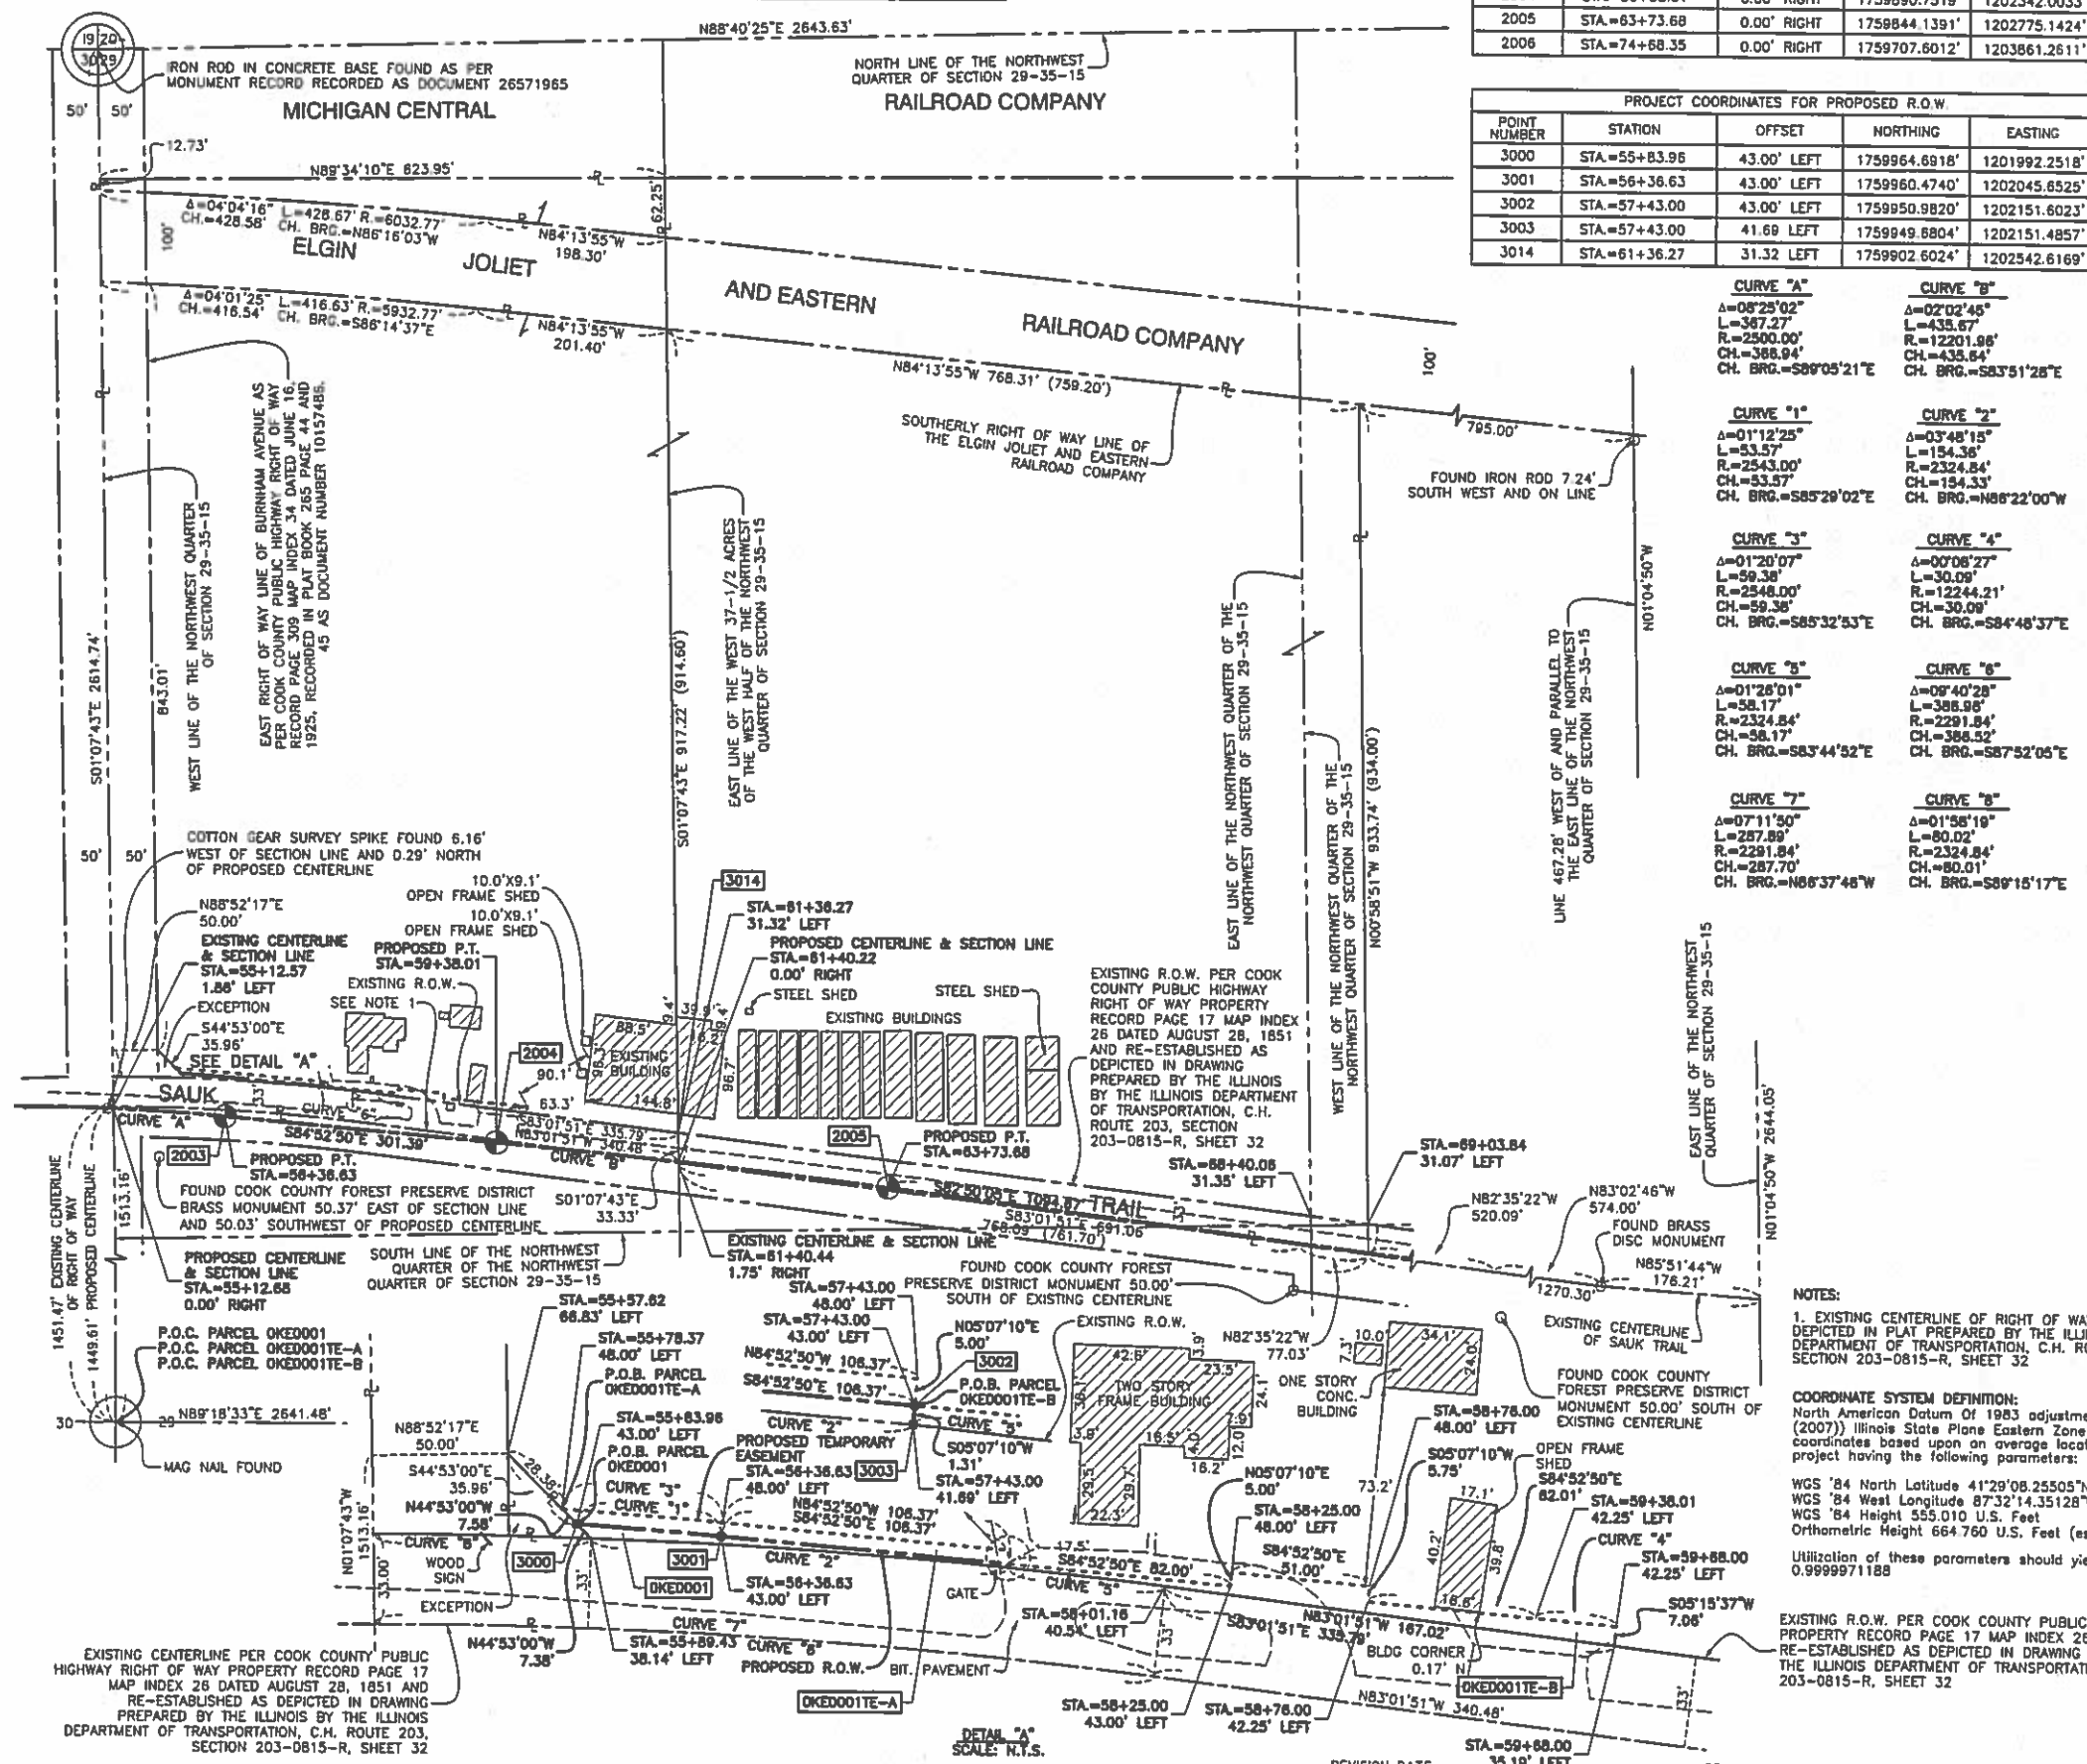


SWER: 11/11/2013 9:04:47 AM DWG. NAME: H:\PROJECTS\2013\10-01-915\_001\_COOK\_COUNTY\_SAUK\_TRAIL\_BURNHAM\_AVE\DRAWING\10-01-915\_001\_Plat.dwg



B L O O M

T W P

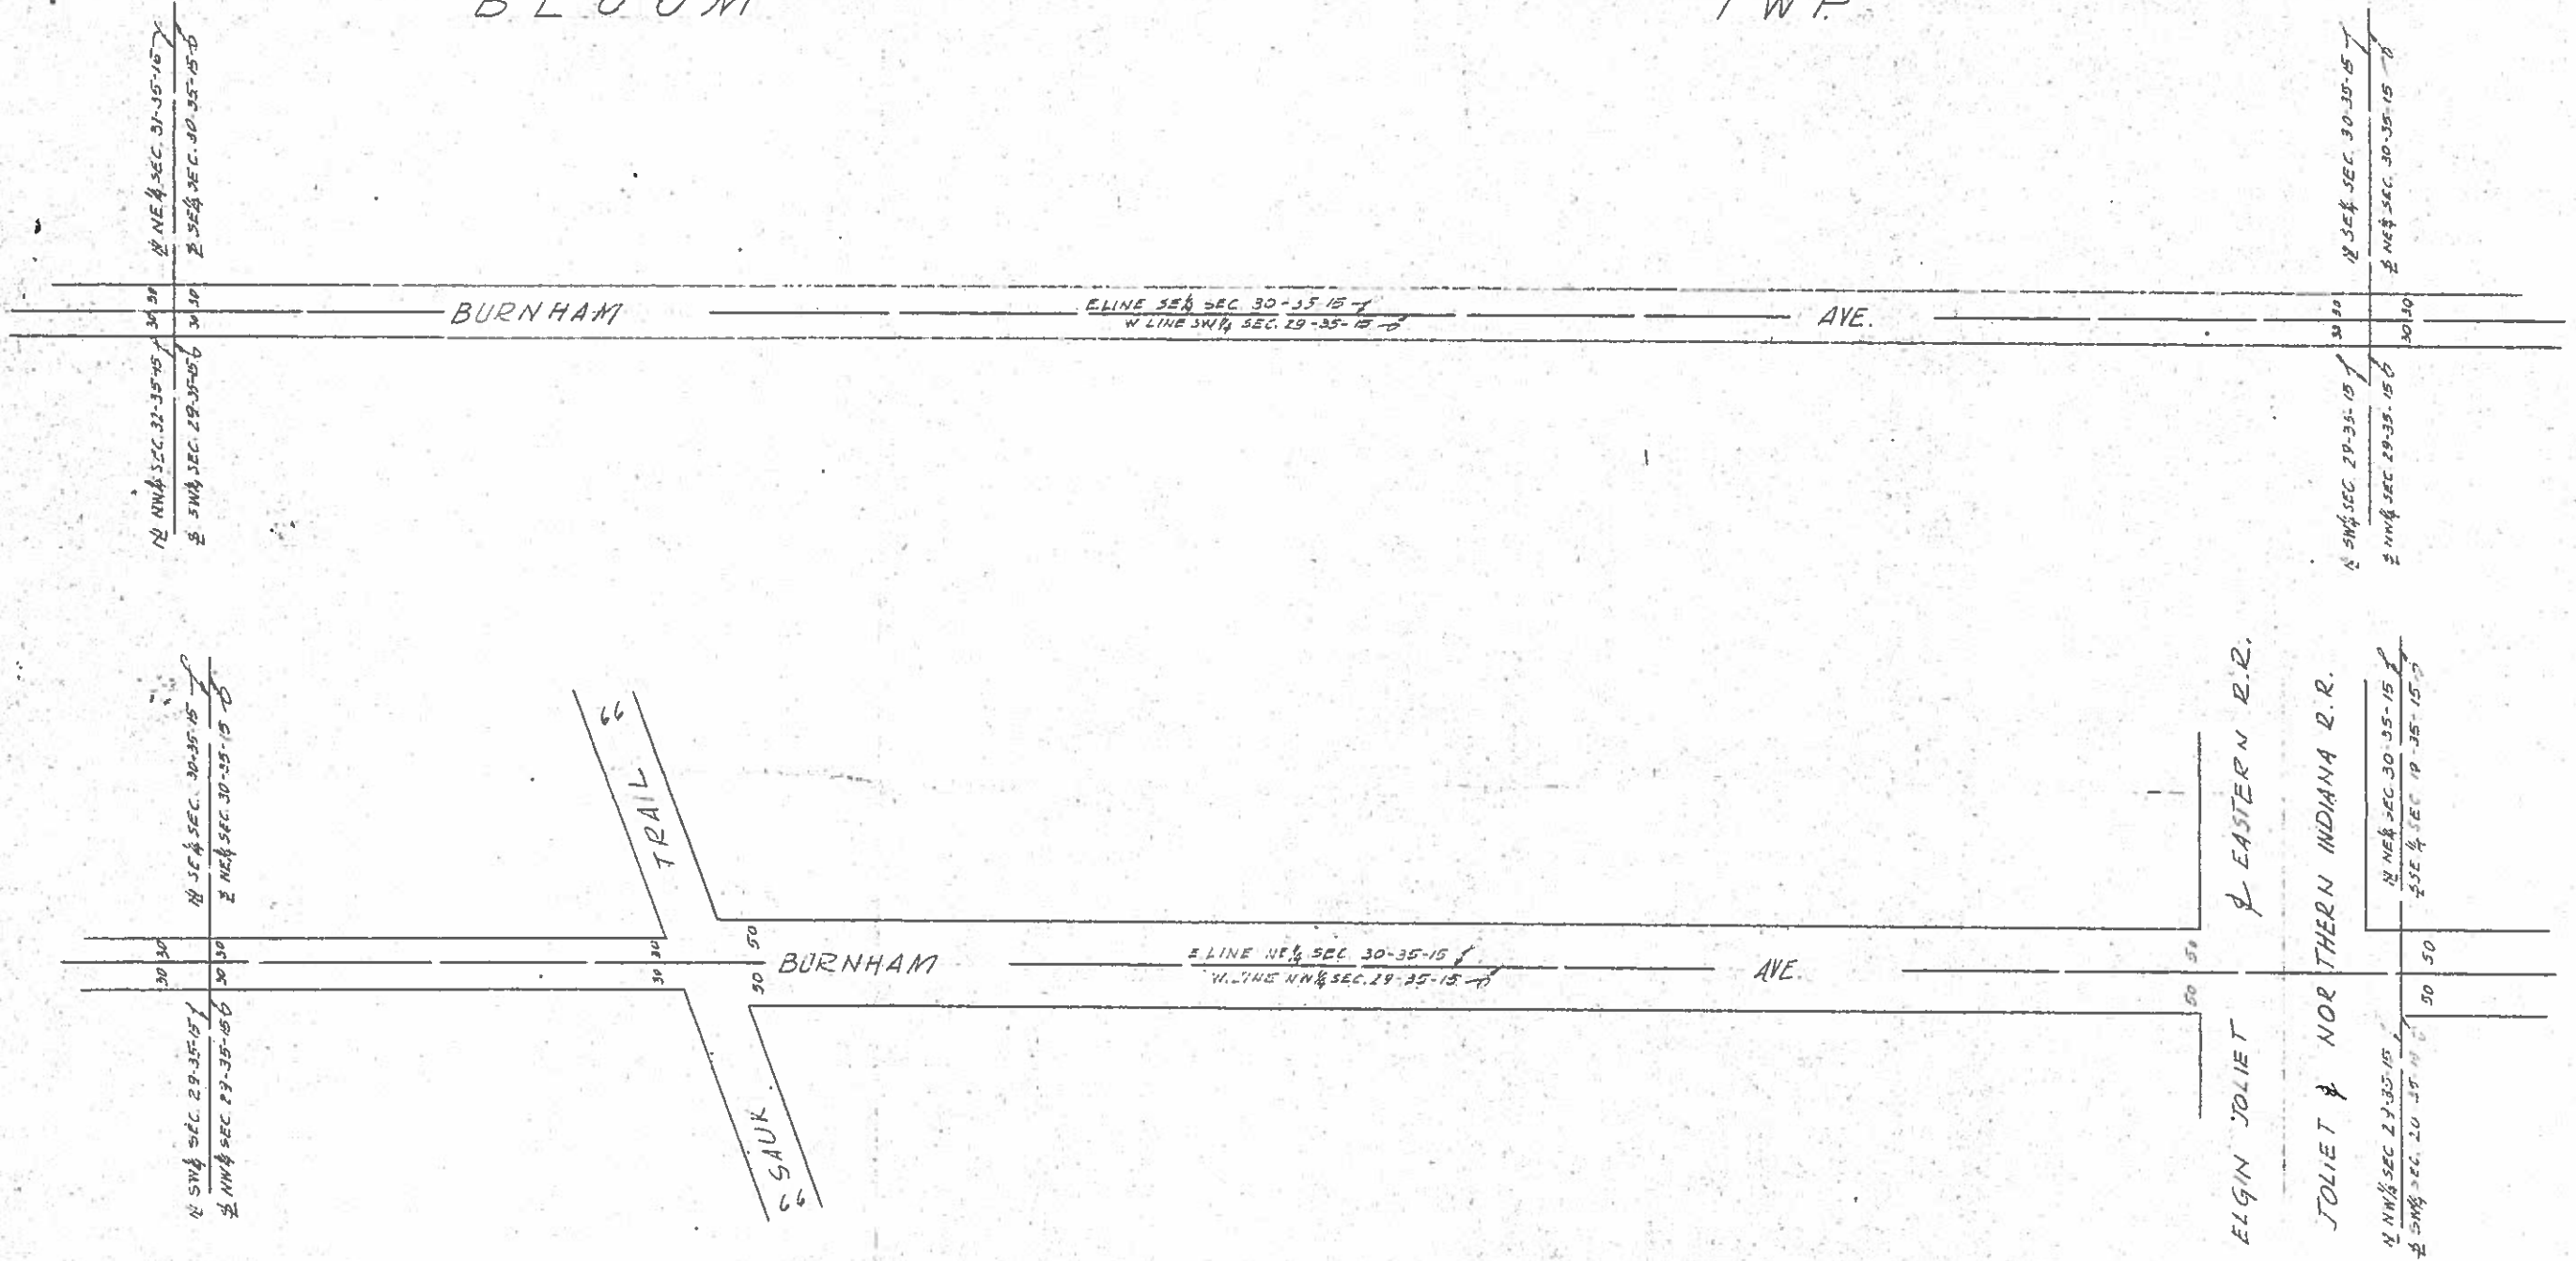


NOTE:  
 SAUK TRAIL HIGHWAY  
 66 BY TRP DEDICATION 8-28-1851  
 COTTAGE GROVE AVE TO INDIANA LINE  
 NO WIDTH GIVEN ILLINOIS STATUTE'S GIVE 66'

NOTE:  
 BURNHAM AVE.  
 60' BY CONDEMNATION 6-13-1893  
 STEGER ROAD TO SAUK TRAIL



NO.	DATE	BY	DESCRIPTION	APP.

<b>(R/W)</b>	<b>DEPARTMENT OF HIGHWAYS</b>				<b>(R/W)</b>
	RIGHT OF WAY ENGINEERING AND SURVEY DIVISION COOK COUNTY, ILLINOIS				
PRESIDENT BOARD OF COMMISSIONERS		SUPERINTENDENT OF HIGHWAYS			
STRIP MAP					
<b>BURNHAM AVE.</b>					
13322 ST TO STEGER RD.					
DRAWN J.K.		DATE 10-15-1973			
SCALE 1" = 100'		CHECKED			
SURVEY NO.		APPROVED			
APPROVED		COUNTY HIGHWAY SECTION NO.	SHEET NO.	TOTAL SHEETS	PLAT NO.
CHIEF ENGINEER OF DESIGN		039-0104	3	6	SM 282

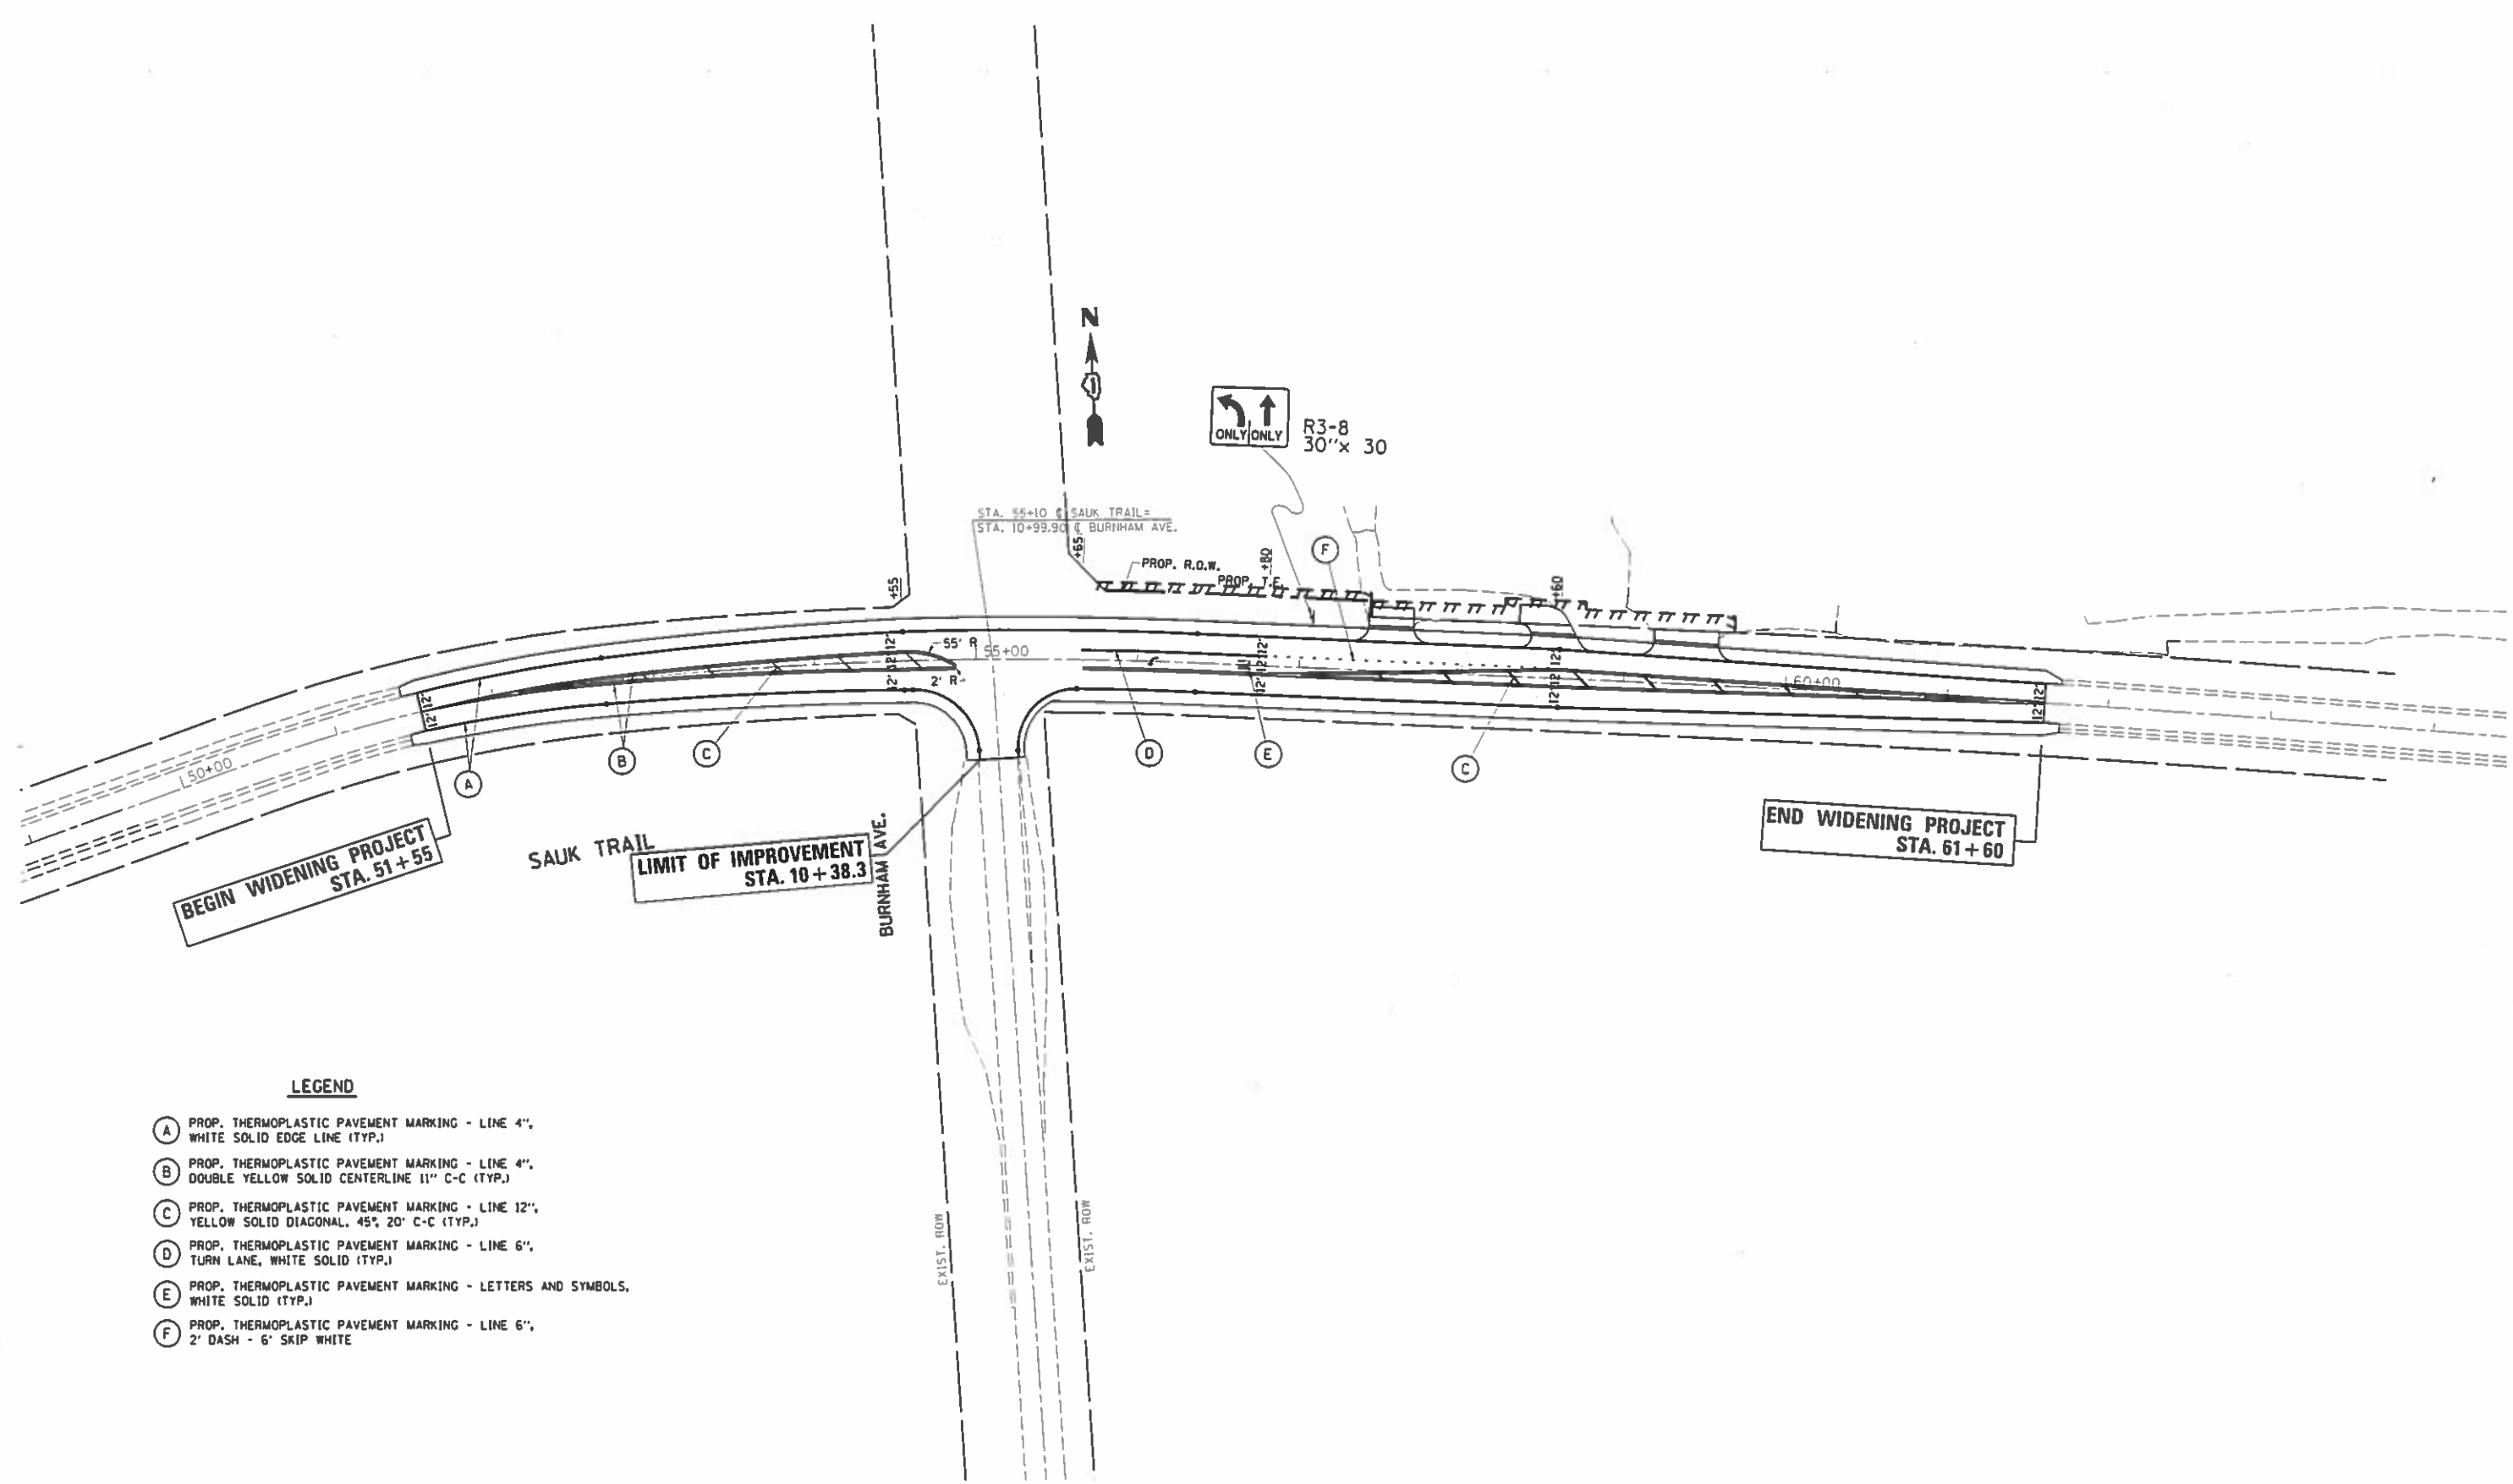

**LEGEND**

- (A) PROP. THERMOPLASTIC PAVEMENT MARKING - LINE 4", WHITE SOLID EDGE LINE (TYP.)
- (B) PROP. THERMOPLASTIC PAVEMENT MARKING - LINE 4", DOUBLE YELLOW SOLID CENTERLINE 11" C-C (TYP.)
- (C) PROP. THERMOPLASTIC PAVEMENT MARKING - LINE 12", YELLOW SOLID DIAGONAL, 45°, 20" C-C (TYP.)
- (D) PROP. THERMOPLASTIC PAVEMENT MARKING - LINE 6", TURN LANE, WHITE SOLID (TYP.)
- (E) PROP. THERMOPLASTIC PAVEMENT MARKING - LETTERS AND SYMBOLS, WHITE SOLID (TYP.)
- (F) PROP. THERMOPLASTIC PAVEMENT MARKING - LINE 6", 2' DASH - 6' SKIP WHITE


FILE NAME	USER NAME: lizakrf	DESIGNED	REVISED
PROJECT: IL084EBIDINTEG.illinois.gov\PI\DOT Documents\DOT Offices\District 1\Projects\PI\DOT\Drawings\CD\Sheets\PI\DOT\2-shr\pmk.dgn	DRAWN	CHECKED	REVISED
Default	PLLOT SCALE: 100.0000	DATE	REVISED
	PLLOT DATE: 11/4/2016		

**STATE OF ILLINOIS  
DEPARTMENT OF TRANSPORTATION**

**PAVEMENT MARKING AND SIGNAGE PLAN  
SAUK TRAIL AT BURNHAM RD.**

SCALE: 1"=50' SHEET OF SHEETS STA. 51+55 TO STA. 61+60



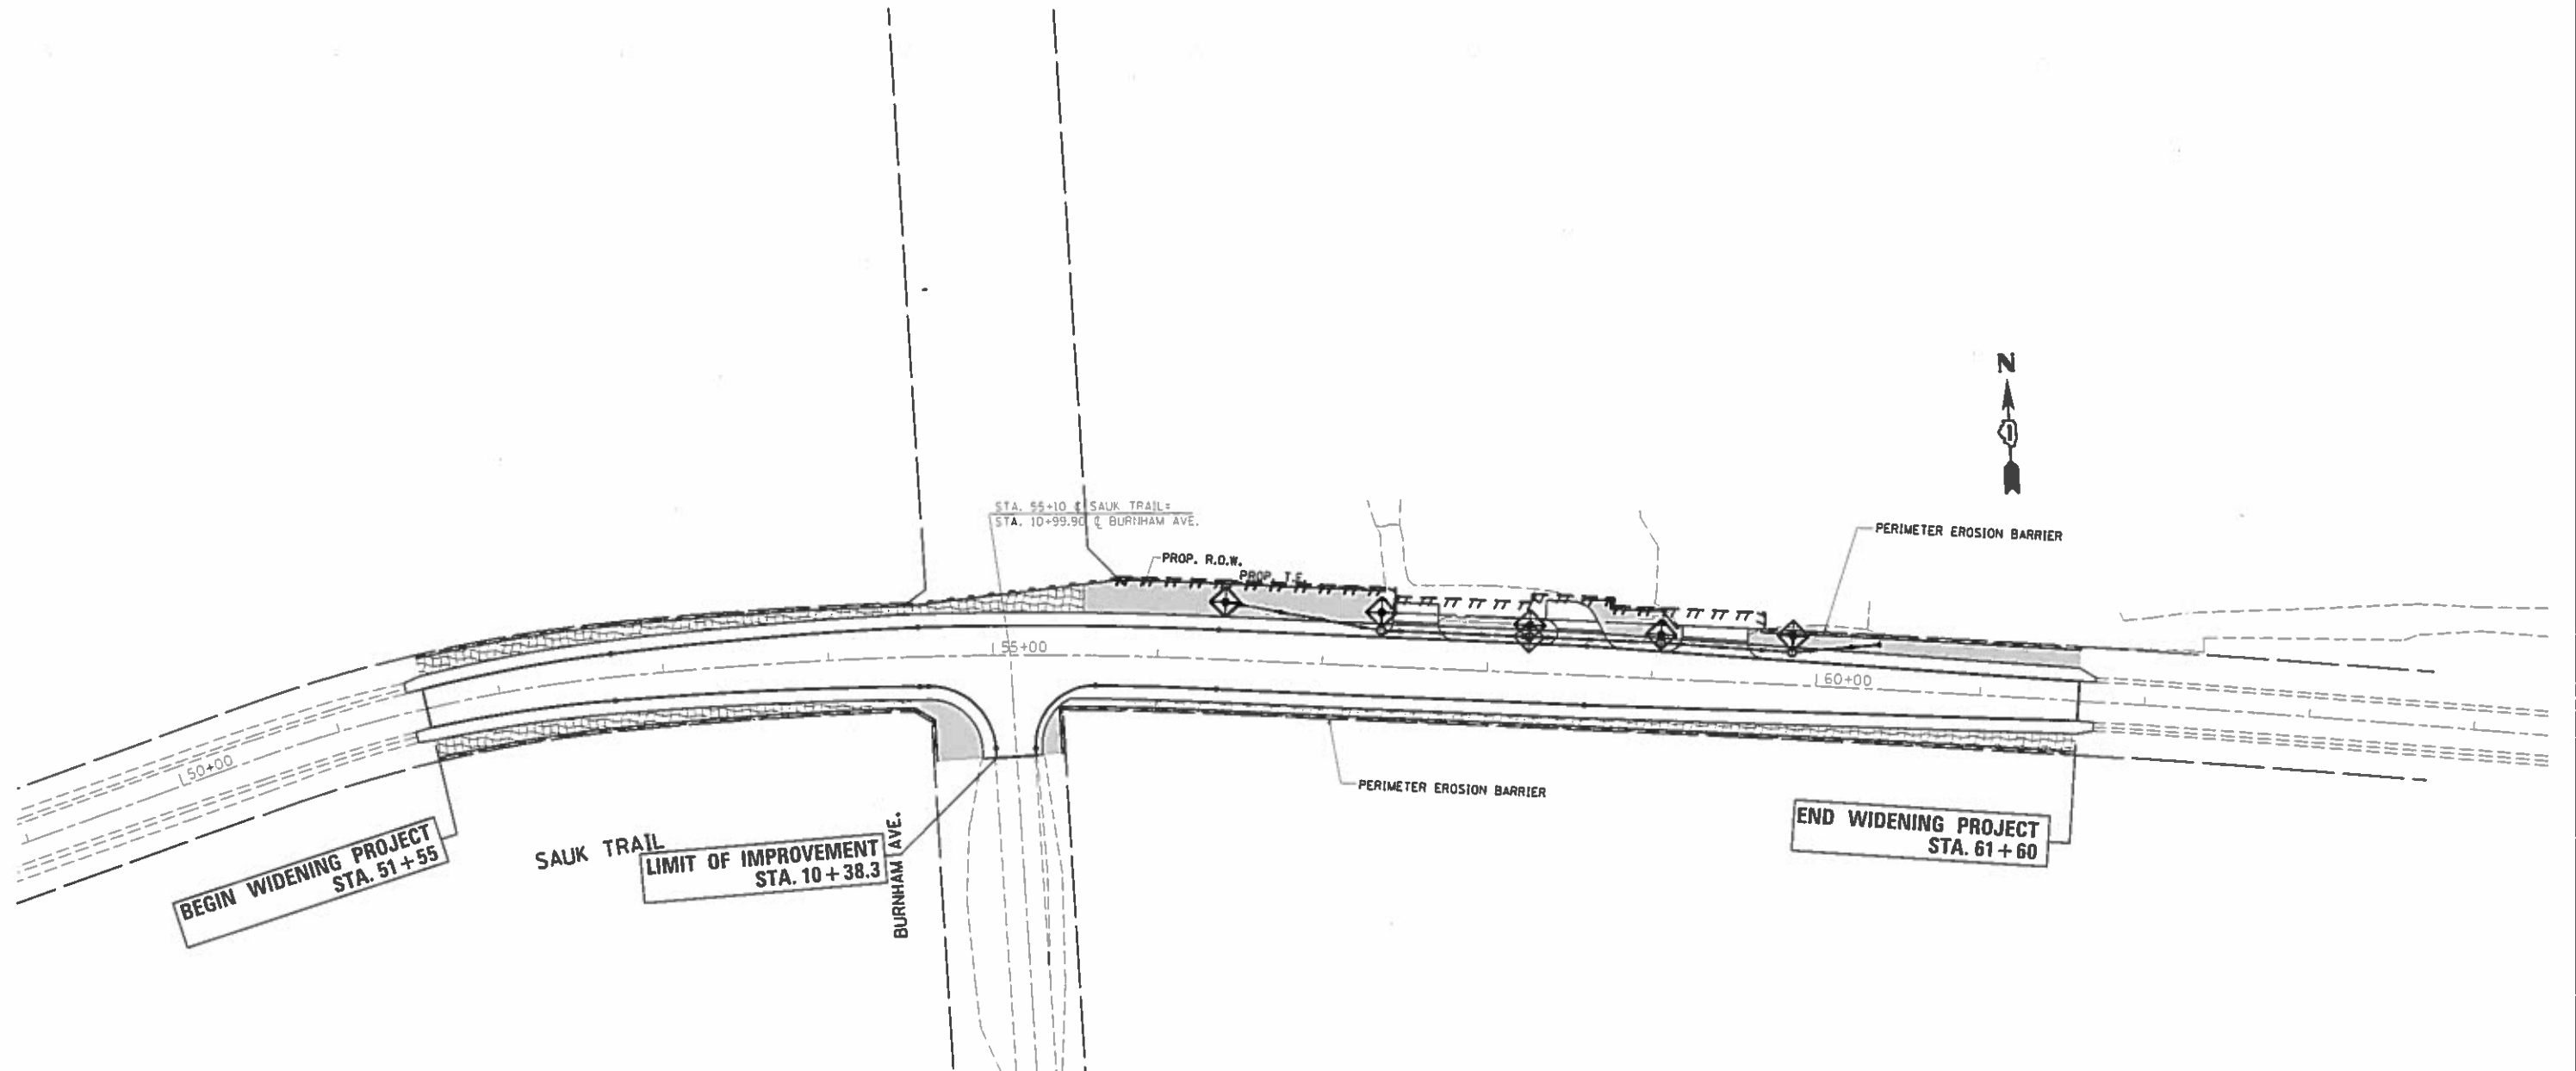

F.A.U. RTE.	SECTION	COUNTY	TOTAL SHEETS	SHEET NO.
1632	49R-R5	COOK	48	26
CONTRACT NO. 60X38				
ILLINOIS FED. AID PROJECT				



**EROSION CONTROL GENERAL NOTES:**


1. SOIL DISTURBANCES SHALL BE CONDUCTED IN SUCH A MANNER AS TO MINIMIZE EROSION. SOIL STABILIZATION MEASURES SHALL CONSIDER THE TIME OF YEAR, SITE CONDITIONS, AND THE USE OF TEMPORARY OR PERMANENT MEASURES.
2. SOIL EROSION AND SEDIMENT CONTROL FEATURES SHALL BE CONSTRUCTED PRIOR TO THE COMMENCEMENT OF UPLAND DISTURBANCE.
3. TEMPORARY SOIL STABILIZATION SHALL BE APPLIED TO DISTURBED AREAS WITHIN 7 CALENDAR DAYS OF THE END OF ACTIVE HYDROLOGIC DISTURBANCE. PERMANENT STABILIZATION SHALL BE DONE WITHIN 14 DAYS AFTER COMPLETION OF FINAL GRADING.
4. ALL STORM SEWERS FACILITIES THAT ARE OR WILL BE FUNCTIONING DURING CONSTRUCTION SHALL BE PROTECTED, FILTERED OR OTHERWISE TREATED TO REMOVE SEDIMENT.
5. ALL TEMPORARY EROSION AND SEDIMENT CONTROL MEASURES SHALL BE REMOVED WITHIN 30 DAYS AFTER FINAL SITE STABILIZATION IS ACHIEVED OR AFTER THE TEMPORARY MEASURES ARE NO LONGER NEEDED. TRAPPED SEDIMENT AND OTHER DISTURBED SOIL AREAS SHALL BE PERMANENTLY STABILIZED.
6. ALL TEMPORARY EROSION AND SEDIMENT CONTROL MEASURES SHALL BE MAINTAINED AND REPAIRED AS NEEDED. THE CONTRACTOR SHALL BE RESPONSIBLE FOR INSPECTION AND REPAIR DURING CONSTRUCTION.
7. THE EROSION CONTROL MEASURES INDICATED ON THE PLANS ARE THE MINIMUM REQUIREMENTS. ADDITIONAL MEASURES MAY BE REQUIRED, AS DIRECTED BY THE ENGINEER.
8. THE CONTRACTOR SHALL INSTALL ALL EROSION CONTROL PRIOR TO THE START OF ANY EARTHWORK.
9. IF A STOCKPILE IS TO REMAIN IN PLACE FOR MORE THAN THREE DAYS, EROSION CONTROL MEASURES SHALL BE PROVIDED BY THE CONTRACTOR.

**LEGEND**


-  PERIMETER EROSION BARRIER
-  INLET FILTER
-  EROSION CONTROL BLANKET SEEDING, CLASS 4 (MODIFIED)
-  SODDING, SALT TOLERANT

NOTE: SEE SHEET 14 FOR LANDSCAPING ITEMS


FILE NAME *	USER NAME *	DESIGNED *	REVISED *	<b>STATE OF ILLINOIS DEPARTMENT OF TRANSPORTATION</b>	<b>LANDSCAPING, EROSION &amp; SEDIMENT CONTROL PLAN SAUK TRAIL AT BURNHAM RD.</b>	F.A.U. RTE.	SECTION	COUNTY	TOTAL SHEETS	SHEET NO.	
g:\11\108\EBID\INTEG.illinois.gov\FW1001\0	laments\1007 Offices\District 1\Projects\P110	DRAWN by C:\osheets\P110012\sh\eros.dgn	REVISED *			1632	49R-RS	COOK	48	26A	
Default	PLOT SCALE = 100.0000 in.	CHECKED *	REVISED *			SCALE: 1"=50'		SHEET OF SHEETS		STA. 51+55 TO STA. 61+60	
	PLOT DATE = 11-22-2016	DATE *	REVISED *			ILLINOIS FED. AID PROJECT CONTRACT NO. 60X38					

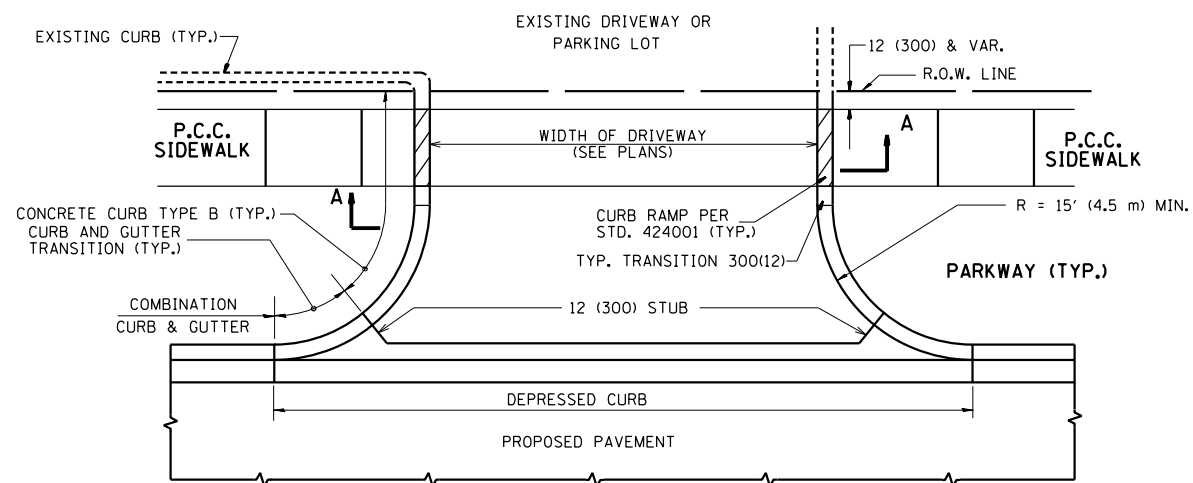


WITH CONCRETE CURB, TYPE B

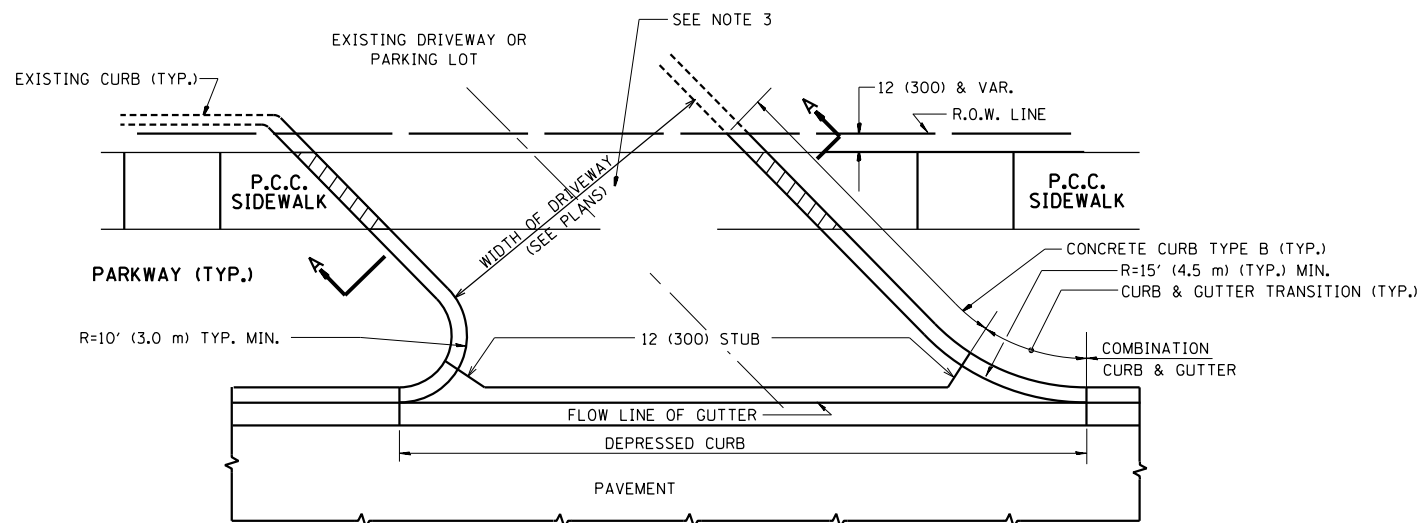


WITH CONCRETE CURB, TYPE B

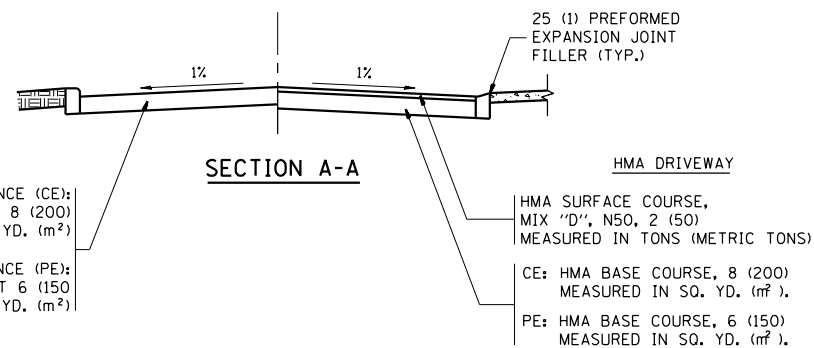


SECTION A-A

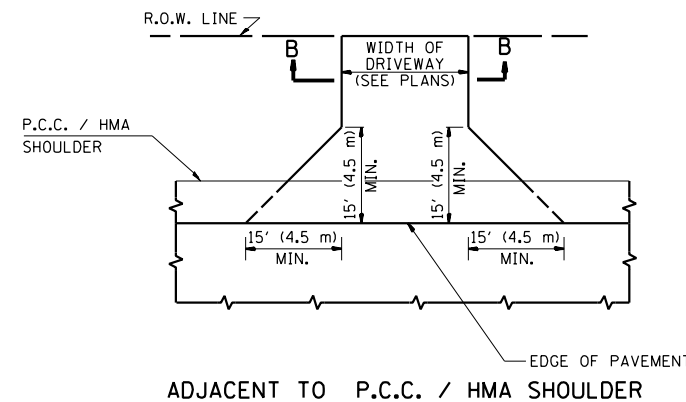

ADJACENT TO P.C.C. / HMA SHOULDER

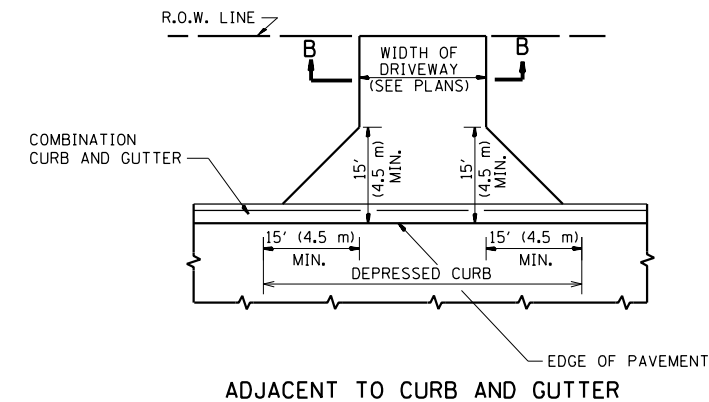

ADJACENT TO CURB AND GUTTER

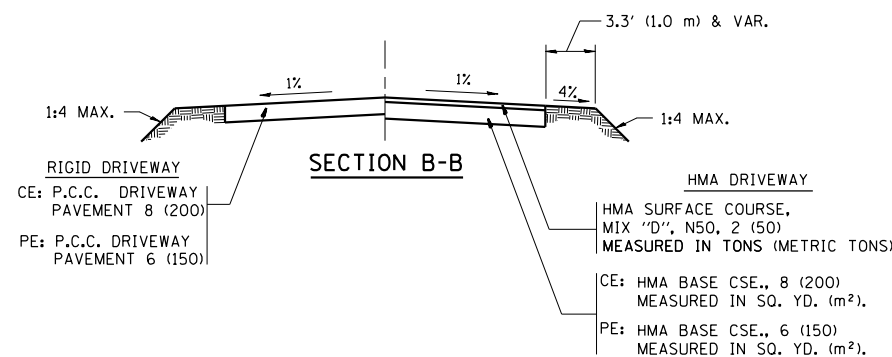

SECTION B-B

**GENERAL NOTES:**

DRIVEWAY SLOPES, LOCATIONS, & GEOMETRIC LAYOUT SHALL BE IN ACCORDANCE WITH THE LATEST EDITION OF THE "HANDBOOK FOR POLICY ON PERMITS FOR ACCESS DRIVEWAYS TO STATE HIGHWAYS". FOR FURTHER LAYOUT REQUIREMENTS, REFER TO ILLUSTRATIONS IN THE PERMIT HANDBOOK. DRIVEWAYS SHALL BE REPLACED IN KIND, UNLESS OTHERWISE NOTED ON THE PLANS.

COMMERCIAL DRIVEWAYS SHALL BE CONSTRUCTED WITH CONCRETE CURB, TYPE B RETURNS EXCEPT WHEN THE SIDEWALK EDGE IS 4 FEET (1.2 METERS) OR LESS FROM THE BACK OF CURB, CONSTRUCT A FLARE DRIVEWAY WITHOUT CURB.

THE RESIDENT ENGINEER SHALL CONTACT THE TRAFFIC PERMIT OFFICE AT 847/ 705-4131 FOR ANY QUESTIONS ON DRIVEWAYS SHOWN IN THE PLANS; SPECIFICALLY IN REFERENCE TO ADDITIONAL AND/OR RELOCATION/REMOVAL OF A DRIVEWAY.

COMBINATION CONCRETE CURB & GUTTER SHALL BE MEASURED STRAIGHT ACROSS THE DRIVEWAY. NO ADDITIONAL COMPENSATION WILL BE ALLOWED FOR THE CURB & GUTTER TRANSITION.

1 (25) PREFORMED EXPANSION JOINT FILLER WILL NOT BE PAID SEPARATELY, BUT SHALL BE CONSIDERED INCLUDED IN THE COST OF THE P.C.C. DRIVEWAY PAVEMENT OR P.C.C. SIDEWALK.

WHEN THE P.C.C. SIDEWALK EXTENDS THROUGH THE DRIVEWAY, THE THICKNESS OF THE SIDEWALK IN THE DRIVEWAY AREA SHALL BE THE SAME AS THE DRIVEWAY THICKNESS. SIDEWALK WILL BE PAID FOR AS P.C.C. SIDEWALK OF THE THICKNESS SPECIFIED. SIDEWALK CROSS SLOPE THRU DRIVEWAY AREA TO BE A MAXIMUM OF 1:50.


**RURAL FIELD ENTRANCE (FE)**  
HMA SURFACE COURSE, MIX "D", N50, 2 (50) MEASURED IN TONS (METRIC TONS)  
AGGREGATE BASE CSE., TYPE B, 8 (200) MEASURED IN SQ. YD. (m<sup>2</sup>).

FILE NAME =	USER NAME = qureshiya	DESIGNED - R. SHAH	REVISED - P. LaFLUER 04-15-03
ca:\pw_work\p1dot\qureshiya\d0283041\Dis	Std.dgn	DRAWN -	REVISED - R. BORO 01-01-07
	PLOT SCALE = 100.0002' / 1"	CHECKED -	REVISED - R. BORO 06-11-08
	PLOT DATE = 10/26/2016	DATE - 11-04-95	REVISED - R. BORO 09-06-11


**STATE OF ILLINOIS  
DEPARTMENT OF TRANSPORTATION**

<b>DRIVEWAY DETAILS - DISTANCE BETWEEN R.O.W. AND FACE OF CURB &amp; EDGE OF SHOULDER &gt;= 15' (4.5 m)</b>	
SCALE: NONE	SHEET NO. 1 OF 1 SHEETS STA. TO STA.


F.A.U. RTE.	SECTION	COUNTY	TOTAL SHEETS	SHEET NO.
1632	49R-RS	COOK	48	27
<b>BD0156-07 (BD-01)</b>		<b>CONTRACT NO. 60X38</b>		
FED. ROAD DIST. NO. 1 (ILLINOIS) FED. AID PROJECT				

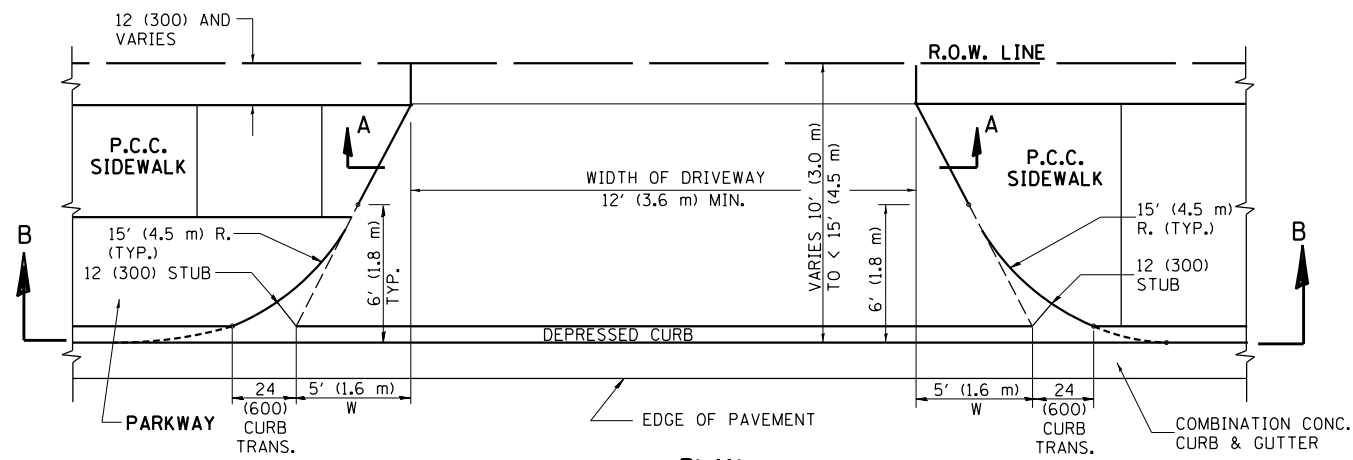


**PLAN**  
10' (3.0 m) TO < 15' (4.5 m)

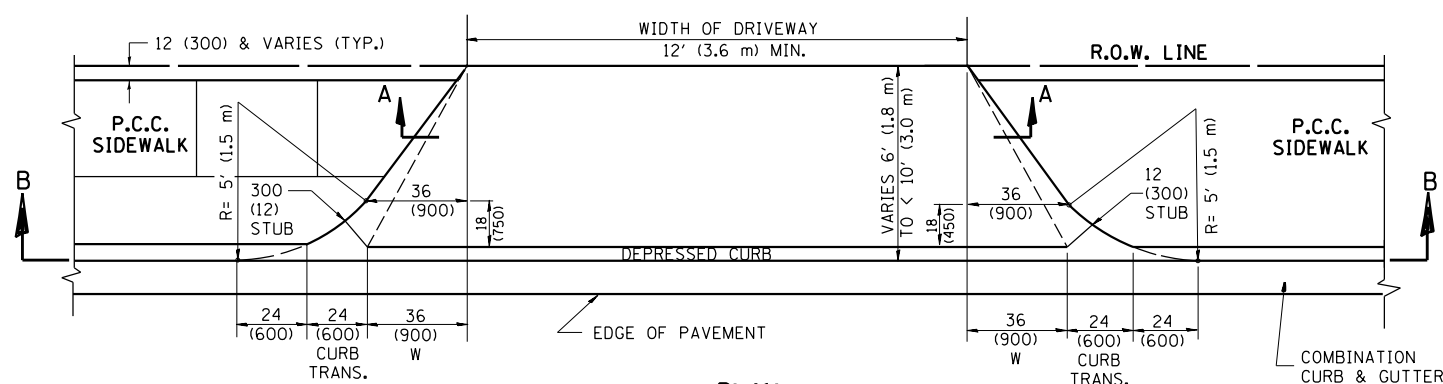


**PLAN**  
6' (1.8 m) TO < 10' (3.0 m)

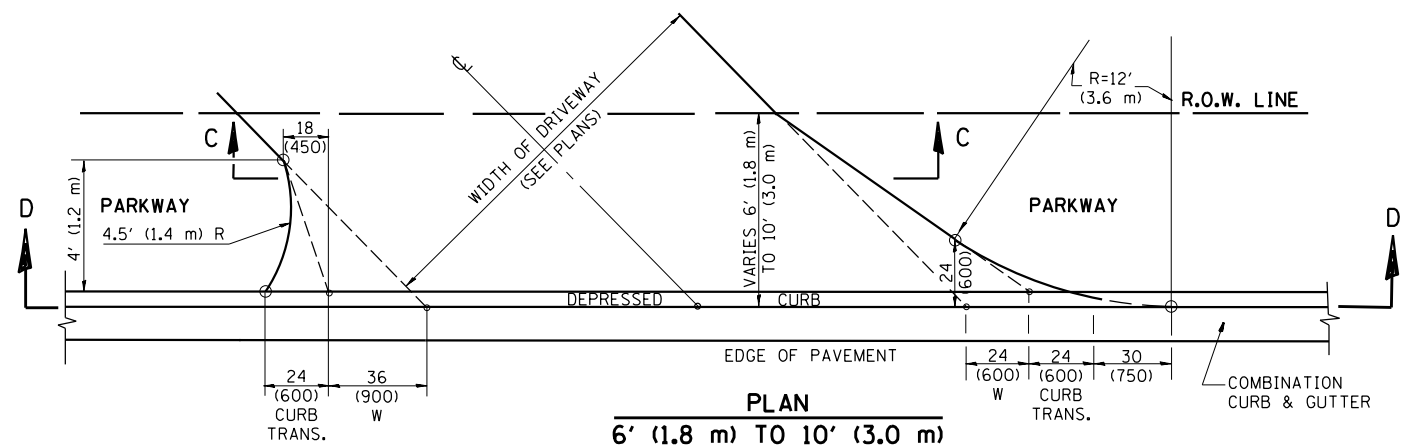


**PLAN**  
6' (1.8 m) TO 10' (3.0 m)

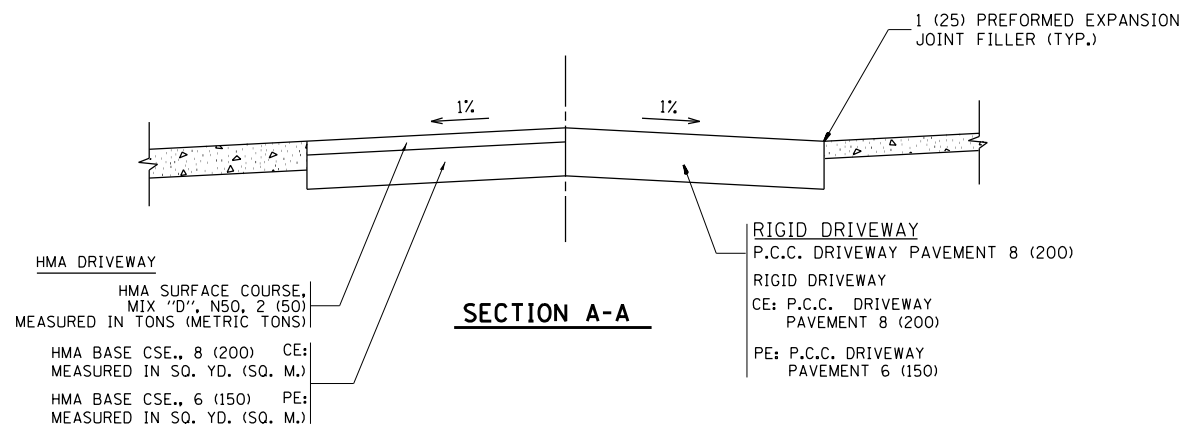


**SECTION A-A**

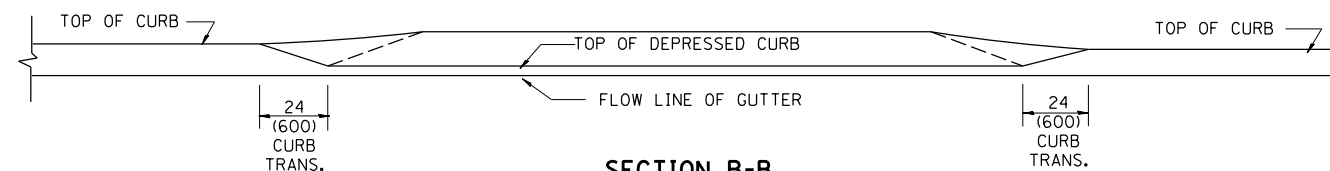

**SECTION B-B**

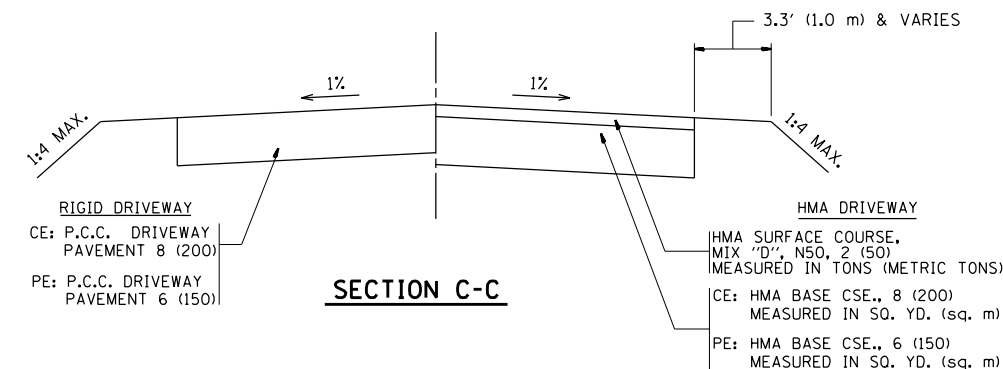

**SECTION C-C**

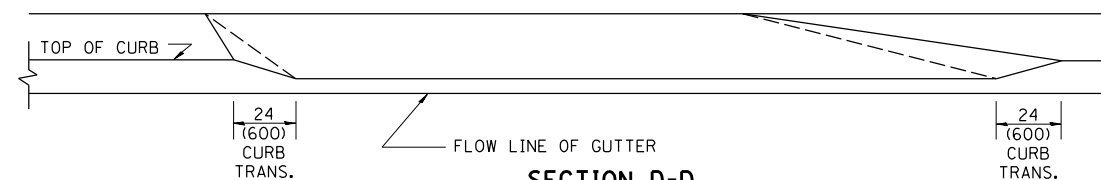

**SECTION D-D**

**GENERAL NOTES**

DRIVEWAY SLOPES, LOCATIONS, & GEOMETRIC LAYOUT SHALL BE IN ACCORDANCE WITH THE LATEST EDITION OF THE "HANDBOOK FOR POLICY ON PERMITS FOR ACCESS DRIVEWAYS TO STATE HIGHWAYS". FOR FURTHER LAYOUT REQUIREMENTS, REFER TO ILLUSTRATION 10 IN THE PERMIT HANDBOOK. WHERE SIDEWALKS EXIST, DRIVEWAYS SHALL BE REPLACED WITH RIGID PAVEMENT. WHERE NO SIDEWALKS EXIST, DRIVEWAYS SHALL BE REPLACED IN KIND. SIDEWALK CROSS SLOPE THRU DRIVEWAY AREA TO BE A MAXIMUM OF 1:50.

WHEN THE DISTANCE BETWEEN R.O.W. AND THE BACK OF CURB IS EQUAL TO OR LESS THAN 8' (2.4 m), THE P.C.C. SIDEWALK SHALL EXTEND TO THE BACK OF CURB.

THE RESIDENT ENGINEER SHALL CONTACT THE TRAFFIC PERMIT OFFICE AT 847/ 705-4131 FOR ANY QUESTIONS ON DRIVEWAYS SHOWN IN THE PLANS; SPECIFICALLY IN REFERENCE TO ADDITIONAL AND/OR RELOCATION/REMOVAL OF A DRIVEWAY.

COMBINATION CONCRETE CURB & GUTTER SHALL BE MEASURED STRAIGHT ACROSS THE DRIVEWAY. NO ADDITIONAL COMPENSATION WILL BE ALLOWED FOR THE CURB & GUTTER TRANSITION.

THE 1 (25) PREFORMED EXPANSION JOINT FILLER WILL NOT BE PAID SEPARATELY, BUT SHALL BE CONSIDERED INCLUDED IN THE COST OF THE P.C.C. DRIVEWAY PAVEMENT OR P.C.C. SIDEWALK.

"W" VARIES FROM 36 (900) TO 5' (1.5 m) PROPORTIONAL TO THE LENGTH (L), FROM 6' (1.8 m) TO 10' (3 m).


ALL DIMENSIONS ARE IN INCHES (MILLIMETERS) UNLESS OTHERWISE NOTED.

FILE NAME =	USER NAME = qureshiya	DESIGNED - R. SHAH	REVISED - M. GOMEZ 04-06-01
ca:\pw_work\p1dot\qureshiya\0283041\01s	Std.dgn	DRAWN -	REVISED - P. LOFLEUR 04-15-03
	PLOT SCALE = 100.0002' / 1"	CHECKED -	REVISED - R. BORO 01-01-07
	PLOT DATE = 10/26/2016	DATE - 11-06-95	REVISED - R. BORO 01-01-07

**STATE OF ILLINOIS  
DEPARTMENT OF TRANSPORTATION**

DRIVEWAY DETAILS	
DISTANCE BETWEEN ROW AND FACE OF CURB < 15' (4.5 m)	
SCALE: NONE	SHEET NO. 1 OF 1 SHEETS STA. TO STA.

F.A.U. RTE.	SECTION	COUNTY	TOTAL SHEETS	SHEET NO.
1632	49R-R5	COOK	48	28
BD400-02 (BD-02)			CONTRACT NO. 60X38	
FED. ROAD DIST. NO. 1 ILLINOIS FED. AID PROJECT				

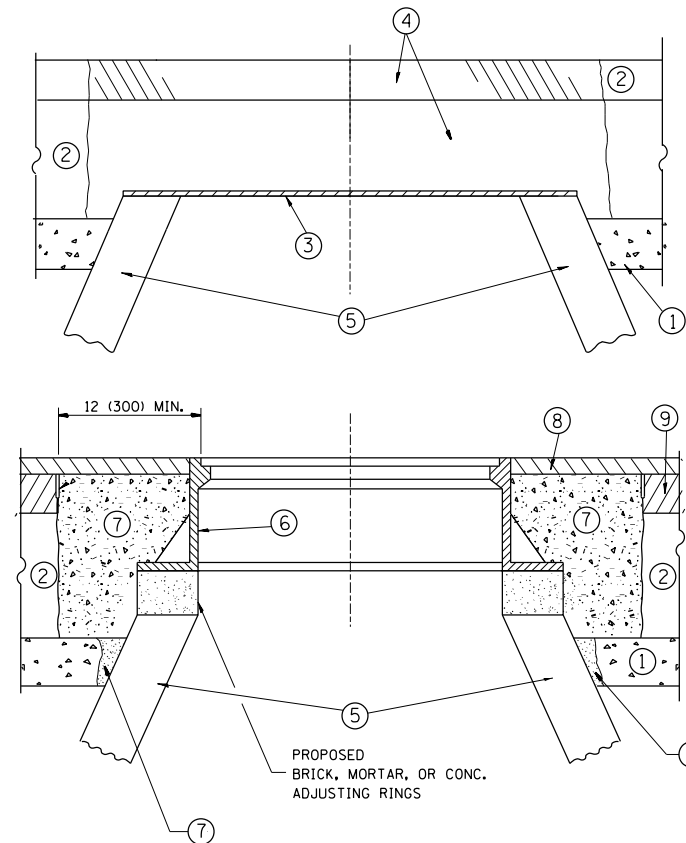

**CONSTRUCTION PROCEDURES**

**STAGE 1 (BEFORE PAVEMENT MILLING)**

- A) REMOVE A MINIMUM OF 12 (300) OF THE PAVEMENT FROM AROUND THE STRUCTURE.
- B) REMOVE THE EXISTING FRAME AND LID FROM THE STRUCTURE.
- C) COVER THE STRUCTURE OPENING WITH A 36 (900) DIAMETER METAL PLATE.
- D) BACKFILL WITH CRUSHED STONE AND A MINIMUM 1/2 (40) THICK HMA SURFACE MIX APPROVED BY THE ENGINEER.

**STAGE 2 (AFTER PAVEMENT MILLING)**

- A) REMOVE THE HMA SURFACE MIX AND CRUSHED STONE.
- B) INSTALL THE FRAME AND LID; ADJUST THE FRAME TO ITS FINAL SURFACE ELEVATION.
- C) THE SURROUNDING SPACE SHALL BE FILLED WITH CLASS PP-1\* CONCRETE TO THE ELEVATION OF THE SURFACE OF THE EXISTING BASE COURSE OR THE BINDER COURSE.

\* UNLESS OTHERWISE SPECIFIED IN THE PLANS.

THE PROCEDURE EXPLAINED ABOVE SHALL CONFORM TO THE APPLICABLE PORTIONS OF SECTIONS 353, 406, 602, AND 603 OF THE STANDARD SPECIFICATIONS EXCEPT THAT "THE CONTRACTOR SHALL ADJUST THE STRUCTURES TO THE FINISHED PAVEMENT ELEVATION NO MORE THAN 5 CALENDAR DAYS PRIOR TO PLACEMENT OF THE FINAL LIFT OF SURFACE UNLESS APPROVED BY THE ENGINEER."

**LEGEND**

- ① SUB-BASE GRANULAR MATERIAL
- ② EXISTING PAVEMENT
- ③ 36 (900) DIAMETER METAL PLATE
- ④ PROPOSED CRUSHED STONE AND HMA SURFACE MIX
- ⑤ EXISTING STRUCTURE
- ⑥ FRAME AND LID (SEE NOTES)
- ⑦ CLASS PP-1\* CONCRETE
- ⑧ PROPOSED HMA SURFACE COURSE
- ⑨ PROPOSED HMA BINDER COURSE

**LOCATION OF STRUCTURES:**

THE CONTRACTOR WILL BE REQUIRED TO KEEP A RECORD OF THE LOCATIONS OF THE BURIED STRUCTURES ACCORDING TO THE STATION AND DISTANCE LEFT OR RIGHT OF THE CENTERLINE OF PAVEMENT. UPON COMPLETION OF THE WORK, THE CONTRACTOR WILL DELIVER THE RECORD TO THE ENGINEER.

**BASIS OF PAYMENT:**

REMOVING FRAMES AND LIDS ON DRAINAGE AND UTILITY STRUCTURES IN THE PAVEMENT PRIOR TO MILLING, AND ADJUSTING TO FINAL GRADE PRIOR TO PLACING THE SURFACE COURSE, WILL BE PAID FOR AT THE CONTRACT UNIT PRICE EACH FOR "FRAMES AND LIDS TO BE ADJUSTED (SPECIAL)."

THIS WORK WILL NOT BE PAID FOR WHEN DRAINAGE AND UTILITY STRUCTURES ARE SPECIFIED FOR PAYMENT AS STRUCTURE RECONSTRUCTION.

NEW FRAMES AND LIDS, WHEN SPECIFIED, WILL BE PAID FOR SEPARATELY.

**NOTES:**

EXISTING BROKEN FRAMES AND LIDS SHALL BE REMOVED AND DISPOSED OF BY THE CONTRACTOR AND SHALL BE REPLACED AS DIRECTED BY THE ENGINEER. REPLACEMENT FRAMES AND LIDS WILL BE PAID FOR IN ACCORDANCE WITH ARTICLE 109.04 OF THE STANDARD SPECIFICATIONS UNLESS A SEPARATE PAY ITEM HAS BEEN PROVIDED.

IF THE EXISTING LIDS ARE OPEN, THE FRAME WILL BE ADJUSTED TO THE ELEVATION OF THE MILLED PAVEMENT SURFACE PRIOR TO THE MILLING OPERATION. THE FRAME WILL NOT BE REMOVED AND COVERED BY THE METAL PLATE.

CITY OF CHICAGO CASTINGS ARE THE PROPERTY OF THE CITY AND THE CONTRACTOR SHALL NOTIFY THE CITY FOR REMOVAL AND DISPOSITION OF THE CASTINGS.

THE METAL PLATE USED TO COVER THE STRUCTURE SHALL REMAIN THE PROPERTY OF THE CONTRACTOR.

WHEN STRUCTURES ARE TO BE ADJUSTED OR RECONSTRUCTED, THE LOWERING AND RAISING OF THE FRAMES AND LIDS WILL NOT BE PAID FOR SEPARATELY BUT WILL BE INCLUDED IN THE COST OF THE CORRESPONDING PAY ITEM.

**DETAILS FOR FRAMES AND LIDS ADJUSTMENT WITH MILLING**


ALL DIMENSIONS ARE IN INCHES (MILLIMETERS) UNLESS OTHERWISE SHOWN

FILE NAME =	USER NAME = qureshiya	DESIGNED - R. SHAH	REVISED - R. WIEDEMAN 05-14-04
ca:\pwork\pwork\qureshiya\0283041\Dis	Std.dgn	DRAWN -	REVISED - R. BORO 01-01-07
	PLOT SCALE = 100.0002' / 1in.	CHECKED -	REVISED - R. BORO 03-09-11
	PLOT DATE = 10/26/2016	DATE - 10-25-94	REVISED - R. BORO 12-06-11

**STATE OF ILLINOIS  
DEPARTMENT OF TRANSPORTATION**

<b>DETAILS FOR FRAMES AND LIDS ADJUSTMENT WITH MILLING</b>			
SCALE: NONE	SHEET NO. 1 OF 1 SHEETS	STA.	TO STA.

F.A.U. RTE.	SECTION	COUNTY	TOTAL SHEETS	SHEET NO.
1632	49R-RS	COOK	48	29
<b>BD600-03 (BD-8)</b>			<b>CONTRACT NO. 60X38</b>	
FED. ROAD DIST. NO. 1   ILLINOIS   FED. AID PROJECT				

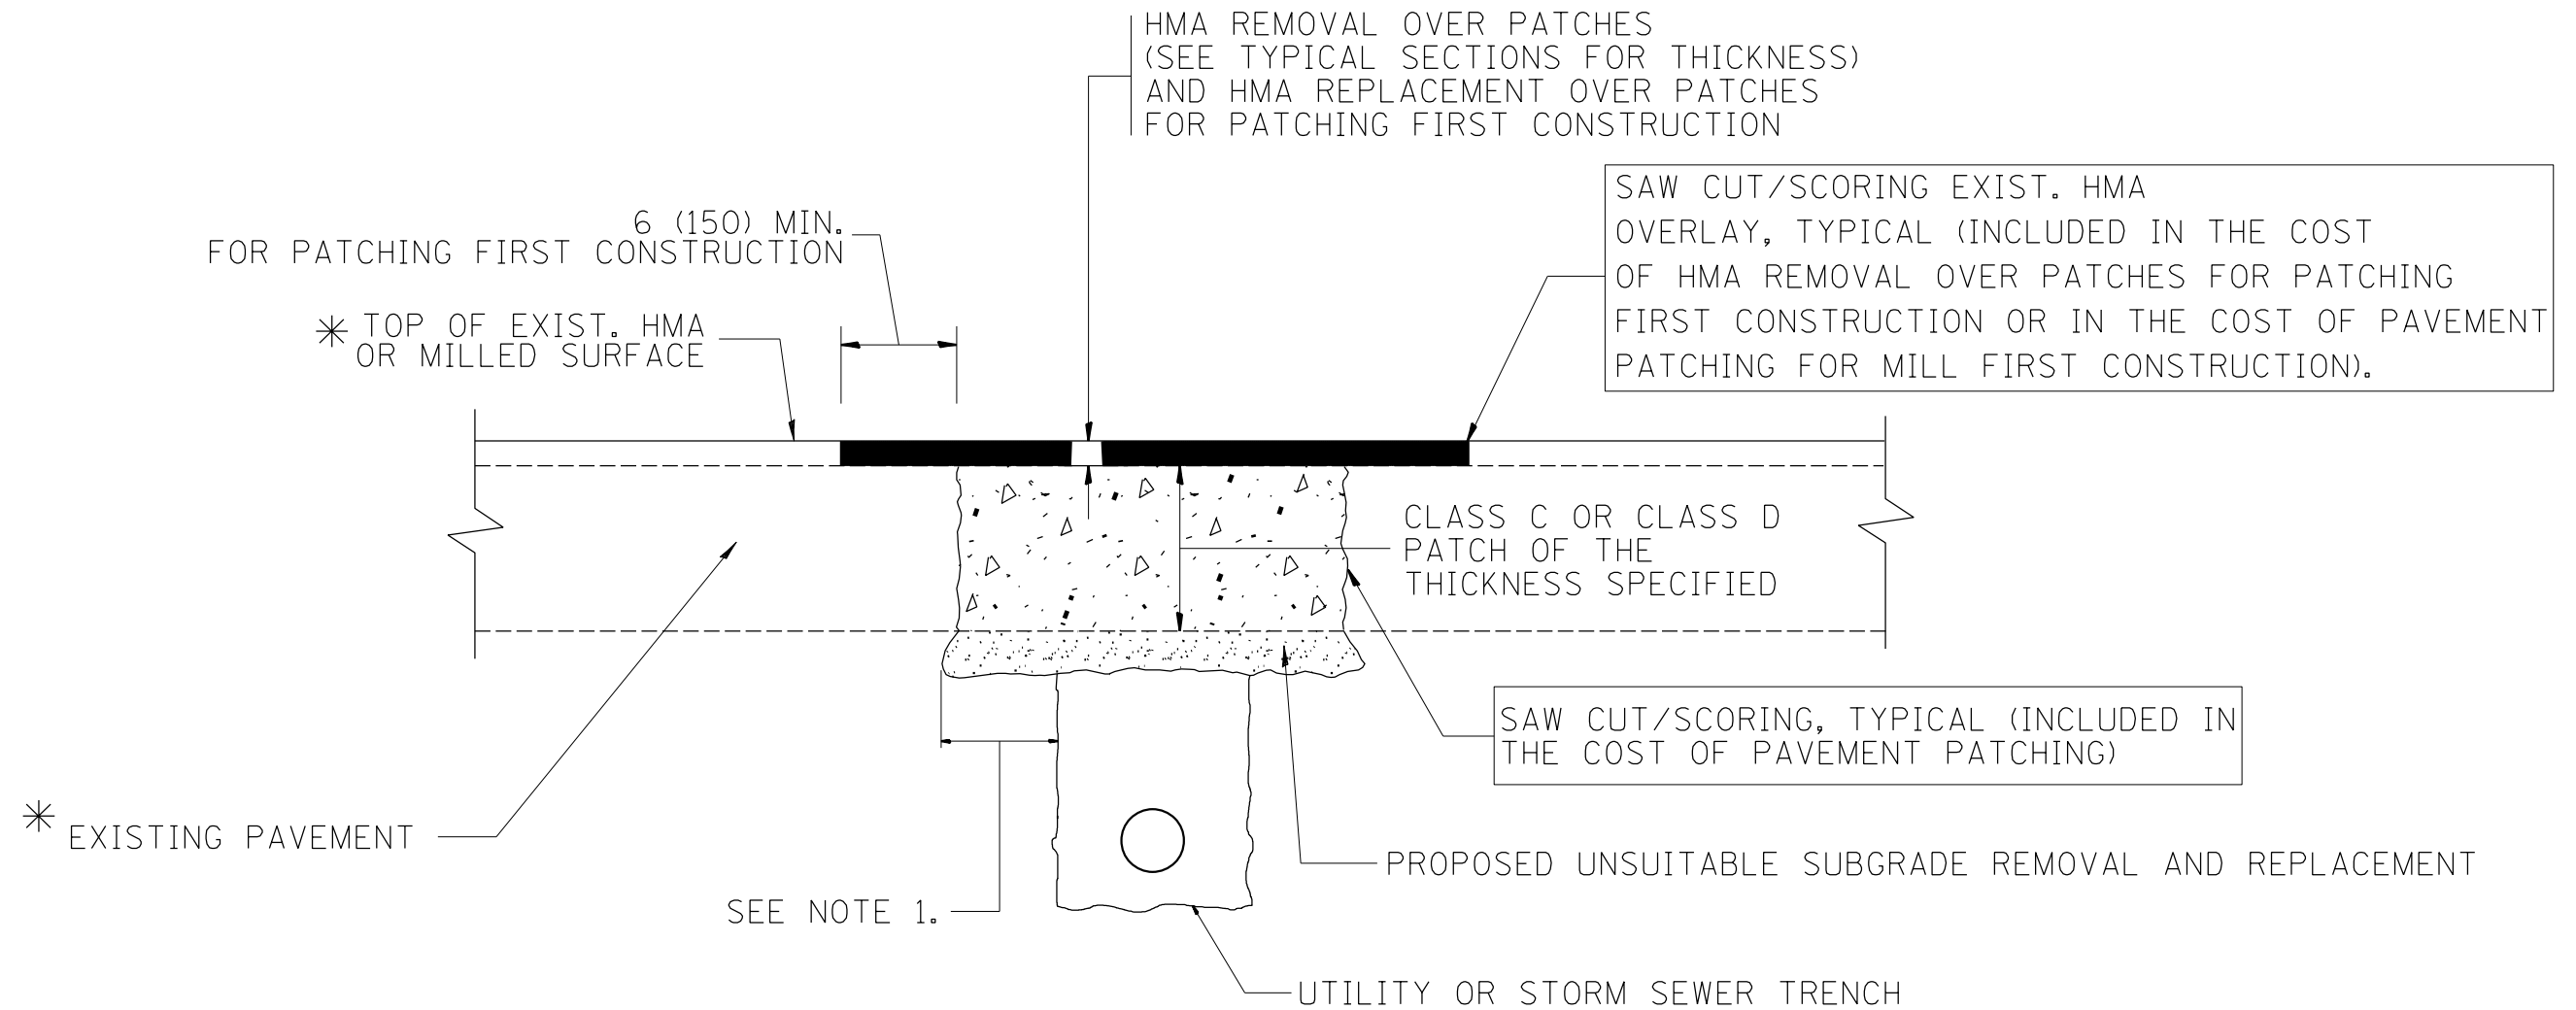

\* SEE TYPICAL SECTIONS FOR THICKNESS AND MATERIALS

**NOTES:**

1. THE WIDTH OF THE FULL DEPTH PATCH OVER A TRENCH SHALL BE 12 (300) WIDER ON EACH SIDE OF THE TRENCH.
2. FOR METHOD OF MEASUREMENT AND BASIS OF PAYMENT, SEE RECURRING SPECIAL PROVISION "PATCHING WITH HOT-MIX ASPHALT OVERLAY REMOVAL".

SEQUENCE OF CONSTRUCTION (PATCHING FIRST)

1. REMOVE THE EXISTING HMA MATERIAL OVER THE AREA TO BE PATCHED.
2. REMOVE AND REPLACE WITH CLASS C OR D PATCH.
3. REPLACE HMA MATERIAL OVER THE AREA TO BE PATCHED.

SEQUENCE OF CONSTRUCTION (MILLING FIRST)

1. MILL HMA FIRST IF THERE IS AT LEAST 4 1/2 INCHES OR MORE OF HMA MATERIAL ON TOP OF THE EXISTING PAVEMENT OR IF THE PAVEMENT IS FULL DEPTH HMA. A MINIMUM OF 2 INCHES OF HMA MATERIAL SHALL BE IN PLACE AFTER MILLING.
2. REMOVE AND REPLACE WITH FULL DEPTH CLASS D PATCHES TO TOP OF MILLED SURFACE.

ALL DIMENSIONS ARE IN INCHES (MILLIMETERS) UNLESS OTHERWISE SHOWN.

FILE NAME =	USER NAME = qureshiya	DESIGNED - R. SHAH	REVISED - A. ABBAS 04-27-98	<b>STATE OF ILLINOIS DEPARTMENT OF TRANSPORTATION</b>	<b>PAVEMENT PATCHING FOR HMA SURFACED PAVEMENT</b>			F.A.U. RTE.	SECTION	COUNTY	TOTAL SHEETS	SHEET NO.
ca:\pw\work\p\idot\qureshiya\0283041\Dis	Std.dgn	DRAWN -	REVISED - R. BORO 01-01-07					1632	49R-R5	COOK	48	30
	PLOT SCALE = 100.0002' / 1in.	CHECKED -	REVISED - R. BORO 09-04-07		<b>BD400-04 (BD-22)</b>			<b>CONTRACT NO. 60X38</b>				
	PLOT DATE = 10/26/2016	DATE - 10-25-94	REVISED - K. ENG 10-27-08		SCALE: NONE	SHEET NO. 1 OF 1 SHEETS	STA. TO STA.	FED. ROAD DIST. NO. 1   ILLINOIS FED. AID PROJECT				

VARIABLE - TO MEET EXISTING DIMENSIONS AND FIELD CONDITIONS (SEE NOTE ②)

PROP. CONC. CURB OR CURB AND GUTTER REPLACEMENT IN ACCORDANCE WITH STATE STANDARD 606001. (SEE NOTE ②)

SAW CUT FULL DEPTH - INCLUDED IN THE COST OF SIDEWALK, DRIVEWAY OR MEDIAN SURFACE REMOVAL PAY ITEM.

SEE STATE STANDARD 606001  
EXISTING OR PROPOSED HMA SURFACE (IF APPLICABLE)

18" (450) MAX.

1/4" (5) \*\*

EXISTING SIDEWALK, DRIVEWAY, MEDIAN SURFACE, SOD OR GROUND.

PROPOSED SIDEWALK, DRIVEWAY PAVEMENT, MEDIAN SURFACE OR SODDING SALT TOLERANT WITH TOP SOIL, 4" (100) SOD RESTORATION (SEE NOTE ①).

EXISTING CONCRETE PAVEMENT, CONCRETE BASE COURSE OR FLEXIBLE PAVEMENT

3" (75) MIN.

SUITABLE BACKFILL MATERIAL (INCLUDED IN THE COST OF CURB OR CURB AND GUTTER REMOVAL AND REPLACEMENT)

\* 3" (75) MINIMUM FROM TOP AND BOTTOM OF THE CONCRETE PAVEMENT OR BASE COURSE.

\*\* IF THE FINAL SURFACE OF THE PAVEMENT IS CONCRETE, THE GUTTER IS TO BE FLUSH WITH THE PAVEMENT.

PROPOSED 3/4" (20) PREFORMED EXPANSION JOINT AT CONCRETE SIDEWALKS, DRIVEWAYS, AND MEDIANS. (INCLUDED IN THE COST OF CURB OR CURB AND GUTTER REMOVAL AND REPLACEMENT.)

NOTE: ① SIDEWALK, DRIVEWAY PAVEMENT OR MEDIAN SURFACE SHALL BE SIMILAR TO THE MATERIAL BEING REMOVED AND WILL BE PAID FOR SEPARATELY.

SODDING, SALT TOLERANT AND TOP SOIL, FURNISH AND PLACE 4" WILL BE PAID FOR SEPARATELY.

UNSUITABLE SUB-BASE MATERIAL TO BE REMOVED, IF DIRECTED BY THE ENGINEER, SHALL BE REPLACED WITH EITHER SUB-BASE GRANULAR MATERIAL, TYPE B OR ADDITIONAL THICKNESS OF CONCRETE.

② FERTILIZER FOR THE PLACEMENT OF THE SOD IS NOT REQUIRED

REMOVAL AND REPLACEMENT 4" (100) OR LESS IS INCLUDED IN THE COST OF CURB OR CURB AND GUTTER REMOVAL AND REPLACEMENT.

③ CURB OR CURB AND GUTTER REPLACEMENT SHALL MATCH THE SHAPE OF THE EXISTING CURB OR CURB AND GUTTER UNLESS OTHERWISE SPECIFIED.

REMOVAL AND REPLACEMENT IN EXCESS OF 4" (100) WILL BE PAID FOR IN ACCORDANCE WITH ARTICLE 109.04 OF THE STANDARD SPECIFICATIONS.

④ FOR CURB OR CURB AND GUTTER REMOVAL AND REPLACEMENT ADJACENT TO FLEXIBLE PAVEMENT DELETE EPOXY COATED TIE BARS.

PROPOSED #6 (20) EPOXY COATED TIE BARS 24" (600) LONG AT 24" (600) CENTERS WILL NOT BE PAID FOR SEPARATELY. DELETE EPOXY COATED TIE BARS IF EXISTING TIE BARS ARE USABLE AS DETERMINED BY THE ENGINEER. (SEE NOTE ③).

⑤ LONGITUDINAL BARS, IF ENCOUNTERED IN THE EXISTING CURB OR CURB AND GUTTER, ARE NOT TO BE REPLACED. CUTTING AND REMOVING LONGITUDINAL BARS SHALL BE INCLUDED IN THE COST OF CURB OR CURB AND GUTTER REMOVAL AND REPLACEMENT.

⑥ THE COST OF HMA SURFACE REMOVAL IN THE EXISTING GUTTER FLAG SHALL BE INCLUDED IN THE COST OF THE CURB AND GUTTER REMOVAL AND REPLACEMENT.

BASIS OF PAYMENT:  
THIS WORK WILL BE PAID FOR AT THE CONTRACT UNIT PRICE PER FOOT (METER) FOR "CURB REMOVAL AND REPLACEMENT" OR "COMBINATION CONCRETE CURB AND GUTTER REMOVAL AND REPLACEMENT".

⑦ THE REMOVAL AND REPLACEMENT OF THE EXISTING CURB OR CURB AND GUTTER SHALL BE DONE IN ACCORDANCE WITH THE APPLICABLE PORTIONS OF SECTION 440 AND 606 OF THE STANDARD SPECIFICATIONS.


⑧ THE LOCATIONS OF REMOVAL AND REPLACEMENT OF EXISTING CURB OR CURB AND GUTTER SHALL BE DETERMINED BY THE RESIDENT ENGINEER AT THE TIME OF CONSTRUCTION.

# CURB OR CURB AND GUTTER REMOVAL AND REPLACEMENT


ALL DIMENSIONS ARE IN INCHES (MILLIMETERS) UNLESS OTHERWISE SHOWN.

FILE NAME =	USER NAME = qureshiya	DESIGNED - A. HOUSEH	REVISED - R. SHAH 10-03-96	<b>STATE OF ILLINOIS DEPARTMENT OF TRANSPORTATION</b>	<b>CURB OR CURB AND GUTTER REMOVAL AND REPLACEMENT</b>			F.A.U. RTE.	SECTION	COUNTY	TOTAL SHEETS	SHEET NO.
ca:\pwork\pwork\qureshiya\0283041\Dis	Std.dgn	DRAWN -	REVISED - A. ABBAS 03-21-97					1632	49R-RS	COOK	48	31
	PLOT SCALE = 100.0002' / 1"	CHECKED -	REVISED - M. GOMEZ 01-22-01		<b>BD600-06 (BD-24)</b>			<b>CONTRACT NO. 60X38</b>				
	PLOT DATE = 10/26/2016	DATE - 03-11-94	REVISED - R. BORO 12-15-09		SCALE: NONE	SHEET NO. 1 OF 1 SHEETS	STA. TO STA.	FED. ROAD DIST. NO. 1 ILLINOIS FED. AID PROJECT				




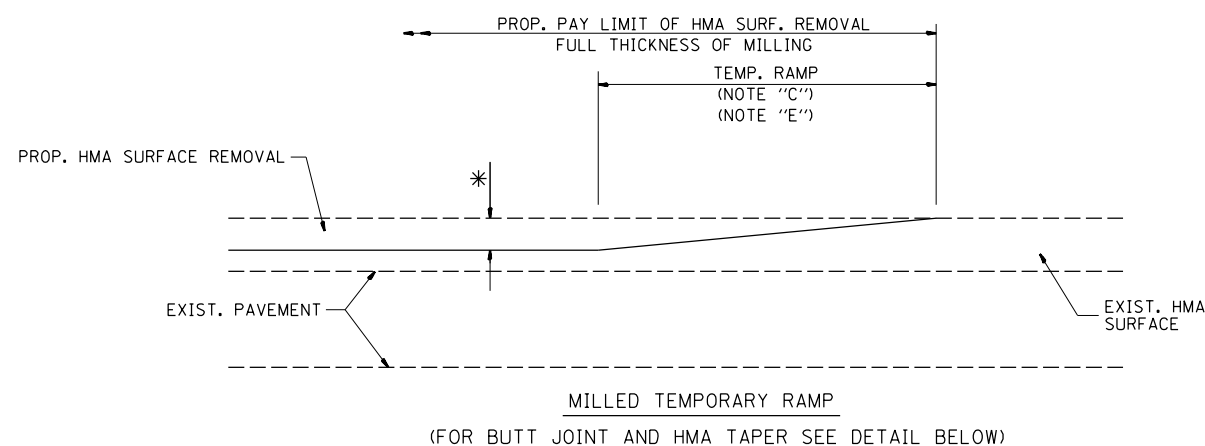


**OPTION 1**

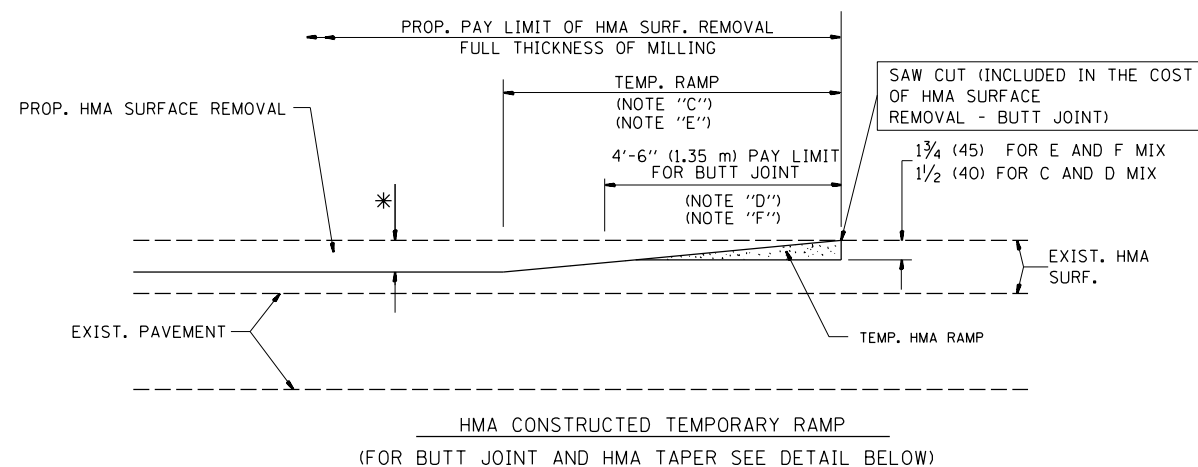

**OPTION 2**

**TYPICAL TEMPORARY RAMP**

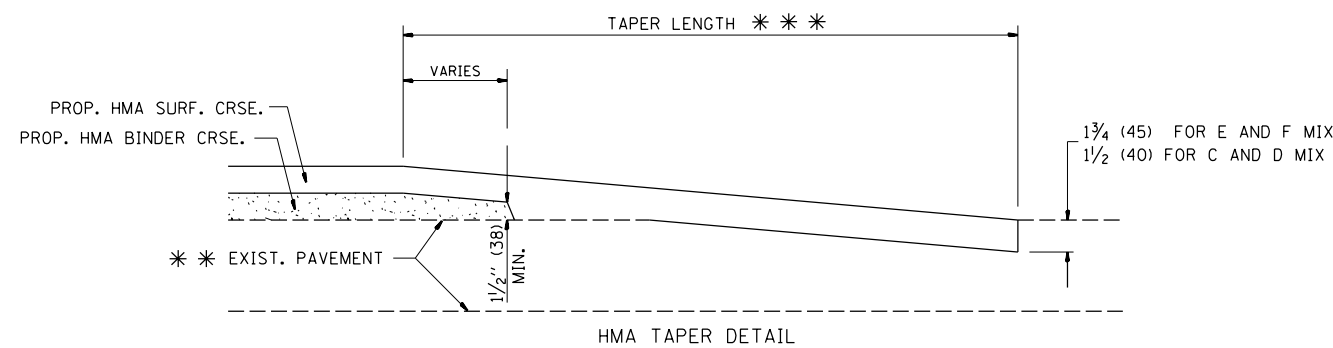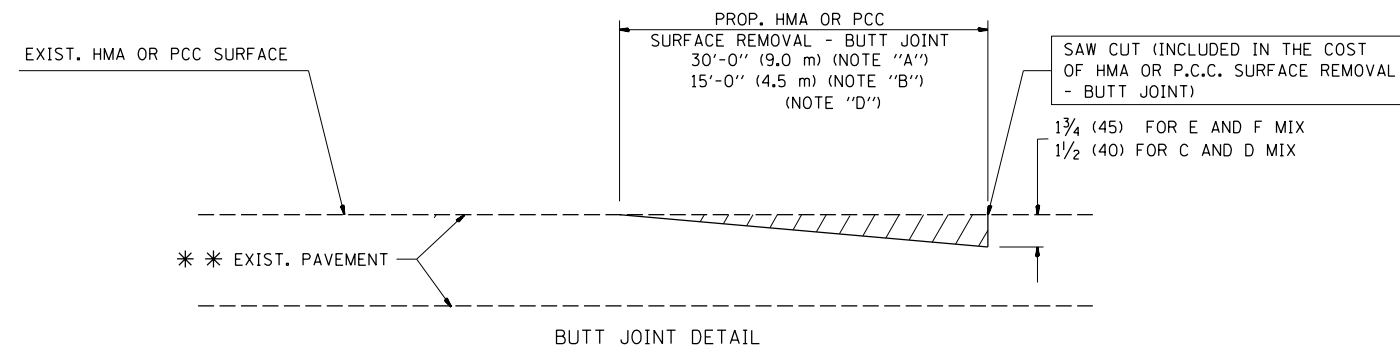

**TYPICAL BUTT JOINT AND HMA TAPER FOR RESURFACING ONLY**

\* \* PC CONCRETE, HMA OR HMA RESURFACED PAVEMENT.

**NOTES**

- A: MAINLINE ROADWAYS AND MAJOR SIDE ROADS.
- B: MINOR SIDE ROADS.
- C: THE TEMP. RAMP SHALL BE CONSTRUCTED IMMEDIATELY UPON REMOVAL OF THE EXISTING HMA SURFACE.
- D: THE BUTT JOINT SHALL BE CONSTRUCTED IMMEDIATELY PRIOR TO PLACING THE PROPOSED HMA COURSES.
- E: TAPER THE TEMP. RAMP AT A RATE OF 3'-0" (900 mm) PER 1 INCH (25 mm) OF MILLING THICKNESS.
- F: INSTALLATION AND REMOVAL OF THE 4'-6" (1.35 m) TEMP. RAMP IS INCLUDED IN COST OF HMA SURFACE REMOVAL - BUTT JOINT
- G: SEE ARTICLE 406.08 AND 406.14 OF THE STANDARD SPECIFICATIONS FOR "HMA AND/OR PCC SURFACE REMOVAL, BUTT JOINT".


\* SEE TYPICAL SECTIONS FOR MILLING THICKNESS.

\* \* \* 20'-0" (6.1 m) PER 1 (25) RESURFACING (NOTE "A")  
10'-0" (3.0 m) PER 1 (25) RESURFACING (NOTE "B")

**BASIS OF PAYMENT:**

THE BUTT JOINT WILL BE PAID FOR AT THE CONTRACT UNIT PRICE PER SQUARE YARD (SQUARE METER) FOR "HOT-MIX ASPHALT SURFACE REMOVAL - BUTT JOINT" OR FOR "PORTLAND CEMENT CONCRETE SURFACE REMOVAL - BUTT JOINT".

ALL DIMENSIONS ARE IN INCHES (MILLIMETERS) UNLESS OTHERWISE SHOWN.

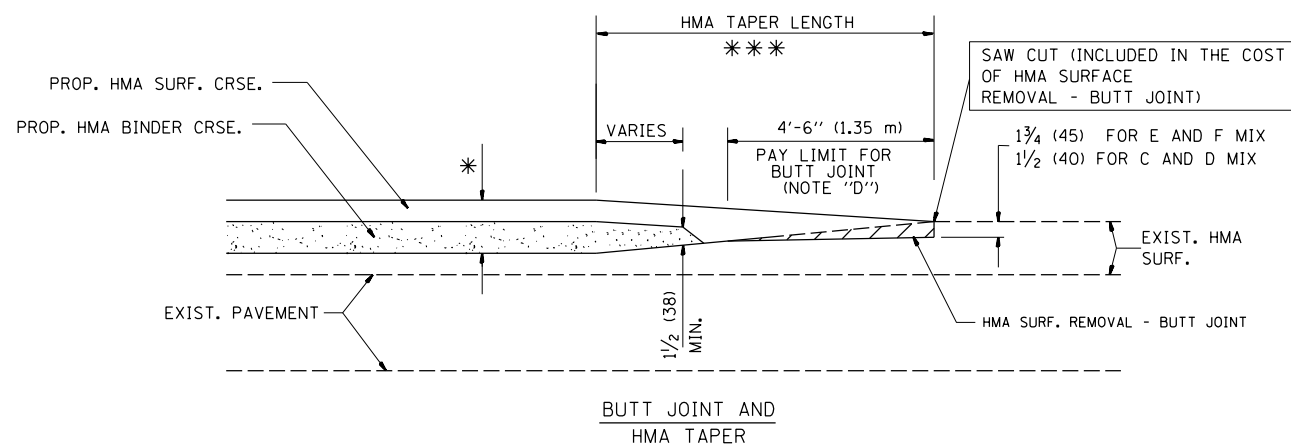

**TYPICAL BUTT JOINT AND HMA TAPER FOR MILLING AND RESURFACING**


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	PLOT SCALE = 100.0002' / 1"	CHECKED -	REVISED - M. GOMEZ 04-06-01
	PLOT DATE = 10/26/2016	DATE - 06-13-90	REVISED - R. BORO 01-01-07

**STATE OF ILLINOIS  
DEPARTMENT OF TRANSPORTATION**

**BUTT JOINT AND  
HMA TAPER DETAILS**

SCALE: NONE SHEET NO. 1 OF 1 SHEETS STA. TO STA.

F.A.U. RTE.	SECTION	COUNTY	TOTAL SHEETS	SHEET NO.
1632	49R-R5	COOK	48	32
BD400-05 BD32			CONTRACT NO. 60X38	
FED. ROAD DIST. NO. 1 ILLINOIS FED. AID PROJECT				

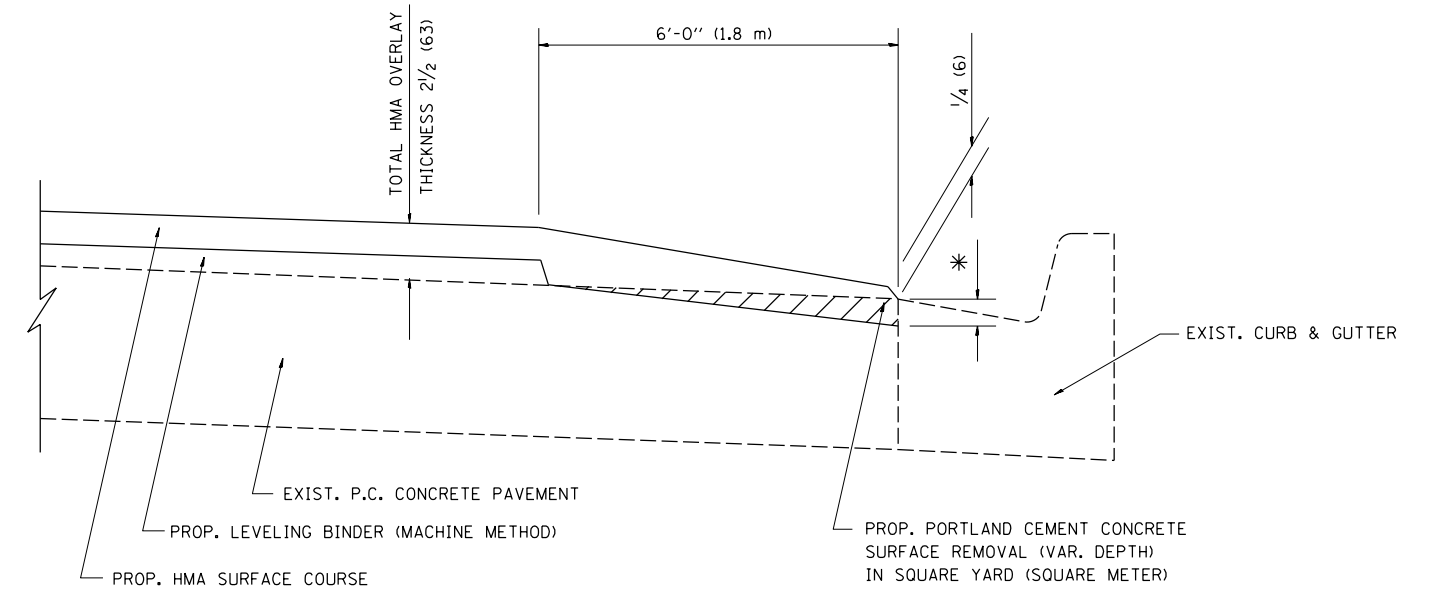

HMA TAPER AT  
EDGE OF P.C.C. PAVEMENT

HMA SURFACE	THICKNESS	LEVELING BINDER THICKNESS	* MILLING AT GUTTER FLAG
C OR D	1 1/2 (38)	1 (25)	1/4 (33)
E	1 3/4 (44)	3/4 (19)	1/2 (38)


ALL DIMENSIONS ARE IN INCHES (MILLIMETERS) UNLESS OTHERWISE SHOWN.

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	PLOT DATE = 10/26/2016	DATE - 09-10-94	REVISED - JP CHANG 07-08-16

**STATE OF ILLINOIS  
DEPARTMENT OF TRANSPORTATION**

<b>HMA TAPER AT EDGE OF P.C.C. PAVEMENT</b>			
SCALE: NONE	SHEET 1	OF 1 SHEETS	STA. TO STA.


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1632	49R-RS	COOK	48	33
<b>BD400-06 (BD33)</b>		<b>CONTRACT NO. 60X38</b>		
ILLINOIS FED. AID PROJECT				

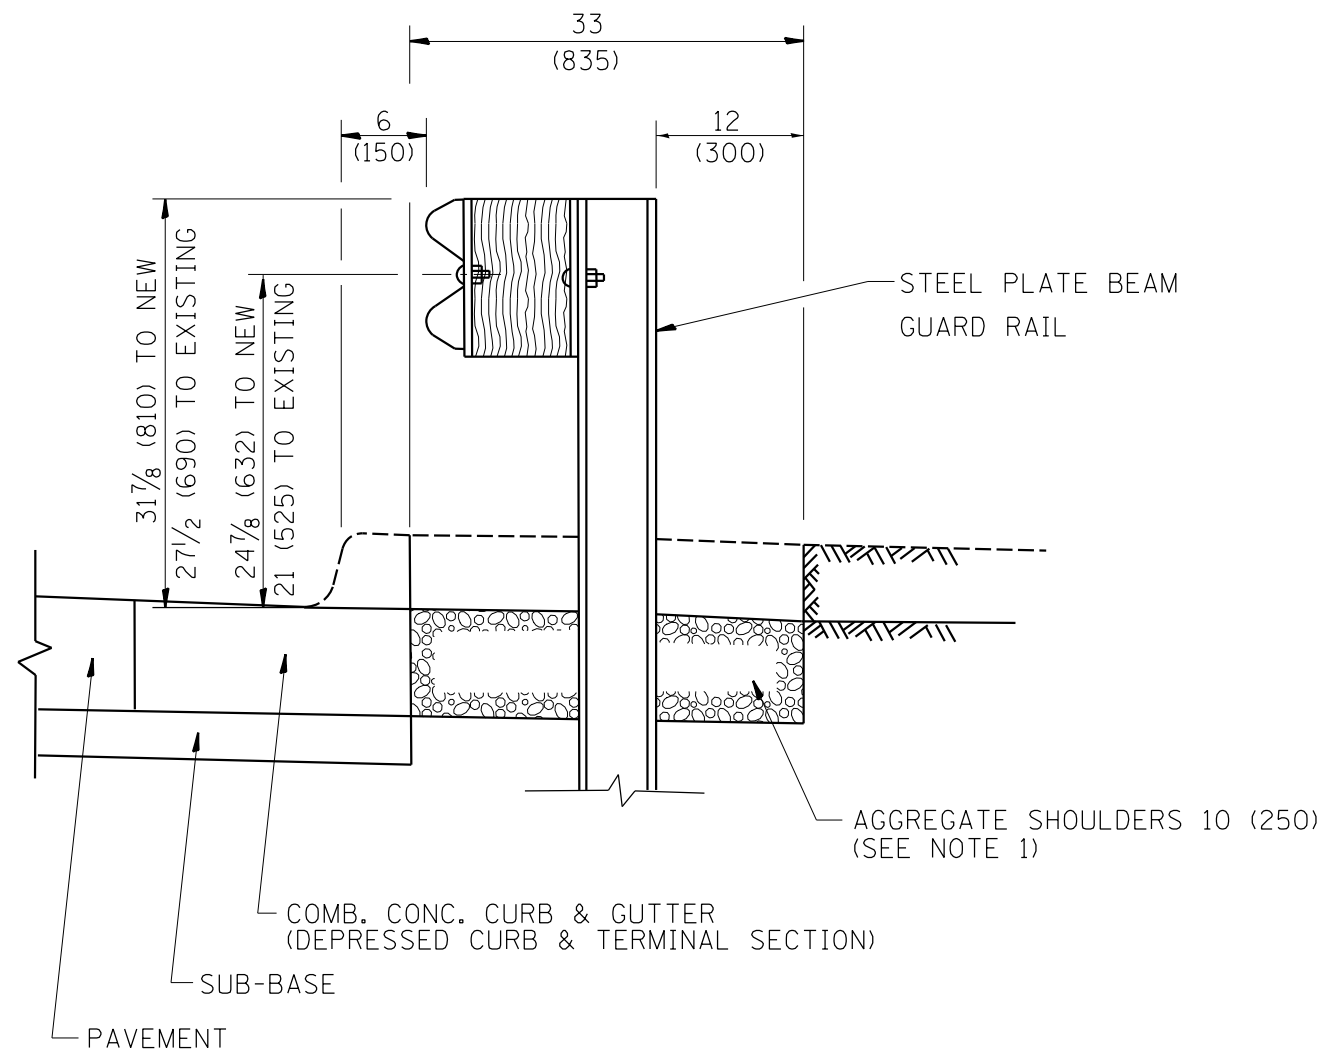

**SECTION A-A**

- NOTES:
1. THE AGGREGATE SHOULDER, 10" OR HMA SHOULDER, 6" (IF REQUIRED) SHALL EXTEND UNDER THE TRAFFIC BARRIER TERMINAL.
  2. "EXISTING" GUARDRAIL REFERS TO CONNECTING TERMINAL SECTION TO GUARD RAILING PRIOR TO THE MIDWEST GUARDRAIL SYSTEM.
  3. THE CONTRACTOR SHALL VERIFY THE TYPE/HEIGHT OF GUARDRAIL IN-PLACE BEFORE ORDERING THE NEW TERMINAL SECTION. COST INCLUDED WITH THE COST OF THE TERMINAL. THE TERMINAL SECTION HEIGHT TO BE PLACED MUST MATCH THE HEIGHT OF THE IN-PLACE GUARDRAIL.

**DETAILS FOR STEEL PLATE BEAM  
GUARD RAIL ADJACENT TO CURB AND GUTTER  
[FOR ROADWAY SPEED 35 MPH (60 kmh) TO 45 MPH (70 kmh)]**

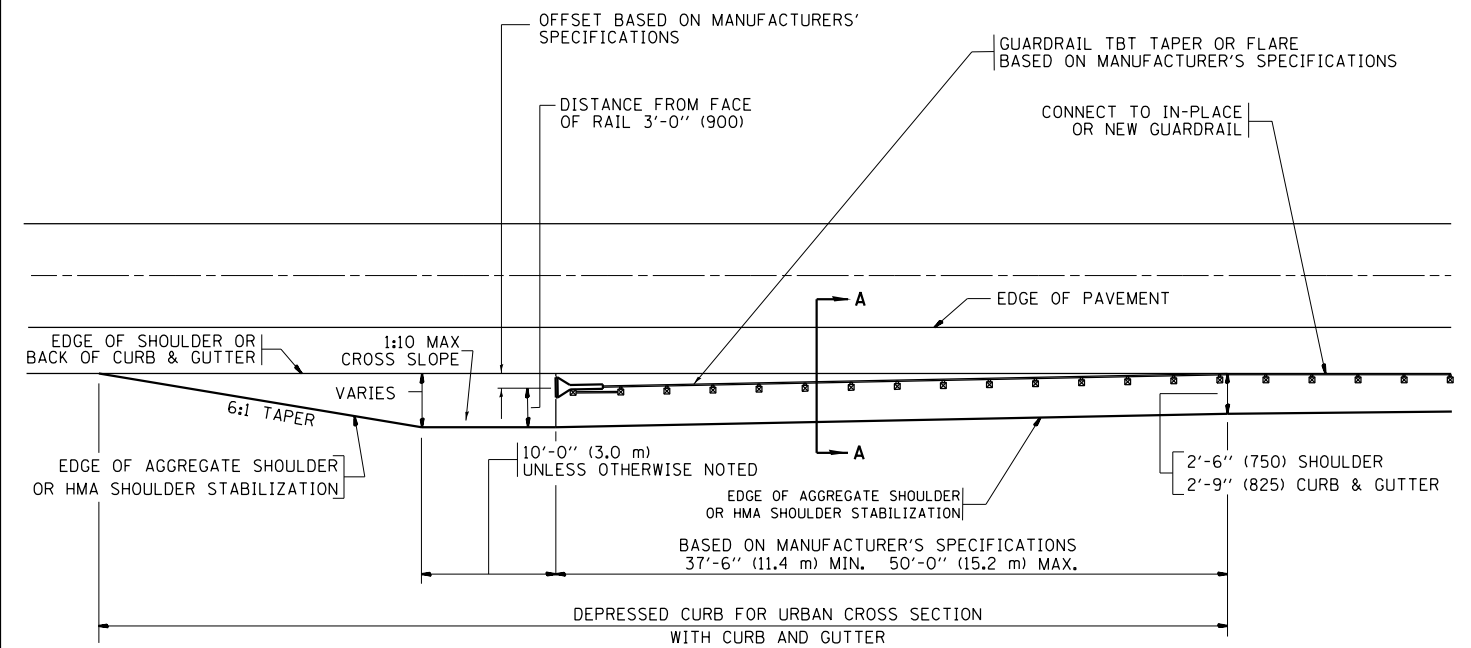

**DEPRESSED CURB AND GUTTER AND  
SHOULDER TREATMENT AT TBT TY. 1 SPL.**

BASIS OF PAYMENT: HMA SHOULDERS 6 (150) (IF REQUIRED) WILL BE PAID FOR AT THE CONTRACT UNIT PRICE PER SQUARE YARD (SQUARE METER) FOR "HOT-MIX ASPHALT SHOULDERS 6" (150 mm)".

STEEL PLATE BEAM GUARD RAIL AND TRAFFIC BARRIER TERMINAL, OF THE TYPE SPECIFIED WILL BE PAID FOR SEPARATELY.

TBT = TRAFFIC BARRIER TERMINAL  
ALL DIMENSIONS ARE IN INCHES (MILLIMETERS) UNLESS OTHERWISE SHOWN.


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	PLOT DATE = 10/26/2016	DATE - 09-22-90	REVISED - R. BORO 09-14-2009

**STATE OF ILLINOIS  
DEPARTMENT OF TRANSPORTATION**

**DETAILS FOR DEPRESSED CURB & GUTTER AND  
SHOULDER TREATMENT AT TBT TY 1 SPL.**

SCALE: NONE SHEET NO. 1 OF 1 SHEETS STA. TO STA.

F.A.U. RTE.	SECTION	COUNTY	TOTAL SHEETS	SHEET NO.
1632	49R-R5	COOK	48	34
<b>BD600-10 (BD 34)</b>		<b>CONTRACT NO. 60X38</b>		
FED. ROAD DIST. NO. 1 ILLINOIS FED. AID PROJECT				

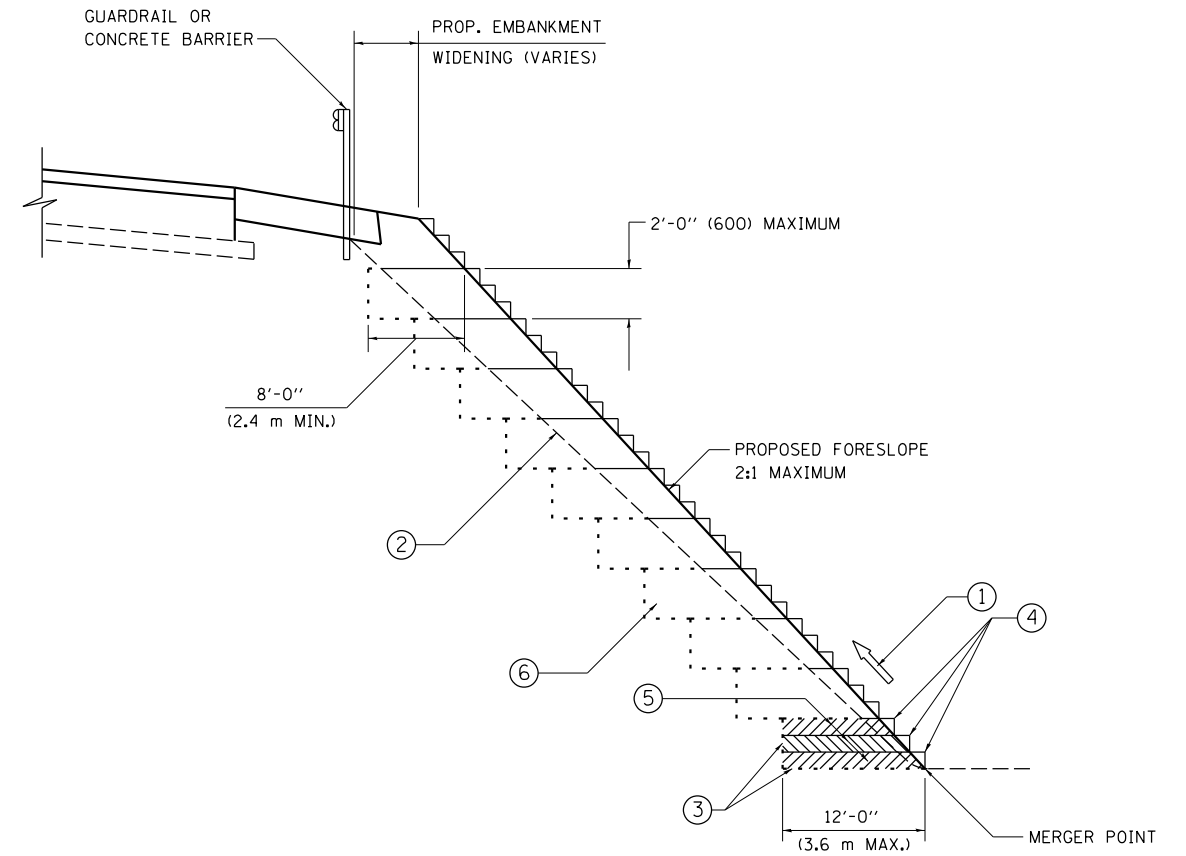

**TYPICAL BENCHING DETAIL  
FOR EMBANKMENT**

**NOTES:**

- ① CONSTRUCT SUCCEEDING BENCH CUTS AND EMBANKMENT PLACEMENT AND COMPACTION FROM BOTTOM TO TOP IN STAIRSTEP FASHION.
- ② EXISTING FORESLOPE PREPARED IN ACCORDANCE WITH ARTICLE 205.03 OF THE STANDARD SPECIFICATIONS.
- ③ BENCH CUT EXISTING SLOPE TYPICAL FOR EACH STEP.
- ④ TRIM TO FINAL SLOPE.
- ⑤ EQUAL 8-INCH (200) LIFTS OF EMBANKMENT COMPACTED IN ACCORDANCE WITH ARTICLE 205.05 OF THE STANDARD SPECIFICATIONS.
- ⑥ EXCAVATION OF BENCH CUTS WITHIN EXISTING EMBANKMENT WILL BE PAID FOR AT THE CONTRACT UNIT PRICE PER CUBIC METER OR CUBIC YARD FOR "EARTH EXCAVATION". THIS PRICE WILL INCLUDE ALL LABOR AND MATERIAL, NO ADDITIONAL COMPENSATION WILL BE ALLOWED.
- ⑦ SLOPES SHALL BE BENCHED ACCORDING TO THIS DETAIL WHEN THE SLOPE IS STEEPER THAN 4:1 AND THE HEIGHT IS GREATER THAN 5' (1.5 m).


ALL DIMENSIONS ARE IN INCHES (MILLIMETERS)  
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	PLOT DATE = 10/26/2016	DATE - 06-16-04	REVISED -

**STATE OF ILLINOIS  
DEPARTMENT OF TRANSPORTATION**

BENCHING DETAIL FOR EMBANKMENT WIDENING			
SCALE:	SHEET	OF SHEETS	STA. TO STA.


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1632	49R-R5	COOK	48	35
BD-51			CONTRACT NO. 60X38	
ILLINOIS FED. AID PROJECT				

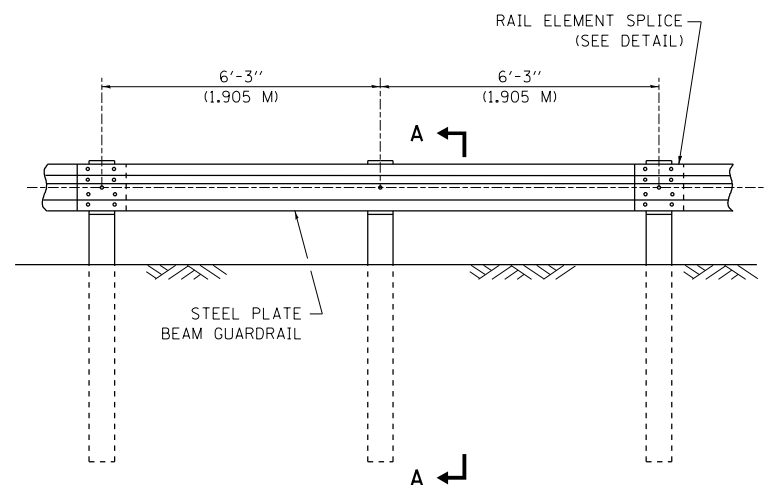


ELEVATION

**TYPE A**

6'-3" (1.905 M) TYPICAL POST SPACING

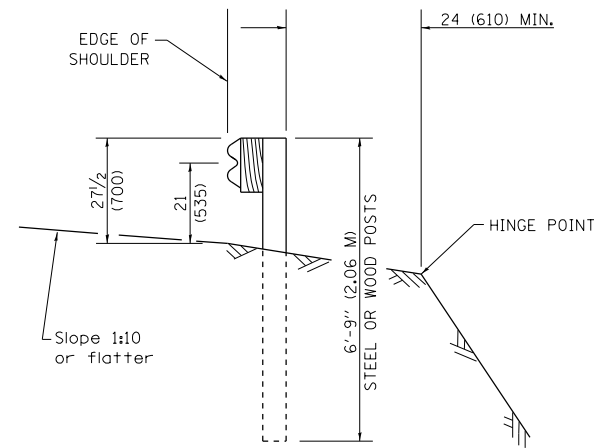


SECTION A-A

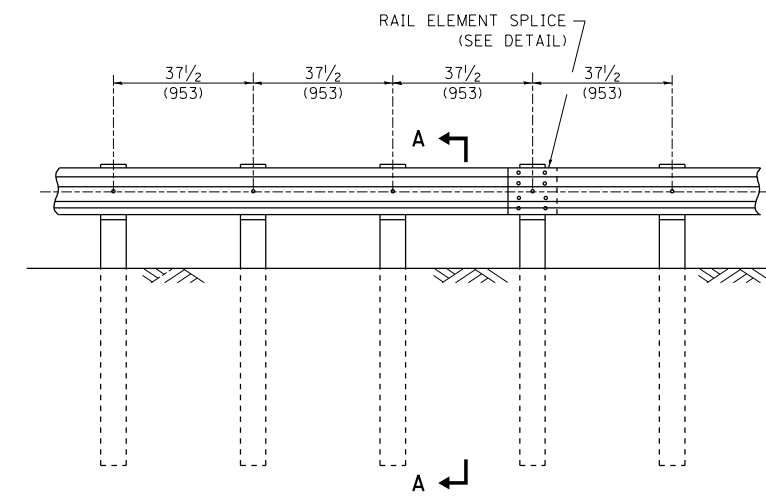

ELEVATION


**TYPE A**

37 1/2 (953) CLOSED POST SPACING

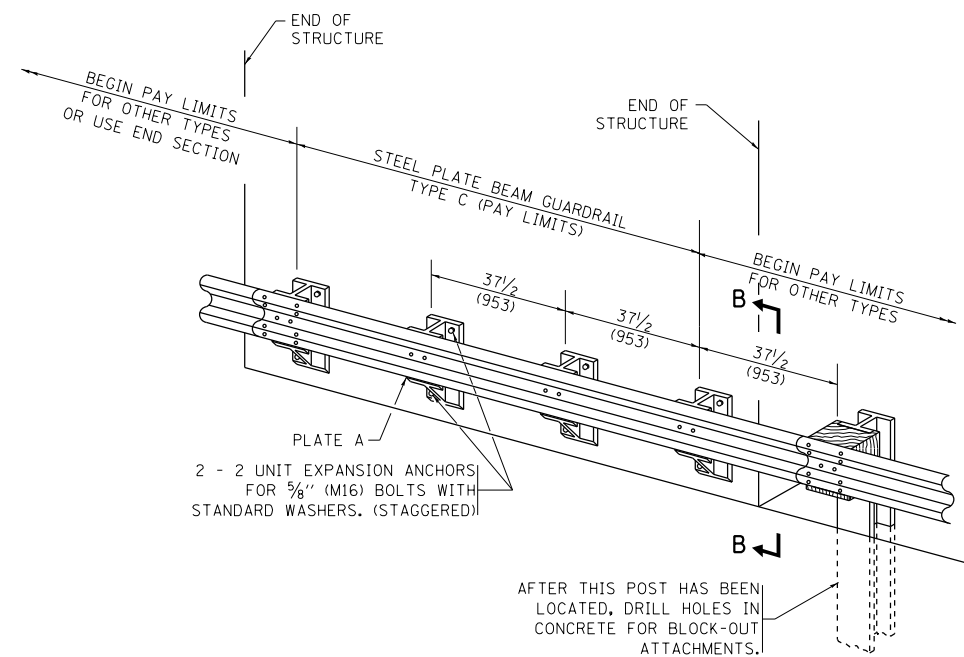


**TYPE C**

37 1/2 (953) BLOCK-OUT SPACING

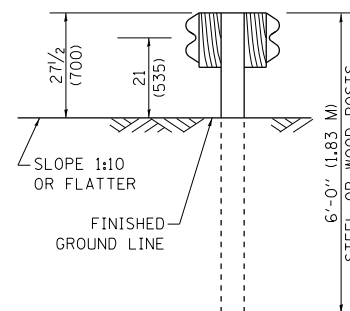


SECTION C-C

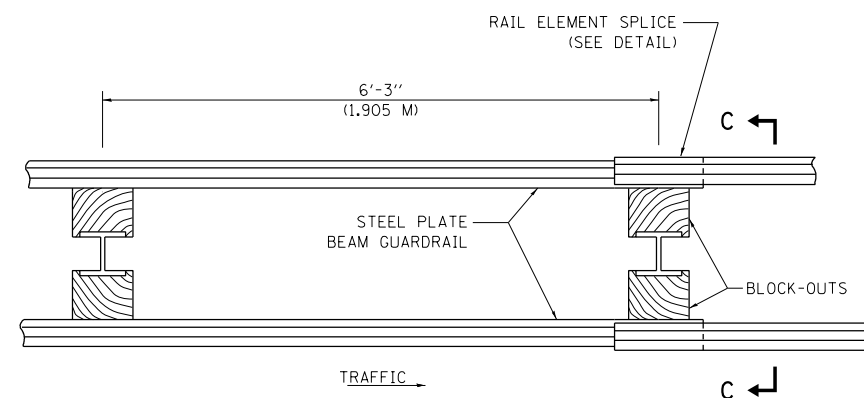

PLAN

**TYPE D**

DOUBLE STEEL PLATE BEAM GUARDRAIL  
6'-3" (1.905 M) TYPICAL POST SPACING

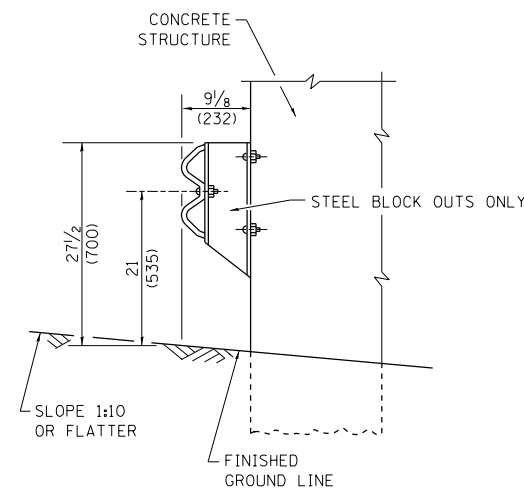

SECTION B-B

**GENERAL NOTES**

ALL SLOPE RATIOS ARE EXPRESSED AS UNITS OF VERTICAL DISPLACEMENT TO UNITS OF HORIZONTAL DISPLACEMENT (V:H).

ALL DIMENSIONS ARE IN INCHES (MILLIMETERS) UNLESS OTHERWISE SHOWN.

THE EXISTING STEEL POSTS MAY BE DRILLED TO MATCH THE BOLT PATTERN SHOWN HEREIN FOR THE WOOD BLOCK-OUT, OR A NEW STEEL POST SHALL BE PROVIDED.


THIS DETAIL IS APPLICABLE TO THE GUARDRAIL SYSTEM USED PRIOR TO JANUARY 1, 2007. FOR DETAILS ON THE MIDWEST GUARDRAIL SYSTEM, SEE STANDARD 630001.

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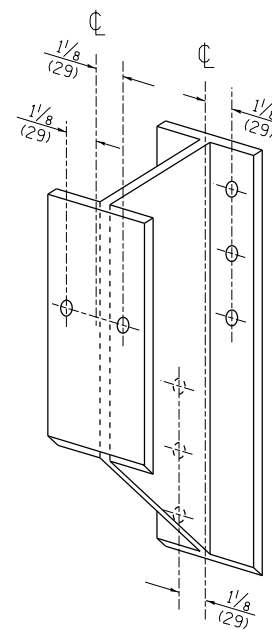
**STATE OF ILLINOIS  
DEPARTMENT OF TRANSPORTATION**

<b>REMOVE AND REERECT STEEL PLATE BEAM GUARDRAIL</b>			
SCALE: NONE	SHEET NO. 1 OF 4 SHEETS	STA.	TO STA.


F.A.U. RTE.	SECTION	COUNTY	TOTAL SHEETS	SHEET NO.
1632	49R-R5	COOK	48	36
<b>BM-21</b>			<b>CONTRACT NO. 60X38</b>	
FED. ROAD DIST. NO. 1   ILLINOIS FED. AID PROJECT				

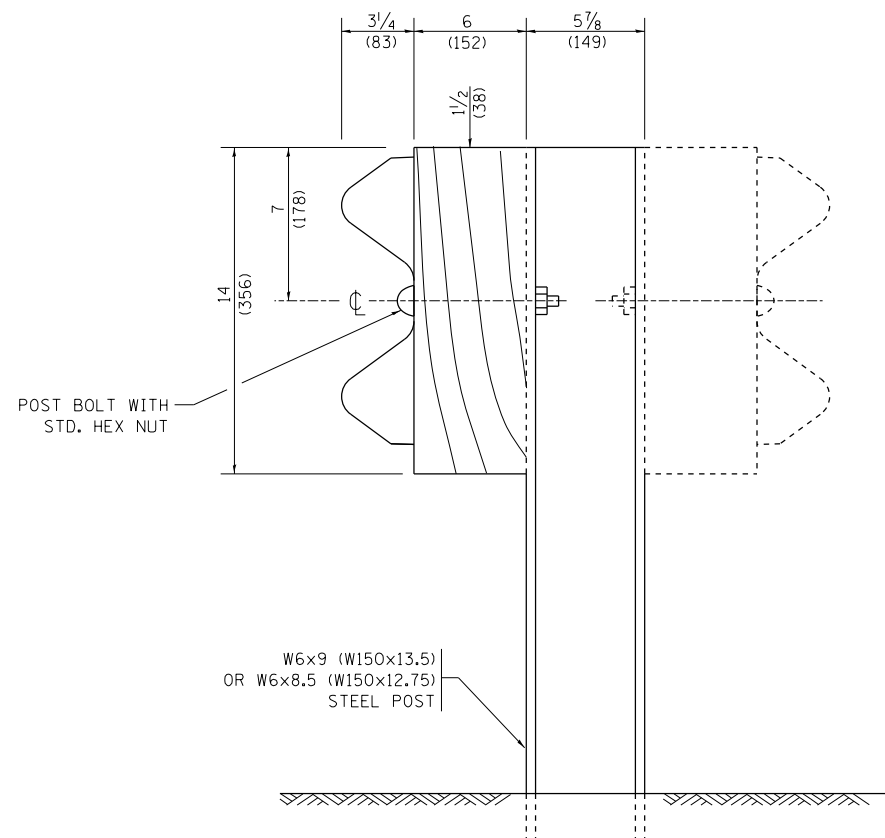


**STEEL POST CONSTRUCTION**



**STEEL BLOCK-OUT DETAIL**

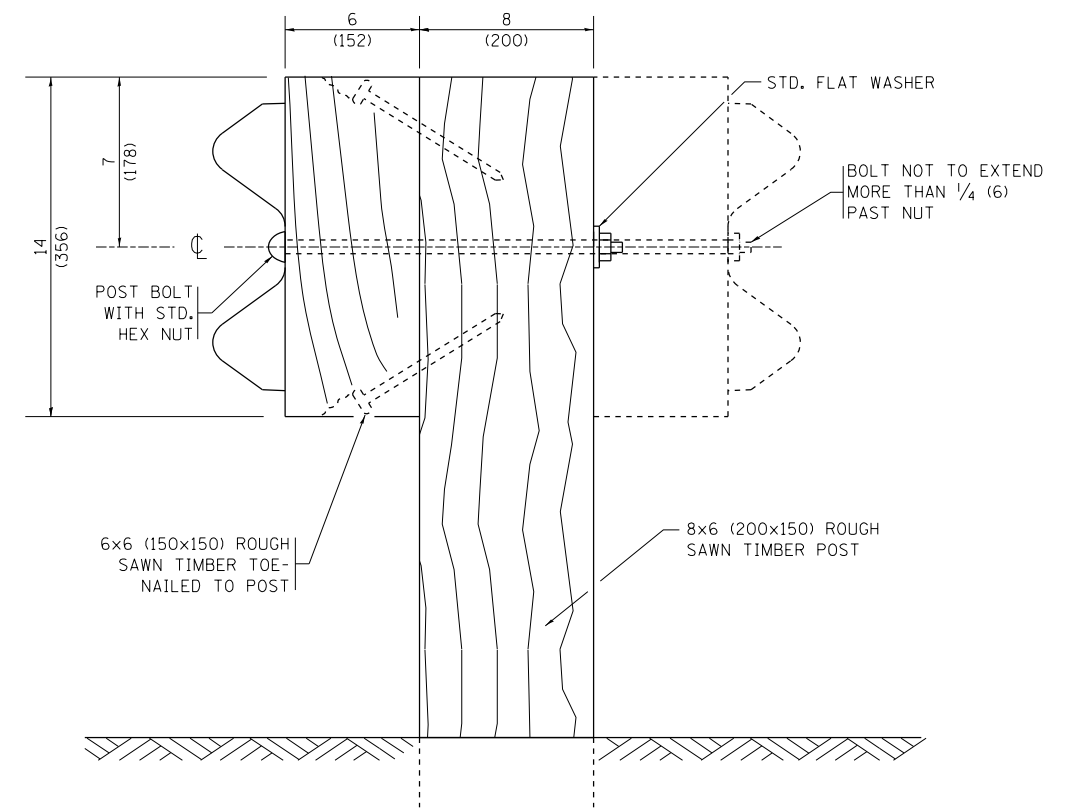


**WOOD POST CONSTRUCTION**

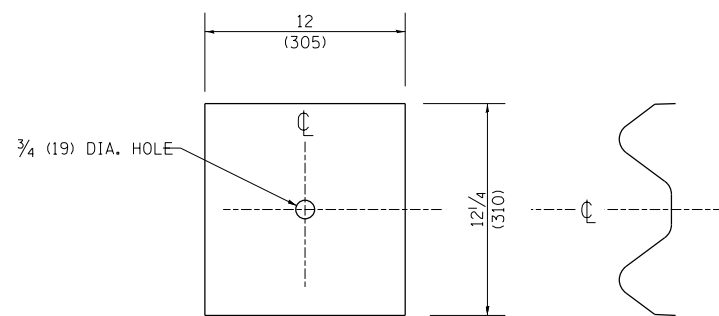

**NOTE:**

PLATE A SHALL BE PLACED BETWEEN RAIL ELEMENT AND BLOCK-OUT AT NON-SPLICE MOUNTING POINTS ONLY WHEN STEEL BLOCK-OUTS ARE USED.

**PLATE A**

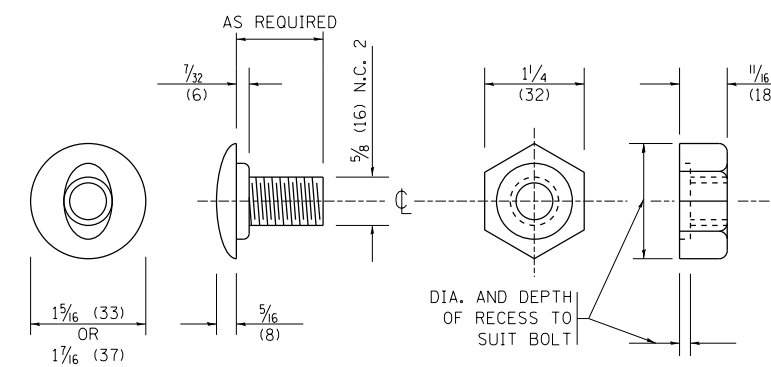


**POST OR SPLICE BOLT & NUT**

FILE NAME =	USER NAME = qureshiya	DESIGNED -	REVISED - 10-31-06
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	PLOT SCALE = 100.0002' / 1in.	CHECKED -	REVISED -
	PLOT DATE = 10/26/2016	DATE -	REVISED -


**STATE OF ILLINOIS  
DEPARTMENT OF TRANSPORTATION**

<b>REMOVE AND REERECT STEEL PLATE BEAM GUARDRAIL</b>			
SCALE: NONE	SHEET NO. 2 OF 4 SHEETS	STA.	TO STA.


F.A.U. RTE.	SECTION	COUNTY	TOTAL SHEETS	SHEET NO.
1632	49R-R5	COOK	48	37
<b>BM-21</b>			<b>CONTRACT NO. 60X38</b>	
FED. ROAD DIST. NO. 1 ILLINOIS FED. AID PROJECT				

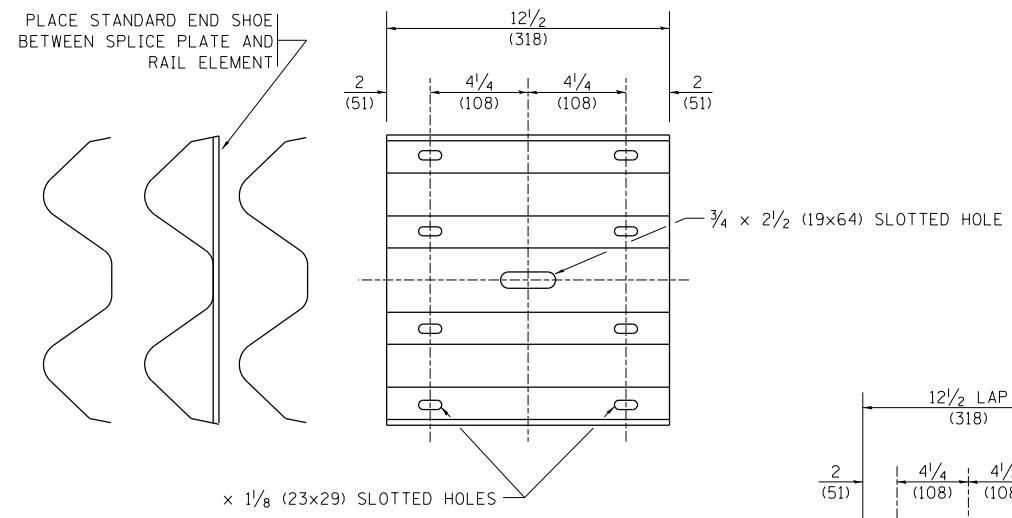


**SPLICE PLATE**

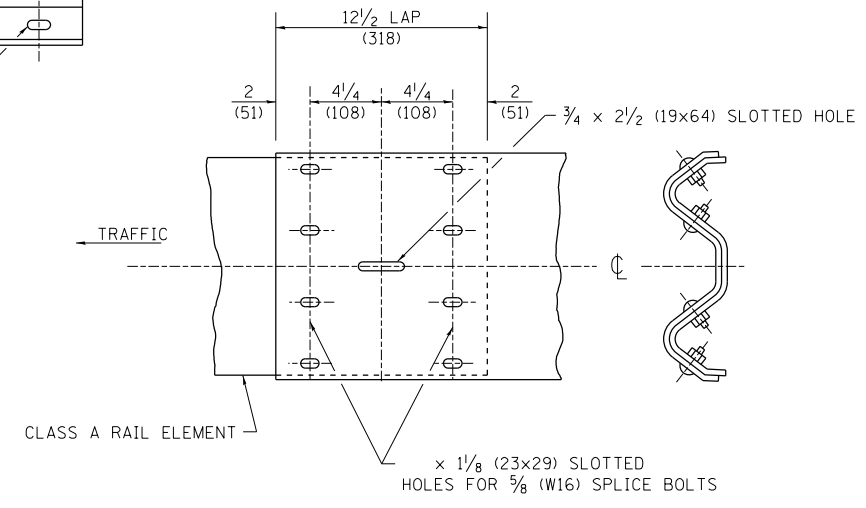

**RAIL ELEMENT SPLICE**

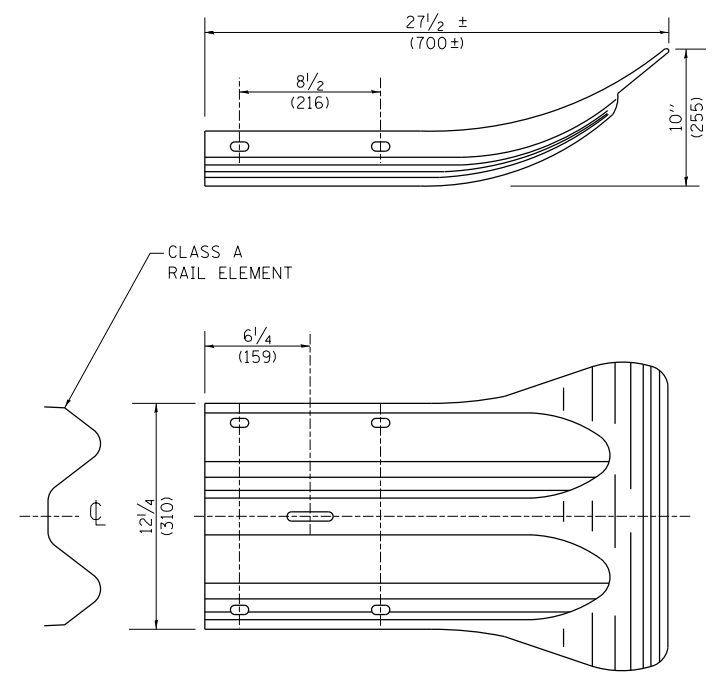


**END SECTION**

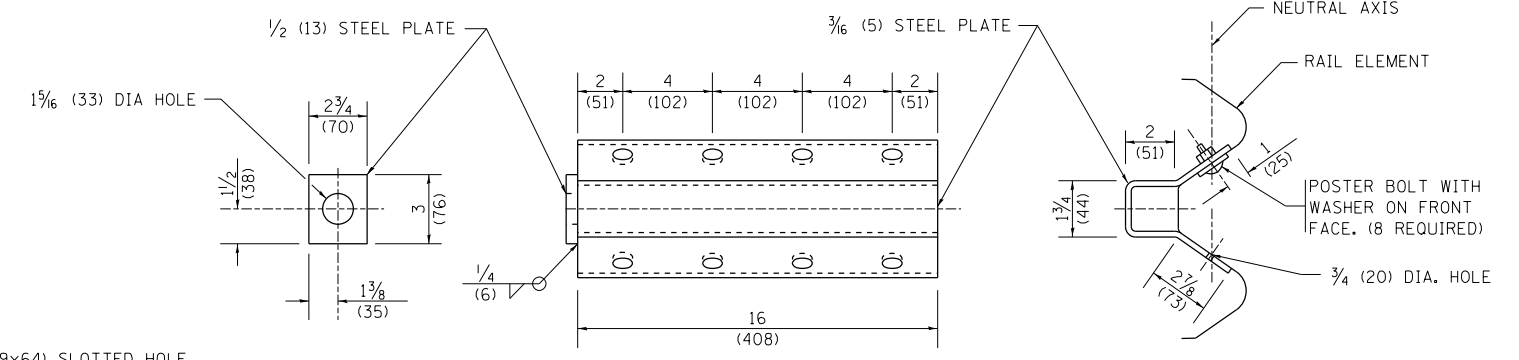

**NOTE:**

ANCHORE PLATE T SHALL BE USED TO ATTACH CABLE ASSEMBLY TO GUARDRAIL WHEN REQUIRED ON TRAFFIC BARRIER TERMINALS.

**ANCHORE PLATE T DETAILS**

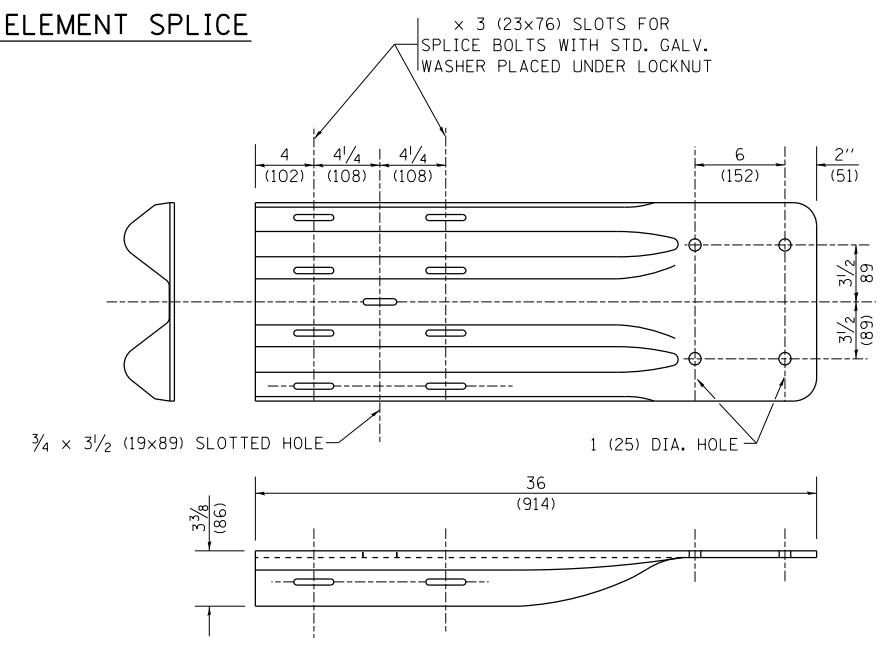


**END SHOE**

**NOTE:**

WHEN END SHOE IS ATTACHED TO A BRIDGE PARAPET WHICH HAS AN EXPANSION JOINT, THE BOLTS SHALL BE PROVIDED WITH A LOCKNUT OR DOUBLE NUT AND SHALL BE TIGHTENED ONLY TO A POINT THAT WILL ALLOW GUARDRAIL MOVEMENT.


THE STANDARD END SHOE SHALL BE ATTACHED TO THE CONCRETE WITH PRE-DRILLED OR SELF-DRILLING ANCHOR BOLTS. THE ANCHOR CONE SHALL BE SET FLUSH WITH THE SURFACE OF THE CONCRETE.

EXTERNALLY THREADED STUDS PROTRUDING FROM THE SURFACE OF THE CONCRETE WILL NOT BE PERMITTED.

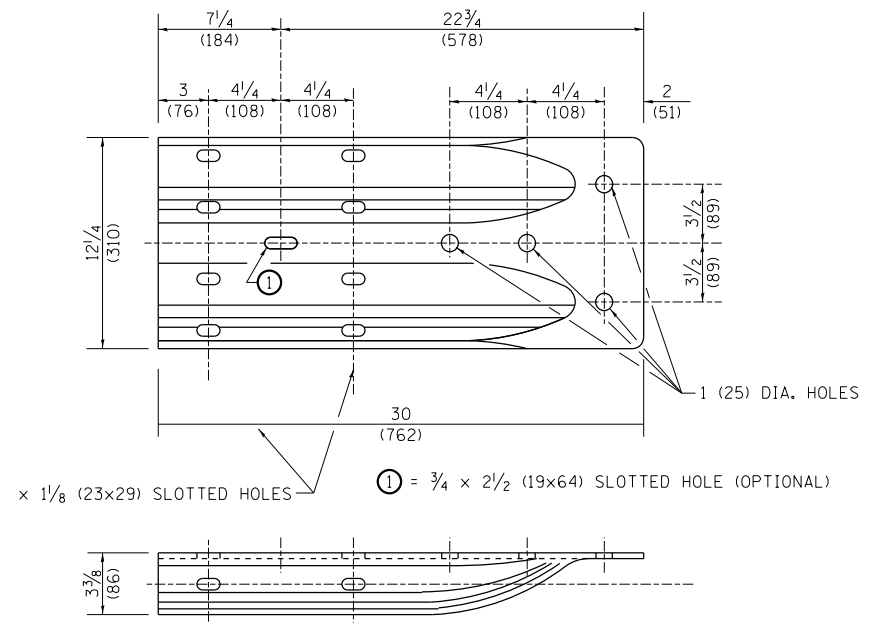


**ALTERNATE END SHOE**

FILE NAME =	USER NAME = qureshiya	DESIGNED -	REVISED - 10-31-06	<b>STATE OF ILLINOIS DEPARTMENT OF TRANSPORTATION</b>	<b>REMOVE AND REERECT STEEL PLATE BEAM GUARDRAIL</b>			F.A.U. RTE.	SECTION	COUNTY	TOTAL SHEETS	SHEET NO.	
ca:\pw_work\pwidot\qureshiya\d0283041\Dis	Std.dgn	DRAWN -	REVISED -		SCALE: NONE	SHEET NO. 3 OF 4 SHEETS	STA.	TO STA.	1632	49R-R5	COOK	48	38
		CHECKED -	REVISED -						<b>BM-21</b>		<b>CONTRACT NO. 60X38</b>		
		DATE -	REVISED -						FED. ROAD DIST. NO. 1 ILLINOIS FED. AID PROJECT				

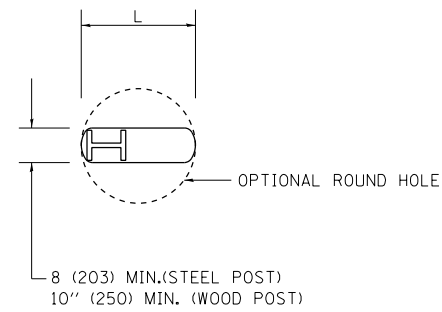


PLAN

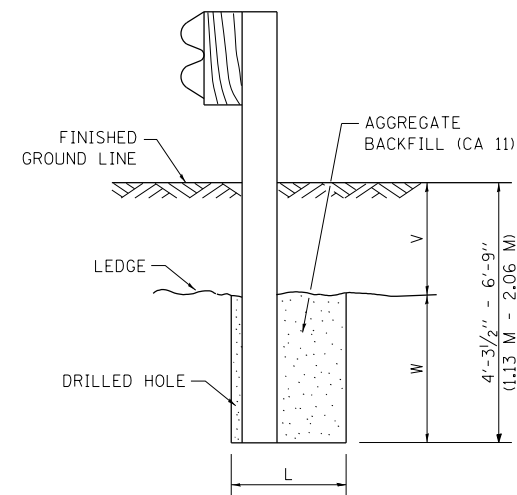

NOTE:  
LEDGE LINE IS TOP OF ROCK LEDGE OR HARD SLAG FILL.

ELEVATION

**FOOTING FOR POST WHEN IMPERVIOUS MATERIAL IS ENCOUNTERED**

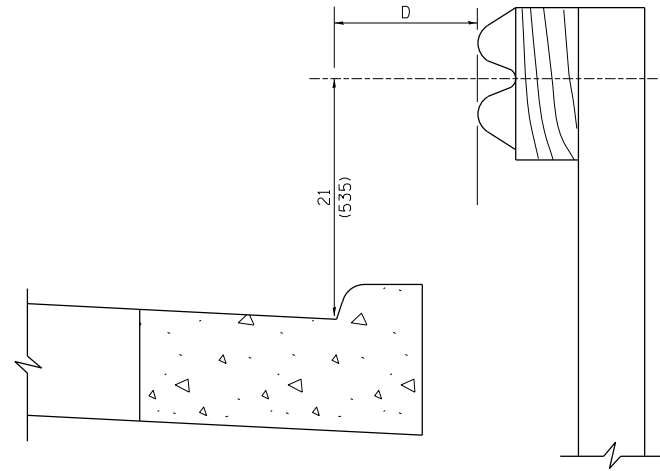


**NOTE:**

IF IT IS NECESSARY FOR D TO BE MORE THAN 12 (300) AND LESS THAN 10'-0" (3.0 M) TYPE M-2 (M-5) CURB AND GUTTER (STD. 606001) SHALL BE USED IN FRONT OF AND IN ADVANCE OF THE GUARDRAIL.


**GUARDRAIL PLACED BEHIND CURB**

(D = 0 DESIRABLE TO 12 (300) MAXIMUM)

V	W	L	
		STEEL POST	WOOD POST
0 - 18 (0 - 460)	24 (610)	21 (530)	23 (580)
>18 - 41.5 (> 460 - 825)	12 (305)	8 (203)	10 (250)
>41.5 - 53.5 (> 825 - 1.13 M)	12 - 0 (350 - 0)	8 (203)	10 (250)

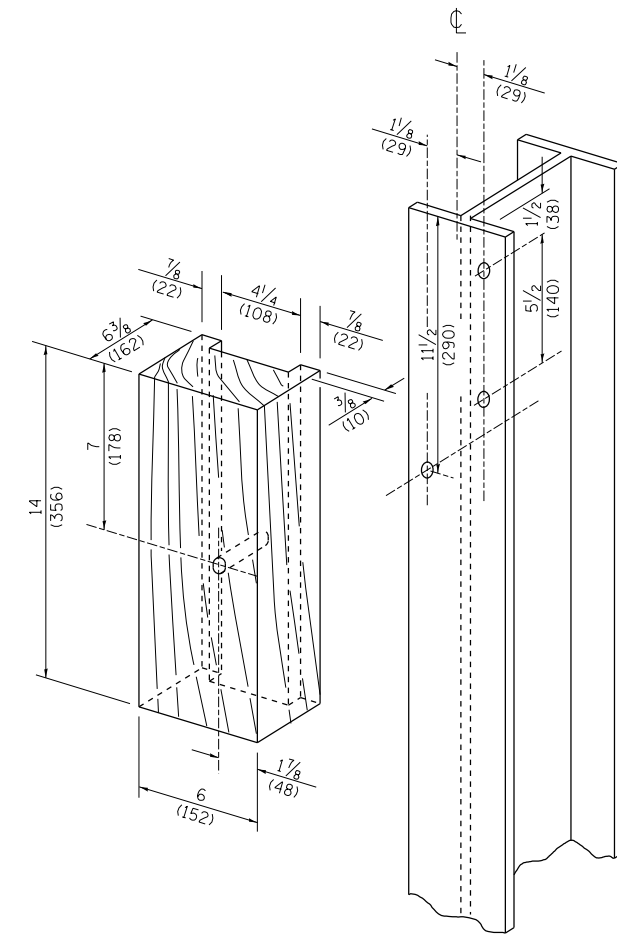


**WOOD BLOCK-OUT AND STEEL POST DETAILS**

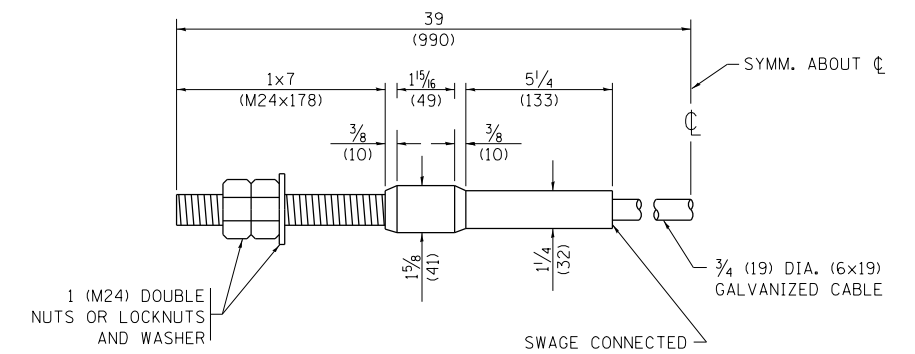

**CABLE ASSEMBLY**

(40,000 LBS (18,100 KG) MIN. BREAKING STRENGTH)  
TIGHTEN TO TAUT TENSION



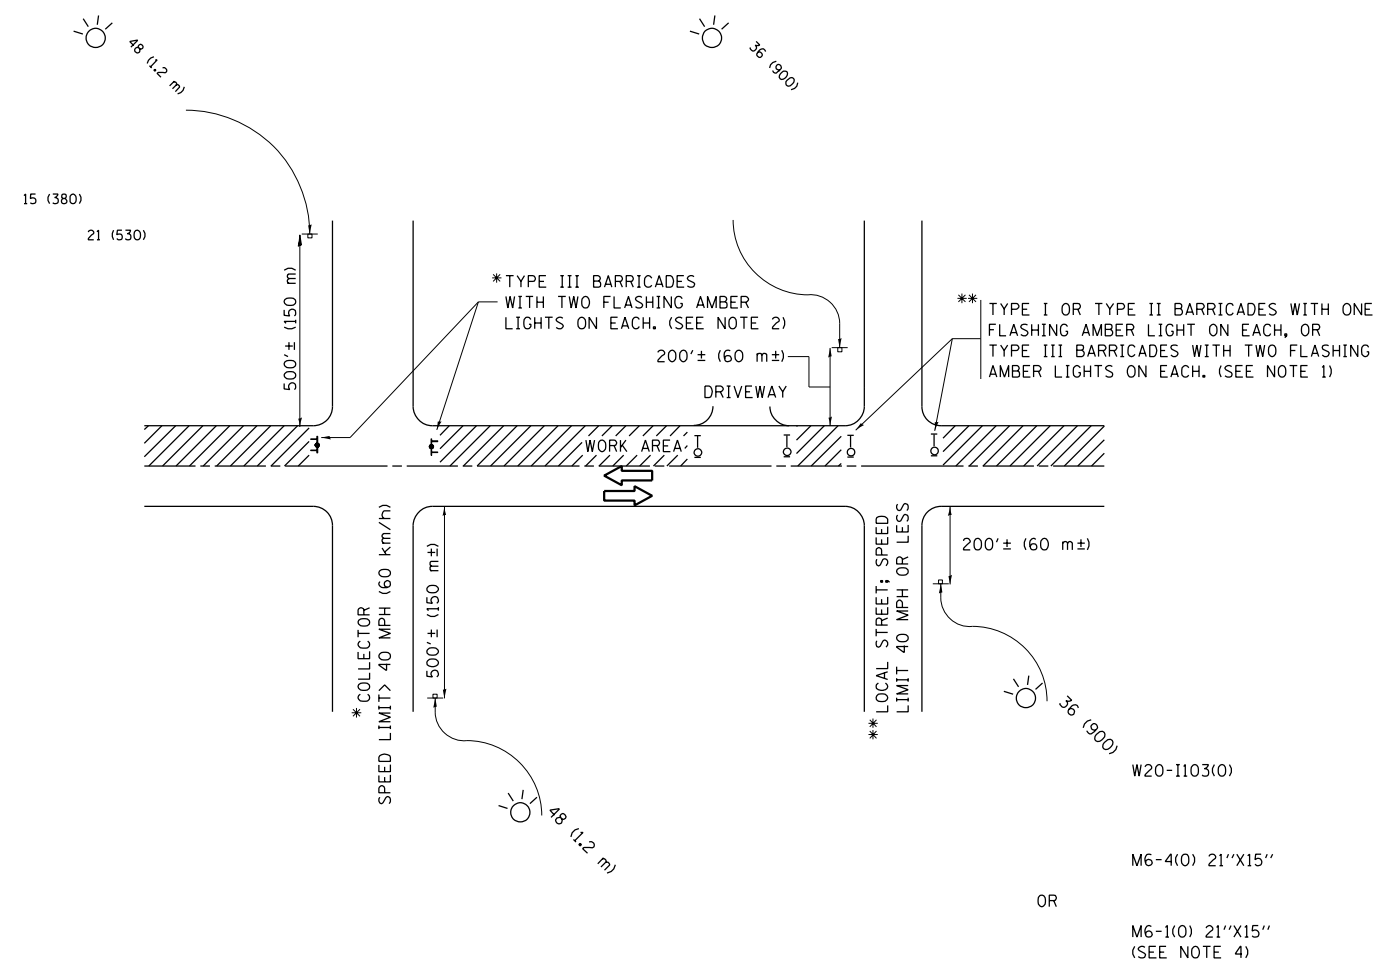

**NOTES:**

1. SIDE ROAD WITH A SPEED LIMIT OF 40 MPH (60 km/h) OR LESS AS SHOWN ON THE DRAWING AND AS DIRECTED BY THE ENGINEER:
  - a) ONE "ROAD CONSTRUCTION AHEAD" SIGN 36 x 36 (900x900) WITH A FLASHER MOUNTED ON IT APPROXIMATELY 200' (60 m) IN ADVANCE OF THE MAIN ROUTE.
  - b) THE CLOSED PORTION OF THE MAIN ROUTE SHALL BE PROTECTED BY BLOCKING WITH TYPE I, TYPE II OR TYPE III BARRICADES, 1/3 OF THE CROSS SECTION OF THE CLOSED PORTION.
2. SIDE ROAD WITH A SPEED LIMIT GREATER THAN 40 MPH (60 km/h) AS SHOWN ON THE DRAWING AND AS DIRECTED BY THE ENGINEER:
  - a) ONE "ROAD CONSTRUCTION AHEAD" SIGN 48 x 48 (1.2 m x 1.2 m) WITH A FLASHER MOUNTED ON IT APPROXIMATELY 500' (150 m) IN ADVANCE OF THE MAIN ROUTE.
  - b) THE CLOSED PORTION OF THE MAIN ROUTE SHALL BE PROTECTED BY BLOCKING WITH TYPE III BARRICADES, 1/2 OF THE CROSS SECTION OF THE CLOSED PORTION.
3. CONES MAY BE SUBSTITUTED FOR BARRICADES OR DRUMS AT HALF THE SPACING DURING DAY OPERATIONS. CONES SHALL BE A MINIMUM OF 28 (710) IN HEIGHT.
4. WHEN THE SIDE ROAD LIES BETWEEN THE BEGINNING OF THE MAINLINE SIGNING AND THE WORK ZONE, A SINGLE HEADED ARROW (M6-1) SHALL BE USED IN LIEU OF THE DOUBLE HEADED ARROW (M6-4).
5. WHEN WORK IS BEING PERFORMED ON A SIDE ROAD OR DRIVEWAY, FOLLOW THE APPLICABLE STANDARD(S). THE DIRECTIONAL ARROW (M6-1 OR M6-4) SHALL BE COVERED OR REMOVED WHEN NO LONGER CONSISTENT WITH THE TRAFFIC CONTROL SET-UP.
6. ADVANCE WARNING SIGNS ARE TO BE OMITTED ON DRIVEWAYS UNLESS OTHERWISE SPECIFIED IN THE PLANS OR BY THE ENGINEER.
7. THE TRAFFIC CONTROL AND PROTECTION FOR SIDE ROADS, INTERSECTIONS, AND DRIVEWAYS SHALL BE INCLUDED IN THE COST OF SPECIFIED TRAFFIC CONTROL STANDARDS OR ITEMS.

All dimensions are in inches (millimeters) unless otherwise shown.


FILE NAME =	USER NAME = qureshiya	DESIGNED - L.H.A.	REVISED - A. HOUSEH 10-15-96
Default	Std.dgn	DRAWN -	REVISED - T. RAMMACHER 01-06-00
	PLOT SCALE = 100.0002' / in.	CHECKED -	REVISED - A. SCHUETZE 07-01-13
	PLOT DATE = 10/26/2016	DATE - 06-89	REVISED - A. SCHUETZE 09-15-16

**STATE OF ILLINOIS  
DEPARTMENT OF TRANSPORTATION**

**TRAFFIC CONTROL AND PROTECTION FOR  
SIDE ROADS, INTERSECTIONS, AND DRIVEWAYS**


SCALE: NONE SHEET 1 OF 1 SHEETS STA. TO STA.

F.A.U. RTE.	SECTION	COUNTY	TOTAL SHEETS	SHEET NO.
1632	49R-R5	COOK	48	40
<b>TC-10</b>			<b>CONTRACT NO. 60X38</b>	
ILLINOIS FED. AID PROJECT				

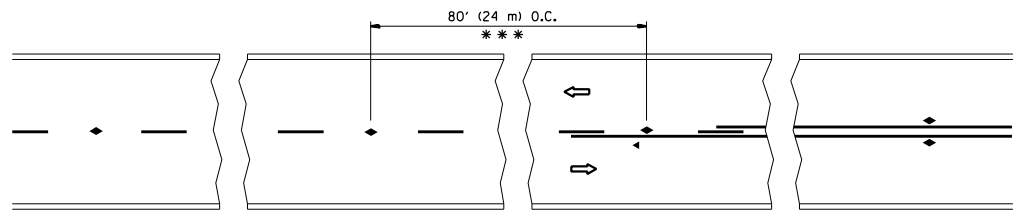


\*\*\* REDUCE TO 40' (12 m) O.C. ON CURVES WITH POSTED OR ADVISORY SPEED 45 M.P.H. (70 km/h) OR LESS.


TWO-LANE/TWO-WAY

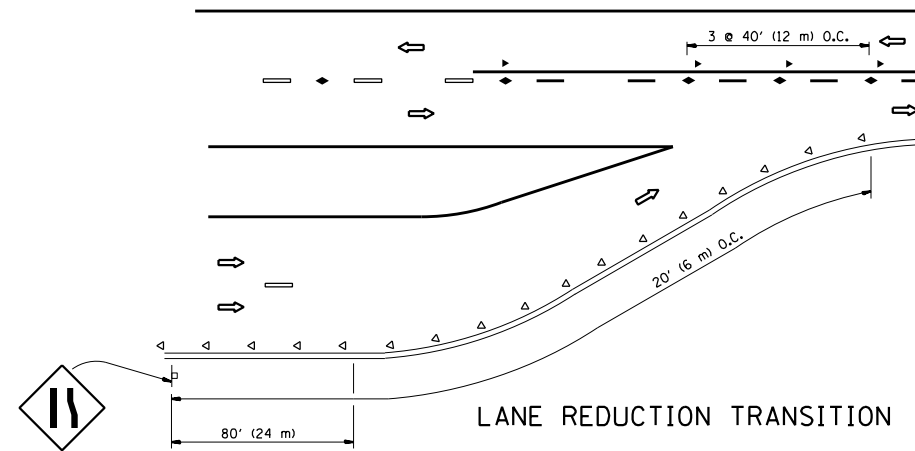


LANE REDUCTION TRANSITION

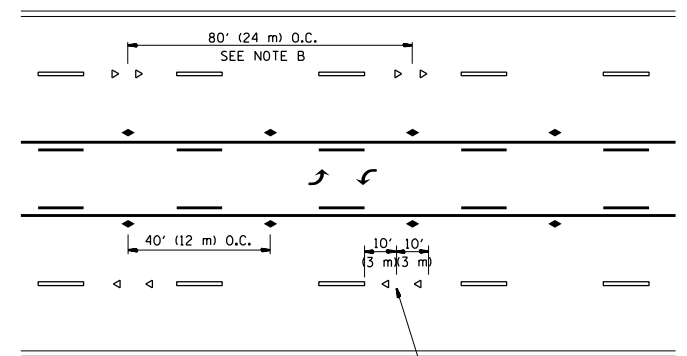

TWO-WAY LEFT TURN

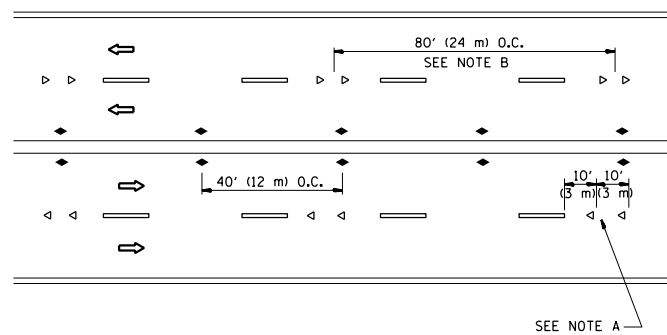

MULTI-LANE/UNDIVIDED

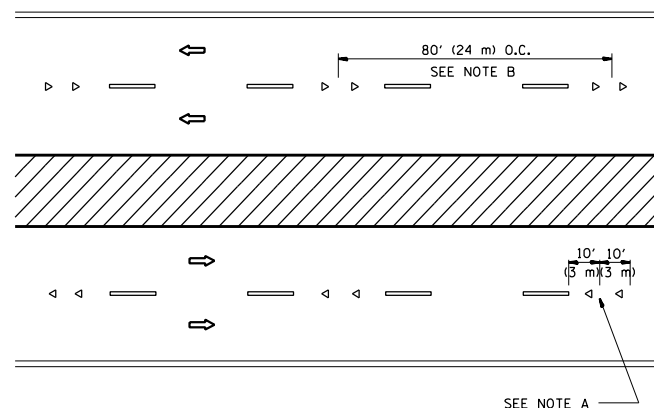

MULTI-LANE/DIVIDED

GENERAL NOTES

1. MARKERS USED WITH DASHED LINES SHALL BE CENTERED IN THE GAP BETWEEN SEGMENTS.
2. MARKERS USED ADJACENT TO SOLID LINES SHALL BE OFFSET 2 TO 3 (50 TO 75) TOWARD TRAFFIC AS SHOWN.
3. MARKERS THROUGH TANGENTS LESS THAN 500' (150 m) IN LENGTH BETWEEN CURVES SHALL BE INSTALLED AT THE LESSER OF THE TWO CURVE SPACINGS.

SYMBOLS


- YELLOW STRIPE
- WHITE STRIPE
- ◀ ONE-WAY AMBER MARKER
- ◁ ONE-WAY CRYSTAL MARKER (W/O)
- ◆ TWO-WAY AMBER MARKER

LANE MARKER NOTES

- A. USE DOUBLE LANE LINE MARKERS SPACED AS SHOWN.
- B. REDUCE TO 40' (12 m) O.C. ON CURVES WHERE ADVISORY SPEEDS ARE 10 M.P.H. (20 km/h) LOWER THAN POSTED SPEEDS.

DESIGN NOTES

1. DOUBLE LANE LINE MARKERS SHALL BE USED UNLESS SPECIFIED OTHERWISE.
2. EXCEPT AS SHOWN ON THE LANE REDUCTION TRANSITION AND FREEWAY EXIT RAMP DETAIL, MARKERS ARE NOT TO BE SPECIFIED ON RIGHT EDGE LINES.
3. THE EXACT MARKER LIMITS, SPACING, AND COLOR SHALL BE INCLUDED IN THE PLANS WHEN STANDARD SPECIFICATIONS ARE NOT BEING USED.
4. MARKERS SHOULD NOT BE USED ALONGSIDE CURBS EXCEPT FOR EXTREMELY SHORT SECTIONS OF CURBS WHERE NOT MORE THAN TWO MARKERS WOULD BE INVOLVED.

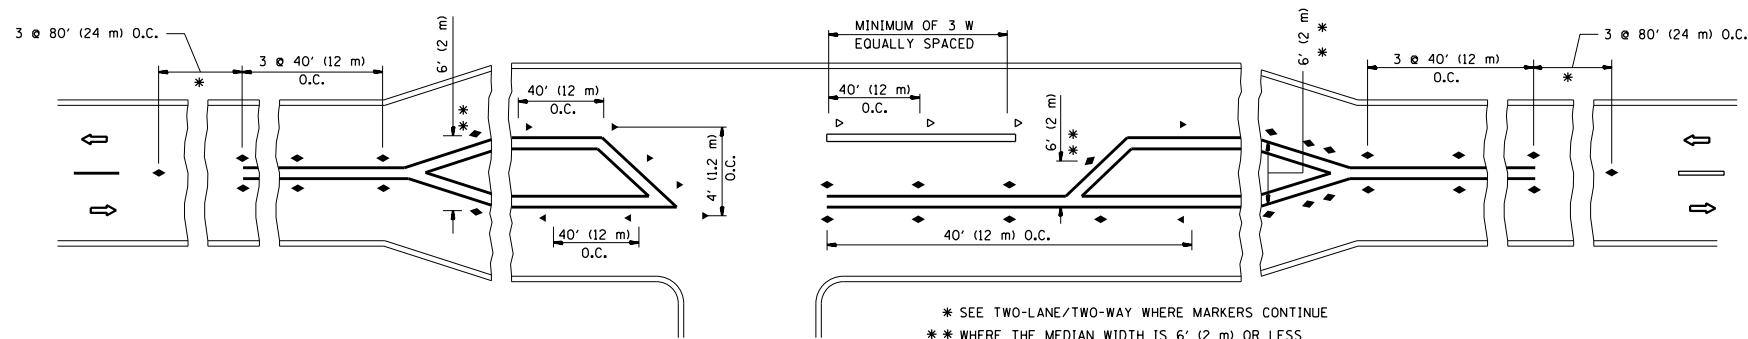


LEFT TURN


\* SEE TWO-LANE/TWO-WAY WHERE MARKERS CONTINUE  
 \*\* WHERE THE MEDIAN WIDTH IS 6' (2 m) OR LESS USE TWO-WAY MARKERS.

All dimensions are in inches (millimeters) unless otherwise shown.


FILE NAME =	USER NAME = qureshiya	DESIGNED -	REVISED - T. RAMMACHER 09-19-94	<b>STATE OF ILLINOIS DEPARTMENT OF TRANSPORTATION</b>	<b>TYPICAL APPLICATIONS</b>			F.A.U. RTE.	SECTION	COUNTY	TOTAL SHEETS	SHEET NO.	
ca:\pwork\pwork\qureshiya\0283041\Dis	Std.dgn	DRAWN -	REVISED - T. RAMMACHER 03-12-99		<b>RAISED REFLECTIVE PAVEMENT MARKERS (SNOW-PLOW RESISTANT)</b>			1632	49R-RS	COOK	48	41	
	PLOT SCALE = 100.0002' / in.	CHECKED -	REVISED - T. RAMMACHER 01-06-00		SCALE: NONE	SHEET NO. 1	OF 1 SHEETS	STA.	TO STA.	<b>TC-11</b>			<b>CONTRACT NO. 60X38</b>
	PLOT DATE = 10/26/2016	DATE -	REVISED - C. JUCIUS 09-09-09		FED. ROAD DIST. NO. 1   ILLINOIS FED. AID PROJECT								

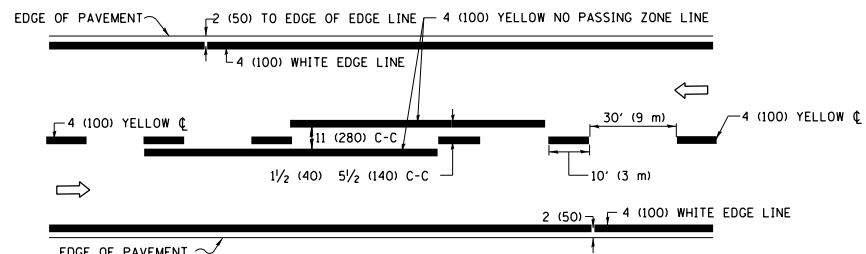

**2-LANE ROADWAY**

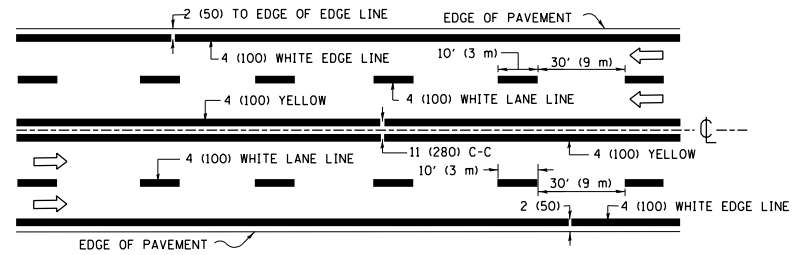


**MULTI-LANE UNDIVIDED**

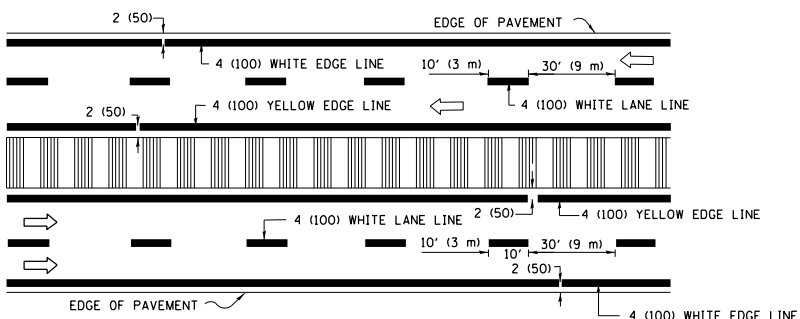


**MULTI-LANE DIVIDED WITH MEDIAN**

**TYPICAL LANE AND EDGE LINE MARKING**

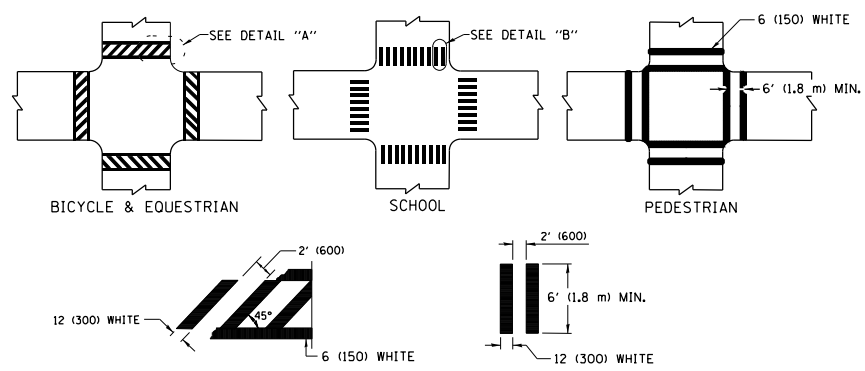


**TYPICAL CROSSWALK MARKING**


\* MARKINGS SHALL BE INSTALLED PARALLEL TO THE CENTERLINE OF THE ROAD WHICH IT CROSSES

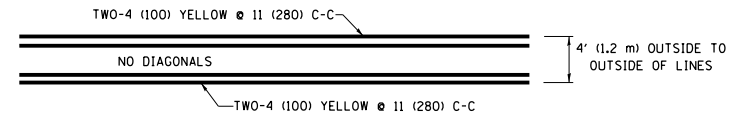


**4' (1.2 m) WIDE MEDIANS ONLY**

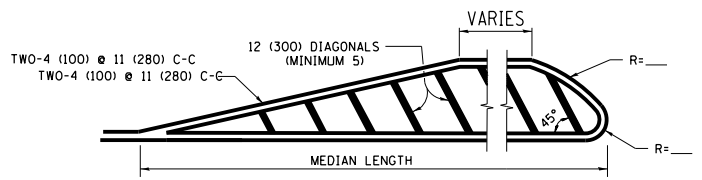

**MEDIANS OVER 4' (1.2 m) WIDE**

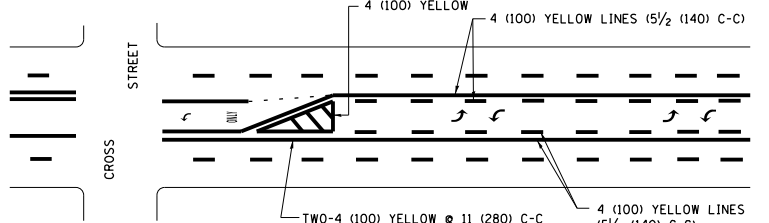


**MEDIAN WITH TWO-WAY LEFT TURN LANE TYPICAL PAINTED MEDIAN MARKING**

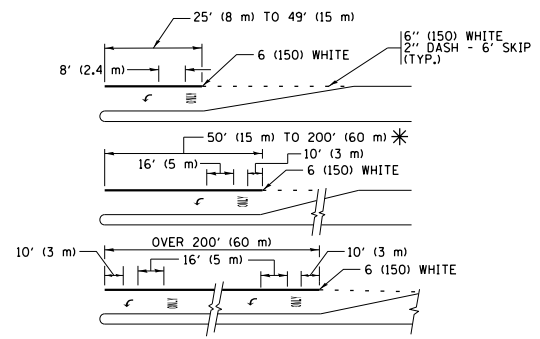


**TYPICAL LEFT (OR RIGHT) TURN LANE TYPICAL TURN LANE MARKING**


FULL SIZE LETTERS 8' (2.4 m) AND ARROWS SHALL BE USED.  
 \* TURN LANES IN EXCESS OF 400' (120 m) IN LENGTH MAY HAVE AN ADDITIONAL SET OF ARROW - "ONLY" INSTALLED MIDWAY BETWEEN THE OTHER TWO SETS OF ARROW - "ONLY".

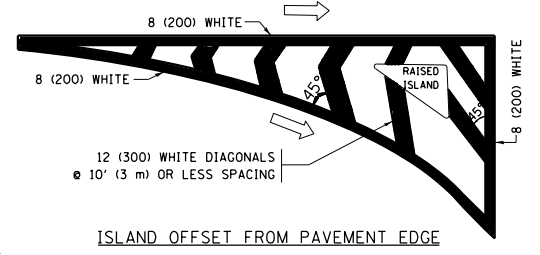


**ISLAND OFFSET FROM PAVEMENT EDGE**

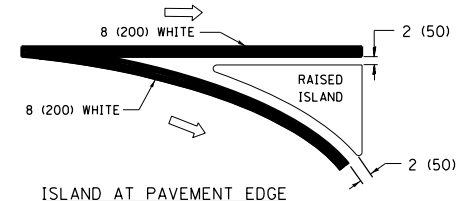

**ISLAND AT PAVEMENT EDGE TYPICAL ISLAND MARKING**

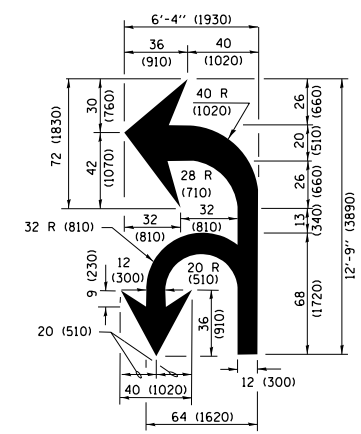

**COMBINATION LEFT AND U-TURN**

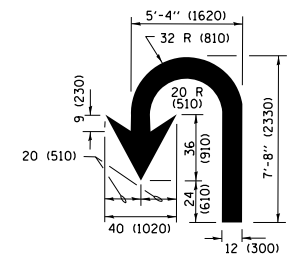

**U-TURN**

**LANE REDUCTION TRANSITION**

\* LANE REDUCTION ARROWS REQUIRED AT SPEEDS OF 45 MPH OR GREATER OR WHEN SPECIFIED IN PLANS.

D(FT)	SPEED LIMIT
345	30
425	35
500	40
580	45
665	50
750	55

TYPE OF MARKING	WIDTH OF LINE	PATTERN	COLOR	SPACING /REMARKS
CENTERLINE ON 2 LANE PAVEMENT	4 (100)	SKIP-DASH	YELLOW	10' (3 m) LINE WITH 30' (9 m) SPACE
CENTERLINE ON MULTI-LANE UNDIVIDED PAVEMENT	2 @ 4 (100)	SOLID	YELLOW	11 (280) C-C
NO PASSING ZONE LINES FOR ONE DIRECTION FOR BOTH DIRECTIONS	4 (100) 2 @ 4 (100)	SOLID SOLID	YELLOW YELLOW	5 1/2 (140) C-C FROM SKIP-DASH CENTERLINE 11 (280) C-C OMIT SKIP-DASH CENTERLINE BETWEEN
LANE LINES	4 (100) 5 (125) ON FREEWAYS	SKIP-DASH SKIP-DASH	WHITE WHITE	10' (3 m) LINE WITH 30' (9 m) SPACE
DOTTED LINES (EXTENSIONS OF CENTER, LANE OR TURN LANE MARKINGS)	SAME AS LINE BEING EXTENDED	SKIP-DASH	SAME AS LINE BEING EXTENDED	2' (600) LINE WITH 6' (1.8 m) SPACE
EDGE LINES	4 (100)	SOLID	YELLOW-LEFT WHITE-RIGHT	OUTLINE MEDIANS IN YELLOW
TURN LANE MARKINGS	6 (150) LINE, FULL SIZE LETTERS & SYMBOLS (8' (2.4m))	SOLID	WHITE	SEE TYPICAL TURN LANE MARKING DETAIL
TWO WAY LEFT TURN MARKING	2 @ 4 (100) EACH DIRECTION 8' (2.4m) LEFT ARROW	SKIP-DASH AND SOLID IN PAIRS	YELLOW WHITE	10' (3 m) LINE WITH 30' (9 m) SPACE FOR SKIP-DASH; 5 1/2 (140) C-C BETWEEN SOLID LINE AND SKIP-DASH LINE SEE TYPICAL TWO-WAY LEFT TURN MARKING DETAIL
CROSSWALK LINES (PEDESTRIAN A. DIAGONALS (BIKE & EQUESTRIAN) B. LONGITUDINAL BARS (SCHOOL))	2 @ 6 (150) 12 (300) @ 45° 12 (300) @ 90°	SOLID SOLID SOLID	WHITE WHITE WHITE	NOT LESS THAN 6' (1.8 m) APART 2' (600) APART SEE TYPICAL CROSSWALK MARKING DETAILS.
STOP LINES	24 (600)	SOLID	WHITE	PLACE 4' (1.2 m) IN ADVANCE OF AND PARALLEL TO CROSSWALK, IF PRESENT, OTHERWISE, PLACE AT DESIRED STOPPING POINT, PARALLEL TO CROSSROAD CENTERLINE, WHERE POSSIBLE.
PAINTED MEDIANS	2 @ 4 (100) WITH 12 (300) DIAGONALS @ 45° NO DIAGONALS USED FOR 4' (1.2 m) WIDE MEDIANS	SOLID	YELLOW; TWO WAY TRAFFIC WHITE; ONE WAY TRAFFIC	11 (280) C-C FOR THE DOUBLE LINE SEE TYPICAL PAINTED MEDIAN MARKING.
GORE MARKING AND CHANNELIZING LINES	8 (200) WITH 12 (300) DIAGONALS @ 45°	SOLID	WHITE	DIAGONALS: 15' (4.5 m) C-C (LESS THAN 30MPH (50 km/h)) 20' (6 m) C-C 30MPH (50 km/h) TO 45MPH (70 km/h) 30' (9 m) C-C (OVER 45MPH (70 km/h))
RAILROAD CROSSING	24 (600) TRANSVERSE LINES; "RR" 15 6' (1.8 m) LETTERS; 16 (400) LINE FOR "X"	SOLID	WHITE	SEE STATE STANDARD 780001 AREA OF: "R"=3.6 SQ. FT. (0.33 m²) EACH "X"=54.0 SQ. FT. (5.0 m²)
SHOULDER DIAGONALS (REQUIRED FOR SHOULDERS ≥ 8')	12 (300) @ 45°	SOLID	WHITE - RIGHT YELLOW - LEFT	50' (15 m) C-C (LESS THAN 30MPH (50 km/h)) 75' (25 m) C-C (30 MPH (50 km/h) TO 45MPH (70 km/h)) 150' (45 m) C-C (OVER 45MPH (70 km/h))
U TURN ARROW	SEE DETAIL	SOLID	WHITE	16.3 SF
2 ARROW COMBINATION LEFT AND U TURN	SEE DETAIL	SOLID	WHITE	30.4 SF

FOR FURTHER DETAILS ON PAVEMENT MARKING REFER TO STANDARD SPECIFICATIONS FOR ROAD AND BRIDGE CONSTRUCTION AND STATE STANDARD 780001.

All dimensions are in inches (millimeters) unless otherwise shown.


FILE NAME =	USER NAME = qureshiya	DESIGNED - EVERS	REVISED - C. JUCIUS 09-09-09
Default	Plot Scale = 100.0002' / in.	CHECKED -	REVISED - C. JUCIUS 07-01-13
	Plot Date = 10/26/2016	DATE - 03-19-90	REVISED - C. JUCIUS 12-21-15
			REVISED - C. JUCIUS 04-12-16

**STATE OF ILLINOIS DEPARTMENT OF TRANSPORTATION**

<b>DISTRICT ONE TYPICAL PAVEMENT MARKINGS</b>			
SCALE: NONE	SHEET 1 OF 1 SHEETS	STA. TO STA.	


F.A.U R.T.E.	SECTION	COUNTY	TOTAL SHEETS	SHEET NO.
1632	49R-R5	COOK	48	42
<b>TC-13</b>		<b>CONTRACT NO. 60X38</b>		
ILLINOIS FED. AID PROJECT				

# TURN BAY ENTRANCE AT START OF LANE CLOSURE TAPER

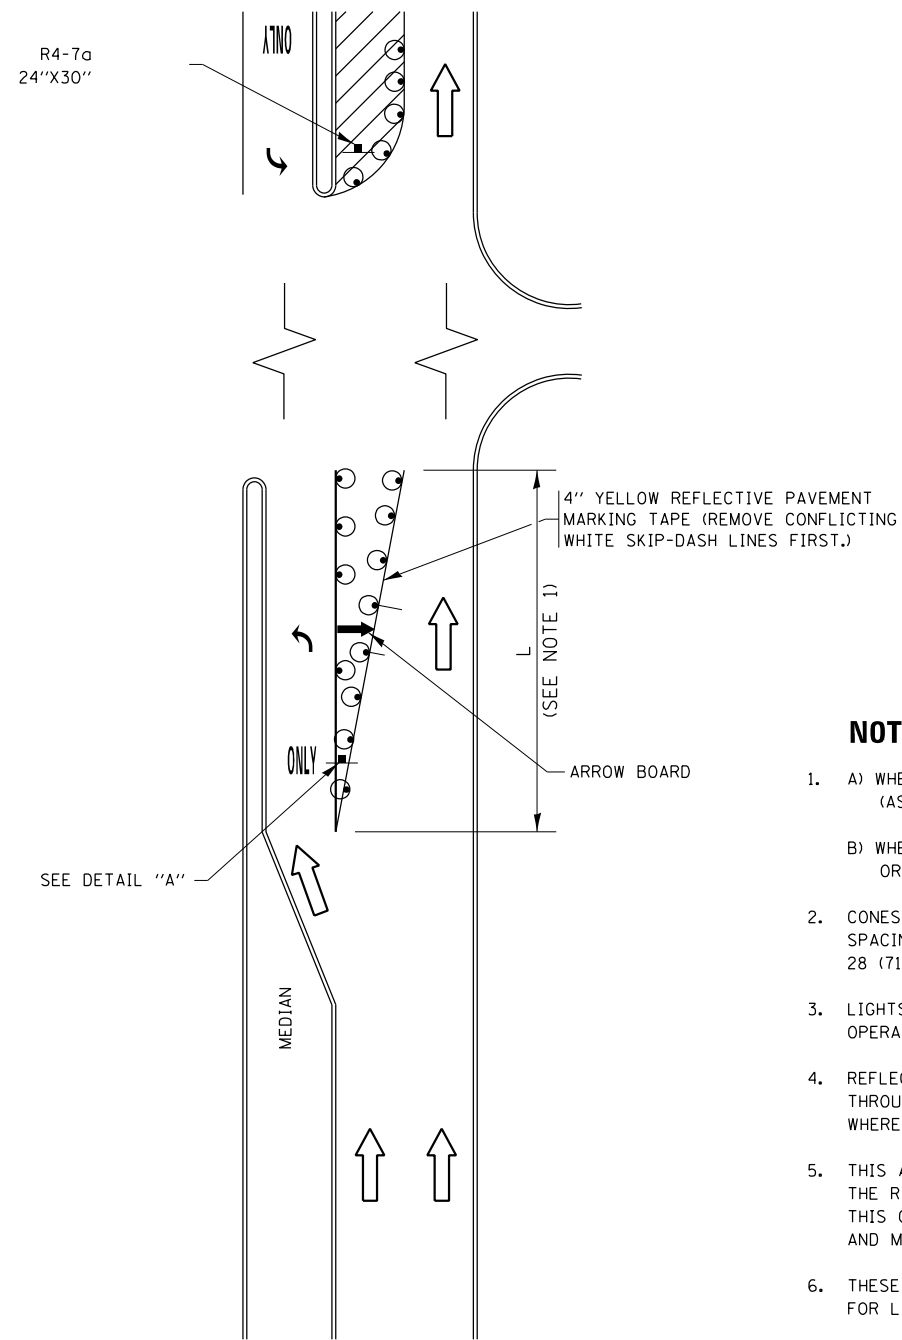

**FIGURE 1**


## LEGEND

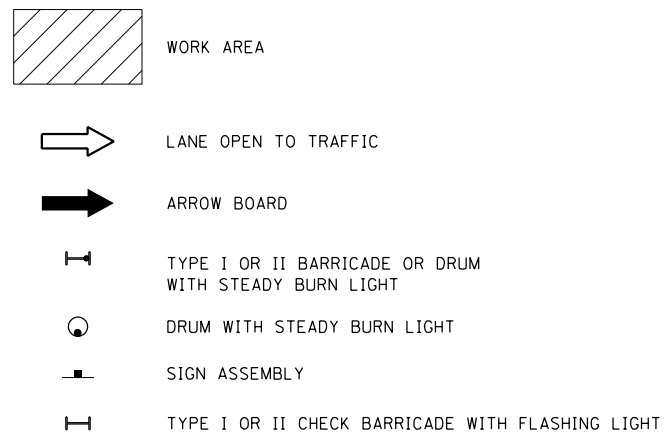


### NOTES:

1. A) WHEN "L" IS  $\leq$  THE STORAGE LENGTH OF THE TURN LANE (AS SHOWN IN FIG. 1), USE FIGURE 1.  
B) WHEN "L" IS  $>$  THE STORAGE LENGTH OF THE TURN LANE OR THE TURN LANE IS WITHIN THE LANE CLOSURE, USE FIGURE 2.
2. CONES MAY BE SUBSTITUTED FOR BARRICADES OR DRUMS AT HALF THE SPACING DURING DAY OPERATIONS. CONES SHALL BE A MINIMUM OF 28 (710) IN HEIGHT.
3. LIGHTS WILL NOT BE REQUIRED ON BARRICADES OR DRUMS FOR DAY OPERATIONS. ALL LIGHTS SHALL BE MONODIRECTIONAL.
4. REFLECTIVE TEMPORARY PAVEMENT MARKINGS SHALL BE PLACED THROUGHOUT THE BARRICADED AREAS OF EACH TURN BAY AS SHOWN WHERE THE CLOSURE TIME IS GREATER THAN FOURTEEN (14) DAYS.
5. THIS APPLICATION ALSO APPLIES WHEN WORK IS BEING PERFORMED IN THE RIGHT LANE(S) AND THE RIGHT TURN BAY IS TO REMAIN OPEN. UNDER THIS CONDITION, "RIGHT TURN LANE" R3-I100R 24 x 24 (600 x 600) AND M6-2R 21 x 15 (530 x 380) SHALL BE USED.
6. THESE CONTROLS SHALL SUPPLEMENT MAINLINE TRAFFIC CONTROL FOR LANE CLOSURES.
7. THE SIGNS SHALL BE MOUNTED ABOVE THE BARRICADES/DRUMS ON SEPARATE SIGN SUPPORTS THAT MEET NCHRP 350 OR MASH PREQUIREMENTS.
8. TRAFFIC CONTROL AND PROTECTION AT TURN BAYS (TO REMAIN OPEN TO TRAFFIC) SHALL BE INCLUDED IN THE COST OF SPECIFIED TRAFFIC CONTROL STANDARDS OR ITEMS.

# TURN BAY ENTRANCE WITHIN A LANE CLOSURE

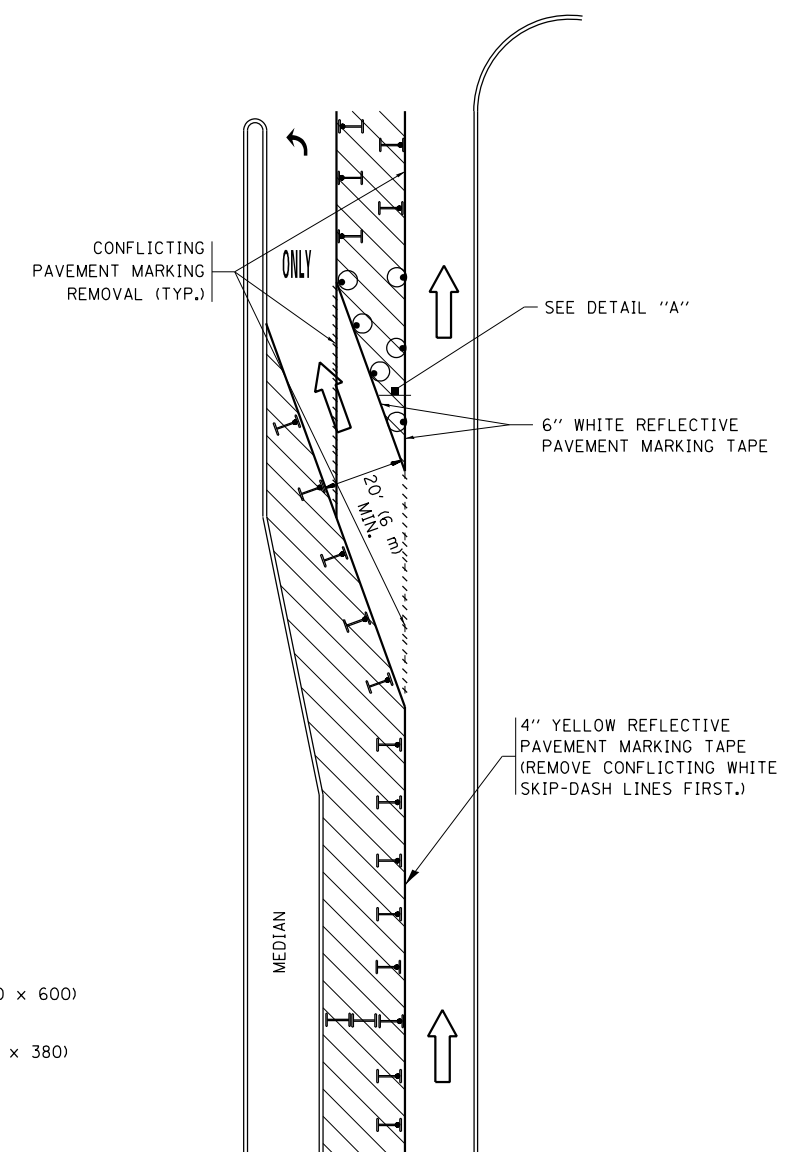


**FIGURE 2**

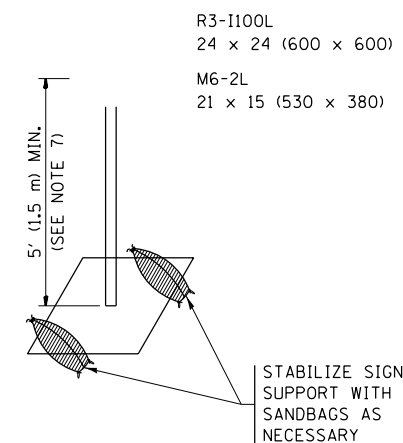


**DETAIL A**

All dimensions are in inches (millimeters) unless otherwise shown.


FILE NAME =	USER NAME = qureshiya	REVISED - T. RAMMACHER 09-08-94	REVISED - R. BORO 09-14-09	<b>STATE OF ILLINOIS DEPARTMENT OF TRANSPORTATION</b>	<b>TRAFFIC CONTROL AND PROTECTION AT TURN BAYS (TO REMAIN OPEN TO TRAFFIC)</b>	F.A.U. R.T.E.	SECTION	COUNTY	TOTAL SHEETS	SHEET NO.	
Default	Std.dgn	REVISED - A. HOUSEH 11-07-95	REVISED - A. SCHUETZE 07-01-13			1632	49R-R5	COOK	48	43	
	PLOT SCALE = 100.0002' / 1in.	REVISED - A. HOUSEH 10-12-96	REVISED - A. SCHUETZE 09-15-16			<b>TC-14</b>		<b>CONTRACT NO. 60X38</b>			
	PLOT DATE = 10/26/2016	REVISED - T. RAMMACHER 01-06-00	REVISED -			ILLINOIS FED. AID PROJECT					
				SCALE: NONE	SHEET 1 OF 1 SHEETS	STA.	TO STA.				

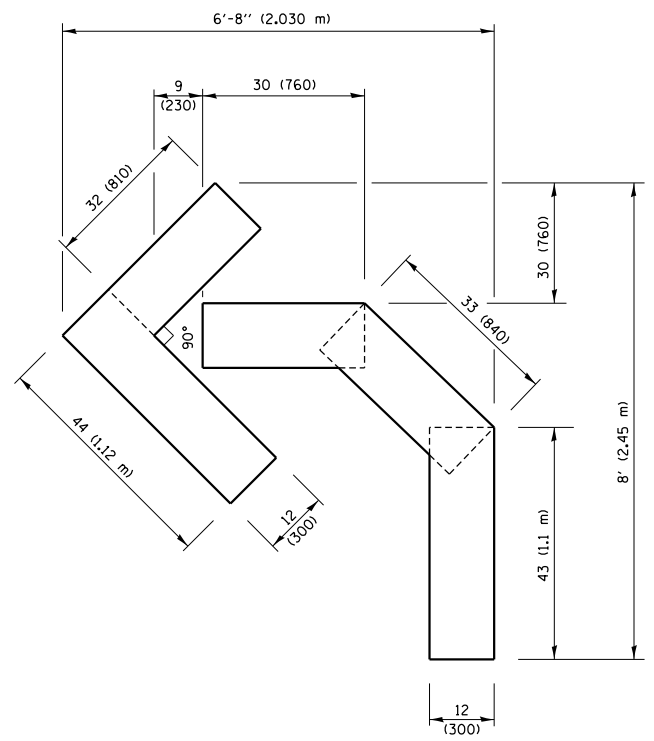

**QUANTITY**  
 4 (100) LINE = 45.5 ft. (13.9 m)  
 15.2 sq. ft. (1.41 sq. m)

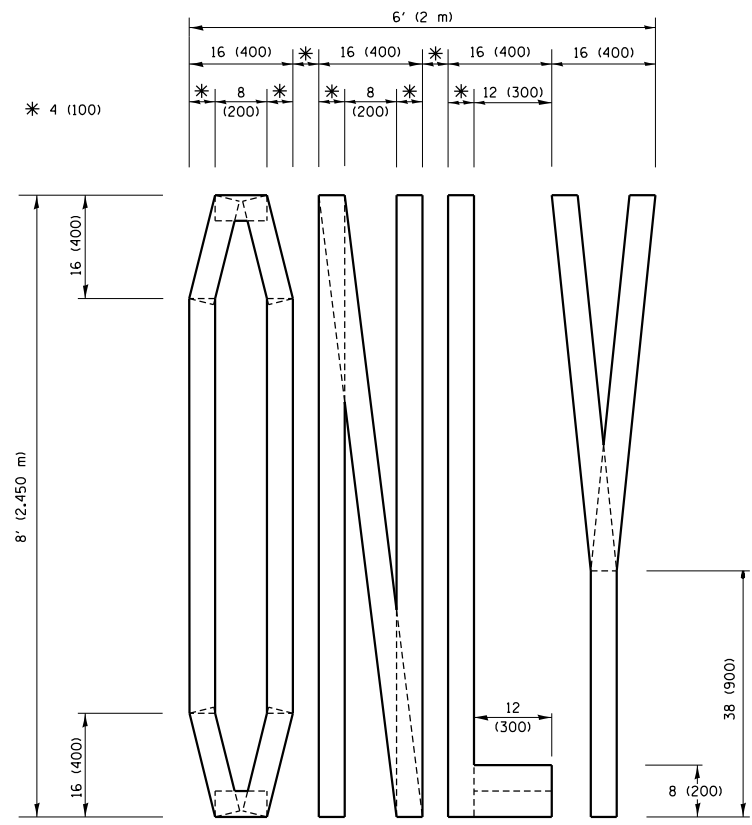


**QUANTITY**  
 4 (100) LINE = 64.1 ft. (19.5 m)  
 21.4 sq. ft. (1.99 sq. m)

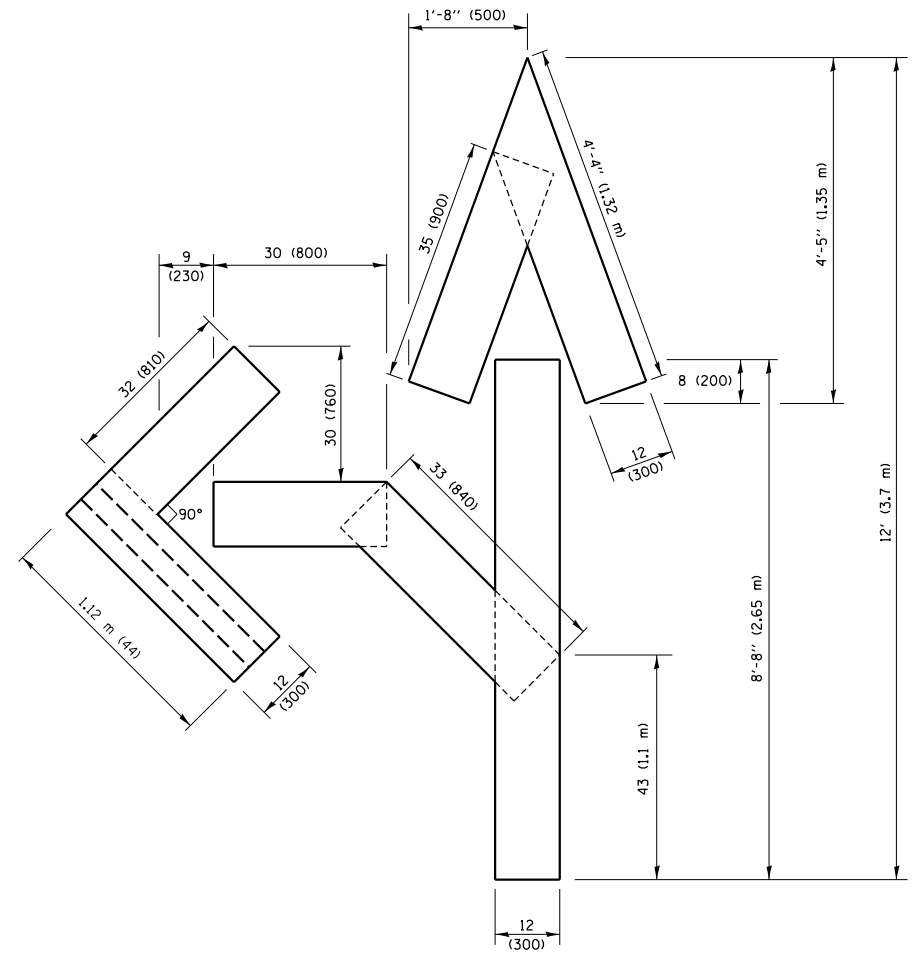

**QUANTITY**  
 4 (100) LINE = 82.5 ft. (25.1 m)  
 27.5 sq. ft. (2.53 sq. m)

**NOTE:**  
 ALL QUANTITIES OF PLACEMENT ARE REPRESENTED IN LINEAR FEET OF 4" LINES TO MATCH THE 4" TEMPORARY TAPE PAY ITEM AND REPRESENTS THE TOTAL QUANTITY OF 4" TAPE REQUIRED.

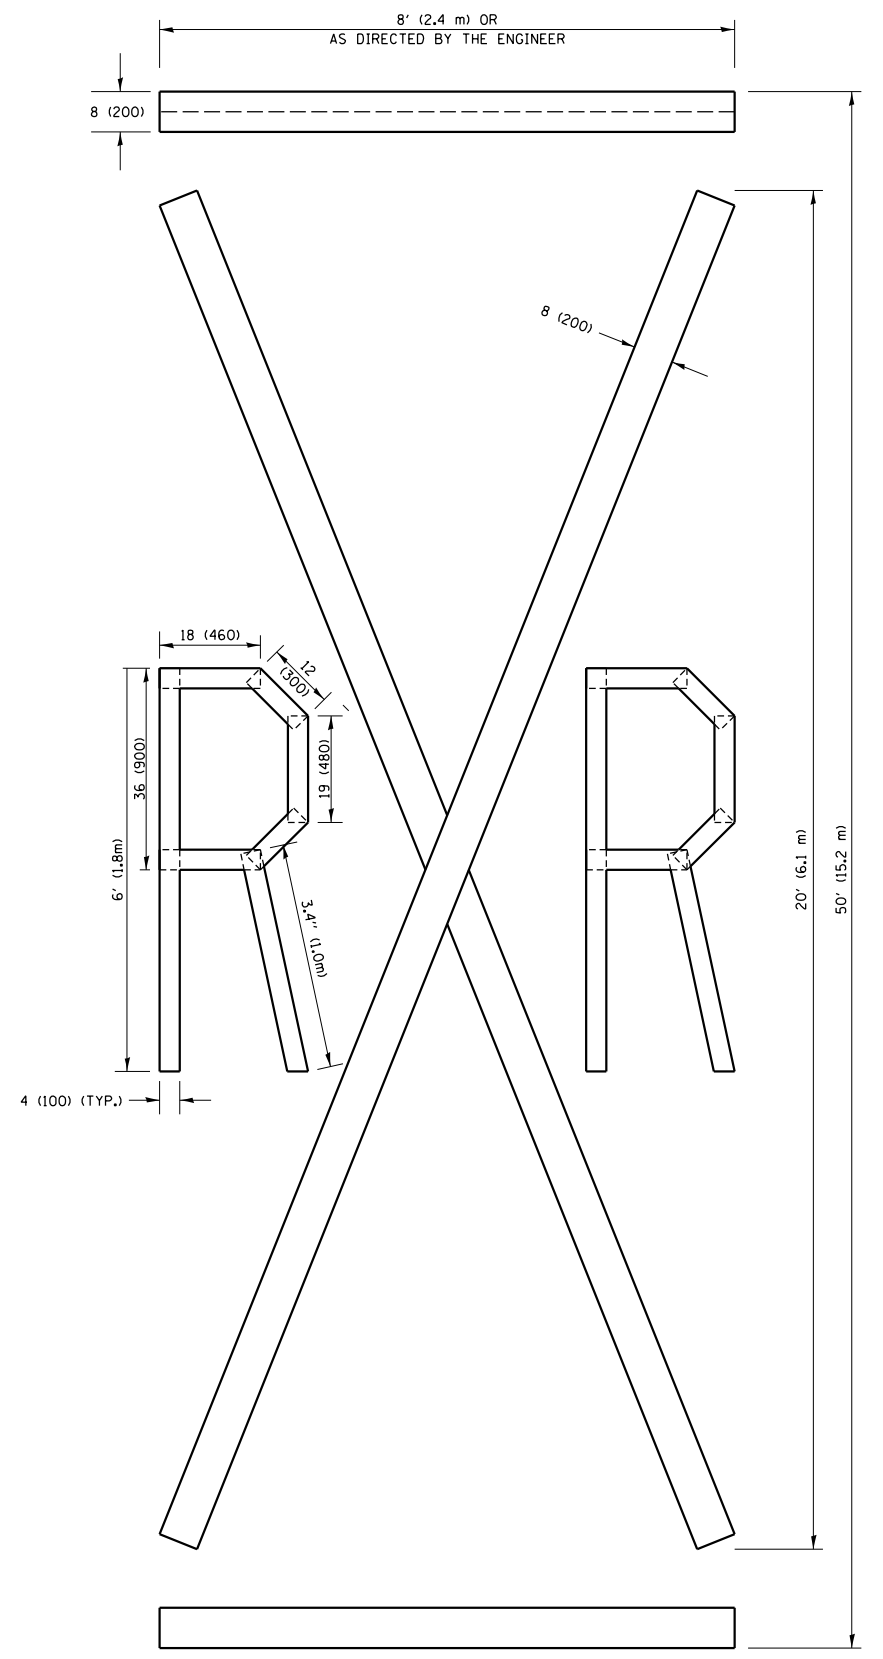

**QUANTITY**  
 4 (100) LINE = 225.9 ft. (68.9 m)  
 75.3 sq. ft. (6.99 sq. m)


All dimensions are in inches (millimeters) unless otherwise shown.

FILE NAME =	USER NAME = qureshiya	DESIGNED -	REVISED - T. RAMMACHER 03-02-98
ci:\pwork\pwork\qureshiya\d0283041\Dist	Std.dgn	DRAWN -	REVISED - E. GOMEZ 08-28-00
	PLOT SCALE = 100.0010' / 1"	CHECKED -	REVISED - E. GOMEZ 08-28-00
	PLOT DATE = 10/26/2016	DATE -	REVISED - A. SCHUETZE 09-15-16

**STATE OF ILLINOIS  
 DEPARTMENT OF TRANSPORTATION**

<b>SHORT TERM PAVEMENT MARKING LETTERS AND SYMBOLS</b>			
SCALE: NONE	SHEET NO. 1 OF 1 SHEETS	STA.	TO STA.

F.A.U. RTE.	SECTION	COUNTY	TOTAL SHEETS	SHEET NO.
1632	49R-R5	COOK	48	44
<b>TC-16</b>		<b>CONTRACT NO. 60X38</b>		
FED. ROAD DIST. NO. 1 ILLINOIS FED. AID PROJECT				

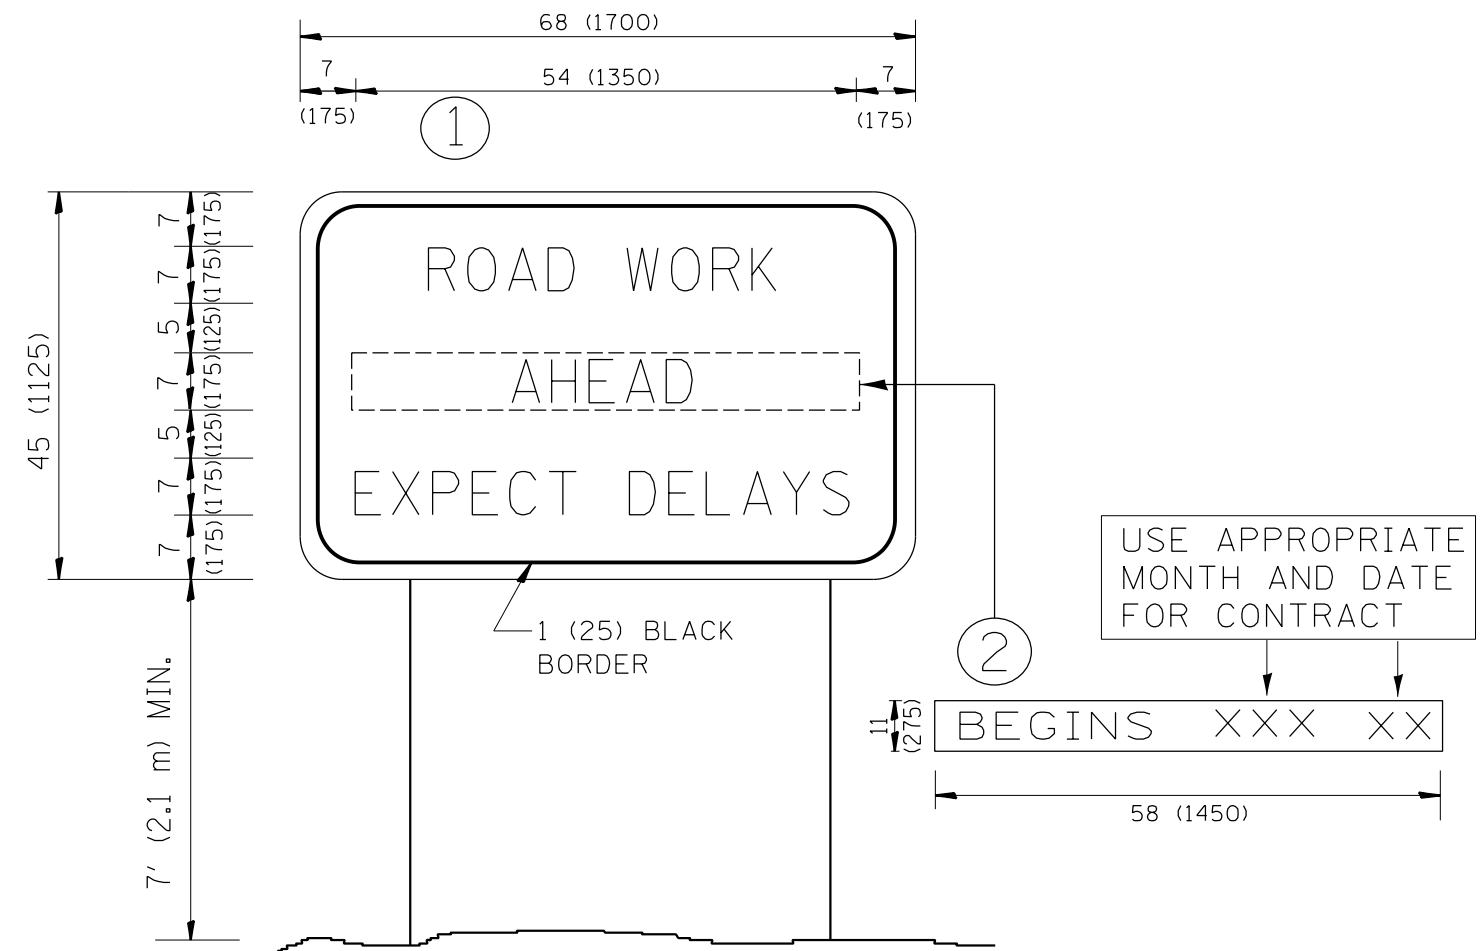

**NOTES:**

1. USE BLACK LETTERING ON ORANGE BACKGROUND.
2. ERECT SIGNS IN ADVANCE OF THE LOCATION FOR THE "ROAD CONSTRUCTION AHEAD" SIGN AT LOCATIONS AS DIRECTED BY THE ENGINEER.
3. ERECT SIGN ① WITH INSTALLED PANEL ② ONE WEEK PRIOR TO THE START OF CONSTRUCTION.
4. REMOVE PANEL ② SOON AFTER THE START OF CONSTRUCTION.
5. SEE SPECIAL PROVISION FOR "TEMPORARY INFORMATION SIGNING" FOR ADDITIONAL INFORMATION.
6. ONE SIGN ASSEMBLY EQUALS 25.70 SQ. FT. (2.3 SQ. M.)
7. SHALL BE PAID FOR AS TEMPORARY INFORMATION SIGNING.

ALL DIMENSIONS ARE IN INCHES (MILLIMETERS) UNLESS OTHERWISE SHOWN.

FILE NAME =	USER NAME = qureshiya	DESIGNED -	REVISED - R. MIRS 09-15-97
ca:\pw_work\pwidot\qureshiya\d0283041\Dis	Std.dgn	DRAWN -	REVISED - R. MIRS 12-11-97
	PLOT SCALE = 100.0010' / in.	CHECKED -	REVISED - T. RAMMACHER 02-02-99
	PLOT DATE = 10/26/2016	DATE -	REVISED - C. JUCIUS 01-31-07

**STATE OF ILLINOIS  
DEPARTMENT OF TRANSPORTATION**


**ARTERIAL ROAD  
INFORMATION SIGN**

SCALE: NONE SHEET NO. 1 OF 1 SHEETS STA. TO STA.

F.A.U. RTE.	SECTION	COUNTY	TOTAL SHEETS	SHEET NO.
1632	49R-R5	COOK	48	45
<b>TC-22</b>			<b>CONTRACT NO. 60X38</b>	
<small>FED. ROAD DIST. NO. 1   ILLINOIS FED. AID PROJECT</small>				

LOOPS NEXT TO SHOULDERS

PROVIDE A PAVEMENT REPLACEMENT NOTE WHICH SHOULD EQUAL 3' (900 mm) X WIDTH OF PAVED SHOULDER.

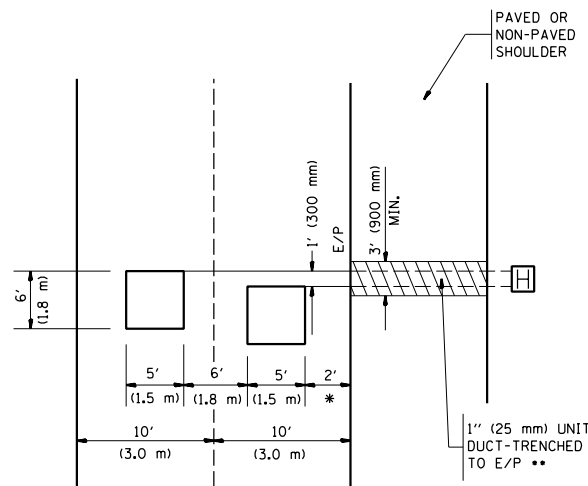


\* = (600 mm)

\*\* UNIT DUCT IS TO BE SHOWN ON PLAN SHEETS BUT SHALL NOT BE INCLUDED IN THE PAY ITEMS.

LEFT TURN LANES WITH MEDIANS  
VOLUME DENSITY ("FAR OUT" DETECTION)  
ON SAME APPROACH

(PROTECTED / PERMITTED LEFT TURN PHASING)

HANDHOLE LOCATION MAY VARY DEPENDING ON GEOMETRICS AND DESIGN OF TRAFFIC SIGNALS. HEAVY-DUTY HANDHOLES TO BE USED WHEN THE MEDIAN IS MOUNTABLE. REFER TO STANDARD 814001 TO ENSURE THAT HANDHOLE FITS IN MEDIAN.

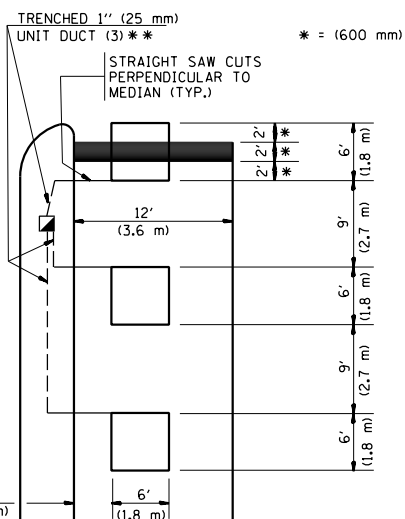


\* = (600 mm)

\*\* UNIT DUCT IS TO BE SHOWN ON PLAN SHEETS BUT SHALL NOT BE INCLUDED IN THE PAY ITEMS.

NOTE: DUAL LEFT TURNS NOT SHOWN REFER TO PLAN SHEET FOR DETECTOR LOOP REPLACEMENT

LEFT TURN LANES WITHOUT MEDIANS  
VOLUME DENSITY ("FAR OUT" DETECTION)  
ON SAME APPROACH

(PROTECTED / PERMITTED LEFT TURN PHASING)

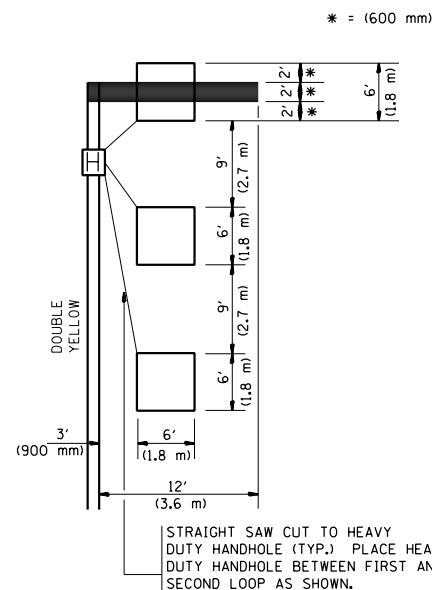

\* = (600 mm)

NOTE: DUAL LEFT TURNS NOT SHOWN REFER TO PLAN SHEET FOR DETECTOR LOOP REPLACEMENT

NOTES:

VEHICLES LOOP DETECTORS

- \* ALL LEAD IN CABLE SHALL BE TWO CONDUCTOR NO. 14 TWISTED, SHIELDED.
- \* EACH DETECTOR LOOP SHALL HAVE ITS OWN SAW CUT FROM THE LOOP TO THE EDGE OF PAVEMENT OR TO A HANDHOLE IN THE PAVEMENT.
- \* EACH DETECTOR LOOP SHALL HAVE ITS OWN ONE INCH (25 mm) UNIT DUCT BETWEEN THE EDGE OF PAVEMENT AND THE FIRST HANDHOLE OR JUNCTION BOX. EACH UNIT DUCT RUN SHALL BE SHOWN ON THE PLANS BY THE DESIGNER, BUT SHALL NOT BE PAID FOR SEPARATELY. THIS ITEM IS INCIDENTAL TO THE PAY ITEM FOR DETECTOR LOOPS.
- \* ONE DIMENSION OF ALL DETECTOR LOOPS SHALL BE SIX FEET (1.8 m)
- \* EACH LANE OF NON-LOCKING, PRESENCE DETECTION AND EACH LANE OF A DOUBLE LEFT TURN LANE REQUIRES A SEPARATE INDUCTIVE LOOP DETECTOR AND LEAD IN CABLE.
- \* WHEN NON-LOCKING, PRESENCE DETECTION IS USED, MORE THAN ONE LOOP PER LANE IS REQUIRED BEHIND THE STOP BAR (i.e. 1-1/2, 1-3/4, 2).
- \* WHEN SYSTEM LOOPS ARE REQUIRED ON AN APPROACH OF AN INTERSECTION, THE LOOPS USED FOR VOLUME DENSITY AND INTERSECTION TIMING SHALL ALSO BE USED AS SYSTEM DETECTORS. EACH ONE OF THESE TYPE OF LOOPS REQUIRES A SEPARATE TWO CONDUCTOR NO. 14 TWISTED SHIELDED CABLE AND A SEPARATE INDUCTIVE LOOP DETECTOR WHEN NEW CONTROLLERS ARE UTILIZED. THE DESIGNER SHALL LABEL THESE TYPES OF LOOPS AS "INTERSECTION AND SAMPLING (SYSTEM) DETECTORS" ON THE SIGNAL LAYOUT, THE INTERCONNECT PLAN AND THE SYSTEM CABLE PLAN. WHEN AN EXISTING CONTROLLER IS UTILIZED FOR THIS TYPE OF DETECTION, THE PAY ITEM "INDUCTIVE LOOP DETECTOR WITH SYSTEM OUTPUT" SHOULD BE USED.

PLACEMENT OF DETECTORS

THE FOLLOWING FIGURES REPRESENT THE MOST COMMON DETECTOR LOOP LOCATIONS AND SIZES. ADJUSTMENTS WILL BE NECESSARY FOR SPECIFIC GEOMETRIC CONSIDERATIONS.

LOCATIONS AND DEMENSIONS OF DETECTOR LOOPS ARE REQUIRED ON ALL SIGNAL LAYOUT PLAN SHEETS.


"FAR OUT" DETECTION REFERS TO LOCKING, PRESENCE TYPE DETECTION LOCATED IN THRU LANES, RIGHT TURN LANES, AND RIGHT TURN LANE TAPER AREAS (IF APPLICABLE), USUALLY 250' (75 m) IN ADVANCE OF STOP BARS. "UPTIGHT" DETECTION REFERS TO NON-LOCKING PRESENCE TYPE DETECTION LOCATED IN ALL LANES AND 10'-15' (3.0 m-4.5 m) BEHIND THE CROSSING STREET'S EDGE OF PAVEMENT EXTENDED.

NOTE:

ALL DETAILS AND NOTES SHOWN ARE FROM THE I.D.O.T. DISTRICT 1 TRAFFIC SIGNAL DESIGN GUIDELINES DATED JANUARY 1995


THIS DRAWING HAS BEEN PREPARED TO ASSIST THE RESIDENT ENGINEER FOR ALL ROADWAY RESURFACING OR S.M.A.R.T. PROJECTS WHERE THE DIMENSIONS ARE NOT SHOWN ON THE PLANS AND THE FINAL LOCATIONS FOR CROSSWALKS OR STOP BARS ARE NOT DETERMINED.

ARTERIAL-VOLUME DENSITY ("FAR OUT" DETECTION)  
CROSS STREET-VOLUME DENSITY ("FAR OUT" DETECTION)

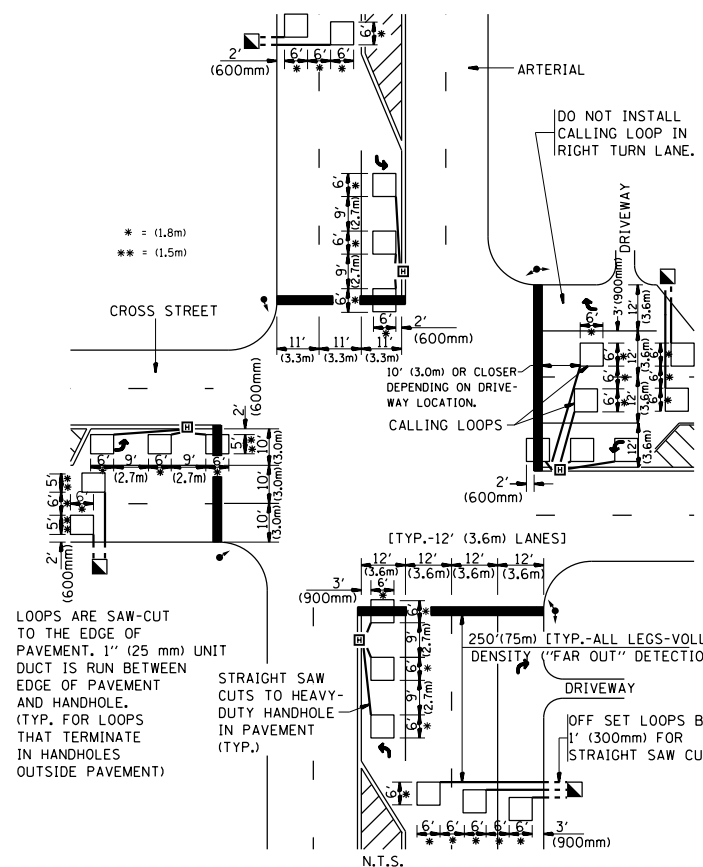

DETAIL 1  
N.T.S.

ARTERIAL-VOLUME DENSITY ("FAR OUT" DETECTION)  
CROSS STREET-NON VOLUME DENSITY ("UPTIGHT" PRESENCE DETECTION)

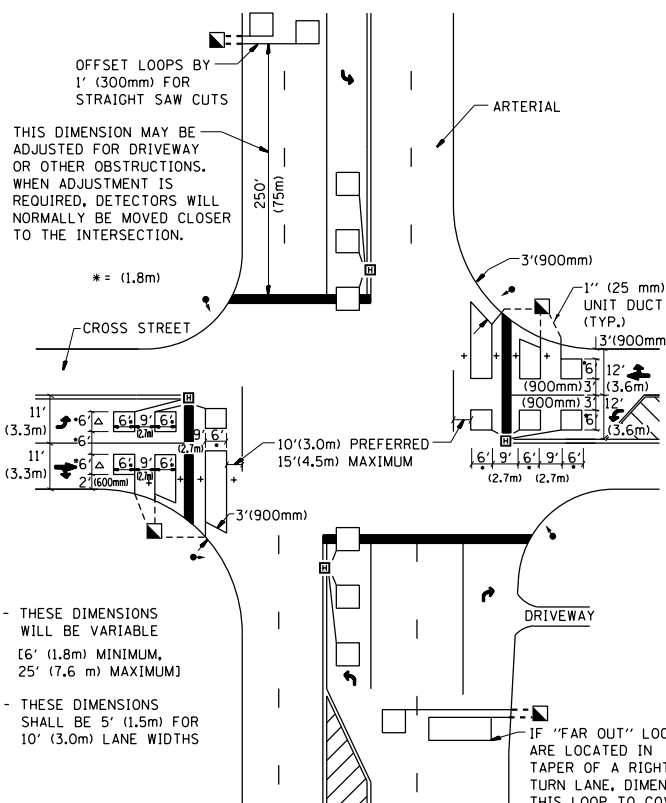

DETAIL 2  
N.T.S.

FILE NAME =	USER NAME = qureshiya	DESIGNED -	REVISED -
ca:\pwwork\pwwork\qureshiya\0283041\Dist	Std.dgn	DRAWN -	REVISED -
	PLOT SCALE = 100.0010' / 1" =	CHECKED - R.K.F.	REVISED -
	PLOT DATE = 10/26/2016	DATE -	REVISED -

STATE OF ILLINOIS  
DEPARTMENT OF TRANSPORTATION


DISTRICT 1 - DETECTOR LOOP INSTALLATION  
DETAILS FOR ROADWAY RESURFACING

SCALE: NONE SHEET NO. 1 OF 1 SHEETS STA. TO STA.

F.A.U. RTE.	SECTION	COUNTY	TOTAL SHEETS	SHEET NO.
1632	49R-R5	COOK	48	46
TS-07		CONTRACT NO. 60X38		
FED. ROAD DIST. NO. 1 ILLINOIS FED. AID PROJECT				

FINAL SURVEY	SURVEYED	BY	DATE
NOTE BOOK	PLOTTED		
AREAS CHECKED	TEMPLATE		
	AREAS CHECKED		

ORIGINAL SURVEY	SURVEYED	BY	DATE
NOTE BOOK	PLOTTED		
AREAS CHECKED	TEMPLATE		
	AREAS CHECKED		

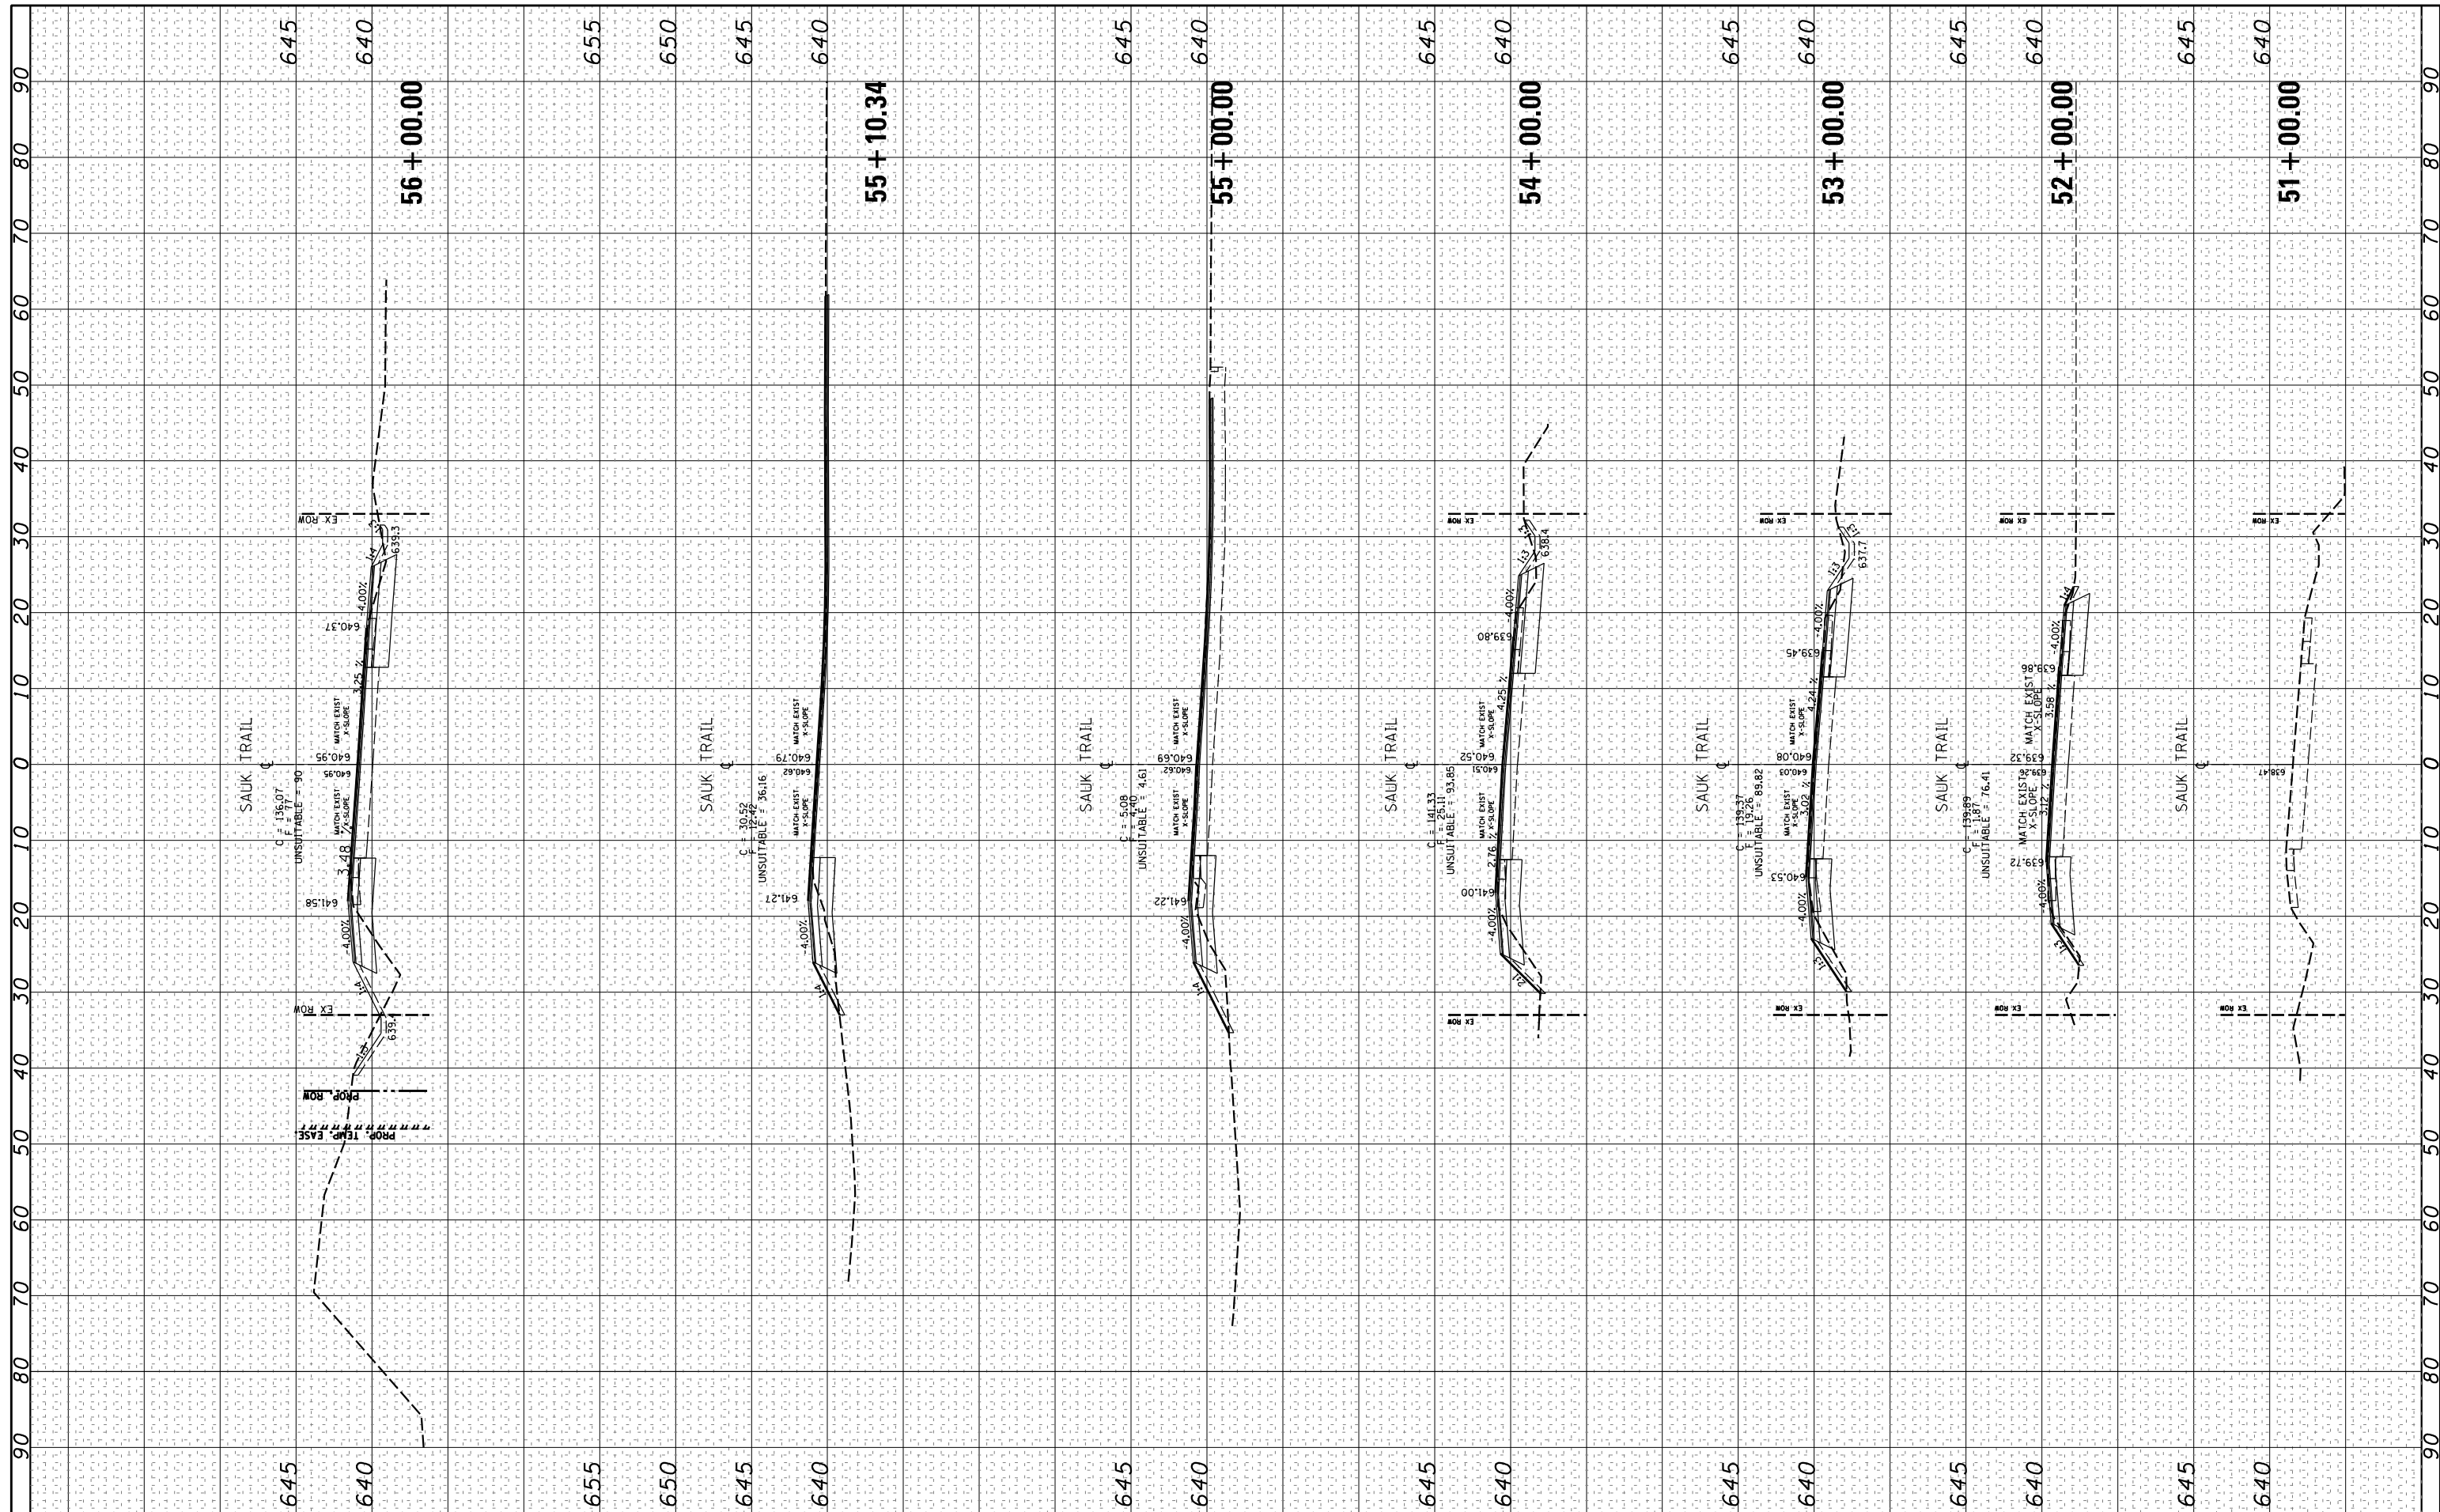


FILE NAME =	USER NAME = qureshiya	DESIGNED -	REVISED -	<b>STATE OF ILLINOIS</b> <b>DEPARTMENT OF TRANSPORTATION</b>	<b>CROSS SECTIONS</b> <b>SAUK TRAIL AT BURNHAM AVE.</b>			F.A.U. RTE.	SECTION	COUNTY	TOTAL SHEETS	SHEET NO.	
10/31/2016	10/31/2016	10/31/2016	10/31/2016		1632	49R-RS	COOK	48	47	CONTRACT NO. 60X38			
					SCALE:	SHEET	OF	SHEETS	STA. 48+00.00	TO STA. 55+00.00	ILLINOIS FED. AID PROJECT		



FINAL SURVEY	SURVEYED	DATE
NOTE BOOK	PLOTTED	
AREAS CHECKED	TEMPLATE	
	AREAS CHECKED	

ORIGINAL SURVEY	SURVEYED	DATE
NOTE BOOK	PLOTTED	
AREAS CHECKED	TEMPLATE	
	AREAS CHECKED	

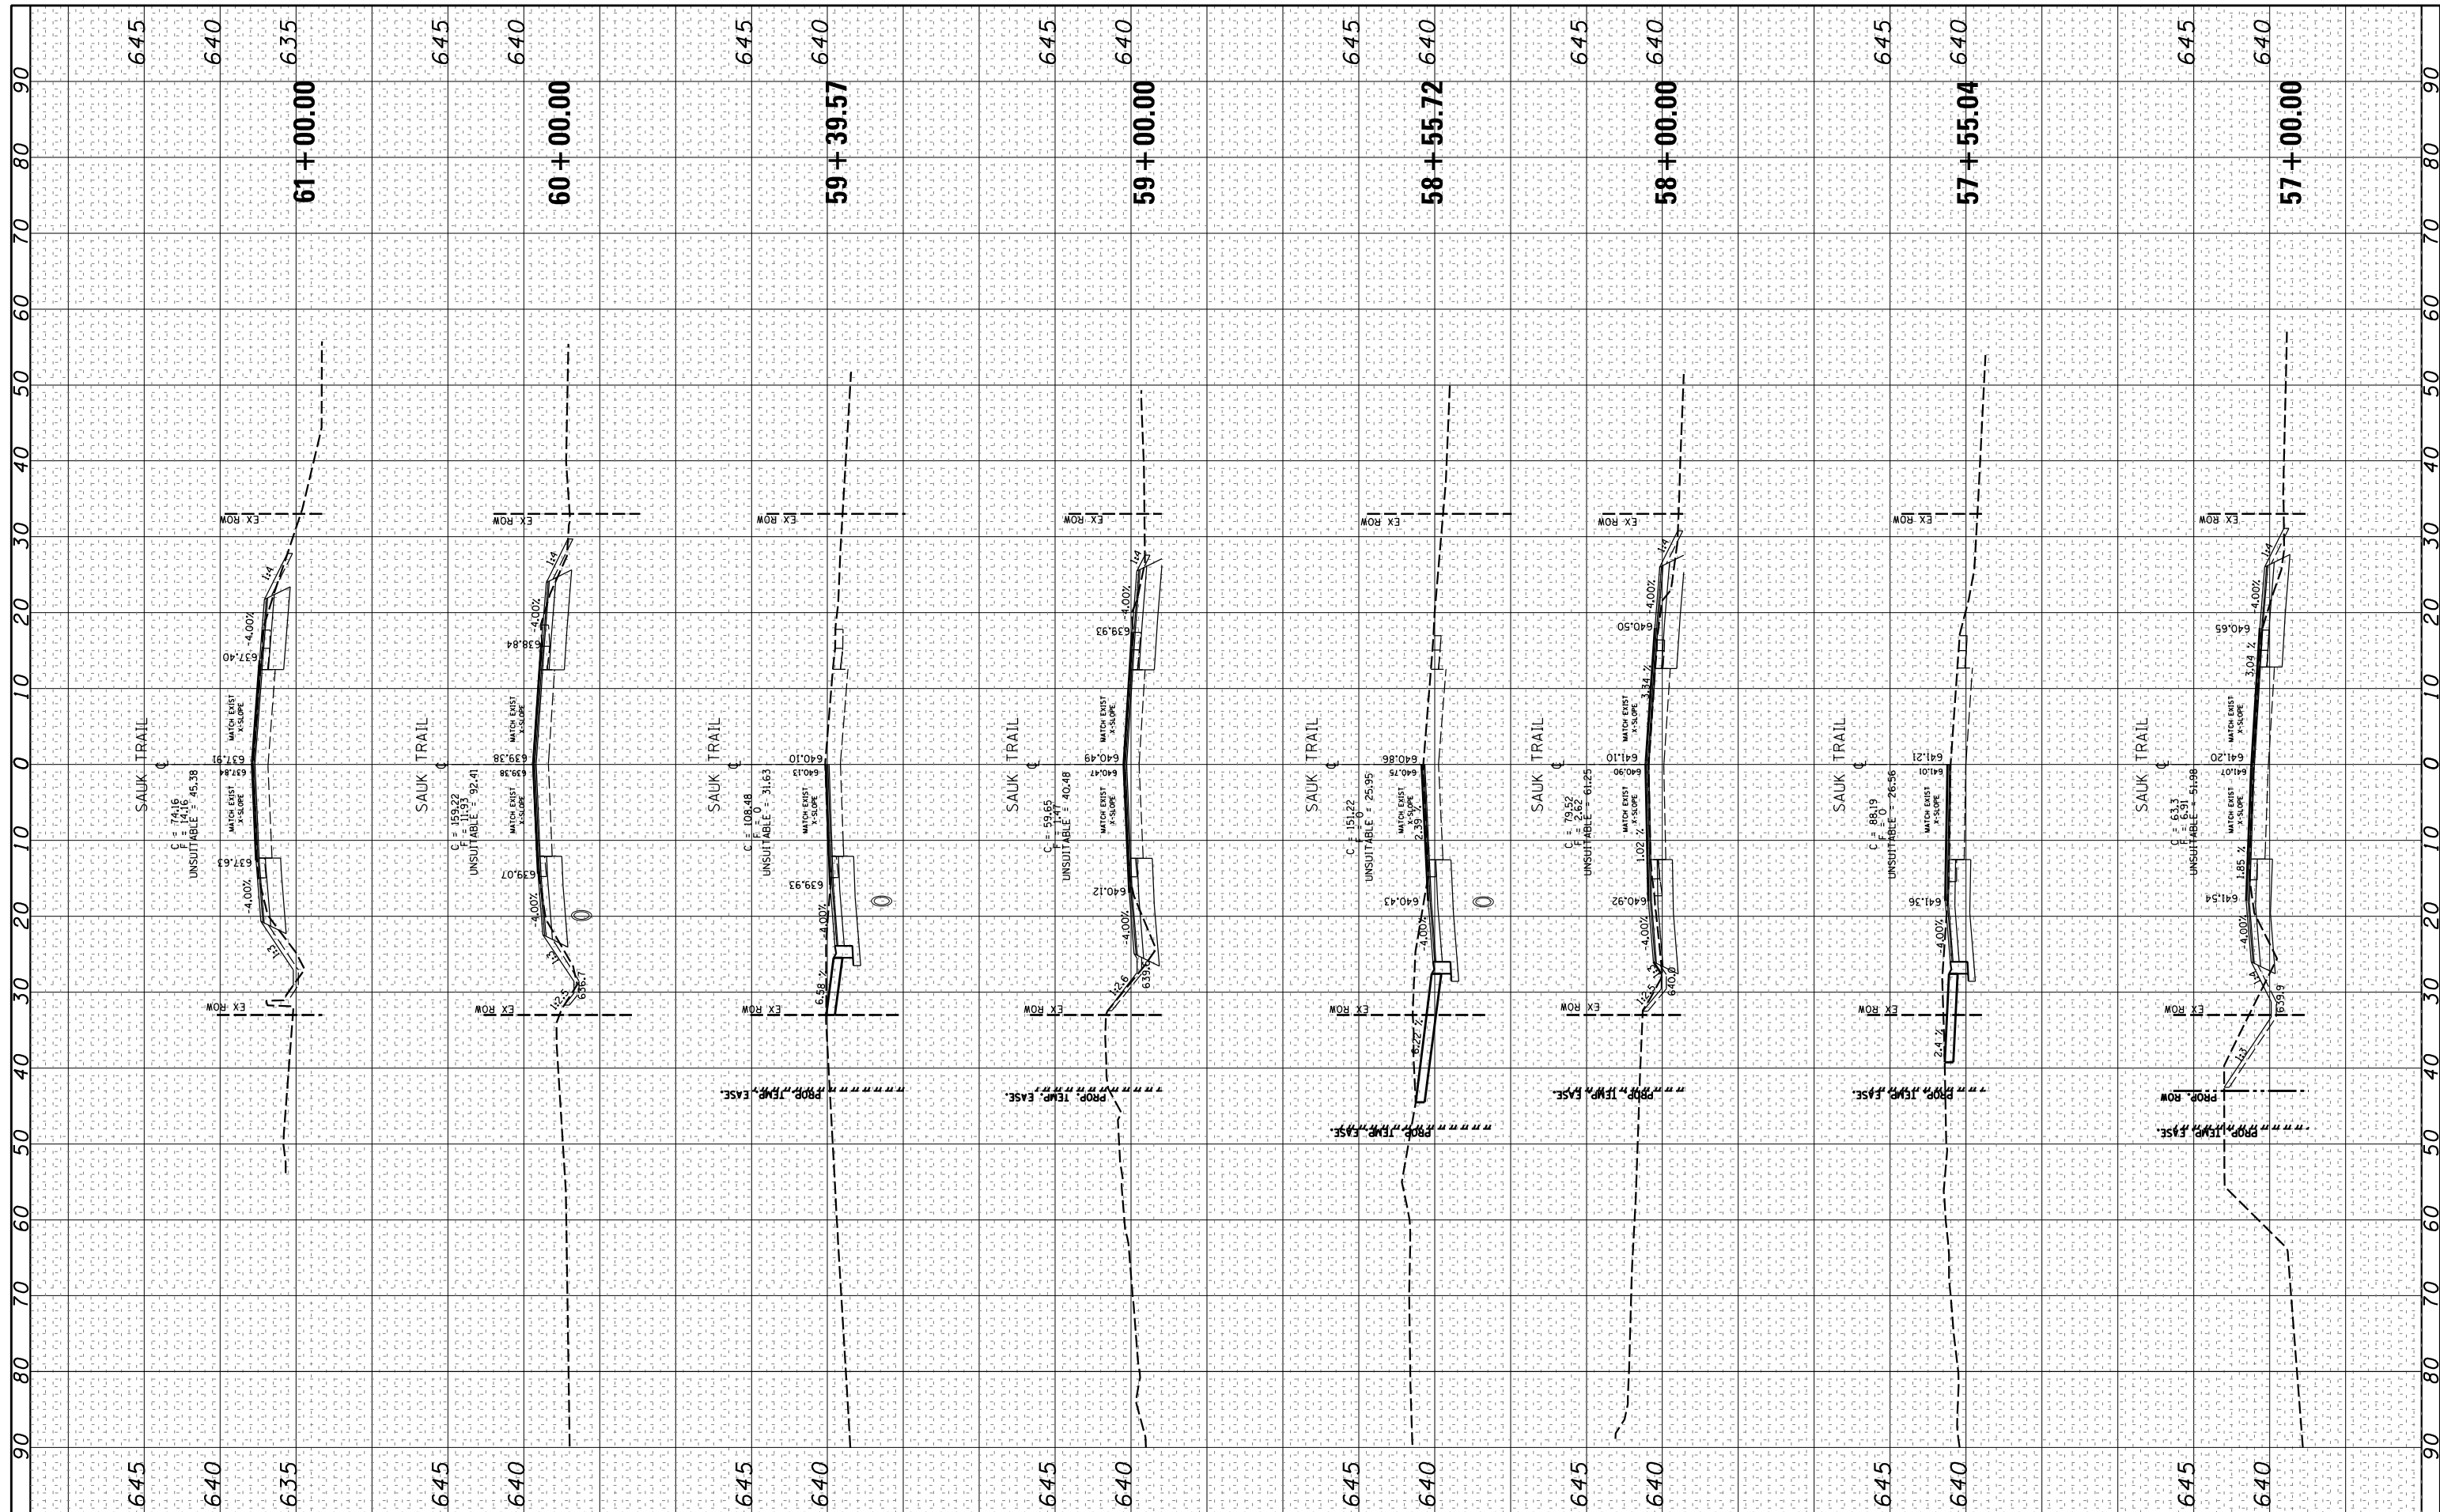

FILE NAME = P:\110012\sh-xssht-Sauk.dgn  
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 PLOT DATE = 10/31/2016

**STATE OF ILLINOIS  
 DEPARTMENT OF TRANSPORTATION**

**CROSS SECTIONS  
 SAUK TRAIL AT BURNHAM AVE.**

SCALE: SHEET OF SHEETS STA. 55+10.34 TO STA. 59+00.00

F.A.U. RTÉ.	SECTION	COUNTY	TOTAL SHEETS	SHEET NO.
1632	49R-RS	COOK	48	48
CONTRACT NO. 60X38				
ILLINOIS FED. AID PROJECT				