
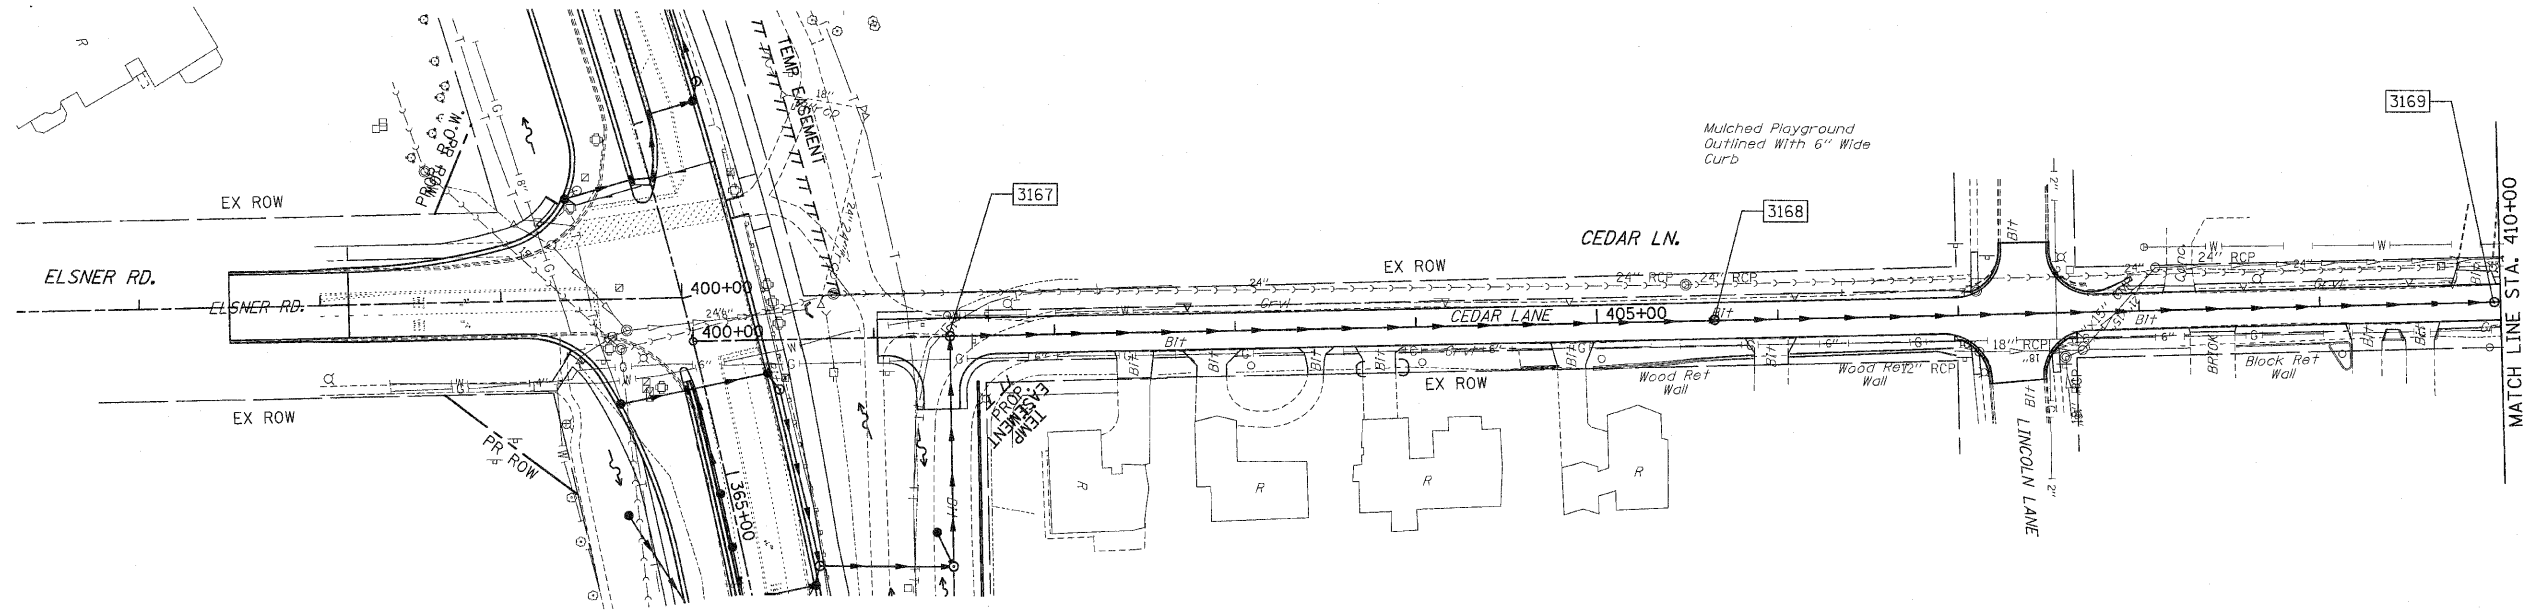


F.A.P. RTE.	SECTION	COUNTY	TOTAL SHEETS	SHEET NO.
353	(12&13)WRS-3	WILL	1235	328
STA. TO STA.				
FED. ROAD DIST. NO.		ILLINOIS	FED. AID PROJECT	

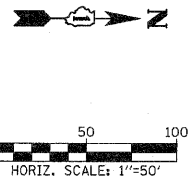

U.S. ROUTE 30

STRUCTURE TABLE

STR. #	STRUCTURE				RIM ELEV	INVERT ELEVATION				UNDER DRAIN CONNECT	STR TOP SLAB
	STATION	OFFSET	TYPE	FRAME		NORTH	EAST	SOUTH	WEST		
3167	401+42.11	0.0	MH A9	1 CL	732.43	716.06	716.05			-	TAPERED
3168	405+65.00	0.0	MH A8	1 CL	726.50	713.36	713.35			-	TAPERED
3169	409+95.00	0.0	MH A8	1 CL	720.12	704.74	710.61			-	TAPERED

PIPE TABLE

STRUCTURE	INVERT		SLOPE (FT/FT)	TYPE	STORM SEWER *		DIA (INCH)	TRENCH BACKFILL (CU YD)
	U. S.	D. S.			LENGTH (1)	LENGTH (2)		
3167	3168	716.06	713.35	0.0064	2	423	54	1131.2
3168	3169	713.36	710.61	0.0064	2	430	54	667.8
3169	3170	704.74	702.82	0.0064	2	300	54	521.7

* TOTAL LENGTH FROM STRUCTURE TO STRUCTURE = STORM SEWER LENGTH (1) + STORM SEWER (WATER MAIN REQUIREMENTS) LENGTH (2)

- NOTES:
1. FOR DRAINAGE NOTES SEE FIRST PAGE DRAINAGE AND UTILITY PLANS.

REVISIONS		ILLINOIS DEPARTMENT OF TRANSPORTATION DRAINAGE AND UTILITIES CEDAR LANE
NAME	DATE	

SCALE : 1" = 50'
DATE : / /
DRAWN BY : BAE
CHECKED BY : GB