


HIGHWAY CLASSIFICATION 01-21-2022 LETTING ITEM 010

WEIGH STATIONS DISTRICT 1

- ① I-80 TINLEY PARK WB - APPROX. MILE MARKER 143.0
- ② I-80 MOKENA EB - APPROX. MILE MARKER 148.0
- ③ I-57 PEOTONE NB - APPROX. MILE MARKER 330.0
- ④ I-57 PEOTONE SB - APPROX. MILE MARKER 330.0
- ⑤ I-55 BOLINGBROOK NB - APPROX. MILE MARKER 266.0
- ⑥ I-55 BOLINGBROOK SB - APPROX. MILE MARKER 265.0
- ⑦ US 41 ROSECRANS SB
- ⑧ US 41 WADSWORTH NB
- ⑨ US 12 RICHMOND
- ⑩ US 14 HARVARD
- ⑪ US 30 CHICAGO HEIGHTS
- ⑫ IL 83 VILLA PARK

INDEX OF SHEETS

SHEET NO.	DESCRIPTION
1	COVER PAGE
2	GENERAL NOTES, ROUTE NOTES, AND HIGHWAY STANDARDS
3	SUMMARY OF QUANTITIES
4 - 15	WEIGH STATION PLAN SHEETS
16 - 28	LANDSCAPING SHEETS
29 - 34	SITE SPECIFIC WEIGH STATION DETAILS
35 - 36	GENERAL WEIGH STATION DETAILS
37	DISTRICT 1 DETAILS

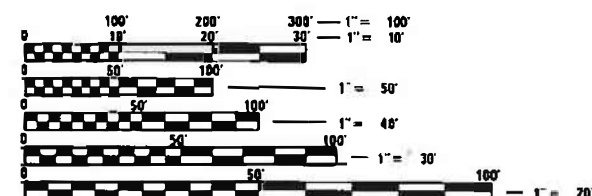

FULL SIZE PLANS HAVE BEEN PREPARED USING STANDARD ENGINEERING SCALES. REDUCED SIZED PLANS WILL NOT CONFORM TO STANDARD SCALES. IN MAKING MEASUREMENTS ON REDUCED PLANS, THE ABOVE SCALES MAY BE USED.

J.U.L.I.E.
JOINT UTILITY LOCATION INFORMATION FOR EXCAVATION
1-800-892-0123
OR 811



PROJECT MANAGER: FAWAD AQUEEL, PE, PTOE (847) 705-4247
PROJECT ENGINEER: DAN WILGREEN, PE (847) 705-4240

CONTRACT NO. 62P28

STATE OF ILLINOIS
DEPARTMENT OF TRANSPORTATION


PROPOSED
HIGHWAY PLANS

VARIOUS WEIGH STATIONS IN DISTRICT ONE
WEIGH STATION REPAIRS (PIT CLEANING)

SECTION 2021-100-I

COUNTIES: VARIOUS

NUMBER: C-91-225-21

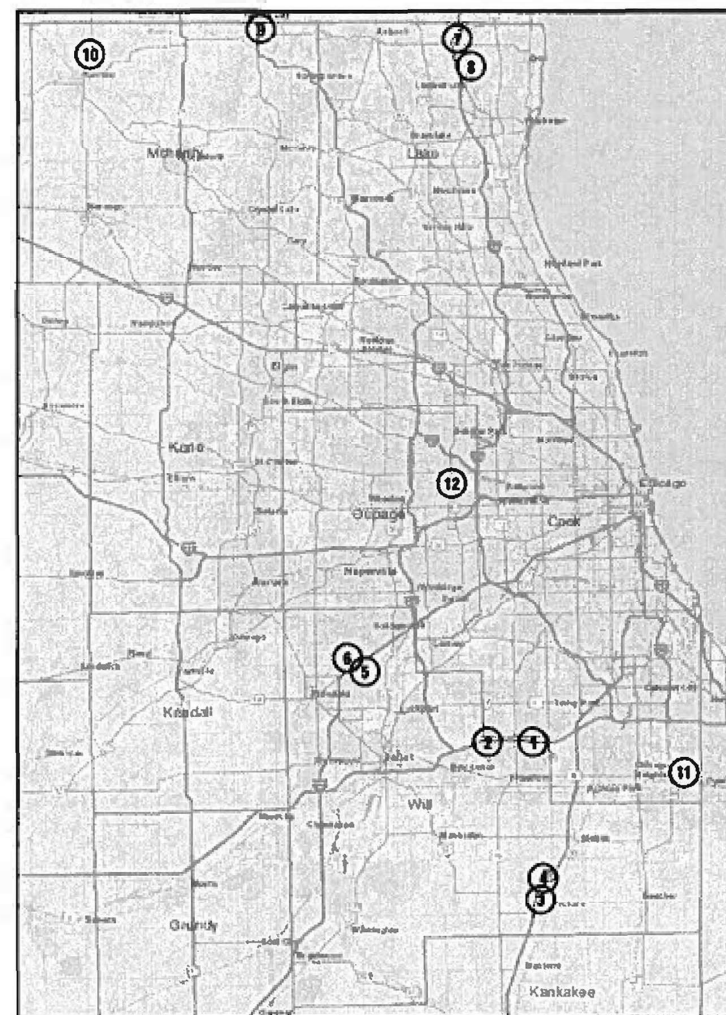

GROSS & NET LENGTH = NA (SPOT IMPROVEMENTS)

LOCATION MAP



MAIN RTE.	SECTION	COUNTY	TOTAL SHEETS	SHEET NO.
VAR.	2021-100-I	VARIOUS	37	1

ILLINOIS CONTRACT NO. 62P28



LOCATION OF SECTION INDICATED THUS: - [shaded area symbol]

STATE OF ILLINOIS
DEPARTMENT OF TRANSPORTATION

SUBMITTED October 20, 2021
[Signature] REGIONAL ENGINEER
December 10, 2021
[Signature] ENGINEER OF DESIGN AND ENVIRONMENT
December 10, 2021
[Signature] DIRECTOR OF HIGHWAYS PROJECT IMPLEMENTATION 2

PRINTED BY THE AUTHORITY
OF THE STATE OF ILLINOIS

PROFESSIONAL ENGINEER'S CERTIFICATION

I HEREBY CERTIFY THAT THIS SUBMISSION WAS PREPARED UNDER MY PERSONAL DIRECTION. THIS TECHNICAL SUBMISSION IS INTENDED TO BE USED AS AN INTEGRAL PART OF AND IN CONJUNCTION WITH THE PROJECT SPECIFICATIONS AND CONTRACT DOCUMENTS.

DATED THIS 21ST DAY OF OCTOBER, 2021

[Signature] 10/20/2021
ILLINOIS REG. PROF. ENGINEER NO. 062-059098 EXPIRATION DATE: 11/30/2021



thomas engineering group, llc
2625 butterfield rd suite
209W
Oak Brook, IL 60523
phone: 855-533-1700

HIGHWAY CLASSIFICATION

1) F.A.I. ROUTE 0080 (WB - I80)
180 TINLEY PARK WEIGH STATION - COOK COUNTY
ADT: 76000 (2020) PV: 85.53%
DESIGNATED TRUCK ROUTE SU: 3.95%
POSTED SPEED = 60 MPH MU: 10.53%

CLASSIFICATION: INTERSTATE

2) F.A.I. ROUTE 0080 (EB - I80)
180 MOKENA WEIGH STATION - COOK COUNTY
ADT: 63600 (2020) PV: 66.11%
DESIGNATED TRUCK ROUTE SU: 6.37%
POSTED SPEED = 60 MPH MU: 27.52%

CLASSIFICATION: INTERSTATE

3) F.A.I. ROUTE 0057 (SB - I57)
157 PEOTONE WEIGH STATION - WILL COUNTY
ADT: 37600 (2019) PV: 78.99%
DESIGNATED TRUCK ROUTE SU: 2.66%
POSTED SPEED = 70 MPH MU: 18.35%

CLASSIFICATION: INTERSTATE

4) F.A.I. ROUTE 0057 (NB - I57)
157 PEOTONE WEIGH STATION - WILL COUNTY
ADT: 37600 (2019) PV: 78.99%
DESIGNATED TRUCK ROUTE SU: 2.66%
POSTED SPEED = 70 MPH MU: 18.35%

CLASSIFICATION: INTERSTATE

5) F.A.I. ROUTE 0055 (NB - I55)
155 BOLINGBROOK WEIGH STATION - WILL COUNTY
ADT: 99200 (2020) PV: 84.73%
DESIGNATED TRUCK ROUTE SU: 3.58%
POSTED SPEED = 55 MPH MU: 11.69%

CLASSIFICATION: INTERSTATE

6) F.A.I. ROUTE 0055 (SB - I55)
155 BOLINGBROOK WEIGH STATION - WILL COUNTY
ADT: 99200 (2020) PV: 84.73%
DESIGNATED TRUCK ROUTE SU: 3.58%
POSTED SPEED = 55 MPH MU: 11.69%

CLASSIFICATION: INTERSTATE

7) F.A.P. ROUTE 0346 (SB - US 41)
US 41 ROSECRANS WEIGH STATION - LAKE COUNTY
ADT: 22700 (2019) PV: 90.64%
DESIGNATED TRUCK ROUTE SU: 1.87%
POSTED SPEED = 55 MPH MU: 7.49%

CLASSIFICATION: OTHER PRINCIPAL ARTERIAL

8) F.A.P. ROUTE 0346 (NB - US 41)
US 41 WADSWORTH WEIGH STATION - LAKE COUNTY
ADT: 25600 (2019) PV: 86.52%
DESIGNATED TRUCK ROUTE SU: 6.25%
POSTED SPEED = 45 MPH MU: 7.23%

CLASSIFICATION: OTHER PRINCIPAL ARTERIAL

9) F.A.P. ROUTE 0334 (US 12)
US 12 RICHMOND WEIGH STATION - MCHENRY COUNTY
ADT: 7850 (2019) PV: 94.84%
DESIGNATED TRUCK ROUTE SU: 2.42%
POSTED SPEED = 45 MPH MU: 2.74%

CLASSIFICATION: OTHER PRINCIPAL ARTERIAL

10) F.A.P. ROUTE 0066 (US 14)
US 14 HARVARD WEIGH STATION - MCHENRY COUNTY
ADT: 6650 (2019) PV: 90.23%
DESIGNATED TRUCK ROUTE SU: 5.64%
POSTED SPEED = 45 MPH MU: 4.14%

CLASSIFICATION: OTHER PRINCIPAL ARTERIAL

11) F.A.P. ROUTE 0353 (US 30)
US 30 SAUK VILLAGE WEIGH STATION - COOK COUNTY
ADT: 15600 (2020) PV: 95.19%
DESIGNATED TRUCK ROUTE SU: 1.76%
POSTED SPEED = 45 MPH MU: 3.04%

CLASSIFICATION: OTHER PRINCIPAL ARTERIAL

12) F.A.P. ROUTE 0344 (IL 83)
IL 83 ELMHURST WEIGH STATION - DUPAGE COUNTY
ADT: 60500 (2019) PV: 93.14%
DESIGNATED TRUCK ROUTE SU: 2.98%
POSTED SPEED = 45 MPH MU: 3.88%

CLASSIFICATION: OTHER PRINCIPAL ARTERIAL

GENERAL NOTES

- ONE WEEK PRIOR TO BEGINNING WORK AT THE WEIGH STATIONS, PLEASE CONTACT KEITH DONOVAN AT KEITH.DONOVAN@ILLINOIS.GOV OR (217)-299-0934.
- TWENTY FOUR (24) HOURS PRIOR TO SCALES BEING SHUT DOWN, CONTACT ILLINOIS STATE POLICE (ISP) SUPERVISOR IN CHARGE MASTER SARGENT GEORGE DELRIO AT GEORGE.DELRIO@ILLINOIS.GOV OR (815)-726-6377.
- BARRICADES: THE CONTRACTOR SHALL PROVIDE AND INSTALL TWO (2) WEIGHTED SAND BAGS ON EACH TYPE I OR TYPE II BARRICADE. USE ONE (1) WEIGHTED SAND BAG ACROSS EACH BOTTOM RAIL.
- THE CONTRACTOR MUST EXERCISE EXTREME CAUTION WORKING AROUND EXISTING UTILITIES. THE CONTRACTOR SHALL NOTIFY JULIE (800)-892-0123, A MINIMUM OF 48 HOURS BEFORE COMMENCING CONSTRUCTION FOR UTILITY LOCATIONS WITHIN THE SCOPE OF THE PROJECT. IT IS RECOMMENDED THAT THE CONTRACTOR CONDUCT A JOINT UTILITY MEET. IT IS THE RESPONSIBILITY OF THE CONTRACTOR TO CONTACT ALL AGENCIES WHO MAY OR MAY NOT BE PART OF THE JULIE SYSTEM TO VERIFY THE LOCATION OF THEIR FACILITIES.
- THE CONTRACTOR SHALL CONTACT THE BUREAU OF ELECTRICAL OPERATIONS FIELD OFFICE (630)-860-3670. TO COORDINATE CABLE LOCATES.
- THE CONTRACTOR SHALL BE RESPONSIBLE FOR THE PROTECTION OF ALL UNDERGROUND AND SURFACE UTILITIES EVEN THOUGH THEY MIGHT NOT BE SHOWN IN THE PLANS. ANY UTILITY PROPERTY DAMAGED DURING CONSTRUCTION SHALL BE REPAIRED OR REPLACED TO THE SATISFACTION OF THE ENGINEER.
- THE CONTRACTOR SHALL USE CARE IN REMOVING OR EXCAVATING NEAR ALL EXISTING ITEMS WHICH WILL REMAIN. ANY DAMAGE DONE TO EXISTING ITEMS BY THE CONTRACTOR SHALL BE REPAIRED AT THE CONTRACTOR'S EXPENSE TO THE SATISFACTION OF THE ENGINEER.
- THE CONTRACTOR SHALL CONTACT THE DISTRICT ONE TRAFFIC CONTROL SUPERVISOR AT (847)-705-4470 OR KALPANA KANNAN-HOSADURGA@ILLINOIS.GOV A MINIMUM OF 72 HOURS IN ADVANCE OF BEGINNING WORK AND A MINIMUM OF 72 HOURS PRIOR TO THE INSTALLATION OF ANY TEMPORARY TRAFFIC CONTROL DEVICES.
- UNLESS OTHER CONDITIONS WARRANT EXTENDED LANE CLOSURE AS DETERMINED AND APPROVED IN WRITING BY THE ENGINEER OR AS PROVIDED FOR IN THE CONTRACT SPECIFICATIONS, OVERNIGHT CLOSURES SHALL NOT BE ALLOWED.


HIGHWAY STANDARDS

00001-08 STANDARD SYMBOLS, ABBREVIATIONS, AND PATTERNS
701106-02 OFF-ROAD OPERATIONS, MULTILANE, MORE THAN 15' (4.5M) AWAY
701451-05 RAMP CLOSURE FREEWAY / EXPRESSWAY
701901-08 TRAFFIC CONTROL DEVICES

DISTRICT 1 DETAILS

TC-08 ENTRANCE AND EXIT RAMP CLOSURE DETAIL

MODEL: D:\p\h\l\19-012 DOT Phase II Sub Vpr-Vpr01 Weigh Station RR Cleaning\05_CADD\02_CADD_Sheets\B_Gen_Notes.dgn
FILE NAME: T:\projects\19-012 DOT Phase II Sub Vpr-Vpr01 Weigh Station RR Cleaning\05_CADD\02_CADD_Sheets\B_Gen_Notes.dgn

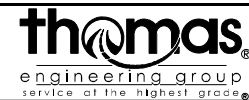

USER NAME = maciej	DESIGNED - MIK	REVISED -
	DRAWN - FS	REVISED -
PLOT SCALE = 2,0000 ' / in.	CHECKED - CC	REVISED -
PLOT DATE = 10/21/2021	DATE -	REVISED -

STATE OF ILLINOIS
DEPARTMENT OF TRANSPORTATION


GENERAL NOTES – HIGHWAY CLASSIFICATION

SCALE: N.T.S. SHEET OF SHEETS STA. TO STA.

F.A.I./P.RTE.	SECTION	COUNTY	TOTAL SHEETS	SHEET NO.
VAR.	2021-100-I	VARIOUS	37	2
			CONTRACT NO. 62P28	
ILLINOIS FED. AID PROJECT				

SPECIALTY ITEM	CODE NO.	ITEM	UNIT	URBAN TOTAL QTY.	CONSTR.											
					COOK	COOK	WILL	WILL	WILL	WILL	LAKE	LAKE	MCHENRY	MCHENRY	COOK	DUPAGE
					I-80 WB	I-80 EB	I-57 NB	I-57 SB	I-55 NB	I-55 SB	US 41 SB	US 41 NB	US 12	US 14	US 30	IL 83
					100% State	100% State	100% State	100% State	100% State	100% State	100% State	100% State	100% State	100% State	100% State	100% State
	20100110	TREE REMOVAL (6 TO 15 UNITS DIAMETER)	UNIT	82.7	0	31.2	0	0	0	51.5	0	0	0	0	0	0
	20101300	TREE PRUNING (1 TO 10 INCH DIAMETER)	EACH	5	0	0	0	0	0	0	0	1	0	4	0	0
	20101350	TREE PRUNING (OVER 10 INCH DIAMETER)	EACH	38	14	20	0	0	0	0	1	2	0	0	0	1
	25003210	INTERSEEDING, CLASS 2A	ACRE	1.46	0	0.77	0	0	0.69	0	0	0	0	0	0	0
	67000400	ENGINEER'S FIELD OFFICE TYPE A	CAL MO.	12	1	1	1	1	1	1	1	1	1	1	1	1
	67100100	MOBILIZATION	L SUM	1	0.09	0.09	0.09	0.09	0.08	0.08	0.08	0.08	0.08	0.08	0.08	0.08
*	66900200	NON-SPECIAL WASTE DISPOSAL	CU YD	27.60	3.57	3.57	3.57	3.57	3.57	3.57	2.47	2.47	0.31	0.31	0.31	0.31
*	66900530	SOIL DISPOSAL ANALYSIS	EACH	12	1	1	1	1	1	1	1	1	1	1	1	1
*	66901001	REGULATED SUBSTANCES PRE-CONSTRUCTION PLAN	L SUM	1	0.09	0.09	0.09	0.09	0.08	0.08	0.08	0.08	0.08	0.08	0.08	0.08
*	66901003	REGULATED SUBSTANCES FINAL CONSTRUCTION REPORT	L SUM	1	0.09	0.09	0.09	0.09	0.08	0.08	0.08	0.08	0.08	0.08	0.08	0.08
*	66901006	REGULATED SUBSTANCES MONITORING	CAL DA	24.00	2	2	2	2	2	2	2	2	2	2	2	2
	K0029614	WEED CONTROL, AQUATIC	GALLON	2.8	0.9	0.3	0.1	0.0	0.5	0.8	0.1	0.1	0.0	0.0	0.0	0.0
	K0029624	WEED CONTROL, TEASEL	GALLON	3.1	0.9	0.8	0.2	0.4	0.5	0.0	0.1	0.0	0.0	0.1	0.0	0.1
	X2010350	TREE REMOVAL, ACRES (SPECIAL)	ACRE	1.46	0.00	0.77	0.00	0.00	0.69	0.00	0.00	0.00	0.00	0.00	0.00	0.00
	X2010400	STUMP REMOVAL ONLY	UNIT	34	0.00	0.00	0.00	0.00	0.00	0.00	0.00	0.00	0.00	0.00	0.00	34.00
	X2503318	INTERSEEDING, CLASS 4B (MODIFIED)	ACRE	2.56	1.05	0.15	0.00	0.00	0.00	1.36	0.00	0.00	0.00	0.00	0.00	0.00
	X0320094	SCALE PIT CLEANING	EACH	12	1.00	1.00	1.00	1.00	1.00	1.00	1.00	1.00	1.00	1.00	1.00	1.00
	X7010216	TRAFFIC CONTROL AND PROTECTION, (SPECIAL)	L SUM	1	0.00	0.00	0.00	0.00	0.00	0.00	0.16	0.16	0.17	0.17	0.17	0.17
	X7011015	TRAFFIC CONTROL AND PROTECTION (EXPRESSWAYS)	L SUM	1	0.16	0.16	0.17	0.17	0.17	0.17	0.00	0.00	0.00	0.00	0.00	0.00
	Z0030850	TEMPORARY INFORMATION SIGNING	SQ FT	480	40.00	40.00	40.00	40.00	40.00	40.00	40.00	40.00	40.00	40.00	40.00	40.00
	Z0064800	SELECTIVE CLEARING	UNIT	155.45	0	60.98	0	0	14.45	45.82	0	1.09	0.41	5.3	0	27.4

MODEL: D:\proj\19-013\DOT\Phase II Sub\X20104001\Wdrsh_Schedule_CADD\03_CADD_Schedule_000.dwg
 FILE NAME: 19-013\DOT\Phase II Sub\X20104001\Wdrsh_Schedule_CADD\03_CADD_Schedule_000.dwg

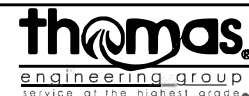

USER NAME = maciejk
 DESIGNED = MJK
 DRAWN = FS
 CHECKED = CC
 DATE = 10/28/2021
 PLOT SCALE = 2.0000' / 1"



REVISED =
 REVISED =
 REVISED =
 REVISED =

**STATE OF ILLINOIS
DEPARTMENT OF TRANSPORTATION**

SUMMARY OF QUANTITIES


SCALE: N.T.S. SHEET 0F SHEETS STA. TO STA.

F.A.I.P. RTE.	SECTION	COUNTY	TOTAL SHEETS	SHEET NO.
VAR.	2021-100-I	VARIOUS	37	3
ILLINOIS FED. AID PROJECT			CONTRACT NO. 62P28	

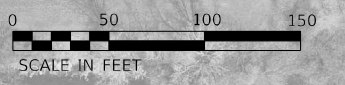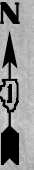

LEGEND	
	EX ROW

MODEL: Default
 FILE NAME: I:\Projects\19-012 IDOT Phase II Sub Vix-Vir01 Weigh Station PR Cleaninc05 CADD02_CADD_Sheet01_L80 WB Tinley Park.dwg

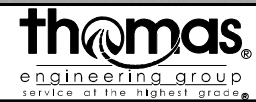

USER NAME = maciejk	DESIGNED - MIK	REVISED -
PLOT SCALE = 100,0000' / in.	DRAWN - FS	REVISED -
PLOT DATE = 10/21/2021	CHECKED - CC	REVISED -
	DATE -	REVISED -

STATE OF ILLINOIS
DEPARTMENT OF TRANSPORTATION

I-80 WB WEIGH STATION, TINLEY PARK
PLAN SHEET

SCALE: 1"=50' SHEET OF SHEETS STA. TO STA.

F.A.I. RTE.	SECTION	COUNTY	TOTAL SHEETS	SHEET NO.
80	2021-100-I	VARIOUS	37	4
			CONTRACT NO. 62P28	
ILLINOIS FED. AID PROJECT				

MODEL: Default
 FILE NAME: I:\Projects\19-012 IDOT Phase II Sub-Via-Via\01 Weigh Station Rtr Clean\05_CADD\02_Sheet\01_L80 EB Weigh.dwg



LEGEND	
	EX ROW




USER NAME = maciej	DESIGNED - MIK	REVISED -
PLOT SCALE = 100,000' / in.	DRAWN - FS	REVISED -
PLOT DATE = 10/21/2021	CHECKED - CC	REVISED -
	DATE -	REVISED -

STATE OF ILLINOIS
DEPARTMENT OF TRANSPORTATION

I-80 EB WEIGH STATION, TINLEY PARK
PLAN SHEET

SCALE: 1"=50' SHEET OF SHEETS STA. TO STA.

F.A.I. RTE.	SECTION	COUNTY	TOTAL SHEETS	SHEET NO.
80	2021-100-I	VARIOUS	37	5
CONTRACT NO. 62P28				
ILLINOIS FED. AID PROJECT				

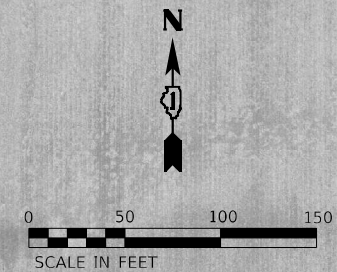

LEGEND	
	EX ROW

MODEL: Default
 FILE NAME: T:\projects\19-012 DOT Phase II Sub-Via-Via\01 Weigh Station Rtr Clean\05 CADD\02_CADD_Sheet\01_157_NB_Peotone.dwg




USER NAME = maciejk	DESIGNED - MIK	REVISED -
PLOT SCALE = 100,0000 ' / in.	DRAWN - FS	REVISED -
PLOT DATE = 10/21/2021	CHECKED - CC	REVISED -
	DATE -	REVISED -

STATE OF ILLINOIS
DEPARTMENT OF TRANSPORTATION

I-57 NB WEIGH STATION, PEOTONE
PLAN SHEET

SCALE: 1"=50'	SHEET	OF	SHEETS	STA.	TO	STA.
---------------	-------	----	--------	------	----	------

F.A.I. RTE.	SECTION	COUNTY	TOTAL SHEETS	SHEET NO.
57	2021-100-I	VARIOUS	37	6
CONTRACT NO. 62P28			ILLINOIS FED. AID PROJECT	

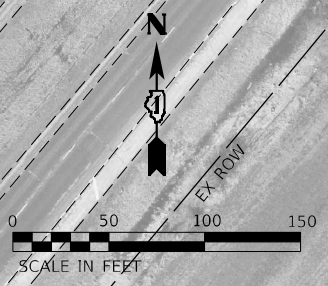

LEGEND	
	EX ROW



MODEL: Default
 FILE NAME: I:\Projects\19-012 DOT Phase II Sub-Via-Var\01 Weigh Station Rtr Cleaning\05 CADD\02_CADD_Sheet\01-D1.62228-214-04-157_SB_Peotone.dwg



USER NAME = maciej	DESIGNED - MIK	REVISED -
PLOT SCALE = 100,0000' / in.	DRAWN - FS	REVISED -
PLOT DATE = 10/21/2021	CHECKED - CC	REVISED -
	DATE -	REVISED -

DESIGNED - MIK	REVISED -
DRAWN - FS	REVISED -
CHECKED - CC	REVISED -
DATE -	REVISED -

STATE OF ILLINOIS
DEPARTMENT OF TRANSPORTATION

I-57 SB WEIGH STATION, PEOTONE
PLAN SHEET

SCALE: 1"=50' SHEET OF SHEETS STA. TO STA.

F.A.I. RTE.	SECTION	COUNTY	TOTAL SHEETS	SHEET NO.
57	2021-100-I	VARIOUS	37	7
CONTRACT NO. 62P28				
ILLINOIS FED. AID PROJECT				

MODEL: Default
 FILE NAME: I:\projects\19-012 DOT Phase II Sub Use\Var01 Weigh Station RIR Clean\05_CADD\Sheet\05_L55 NB Bolingbrook.dwg
 PROJECT: 19-012 DOT Phase II Sub Use\Var01 Weigh Station RIR Clean\05_CADD\Sheet\05_L55 NB Bolingbrook.dwg



IMAGES FOR INFORMATIONAL PURPOSES ONLY

PIT ACCESS FIELD DIMENSIONS:
 STAIRWELL WIDTH = 32"
 STAIRWELL HEIGHT = 77"
 HEIGHT INSIDE THE SCALE = 56"
 LOWEST CLEARANCE = 54"

LEGEND
 - - - - - EX ROW



USER NAME = maciej	DESIGNED - MIK	REVISED -
	DRAWN - FS	REVISED -
PLOT SCALE = 100,0000' / in.	CHECKED - CC	REVISED -
PLOT DATE = 10/21/2021	DATE -	REVISED -

**STATE OF ILLINOIS
 DEPARTMENT OF TRANSPORTATION**

**I-55 NB WEIGH STATION, BOLINGBROOK
 PLAN SHEET**

SCALE: 1"=50' SHEET OF SHEETS STA. TO STA.

F.A.I. RTE.	SECTION	COUNTY	TOTAL SHEETS	SHEET NO.
55	2021-100-I	VARIOUS	37	8
CONTRACT NO. 62P28				
ILLINOIS FED. AID PROJECT				

MODEL: Default
 FILE NAME: I:\Projects\19-012 IDOT Phase II Sub-Via-Via\01 Weigh Station Rtr Clean\05 CADD\02_CADD_Sheet\05_L55 SB Bolingbrook.dgn



LEGEND	
	EX ROW



USER NAME = maciej	DESIGNED - MIK	REVISED -
PLOT SCALE = 100,0000' / in.	DRAWN - FS	REVISED -
PLOT DATE = 10/21/2021	CHECKED - CC	REVISED -
	DATE -	REVISED -


DESIGNED - MIK	REVISED -
DRAWN - FS	REVISED -
CHECKED - CC	REVISED -
DATE -	REVISED -

STATE OF ILLINOIS
DEPARTMENT OF TRANSPORTATION

I-55 SB WEIGH STATION, BOLINGBROOK
PLAN SHEET

SCALE: 1"=50' SHEET OF SHEETS STA. TO STA.

F.A.I. RTE.	SECTION	COUNTY	TOTAL SHEETS	SHEET NO.
55	2021-100-I	VARIOUS	37	9
CONTRACT NO. 62P28				
ILLINOIS FED. AID PROJECT				

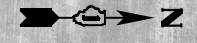

MODEL: Default
FILE NAME: I:\projects\19-012 IDOT Phase II Sub-Variation 11 Weigh Station RR Clearing\05_CADD\02_CADD_Sheet\01_US 41 SB Rosecrans.dgn



LEGEND

—— EX ROW



USER NAME = maciejk	DESIGNED - MIK	REVISED -
PLOT SCALE = 100,0000' / in.	DRAWN - FS	REVISED -
PLOT DATE = 10/21/2021	CHECKED - CC	REVISED -
	DATE -	REVISED -

**STATE OF ILLINOIS
DEPARTMENT OF TRANSPORTATION**

**US 41 SB WEIGH STATION, ROSECRANS
PLAN SHEET**

F.A.P. RTE. 0346	SECTION 2021-100-I	COUNTY VARIOUS	TOTAL SHEETS 37	SHEET NO. 10
			CONTRACT NO. 62P28	
ILLINOIS FED. AID PROJECT				

SCALE: 1"=50' SHEET OF SHEETS STA. TO STA.



LEGEND	
	EX ROW

MODEL: D:\p01\19-012 DOT Phase II Sub-VAR\01 Weigh Station FR Clean\05 CADD\02_CADD_Sheet\01_19-012-NB-WeighStation.dwg
 FILE NAME: T:\projects\19-012 DOT Phase II Sub-VAR\01 Weigh Station FR Clean\05 CADD\02_CADD_Sheet\01_19-012-NB-WeighStation.dwg



USER NAME = maciejk	DESIGNED - MIK	REVISED -
	DRAWN - FS	REVISED -
PLOT SCALE = 100,0000' / in.	CHECKED - CC	REVISED -
PLOT DATE = 10/21/2021	DATE -	REVISED -

STATE OF ILLINOIS
DEPARTMENT OF TRANSPORTATION

US 41 NB WEIGH STATION, WADSWORTH
PLAN SHEET

SCALE: 1"=50' SHEET OF SHEETS STA. TO STA.

F.A.P. RTE.	SECTION	COUNTY	TOTAL SHEETS	SHEET NO.
0346	2021-100-I	VARIOUS	37	11
CONTRACT NO. 62P28				
ILLINOIS FED. AID PROJECT				



LEGEND	
	EX ROW

MODEL: Default
 FILE NAME: T:\Projects\19-012 IDOT Phase II Sub-Via-Via01 Weigh Station RR Cleaninc05_CADD02_CADD_Sheet01.Dwg 12 Richmond.dwg



USER NAME = maciej	DESIGNED - MIK	REVISED -
PLOT SCALE = 100,000' / in.	DRAWN - FS	REVISED -
PLOT DATE = 10/21/2021	CHECKED - CC	REVISED -
	DATE -	REVISED -

STATE OF ILLINOIS
DEPARTMENT OF TRANSPORTATION

US 12 WEIGH STATION, RICHMOND			
PLAN SHEET			
SCALE: 1"=50'	SHEET	OF SHEETS	STA. TO STA.

F.A.P. RTE.	SECTION	COUNTY	TOTAL SHEETS	SHEET NO.
0334	2021-100-I	VARIOUS	37	12
CONTRACT NO. 62P28				
ILLINOIS FED. AID PROJECT				



LEGEND	
	EX ROW

MODEL: Default
 FILE NAME: I:\projects\19-012 DOT Phase II Sub-Via-Var01 Weigh Station PK Cleanup\05_CADD\02_CADD_Sheet\010_US_14_Weigh.dgn



USER NAME = maciejk	DESIGNED - MIK	REVISED -
	DRAWN - FS	REVISED -
PLOT SCALE = 100,0000' / in.	CHECKED - CC	REVISED -
PLOT DATE = 10/21/2021	DATE -	REVISED -

STATE OF ILLINOIS
DEPARTMENT OF TRANSPORTATION

US 14 WEIGH STATION, HARVARD			
PLAN SHEET			
SCALE: 1"=50'	SHEET	OF	SHEETS
	STA.		TO STA.

F.A.P. RTE.	SECTION	COUNTY	TOTAL SHEETS	SHEET NO.
0066	2021-100-I	VARIOUS	37	13
CONTRACT NO. 62P28				
ILLINOIS FED. AID PROJECT				



MODEL: Default
 FILE NAME: I:\projects\19-012 DOT Phase II Sub Vdr-Vdr01 Weigh Station Rtr Clean05 CAD002_CADD_Sheet01.dwg
 PROJECT: 19-012 DOT Phase II Sub Vdr-Vdr01 Weigh Station Rtr Clean05 CAD002_CADD_Sheet01.dwg

LEGEND

—— EX ROW



USER NAME = maciejk	DESIGNED - MIK	REVISED -
PLOT SCALE = 100,0000' / in.	DRAWN - FS	REVISED -
PLOT DATE = 10/21/2021	CHECKED - CC	REVISED -
	DATE -	REVISED -

**STATE OF ILLINOIS
DEPARTMENT OF TRANSPORTATION**

**US 30 WEIGH STATION, SAUK VILLAGE
PLAN SHEET**

SCALE: 1"=50' SHEET OF SHEETS STA. TO STA.

F.A.P. RTE. 0353	SECTION 2021-100-I	COUNTY VARIOUS	TOTAL SHEETS 37	SHEET NO. 14
CONTRACT NO. 62P28				
ILLINOIS FED. AID PROJECT				

MODEL: Default
 FILE NAME: I:\Projects\19-012 DOT Phase II Sub Vix-Vic01 Weigh Station RR Cleaninc05_CADD02_CADD_Sheet02.Dwg
 11/12/2021 11:12:12 AM

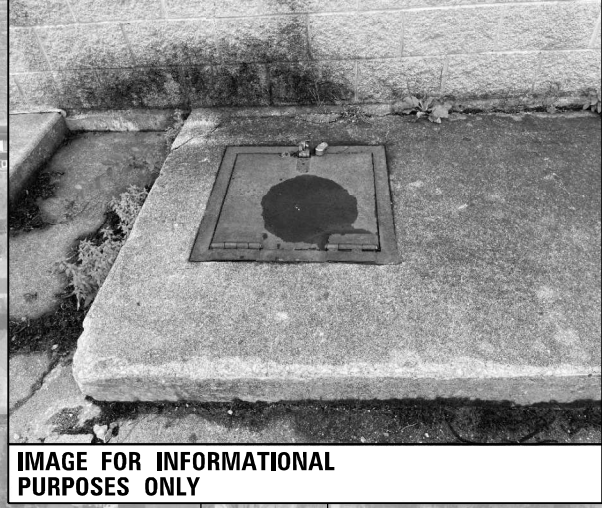


IMAGE FOR INFORMATIONAL PURPOSES ONLY

EXIST SCALE (10' x 10')

PIT ACCESS

PIT ACCESS FIELD DIMENSIONS:
 PIT ACCESS = 22" X 22"

LEGEND
 ——— EX ROW



USER NAME = maciej
 PLOT SCALE = 100,0000' / in.
 PLOT DATE = 10/21/2021

DESIGNED - MIK
 DRAWN - FS
 CHECKED - CC
 DATE -

REVISED -
 REVISED -
 REVISED -
 REVISED -







**STATE OF ILLINOIS
 DEPARTMENT OF TRANSPORTATION**

**IL 83 WEIGH STATION, ELMHURST
 PLAN SHEET**

SCALE: 1"=50' SHEET OF SHEETS STA. TO STA.

F.A.P. RTE.	SECTION	COUNTY	TOTAL SHEETS	SHEET NO.
0344	2021-100-I	VARIOUS	37	15
CONTRACT NO. 62P28				
ILLINOIS FED. AID PROJECT				

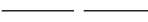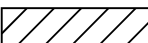

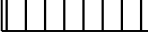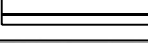LEGEND	
	EX ROW
	WEED CONTROL TEASEL
	WEED CONTROL AQUATIC
	WEED CONTROL TEASEL AND AQUATIC
	SELECTIVE CLEARING
	TREE REMOVAL ACRES (SPECIAL)

MODEL: D:\p\1\19-012 IDOT Phase II Sub Vax-Vax01 Weigh Station RR Clearing05 CADD02_CADD_Sheet05_Landscaping_dwg01 I-80 WB Tinley Park.dwg
 FILE NAME: T:\p\1\19-012 IDOT Phase II Sub Vax-Vax01 Weigh Station RR Clearing05 CADD02_CADD_Sheet05_Landscaping_dwg01 I-80 WB Tinley Park.dwg




USER NAME = maciejk	DESIGNED - MIK	REVISED -
PLOT SCALE = 100,0000' / in.	DRAWN - FS	REVISED -
PLOT DATE = 10/21/2021	CHECKED - CC	REVISED -
	DATE -	REVISED -

STATE OF ILLINOIS
DEPARTMENT OF TRANSPORTATION

I-80 WB WEIGH STATION, TINLEY PARK
LANDSCAPING PLAN SHEETS

SCALE: 1"=50' SHEET OF SHEETS STA. TO STA.

F.A.I. RTE.	SECTION	COUNTY	TOTAL SHEETS	SHEET NO.
80	2021-100-I	VARIOUS	37	16
			CONTRACT NO. 62P28	
ILLINOIS FED. AID PROJECT				

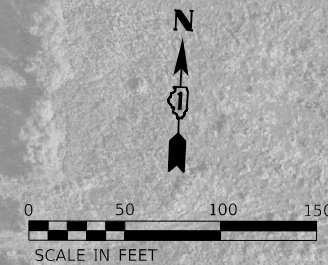

LEGEND

	EX ROW
	WEED CONTROL TEASEL
	WEED CONTROL AQUATIC
	WEED CONTROL TEASEL AND AQUATIC
	SELECTIVE CLEARING
	TREE REMOVAL ACRES (SPECIAL)

MODEL: Default
 FILE NAME: I:\Projects\19-012 DOT Phase II Sub Vpr-Vpr01 Weigh Station RR Clearing\05_CADD\02_CADD_Sheets\15_Landscaping\15-02_EB_WeighStation.dwg




USER NAME = maciejk	DESIGNED - MIK	REVISED -
PLOT SCALE = 100,0000' / in.	DRAWN - FS	REVISED -
PLOT DATE = 10/21/2021	CHECKED - CC	REVISED -
	DATE -	REVISED -

STATE OF ILLINOIS
DEPARTMENT OF TRANSPORTATION

I-80 EB WEIGH STATION, TINLEY PARK
LANDSCAPING PLAN SHEETS

SCALE: 1"=50' SHEET OF SHEETS STA. TO STA.


F.A.I. RTE.	SECTION	COUNTY	TOTAL SHEETS	SHEET NO.
80	2021-100-I	VARIOUS	37	17
CONTRACT NO. 62P28				
ILLINOIS FED. AID PROJECT				

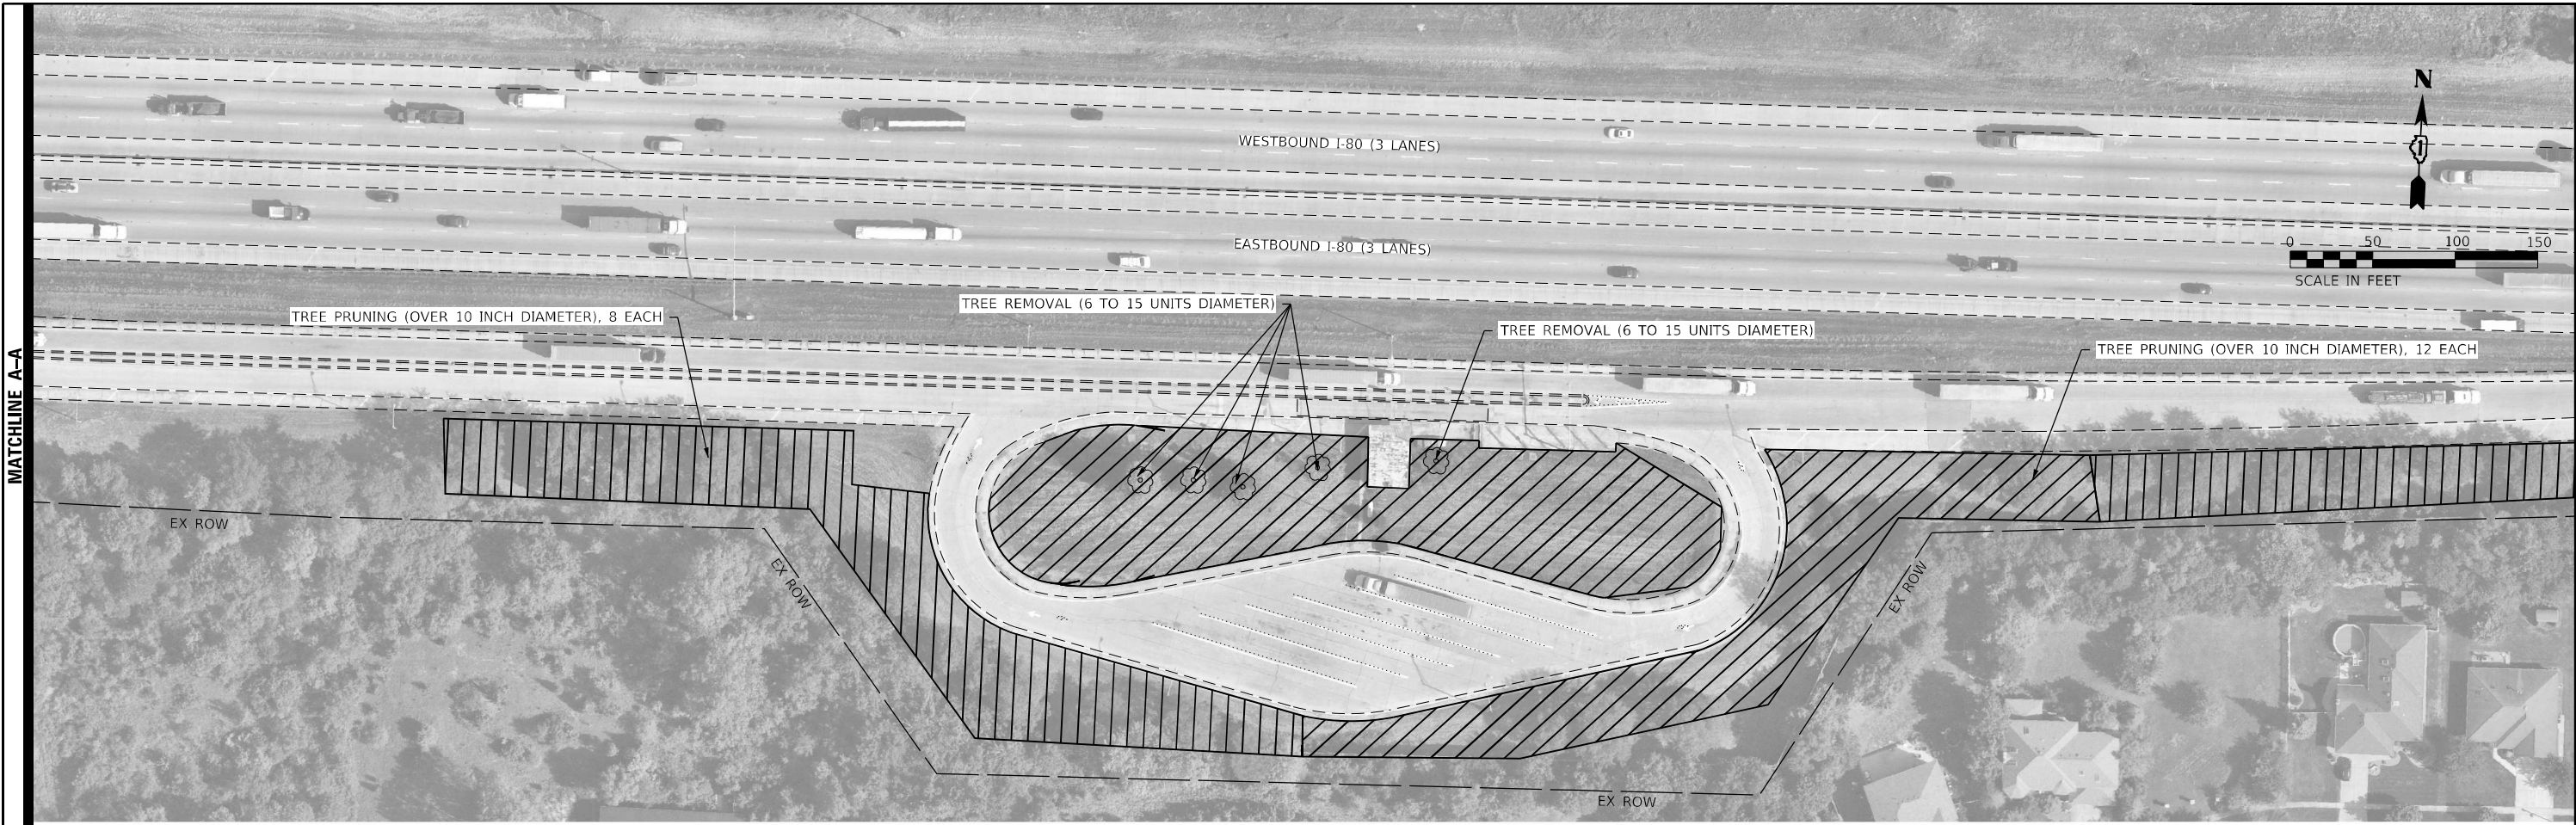

LEGEND

	EX ROW
	WEED CONTROL TEASEL
	WEED CONTROL AQUATIC
	WEED CONTROL TEASEL AND AQUATIC
	SELECTIVE CLEARING
	TREE REMOVAL ACRES (SPECIAL)

MODEL: Default
 FILE NAME: T:\06\sect19-012 IDOT Phase II Sub Vpr-Vpr01 Weigh Station RR Clearing05_CADD02_CADD_SheetSetE_D162P28-Landscaping_eht-03_130 EB_Morena.dgn

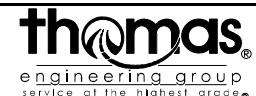

USER NAME = maciej	DESIGNED - MIK	REVISED -
PLOT SCALE = 100,0000' / in.	DRAWN - FS	REVISED -
PLOT DATE = 10/21/2021	CHECKED - CC	REVISED -
	DATE -	REVISED -

STATE OF ILLINOIS
DEPARTMENT OF TRANSPORTATION

I-80 EB WEIGH STATION, TINLEY PARK
LANDSCAPING PLAN SHEETS

SCALE: 1"=50' SHEET OF SHEETS STA. TO STA.

F.A.I. RTE.	SECTION	COUNTY	TOTAL SHEETS	SHEET NO.
80	2021-100-I	VARIOUS	37	18
CONTRACT NO. 62P28				
ILLINOIS FED. AID PROJECT				



MATCHLINE A-A



MATCHLINE A-A

LEGEND	
	EX ROW
	WEED CONTROL TEASEL
	WEED CONTROL AQUATIC
	WEED CONTROL TEASEL AND AQUATIC
	SELECTIVE CLEARING
	TREE REMOVAL ACRES (SPECIAL)

MODEL: Default
FILE NAME: I:\Projects\19-0112 IDOT Phase II Sub V&V\01 Weigh Station FR Clearing\05 CAD\002_CADD_SheetSet\01652P28-Landscaping_ent-04_157_NB_Peotone.dwg



USER NAME = maciejk	DESIGNED - MIK	REVISED -
PLOT SCALE = 100,0000' / in.	DRAWN - FS	REVISED -
PLOT DATE = 10/21/2021	CHECKED - CC	REVISED -
	DATE -	REVISED -

**STATE OF ILLINOIS
DEPARTMENT OF TRANSPORTATION**

I-57 NB WEIGH STATION, PEOTONE LANDSCAPING PLAN SHEETS			
SCALE: 1"=50'	SHEET	OF	SHEETS
	STA.		TO STA.

F.A.I. RTE.	SECTION	COUNTY	TOTAL SHEETS	SHEET NO.
57	2021-100-I	VARIOUS	37	19
CONTRACT NO. 62P28				
ILLINOIS FED. AID PROJECT				

MODEL: Default
 FILE NAME: I:\projects\19-0112 IDOT Phase II Sub-Via-Via\01 Weigh Station Rtr Clearance\05 CAD\02_CADD_Sheets\1657228-Landscaping_sht-05_157_SB_Peotone.dgn



LEGEND	
	EX ROW
	WEED CONTROL TEASEL
	WEED CONTROL AQUATIC
	WEED CONTROL TEASEL AND AQUATIC
	SELECTIVE CLEARING
	TREE REMOVAL ACRES (SPECIAL)



USER NAME = maciejk	DESIGNED - MIK	REVISED -
PLOT SCALE = 100,0000' / in.	DRAWN - FS	REVISED -
PLOT DATE = 10/21/2021	CHECKED - CC	REVISED -
	DATE -	REVISED -

STATE OF ILLINOIS
DEPARTMENT OF TRANSPORTATION

I-57 SB WEIGH STATION, PEOTONE LANDSCAPING PLAN SHEETS			
SCALE: 1"=50'	SHEET	OF	SHEETS
	STA.		TO STA.

F.A.I. RTE.	SECTION	COUNTY	TOTAL SHEETS	SHEET NO.
57	2021-100-I	VARIOUS	37	20
CONTRACT NO. 62P28				
ILLINOIS FED. AID PROJECT				



MATCHLINE A-A



LEGEND	
	EX ROW
	WEED CONTROL TEASEL
	WEED CONTROL AQUATIC
	WEED CONTROL TEASEL AND AQUATIC
	SELECTIVE CLEARING
	TREE REMOVAL ACRES (SPECIAL)

MODEL: Default
FILE NAME: I:\Projects\19-012 DOT Phase II Sub V&V\01 Weigh Station Rk Clean\05_CADD\02_Sheet\01_Landscaping_01-06_155_NB_Bolingbrook.dgn




USER NAME = maciejk	DESIGNED - MIK	REVISED -
PLOT SCALE = 100,0000' / in.	DRAWN - FS	REVISED -
PLOT DATE = 10/21/2021	CHECKED - CC	REVISED -
	DATE -	REVISED -

**STATE OF ILLINOIS
DEPARTMENT OF TRANSPORTATION**

**I-55 NB WEIGH STATION, BOLINGBROOK
LANDSCAPING PLAN SHEETS**

F.A.I. RTE.	SECTION	COUNTY	TOTAL SHEETS	SHEET NO.
55	2021-100-I	VARIOUS	37	21
CONTRACT NO. 62P28				
ILLINOIS FED. AID PROJECT				

SCALE: 1"=50' SHEET OF SHEETS STA. TO STA.

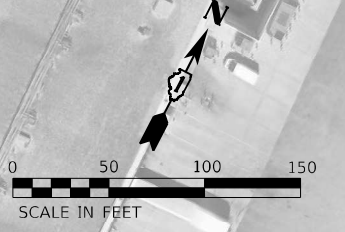

LEGEND	
	EX ROW
	WEED CONTROL TEASEL
	WEED CONTROL AQUATIC
	WEED CONTROL TEASEL AND AQUATIC
	SELECTIVE CLEARING
	TREE REMOVAL ACRES (SPECIAL)

MODEL: Default
 FILE NAME: I:\projects\19-012 IDOT Phase II Sub-Via-Via\01 Weigh Station RIR\Cleanroom\CADD\02_CADD_SheetSet\01657228-Landscaping_sht-07_155_SB_Bolingbrook.dgn




USER NAME = maciej	DESIGNED - MIK	REVISED -
	DRAWN - FS	REVISED -
PLOT SCALE = 100,0000' / in.	CHECKED - CC	REVISED -
PLOT DATE = 10/21/2021	DATE -	REVISED -

STATE OF ILLINOIS
DEPARTMENT OF TRANSPORTATION

I-55 SB WEIGH STATION, BOLINGBROOK LANDSCAPING PLAN SHEETS			
SCALE: 1"=50'	SHEET	OF	SHEETS
	STA.		TO STA.

F.A.I. RTE.	SECTION	COUNTY	TOTAL SHEETS	SHEET NO.
55	2021-100-I	VARIOUS	37	22
CONTRACT NO. 62P28				
ILLINOIS FED. AID PROJECT				

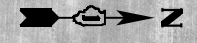

TREE PRUNING (OVER 10 INCH DIAMETER), 1 EACH

EX ROW

EX ROW

EX ROW

EX ROW






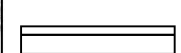
SOUTHBOUND US 41 (2 LANES)

NORTHBOUND US 41 (2 LANES)

EX ROW

EX ROW

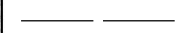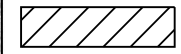LEGEND

-  EX ROW
-  WEED CONTROL TEASEL
-  WEED CONTROL AQUATIC
-  WEED CONTROL TEASEL AND AQUATIC
-  SELECTIVE CLEARING
-  TREE REMOVAL ACRES (SPECIAL)

MODEL: Default
FILE NAME: I:\projects\19-012 DOT Phase II Sub-Via-Vari01 Weigh Station RR Cleaninc05 CADD02 CADD_SheetSet D:\62228-Landscaping_eht08 US 41 SB Rosecrans.dgn




USER NAME = maclejk	DESIGNED - MIK	REVISED -
PLOT SCALE = 100,0000' / in.	DRAWN - FS	REVISED -
PLOT DATE = 10/21/2021	CHECKED - CC	REVISED -
	DATE -	REVISED -

**STATE OF ILLINOIS
DEPARTMENT OF TRANSPORTATION**

US 41 SB WEIGH STATION, ROSECRANS LANDSCAPING PLAN SHEETS			
SCALE: 1"=50'	SHEET	OF	SHEETS
	STA.		TO STA.

F.A.P. RTE.	SECTION	COUNTY	TOTAL SHEETS	SHEET NO.
0346	2021-100-I	VARIOUS	37	23
CONTRACT NO. 62P28				
ILLINOIS FED. AID PROJECT				

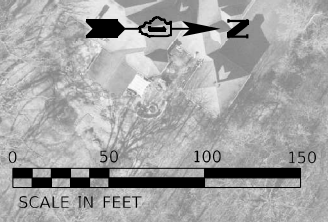

LEGEND	
	EX ROW
	WEED CONTROL TEASEL
	WEED CONTROL AQUATIC
	WEED CONTROL TEASEL AND AQUATIC
	SELECTIVE CLEARING
	TREE REMOVAL ACRES (SPECIAL)

MODEL: D:\p1\19-0112 IDOT Phase II Sub V&V\01 Weigh Station RR Cleaning\05 CADD\02_CADD_Sheets\165728-Landscaping_eht-09_US_41_NB_Wadsworth.dgn
 FILE NAME: 165728-Landscaping_eht-09_US_41_NB_Wadsworth.dgn



USER NAME = maciejk	DESIGNED - MIK	REVISED -
	DRAWN - FS	REVISED -
PLOT SCALE = 100,0000' / in.	CHECKED - CC	REVISED -
PLOT DATE = 10/21/2021	DATE -	REVISED -

STATE OF ILLINOIS
DEPARTMENT OF TRANSPORTATION

US 41 NB WEIGH STATION, WADSWORTH
LANDSCAPING PLAN SHEETS

SCALE: 1"=50' SHEET OF SHEETS STA. TO STA.

F.A.P. RTE.	SECTION	COUNTY	TOTAL SHEETS	SHEET NO.
0346	2021-100-I	VARIOUS	37	24
CONTRACT NO. 62P28				
ILLINOIS FED. AID PROJECT				



LEGEND	
	EX ROW
	WEED CONTROL TEASEL
	WEED CONTROL AQUATIC
	WEED CONTROL TEASEL AND AQUATIC
	SELECTIVE CLEARING
	TREE REMOVAL ACRES (SPECIAL)

MODEL: Default
 FILE NAME: T:\projects\19-012 IDOT Phase II Sub Var-Vari01 Weigh Station RR Cleaninc05_CADD02_CADD_Sheet05_Landscaping_eht-10_US 12 Richmond.dgn



USER NAME = maciejk	DESIGNED - MIK	REVISED -
PLOT SCALE = 100,0000' / in.	DRAWN - FS	REVISED -
PLOT DATE = 10/21/2021	CHECKED - CC	REVISED -
	DATE -	REVISED -

STATE OF ILLINOIS
DEPARTMENT OF TRANSPORTATION

US 12 WEIGH STATION, RICHMOND
LANDSCAPING PLAN SHEETS

F.A.P. RTE.	SECTION	COUNTY	TOTAL SHEETS	SHEET NO.
0334	2021-100-I	VARIOUS	37	13
CONTRACT NO. 62P28				
ILLINOIS FED. AID PROJECT				

SCALE: 1"=50' SHEET OF SHEETS STA. TO STA.



LEGEND	
	EX ROW
	WEED CONTROL TEASEL
	WEED CONTROL AQUATIC
	WEED CONTROL TEASEL AND AQUATIC
	SELECTIVE CLEARING
	TREE REMOVAL ACRES (SPECIAL)

MODEL: Default
 FILE NAME: I:\projects\19-012 DOT Phase II Sub V&V\01 Weigh Station PK Clearing\05 CADD\02_CADD_SheetSet_D165228-Landscaping_eht-11_US 14 Harvard.dgn



USER NAME = maciejk	DESIGNED - MIK	REVISED -
PLOT SCALE = 100,000' / in.	DRAWN - FS	REVISED -
PLOT DATE = 10/21/2021	CHECKED - CC	REVISED -
	DATE -	REVISED -

STATE OF ILLINOIS
DEPARTMENT OF TRANSPORTATION

US 14 WEIGH STATION, HARVARD
LANDSCAPNG PLAN SHEETS

F.A.P. RTE.	SECTION	COUNTY	TOTAL SHEETS	SHEET NO.
0066	2021-100-I	VARIOUS	37	26
CONTRACT NO. 62P28				
ILLINOIS FED. AID PROJECT				


SCALE: 1"=50' SHEET OF SHEETS STA. TO STA.



NO LANDSCAPING WORK AT THIS LOCATION

LEGEND	
	EX ROW
	WEED CONTROL TEASEL
	WEED CONTROL AQUATIC
	WEED CONTROL TEASEL AND AQUATIC
	SELECTIVE CLEARING
	TREE REMOVAL ACRES (SPECIAL)

MODEL: Default
 FILE NAME: I:\Projects\19-012 DOT Phase II Sub Vars\01 Weigh Station FR Cleanup\05 CADD\02_CADD_SheetSet_D165228-Landscaping_sht12_US_30_Sauk_Village.dwg

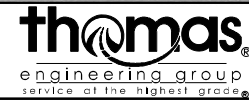

USER NAME = maciejk	DESIGNED - MIK	REVISED -
PLOT SCALE = 100,0000' / in.	DRAWN - FS	REVISED -
PLOT DATE = 10/21/2021	CHECKED - CC	REVISED -
	DATE -	REVISED -

DESIGNED - MIK	REVISED -
DRAWN - FS	REVISED -
CHECKED - CC	REVISED -
DATE -	REVISED -

**STATE OF ILLINOIS
DEPARTMENT OF TRANSPORTATION**

**US 30 WEIGH STATION, SAUK VILLAGE
LANDSCAPING PLAN SHEETS**

SCALE: 1"=50' SHEET OF SHEETS STA. TO STA.

F.A.P. RTE.	SECTION	COUNTY	TOTAL SHEETS	SHEET NO.
0353	2021-100-I	VARIOUS	37	15
CONTRACT NO. 62P28				
ILLINOIS FED. AID PROJECT				

MODEL: Default
 FILE NAME: I:\projects\19-012 IDOT Phase II Sub Vix-Vic\01 Weigh Station RR Cleaning\05 CADD\02_CADD_Sheets\01_Landscaping\04_eht-13_IL_83_Elmhurst.dgn



LEGEND	
	EX ROW
	WEED CONTROL TEASEL
	WEED CONTROL AQUATIC
	WEED CONTROL TEASEL AND AQUATIC
	SELECTIVE CLEARING
	TREE REMOVAL ACRES (SPECIAL)



USER NAME = maciejk	DESIGNED - MIK	REVISED -
PLOT SCALE = 100,0000' / in.	DRAWN - FS	REVISED -
PLOT DATE = 10/21/2021	CHECKED - CC	REVISED -
	DATE -	REVISED -

STATE OF ILLINOIS
DEPARTMENT OF TRANSPORTATION






IL 83 WEIGH STATION, ELMHURST LANDSCAPING PLAN SHEETS			
SCALE: 1"=50'	SHEET	OF	SHEETS
	STA.		TO STA.

F.A.P. RTE.	SECTION	COUNTY	TOTAL SHEETS	SHEET NO.
0344	2021-100-I	VARIOUS	37	28
				CONTRACT NO. 62P28
ILLINOIS		FED. AID PROJECT		

NOTE: Anchor bolts are to be cast into pedestals at locations supplied by the Scale Manufacturer.

ROUTE NO.	SECTION	COUNTY	TOTAL SHEETS	SHEET NO.
180	4	WILL	16	8
F.A.I. PROJECT NO. 1995-995-01-1				

FOR INFORMATION ONLY

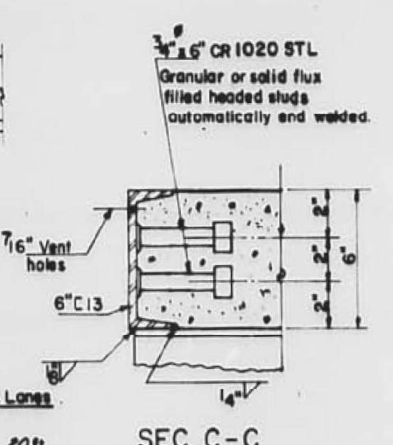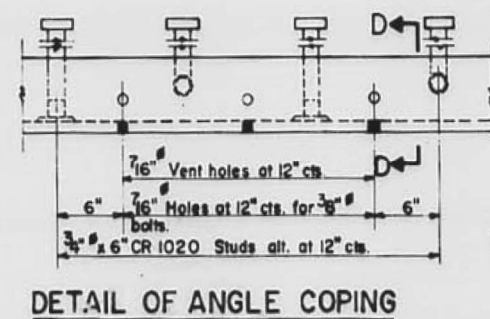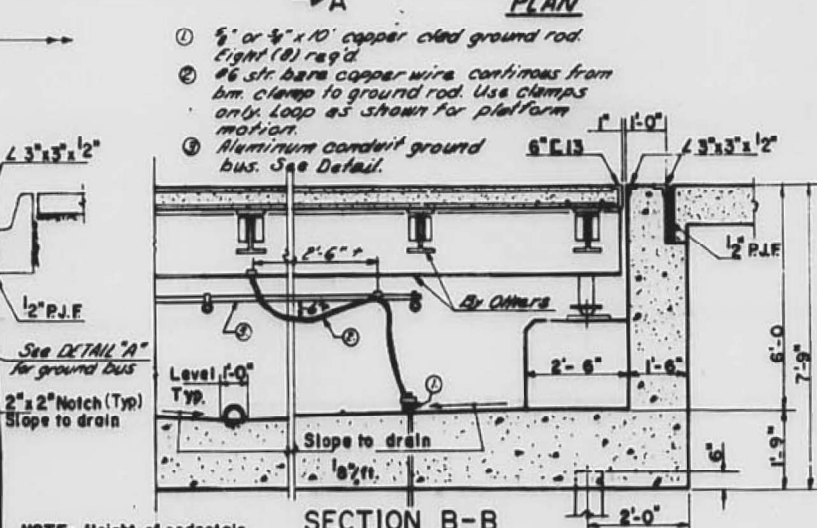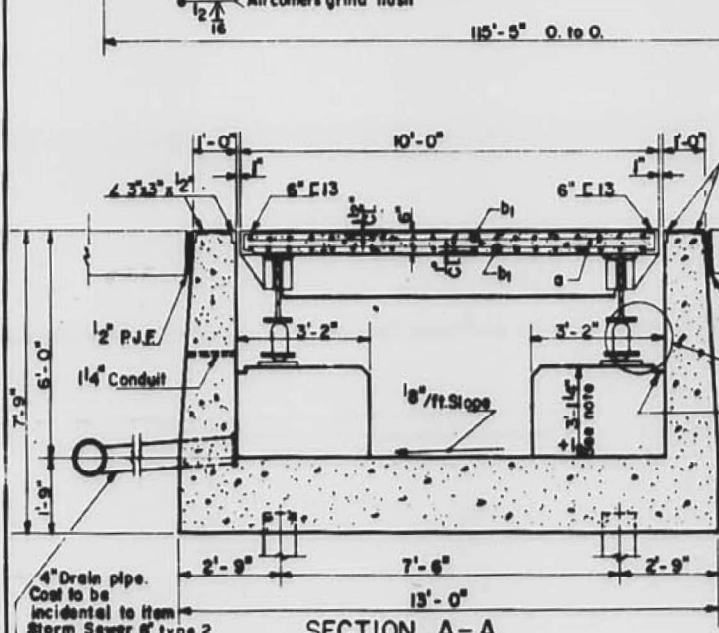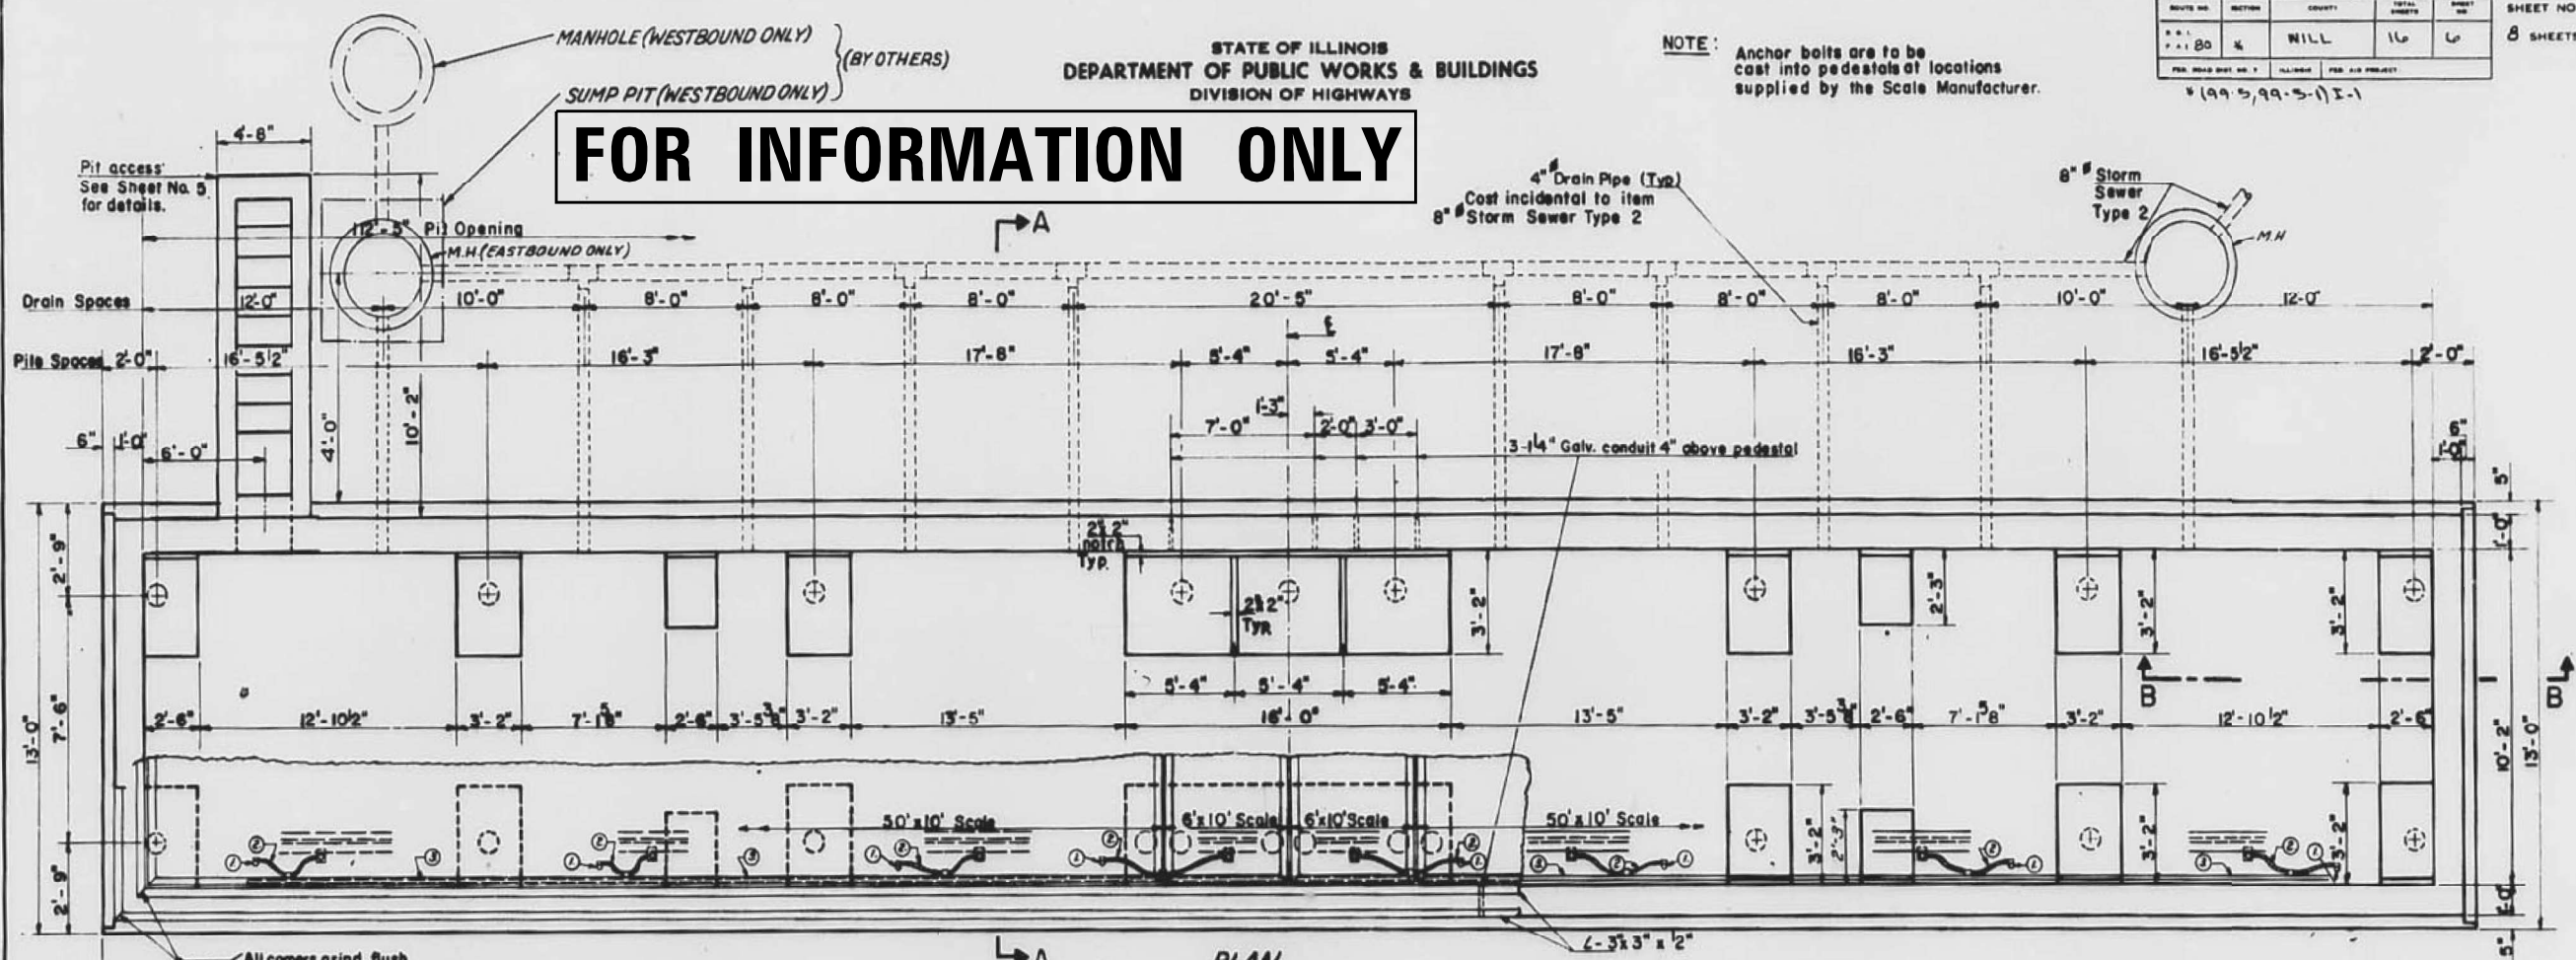

PILE DATA
E. Bd. Lanes - A. Bd. Lanes



Type	Creosoted
Est. Length	15 ft. 20 ft.
No. Req'd.	18 # 18 #
Capacity	20 Ton. 20 Ton.

DESIGNED: *James M. Rudy*
CHECKED: *A. Barasa*
DRAWN: *A. Barasa*
CHECKED: *B*

EXAMINED: *[Signature]*
PASSED: _____
APPROVED: _____

NOTE: Height of pedestals to be furnished by the Scale Manufacturer.

NOTE: Ground bus of 1/2\"/>

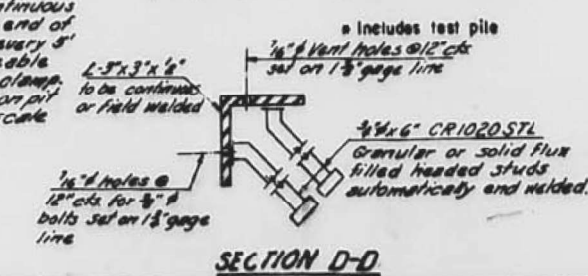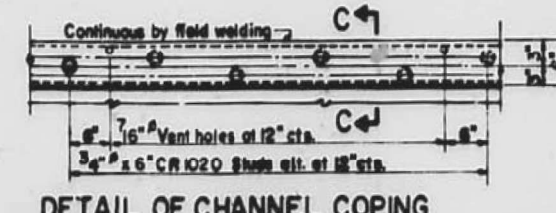

GENERAL LAYOUT
F.A.I. RT. 80 SEC. 1995-995-01-1
WILL COUNTY
STA. 989+44.94
STA. 1212+05.16

MODEL: Default; FILE NAME: I:\projects\1995\1212 DOT Phase II Sub-Via-Via\01 Weigh Station Rtr Cleaning\05 CAD\02_CADD_Sheets\Site Specific Detail Sheets 1 of 8.dgn



USER NAME = maciej	DESIGNED - MIK	REVISED -
PLOT SCALE = 2,000' / 1"	DRAWN - FS	REVISED -
PLOT DATE = 10/21/2021	CHECKED - CC	REVISED -
	DATE -	REVISED -

STATE OF ILLINOIS
DEPARTMENT OF TRANSPORTATION


DETAILS - TINLEY PARK I-80 WESTBOUND

SCALE: N.T.S. SHEET OF SHEETS STA. TO STA.

F.A.I.P. RTE.	SECTION	COUNTY	TOTAL SHEETS	SHEET NO.
VAR.	2021-100-I	VARIOUS	37	29
CONTRACT NO. 62P28				

ILLINOIS FED. AID PROJECT

NOTE: Lifter balls are to be cast into pedestals at locations supplied by the Scale Manufacturer



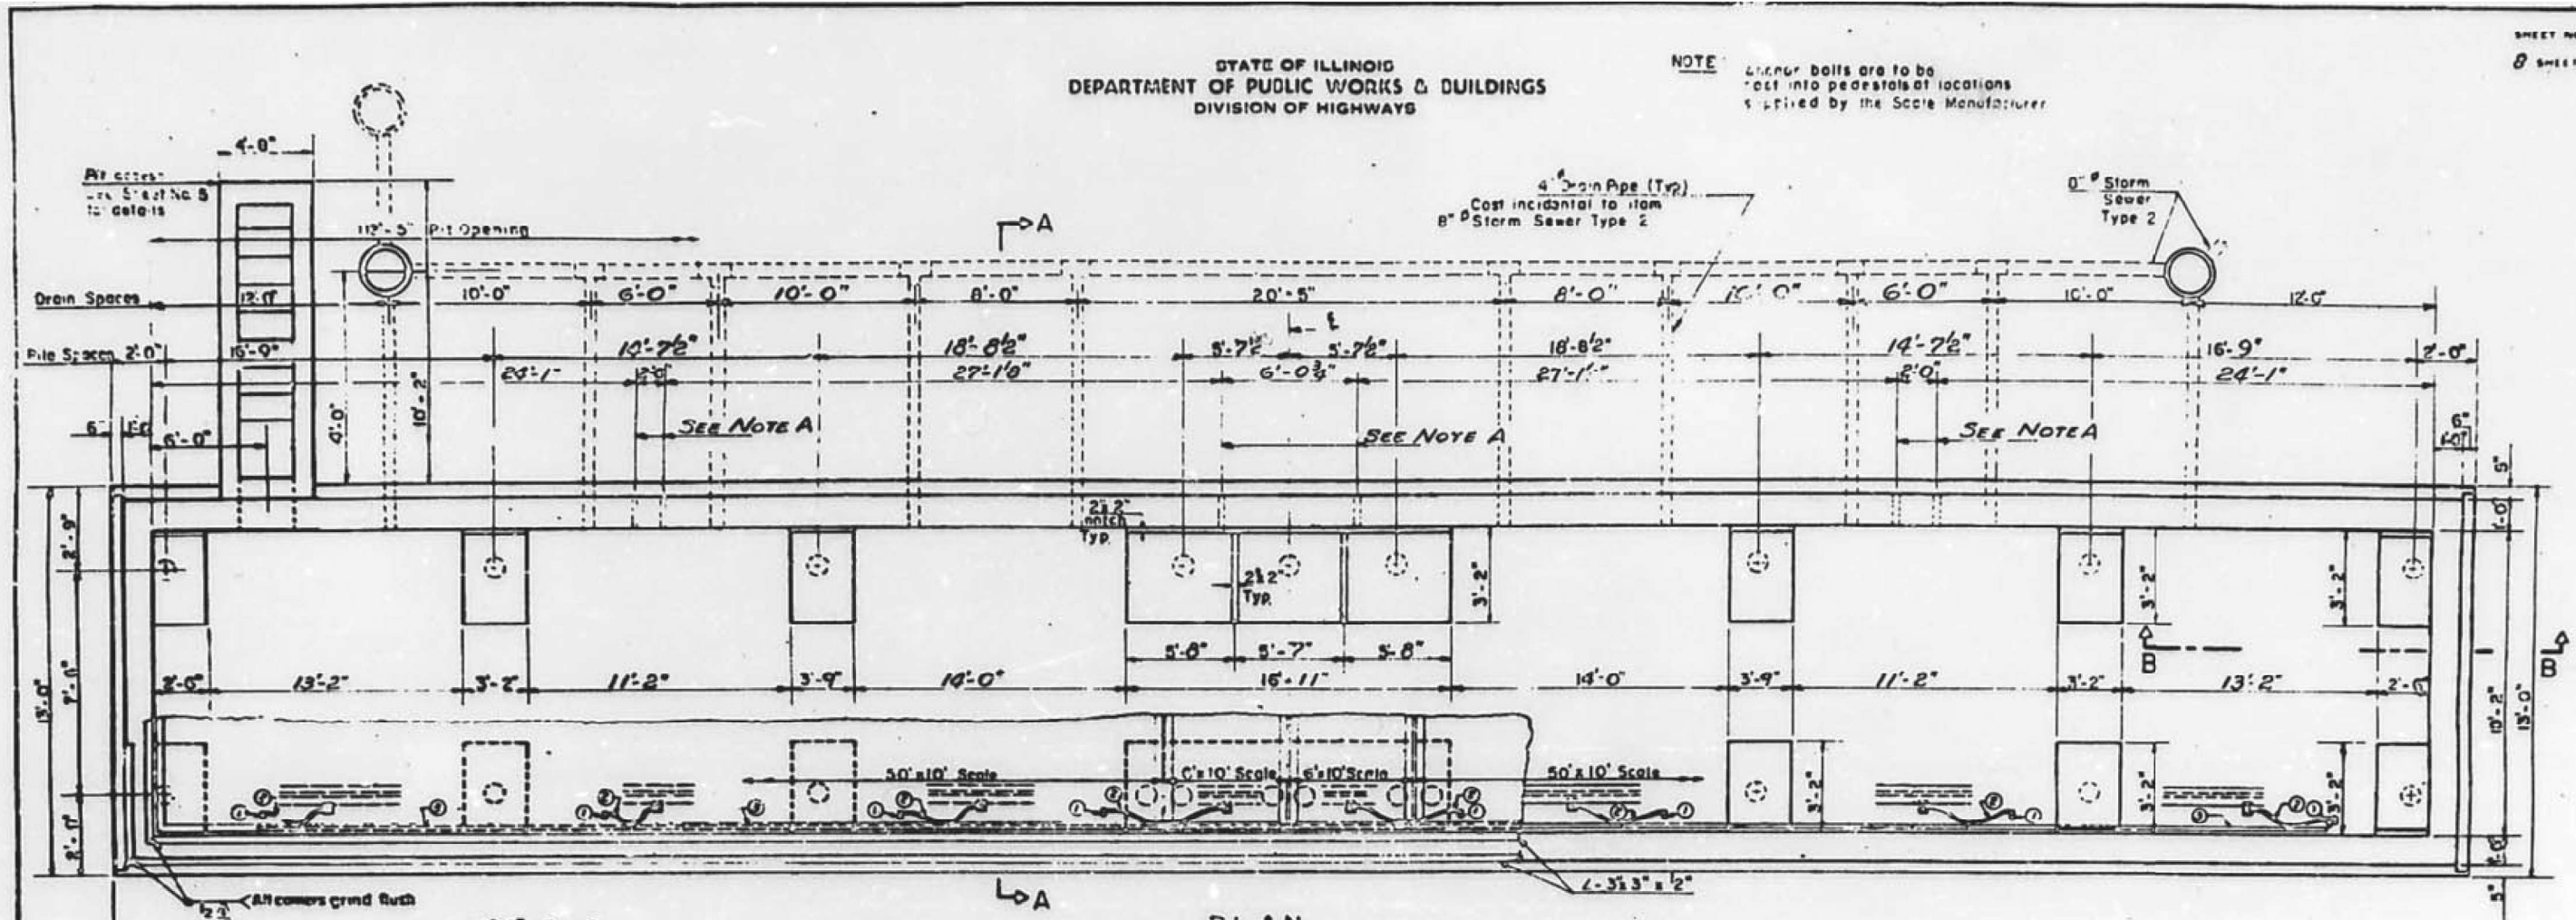


FOR INFORMATION ONLY

- ① 5/8" x 5/8" x 10' copper clad ground rod light rod
- ② #6 str bars copper wire continuous from bar clasp to ground rod. Use clamps only loop as shown for platform section. 5" dia.
- ③ Aluminum conduct ground bus. See Det.

NOTE:
ELECTRICAL DETAILS SUBJECT TO CHANGE.
PEDESTAL RELOCATION REDUCES CLASS X CONC.
11 Cu. Yd. PER PIT. & REINF BARS 70 Lbs. PER PIT.

NOTE A: 3" GALV. STD. PIPE SLEEVES

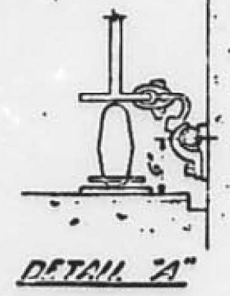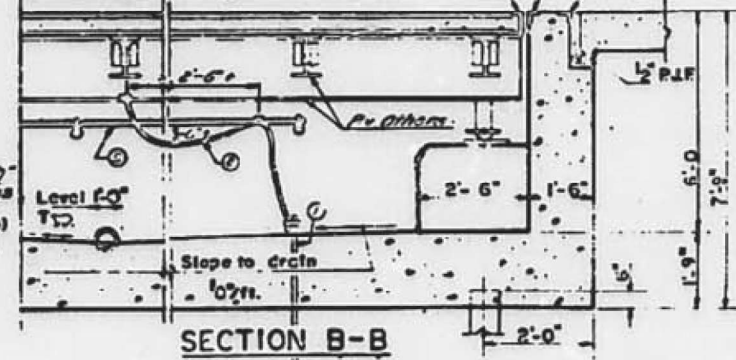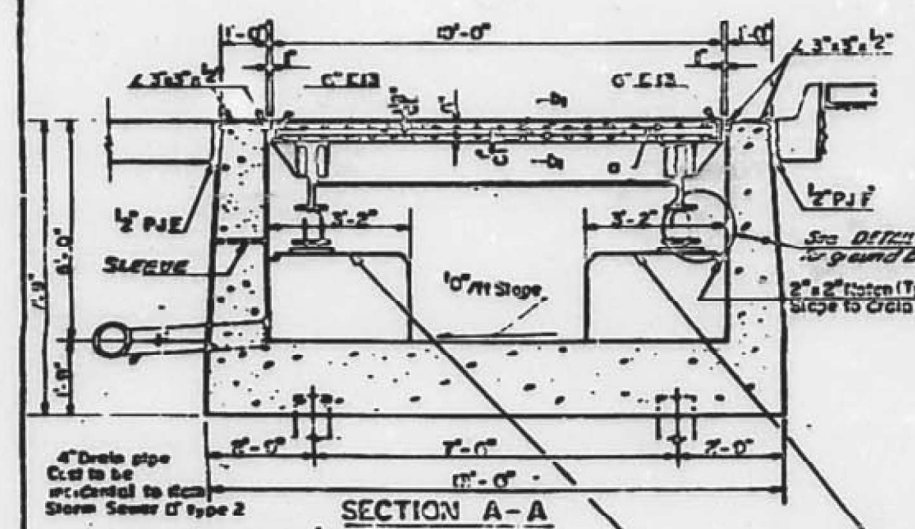

Elev. W.Bd. 695.32
Elev. E. Bd. 732.80
Typ. ea. pedestal.

GENERAL LAYOUT
FAL RT. 80 SEC. (995995) 1/1
WILL COUNTY
STA. 989+44.94
STA. 1212+05.16

MODEL: Default
FILE NAME: T:\projects\194112 DOT Phase II Sub-Via-Via-01 Weigh Station RR Cleanroom05 CAD002_CADD_Sheets\Site Specific Detail Sheets 2 of 6.dgn



USER NAME = maciek	DESIGNED - MIK	REVISED -
DRAWN - FS	REVISED -	
PLOT SCALE = 2,000' / in.	CHECKED - CC	REVISED -
PLOT DATE = 10/21/2021	DATE -	REVISED -

STATE OF ILLINOIS
DEPARTMENT OF TRANSPORTATION

DETAILS - MOKENA I-80 EASTBOUND	
SCALE: N.T.S.	SHEET OF SHEETS STA. TO STA.



F.A./P.RTE.	SECTION	COUNTY	TOTAL SHEETS	SHEET NO.
VAR.	2021-100-I	VARIOUS	37	30
ILLINOIS FED. AID PROJECT			CONTRACT NO. 62P28	

FOR INFORMATION ONLY

STATE OF ILLINOIS
DEPARTMENT OF PUBLIC WORKS & BUILDINGS
DIVISION OF HIGHWAYS

NOTE: Anchor bolts are to be cast into pedestals at locations supplied by the Scale Manufacturer.

NO. 57	DATE 11/14/19	BY WILL	SCALE 1/4" = 1'-0"	SHEET 3
--------	---------------	---------	--------------------	---------

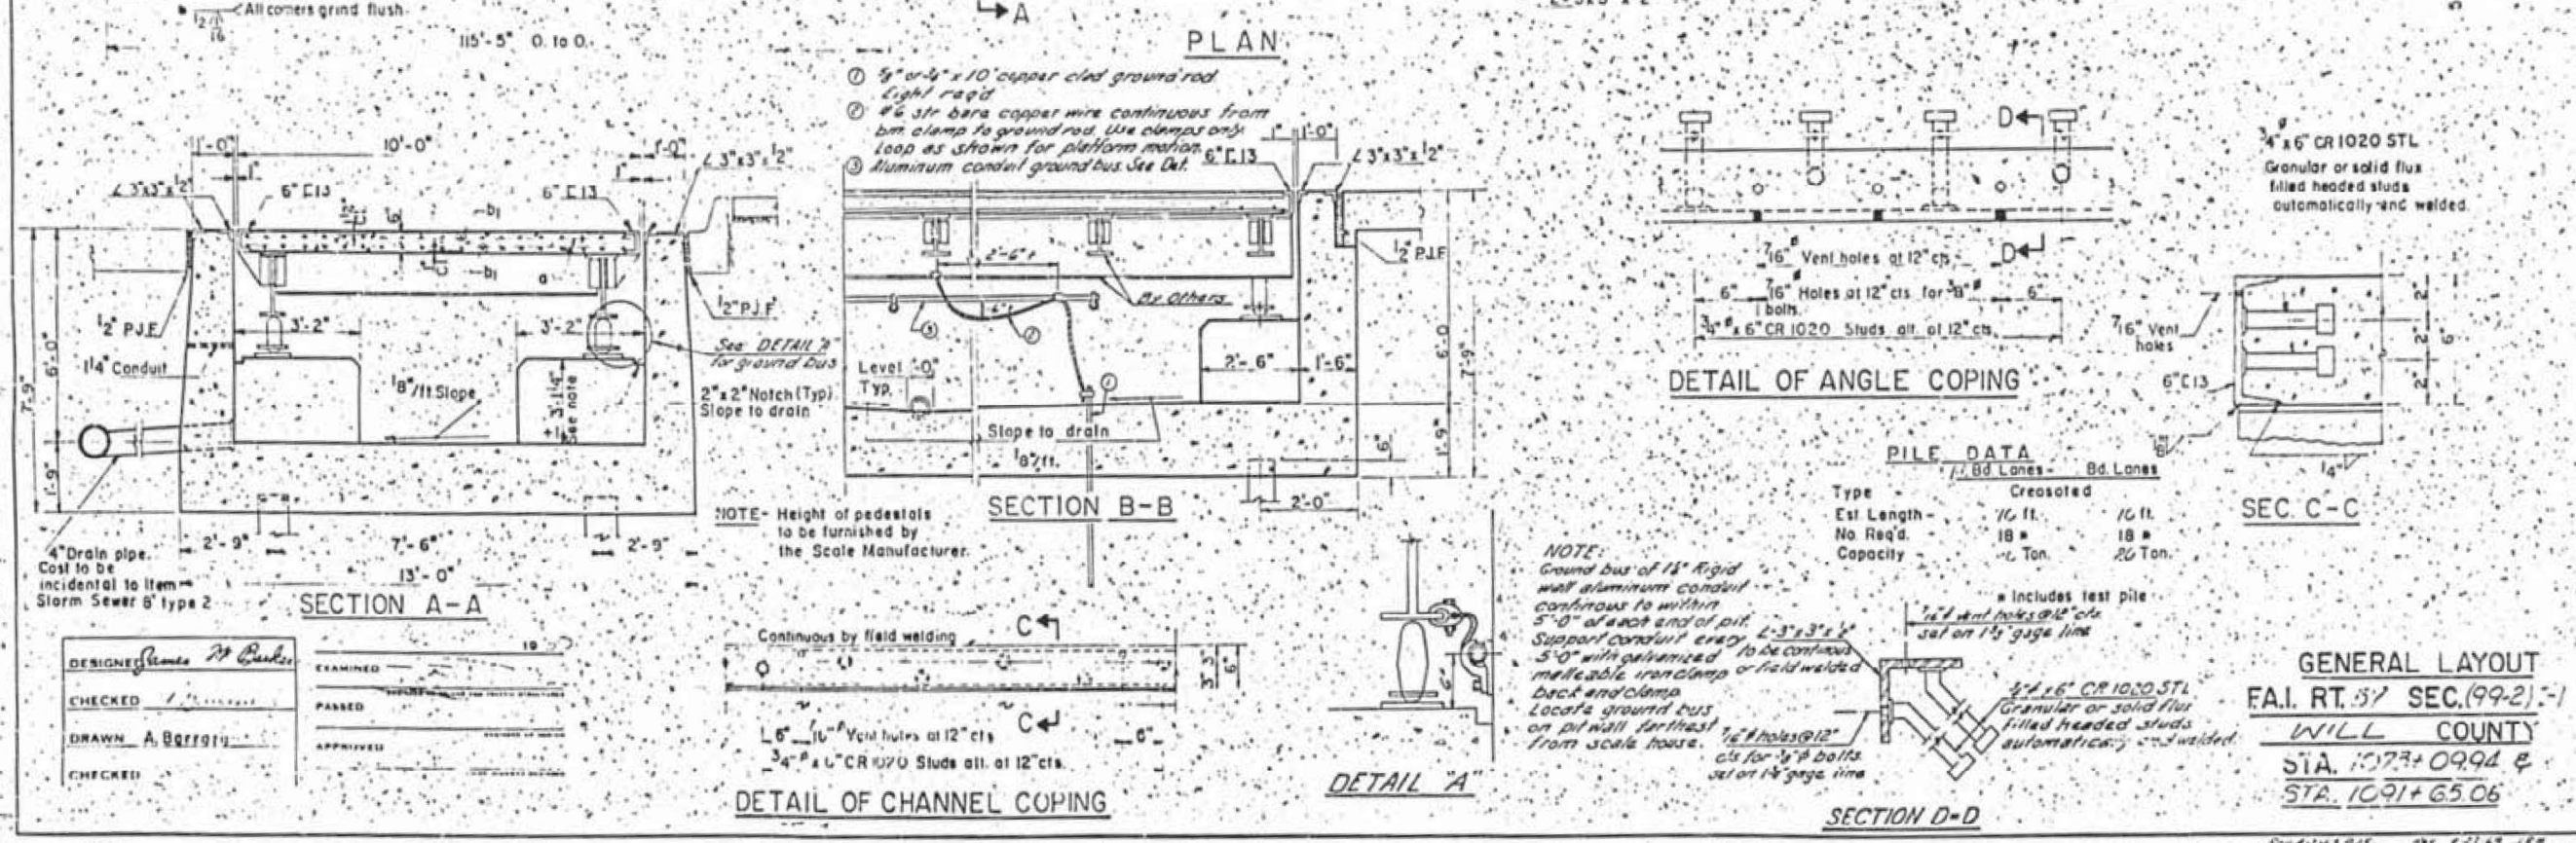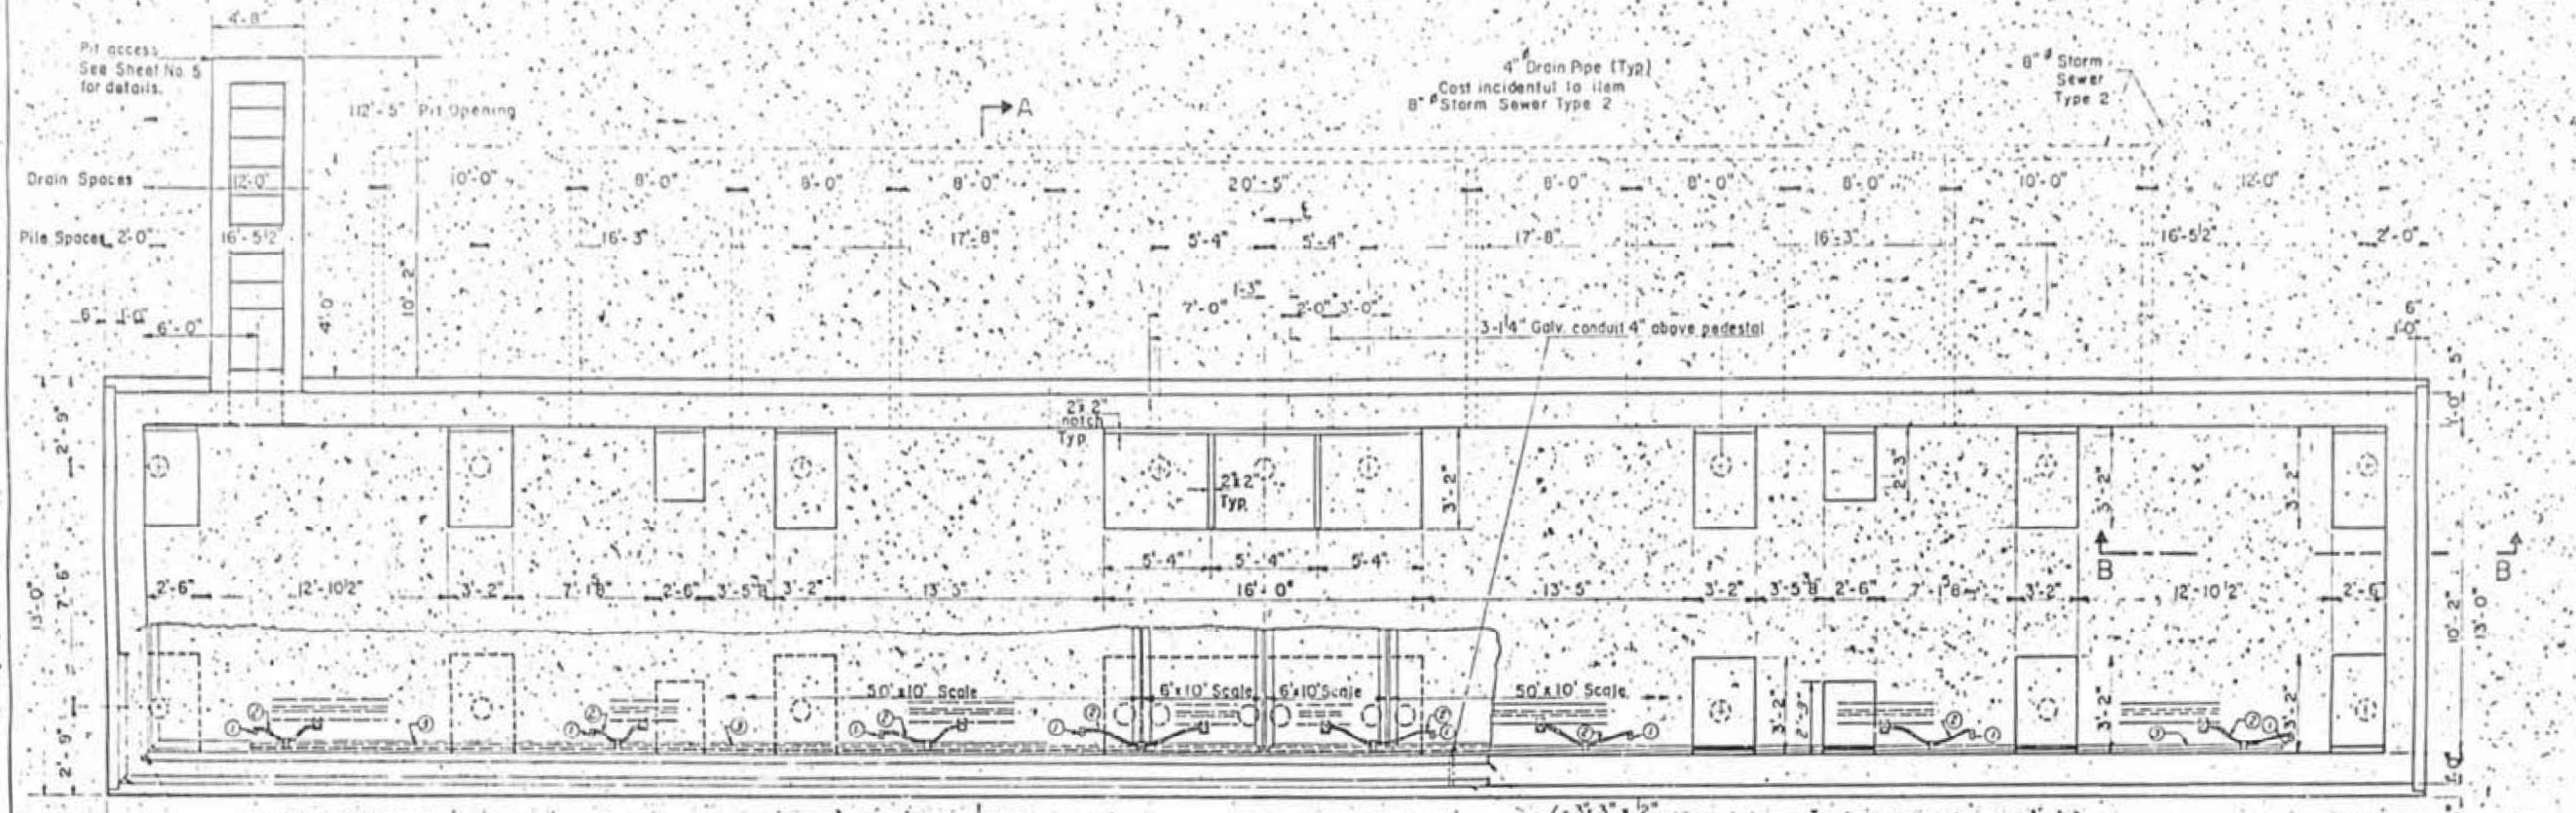

DESIGNED: <i>Romas M. Baska</i>	EXAMINED:
CHECKED: <i>A. B. Griffin</i>	PASSED:
DRAWN: <i>A. B. Griffin</i>	APPROVED:
CHECKED:	

MODEL: Default FILE NAME: I:\projects\191012 DOT Phase II Sub-Vari01 Weigh Station RR Clearing\05_CADD\02_Site Specific Detail Sheets_3 of 6.dgn





USER NAME = maciej	DESIGNED - MIK	REVISED -
PLOT SCALE = 2,000' / in.	DRAWN - FS	REVISED -
PLOT DATE = 10/21/2021	CHECKED - CC	REVISED -
	DATE -	REVISED -

STATE OF ILLINOIS
DEPARTMENT OF TRANSPORTATION

DETAIL - PEOTONE I-57 SOUTHBOUND			
SCALE: N.T.S.	SHEET	OF SHEETS	STA. TO STA.

F.A.I.P. RTE.	SECTION	COUNTY	TOTAL SHEETS	SHEET NO.
VAR.	2021-100-I	VARIOUS	37	31
			CONTRACT NO. 62P28	
		ILLINOIS	FED. AID PROJECT	

FOR INFORMATION ONLY

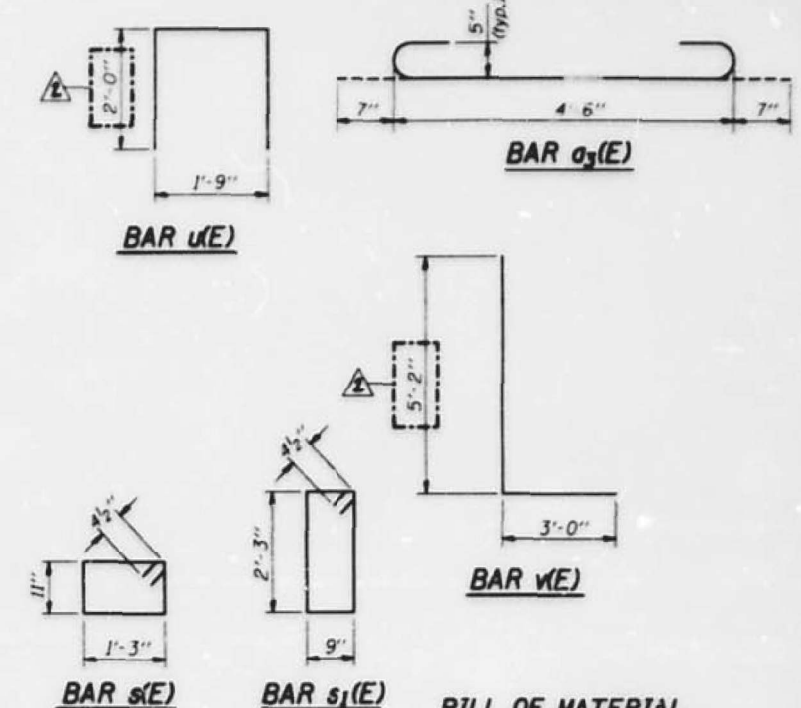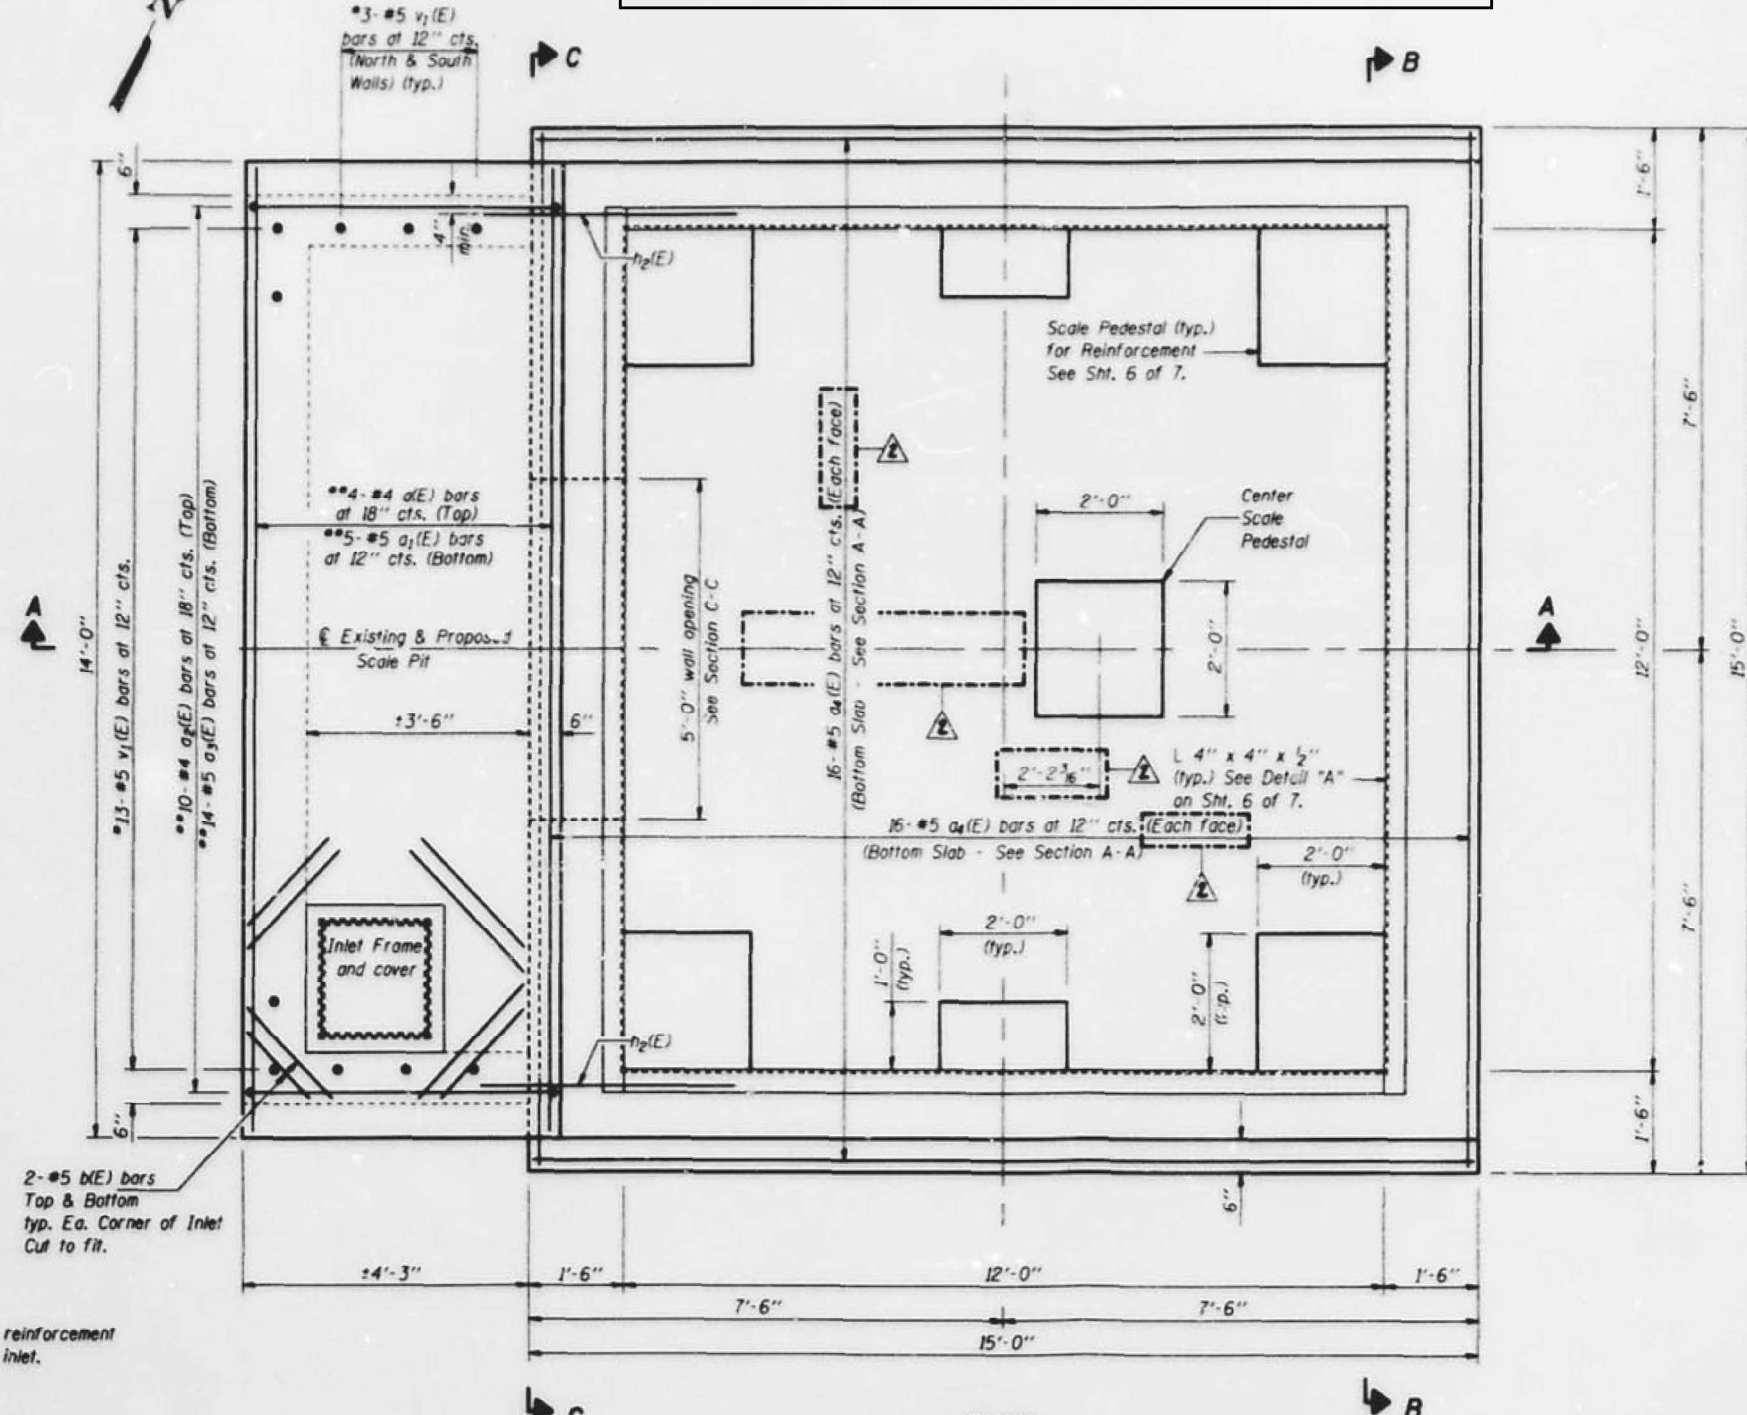

BILL OF MATERIAL

Bar No.	Size	Length	Shape
a1(E)	#4	13'-9"	
a2(E)	#5	13'-9"	
a3(E)	#4	4'-6"	
a4(E)	#5	5'-8"	
a5(E)	#5	14'-9"	
b(E)	#5	2'-0"	
c(E)	#5	14'-9"	
d(E)	#5	4'-9"	
e(E)	#5	2'-11"	
f(E)	#6	10'-2"	
g(E)	#4	1'-9"	
h(E)	#4	0'-9"	
i(E)	#5	13'-9"	
s(E)	#4	5'-1"	□
s1(E)	#4	6'-"	□
u(E)	#4	5'-9"	□
v(E)	#6	8'-2"	
v1(E)	#5	1'-11"	
Structure Excavation	Cu. Yd.	21.8	
Furnishing & Erecting Structural Steel	Lb.	700	
Reinforcement Bars, Epoxy Coated	Lb.	3790	
Concrete Structures	Cu. Yd.	26.2	
Concrete Removal	Cu. Yd.	22.2	

CONCRETE PIT DETAILS
RICHMOND WEIGH STATION
U.S. ROUTE 12
McHENRY COUNTY

Notes:
 • Epoxy grout h2(E) and v1(E) bars in 9" min. drilled holes according to Section 584 of the Standard Specifications.
 The manhole frame and lid shall be approved by the Engineer. The opening for the manhole shall be 30" x 30". The lid shall be hinged and equipped with fastening devices. Cost included with Concrete Structures.
 For Section A-A, See sheet 4 of 7.
 For Section B-B and C-C see sheet 5 of 7.

DESIGNED: Scott D. Sanford
 DRAWN: Fessha Teklehaimanot
 CHECKED: PAUL W. SWEST
 S.D.S and F.T.

MODEL: Default
 FILE NAME: T:\projects\19-012 DOT Phase II Sub-Variation1\Workshop\Station R1\Cleanings\CADD\CADD_Sheets\Site-Specific\Detail_Sheets_4_of_6.dgn



USER NAME = maciek	DESIGNED - MIK	REVISED -
PLOT SCALE = 2,000' / in.	DRAWN - FS	REVISED -
PLOT DATE = 10/21/2021	CHECKED - CC	REVISED -
	DATE -	REVISED -

STATE OF ILLINOIS
DEPARTMENT OF TRANSPORTATION

DETAIL - RICHMOND US 12



SCALE: N.T.S. SHEET OF SHEETS STA. TO STA.

F.A.I.P. RTE.	SECTION	COUNTY	TOTAL SHEETS	SHEET NO.
VAR.	2021-100-I	VARIOUS	37	32
			CONTRACT NO. 62P28	
ILLINOIS FED. AID PROJECT				

STATE OF ILLINOIS
DEPARTMENT OF TRANSPORTATION

ROUTE NO.	SECTION	COUNTY	STA.	POST	SHEET NO. 3 6 SHEETS
F.A.P. (US 14)	Truck Weighing Station	McHENRY	9	5	
FED. AID PROJ. NO. 7	BLANK	FED. AID PROJECT			

FOR INFORMATION ONLY

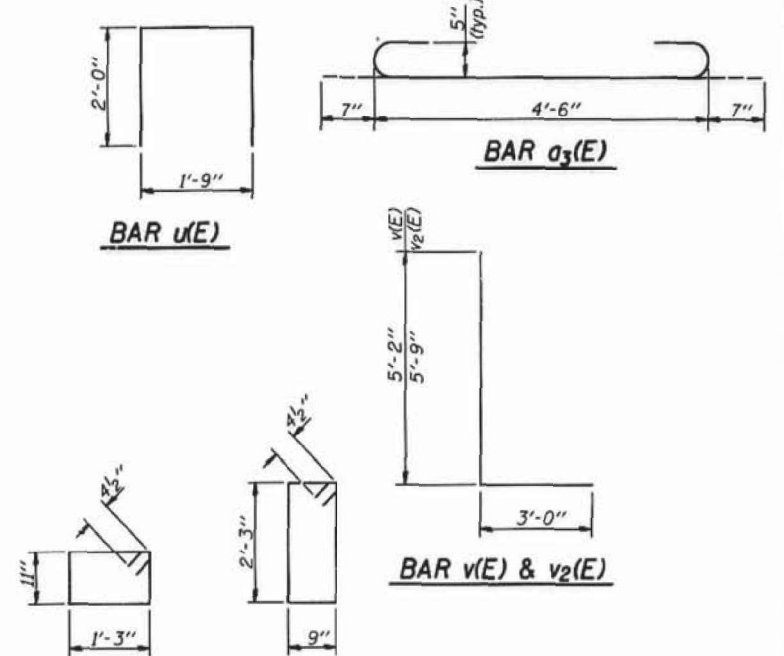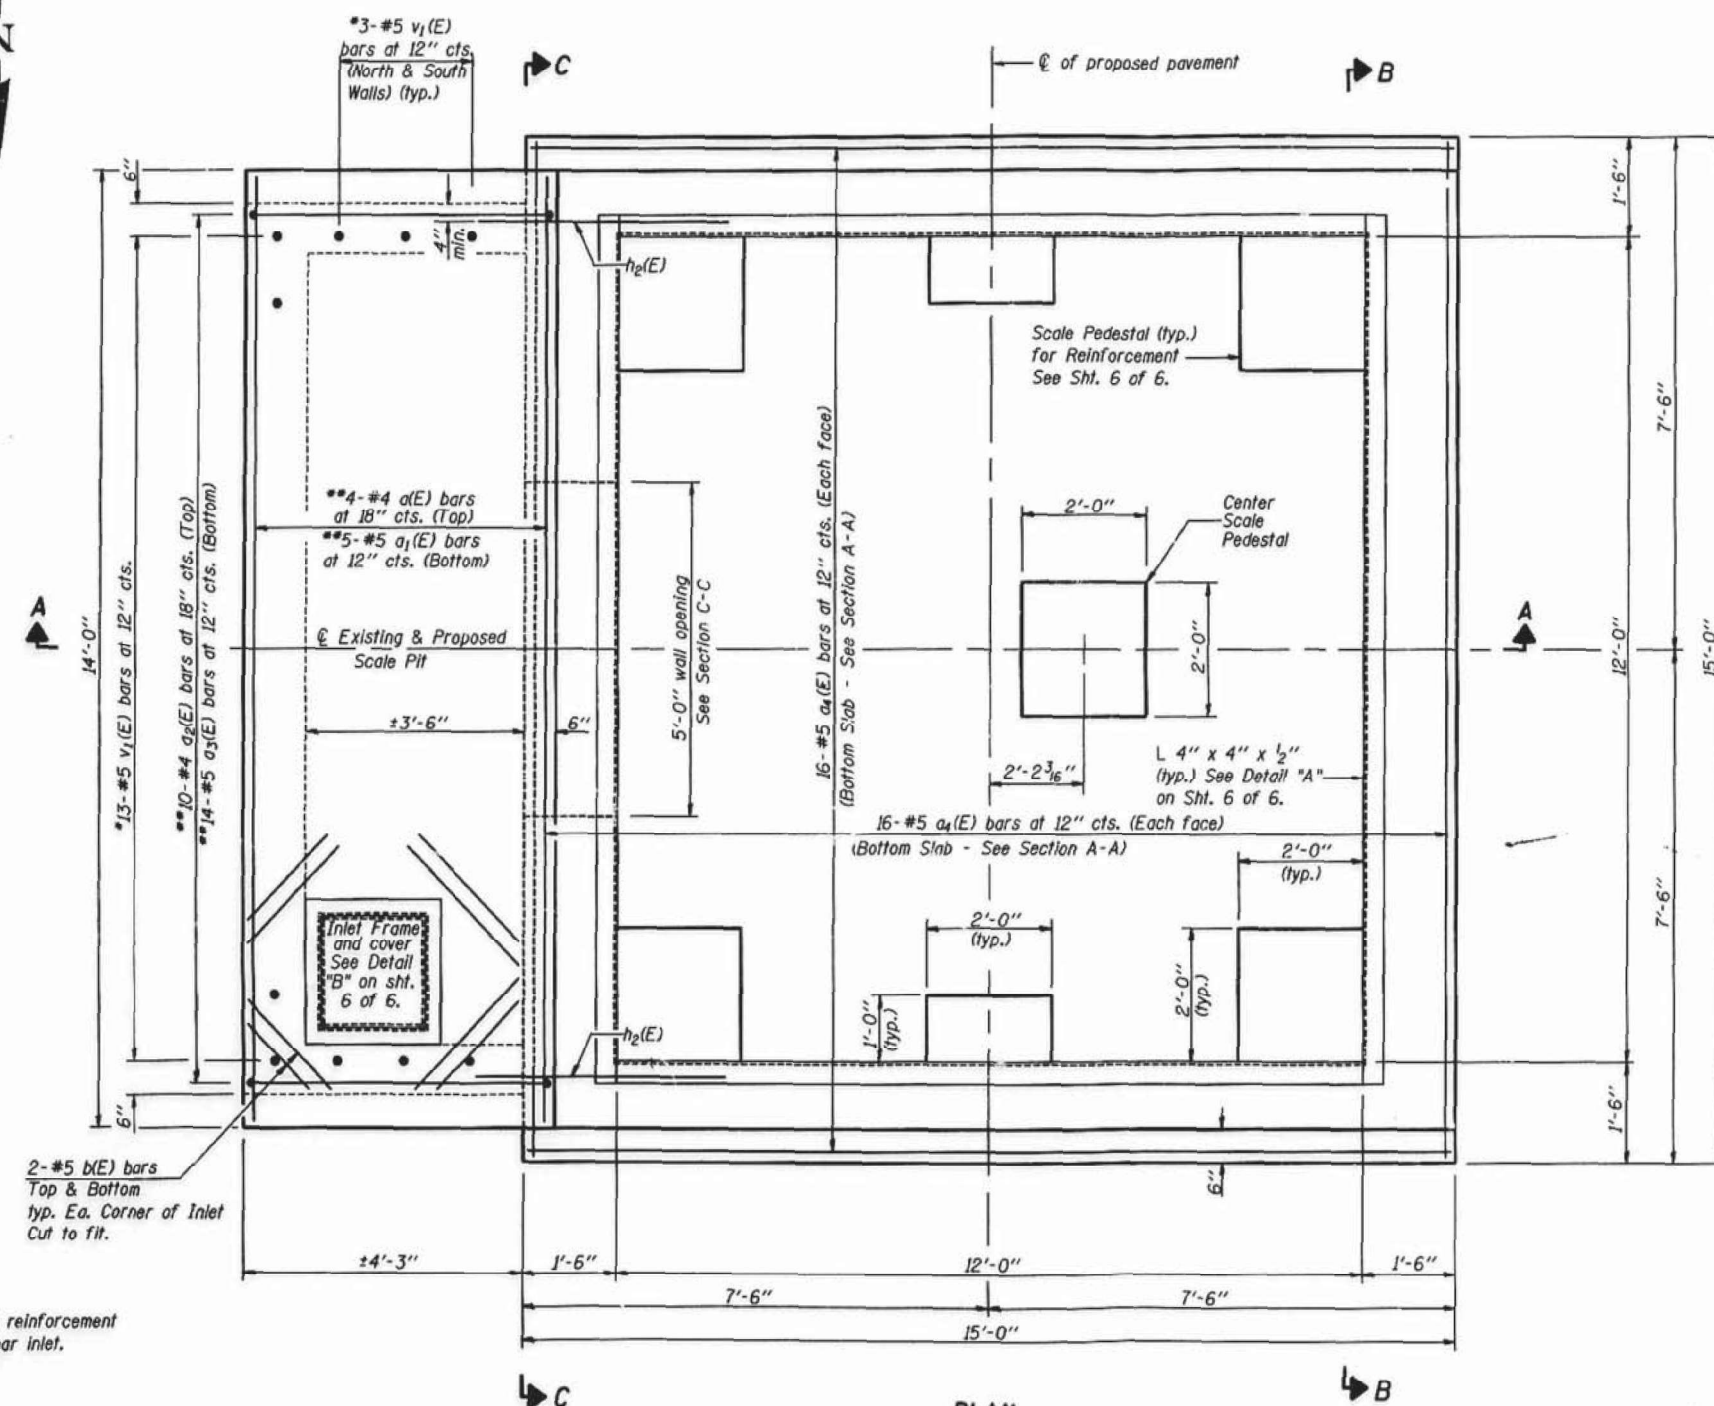

BILL OF MATERIAL

Bar	No.	Size	Length	Shape
a(E)	4	#4	13'-9"	—
a1(E)	5	#5	13'-9"	—
a2(E)	10	#4	4'-6"	—
a3(E)	14	#5	5'-8"	□
a4(E)	64	#5	14'-9"	—
b(E)	16	#5	2'-0"	—
h(E)	32	#5	14'-9"	—
h1(E)	20	#5	4'-9"	—
h2(E)	10	#5	2'-11"	—
h3(E)	6	#6	10'-2"	—
h4(E)	39	#4	1'-9"	—
h5(E)	10	#4	0'-9"	—
h6(E)	6	#5	13'-9"	—
s(E)	21	#4	5'-1"	□
s1(E)	21	#4	6'-9"	□
u(E)	19	#4	5'-9"	□
v(E)	53	#6	8'-2"	—
v1(E)	19	#5	1'-11"	—
v2(E)	53	#6	8'-9"	—

Structure Excavation	Cu. Yd.	24.6
Furnishing & Erecting Structural Steel	Lb.	700
Reinforcement Bars, Epoxy Coated	Lb.	3710
Concrete Structures	Cu. Yd.	26.2
Concrete Removal	Cu. Yd.	23.1

Reinforcement bars designated (E) shall be epoxy coated.

PLAN

Notes:
 • Epoxy grout v1(E) bars in 9" min. drilled holes according to Section 584 of the Standard Specifications.
 For Section A-A, See sheet 4 of 6.
 For Section B-B and C-C see sheet 5 of 6.

DESIGNED	Jonas Petty
CHECKED	Rebecca L. Mitchell
DRAWN	R. Sommer
CHECKED	J.H.P./R.L.M.

November 13 2002
 EXAMINED *Thomas J. Damascelli*
 PASSED *Ralph E. Anderson*
 CHIEF OF BRIDGES AND STRUCTURES

CONCRETE PIT DETAILS
HARVARD WEIGH STATION
F.A.P. ROUTE 66 (US 14)
SECTION TRUCK WEIGHING STATION
McHENRY COUNTY

MODEL: Default
 FILE NAME: T:\projects\19-012 DOT Phase II Sub-Variation 1 Weigh Station RR Clearing\05_CADD\02_CADD_Sheets\Site Specific Detail Sheets_5 of 6.dgn



USER NAME = maciejk	DESIGNED - MIK	REVISED -
PLOT SCALE = 2,000' / in.	DRAWN - FS	REVISED -
PLOT DATE = 10/21/2021	CHECKED - CC	REVISED -
	DATE -	REVISED -

STATE OF ILLINOIS
DEPARTMENT OF TRANSPORTATION

DETAILS - HARVARD US14



SCALE: N.T.S. SHEET OF SHEETS STA. TO STA.

F.A.P. RTE.	SECTION	COUNTY	TOTAL SHEETS	SHEET NO.
VAR.	2021-100-I	VARIOUS	37	33
			CONTRACT NO. 62P28	
		ILLINOIS	FED. AID PROJECT	

FOR INFORMATION ONLY

STATE OF ILLINOIS
DEPARTMENT OF TRANSPORTATION

PROJECT NO.	DATE	BY	CHKD	APP	SHEET NO. 3
F.A.P. 2021-100-I	11-0-18	COOK	MJ	B	6 SHEETS
FED. AID PROJ. NO. 7	PLAN	FED. AID PROJ.			

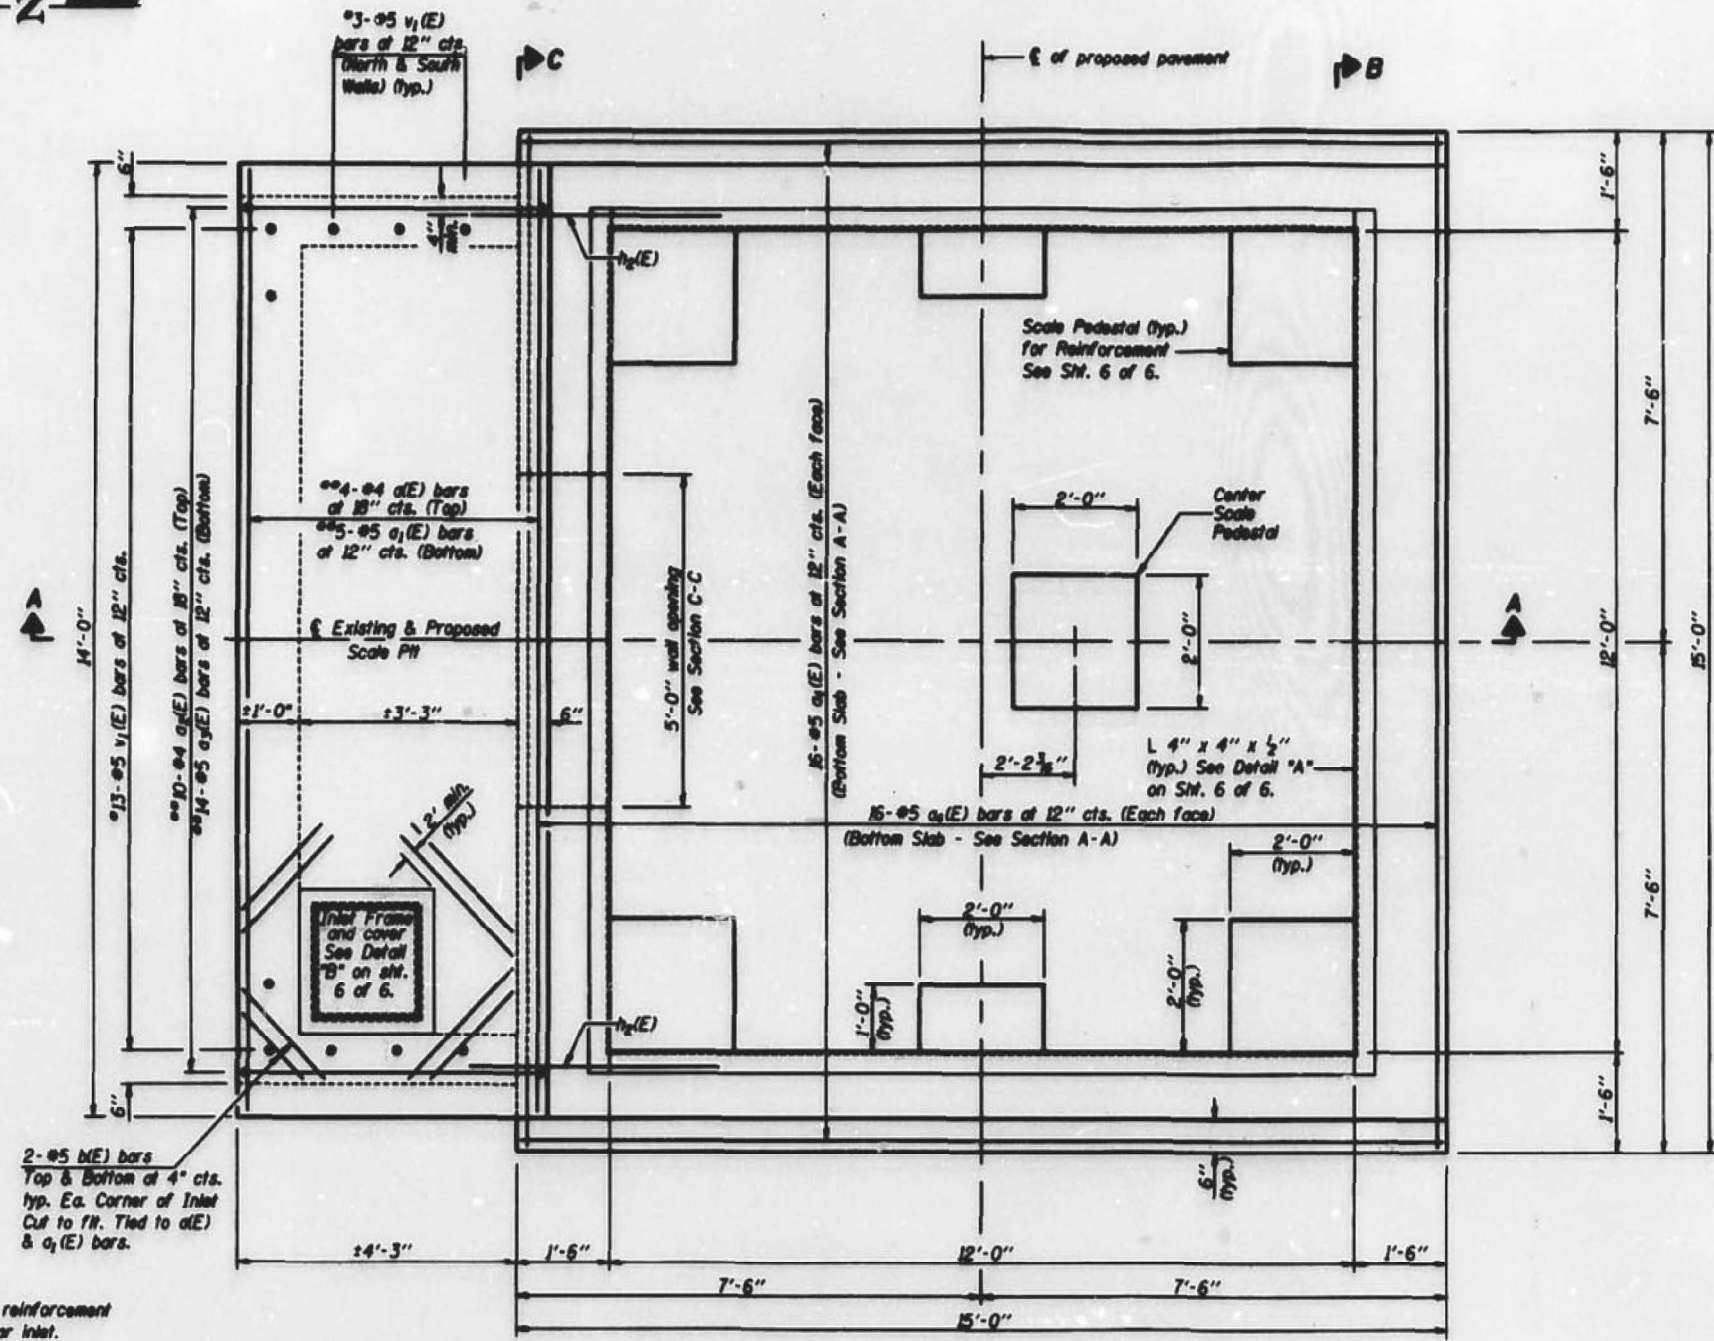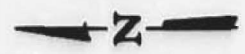


**Cut reinforcement to clear inlet.

PLAN

Notes:
 *Epoxy grout v₁(E) bars in 9" min. drilled holes according to Section 584 of the Standard Specifications.
 For Section A-A. See sheet 4 of 6.
 For Section B-B and C-C see sheet 5 of 6.

DESIGNED	Jonas Petty
CHECKED	Rebecca L. Michel
DRAWN	R. SORRENT
CHECKED	J.H.P./R.L.M.

March 18, 2019
 APPROVED
 PROJECT

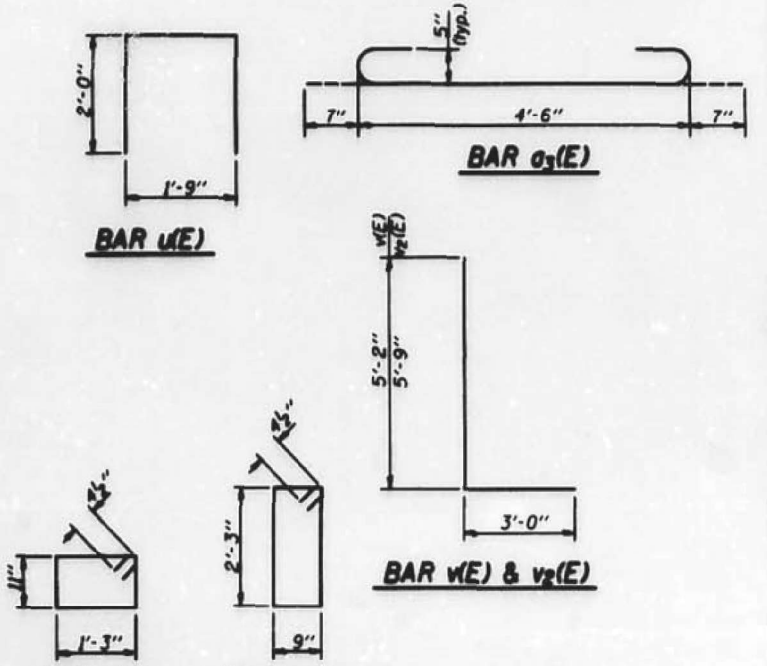

BILL OF MATERIAL

Bar	No.	Size	Length	Shape
d(E)	4	#4	13'-9"	—
a ₁ (E)	5	#5	13'-9"	—
a ₂ (E)	10	#4	4'-6"	—
a ₃ (E)	14	#5	5'-8"	—
a ₄ (E)	64	#5	14'-9"	—
d(E)	16	#5	2'-0"	—
w(E)	32	#5	14'-9"	—
h ₁ (E)	20	#5	4'-9"	—
h ₂ (E)	10	#5	2'-11"	—
h ₃ (E)	6	#6	10'-2"	—
h ₄ (E)	39	#4	1'-9"	—
h ₅ (E)	10	#4	0'-9"	—
h ₆ (E)	6	#5	13'-9"	—
s(E)	21	#4	5'-1"	□
s ₁ (E)	21	#4	6'-9"	□
u(E)	19	#4	5'-9"	⌒
w(E)	53	#6	8'-2"	—
v ₁ (E)	19	#5	1'-11"	—
v ₂ (E)	53	#6	8'-9"	—

Structure Excavation	Cu. Yd.	24.6
Furnishing & Erecting Structural Steel	Lb.	700
Reinforcement Bars, Epoxy Coated	Lb.	3710
Concrete Structures	Cu. Yd.	26.2
Concrete Removal	Cu. Yd.	17.5

Reinforcement bars designated (E) shall be epoxy coated.

CONCRETE PIT DETAILS
CHICAGO HEIGHTS WEIGH STATION
F.A.P. ROUTE 353 (US 30)
SECTION 11-5-WS
COOK COUNTY

MODEL Path: \\p01\projects\11-012 IDOT Phase II Sub-Via-Via\01 Weigh Station RR Clearing\05 CAD\02_CADD_Sheets\Site Specific Detail Sheets 6 of 6.dgn
 FILE NAME: \\p01\projects\11-012 IDOT Phase II Sub-Via-Via\01 Weigh Station RR Clearing\05 CAD\02_CADD_Sheets\Site Specific Detail Sheets 6 of 6.dgn



USER NAME	= maciej	DESIGNED	- MIK	REVISED	-
PLOT SCALE	= 2,000' / in.	DRAWN	- FS	REVISED	-
PLOT DATE	= 10/21/2021	CHECKED	- CC	REVISED	-
		DATE	-	REVISED	-

STATE OF ILLINOIS
DEPARTMENT OF TRANSPORTATION


DETAILS - CHICAGO HEIGHTS US30

SCALE: N.T.S. SHEET OF SHEETS STA. TO STA.

F.A.P. RTE.	SECTION	COUNTY	TOTAL SHEETS	SHEET NO.
VAR.	2021-100-I	VARIOUS	37	34
			CONTRACT NO. 62P28	
ILLINOIS FED. AID PROJECT				

STATE OF ILLINOIS
DEPARTMENT OF TRANSPORTATION

ROUTE NO.	SECTION	COUNTY	SHEET	SHEET NO.
F.A.P. 141	Trunk Weighing Station	McHENRY	9	6
FED. ROAD DIST. NO. 7	ILLINOIS	FED. AID PROJECT		6 SHEETS

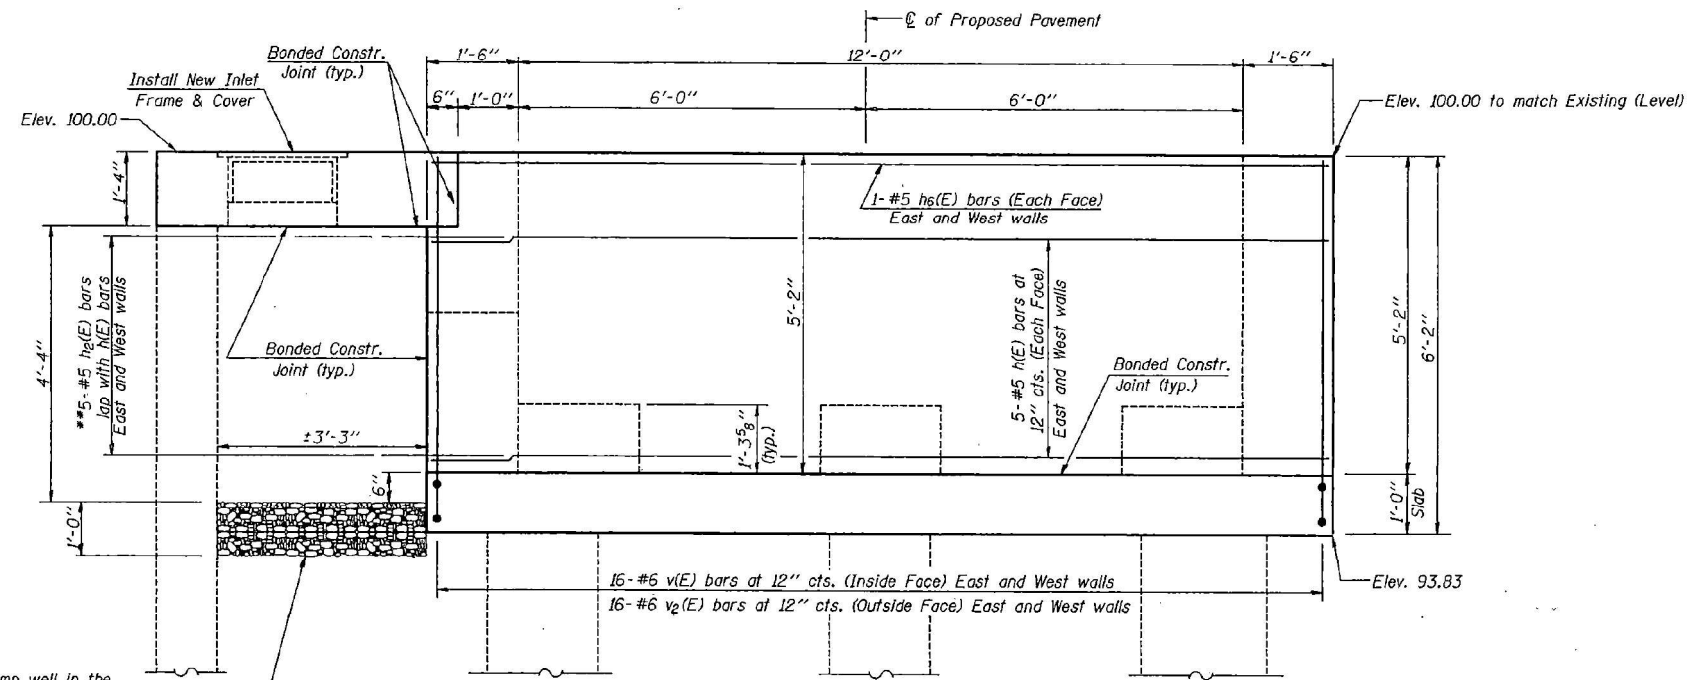


*The Contractor shall Construct a 1'-0" deep sump well in the CA-6 using 18" Perforated, Corrugated Metal Pipe 1'-3" long. The existing pump, pipe and electrical supply shall be re-installed. The location of the well shall be as directed by the Engineer. Cost included with Concrete Structures.
**Epoxy grout $h_2(E)$ bars in 9" (min.) holes according to Section 584 of the Standard Specifications.

*Fill area with CA-6 or equal
Cost Included with Concrete Structures.

ELEVATION
(Looking South)

FOR INFORMATION ONLY

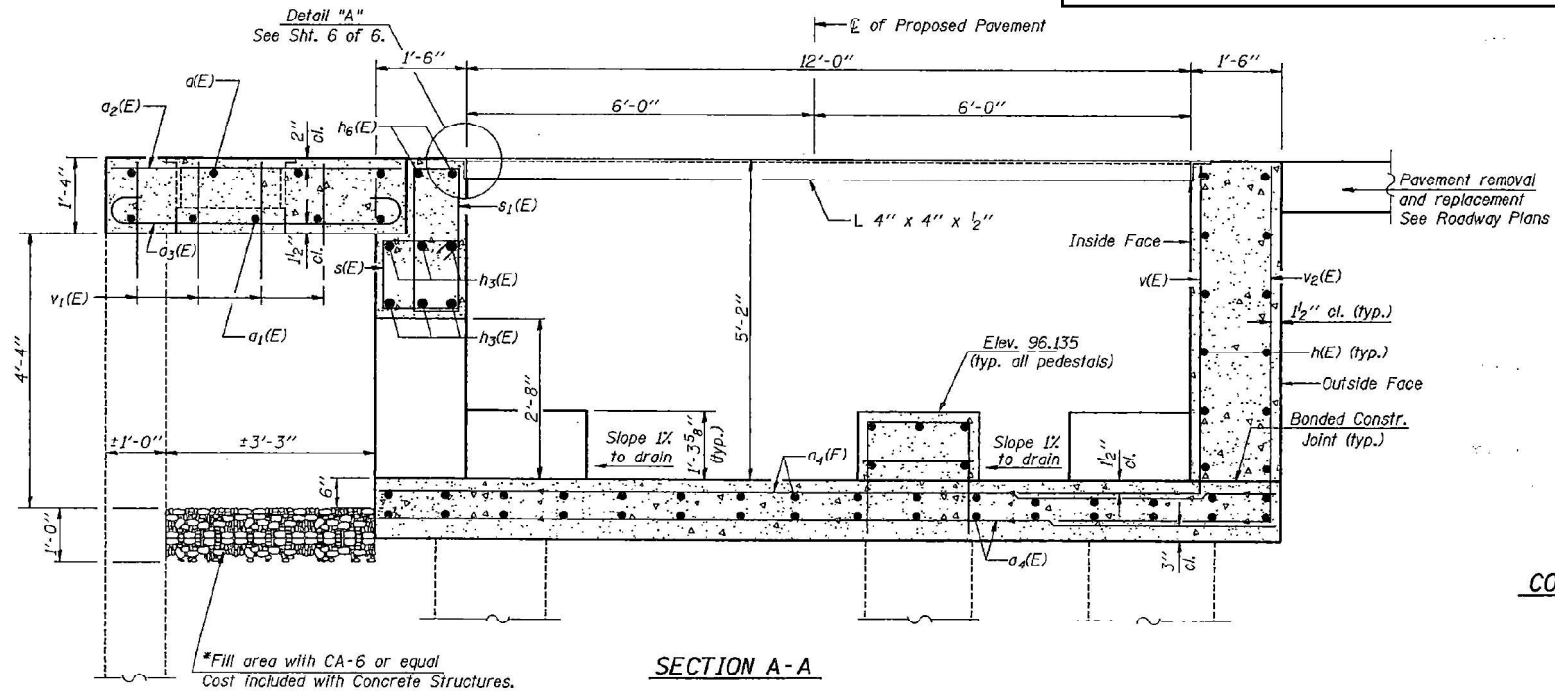

*Fill area with CA-6 or equal
Cost Included with Concrete Structures.

SECTION A-A

CONCRETE PIT DETAILS

DESIGNED	Jonas Paffy
CHECKED	Robecca L. Mitchell
DRAWN	R. Sommer
CHECKED	J.H.P./R.L.M.

November 13, 2002	EXAMINED	Thomas J. Domagalaki
	PASSED	Ralph E. Anderson

STATE OF ILLINOIS
DEPARTMENT OF TRANSPORTATION

GENERAL DETAILS - AXLE LOAD SCALE

SCALE: N.T.S. SHEET OF SHEETS STA. TO STA.


F.A.P. RTE.	SECTION	COUNTY	TOTAL SHEETS	SHEET NO.
VAR.	2021-100-I	VARIOUS	37	35
CONTRACT NO. 62P28				

ILLINOIS FED. AID PROJECT

USER NAME = macljek	DESIGNED - MIK	REVISED -
PLOT SCALE = 2,000' / in.	DRAWN - FS	REVISED -
PLOT DATE = 10/21/2021	CHECKED - CC	REVISED -
	DATE -	REVISED -

NOTE: Anchor bolts are to be cast into pedestals at locations supplied by the Scale Manufacturer. Location and size of openings for conduit entries into pit are to be furnished by scale manufacturer.

FOR INFORMATION ONLY

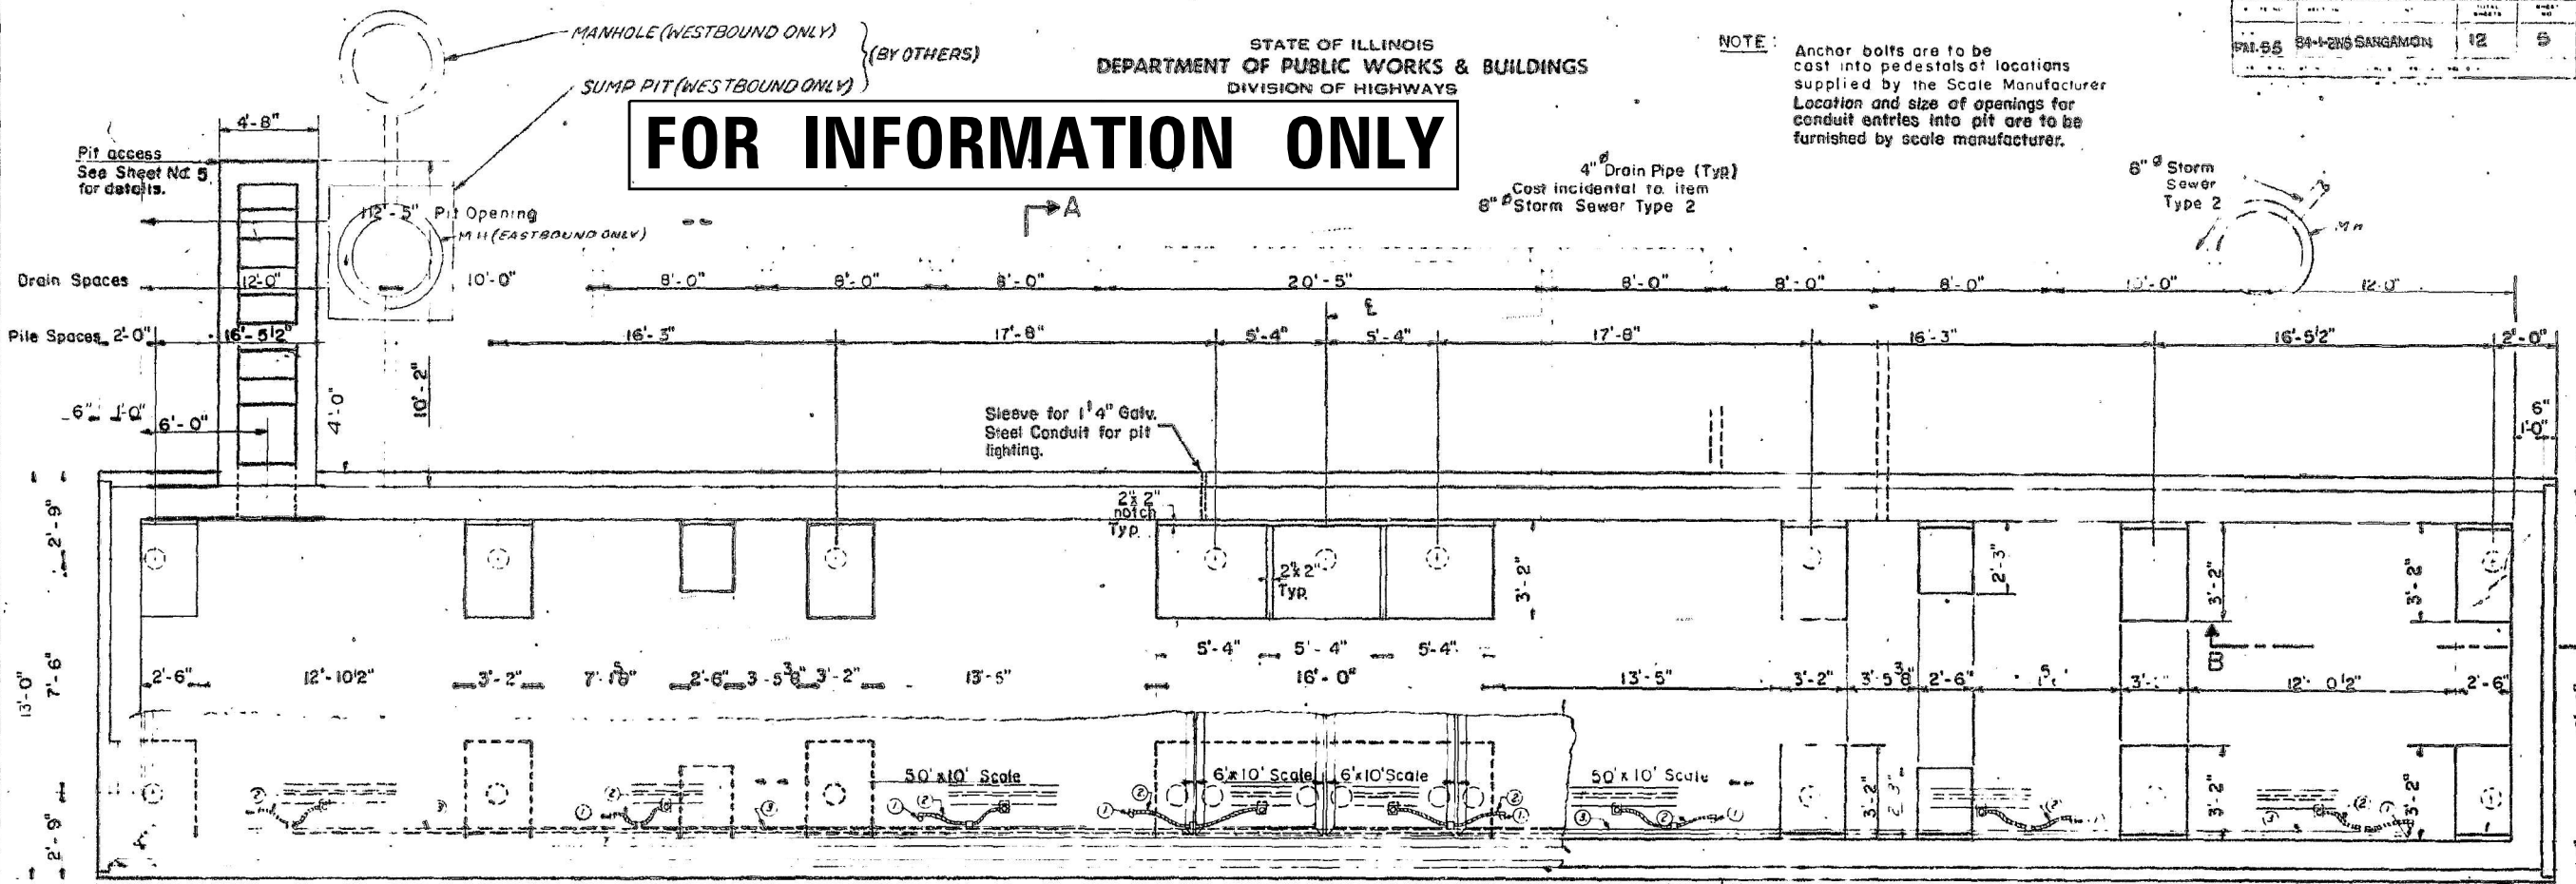


PLAN


- ① 5/8" or 3/4" X 10' copper clad ground rod. Eight (8) Req'd.
- ② #6 or larger stranded bare copper wire. Continuous from beam clamp to ground rod. Use clamps only. Loop as shown for platform motion.
- ③ 1/4" Rigid aluminum conduit ground buss, 6" C 13

NOTE: THIS SHEET NOT FOR PIT CONSTRUCTION DETAILS.


NOTE: Pit contractor to install ground rods and aluminum ground buss. All other grounding apparatus to be furnished by others.

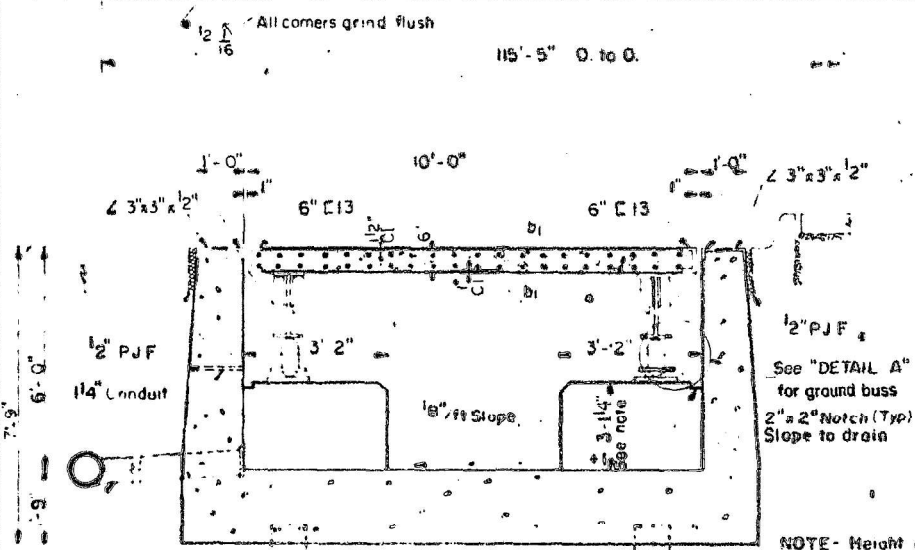

SECTION A-A

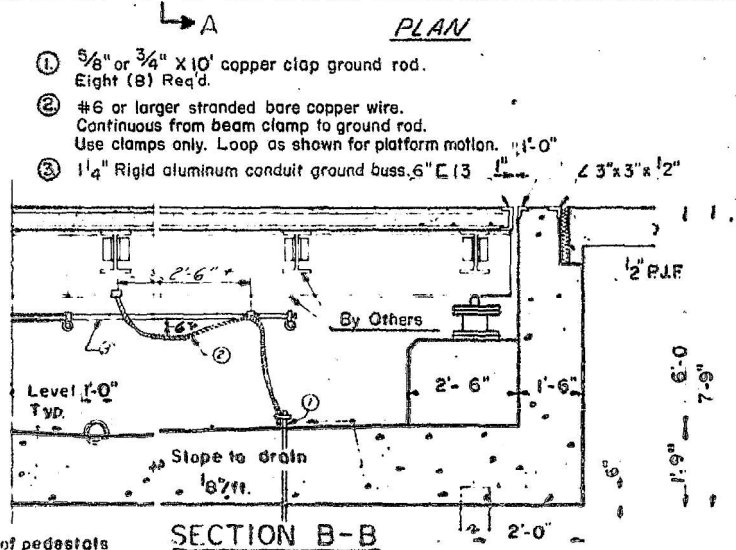

SECTION B-B

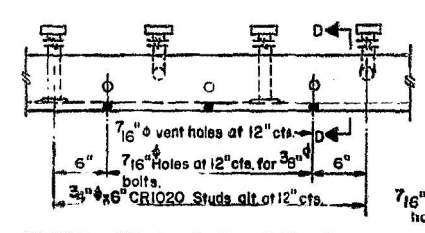


DETAIL OF ANGLE COPING

PILE DATA


Type	Created	
Est. Length -	ft.	ft.
No. Req'd. -	*	*
Capacity -	Ton	Ton

*Includes test pile

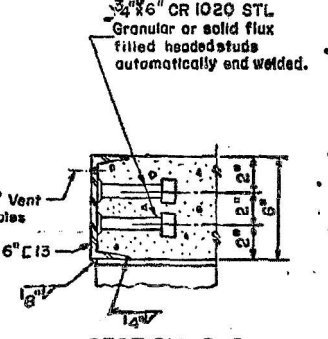


SECTION C-C

**WEIGH STATION
GROUNDING DETAILS**

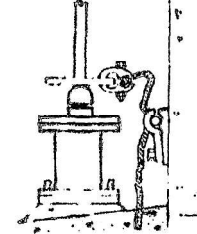

DETAIL 'A'

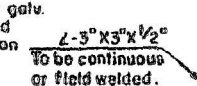

SECTION D-D

4" Drain pipe
Cost to be incidental to item
Storm Sewer @ Type 2

DESIGNED BY	APPROVED BY
CHECKED BY	APPROVED BY
DRAWN A. Borczyk	APPROVED BY
(DATE)	

NOTE: Height of pedestals to be furnished by the Scale Manufacturer.

NOTE: Ground buss of 1/4" rigid aluminum conduit continuous to within 5'-0" of each end of pit. Support wire every 5'-0" with galv. malleable iron clamp back and saddle. Locate ground buss on pit wall farthest from scale house.

DETAIL OF CHANNEL COPING

MODEL: Default FILE NAME: T:\projects\11-0112 DOT Phase II Sub-Vari01 Weigh Station RR Cleanings CAD002_CADD_SheetSet_General Detail Sheets 2 of 2.dgn



USER NAME = maciej	DESIGNED - MIK	REVISED -
	DRAWN - FS	REVISED -
PLOT SCALE = 2,000' / in.	CHECKED - CC	REVISED -
PLOT DATE = 10/21/2021	DATE -	REVISED -


STATE OF ILLINOIS
DEPARTMENT OF TRANSPORTATION

GENERAL DETAILS - INTERSTATE SCALE

SCALE: N.T.S. SHEET OF SHEETS STA. TO STA.

F.A./P. RTE.	SECTION	COUNTY	TOTAL SHEETS	SHEET NO.
VAR.	2021-100-I	VARIOUS	37	36
ILLINOIS FED. AID PROJECT			CONTRACT NO. 62P28	

REV. 12-21-70 JLP 12-21-70 JLP 12-21-70 JLP
REV. 6-27-70 JLP Revised 9-1-70 JLP

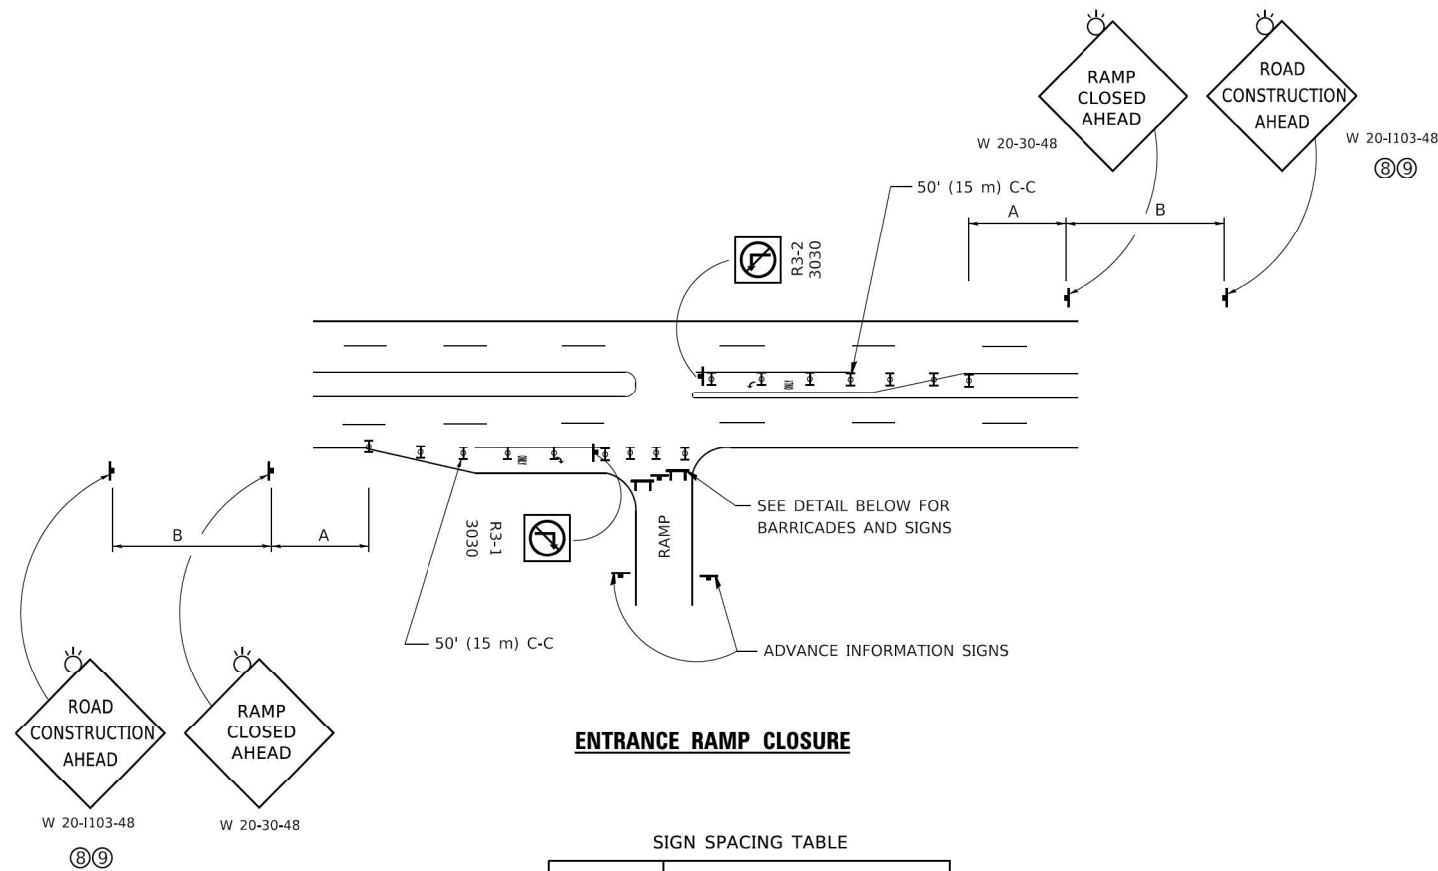


ENTRANCE RAMP CLOSURE

SIGN SPACING TABLE


FACILITY	DISTANCE BETWEEN SIGNS	
	A	B
EXPRESSWAY >24 HOURS	1000' (300 m)	1500' (450 m)
EXPRESSWAY ≤24 HOURS	500' (150 m)	500' (150 m)
ARTERIAL 55 MPH	500' (150 m)	500' (150 m)
ARTERIAL 50-45 MPH	350' (100 m)	350' (100 m)
ARTERIAL <45 MPH	200' (60 m)	200' (60 m)

DISTANCES MAY BE SHORTENED DEPENDING UPON THE PROXIMITY OF ADJACENT RAMPS OR INTERSECTIONS.

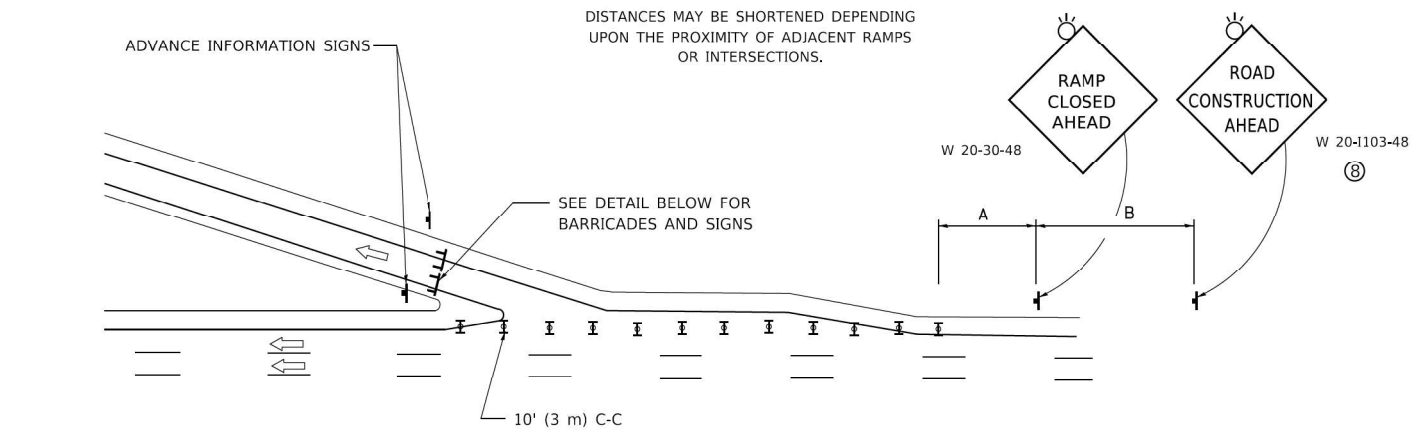


EXIT RAMP CLOSURE


- SYMBOLS**
- ▬ TYPE II BARRICADE OR DRUM
 - ▬ TYPE III BARRICADE WITH 2 FLASHING LIGHTS

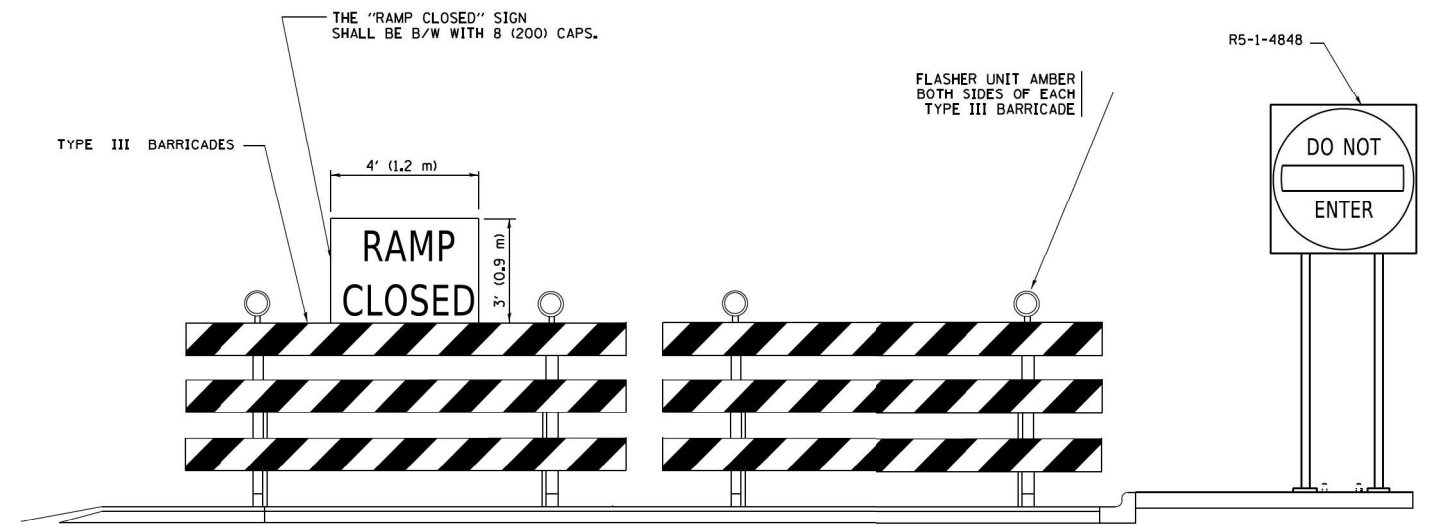

DETAIL FOR REQUIRED BARRICADES & SIGNS

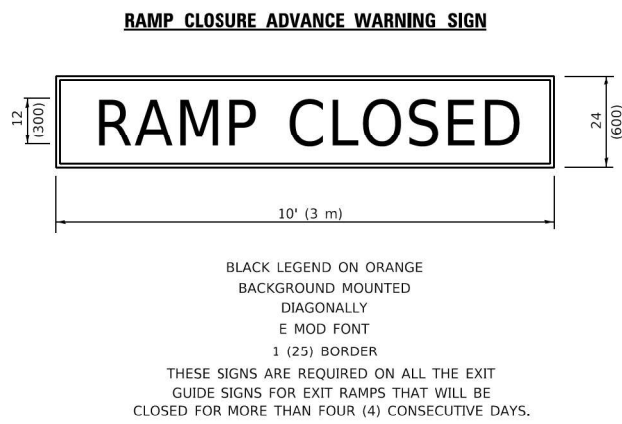

THESE SIGNS ARE REQUIRED ON BOTH SIDES OF THE RAMP, MINIMUM OF 1 WEEK IN ADVANCE OF THE CLOSURE.
THESE SIGNS SHALL BE FABRICATED AND PAID FOR ACCORDING TO THE TEMPORARY INFORMATION SIGNING SPECIAL PROVISION

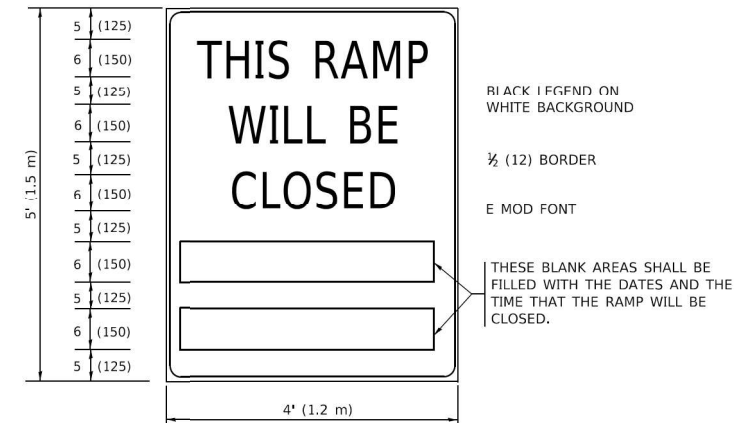

GENERAL NOTES:

- ① CONES MAY BE SUBSTITUTED FOR DRUMS OR TYPE II BARRICADES DURING DAY OPERATIONS. CONES SHALL BE A MINIMUM OF 28 (700) HIGH.
- ② VERTICAL BARRICADES SHALL NOT BE USED FOR RAMP CLOSURES.
- ③ A FLAGGER SHALL BE POSITIONED AT EACH CLOSED RAMP THAT IS OPEN TO CONSTRUCTION VEHICLES, PRECEDED BY A W20-7 FLAGGER WARNING SIGN.
- ④ ALL ROUTE MARKERS AND TRAILBLAZER ASSEMBLIES WHICH DIRECT MOTORISTS TO A CLOSED ENTRANCE RAMP SHALL BE COVERED WHEN THE RAMP IS CLOSED FOR MORE THAN FOUR (4) DAYS.
- ⑤ THE SIGNING AND BARRICADING WHICH IS REQUIRED BY THIS DETAIL SHALL BE INCLUDED IN THE COST OF TRAFFIC CONTROL AND PROTECTION (EXPRESSWAYS).
- ⑥ AUTHORIZATION FROM THE DISTRICT'S BUREAU OF TRAFFIC IS REQUIRED FOR ALL RAMP CLOSURES.
- ⑦ THE RAMP CLOSURE ADVANCE INFORMATION SIGNS SHALL BE ERECTED IF THE CLOSURE TIME EXCEEDS TWENTY-FOUR (24) HOURS. ADDITIONAL ADVANCE WARNING SIGNS ON EXIT GUIDE SIGNING WILL BE REQUIRED FOR EXIT RAMP CLOSURES THAT EXCEED FOUR (4) DAYS IN LENGTH
- ⑧ ROAD CONSTRUCTION AHEAD SIGNS MAY BE OMITTED WHEN THIS DETAIL IS USED IN CONJUNCTION WITH OTHER TRAFFIC CONTROL THAT ALREADY INCLUDES A ROAD CONSTRUCTION AHEAD SIGN.
- ⑨ ARTERIAL ROAD CONSTRUCTION AHEAD SIGNS SHALL BE INSTALLED ON THE LEFT SIDE OF TRAFFIC IF THE MEDIAN IS MORE THAN 10 FT WIDE.

ALL DIMENSIONS ARE IN INCHES (MILLIMETERS) UNLESS OTHERWISE SHOWN.

MODEL: Default; FILE: \\mace-pw01\0848\BID\ITEC\Illinois\proj\WV\DOT\Documents\DOT_Offices\District 1\Projects\BNSF\S272321\CAD\Drawn\CADsheets\K08.dgn

USER NAME = footermj	DESIGNED - D.W.S.	REVISED - S.P.B._01-07
DRAWN -	REVISED - S.P.B._12-09	
PLOT SCALE = 50.0000" / 1"	CHECKED -	REVISED - M.D._06-13
PLOT DATE = 3/4/2019	DATE - 02-83	REVISED - M.D._01-18

**STATE OF ILLINOIS
DEPARTMENT OF TRANSPORTATION**

**ENTRANCE AND EXIT RAMP
CLOSURE DETAILS**

SCALE: NONE SHEET 1 OF 1 SHEETS STA. TO STA.

F.A.I.P RTE.	SECTION	COUNTY	TOTAL SHEETS	SHEET NO.
VAR.	2021-100-I	VARIOUS	37	37
TC-08			CONTRACT NO. 62P28	
ILLINOIS / FED. AID PROJECT				