

FILE NAME: V: \DUPAGECO\140901.00 87th St & Woodward ave Design\CADD\A-FINAL July 2021\140901 87th


ENGINEERING RESOURCE ASSOCIATES

	USER NAME = csedlacko	DESIGNED	_	CS	REVISED	_	04/25/2019
G		DRAWN	_	CS	REVISED	_	08/13/2021
FS	PLOT SCALE = \$SCALE\$	CHECKED	_	JM	REVISED	_	11/03/2021
	PLOT DATE = $12/1/2021$	DATE	_	04/25/2019	REVISED	_	12/02/2021

STATE OF ILLINOIS
DEPARTMENT OF TRANSPORTATION

SCALE: 1"=20'

87th. STREET AND WOODWARD AVE.				A.U. TE.		SECTIO	
TEMPORARY TRAFFIC SIGNAL INSTALLATION PLAN		3580	13	-0025	3-0		
STAGE 1							
20'	SHEET NO. 1 OF 1 SHEETS	STA: 65+00 TO STA: 69+50	FED R	TAIL DIST	NO	l II I	

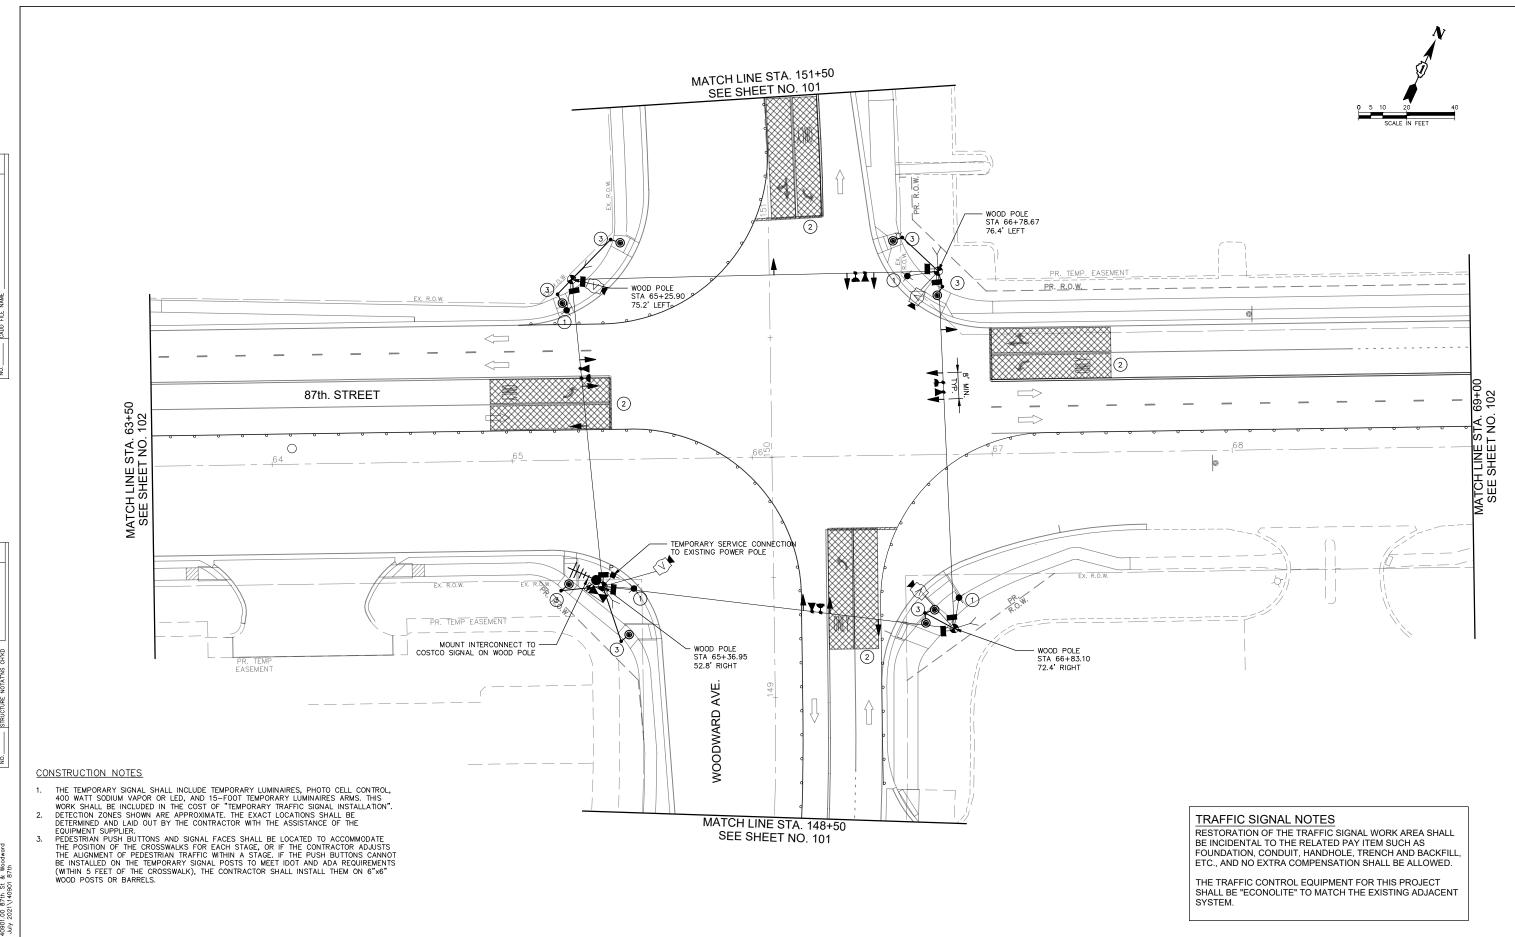




	USER NAME = csedlacko	DESIGNED	_	CS	REVISED	_	04/25/2019
G		DRAWN	_	CS	REVISED	_	08/13/2021
FS	PLOT SCALE = \$SCALE\$	CHECKED	_	JM	REVISED	_	11/03/2021
		DATE	_	04/25/2019	REVISED	_	12/02/2021

STATE OF ILLINOIS
DEPARTMENT OF TRANSPORTATION

87th. STREET AND WOODWARD AVE. TEMPORARY TRAFFIC SIGNAL INSTALLATION PLAN				F.A.U. RTE. SECTION		TOTAL SHEETS	SHEET NO.
			3580	3580 13-00253-01-CH		177	104
STAGE 2					CONTRACT	Г NO. 6	1E87
SCALE: 1"=20'	SHEET NO. 1 OF 1 SHEETS	STA. 65+00 TO STA. 69+50	FED. RO	AD DIST. NO ILLINOIS FED. AI	D PROJECT		

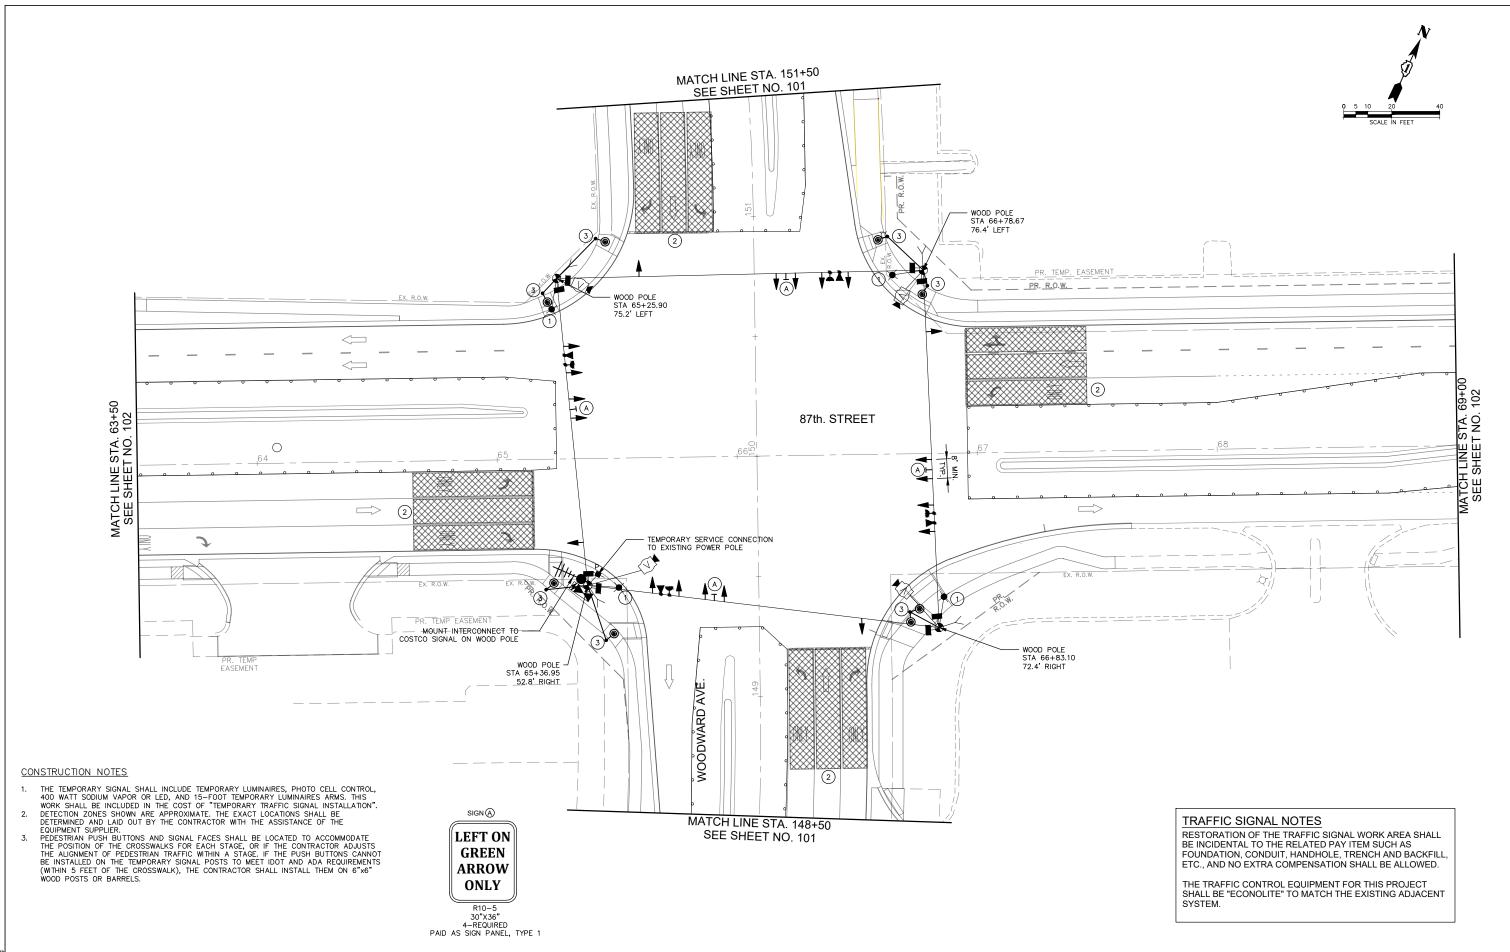

STATE OF ILLINOIS

DEPARTMENT OF TRANSPORTATION

87th. STREET AND WOODWARD AVE.

TEMPORARY TRAFFIC SIGNAL INSTALLATION PLAN

STAGE 3

SHEET NO. 1 OF 1 SHEETS STA. 65+00 TO STA. 69+50

SCALE: 1"=20'

COUNTY

DuPage

CONTRACT NO. 61E87

3580

LE NAME: V: \DUPAGECO\140901.00 87th St & Woodward ve Design\CADD\A-FINAL July 2021\140901 87th

ENGINEERING RESOURCE ASSOCIATES

USER NAME = csedlacko

PLOT SCALE = \$SCALE\$

PLOT DATE = 12/1/2021

DESIGNED - CS

DRAWN - CS

CHECKED - JM


- 04/25/2019

REVISED - 04/25/2019

REVISED - 08/13/2021


REVISED - 11/03/2021

REVISED - 12/02/2021

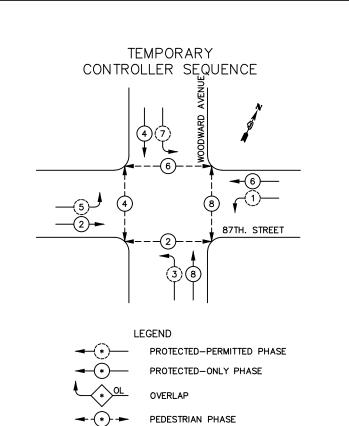

TEMPORARY PHASE DESIGNATION DIAGRAM

NUMBER REFERS TO ASSOCIATED PHASE

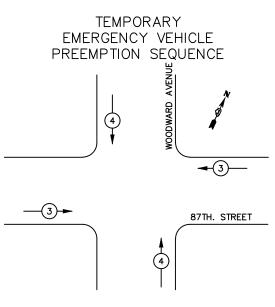

TEMPORARY EMERGENCY VEHICLE PREEMPTORS EMERGENCY VEHICLE PREEMPTOR MOVEMENT

TEMPORARY CABLE PLAN NOTES

THE TEMPORARY LUMINAIRES SHALL NOT BE CONNECTED TO THE UNINTERRUPTED POWER SUPPLY.

THE TRAFFIC SIGNAL CONTROLLER EQUIPMENT FOR THE PROJECT SHALL BE "ECONOLITE" TO MATCH THE EXISTING ADJACENT SYSTEM.

3 2 ® C 3 X D NO. 10	5 NO. 20 NO. 10 NO. 10 R R Y G G H Y G H Y G G H Y G G H Y G G H Y G G H Y G G H Y G G H Y G G H Y G G H Y G G H Y G G H Y G G H Y G G H Y G G H Y G G H Y H G G H Y H G G H Y H G G H G H
7	(a) -2 -
WIRELESS INTERCONNECT TO COSTCO SIGNAL No. 10	0+ A+ 0 A A NO. 10 NO. 10 NO. 10 NO. 10 NO. 10 NO. 10
NO. 10	(5) R Y G

TEMPORARY CABLE PLAN - PRESTAGE, STAGES 1 AND 2

	I.D.O.T.								
	TRAFFIC SIGNAL INSTALLATION								
	E	LECTRICAL SERV	ICE REQUIR	EMENTS		WATTAGE			
	TYPE	NO. OF LAMPS	xINCAND.	LED	% OPERATION				
	SIGNAL (RED)	12		17	0.50	102.00			
	(YELLOW)	12		25	0.25	75.00			
	(GREEN)	12		15	0.25	45.00			
	ARROW	16		12	0.10	19.20			
	PED. SIGNAL	8		25	1.00	200.00			
	CONTROLLER	1		100	1.00	100.00			
	ILLUM. SIGN	-		25	0.05				
	VIDEO SYSTEM	1	150		1.00	150.00			
6	FLASHER				0.50				

USER NAME = csedlacko REVISED - 04/25/2019 DESIGNED - CS ENGINEERING RESOURCE ASSOCIATES DRAWN — CS REVISED - 08/13/2021 RESOURCE ASSOCIATES PLOT SCALE = \$SCALE\$ CHECKED - JM REVISED — 11/03/2021 PLOT DATE = 12/1/2021 - 04/25/2019 REVISED - 12/02/2021 DATE

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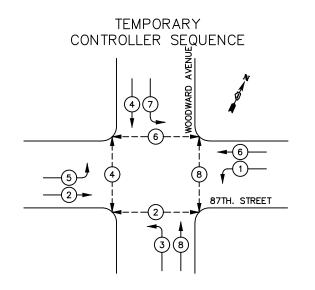
TOTAL =

STATE OF ILLINOIS DEPARTMENT OF TRANSPORTATION

87th. STREET AND WOODWARD AVE. PRESTAGE, STAGES 1 AND 2 SECTION TEMPORARY CABLE PLAN, PHASE DESIGNATION DIAGRAM, AND 3580 13-00253-01-CH TEMPORARY EMERGENCY VEHICLE PREEMPTION SEQUENCE NOT TO SCALE SHEET NO. 1 OF 1 SHEETS STA.

COUNTY DuPage CONTRACT NO. 61E87

ENERGY COSTS TO:






PROTECTED-PERMITTED PHASE PROTECTED-ONLY PHASE OVERLAP

> PEDESTRIAN PHASE NUMBER REFERS TO ASSOCIATED PHASE

TEMPORARY PHASE DESIGNATION DIAGRAM

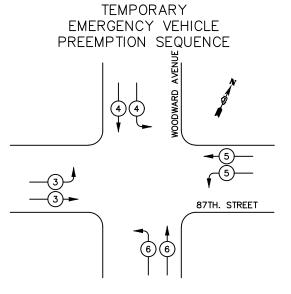

PROPOSED EMERGENCY VEHICLE PREEMPTORS					
EMERGENCY VEHICLE PREEMPTOR	3	4	5	6	
MOVEMENT	<u> </u>	→	1-	→	

TEMPORARY CABLE PLAN NOTES

THE TEMPORARY LUMINAIRES SHALL NOT BE CONNECTED TO THE UNINTERRUPTED POWER SUPPLY.

THE TRAFFIC SIGNAL CONTROLLER EQUIPMENT FOR THE PROJECT SHALL BE "ECONOLITE" TO MATCH THE EXISTING ADJACENT SYSTEM.

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(5) (第)	UE		3 0 < 7 5 0 < 7 5	NO. 20	
WIRELESS INTERCONNECT TO COSTCO SIGNAL V 2	C C C C C C C C C C C C C C C C C C C		© 3 © 3 © 3 © 3 © 3 © 3 © 2		
No. 10 —/	(5) R Y G				

TEMPORARY CABLE PLAN - STAGE 3

	I.D.O.T.								
	TRAFFIC SIGNAL INSTALLATION								
	E	LECTRICAL SERV	ICE REQUIR	EMENTS		WATTAGE			
	TYPE	NO. OF LAMPS	xINCAND.	LED	% OPERATION				
	SIGNAL (RED)	20		17	0.50	170.00			
	(YELLOW)	20		25	0.25	125.00			
	(GREEN)	20		15	0.25	75.00			
	ARROW	16		12	0.10	19.20			
	PED. SIGNAL	8		25	1.00	200.00			
5	CONTROLLER	1		100	1.00	100.00			
	ILLUM. SIGN	-		25	0.05	-			
	VIDEO SYSTEM	1	150		1.00	150.00			
, -									
,									
0	FLASHER			·	0.50	-			
ls.dw	FLASHER 0.50 ENERGY COSTS TO: TOTAL =								


USER NAME = csedlacko DESIGNED — CS REVISED - 04/25/2019 ENGINEERING RESOURCE ASSOCIATES DRAWN — CS REVISED - 08/13/2021 RESOURCE ASSOCIATES PLOT SCALE = \$SCALE\$ CHECKED - JM REVISED — 11/03/2021 PLOT DATE = 12/1/2021 - 04/25/2019 REVISED — 12/02/2021 DATE


STATE OF ILLINOIS DEPARTMENT OF TRANSPORTATION


87th. STREET AND WOODWARD AVE. STAGE 3 SECTION TEMPORARY CABLE PLAN, PHASE DESIGNATION DIAGRAM, AND 3580 TEMPORARY EMERGENCY VEHICLE PREEMPTION SEQUENCE NOT TO SCALE SHEET NO. 1 OF 1 SHEETS STA.


13-00253-01-CH DuPage CONTRACT NO. 61E87


COUNTY

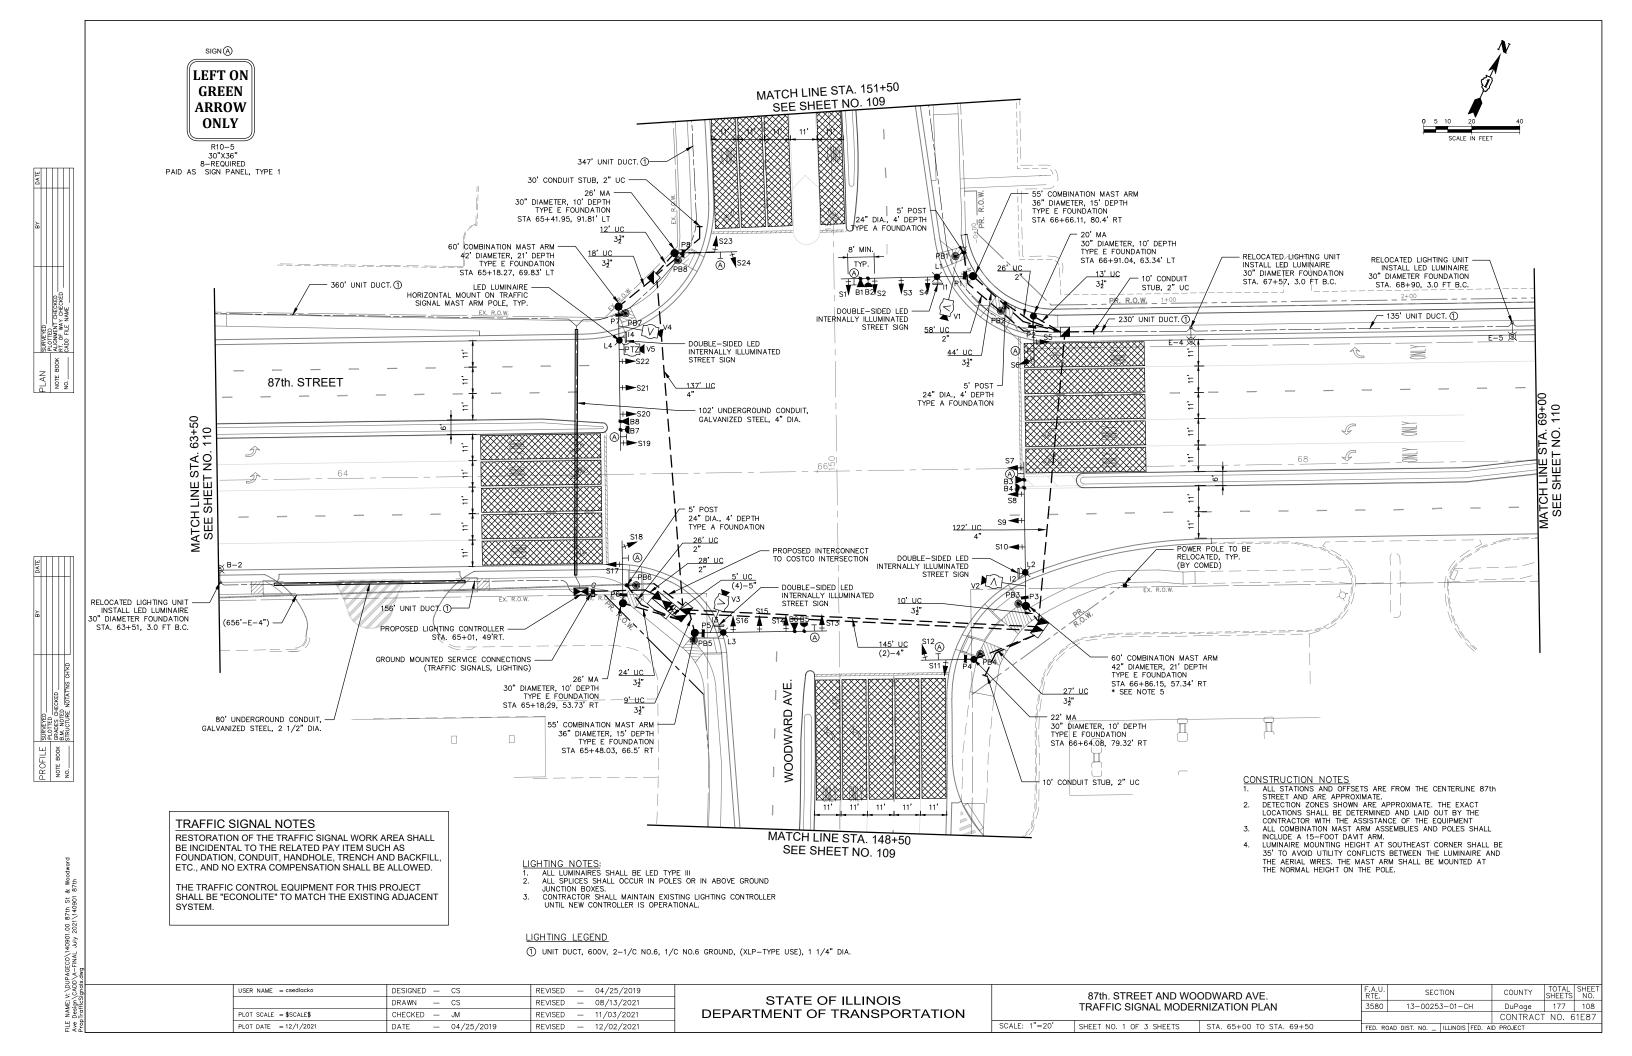

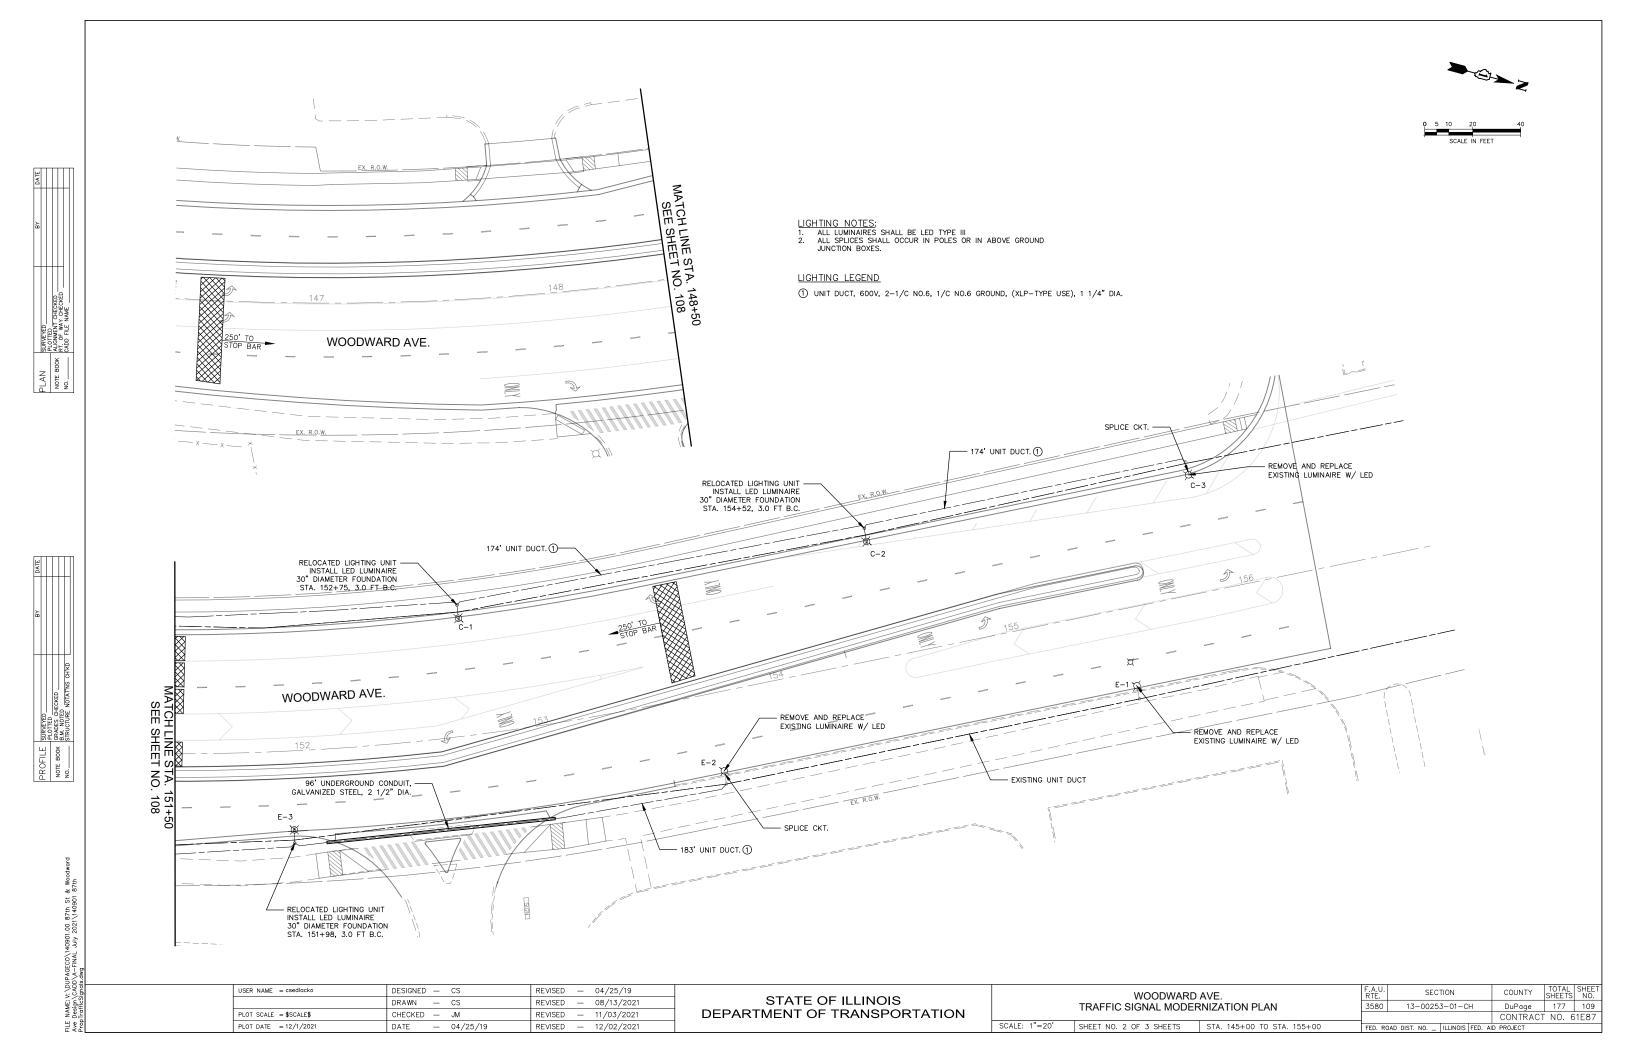

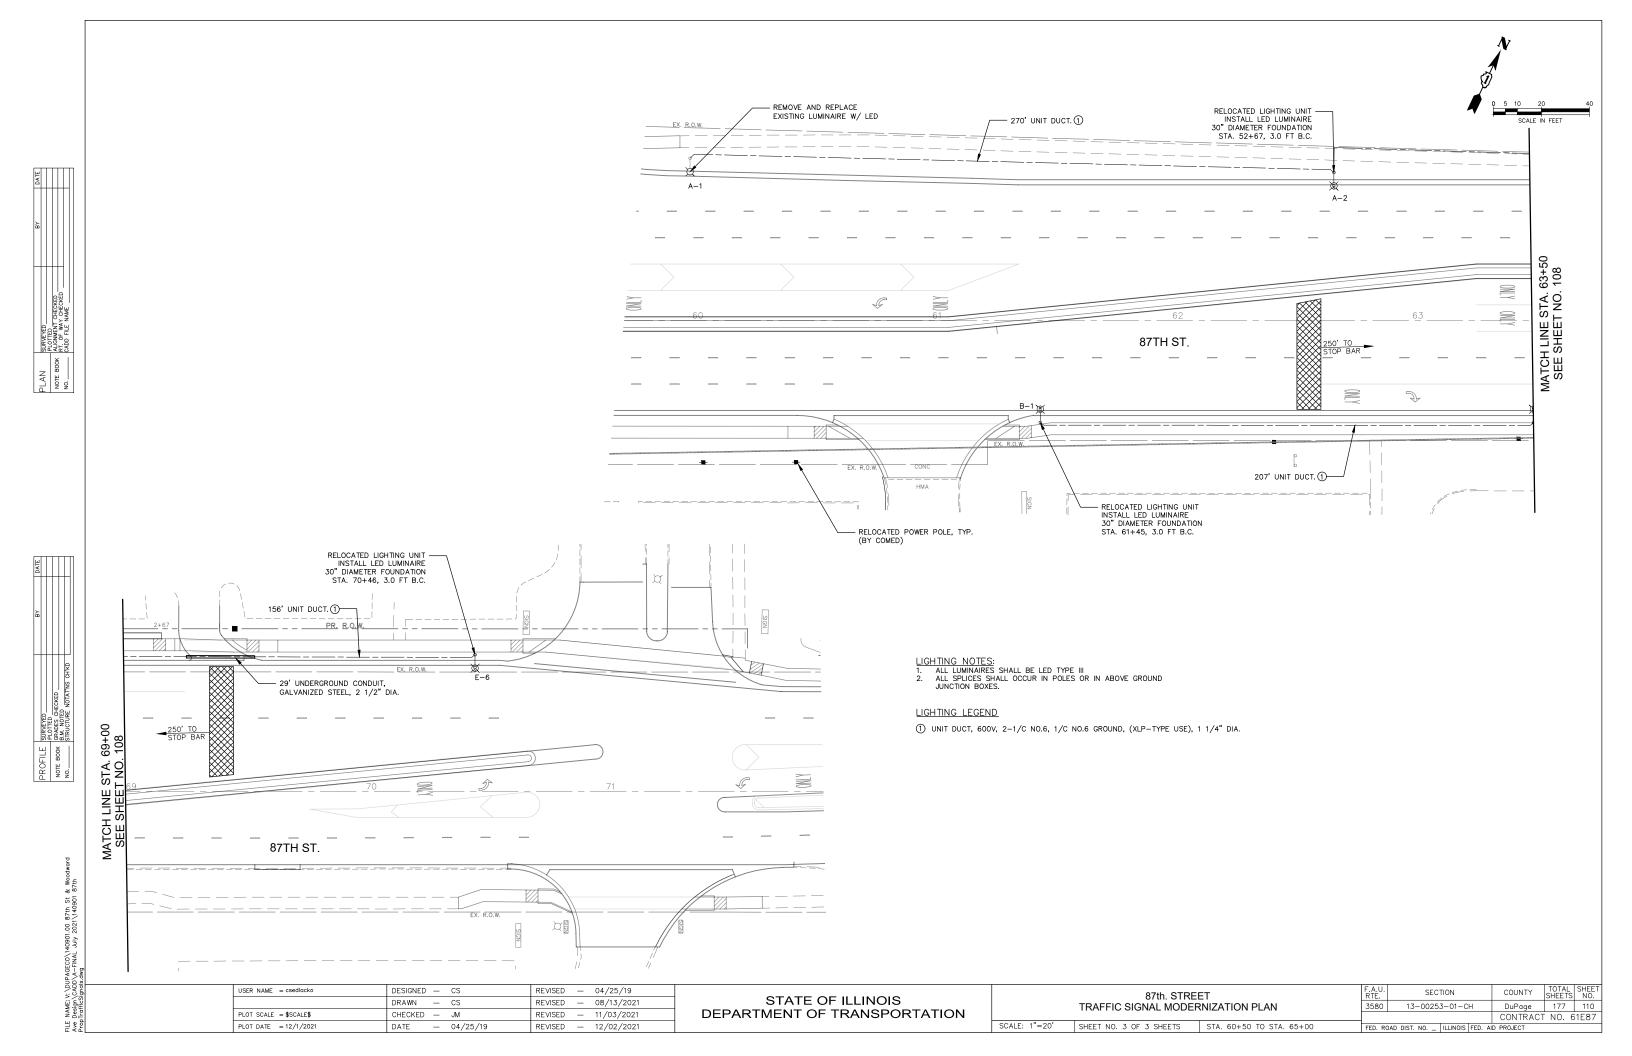

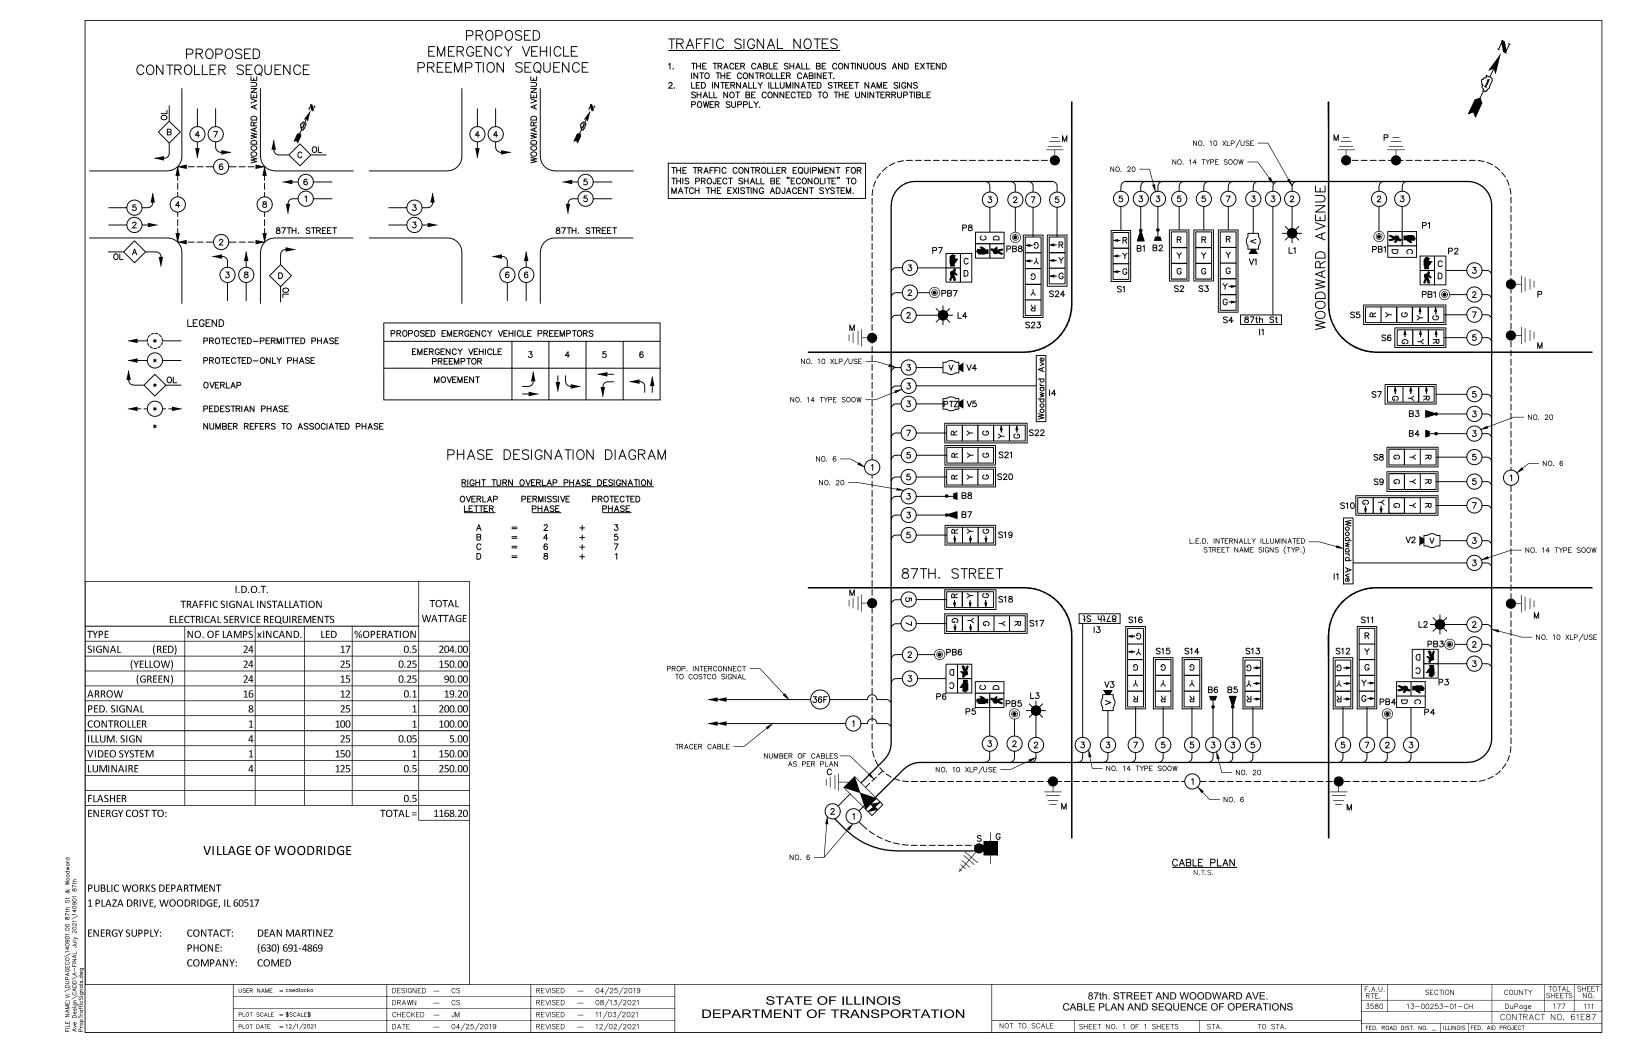

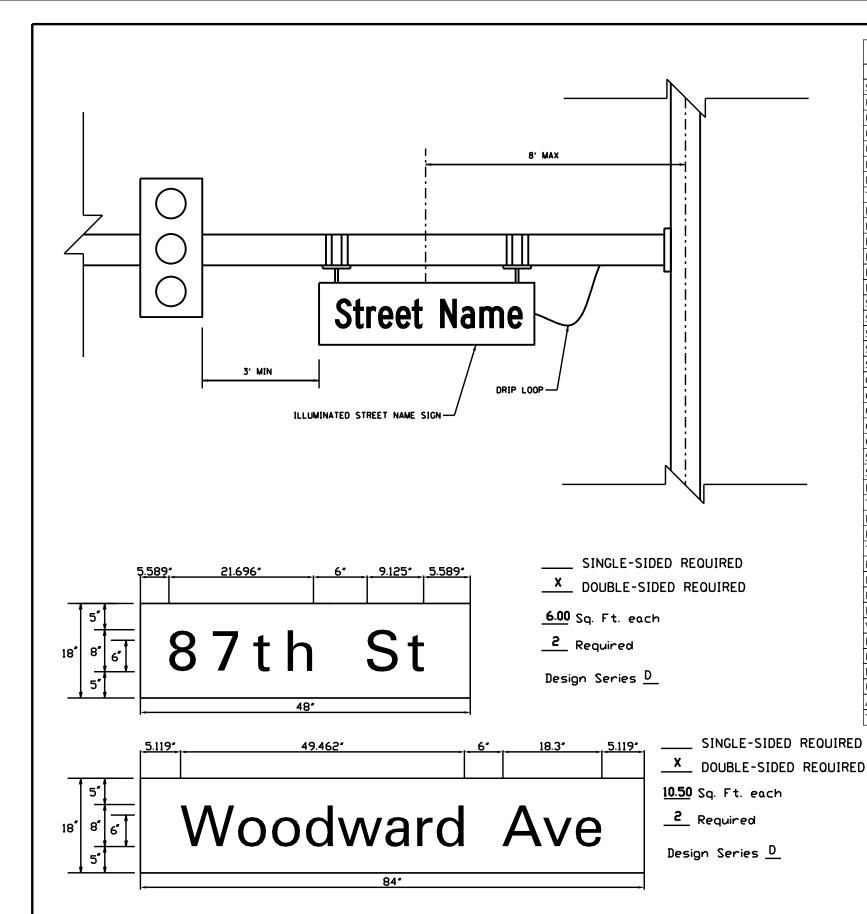

Schedule of Quantities		
Pay Item	QTY	Unit
SERVICE INSTALLATION, GROUND MOUNTED	1	EACH
UNDERGROUND CONDUIT, GALVANIZED STEEL, 2" DIA.	162	FOOT
UNDERGROUND CONDUIT, GALVANIZED STEEL, 3.5" DIA.	157	FOOT
UNDERGROUND CONDUIT, GALVANIZED STEEL, 4" DIA.	549	FOOT
UNDERGROUND CONDUIT, GALVANIZED STEEL, 5" DIA.	20	FOOT
HANDHOLE	2	EACH
DOUBLE HANDHOLE	2	EACH
TRANSCEIVER-FIBER OPTIC	1	EACH
ELECTRIC CABLE IN CONDUIT, EQUIPMENT GROUNDING CONDUCTOR, NO. 6 1C	927	FOOT
ELECTRIC CABLE IN CONDUIT, NO. 14 2C	2506	FOOT
ELECTRIC CABLE IN CONDUIT, NO. 14 3C	2454	FOOT
ELECTRIC CABLE IN CONDUIT, NO. 145C	3945	FOOT
ELECTRIC CABLE IN CONDUIT, NO. 147C	1814	FOOT
PEDESTRIAN SIGNAL POST, 5 FT.	3	EACH
STEEL MAST ARM ASEMBLY AND POLE 20 FT	1	EACH
STEEL MAST ARM ASEMBLY AND POLE 22 FT	1	EACH
STEEL MAST ARM ASEMBLY AND POLE 26 FT	2	EACH
STEEL COMBINATION MAST ARM ASSEMBLY AND POLE 55 FT.	2	EACH
STEEL COMBINATION MAST ARM ASSEMBLY AND POLE 60 FT.	2	EACH
CONCRETE FOUNDATION, TYPE A 12-INCH DIAMETER	12	FOOT
CONCRETE FOUNDATION TYPE C	4	FOOT
CONCRETE FOUNDATION TYPE E, 30" DIAMETER	40	FOOT
CONCRETE FOUNDATION TYPE E, 36" DIAMETER	30	FOOT
CONCRETE FOUNDATION TYPE E, 42" DIAMETER	63	FOOT
SIGNAL HEAD, LED, 1-FACE, 3-SECTION MAST ARM MOUNTED	16	EACH
SIGNAL HEAD, LED, 1-FACE, 5-SECTION MAST ARM MOUNTED	8	EACH
PEDESTRIAN SIGNAL HEAD, POLYCARBONATE, LED, 1-FACE, BRACKET MOUNTED WITH COUNT DOWN TIMER	8	EACH
TRAFFIC SIGNAL BACKPLATE LOUVERED, FORMED PLASTIC	24	EACH
LIGHT DETECTOR	4	EACH
LIGHT DETECTOR AMPLIFIER	1	EACH
TEMPORARY TRAFFIC SIGNAL INSTALLATION	1	EACH
REMOVE ELECTRIC CABLE FROM CONDUIT	10500	FOOT
REMOVE EXISTING TRAFFIC SIGNAL EQUIPMENT	1	EACH
REMOVE EXISTING HANDHOLE	6	EACH
EMERGENCY VEHICLE PRIORITY SYSTEM LINE SENSOR CABLE, NO. 20 3/C	1965	FOOT
VIDEO DETECTION SYSTEM	1	EACH
ELECTRIC CABLE IN CONDUIT, STREET NAME SIGN, NO. 14 3C, TYPE SOOW	873	FOOT
LED INTERNALLY ILLUMINATED STREET NAME SIGN	4	
FULL-ACTUATED CONTROLLER AND TYPE IV CABINET, SPECIAL	1	EACH
UNINTERRUPTABLE POWER SUPPLY, SPECIAL	1	
ACCESSIBLE PEDSTRIAN PUSH-BUTTON	8	
TEMPORARY TRAFFIC SIGNAL TIMING	1	

NOTE: SIGN DIMENSIONS ARE IN ENGLISH UNITS

ENGINEERING RESOURCE ASSOCIATES

USER NAME = csedlacko	DESIGNED CS	REVISED 04/25/19
	DRAWN CS	REVISED 08/13/2021
PLOT SCALE = \$SCALE\$	CHECKED JM	REVISED 11/03/2021
PLOT DATE = \$DATE\$	DATE 04/25/19	REVISED 12/02/2021


STATE OF ILLINOIS
DEPARTMENT OF TRANSPORTATION

SCALE: N.T.S.

	ILLUMINATED STREET NAME SIGN		F.A. RTE:	SECTION	COUNTY	TOTAL	SHEET NO.						
									3580	13-00253-01-СН	DuPAGE	177	112
											CONTRAC	NO.	61E87
SF	ÆET	1	OF	1	SHEETS	STA.	TO STA.			ILLINOIS FED. A	O PROJECT HSIP	-0043 (0)	121



CO\140901.00 87th St INAL July 2021\140901

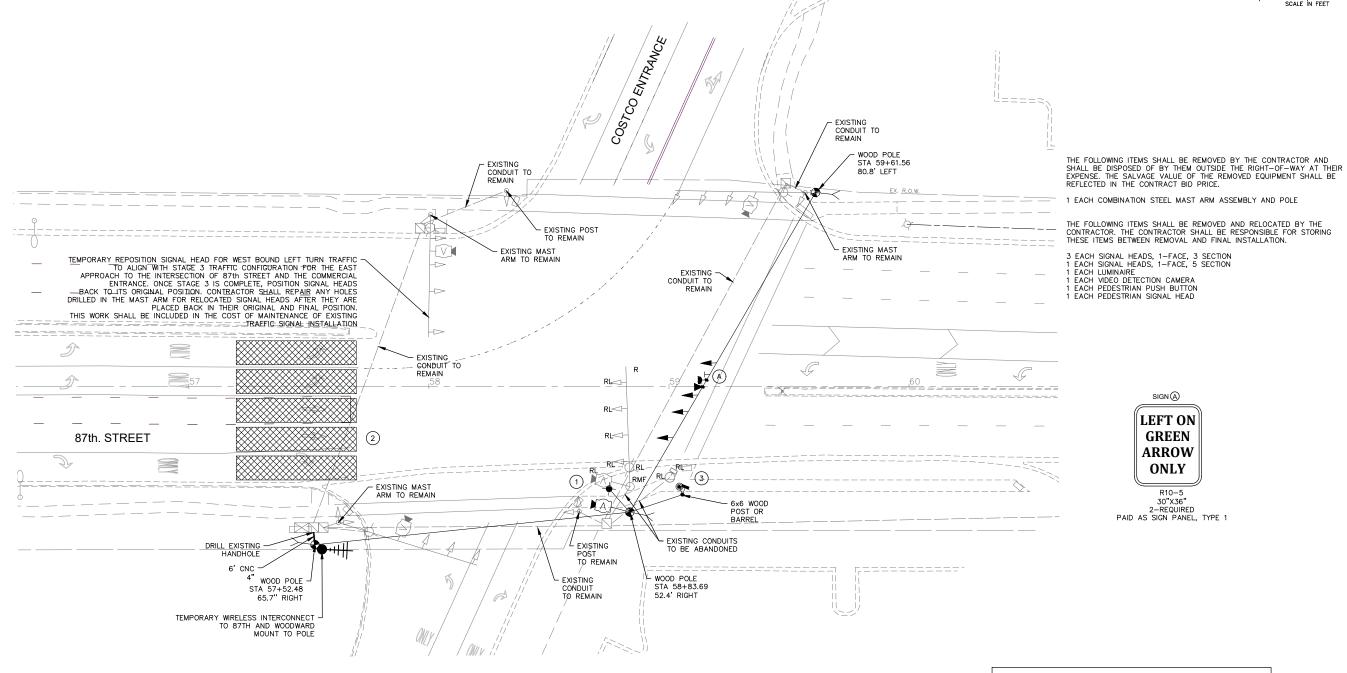

CONSTRUCTION NOTES

- THE TEMPORARY SIGNAL SHALL INCLUDE TEMPORARY LUMINAIRES, PHOTO CELL CONTROL, 400 WATT SODIUM VAPOR OR LED AND 15-FOOT TEMPORARY LUMINAIRES ARMS. THIS WORK SHALL BE INCLUDED IN THE COST OF "TEMPORARY TRAFFIC SIGNAL INSTALLATION, SPECIAL".
- DETECTION ZONES SHOWN ARE APPROXIMATE. THE EXACT LOCATIONS SHALL BE DETERMINED AND LAID OUT BY THE CONTRACTOR WITH THE ASSISTANCE OF THE EQUIPMENT SUPPLIER.
- EQUIPMENT SUPPLIER.

 PEDESTRIAN PUSH BUTTONS AND SIGNAL FACES SHALL BE LOCATED TO ACCOMMODATE THE POSITION OF THE CROSSWALKS FOR EACH STAGE, OR IF THE CONTRACTOR ADJUSTS THE ALIGNMENT OF PEDESTRIAN TRAFFIC WITHIN A STAGE. IF THE PUSH BUTTONS CANNOT BE INSTALLED ON THE TEMPORARY SIGNAL POSTS TO MEET IDOT AND ADA REQUIREMENTS (WITHIN 5 FEET OF THE CROSSWALK), THE CONTRACTOR SHALL INSTALL THEM ON 6"x6" WOOD POSTS OR BARRELS.

TRAFFIC SIGNAL NOTES

RESTORATION OF THE TRAFFIC SIGNAL WORK AREA SHALL BE INCIDENTAL TO THE RELATED PAY ITEM SUCH AS FOUNDATION, CONDUIT, HANDHOLE, TRENCH AND BACKFILL, ETC., AND NO EXTRA COMPENSATION SHALL BE ALLOWED.


THE TRAFFIC CONTROL EQUIPMENT FOR THIS PROJECT SHALL BE "ECONOLITE" TO MATCH THE EXISTING ADJACENT SYSTEM.

	USER NAME = csedlacko	DESIGNED	_	CS	REVISED	_	04/25/2019
G		DRAWN	_	CS	REVISED	_	08/13/2021
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	PLOT DATE = 12/1/2021	DATE	_	04/25/2019	REVISED	_	12/02/2021

STATE OF ILLINOIS **DEPARTMENT OF TRANSPORTATION**

87th. STREET AND COSTCO	F.A.U. SECTION					
TEMPORARY TRAFFIC SIGNAL INSTALLA	3580	13-0025	53-01-C⊢	1		
						7
SCALE: 1"=20' SHEET NO. 1 OF 1 SHEETS S	STA. 56+25 TO STA. 61+60	FFD RC	DAD DIST NO	ILLINOIS F	FFD A	ID F

RTE.	SEC.	TION	COUNTY	SHEETS		
3580	13-0025	DuPage	177	113		
			CONTRACT	NO. 6	31E87	
FED. RO	DAD DIST. NO	ILLINOIS	FED. A	ID PROJECT		

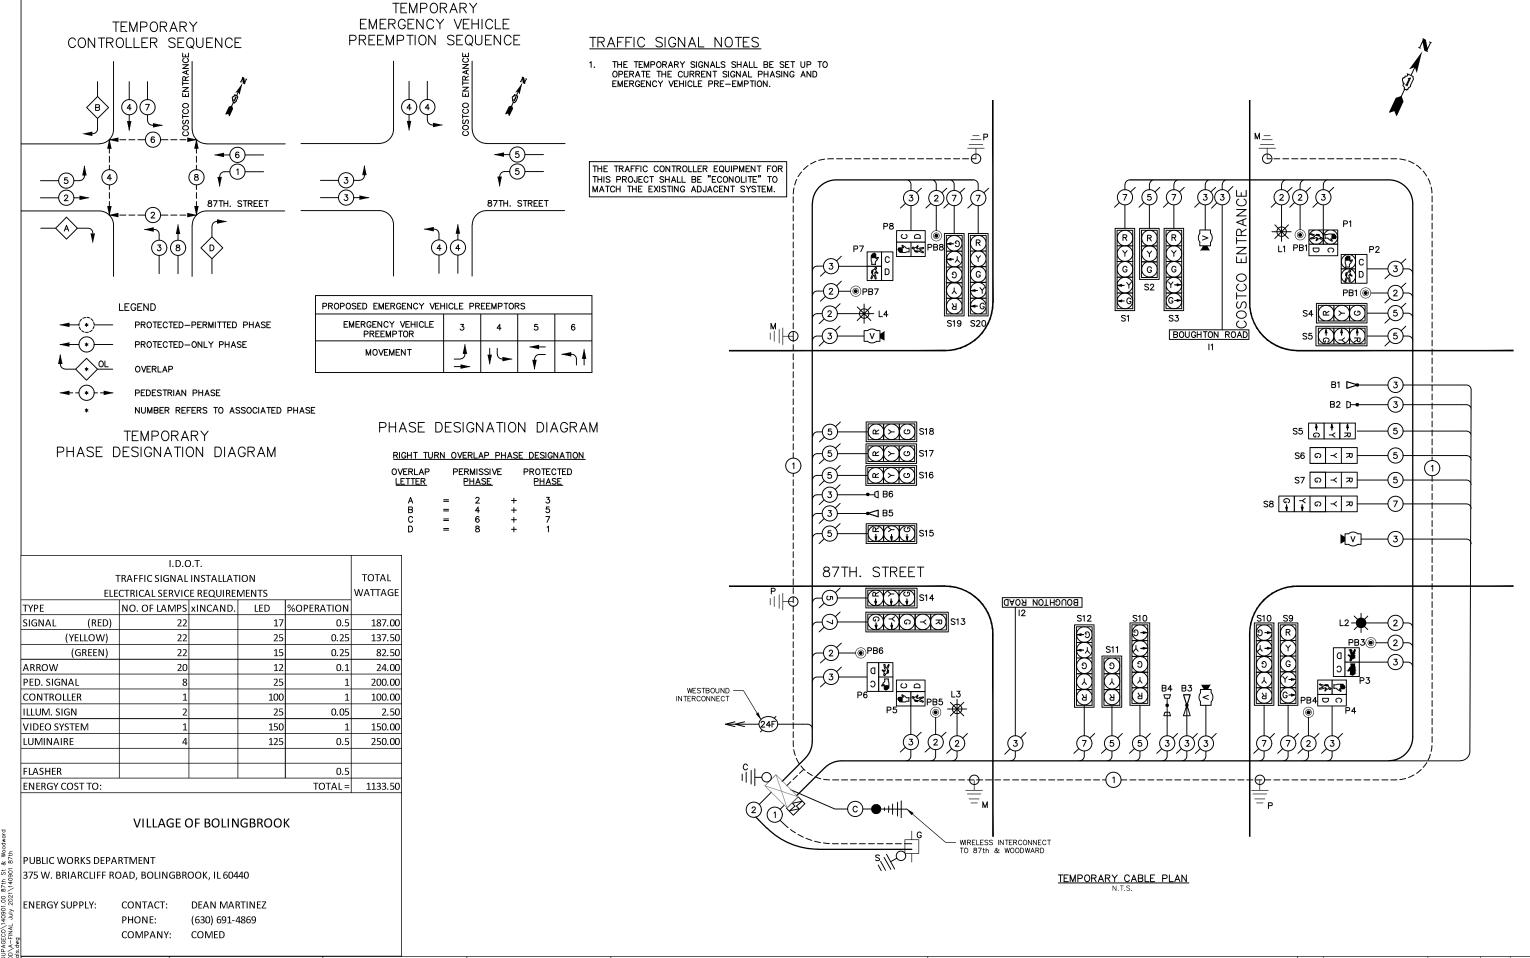

FILE NAME: V: \DUPAGECO\140901.00 87th St Ave Desian\CADD\A-FINAL July 2021\14090

ENGINEERING


RESOURCE ASSOCIATES

PLOT SCALE = \$SCALE\$

PLOT DATE = 12/1/2021

	OSEK NAME - CSECIOCKO	DESIGNED -		CS	KE VISED		04/23/2019
ì		DRAWN -	-	CS	REVISED	_	08/13/2021
	PLOT SCALE = \$SCALE\$	CHECKED -	-	JM	REVISED	_	11/03/2021
	PLOT DATE = 12/1/2021	DATE -		04/25/2019	REVISED	_	12/02/2021

87th. STREET AND COSTCO ENTRANCE					F.A.U. RTE.	SECTION	COUNTY	TOTAL SHEETS	SHEET NO.
	TEMPORARY CABLE PLAN			3580	13-00253-01-CH	DuPage	177	114	
							CONTRAC	T NO. 6	1E87
NOT TO SCALE	SHEET NO. 1 OF 1 SHEETS	STA.	TO STA.		FED. ROAD DIST. NO ILLINOIS FED. AID PROJECT				

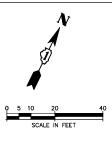

TRAFFIC SIGNAL NOTES

RESTORATION OF THE TRAFFIC SIGNAL WORK AREA SHALL BE INCIDENTAL TO THE RELATED PAY ITEM SUCH AS FOUNDATION, CONDUIT, HANDHOLE, TRENCH AND BACKFILL, ETC., AND NO EXTRA COMPENSATION SHALL BE ALLOWED.

THE TRAFFIC CONTROL EQUIPMENT FOR THIS PROJECT SHALL BE "ECONOLITE" TO MATCH THE EXISTING ADJACENT SYSTEM.

EXISTING -- EXISTING CONDUIT EXISTING -EXISTING CONDUIT 87th. STREET CONDUIT D \Rightarrow \Longrightarrow 10' UC 3½" EXISTING -EXISTING POST EXISTING INTERCONNECT CONDUIT (656'-E-4") REUSE EXISTING CONDUIT RELOCATED PEDESTRIAN SIGNAL POST, PUSH BUTTON AND SIGNAL FACE 24" DIA., 4' DEPTH EXISTING -INTERCONNECT CONDUIT EXISTING -DRILL INTO EXISTING - RELOCATED POWER POLE, TYP. (BY COMED) 60' COMBINATION MAST ARM 119' ELECTRICAL CABLE IN CONDUIT HANDHOLE (2) 42" DIAMETER, TYPE E FOUNDATION 21' DEPTH STA 58+88.00, 53.0' RT SIGN LEFT ON **GREEN ARROW**

- CONSTRUCTION NOTES

 1. ALL STATIONS AND OFFSETS ARE FROM THE CENTERLINE 87th STREET.

 2. DETECTION ZONES SHOWN ARE APPROXIMATE. THE EXACT LOCATIONS SHALL BE DETERMINED AND LAID OUT BY THE CONTRACTOR WITH THE ASSISTANCE OF THE EQUIPMENT SUPPLIER.


 3. ALL COMBINATION MAST ARM ASSEMBLIES AND POLES SHALL INCLUDE A 15-FOOT LUMINAIRE ARM.



2-REQUIRED
PAID AS SIGN PANEL, TYPE 1

NAME.Y.\DUPAGECO\140901.00 87th St & Woodward Design\CADD\A-FINAL July 2021\140901 87th TrafficSignols.dwg

3	37th. STREET AND COSTC	F.A.U. RTE.	SECTION	COUNTY	TOTAL SHEETS	SHEET NO.	
	TRAFFIC SIGNAL MODERNIZATION PLAN				DuPage	177	115
				CONTRAC	T NO. 6	51E87	
SCALE: 1"=20' SHEET NO. 1 OF 1 SHEETS STA. 58+78 TO STA. 60+50				DAD DIST. NO ILLINOIS FED. A	ID PROJECT		

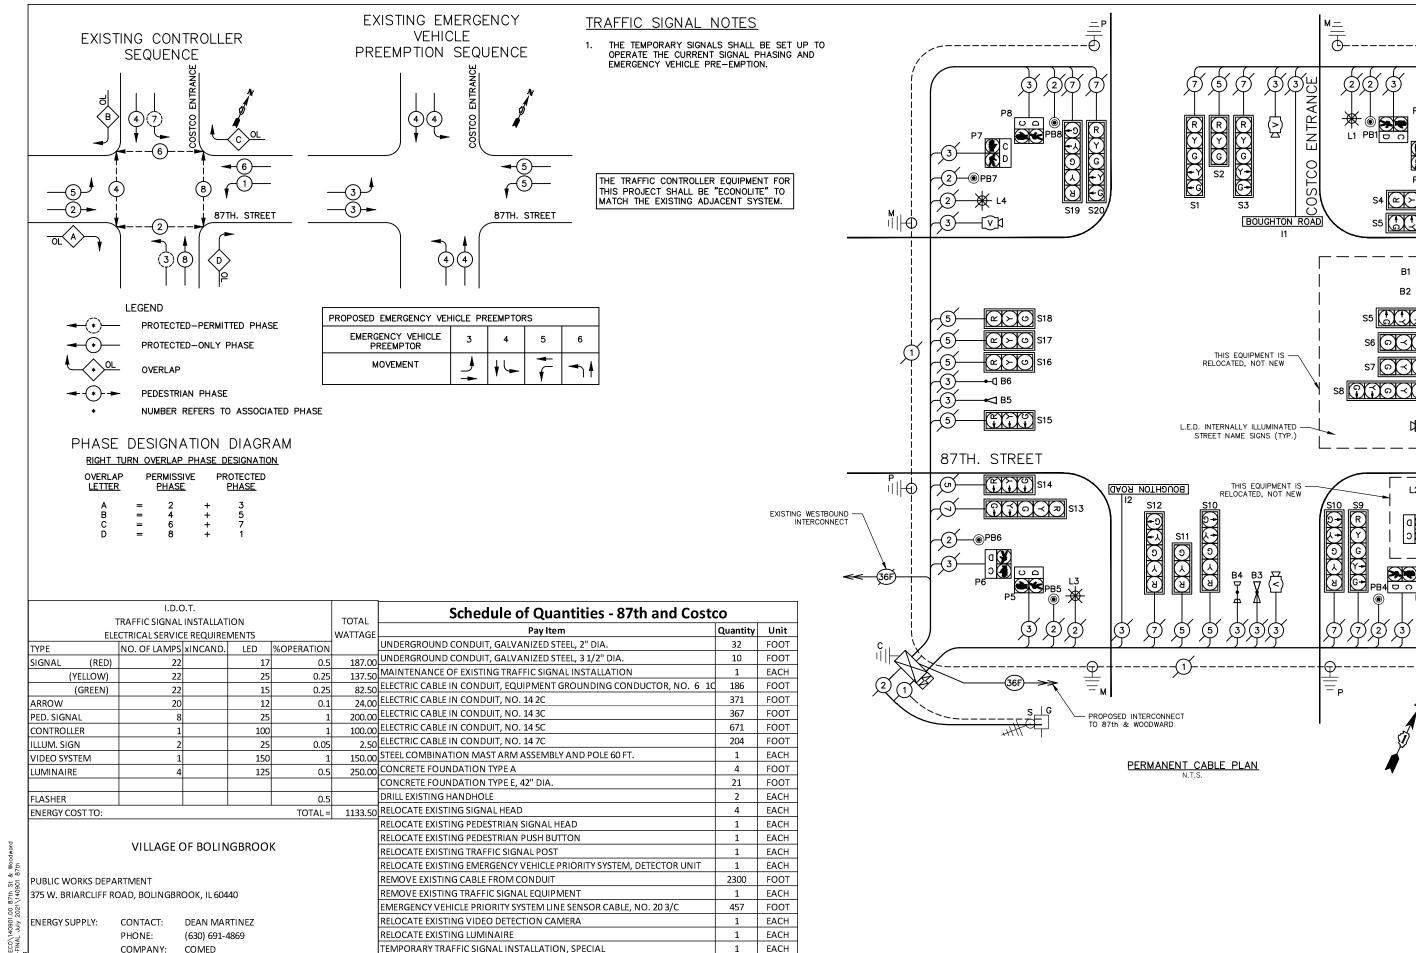


REVISED - 04/25/19 USER NAME = csedlacko DESIGNED - CS DRAWN - CS REVISED - 08/13/2021 PLOT SCALE = \$SCALE\$ CHECKED - JM REVISED - 11/03/2021 PLOT DATE = 12/1/202- 04/25/19 REVISED — 12/02/2021

TEMPORARY TRAFFIC SIGNAL TIMING

STATE OF ILLINOIS DEPARTMENT OF TRANSPORTATION

EACH


SECTION COUNTY 87th. STREET AND COSTCO ENTRANCE CABLE PLAN AND SEQUENCE OF OPERATIONS 3580 13-00253-01-CH DuPage CONTRACT NO. 61E87 NOT TO SCALE SHEET NO. 1 OF 1 SHEETS STA.

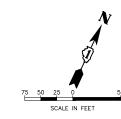





FILE NAME: V: \DUPAGECO\140901.00 87th St & Woodward Ave Design\CADD\A-FINAL July 2021\140901 87th PropinterconnectPlan.dwg

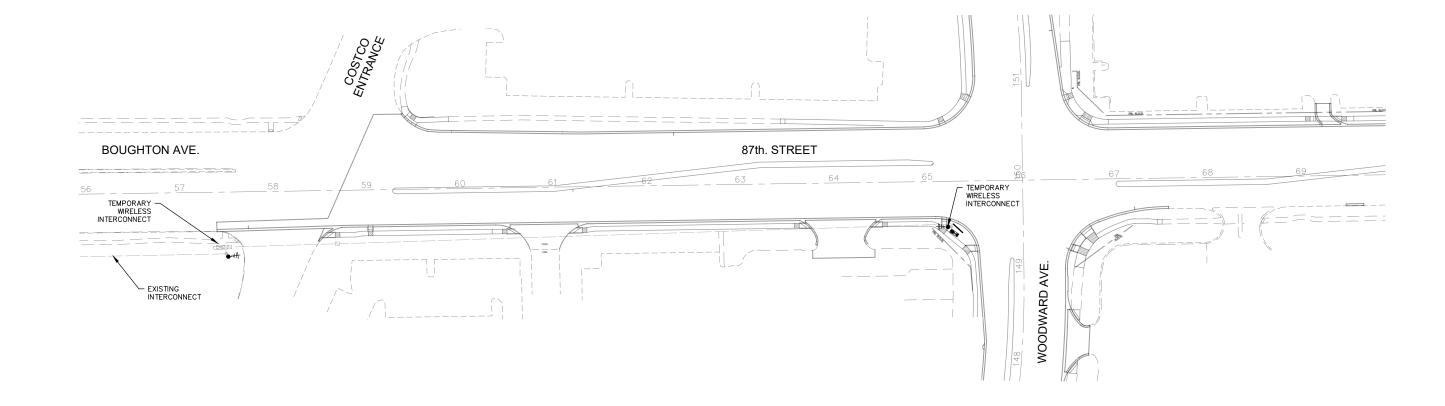


TRAFFIC SIGNAL NOTES
RESTORATION OF THE TRAFFIC SIGNAL WORK AREA SHALL
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STATE OF ILLINOIS
DEPARTMENT OF TRANSPORTATION

	87th. STREET AND WOODWARD AVE. TEMPORARY INTERCONNECT PLAN				F.A.U. RTE. SECTION		TOTAL SHEETS	SHEET NO.
					13-00253-01-CH	DuPage	177	117
					CONTRACT	Г NO. 6	1E87	
SCALE: 1"=20' SHEET NO. 1 OF 1 SHEETS STA. 56+00 TO STA. 70+00 FED. ROAD DIST. NO ILLINOIS FED. AID PROJECT			D PROJECT					



TRAFFIC SIGNAL NOTES


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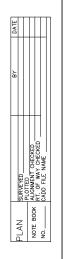
FILE NAME: V: \DUPAGECO\140901.00 87th St & Woodward Are Design\CADD\2014 -FINAL JULY 2021\140901 87th Pophiterconnect.dwg		
FILE NAME: V: \DUPAG Ave Design\CADD\A- PropInterconnect.dwg	ENGINEERING RESOURCE ASSOCIATES	

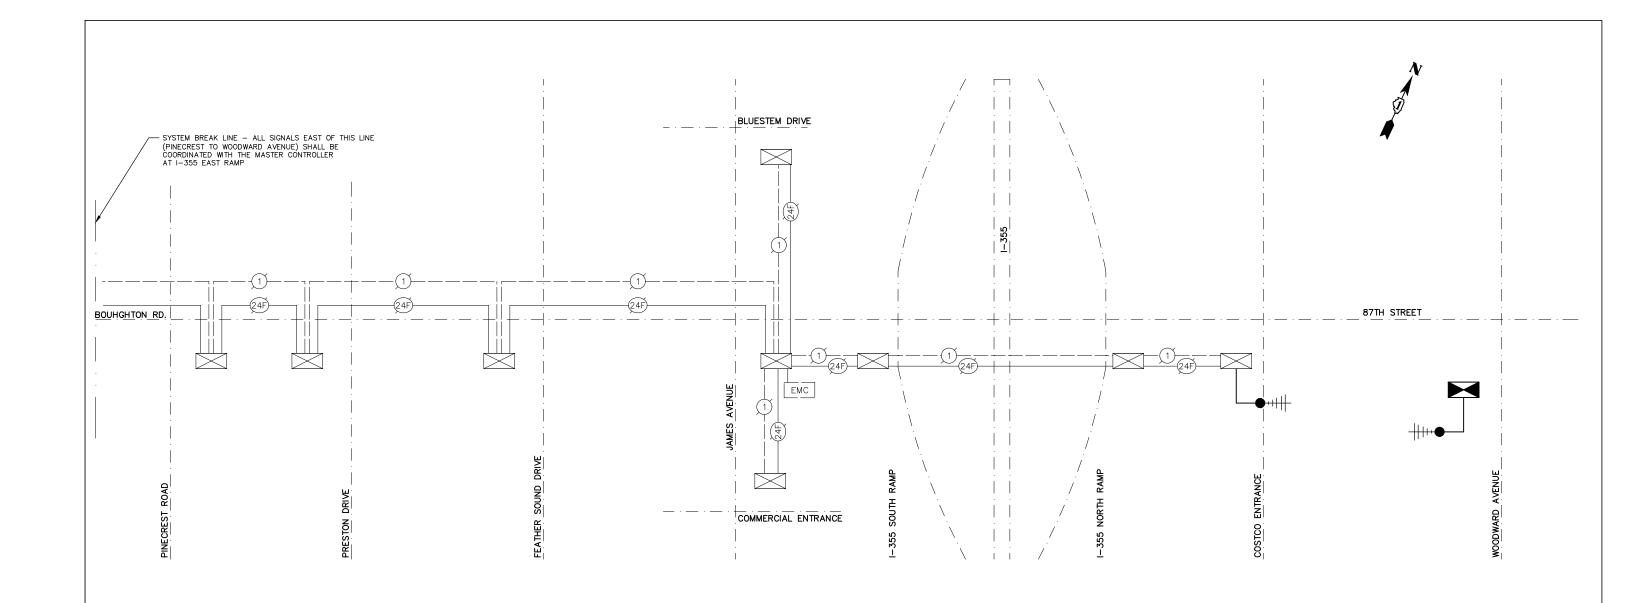
	USER NAME = csedlacko	DESIGNED - CS	REVI	SED —	04/25/19
;		DRAWN — CS	REVI	SED —	08/13/2021
\$	PLOT SCALE = \$SCALE\$	CHECKED — JM	REVI	SED —	11/03/2021
	PLOT DATE = 12/1/2021	DATE - 04/	25/19 REVI	SED —	12/02/2021

STATE OF ILLINOIS
DEPARTMENT OF TRANSPORTATION


	87th. STREET AND WOO	DDWARD A	AVE.	F.A.U. RTE.	SECTION	COUNTY	TOTAL SHEETS	SHEET NO.
	TEMPORARY INTERCONN	ECT SCHE	EMATIC	3580	13-00253-01-CH	DuPage	177	118
				·		CONTRACT	NO. 6	51E87
NOT TO SCALE	SHEET NO. 1 OF 1 SHEETS	STA.	TO STA.	FED. RO	AD DIST. NO ILLINOIS FED. AI	D PROJECT		



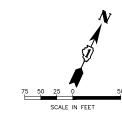

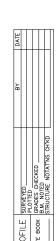

NAME:V:\DUPAGECO\(140901.00 B7th St & Woodward Design\(CADD\A-FINAL July 2021\(140901 B7th InterconnectPlan.dwg

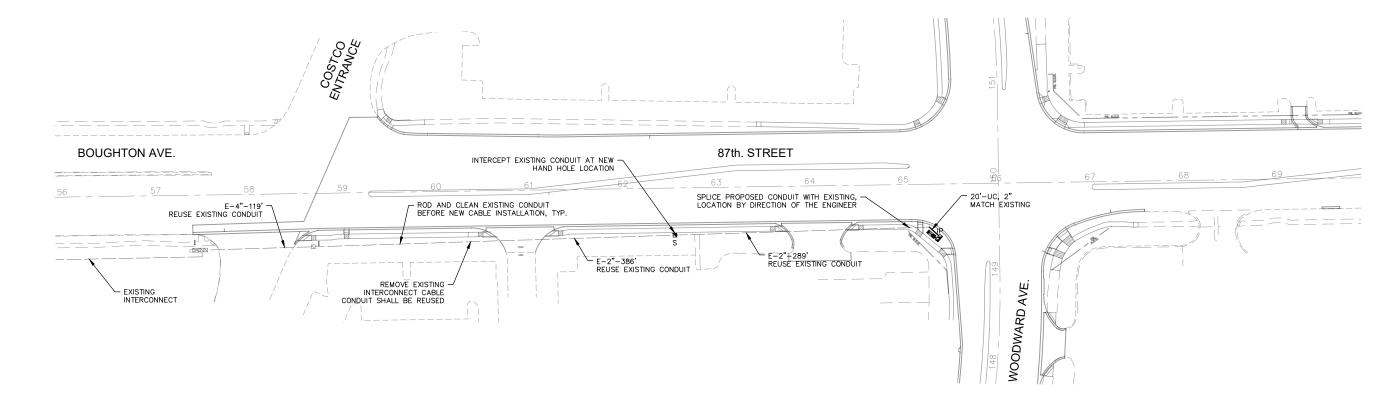

TRAFFIC SIGNAL NOTES

RESTORATION OF THE TRAFFIC SIGNAL WORK AREA SHALL BE INCIDENTAL TO THE RELATED PAY ITEM SUCH AS FOUNDATION, CONDUIT, HANDHOLE, TRENCH AND BACKFILL, ETC., AND NO EXTRA COMPENSATION SHALL BE ALLOWED.

THE TRAFFIC CONTROL EQUIPMENT FOR THIS PROJECT SHALL BE "ECONOLITE" TO MATCH THE EXISTING ADJACENT SYSTEM.

CONSTRUCTION NOTES

1. ALL STATIONS AND OFFSETS ARE FROM THE CENTERLINE 87th STREET.

2. NEW CABLE SHALL BE INSTALLED IN EXISTING CONDUIT, EXCEPT NEAR PROPOSED INTERSECTION CONTROLLER (87TH AND WOODWARD).

CONTRACTOR SHALL INTERCEPT EXISTING INTERCONNECT CONDUIT TO BE CONNECTED TO NEW CONDUIT. THIS INTERCEPT SHALL BE DONE AS CLOSE TO THE NEW CONTROLLER AS POSSIBLE, AS DETERMINED BY THE ENGINEER.

INTERCONNECT LEGEND


① SEE INTERCONNECT SCHEMATIC FOR CABLE SIZE AND TYPE.

Schedule of Quantities - Intercor	nnect	
Pay Item	Quantity	Unit
UNDERGROUND CONDUIT, GALVANIZED STEEL, 2" DIA.	20	FOOT
HANDHOLE	1	EACH
ELECTRIC CABLE IN CONDUIT, TRACER NO. 141C	827	FOOT
CONDUIT SPLICE	1	EACH
NTERCEPT EXISTING CONDUIT	1	EACH
REMOVE EXISTING ELECTRIC CABLE	1654	FOOT
ROD AND CLEAN EXISTING CONDUIT	827	FOOT
FIBER OPTIC CABLE IN CONDUIT, NO.62.5/125, MM12F, SM24F	827	FOOT
RE-OPTIMIZE TRAFFIC SIGNAL SYSTEM LEVEL 2	1	EACH

USER NAME = csedlacko	DESIGNED — CS	REVISED — 04/25/19
	DRAWN — CS	REVISED - 08/13/2021
PLOT SCALE = \$SCALE\$	CHECKED — JM	REVISED - 11/03/2021
PLOT DATE = 12/1/2021	DATE - 04/25/19	REVISED — 12/02/2021

STATE OF ILLINOIS
DEPARTMENT OF TRANSPORTATION

	87th. STREET AND WO	ODWARD AVE.	F.A.U. RTE.	SECTION	COUNTY	SHEETS	SHEET NO.
	PROPOSED INTERCO	NNECT PLAN	3580	13-00253-01-CH	DuPage	177	119
					CONTRAC	T NO. 6	51E87
SCALE: 1"=20'	SHEET NO. 1 OF 1 SHEETS	STA. 56+00 TO STA. 70+00	FED. RO	DAD DIST. NO ILLINOIS FED. A	D PROJECT		

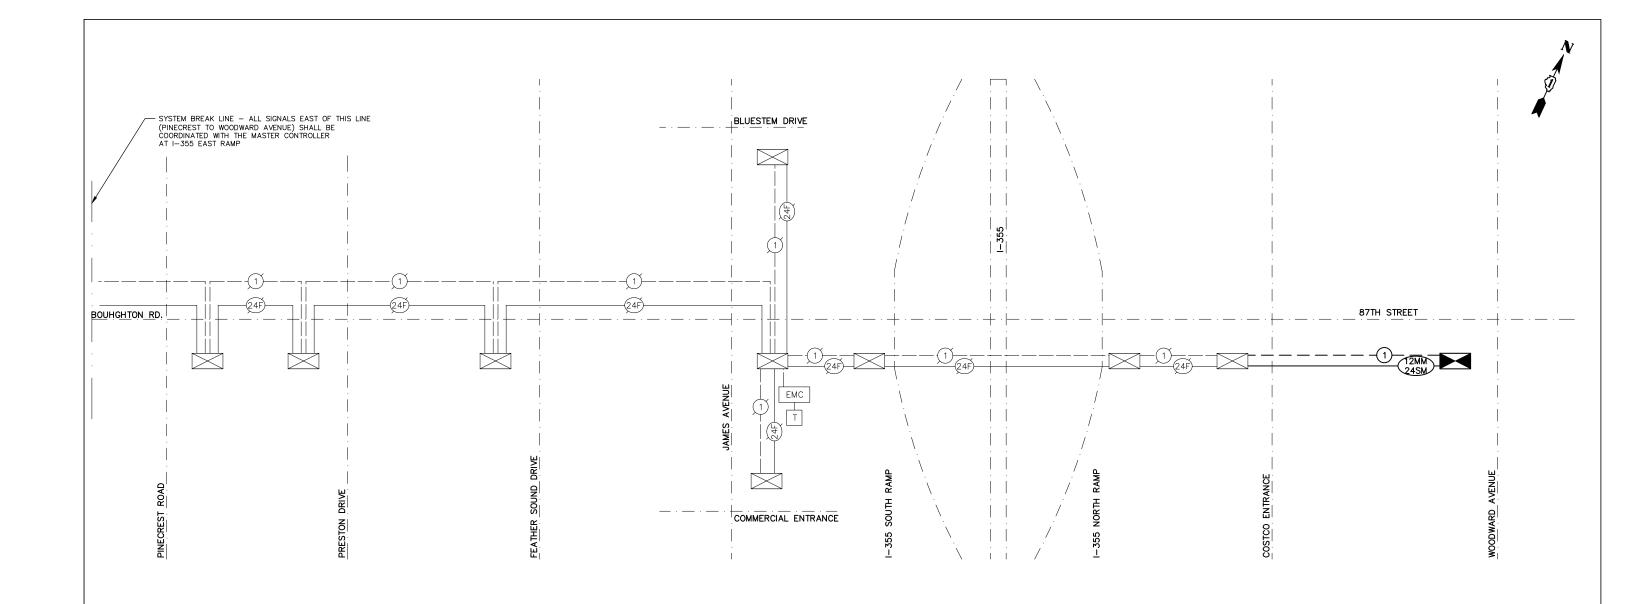

TEMPORARY INTERCONNECT NOTES


 THE TRAFFIC CONTROLLER EQUIPMENT FOR THIS PROJECT SHALL BE "ECONOLITE" TO MATCH THE EXISTING ADJACENT SYSTEM.

NAME: V: \DUPAGECO\140901.00 87th { Design\CADD\A-FINAL July 2021\1409 nterconnect.dwg		
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NA Desi	RESOURCE ASSOCIATES	Γ
ve De ropint	INESOUNCE ASSOCIATES	Γ

USER NAME = csedlacko	DESIGNED — CS	REVISED — 04/25/19
	DRAWN — CS	REVISED - 08/13/2021
PLOT SCALE = \$SCALE\$	CHECKED — JM	REVISED - 11/03/2021
PLOT DATE = 12/1/2021	DATE - 04/25/19	REVISED - 12/02/2021

STATE OF ILLINOIS	
DEPARTMENT OF TRANSPORTATION	

	87th. STREET AND WO	ODWARD A	AVE.	F.A.U. RTE.	SEC ⁻	TION	COUNTY	TOTAL SHEETS	SHEET NO.
	PROPOSED INTERCONNE	ECT SCHE	MATIC	3580	13-0025	3-01-CH	DuPage	177	120
							CONTRAC	T NO. 6	31E87
NOT TO SCALE	SHEET NO. 1 OF 1 SHEETS	STA.	TO STA.	FED. RO	AD DIST. NO	ILLINOIS FED. AI	D PROJECT		

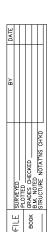

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BY						
	SURVEYED	PLOTTED	GRADES CHECKED	B.M. NOTED	STRUCTURE NOTATINS CHIKD	
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LIGHTING GENERAL NOTES

- IT SHALL BE THE CONTRACTOR'S RESPONSIBILITY TO VERIFY ALL DIMENSIONS AND CONDITIONS IN THE FIELD PRIOR TO ORDERING MATERIALS AND BEGINNING CONSTRUCTION
- PAY ITEMS IN THE SCHEDULE OF QUANTITIES HAVE BEEN ESTIMATED. IF, IN THE ENGINEER'S OPINION, ANY WORK IS NOT REQUIRED, THAT ITEM WILL BE DEDUCTED FROM THE CONTRACT AND NO ADDITIONAL COMPENSATION WILL BE ALLOWED
- IT SHALL BE THE CONTRACTOR;S RESPONSIBILITY TO MARK THE PROPOSED LOCATIONS OF ALL LIGHT POLES FOR EXAMINATION AND CONFIRMATION WITH THE ENGINEER PRIOR TO INSTALLATION OF LIGHTING FOUNDATIONS.
- RELOCATED LIGHTING UNIT SHALL BE INSTALLED IMMEDIATELY ON THE PROPOSED LIGHTING FOUNDATION AND ALL ELECTRICAL CABLES SHALL BE CONNECTED AND BECOME OPERATIONAL THAT SAME EVENING WITHOUT INTERRUPTION.
- THE QUANTITY FOR LIGHT POLE 24" DIAMETER. OFFSET IS ESTIMATED, IF IT DETERMINED IN THE FIELD THAT A LIGHT POLE FOUNDATION , 24" DIAMETER CANNOT BE PLACED, THE PAY ITEM FOR LIGHT POLE FOUNDATION, 24" DIAMETER, OFFSET SHALL BE USED WITH THE APPROVAL OF THE ENGINEER.
- THE CONTRACTOR SHALL BE RESPONSIBLE FOR THE ESTABLISHMENT OF FINISHED GRADE. THE ENGINEER MAY ASSIST THE CONTRACTOR, AS APPLICABLE, BUT THE RESPONSIBILITY FOR COORDINATING THE FINISHED GRADE ELEVATION WITH THE INSTALLATION OF CONDUITS, UNITS DUCTS AND THE TOP OF THE FOUNDATION HEIGHTS REMAIN WITH THE CONTRACTOR.
- ANY DAMAGE TO PAVEMENT, SIDEWALK, CURB, OR ANY OTHER PORTION OF THE ROADWAY NOT SPECIFIED TO BE REMOVED AND REPLACED SHALL BE REPAIRED OR REPLACED BY THE CONTRACTOR AT NO ADDITIONAL COST AND REPLACEMENT SHALL MEET THE APPROVAL OF THE ENGINEER.
- WHEN SPLICING TO EXISTING POLE, ANY AND ALL WORK REQUIRED TO RUN THE PROPOSED UNIT DUCT INTO EXISTING FOUNDATION SLEEVE AND SPLICING IN EXISTING POLE SHALL BE COVERED AND INCLUDED IN THE PAY ITEM OF THE UNIT DUCT.
- COORDINATE WITH TRAFFIC SIGNAL PLANS FOR EXACT LOCATION OF COMBINATION POLES. COMBINATION POLES ARE TRAFFIC SIGNAL PAY ITEMS, LUMINARIES ARE IN PROPOSED LIGHTING PAY ITEMS
- 10. EQUIPMENT GROUND CONDUCTORS SHALL BE SPLICED AND BONDED AT EACH LIGHT POLE OR OTHER PIECE OF EQUIPMENT.
- CONDUIT AND UNIT DUCT MUST BE POSITIONED IN THE FIELD TO AVOID CONFLICT WITH TREES, BUSHES, DRAINS, AND OTHER
- 12. ALL DISTURBED AREAS WHERE RESTORATION IN NOT SPECIFICALLY SHOWN ON THE CONTRACT PLANS MUST BE RESTORED BY THE CONTRACTOR AT NO ADDITIONAL COST AND MEET THE APPROVAL OF THE ENGINEER.
- 13. OFFSET CALL-OUTS ARE FROM THE CENTER OF POLES TO BACK OF CURB (B.C.)
- 14. PROVIDE SPACE RACEWAY AT THE END OF ALL POLE FOUNDATIONS.

LIGHTING SCHEDULE OF QUANTITIES

Schedule of Quantities - Lighting						
Pay Item	Quantity	Unit				
SERVICE INSTALLATION, GROUND MOUNTED	EACH	1				
UNDERGROUND CONDUIT, GALVANIZED STEEL, 2 1/2" DIA.	FOOT	205				
UNDERGROUND CONDUIT, GALVANIZED STEEL, 4" DIA.	FOOT	102				
UNIT DUCT, 600V, 2-1C NO.6, 1/C NO.6 GROUND, (XLP-TYPE USE), 1 1/4" DIA. POLYETHYLENE	FOOT	2,392				
LIGHT POLE FOUNDATION, 30" DIAMETER	FOOT	63				
REMOVAL OF POLE FOUNDATION	EACH	9				
RELOCATE EXISTING LIGHTING UNIT	EACH	9				
REMOVE ELECTRIC CABLE FROM CONDUIT	FOOT	2,324				
REMOVE EXISTING HANDOLE	EACH	1				
REMOVE AND RELOCATE EXISTING LIGHTING CONTROLLER	EACH	1				
MAINTENANCE OF EXISTING LIGHTING SYSTEM	EACH	1				
LUMINAIRE, LED, SPECIAL	EACH	13				

LEGEND

T FYISTING LIGHTING LINIT

\sim	EXISTING EIGHTING ONLY
ф——	EXISTING COMBINATION TRAFFIC SIGNAL AND LIGHTING
	EXISTING UNIT DUCT
¤	PROPOSED LIGHTING UNIT
⊶)⊚(RELOCATED EXISTING LIGHTING UNIT W/ NEW LUMINAIRE
⊸¤	REPLACE EXISTING LUMINAIRE

PROPOSED COMBINATION TRAFFIC SIGNAL AND LIGHTING

PROPOSED CONDUIT (SIZE AS SPECIFIED) REMOVE ELECTRIC CABLE FROM CONDUIT

PROPOSED HANDHOLE \bowtie

---- PROPOSED UNIT DUCT


EXISTING ELECTRICAL CABINET PROPOSED ELECTRICAL CABINET

LIGHT FIXTURE SCHEDULE MAST ARM FIXTURE# OFFSET* (FT) 87TH STREET A-1 FIXTURE ONLY 59+99.20 67.60LT 15 A-2 RELOCATE POLE & FIXTURE 52+67.42 61.58LT 15 RELOCATE POLE & FIXTURE B-1 61+45.10 42.58R1 15 B-2 RELOCATE POLE & FIXTURE 63+50.58 42.58RT 15 RELOCATE POLE & FIXTURE 67+56.56 57.58LT 15 E-5 RELOCATE POLE & FIXTURE 68+90.44 57.58LT 15 E-6 15 RELOCATE POLE & FIXTURE 70+45 64 56 911 T FIXTURE ON TRAFFIC SIGNAL 66+66.11 80.40RT 15 1 -1 MAST ARM FIXTURE ON TRAFFIC SIGNAL L-2 66+86.15 57.34RT 15 MAST ARM FIXTURE ON TRAFFIC SIGNAL 66+45.77 66.50RT 15 L-3 MAST ARM FIXTURE ON TRAFFIC SIGNAL 65+18.27 69.83LT 15 MAST ARM WOODWARD AVENUE C-1 RELOCATE POLE & FIXTURE 152+74.66 54.64LT 15 C-2 RELOCATE POLE & FIXTURE 154+51.58 54.65LT 15 FIXTURE ONLY 155+88.26 15 C-3 54.80LT E-1 FIXTURE ONLY 155+44.63 38.09RT 15 E-2 FIXTURE ONLY 153+73.90 38.25RT 15 E-3 RELOCATE POLE & FIXTURE 151+98.07 38.50RT 15


*OFFSET IS SHOWN TO CENTER OF EXISTING / PROPOSED FOUNDATION

DUPAGE COUNTY DOT LIGHTING LABEL DETAILS

POLE LABELS

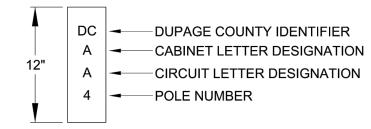

CABINET LABELS

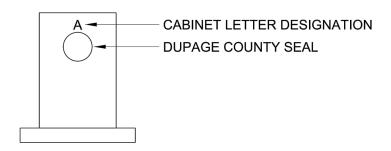


NOTES:

1.) POLE LABELS SHALL CONSIST OF BLACK LETTERS ON A YELLOW BACKGROUND

ENGINEERING RESOURCE ASSOCIATES


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	DRAWN	_	RT	REVISED	_	08/13/2021
PLOT SCALE = \$SCALE\$	CHECKED	_	JM	REVISED	_	11/03/2021
PLOT DATE = 12/1/2021	DATE	_	04/25/19	REVISED	_	12/02/2021

87th. STREET AND WOODWARD AVENUE				F.A.U. SECTION		COUNTY	TOTAL SHEETS	SHE			
LIGHTING NOTES. LEGEND AND SCHEDULE OF QUANTITIES				3580	580 13-00253-01-CH			DuPage	177	12	
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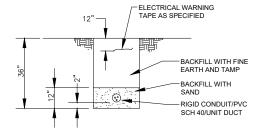


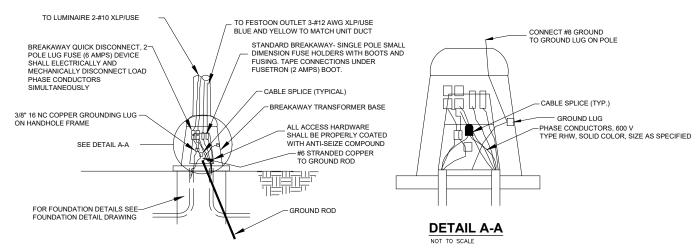THE CONTRACTOR SHALL SUBMIT DETAILED SHOP DRAWINGS OR CATALOG CUTS FOR ALL EQUIPMENT


POLE BASE DETAIL

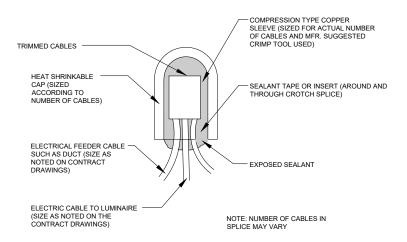


ABOVE GROUND SPLICING ELECTRIC CABLE




TRENCH BACKFILL FOR STREET LIGHTING DETAIL

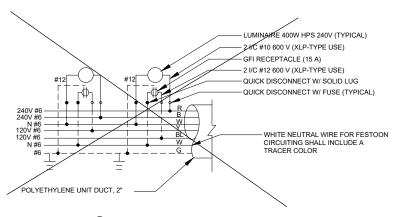


UNIT DUCT(1)
LIGHT POLE WIRING W/ FESTOON

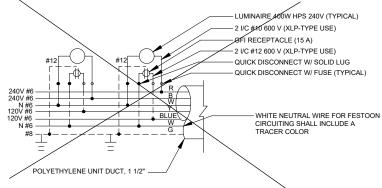


UNIT DUCT②
LIGHT POLE WIRING W/ FESTOON

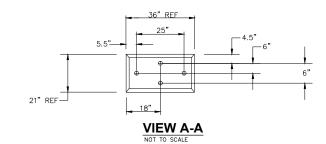

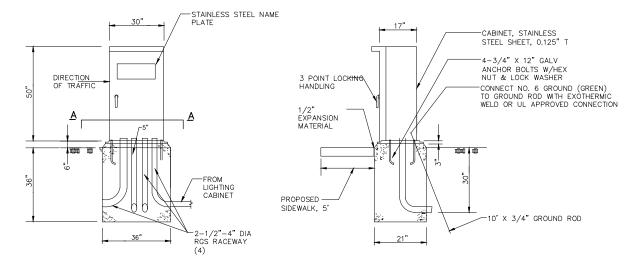

LIGHTING CONTROLLER DETAIL

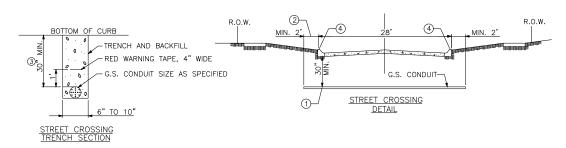

- ① CONDUIT SHALL BE HEAVY WALL RIGID G.S. CONDUIT.
- ② CONDUIT SHALL EXTEND A MINIMUM OF 2 FT. BEYOND BACK OF CURB.
- 3 CONDUIT SHALL BE A MINIMUM OF 30" BELOW BOTTOM OF CURB.

ELECTRICAL CONDUIT UNDER PAVEMENT

١		
		US
	ENGINEERING	
١	RESOURCE ASSOCIATES	PL
,	RESOURCE ASSOCIATES	PL


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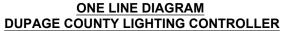
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PLOT DATE = 12/1/2021	DATE	_	04/25/19	REVISED	_	12/02/2021


STATE OF ILLINOIS DEPARTMENT OF TRANSPORTATION

SCALE: NTS

87	87th. STREET AND WOODWARD AVENUE			F.A.U. RTE.	SEC	TION	COUNTY	TOTAL SHEETS	SHEET NO.
LIGHTING DETAILS			3580	13-00253-01-CH		DuPage	177	122	
						CONTRACT	T NO. 6	1E87	
	SHEET NO 1 OF 4 SHEETS	AT2	AT2 OT	550.0	OAD DIGT NO	LILLINGIC FED. A	ID DDO IDOT		



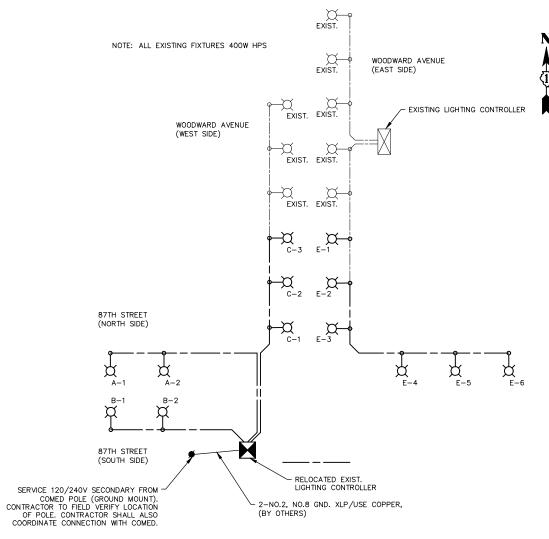

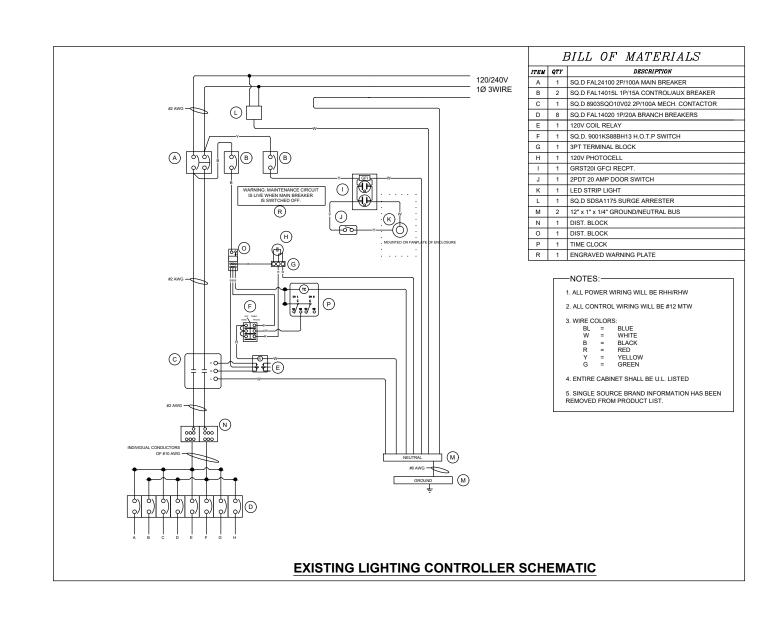





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	DRAWN — RT	REVISED - 08/13/2021
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PLOT DATE = 12/1/2021	DATE - 04/25/19	REVISED — 12/02/2021

STATE OF ILLINOIS DEPARTMENT OF TRANSPORTATION

SCALE: NTS

87	87th. STREET AND WOODWARD AVENUE				F.A.U. RTE.	SECTION	COUNTY	TOTAL SHEETS	
LIGHTING DETAILS			3580	13-00253-01-CH	DuPage	177	123		
2101111110 22171120				CONTRACT	NO. 6	31E87			
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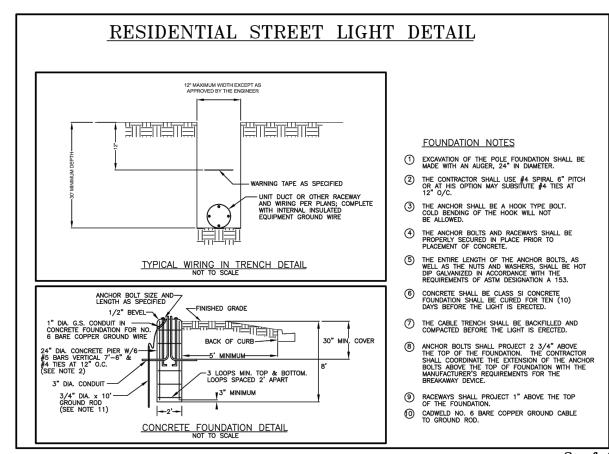
3 of 3

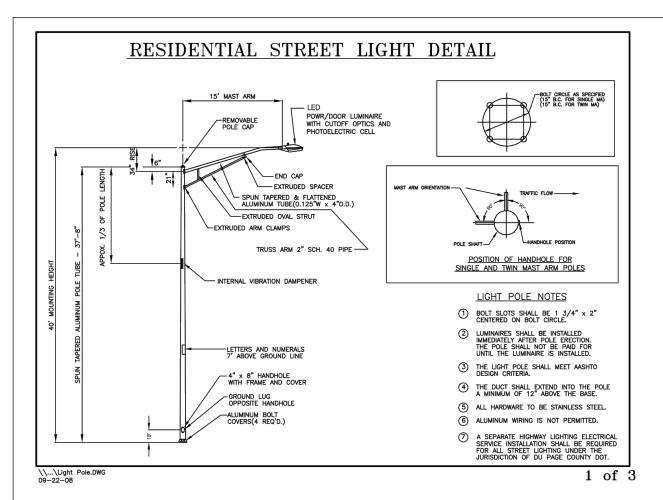

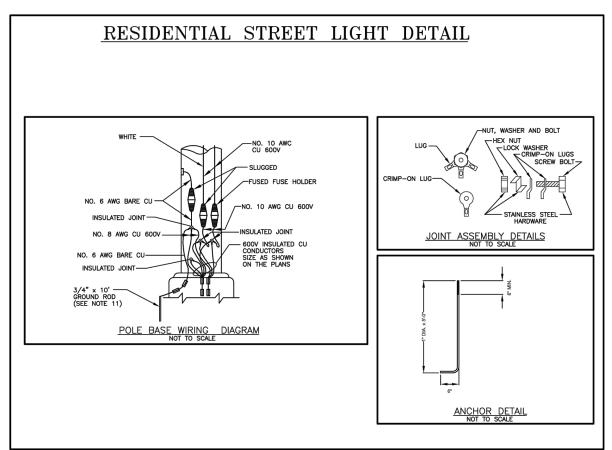STATE OF ILLINOIS DEPARTMENT OF TRANSPORTATION

SCALE: NTS

87	87th. STREET AND WOODWARD AVENUE				F.A.U. RTE.	SECTION		COUNTY	TOTAL	SHEE NO.
LIGHTING DETAILS			3580	13-00253-01-CH		DuPage	177	124		
						CONTRACT	NO.	61E87		
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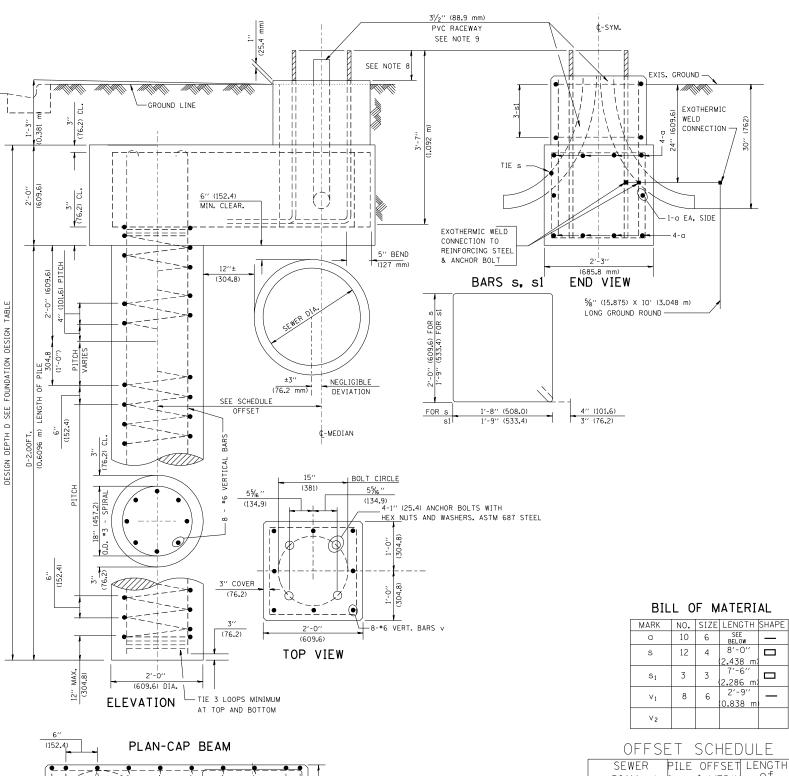
2 of 3


FOUNDATION DESIGN TABLE

	DESIGN DEPTH (OF FOUNDATION	REINFORCEMENT IN FOUNDATION				
TYPE OF SOIL	SINGLE ARM	TWIN ARM	SINGLE	ARM	TWIN	ARM	
	D D		VERT BARS	SPIRAL	VERT BARS	SPIRAL	
SOFT CLAY	13'-0''	15'-0''	8-#6X12'-6''	#3X122′	8-#6X14'-3''	#3X141′	
	(3.962 m)	(4 . 572 m)	(3.810 m)	(37.186 m)	(4.343 m)	(42.977 m)	
MEDIUM CLAY	9'-6''	10′-9′′	8-#6X9'-0''	#3X90′	8-#6X10'-0''	#3X100′	
	(2.896 m)	(3.277 m)	(2.743 m)	(27.432 m)	(3.048 m)	(30.480 m)	
STIFF CLAY	7'-0'' 8'-0''	8'-0''	8-#6X6'-6''	#3X66′	8-#6X7'-6''	#3X76′	
	(2.134 m) (2.438 m)	(2.438 m)	(1.981 m)	(20.112 m)	(2.286 m)	(23.165 m)	
LOOSE SAND	9'-0''	10'-0''	8-#6X8'-6''	#3X85′	8-#6X9'-6''	#3X94'	
	(2.743 m)	(3 . 048 m)	(2.591 m)	(25.908 m)	(2.896 m)	(28.651 m)	
MEDIUM SAND	8'-3''	9'-0''	8-#6X8'-0''	#3X78′	8-#6X8'-6''	#3X85′	
	(2.515 m)	(2.743 m)	(2.438 m)	(23.774 m)	(2.591 m)	(25.908 m)	
DENSE SAND	7'-9'' 9'-0''		8-#6X7'-6''	#3X73′	8-#6X8'-6''	#3X85′	
	(2.362 m) (2.743 m		(2.286 m)	(22.250 m)	(2.591 m)	(25.908 m)	
ROCK OR SOLIDIFIED SLAG	5′-0′′ (1.524 m)	5′-0′′ (1 . 524 m)	NONE	NONE	NONE	NONE	

NOTES

- 1. ALL DIMENSIONS ARE IN INCHES (MILLIMETERS) UNLESS OTHERWISE SHOWN.
- 2. THE ENGINEER SHALL DETERMINE THE CLASS OF SOIL DURING EXCAVATION AND SELECT THE DESIGN DEPTH OF FOUNDATION FROM THE DESIGN TABLE.
- 3. EXCAVATION OF THE POLE FOUNDATION SHALL BE MADE WITH AN AUGER, 24" (609.6 mm) OR 30" (762.0 mm) IN DIAMETER.
- 4. THE ANCHOR ROD SHALL BE A HOOK ROD TYPE, COLD BENDING OF THE ANCHOR ROD WILL NOT BE ALLOWED. THE RADIUS OF THE HOOK BEND SHALL NOT BE LESS THAN 4 TIMES THE NOMINAL DIAMETER OF THE ANCHOR ROD. A TACK WELDED ANCHOR ROD MAY BE SUBSTITUTED WITH THE APPROVAL OF THE ENGINEER.
- 5. THE ANCHOR BOLTS AND RACEWAYS SHALL BE PROPERLY SECURED IN PLACE BEFORE THE CONCRETE IS PLACED IN THE FORM.
- 6. THE ANCHOR RODS SHALL BE ACCORDING TO ASTM F1554 GRADE 725 (GRADE 105). NUTS SHALL BE HEXAGON NUTS ACCORDING TO ASTM A 194 2H OR ASTM A 563 DH, AND WASHERS SHALL BE ACCORDING TO ASTM F 436.
- 7. THE CONTRACTOR SHALL COORDINATE EXTENSION OF ANCHOR BOLTS ABOVE TOP OF FOUNDATION WITH THE BREAKAWAY DEVICE MANUFACTURER'S REQUIREMENTS. IF LIGHT POLE IS MOUNTED WITHOUT BREAKAWAY DEVICE, ANCHOR BOLTS SHALL PROJECT 2¾4" (69.9 mm) ABOVE TOP OF THE FOUNDATION. THE CONTRACTOR SHALL CONFIRM ANCHOR BOLT EXTENTION WITH ENGINEER.
- 8. RACEWAYS SHALL PROJECT 1" (25.4 mm) ABOVE THE TOP OF THE FOUNDATION.
- 9. THE CABLE TRENCH SHALL BE BACKFILLED AND FIRMLY COMPACTED BEFORE THE LIGHT IS ERECTED.



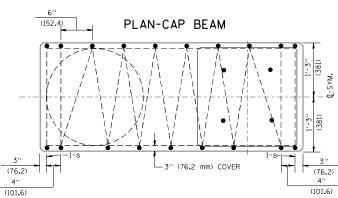



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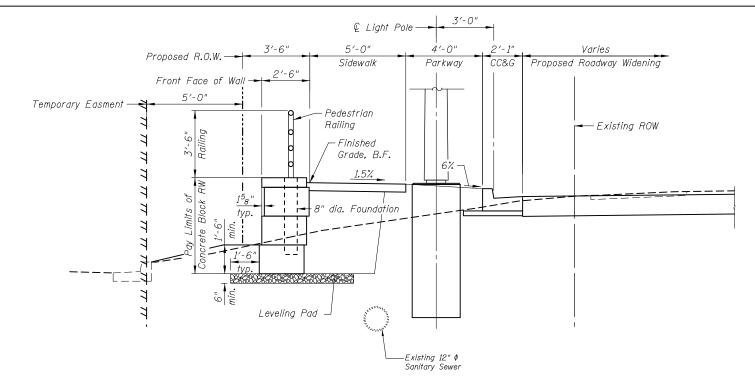
SEWER	PILE OFFSET	
DIAM. d -	from¢-MED′N	of BAR a
IN.	FT.	FT.
UP TO 24"	3′-3′′	#6 × 5′-3′′
(609.6 mm)	(0.991 m)	(1.600 m)
27" (685.8 m)TO	3′-9′′	5′-9′′
36" (914.4 mm)	(1.143 m)	(1.753 m)
42" (1066.8 mm) TO	4′-6′′	6′-6′′
48" (1219.2 mm)	(1.372 m)	(1 . 981 m)
54" (1371.6 mm) TO	5′-0′′	7′-0′′
60" (1524.0 mm)	(1.524 m)	(2.134 m)
66" (1676.4 mm) TO	5′-6′′	7′-6′′
72" (1828.8 mm)	(1.676 m)	(2.286 m)

FILE NAME =	USER NAME = bauerdl	DESIGNED -	REVISED - 06-16-08 R. TOMSONS
K:\diststd22x34\be310.dgn		DRAWN -	REVISED -
	PLOT SCALE = 50.000 '/ IN.	CHECKED -	REVISED -
	PLOT DATE = 6/16/2008	DATE -	REVISED -


STATE OF ILLINOIS
DEPARTMENT OF TRANSPORTATION



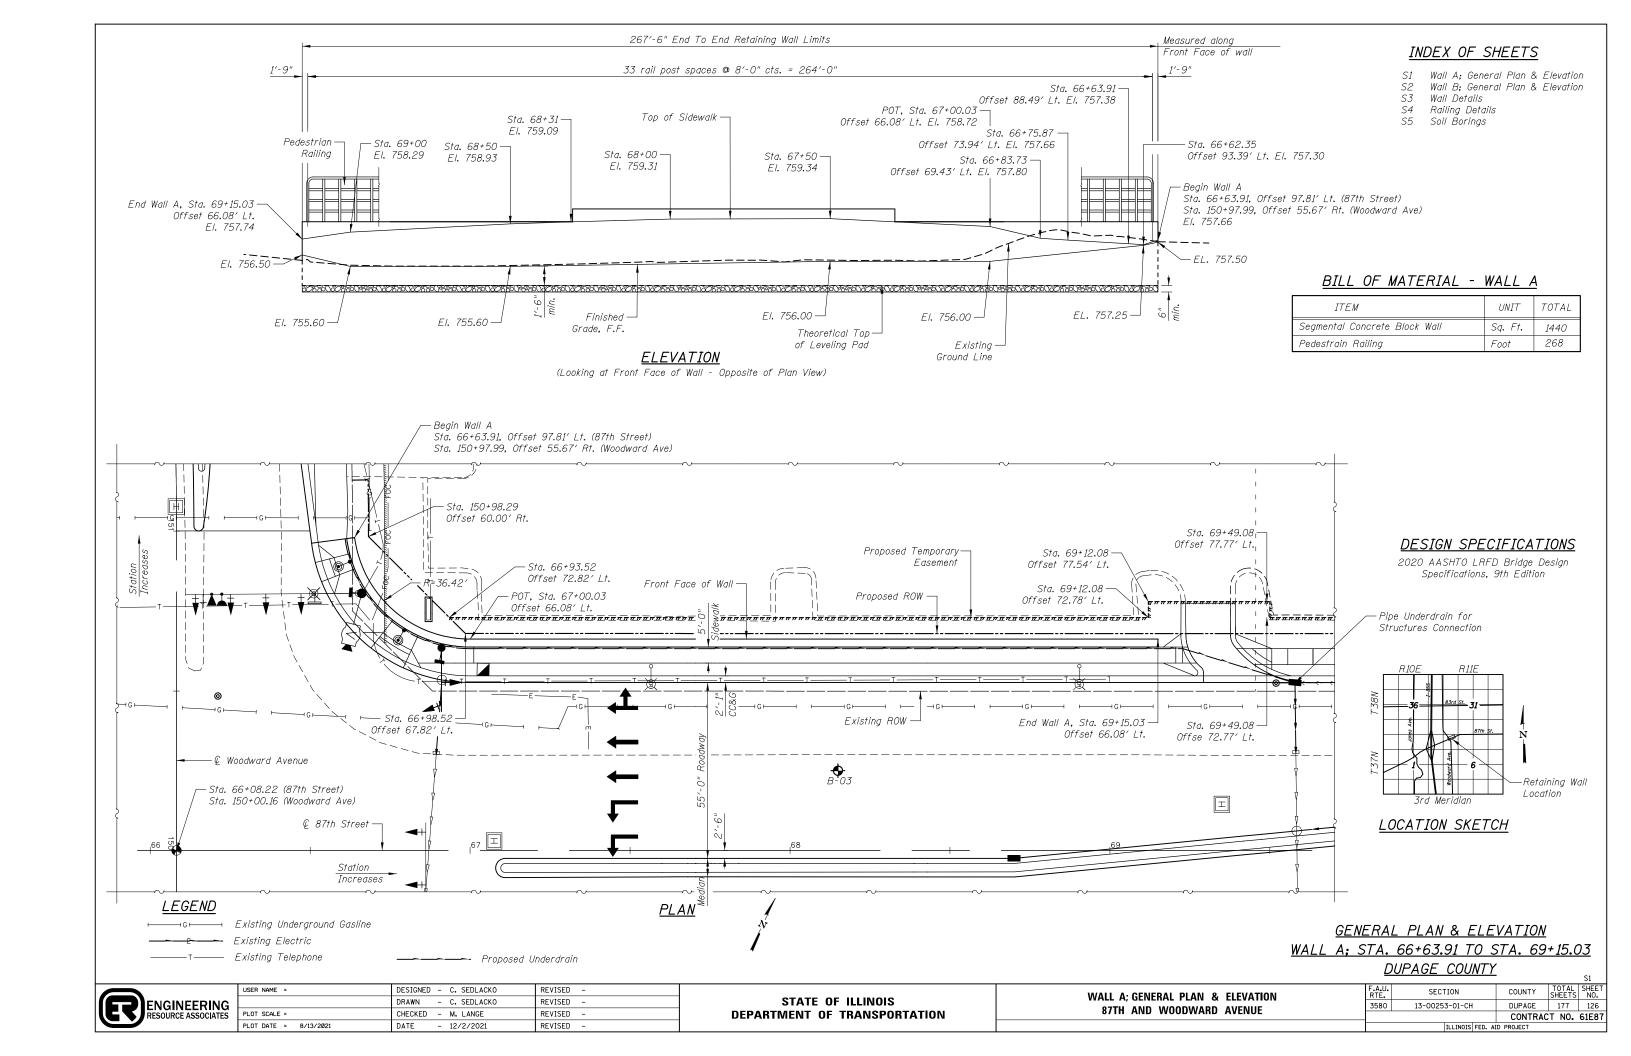


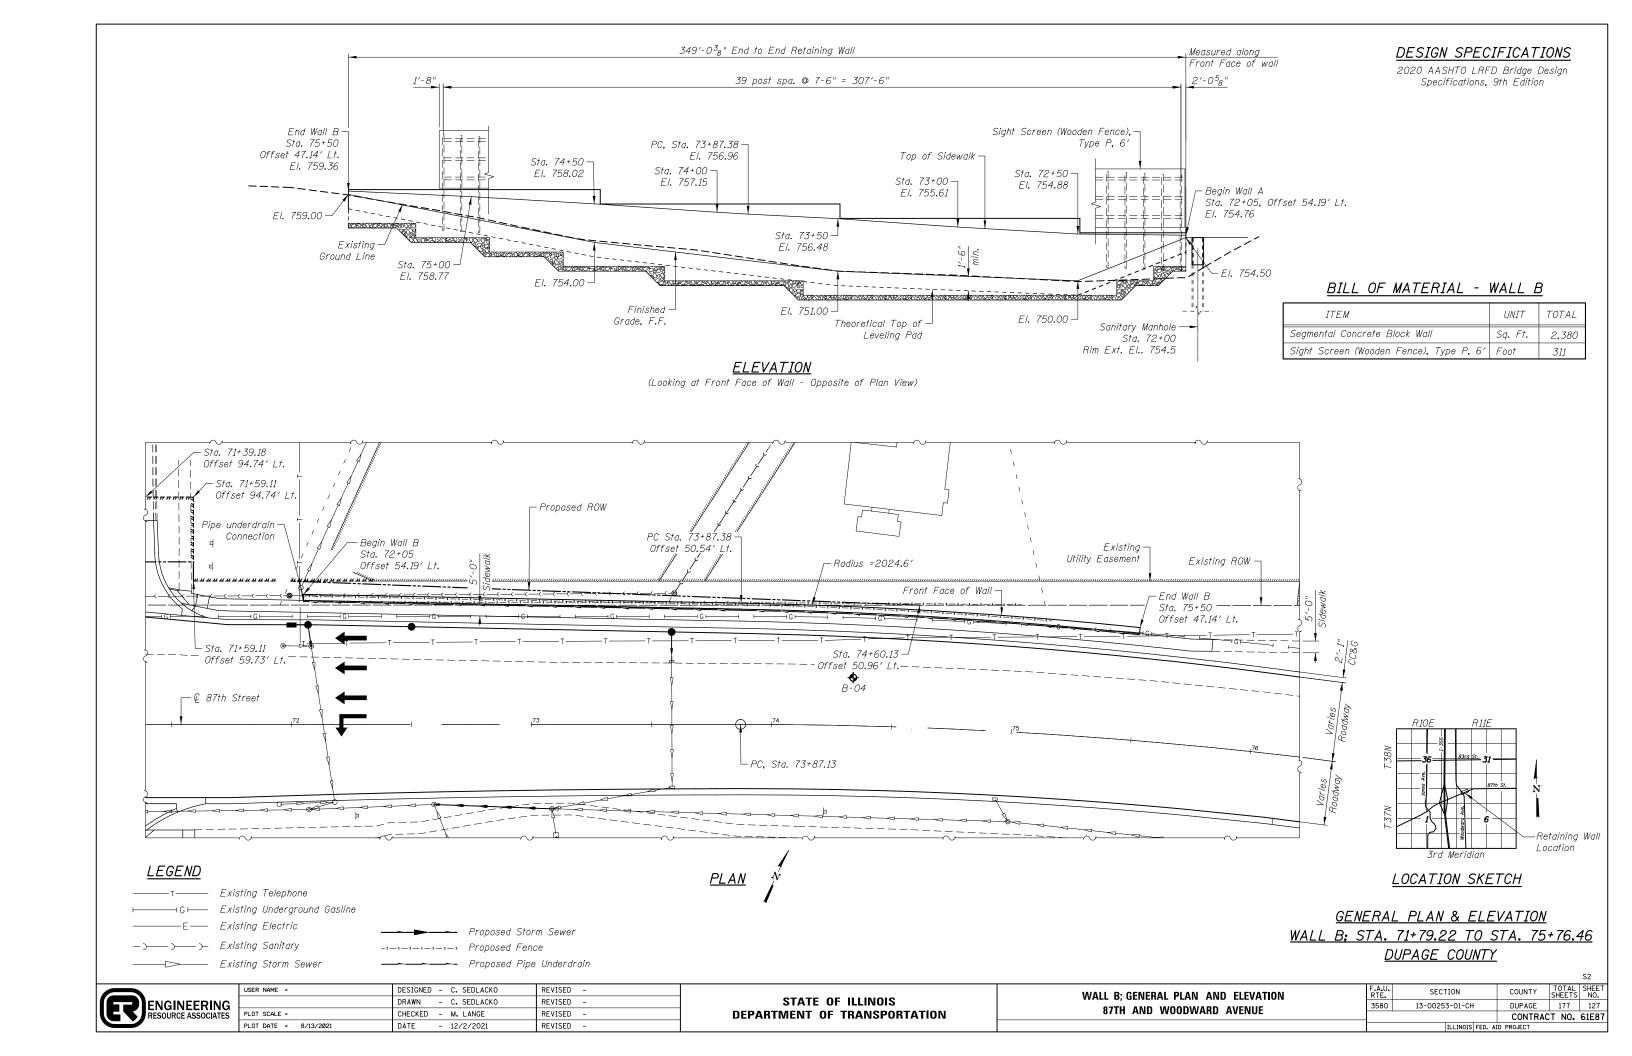

TYPICAL CROSS SECTION - WALL A

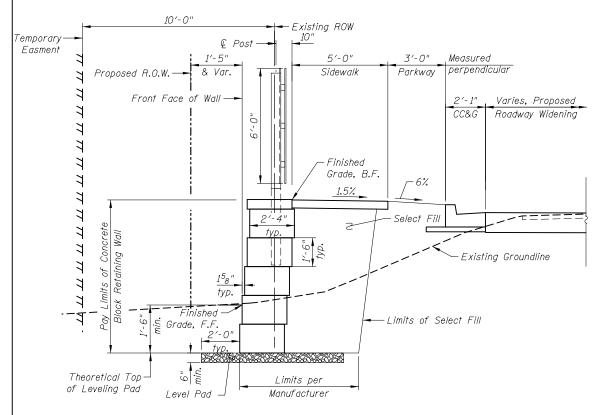

TYPICAL SECTION - WALL B

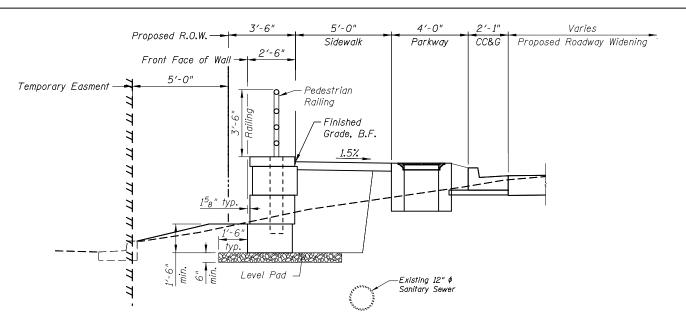

SECTION AT HANDHOLE

GENERAL NOTES:

- Design and installation of Concrete Bock Retaining Wall using big block (without the need for Soil Reinforcement) to be in accordance with Wall System Manufacturer Design Requirements and Specifications.
- 2. Pay limits for Concrete Block retaining wall is from Top of Block to the top of the theoretical leveling pad.
- Limits of backfill behind retaining wall is included in the cost of the concrete block retaining wall.


RESOURCE ASSOCIATES

USER NAME =	DESIGNED - C. SEDLACKO	REVISED -
	DRAWN - C. SEDLACKO	REVISED -
PLOT SCALE =	CHECKED - M. LANGE	REVISED -
PLOT DATE = 8/13/2021	DATE - 12/2/2021	REVISED -


STATE OF ILLINOIS DEPARTMENT OF TRANSPORTATION


WALL DETAILS 87TH AND WOODWARD AVENUE F.A.U. SECTION COUNTY TOTAL SHEETS NO.
3580 13-00253-01-CH DUPAGE 177 128

CONTRACT NO. 61E87

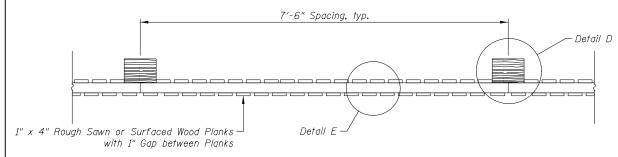


WOOD PRIVACY FENCE - PLAN

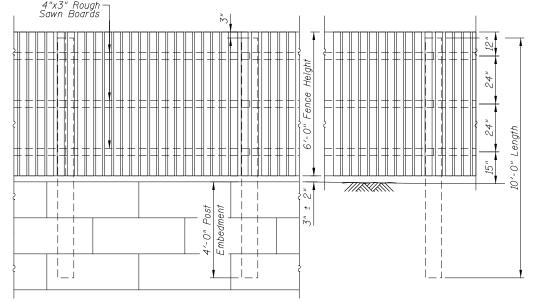

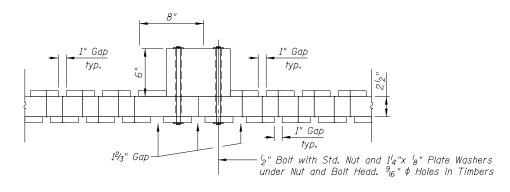


DETAIL D


(Showing Post Connection)

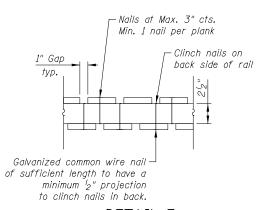


DETAIL E


(Showing Typical Plank to Rail Attachment Each Rail)

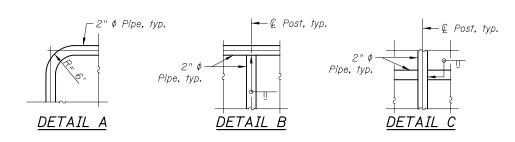

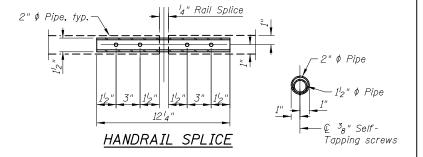

WOOD PRIVACY FENCE - ELEVATION

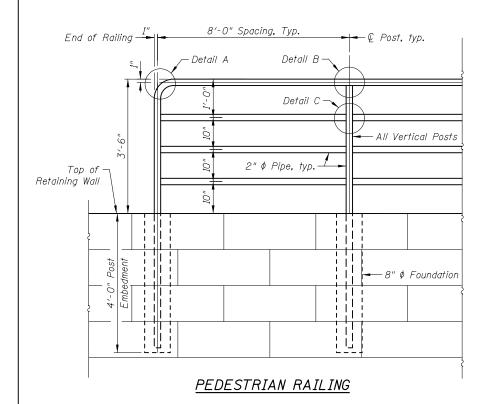


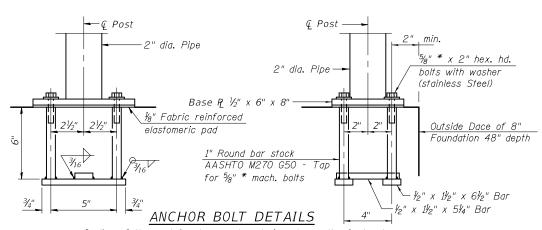

In lieu of the cast-in-place anchor device shown, the Contractor has the option of drilling and setting $\frac{5}{8}$ " * anchor rods according to Article 509.06 of the Standard Specifications. Embedment shall be according to the manufacturer's specifications.

RAILING NOTES:

- 1. Railing shall be according to Section 509 of the Standard Specification, except as noted and will be paid for at the Contract Unit Price per Foot for PEDESTRIAN RAILING.
- 2. Hollow structural steel tubing shall conform to requirements of ASTM designation A500, Grade B structural steel tubing.
- 3. All other steel shapes and plates shall conform to the requirments of AASHTO M270 Grade 36.
- 4. All steel railing elements shall be galvanized according to Article 509.05 of the Standard Specifications.

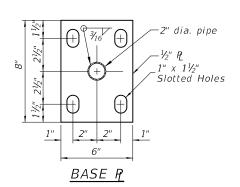


ENGINEERING


USER NAME =	DESIGNED - C. SEDLACKO	REVISED -
	DRAWN - C. SEDLACKO	REVISED -
PLOT SCALE =	CHECKED - M. LANGE	REVISED -
PLOT DATE = 8/13/2021	DATE - 12/2/2021	REVISED -
		•

STATE OF ILLINOIS **DEPARTMENT OF TRANSPORTATION**

RAILING DETAILS 87TH AND WOODWARD AVENUE


				S4
F.A.U. RTE.	SECTION	COUNTY	TOTAL SHEETS	SHEET NO.
3580	13-00253-01-CH	DUPAGE	177	129
		CONTRAC	T NO.	61E87
	ILLINOIS FED. A	AID PROJECT		

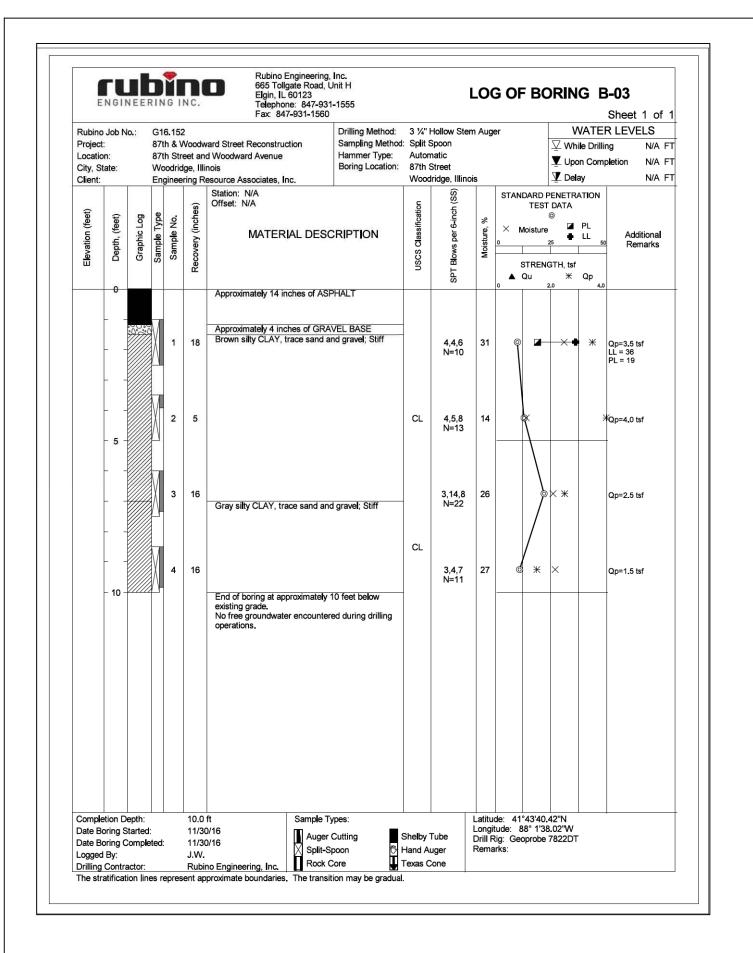

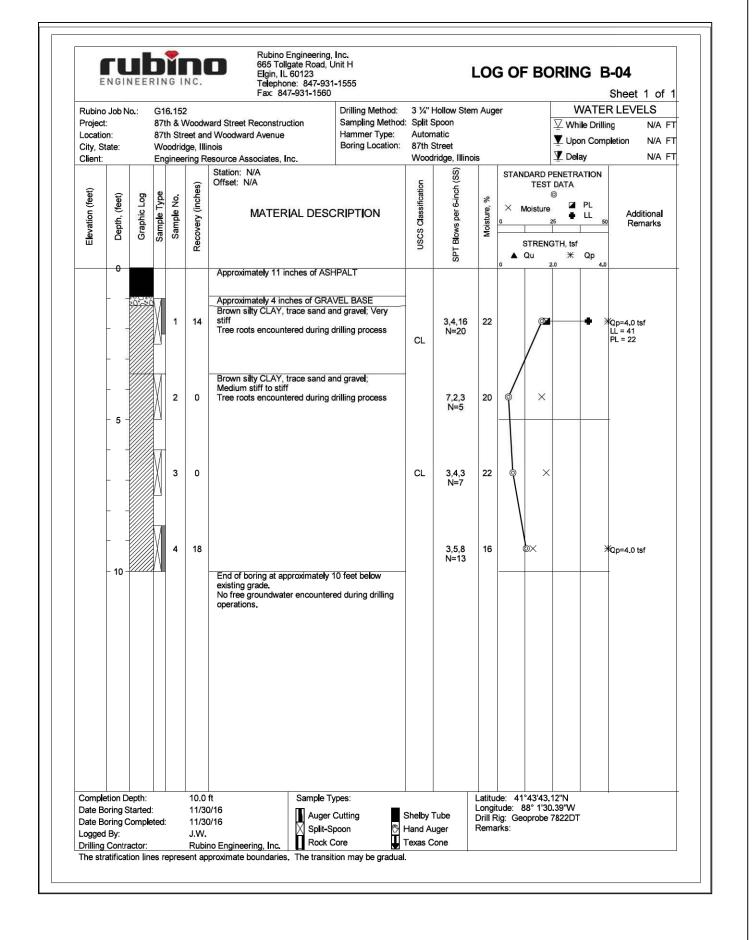






USER NAME =	DESIGNED - C. SEDLACKO	REVISED -
	DRAWN - C. SEDLACKO	REVISED -
PLOT SCALE =	CHECKED - M. LANGE	REVISED -
PLOT DATE = 8/13/2021	DATE - 12/2/2021	REVISED -

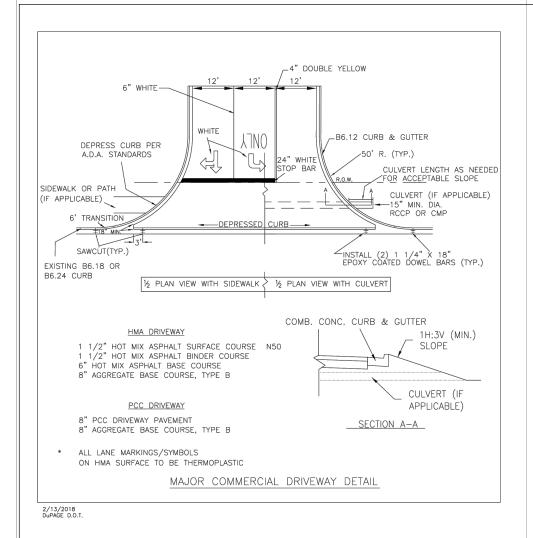

TYPICAL CURBED SIDE ROAD APPROACH

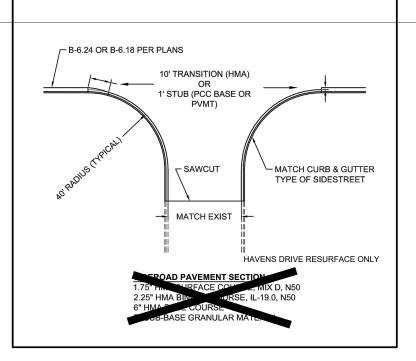

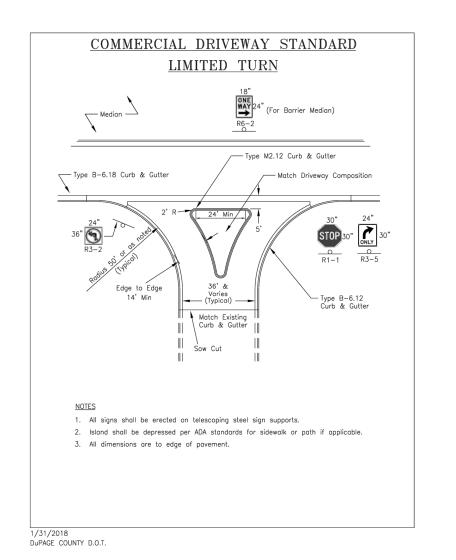

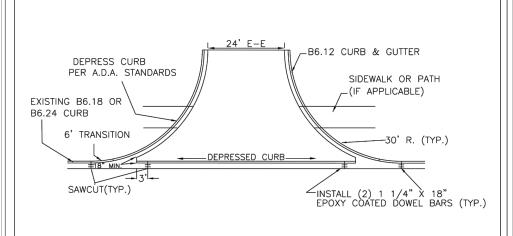

HMA DRIVEWAY

- 1 1/2" HOT MIX ASPHALT SURFACE COURSE N50 1 1/2" HOT MIX ASPHALT BINDER COURSE
- 6" HOT MIX ASPHALT BASE COURSE 8" AGGREGATE BASE COURSE, TYPE B

INCREASE HMA SURFACE AND BINDER THICKNESS AS NEEDED PER MIXTURE DESIGNS.


PCC DRIVEWAY

8" PCC DRIVEWAY PAVEMENT

8" AGGREGATE BASE COURSE, TYPE B

COMMERCIAL DRIVEWAY DETAIL

1/29/2018 Dupage county division of transportation

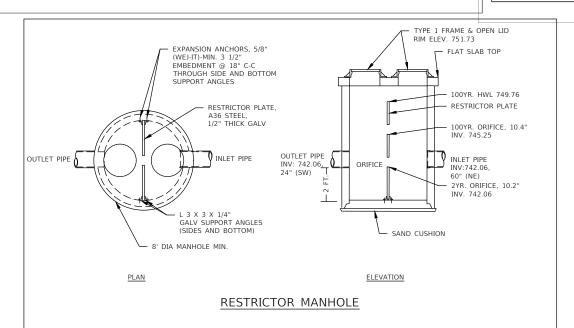

SCALE: N.T.S.

ENGINEERING RESOURCE ASSOCIATES

USER NAME = Richard Tanner	DESIGNED	-	EW	REVISED	-	04/25/19
	DRAWN	-	RT	REVISED	-	10/08/2021
PLOT SCALE = \$SCALE\$	CHECKED	-	BD	REVISED	-	11/03/2021
PLOT DATE = 12/2/2021	DATE	-	04/25/19	REVISED	-	

STATE OF ILLINOIS **DEPARTMENT OF TRANSPORTATION**

87th STREET AND WOODWARD AVENUE			F.A.U. SECTION		COUNTY	TOTAL SHEETS	SHEET NO.	
COUNTY DETAILS		358	30	13-00253-0I-CH	DuPage	177	131	
						CONTRAC	T NO.	6IE87
SHEET NO. 1 OF 4 SHEETS	STA.	TO STA.	FED.	. ROA	D DIST. NO ILLINOIS FED. A	D PROJECT		

PAVEMENT MARKINGS AND PAVEMENT MARKERS

MATERIALS FOR PAVEMENT MARKINGS:

ALL MARKINGS ON BITUMINOUS PAVEMENT THERMOPLASTIC PAVEMENT MARKINGS

ALL MARKINGS ON CONCRETE SURFACES URETHANE

PAVEMENT MARKINGS

INSTALLATION OF PAVEMENT MARKINGS:

LOCATION TYPE OF MARKING 4" DOUBLE YELLOW; 11" c-c AND PAINTED MEDIANS 12" YELLOW @ 45°; 30' c-c 4" YELLOW BARRIER MEDIANS TURN BAY TAPERS ALONG THRU LANES 6" WHITE, 2' LONG, 6' SPACE (DOTTED WHITE) START OF TURN BAYS ARROW AND "ONLY" END OF TURN BAYS 150'-200' LONG ADDITIONAL ARROW 10' FROM END


ALL OTHER MARKINGS PER MANUAL OF UNIFORM TRAFFIC CONTROL DEVICES OF ILLINOIS


INSTALLATION OF RECESSED REFLECTIVE PAVEMENT MARKERS:


<u>LOCATION</u>	SPACING
DOUBLE YELLOW CENTERLINE, & SKIP-DASH WHITE LANE LINES APPROACH & DEPARTURE FROM INTERSECTIONS & CURVES* * EQUAL TO LENGTH OF TURN BAY, OR 200'	40'
ALONG CURVES OR TAPERS	40'
TANGENT SECTIONS	40'
SOLID LANE LINES (TURN BAYS)	40'
END OF PAINTED MEDIANS	3 @ 3' LATERAL
LOCATION	TYPE
DOUBLE YELLOW CENTERLINE	2-WAY YELLOW
PAINTED MEDIANS ≤ 4' WIDE	2-WAY YELLOW
PAINTED MEDIANS >4' WIDE	1-WAY YELLOW
YELLOW LINE ALONG BARRIER MEDIANS ** EXCEPT IN SPECIAL CIRCUMSTANCES	NONE **
SKIP-DASH WHITE LANE LINES, SOLID LANE LINES (TURN BAYS) 2-WAY, UNDIVIDED ROADWAY 1-WAY ROADWAY, OR DIVIDED WITH BARRIER MEDIAN	1-WAY WHITE 2-WAY WHITE / RED
1- 11/11 KOND 11/11, OK DIVIDED WITH BARKIER WEDIAN	2-11/11 1/11/11/11/11/11/11/11/11/11/11/11

9/1/2020 **DuPAGE COUNTY D.O.T.**

TURN BAYS > 200' LONG

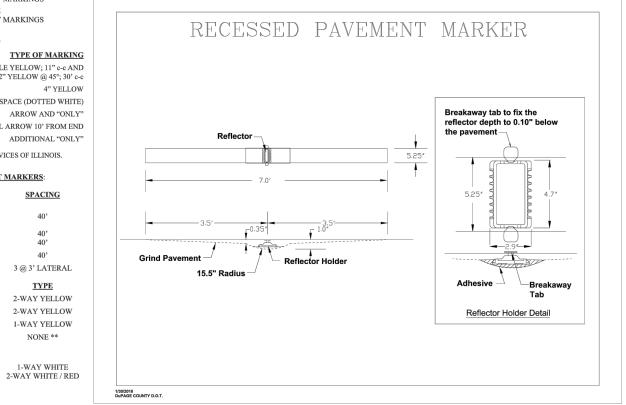

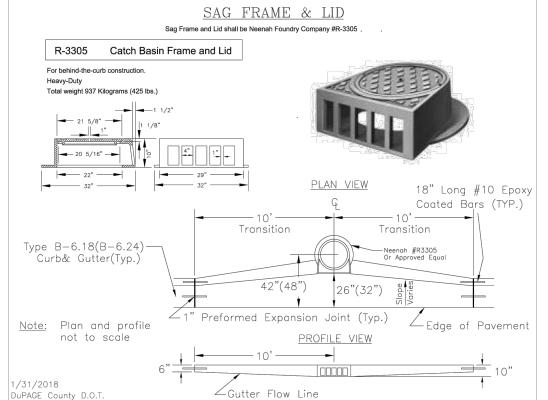

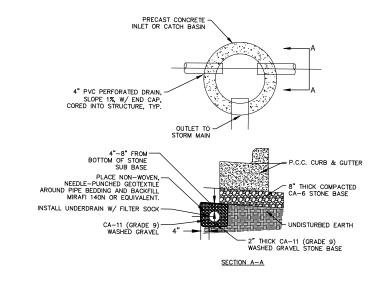

NOTES:


1. INSTALL A 4" PVC PERFORATED DRAIN PIPE ADJACENT TO THE GUTTER AND PARALLEL TO THE CURB IN BOTH DIRECTIONS (SEE PLANS FOR QUANTITY) AND CAP ENDS.

2. INSTALL FILTER FABRIC AROUND GRANULAR BACKFILL WITH 1" OVERLAP. INSTALL TOP OF UNDERDRAIN A MINIMUM OF 4" AND A MAXIMUM OF 8" BELOW THE PAVEMENT BASE COURSE.

SCALE: N.T.S.

PVC UNDERDRAIN IN PAVEMENT

DUPAGE COUNTY DIVISION OF TRANSPORTATION TRENCH BACKFILL STANDARD IN PAVED AREAS _3" Hot-mix asphalt (HMA) adjacent Surface Course 4' or less to lane lane edge-resurfacing of -Minimum 12" (or match adjacent lane req'd(typ) existing, whichever is greater) Class PP PCC -Sawcut full depth(typ) -24" Reflective Crack control Fabric(typ) Undisturbed subbase — Base of existing pavement 1' shelf (typ.) +++ CLSM, FA-6 or FA-7(w/4"-6"capping material) or CA-7 limestone chip trench backfill (As approved by DPCDOT) Undisturbed earth— -Compacted aranular Undisturbed earthcapping material (As approved by engineer) -Compacted granular bedding material (As approved by engineer) Notes: All materials per IDOT's "Standard Specifications for Road & Bridge Construction" (latest edition) and "Supplemental Recurring Special Provisions" (latest edition) 2. Replace all pavement markings, striping, symbols and

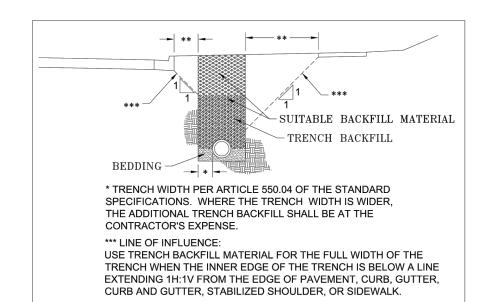


1/31/2018 DuPAGE COUNTY D.O.T

	USER NAME = Richard Tanner	DESIGNED -	EW	REVISED -	11/01/18
ENGINEERING		DRAWN -	RT	REVISED -	10/08/2021
RESOURCE ASSOCIATES	PLOT SCALE = \$SCALE\$	CHECKED -	BD	REVISED -	
	PLOT DATE = 12/2/2021	DATE -	02/23/18	REVISED -	

STATE OF ILLINOIS **DEPARTMENT OF TRANSPORTATION**

87th STREET AND WOODWARD AVENUE COUNTY DETAILS		F.A.U. RTE.	SEC	TION	COUNTY	TOTAL SHEETS	SHEET NO.
		3580	13-0025	53-0I-CH	DuPage	178	132
					CONTRAC	T NO.	6IE87
SHEET NO. 2 OF 4 SHEETS	STA. TO STA.	EED B	OAD DIST NO	ILLINOIS FED A	ID PROJECT		

Dupage County Trench Backfill Detail

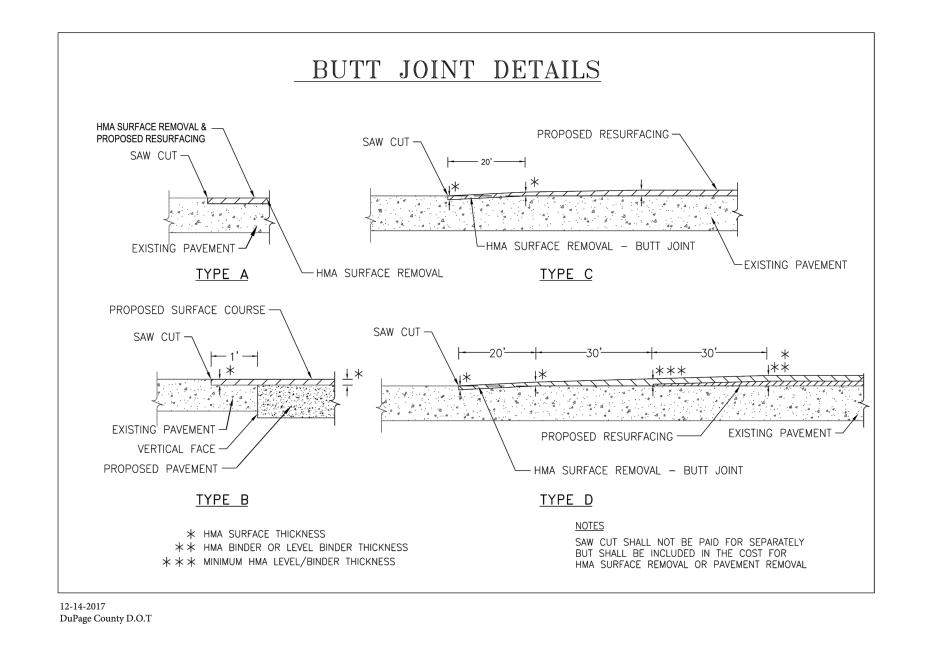


ENGINEERING RESOURCE ASSOCIATES


	USER NAME = Richard Tanner	DESIGNED -	EW	REVISED -	04/25/19
3		DRAWN -	RT	REVISED -	10/08/2021
S	PLOT SCALE = \$SCALE\$	CHECKED -	BD	REVISED -	
	PLOT DATE = 12/2/2021	DATE -	04/25/19	REVISED -	


SCALE: N.T.S.


87th STREET AND WOODWARD AVENUE					SEC.	TION	COUNTY	INTY TOTAL SHEETS	
COUNTY DETAILS			3580	I3-00253-0I-CH		DuPage	177	133	
							CONTRAC	T NO.	6IE87
	SHEET NO. 3 OF 4 SHEETS	STA.	TO STA.	FED. R	OAD DIST. NO	ILLINOIS FED. A	ID PROJECT		

MEDIAN DETAILS

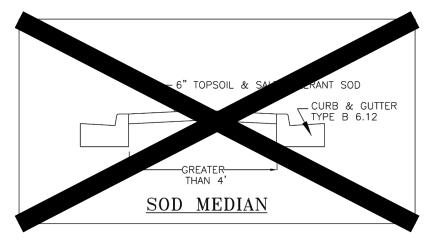

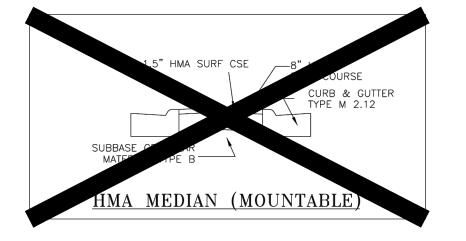


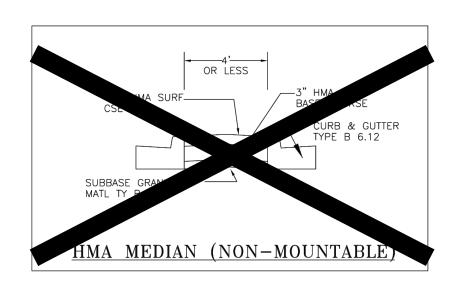


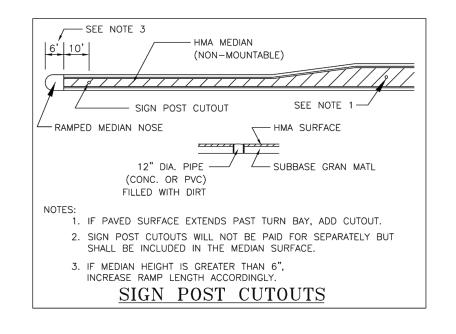

SCALE: N.T.S.

1/30/2018 DuPAGE COUNTY D.O.T.

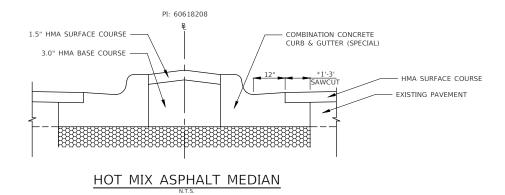

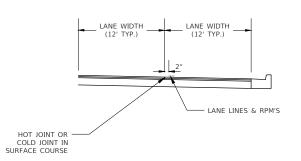



PAVEMENT MARKING LOCATION



	USER NAME = Richard Tanner	DESIGNED -	EW	REVISED -	04/25/19
3		DRAWN -	RT	REVISED -	07/19/19
S	PLOT SCALE = \$SCALE\$	CHECKED -	BD	REVISED -	10/08/2021
	PLOT DATE = 12/2/2021	DATE -	04/25/19	REVISED -	


87th STREET AND WOODWARD AVENUE				F.A.U. RTE.	SECTION			COUNTY	TOTAL SHEETS	SHEET NO.	
COUNTY DETAILS			3580	I3-00253-0I-CH			DuPage	177	134		
	000							CONTRAC	T NO.	6IE87	
	SHEET NO. 4 OF 4 SHEETS	STA.	TO STA.		FED. R	OAD DIST. NO	ILLINOIS	FED. A	D PROJECT		

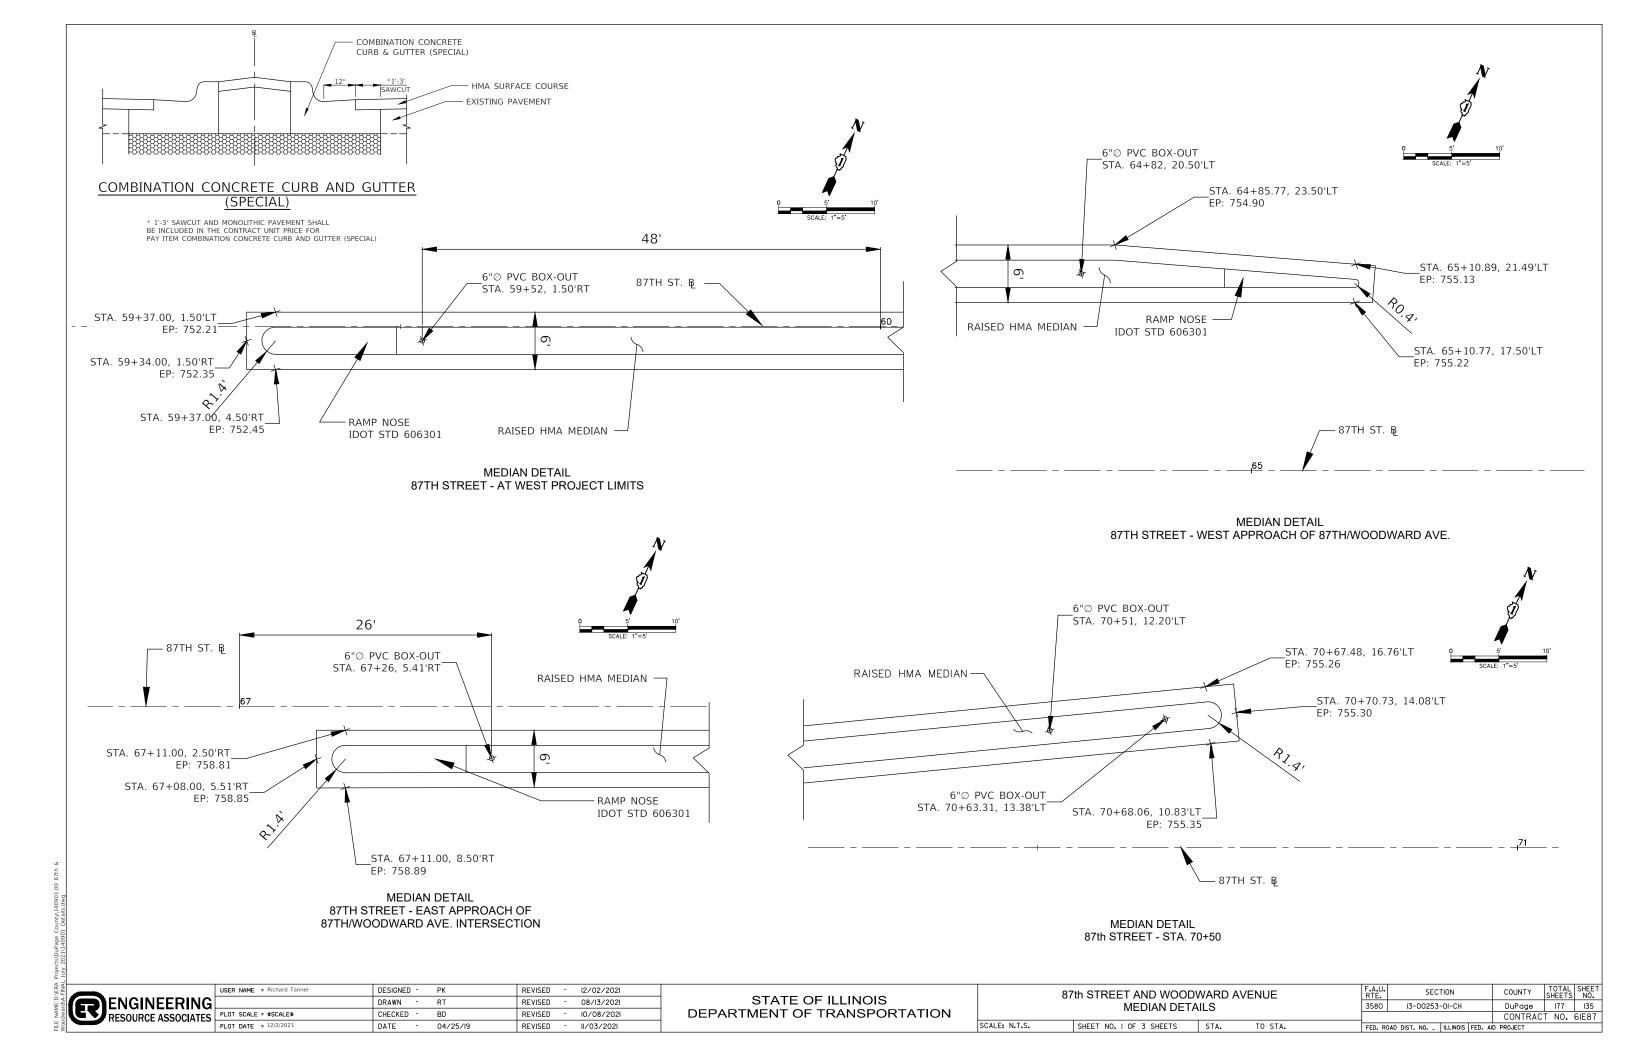


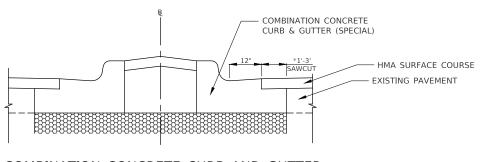


COMBINATION CONCRETE CURB AND GUTTER (SPECIAL)

* 1'-3' SAWCUT AND MONOLITHIC PAVEMENT SHALL BE INCLUDED IN THE CONTRACT UNIT PRICE FOR PAY ITEM COMBINATION CONCRETE CURB AND GUTTER (SPECIAL)

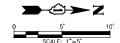

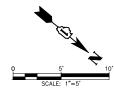

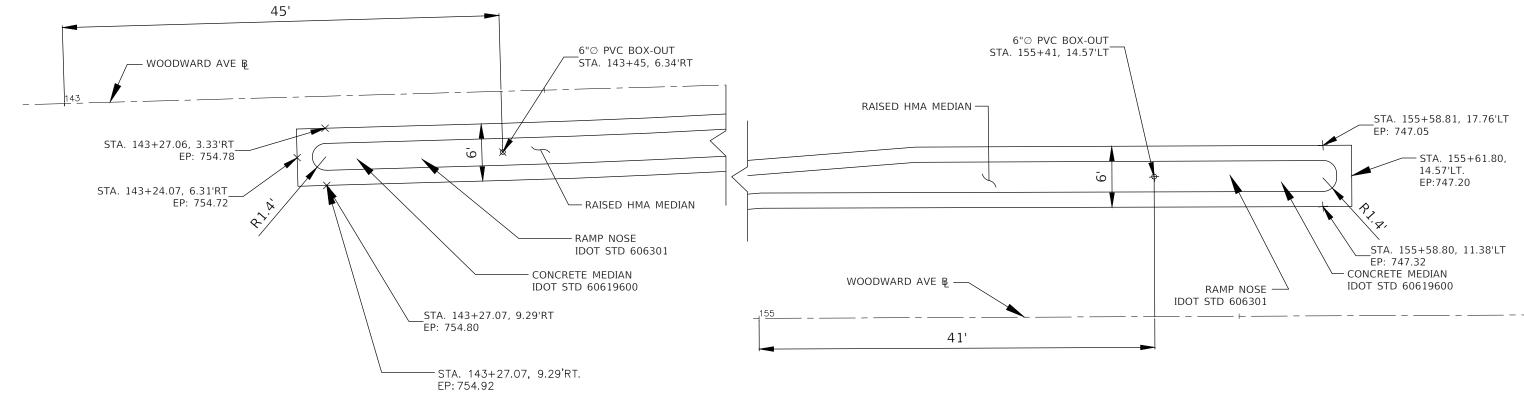

MEDIAN DETAIL
WOODWARD AVE. - AT SOUTH PROJECT LIMITS


MEDIAN DETAIL WOODWARD AVENUE - AT NORTH PROJECT LIMITS

ENGINEERIN RESOURCE ASSOCIATION	G	
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	USER NAME = Richard Tanner	DESIGNED -	PK	REVISED	-	04/26/2019
Gl		DRAWN -	RT	REVISED	-	08/13/2021
s	PLOT SCALE = \$SCALE\$	CHECKED -	BD	REVISED	-	10/08/2021
	PLOT DATE = 12/2/2021	DATE -	04/26/19	REVISED	-	11/03/2021


STATE OF ILLINOIS	
DEPARTMENT OF TRANSPORTATION	

87th STREET AND WOODWARD AVENUE					F.A.U. RTE.	SECTION	COUNTY	TOTAL SHEETS	SHEET NO.
MEDIAN DETAILS				3580 I3-00253-0I-CH		DuPage	177	136	
							CONTRAC	T NO.	6IE87
SCALE: N.T.S.	SHEET NO. 2 OF 3 SHEETS	STA.	TO STA.		FED. ROAD DIST. NO ILLINOIS FED. AID PROJECT				

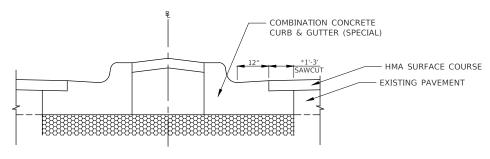



COMBINATION CONCRETE CURB AND GUTTER (SPECIAL)

* 1'-3' SAWCUT AND MONOLITHIC PAVEMENT SHALL BE INCLUDED IN THE CONTRACT UNIT PRICE FOR PAY ITEM COMBINATION CONCRETE CURB AND GUTTER (SPECIAL)

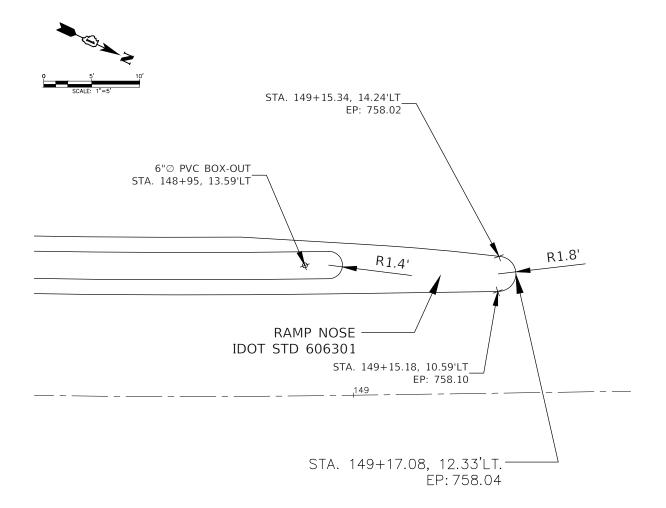



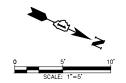

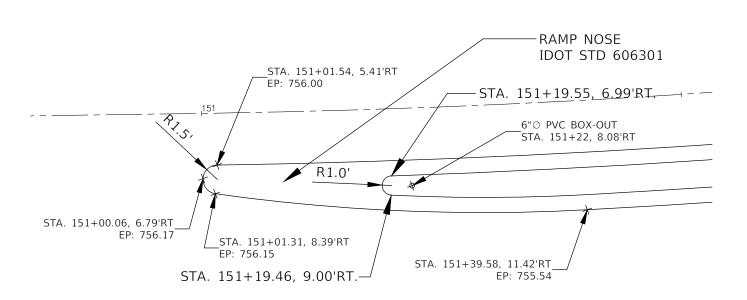


MEDIAN DETAIL WOODWARD AVENUE - NORTH APPROACH OF 87th/WOODWARD AVE. INTERSECTION

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oogward/A-	ENGINEERING BESOURCE ASSOCIATES	Ĺ
awa	RESOURCE ASSOCIATES	Ĺ
8	THE SOUTH OF THE SOUTH TEST	ī


	USER NAME = Richard Tanner	DESIGNED -	PK	REVISED -	04/25/19
;		DRAWN -	RT	REVISED -	08/13/2021
3	PLOT SCALE = \$SCALE\$	CHECKED -	BD	REVISED -	10/08/2021
	PLOT DATE = 12/2/2021	DATE -	04/25/19	REVISED -	11/03/2021


	87th STREET AND WOOD	F.A.U RTE.	• SEC	TION		COUNTY	TOTAL SHEETS	SHEET NO.			
	MEDIAN DETAILS								DuPage	177	137
									CONTRACT	NO. 6	6IE897
SCALE: N.T.S.	SHEET NO. 3 OF 3 SHEETS	STA.	TO STA.		FED.	ROAD DIST. NO	ILLINOIS	FED. A	ID PROJECT		

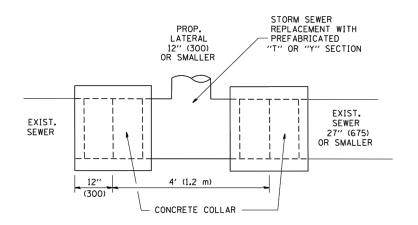

DETAIL "A"

LATERAL CONNECTION TO EXISTING SEWER
OF 27" (675) OR SMALLER

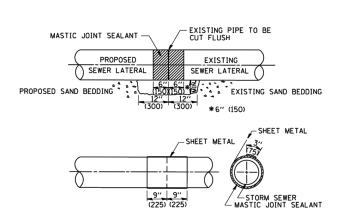


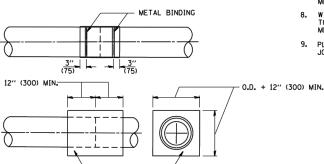

<u>DETAIL "B"</u> CLASS SI CONCRETE COLLAR

CONSTRUCTION SEQUENCE

- 1. CUT THE EXISTING END OF THE PIPE SO AS TO PRESENT A FLUSH BUTT JOINT, BRUSH AND CLEAN ALL PIPES.
- 2. APPLY THE MASTIC JOINT SEALANT TO THE FIRST 6" (150) OF EACH PIPE.
- 3. BUTT THE PIPES TOGETHER LEAVING A MINIMUM OF 12' × 6' (300 × 150) DEEP EXCAVATION UNDER AND AROUND EACH PIPE END.
- 4. CUT A PIECE OF SHEET METAL GAGE NO. 19 1.1 (0.0418) 18" (450) WIDE BY THE OUTSIDE CIRCUMFERANCE OF THE PIPE PLUS 3" (75) LONG.
- 5. WRAP THE SHEET METAL AROUND THE PIPES, 9" (225) ON EACH SIDE OF THE JOINT, STARTING AT THE TOP OF THE PIPE.
- 6. LAP THE SHEET METAL AT LEAST 3" (75) AT THE TOP OF THE PIPE AND PLACE THE MASTIC JOINT SEALANT BETWEEN THE LAP.
- 7. PLACE TWO METAL BANDS AROUND THE SHEET METAL AND TIGHTEN.
- 8. WIPE OFF ANY EXCESS MASTIC JOINT SEALANT THAT OOZES OUT FROM BETWEEN THE SHEET METAL AND THE PIPES.
- 9. PLACE CLASS SI CONCRETE AROUND THE JOINT.

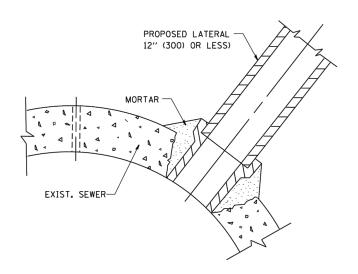

DETAIL "C"

PROPOSED LATERAL
CONNECTION TO EXISTING SEWER
OF 30" (750) OR LARGER

NOTES

MATERIAL

MATERIAL USED FOR THE TEE OR WYE SECTION SHALL BE COMPATIBLE WITH THE EXISTING STORM SEWER OR THE PROPOSED STORM SEWER.

CONSTRUCTION METHODS

- I. THIS WORK SHALL BE CONSTRUCTED IN CONFORMANCE WITH THE APPLICABLE PORTIONS OF SECTION 550 OF THE STANDARD SPECIFICATIONS.
- II. CONNECTION TO AN EXISTING STORM SEWER SHALL BE BY EITHER OF THE FOLLOWING METHODS:

 A) PROPOSED STORM SEWER CONNECTION TO EXISTING SEWER OF 27" (675) OR SMALLER SEE
 - B) PROPOSED STORM SEWER CONNECTION TO EXISTING SEWER OF 30" (750) OR LARGER SEE DETAIL "C".

IF THE EXISTING SEWER PIPE IS CRACKED, BROKEN OR OTHERWISE DAMAGED BY THE CONTRACTOR IN MAKING THE CIRCULAR OPENING, THE CONTRACTOR SHALL REPLACE THAT SECTION OF PIPE WITH PIPE EQUAL AND SIMILAR IN ALL RESPECTS TO THE PIPE IN THE EXISTING SEWER, IN A CAREFUL WORKMANLIKE MANNER, WITHOUT EXTRA COMPENSATION.

GENERAL

CARE MUST BE TAKEN TO PREVENT DEBRIS FROM ENTERING THE SEWER. ALL DEBRIS WHICH ENTERS THE SEWER MUST BE REMOVED. THE SEWER MUST BE LEFT CLEAN AND UNOBSTRUCTED UPON COMPLETION OF THE CONTRACT.

CARE MUST BE TAKEN TO PREVENT ANY PART OF THE NEW PIPE CONNECTION FROM PROJECTING INTO THE EXISTING SEWER.

BASIS OF PAYMENT

TEE OR WYE CONNECTIONS SHALL BE PAID FOR AT THE CONTRACT UNIT PRICE EACH FOR STORM SEWER TEE OR WYE OF THE TYPE AND SIZE SPECIFIED IN THE PLANS, THIS PRICE SHALL INCLUDE ALL EXCAVATION OF THE TRENCH, REMOVAL OF THE EXISTING STORM SEWER, FURNISHING AND INSTALLING THE SPECIFIED TEE OR WYE SECTION, FURNISHING AND INSTALLING THE REOUIRED CONCRETE COLLAR, AND ALL OTHER MATERIAL NECESSARY TO COMPLETE THIS WORK AS SHOWN AND SPECIFIED.

REMOVAL AND REINSTALLATION OF EXISTING STORM SEWER ADJACENT TO THE PROPOSED TEE OR WYE SECTION, FOR THE PURPOSE OF FACILITATING THE INSTALLATION OF THE TEE OR WYE SECTION, WILL NOT BE PAID FOR SEPARATELY BUT SHALL BE INCLUDED IN THE UNIT PRICE BID FOR THE WORK,

TRENCH BACKFILL, EXCAVATION IN ROCK AND REMOVAL AND REPLACEMENT OF UNSUITABLE MATERIAL BELOW PLAN BEDDING GRADE WILL BE PAID FOR SEPARATELY.

SCALE: NONE


CONCRETE COLLAR FOR CONNECTING A PROPOSED STORM SEWER TO AN EXISTING STORM SEWER WILL NOT BE PAID PAID FOR SEPARATELY BUT SHALL BE INCLUDED IN THE COST OF THE PROPOSED STORM SEWER.


ALL DIMENSIONS ARE IN INCHES (MILLIMETERS) UNLESS OTHERWISE SHOWN,

FILE NAME: V:\DUPAGECO\140901.00 87th St & Woodward Ave Design\CADD\A-FINAL July 2021\140901 Dist 1 Details.dwg

USER NAME = gaglianobt DESIGNED - M. DE YONG REVISED - M. DE YONG 05-08-92 DRAWN RT REVISED - R. SHAH 09-09-94 PLOT SCALE = 50.000 '/ IN. CHECKED - BD REVISED - R. SHAH 10-25-94 PLOT DATE = 04/25/2019 DATE 07-25-90 REVISED - R. SHAH 06-12-96

STATE OF ILLINOIS
DEPARTMENT OF TRANSPORTATION

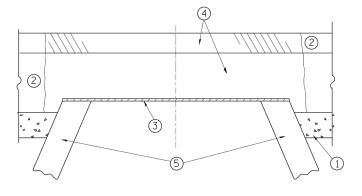

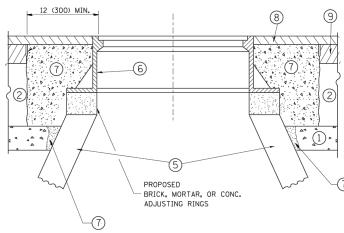

NOTES:

EXISTING BROKEN FRAMES AND LIDS SHALL BE REMOVED AND DISPOSED OF BY THE CONTRACTOR AND SHALL BE REPLACED AS DIRECTED BY THE ENGINEER. REPLACEMENT FRAMES AND LIDS WILL BE PAID FOR IN ACCORDANCE WITH ARTICLE 109,04 OF THE STANDARD SPECIFICATIONS UNLESS A SEPARATE PAY ITEM HAS BEEN PROVIDED.

IF THE EXISTING LIDS ARE OPEN, THE FRAME WILL BE ADJUSTED TO THE ELEVATION OF THE MILLED PAVEMENT SURFACE PRIOR TO THE MILLING OPERATION. THE FRAME WILL NOT BE REMOVED AND COVERED BY THE METAL PLATE.

CITY OF CHICAGO CASTINGS ARE THE PROPERTY OF THE CITY AND THE CONTRACTOR SHALL NOTIFY THE CITY FOR REMOVAL AND DISPOSITION OF THE CASTINGS.

THE METAL PLATE USED TO COVER THE STRUCTURE SHALL REMAIN THE PROPERTY OF THE CONTRACTOR.

WHEN STRUCTURES ARE TO BE ADJUSTED OR RECONSTRUCTED, THE LOWERING AND RAISING OF THE FRAMES AND LIDS WILL NOT BE PAID FOR SEPARATELY BUT WILL BE INCLUDED IN THE COST OF THE CORRESPONDING PAY ITEM.

SCALE: NONE

CONSTRUCTION PROCEDURES

STAGE 1 (BEFORE PAVEMENT MILLING)

- A) REMOVE A MINIMUM OF 12 (300) OF THE PAVEMENT FROM AROUND THE STRUCTURE.
- B) REMOVE THE EXISTING FRAME AND LID FROM THE STRUCTURE.
- C) COVER THE STRUCTURE OPENING WITH A 36 (900) DIAMETER METAL PLATE.

 D) BACKFILL WITH CRUSHED STONE AND A MINIMUM 11/2 (40)
- D) BACKFILL WITH CRUSHED STONE AND A MINIMUM 1/2 (40 THICK HMA SURFACE MIX APPROVED BY THE ENGINEER.

STAGE 2 (AFTER PAVEMENT MILLING)

- A) REMOVE THE HMA SURFACE MIX AND CRUSHED STONE.
- B) INSTALL THE FRAME AND LID; ADJUST THE FRAME TO ITS FINAL SURFACE ELEVATION.
- C) THE SURROUNDING SPACE SHALL BE FILLED WITH CLASS PP-1*
 CONCRETE TO THE ELEVATION OF THE SURFACE OF THE EXISTING
 BASE COURSE OR THE BINDER COURSE.
- *UNLESS OTHERWISE SPECIFIED IN THE PLANS.

THE PROCEDURE EXPLAINED ABOVE SHALL CONFORM TO THE APPLICABLE PORTIONS OF SECTIONS 353, 406, 602, AND 603 OF THE STANDARD SPECIFICATIONS EXCEPT THAT "THE CONTRACTOR SHALL ADJUST THE STRUCTURES TO THE FINISHED PAVEMENT ELEVATION NO MORE THAN 5 CALENDAR DAYS PRIOR TO PLACEMENT OF THE FINAL LIFT OF SURFACE UNLESS APPROVED BY THE ENGINERR."

LEGEND

- 1 SUB-BASE GRANULAR MATERIAL
- (6) FRAME AND LID (SEE NOTES)
- 2 EXISTING PAVEMENT
- (7) CLASS PP-1* CONCRETE
- 3 36 (900) DIAMETER METAL PLATE
- (8) PROPOSED HMA SURFACE COURSE
- PROPOSED CRUSHED STONE AND HMA SURFACE MIX

 (5) EXISTING STRUCTURE
- 9 PROPOSED HMA BINDER COURSE

LOCATION OF STRUCTURES:

THE CONTRACTOR WILL BE REQUIRED TO KEEP A RECORD OF THE LOCATIONS OF THE BURIED STRUCTURES ACCORDING TO THE STATION AND DISTANCE LEFT OR RIGHT OF THE CENTERLINE OF PAVEMENT. UPON COMPLETION OF THE WORK, THE CONTRACTOR WILL DELIVER THE RECORD TO THE ENGINEER.

BASIS OF PAYMENT:

REMOVING FRAMES AND LIDS ON DRAINAGE AND UTILITY STRUCTURES IN THE PAVEMENT PRIOR TO MILLING, AND ADJUSTING TO FINAL GRADE PRIOR TO PLACING THE SURFACE COURSE, WILL BE PAID FOR AT THE CONTRACT UNIT PRICE EACH FOR "FRAMES AND LIDS TO BE ADJUSTED (SPECIAL)."

THIS WORK WILL NOT BE PAID FOR WHEN DRAINAGE AND UTILITY STRUCTURES ARE SPECIFIED FOR PAYMENT AS STRUCTURE RECONSTRUCTION.

NEW FRAMES AND LIDS, WHEN SPECIFIED, WILL BE PAID FOR SEPARATELY.


DETAILS FOR FRAMES AND LIDS ADJUSTMENT WITH MILLING

ALL DIMENSIONS ARE IN INCHES (MILLIMETERS) UNLESS OTHERWISE SHOWN

FILE NAME: V: \DUPAGECO\140901.00 87th
St & Woodward Ave Design\CADD\A-FINAL
July 2021\140901 Dist 1 Details.dwg

	USER NAME = bauerdl	DESIGNED	-	R. SHAH	REVISED	-	R. WIEDEMAN 05-14-04
3.	dgn	DRAWN	-		REVISED	-	R. BORO 01-01-07
	PLOT SCALE = 1968.5000 '/ m	CHECKED	-		REVISED	-	R. BORO 03-09-11
	PLOT DATE = 04/25/2019	DATE	-	10-25-94	REVISED	-	R. BORO 12-06-11

DETAILS FOR	F.A.U. RTE.	SECTION	COUNTY	TOTAL SHEETS	SHEET NO.
FRAMES AND LIDS ADJUSTMENT WITH MILLING	3580	13-00253-01-CH	DuPage	177	139
THANKS AND LIDS ADDOSTMENT WITH MILLING	BD600-03 (BD-8) CONTRACT				61E87
SHEET NO. 1 OF 1 SHEETS STA. TO STA.	FED B	DAD DIST NO 1 THE INDIS FED AT	D PROJECT		

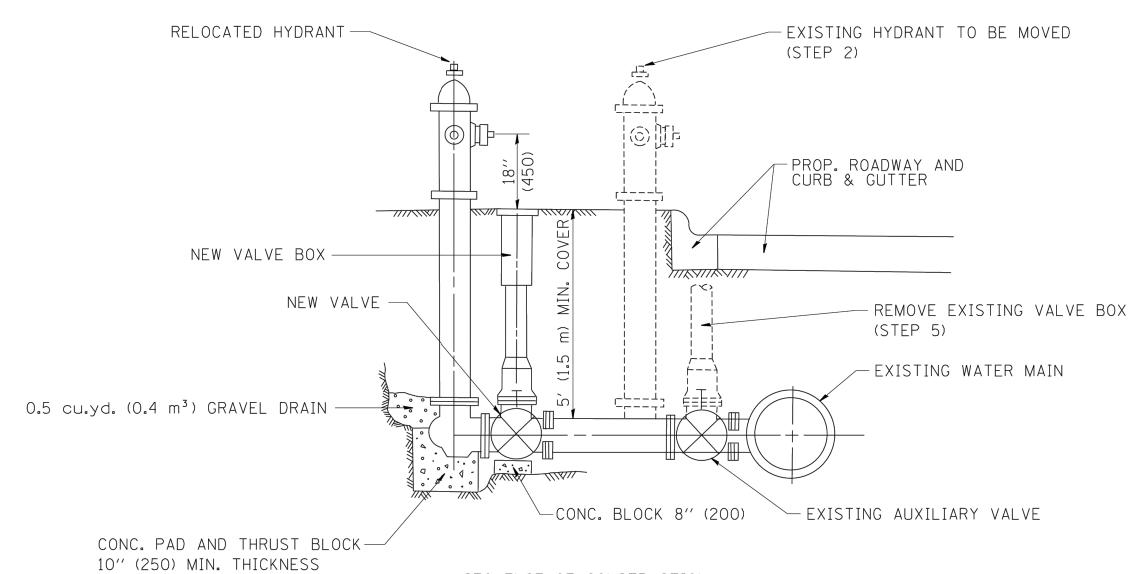

SEQUENCE OF CONSTRUCTION:


- 1. CLOSE EXISTING VALVE.
- 2. REMOVE EXISTING HYDRANT.
- 3. INSTALL HYDRANT EXTENSION AND NEW VALVE.
- 4. RELOCATE EXISTING HYDRANT.
- 5. OPEN EXISTING VALVE, REMOVE BOX.
- 6. BACKFILL.
- 7. FLUSH AND TEST FOR CHLORIDE RESIDUAL AND PROVIDE TEST.

ALL WORK TO BE DONE IN ACCORDANCE WITH ARTICLE 564 OF THE STANDARD SPECIFICATIONS. NEW VALVE AND BOX SHALL BE SAME MAKE AND MODEL AS EXISTING.

FIRE HYDRANT TO BE MOVED

ALL DIMENSIONS ARE IN INCHES (MILLIMETERS) UNLESS OTHERWISE SHOWN.

FILE NAME: V:\DUPAGECO\140901.00 8	th USER NAME = gaglianobt	DESIGNED -	REVISED - R. SHAH 09-09-94			FIRE HYDRANT TO BE MOVED		F.A.U.	SECTION	COUNTY	TOTAL SHE	ĒΤ
July 2021\140901 Dist 1 Details.dwg	NAL	DRAWN -	REVISED - R. SHAH 10-25-94	STATE OF ILLINOIS		FIRE HIDRAINI TO BE MOVED		3580	13-00253-01-CH	DuPage	177 14	40
	PLOT SCALE = 50.0000 '/ IN.	CHECKED -	REVISED -	DEPARTMENT OF TRANSPORTATION				10001	BD-36	CONTRACT	NO. 61E	87
	PLOT DATE = 04/25/2019	DATE -	REVISED -		SCALE: NONE	SHEET NO. 1 OF 1 SHEETS STA.	TO STA.	FED. ROAL	D DIST. NO. 1 ILLINOIS FED. A	ID PROJECT		$\overline{}$

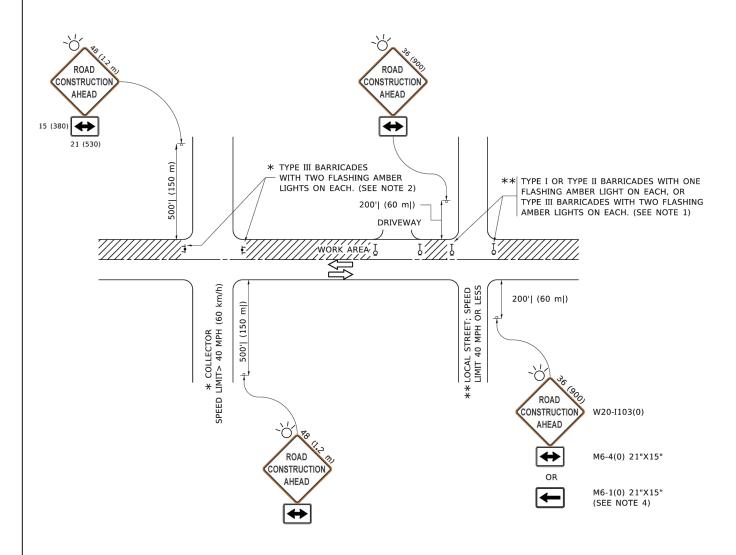

NOTES:

- 1. SIDE ROAD WITH A SPEED LIMIT OF 40 MPH (60 km/h) OR LESS AS SHOWN ON THE DRAWING AND AS DIRECTED BY THE ENGINEER:
- a) ONE "ROAD CONSTRUCTION AHEAD" SIGN 36 x 36 (900x900) WITH A FLASHER MOUNTED ON IT APPROXIMATELY 200' (60 m) IN ADVANCE OF THE MAIN ROUTE.
- b) THE CLOSED PORTION OF THE MAIN ROUTE SHALL BE PROTECTED BY BLOCKING WITH TYPE I, TYPE II OR TYPE III BARRICADES, 1/3 OF THE CROSS SECTION OF THE CLOSED PORTION.
- SIDE ROAD WITH A SPEED LIMIT GREATER THAN 40 MPH (60 km/h) AS SHOWN ON THE DRAWING AND AS DIRECTED BY THE ENGINEER:
 - a) ONE "ROAD CONSTRUCTION AHEAD" SIGN 48 x 48 (1.2 m x 1.2 m) WITH A FLASHER MOUNTED ON IT APPROXIMATELY 500' (150 m) IN ADVANCE OF THE MAIN ROUTE.
- THE CLOSED PORTION OF THE MAIN ROUTE SHALL BE PROTECTED BY
 b) BLOCKING WITH TYPE III BARRICADES, 1/2 OF THE CROSS SECTION
 OF THE CLOSED PORTION.
- 3. CONES MAY BE SUBSTITUTED FOR BARRICADES OR DRUMS AT HALF THE SPACING DURING DAY OPERATIONS. CONES SHALL BE A MINIMUM OF 28 (710)
- WHEN THE SIDE ROAD LIES BETWEEN THE BEGINNING OF THE MAINLINE
 4. SIGNING AND THE WORK ZONE, A SINGLE HEADED ARROW (M6-1) SHALL
 BE USED IN LIEU OF THE DOUBLE HEADED ARROW (M6-4).

SCALE: NONE

- 5. WHEN WORK IS BEING PERFORMED ON A SIDE ROAD OR DRIVEWAY, FOLLOW THE APPLICABLE STANDARD(S). THE DIRECTIONAL ARROW (M6-1 OR M6-4) SHALL BE COVERED OR REMOVED WHEN NO LONGER CONSISTENT WITH THE TRAFFIC CONTROL SET-UP.
- 6. ADVANCE WARNING SIGNS ARE TO BE OMITTED ON DRIVEWAYS UNLESS OTHERWISE SPECIFIED IN THE PLANS OR BY THE ENGINEER
- THE TRAFFIC CONTROL AND PROTECTION FOR SIDE ROADS, INTERSECTIONS, AND DRIVEWAYS SHALL BE INCLUDED IN THE COST OF SPECIFIED TRAFFIC CONTROL STANDARDS OR ITEMS.

All dimensions are in inches (millimeters) unless otherwise shown.

FILE NAME: V: \DUPAGECO\140901.00 87th
St & Woodward Ave Design\CADD\A-FINAL
July 2021\140901 Dist 1 Details.dwg

USER NAME = footemj	DESIGNED - L.H.A.	REVISED - A. HOUSEH 10-15-96
	DRAWN -	REVISED - T. RAMMACHER 01-06-00
PLOT SCALE = 50.0000 ' / in.	CHECKED -	REVISED - A. SCHUETZE 07-01-13
PLOT DATE = 04/25/2019	DATE - 06-89	REVISED _ A. SCHUETZE 09-15-16


STATI	E OI	F ILLINOIS
DEPARTMENT	0F	TRANSPORTATION

	TRAFFIC CONTROL AND PROTECTION FOR										
SI	SIDE ROADS, INTERSECTIONS, AND DRIVEWAYS										
31	SIDE NUADS, INTENSECTIONS, AND DRIVEWAYS										
	SHEET	1	OF	1	SHEETS	STA.	TO STA.				


 F.A.U RTE.
 SECTION
 COUNTY SHEETS
 TOTAL NO.
 SHEETS NO.

 3580
 13-00253-01-CH
 DuPage
 178
 141

 TC-10
 CONTRACT NO.
 61E87

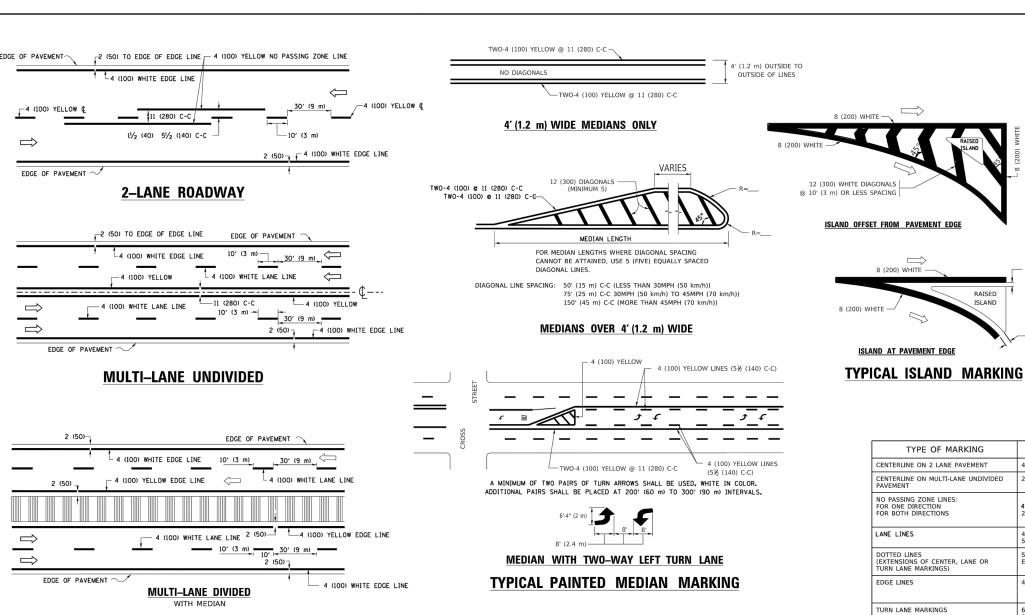


TYPICAL LANE AND EDGE LINE MARKING

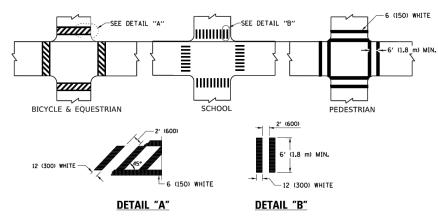

TYPICAL CROSSWALK MARKING


 $m{\star}$ markings shall be installed parallel to the centerline of the road which it crosses

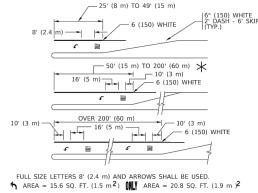

* TURN LANES IN EXCESS OF 400' (120 m) IN LENGTH MAY HAVE AN ADDITIONAL SET OF ARROW - "ONLY" INSTALLED MIDWAY BETWEEN THE OTHER TWO SETS OF

TYPICAL LEFT (OR RIGHT) TURN LANE

TYPICAL TURN LANE MARKING

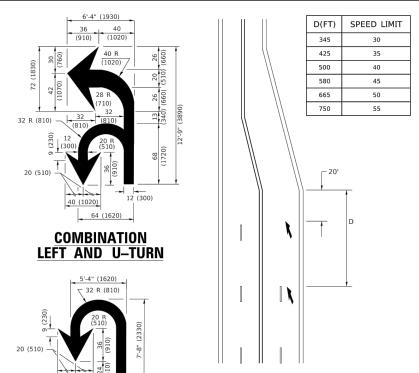

LANE REDUCTION TRANSITION

* LANE REDUCTION ARROWS REQUIRED AT SPEEDS OF 45 MPH OR GREATER OR WHEN SPECIFIED IN PLANS.

		<u>U–T</u>	URN	CANE REDUCTION ARROWS REQUIRED AT SPEEDS OF 45 MP GREATER OR WHEN SPECIFIED IN PLANS.
TYPE OF MARKING	WIDTH OF LINE	PATTERN	COLOR	SPACING / REMARKS
CENTERLINE ON 2 LANE PAVEMENT	4 (100)	SKIP-DASH	YELLOW	10' (3 m) LINE WITH 30' (9 m) SPACE
CENTERLINE ON MULTI-LANE UNDIVIDED PAVEMENT	2 @ 4 (100)	SOLID	YELLOW	11 (280) C-C
NO PASSING ZONE LINES: FOR ONE DIRECTION FOR BOTH DIRECTIONS	4 (100) 2 @ 4 (100)	SOLID SOLID	YELLOW YELLOW	5½ (140) C-C FROM SKIP-DASH CENTERLINE 11 (280) C-C OMIT SKIP-DASH CENTERLINE BETWEEN
LANE LINES	4 (100) 5 (125) ON FREEWAYS	SKIP-DASH SKIP-DASH	WHITE WHITE	10' (3 m) LINE WITH 30' (9 m) SPACE
DOTTED LINES (EXTENSIONS OF CENTER, LANE OR TURN LANE MARKINGS)	SAME AS LINE BEING EXTENDED	SKIP-DASH	SAME AS LINE BEING EXTENDED	2' (600) LINE WITH 6' (1.8 m) SPACE
EDGE LINES	4 (100)	SOLID	YELLOW-LEFT WHITE-RIGHT	OUTLINE MEDIANS IN YELLOW
TURN LANE MARKINGS	6 (150) LINE; FULL SIZE LETTERS & SYMBOLS (8' (2.4m))	SOLID	WHITE	SEE TYPICAL TURN LANE MARKING DETAIL
TWO WAY LEFT TURN MARKING	2 @ 4 (100) EACH DIRECTION 8' (2.4m) LEFT ARROW	SKIP-DASH AND SOLID IN PAIRS	YELLOW	10' (3 m) LINE WITH 30' (9 m) SPACE FOR SKIP-DASH; 5½ (140) C-C BETWEEN SOLID LINE AND SKIP-DASH LINE SEE TYPICAL TWO-WAY LEFT TURN MARKING DETAIL
CROSSWALK LINES (PEDESTRIAN) A. DIAGONALS (BIKE & EQUESTRIAN) B. LONGITUDINAL BARS (SCHOOL)	2 @ 6 (150) 12 (300) @ 45° 12 (300) @ 90°	SOLID SOLID SOLID	WHITE WHITE WHITE	NOT LESS THAN 6' (1.8 m) APART 2' (600) APART 2' (500) APART 5EE TYPICAL CROSSWALK MARKING DETAILS.
STOP LINES	24 (600)	SOLID	WHITE	PLACE 4' (1.2 m) IN ADVANCE OF AND PARALLEL TO CROSSWALK, IF PRESENT. OTHERWISE, PLACE AT DESIRED STOPPING POINT. PARALLEL TO CROSSROAD CENTERLINE, WHERE POSSIBLE
PAINTED MEDIANS	2 @ 4 (100) WITH 12 (300) DIAGONALS @ 45° NO DIAGONALS USED FOR 4' (1.2 m) WIDE MEDIANS	SOLID	YELLOW: TWO WAY TRAFFIC WHITE: ONE WAY TRAFFIC	11 (280) C-C FOR THE DOUBLE LINE SEE TYPICAL PAINTED MEDIAN MARKING.
GORE MARKING AND CHANNELIZING LINES	8 (200) WITH 12 (300) DIAGONALS @ 45°	SOLID	WHITE	DIAGONALS: 15' (4.5 m) C-C (LESS THAN 30MPH (50 km/h)) 20' (6 m) C-C 30MPH (50 km/h) TO 45MPH (70 km/h)) 30' (9 m) C-C (OVER 45MPH (70 km/h))
RAILROAD CROSSING	24 (600) TRANSVERSE LINES; "RR" IS 6' (1.8 m) LETTERS; 16 (400) LINE FOR "X"	SOLID	WHITE	SEE STATE STANDARD 780001 AREA OF: "R"=3.6 SQ. FT. (0.33 m ZEACH "X"=54.0 SQ. FT. (5.0 m Z
SHOULDER DIAGONALS (REQUIRED FOR SHOULDERS > 8')	12 (300) @ 45°	SOLID	WHITE - RIGHT YELLOW - LEFT	50' (15 m) C-C (LESS THAN 30MPH (50 km/h)) 75' (25 m) C-C (30 MPH (50 km/h) TO 45MPH (70 km/h)) 150' (45 m) C-C (OVER 45MPH (70 km/h))
U TURN ARROW	SEE DETAIL	SOLID	WHITE	16.3 SF
2 ARROW COMBINATION LEFT AND U TURN	SEE DETAIL	SOLID	WHITE	30.4 SF

FOR FURTHER DETAILS ON PAVEMENT MARKING REFER TO STANDARD SPECIFICATIONS FOR ROAD AND BRIDGE CONSTRUCTION AND STATE STANDARD 780001.

SCALE: NONE

8 (200) WHITE -

RAISED

All dimensions are in inches (millimeters) unless otherwise shown.

FILE NAME: V:\DUPAGECO\140901.00 87th St & Woodward Ave Design\CADD\A-FINAL July 2021\140901 Dist 1 Details.dwg

USER NAME = footemj	DESIGNED	-	EVERS	REVISED	-	C. JUCIUS 09-09-09
	DRAWN	-		REVISED	-	C. JUCIUS 07-01-13
PLOT SCALE = 50.0000 ' / in.	CHECKED	-		REVISED	-	C. JUCIUS 12-21-15
PLOT DATE = 04/25/2019	DATE	-	03-19-90	REVISED	-	C. JUCIUS 04-12-10

STATE OF ILLINOIS **DEPARTMENT OF TRANSPORTATION**

			DIST	RICT O	VE		F.A.U RTE.	SECTION		COUNTY	TOTAL SHEETS	SHEET NO.
TYPICAL PAVEMENT MARKINGS							3580	13-00253-01-CH	1	DuPage	177	142
TITICAL PAVEINIENT INIANNINGS								TC-13		CONTRACT NO. 61E87		
SHEET	1	OF	2	SHEETS	STA.	TO STA.		ILLINOIS	FED. Al	D PROJECT		

TURN BAY ENTRANCE AT START OF LANE CLOSURE TAPER


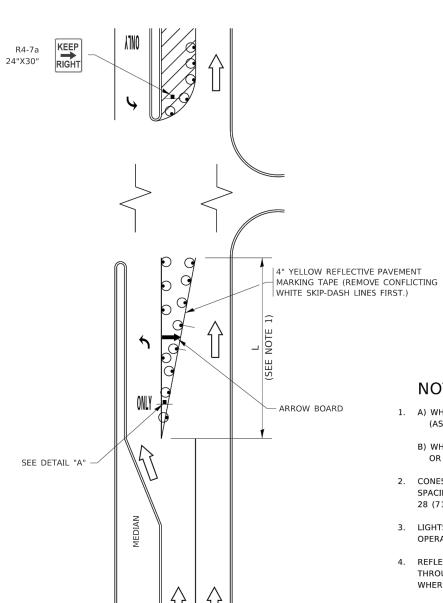



FIGURE 1

WITHIN A LANE CLOSURE

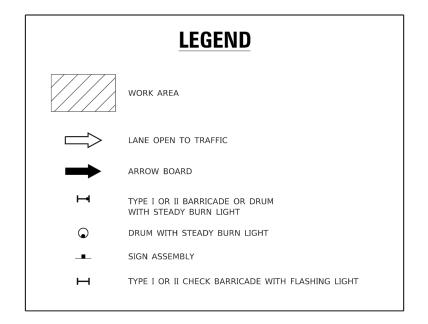


NOTES:

- 1. A) WHEN "L" IS ≤ THE STORAGE LENGTH OF THE TURN LANE (AS SHOWN IN FIG. 1), USE FIGURE 1.
 - B) WHEN "L" IS > THE STORAGE LENGTH OF THE TURN LANE OR THE TURN LANE IS WITHIN THE LANE CLOSURE, USE FIGURE 2.
- 2. CONES MAY BE SUBSTITUTED FOR BARRICADES OR DRUMS AT HALF THE SPACING DURING DAY OPERATIONS. CONES SHALL BE A MINIMUM OF 28 (710) IN HEIGHT.
- 3. LIGHTS WILL NOT BE REQUIRED ON BARRICADES OR DRUMS FOR DAY OPERATIONS. ALL LIGHTS SHALL BE MONODIRECTIONAL.
- 4. REFLECTIVE TEMPORARY PAVEMENT MARKINGS SHALL BE PLACED THROUGHOUT THE BARRICADED AREAS OF EACH TURN BAY AS SHOWN WHERE THE CLOSURE TIME IS GREATER THAN FOURTEEN (14) DAYS.
- 5. THIS APPLICATION ALSO APPLIES WHEN WORK IS BEING PERFORMED IN THE RIGHT LANE(S) AND THE RIGHT TURN BAY IS TO REMAIN OPEN. UNDER THIS CONDITION, "RIGHT TURN LANE" R3-I100R 24 x 24 (600 x 600) AND M6-2R 21 x 15 (530 x 380) SHALL BE USED.
- THESE CONTROLS SHALL SUPPLEMENT MAINLINE TRAFFIC CONTROL FOR LANE CLOSURES.
- 7. THE SIGNS SHALL BE MOUNTED ABOVE THE BARRICADES/DRUMS ON SEPARATE SIGN SUPPORTS THAT MEET NCHRP 350 OR MASH PREOUIREMENTS.
- 8. TRAFFIC CONTROL AND PROTECTION AT TURN BAYS (TO REMAIN OPEN TO TRAFFIC) SHALL BE INCLUDED IN THE COST OF SPECIFIED TRAFFIC CONTROL STANDARDS OR ITEMS.

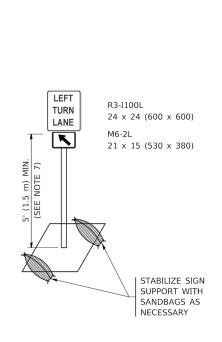

TURN BAY ENTRANCE

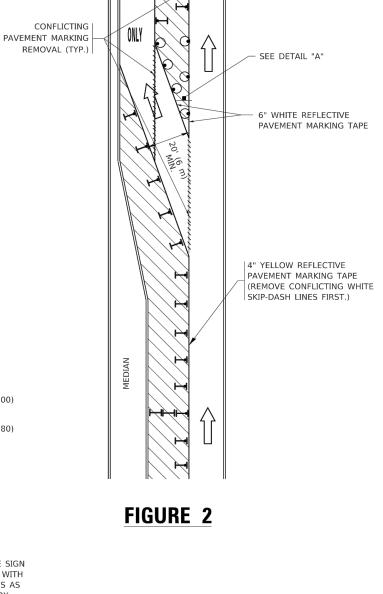

DETAIL A

All dimensions are in inches (millimeters) unless otherwise shown


FILE NAME: V:\DUPAGECO\140901.00 87th St & Woodward Ave Design\CADD\A-FINAL July 2021\140901 Dist 1 Details.dwg

DESIGNED -T. RAMMACHER 09-08-94 REVISED - R. BORO 09-14-09 USER NAME = footemj - A. HOUSEH 11-07-95 REVISED - A. SCHUETZE 07-01-13 A. HOUSEH 10-12-96 REVISED - A. SCHUETZE 09-15-16 PLOT DATE = 344/251/2019 - T. RAMMACHER 01-06-00 REVISED

STATE OF ILLINOIS **DEPARTMENT OF TRANSPORTATION**


SECTION TRAFFIC CONTROL AND PROTECTION AT TURN BAYS 3580 (TO REMAIN OPEN TO TRAFFIC) TC-14 SCALE: NONE SHEET 1 OF 1 SHEETS STA.

COUNTY 13-00253-01-CH DuPage 177 143 CONTRACT NO. 61E87

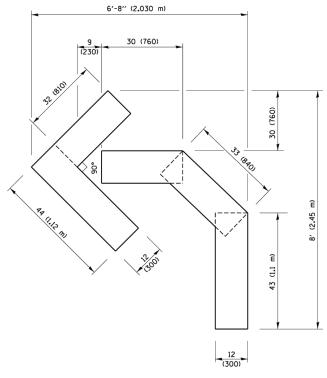


QUANTITY

4 (100) LINE = 45.5 ft. (13.9 m) 15.2 sq. ft. (1.41 sq. m)

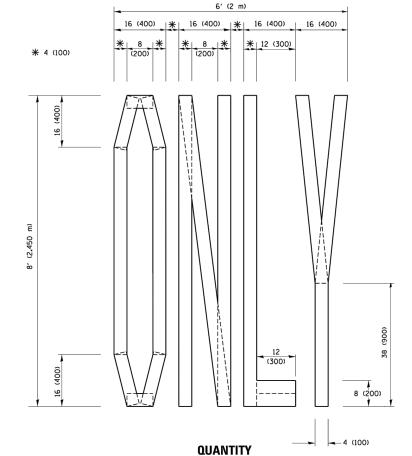

4 (100) LINE = 64.1 ft. (19.5 m) 21.4 sq. ft. (1.99 sq. m)

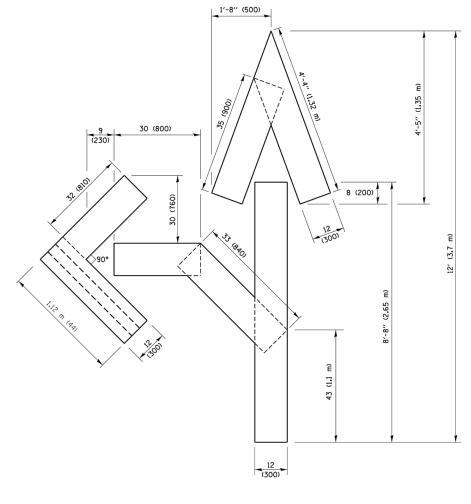


QUANTITY

4 (100) LINE = 82.5 ft. (25.1 m) 27.5 sq. ft. (2.53 sq. m)

NOTE:

ALL QUANTITIES OF PLACEMENT ARE REPRESENTED IN LINEAR FEET OF 4" LINES TO MATCH THE 4" TEMPORARY TAPE PAY ITEM AND REPRESENTS THE TOTAL QUANTITY OF 4" TAPE REQUIRED.

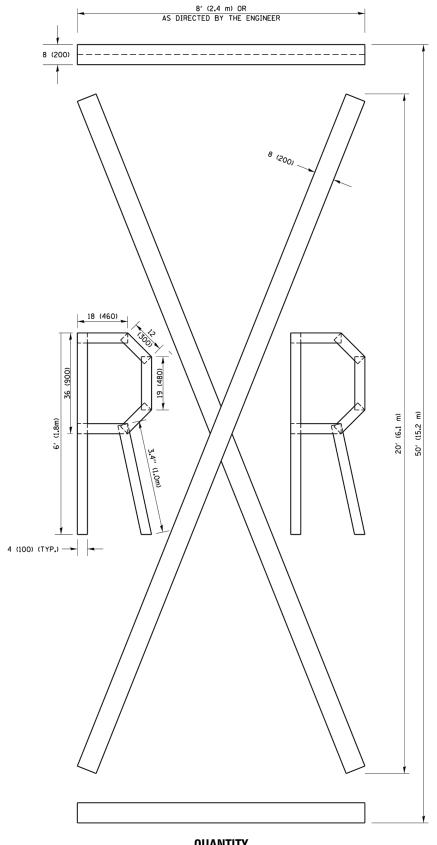

QUANTITY


4 (100) LINE = 225.9 ft. (68.9 m) 75.3 sq. ft. (6.99 sq. m)

> All dimensions are in inches (millimeters) unless otherwise shown.

FILE NAME: V: \DUPAGECO\140901.00 87th
St & Woodward Ave Design\CADD\A-FINAL
Uuly 2021\140901 Dist 1 Details.dwg USER NAME = footemj DESIGNED -REVISED -T. RAMMACHER 03-02-98 ents\IDOT Offices\District 1\Projects\Dis tDRAWN\CADData\CADsheets\tc16.dgn REVISED - E. GOMEZ 08-28-00 CHECKED REVISED -E. GOMEZ 08-28-00 PLOT DATE = 04/25/2019 DATE REVISED - A. SCHUETZE 09-15-16 09-18-94

STATE OF ILLINOIS **DEPARTMENT OF TRANSPORTATION**

						F	RTE.	SECTION	COUNTY	TOTAL SHEETS	SHEET NO.
ı	SHORT TERM PAVEMENT MARKING LETTERS AND SYMBOLS			3580	13-00253-01-CH	DuPage	177	144			
ı							TC-16	CONTRACT	NO. 6	61E87	
ı	SCALE: NONE	SHEET NO. 1 OF 1	SHEETS	STA.	TO STA.		FED. ROAD DIST. NO. 1 ILLINOIS FED. AID PROJECT				

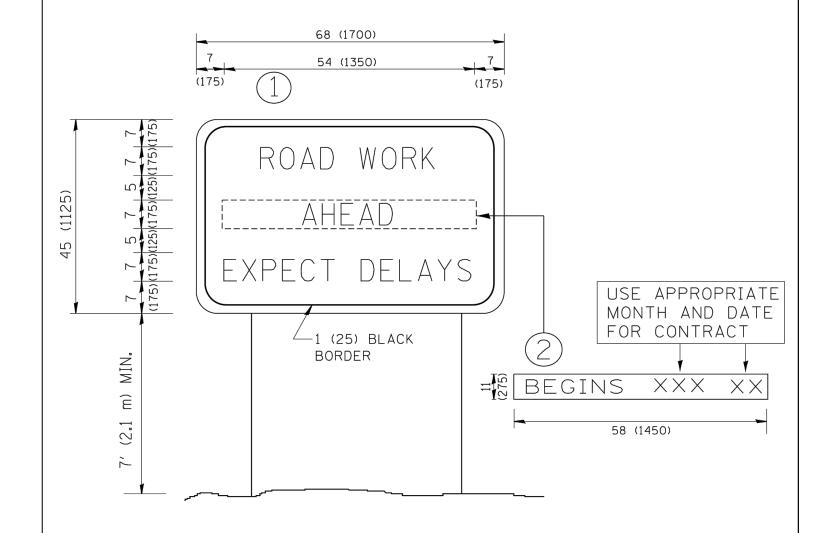

NOTES:


- 1. USE BLACK LETTERING ON ORANGE BACKGROUND.
- 2. ERECT SIGNS IN ADVANCE OF THE LOCATION FOR THE "ROAD CONSTRUCTION AHEAD" SIGN AT LOCATIONS AS DIRECTED BY THE ENGINEER.
- 3. ERECT SIGN (1) WITH INSTALLED PANEL (2) ONE WEEK PRIOR TO THE START OF CONSTRUCTION.
- 4. REMOVE PANEL 2 SOON AFTER THE START OF CONSTRUCTION.
- 5. SEE SPECIAL PROVISION FOR "TEMPORARY INFORMATION SIGNING" FOR ADDITIONAL INFORMATION.
- 6. ONE SIGN ASSEMBLY EQUALS 25.70 SQ. FT. (2.3 SQ. M.)
- 7. SHALL BE PAID FOR AS TEMPORARY INFORMATION SIGNING.

ALL DIMENSIONS ARE IN INCHES (MILLIMETERS) UNLESS OTHERWISE SHOWN.

	USER NAME = gaglianobt	DESIGNED -	REVISED	- R. MIRS 09-15-97
St & Woodward Ave Design\CADD\A-FINAL July 2021\140901 Dist 1 Details.dwg		DRAWN -	REVISED	- R. MIRS 12-11-97
	PLOT SCALE = 50.000 '/ IN.	CHECKED -	REVISED	-T. RAMMACHER 02-02-99
	PLOT DATE = 04/25/2019	DATE -	REVISED	- C. JUCIUS 01-31-07

STATE	OF	: ILLINOIS
DEPARTMENT	0F	TRANSPORTATION

ARTERIAL ROAD					SECTION	COUNTY	TOTAL	SHEET NO.
	INFORMATION SIGN					DuPage	177	145
	INFORMATION		TC-22	CONTRACT	NO.	61E87		
SCALE: NONE	SHEET NO. 1 OF 1 SHEETS	STA.	TO STA.	FED. ROAD DIST. NO. 1 ILLINOIS FED. AID PROJECT				

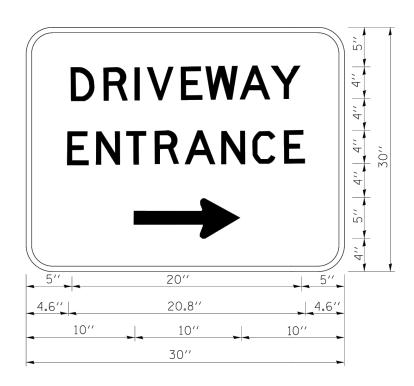

3.0" RADIUS, 0.5" BORDER, WHITE ON GREEN; REFLECTORIZED "DRIVEWAY" D; "ENTRANCE" D; STANDARD ARROW CUSTOM 12.0" x 5.0"

NOTES:

- 1. HALF OF THE SIGNS WILL REQUIRE A LEFT HAND FACING ARROW.
- 2. TWO SIGNS SHALL BE USED AT EACH COMMERCIAL ENTRANCE PLACED BACK-TO-BACK: ONE WITH A RIGHT HAND ARROW (SHOWN) SHALL BE PLACED ON THE NEAR RIGHT SIDE THE DRIVEWAY AND ONE WITH A LEFT HAND ARROW SHALL BE PLACED ON THE FAR LEFT SIDE OF THE DRIVEWAY.
- 3. SIGNS TO BE PAID FOR AS ITEM "TEMPORARY INFORMATION SIGNING".

St & Woodward Ave Design\CADD\A-FINAL	
July 2021\140901 Dist 1 Details.dwg	

	USER NAME = gaglianobt	DESIGNED -	REVISED - C. JUCIUS 02-15-07
С	26.dgn	DRAWN -	REVISED -
	PLOT SCALE = 50.000 '/ in.	CHECKED -	REVISED -
	PLOT DATE = 04/25/2019	DATE -	REVISED -

STATE OF ILLINOIS	
DEPARTMENT OF TRANSPORTATION	N

SCALE: NONE

DRIVEWAY ENTRANCE SIGNING				F.A.U. RTE.	SECTION	COUNTY	TOTAL SHEETS	SHEET NO.	
					3580	13-00253-01-CH	DuPage	177	146
						TC-26	CONTRACT	NO. 6	61E87
	SHEET NO. 1 OF 1	SHEETS	STA.	TO STA.	FED. RO	DAD DIST. NO. 1 ILLINOIS FED. A	D PROJECT		

