STATE OF ILLINOIS DEPARTMENT OF TRANSPORTATION

VOLUME I

+3 = 1,022SECTION COUNTY TOTAL SHEETS 7448 09-00933-01-BR MACON 1019 1 ILLINOIS CONTRACT NO. 95893

BRUSH COLLEGE ROAD (FAU 7448) FARIES PARKWAY (FAU 7369) (WEST LEG) FARIES PARKWAY (FAU 7369) (EAST LEG) JUG HANDLE CONNECTOR ROAD

KIRSTEN

MAWHINNEY

062-062611

21,000 (2035) MINOR ARTERIAL 12,000 (2035) MINOR ARTERIAL 15,000 (2035) COLLECTOR 18.000 (2035) COLLECTOR

POSTED /DESIGN SPEEDS:

35 /40 MPH 35 /40 MPH 35 /40 MPH 30 /30 MPH


PLANS FOR PROPOSED LOCAL AGENCY IMPROVEMENT

FAU ROUTE 7448 (BRUSH COLLEGE ROAD) OVER FARIES PARKWAY GRADE SEPARATION SECTION 09-00933-01-BR PROJECT 3ELT(222) BRIDGE STRUCTURE, RETAINING WALLS, ROADWAY RECONSTRUCTION. LIGHTING, AND TRAFFIC SIGNALS

RICHARD K. ALLENDER III, P.E. DATE LICENSE EXPIRES 2 /28 /2022 SHEET RANGE: 308–378

MACON COUNTY BRUSH COLLEGE RD PROJECT LIMIT C-97-106-21 END STA 75 + 44.21

> **RETAINING WALL SN 058-W004** STA 62+39.94 TO STA 69+25.33

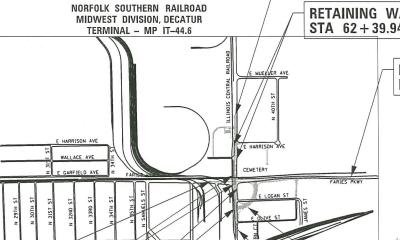

FARIES PKWY PROJECT LIMIT END STA 235 + 41.47

LOCATION OF SECTION INDICATED THUS: - -

AECOM


Kaskaskia Engineering Group. LLC

STA 303 + 46.11

RETAINING WALL SN 058-W006 STA 300 + 31.00 TO

RETAINING WALL SN 058-W007 STA 46 + 86.59 TO STA 51 + 75.56

10 /29 /2021

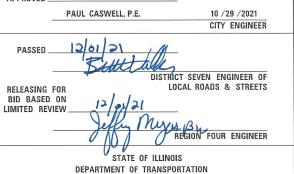

CORY W. CHAMBERLAIN CORY W. CHAMBERLAIN, P.E. 062-055298 LICENSE EXPIRES 2 /28 /2022 SHEET RANGE: 50-52, 54, 93-96, 99, 113-116, 119, 133-140, 142, 158, 176, 178, 399-512, 931-986, 1010-1019

KIRSTEN MAWHINNEY, P.E.

LICENSE EXPIRES 2 /28 /2022 SHEET RANGE: 1–49, 53, 55–92, 97–98, 100–112,

117-118, 120-132, 141, 143-157,

159-175, 177, 179-302, 379-398

568, 742-930, 987-1009

Delovie DEMIR DEBEZIC, S.E. LICENSE EXPIRES 11 /30 /2022 SHEET RANGE: 665-705 081-00774

SCOTT D. SANFORD, S.E.

KEITH W. BENTING, S.E.

LANCE D. CHRISMAN, P.E.

LICENSE EXPIRES 2 /28 /2022

SHEET RANGE: 544-567, 721-730

LICENSE EXPIRES 11/30/2022 SHEET RANGE: 595–664

LICENSE EXPIRES <u>11 /30 /2022</u> SHEET RANGE: 569–594

SEE SHEET 569 FOR SIGNATURE

DATE

10 /22 /2021 DATE RICHARD K. ALLENDER III 062-054436

062-055763

MATTHEW J. LETOURNEAU, P.E. DATE LICENSE EXPIRES 2 /28 /2022 SHEET RANGE: 303-307, 706-720



WILLIAM D. STERMER, P.E. LICENSE EXPIRES 2 /28 /2022 SHEET RANGE: 731-741

10 /22 /2021 PAUL ST. AUBYN 062-064634

DATE PAUL ST. AUBYN, P.E. LICENSE EXPIRES 2 /28 /2022 SHEET RANGE: 513-543

FULL SIZE PLANS HAVE BEEN PREPARED USING STANDARD ENGINEERING SCALES, REDUCED SIZED PLANS WILL NOT CONFORM TO STANDARD SCALES. IN MAKING MEASUREMENTS ON REDUCED PLANS, THE ABOVE SCALES MAY BE USED.

JOINT UTILITY LOCATION INFORMATION FOR EXCAVATION 1-800-892-0123 OR 811

CONTRACT NO. 95893

FARIES PKWY PROJECT LIMIT BEGIN STA 205 + 18.73

BRUSH COLLEGE STRUCTURE LIMIT STA 60+10.96 TO STA 62+76.19 SN 058-9202

RETAINING WALL SN 058-W003 STA 52+00.00 TO STA 59+50.20

BRUSH COLLEGE RD PROJECT LIMIT BEGIN STA 46 + 59.43

GROSS LENGTH = 5.855.36 FT (1.11 MILES) NET LENGTH = 5.855,36 FT (1.11 MILES)

LOCATION MAP NOT TO SCALE

4777

LANCED

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HIGHWAY STANDARDS (CONT)

"	AECOM
	345 EAST ASH AVENUE DECATUR, IL 62526 PHONE: (217) 775-6065

INDEX OF SHEETS - VOLUME I

USER NAME = mawhinneyk	DESIGNED -	EU	REVISED -
	DRAWN -	EU	REVISED -
PLOT SCALE = 2.0000 ' / in.	CHECKED -	WBS	REVISED -
PLOT DATE = 10/29/2021	DATE -	10/22/2021	REVISED -

STATE OF ILLINOIS **DEPARTMENT OF TRANSPORTATION**

SCALE: N/A

BRUSH COLLEGE ROAD	F.A.U. RTE.	SECTION	COUNTY	TOTAL SHEETS	SHEET NO.
INDEX OF SHEETS AND HIGHWAY STANDARDS	NDADDC 7448 09-00933-01-BR				2
INDEX OF SHEETS AND HIGHWAY STANDANDS			CONTRA	ACT NO.	95893
SHEET 1 OF 1 SHEETS STA. TO STA.		ILLINOIS FED. A	D PROJECT		

IDOT DISTRICT 7 STANDARDS

TITLE OR DESCRIPTION

PRISMATIC CURB REFLECTOR

SURVEY MARKER VALUET

PAVEMENT MARKING AND RAISED REFLECTIVE PAVEMENT MARKERS (RURAL AND URBAN APPLICATIONS)

GENERAL NOTES:

- 1. ALL CONSTRUCTION SHALL BE DONE ACCORDING TO THE STATE OF ILLINOIS "STANDARD SPECIFICATIONS FOR ROAD AND BRIDGE CONSTRUCTION" ADOPTED APRIL 1, 2016; THE LATEST EDITION OF THE "MANUAL ON UNIFORM TRAFFIC CONTROL DEVICES FOR STREETS AND HIGHWAYS" THE "SUPPLEMENTAL SPECIFICATIONS AND RECURRING SPECIAL PROVISIONS" ADOPTED JANUARY 1, 2021; "STANDARD SPECIFICATIONS FOR TRAFFIC CONTROL ITEMS" THE DETAILS IN THESE PLANS AND THE SPECIAL PROVISIONS INCLUDED IN THE CONTRACT DOCUMENTS; INCLUDING ALL AMENDMENTS AND SUCCESSOR DOCUMENTS TO THE AFOREMENTIONED DOCUMENTS AS PUBLISHED BY THE ILLINOIS DEPARTMENT OF TRANSPORTATION (IDOT), UNLESS OTHERWISE STATED IN THE CONTRACT DOCUMENTS.
- 2. ANY REFERENCE TO "STANDARDS" THROUGHOUT THE PLANS OR SPECIAL PROVISIONS SHALL BE INTERPRETED AS THE CURRENT IDOT STANDARD REVISION AND SHALL TAKE PRECEDENCE OVER EARLIER REVISIONS THAT MAY BE REFERRED TO ELSEWHERE IN THE PLANS OR SPECIAL PROVISIONS. SHOULD A REVISED STANDARD EXIST THAT SUPERSEDES STANDARDS REFERENCED IN THE CONTRACT DOCUMENTS, THE CONTRACTOR SHALL SEEK CLARIFICATION FROM THE ENGINEER PRIOR TO ORDERING MATERIALS, SCHEDULING PERSONNEL, AND PERFORMING THE WORK OR ANY OTHER ACTIVITY RELATED TO THE WORK. THE CONTRACTOR SHALL IDENTIFY THE CORRECT STANDARD BEFORE PERFORMING WORK.
- 3. ALL ELEVATIONS SHOWN ARE BASED ON NAVD 88.
- 4. ALL BEARINGS AND COORDINATES REFERENCED IN THE PLAN DRAWINGS AND ALL CONTROL COORDINATES ARE BASED ON THE ILLINOIS STATE PLANE COORDINATE SYSTEM, EAST ZONE, NAD 93 (2007)
- ALL RELEVANT SCHOOL DISTRICTS, LOCAL POLICE, LOCAL HOSPITALS AND LOCAL FIRE DEPARTMENTS SHALL BE NOTIFIED BY THE CONTRACTOR PRIOR TO THE START OF CONSTRUCTION.
- 6. THE CONTRACTOR'S SUPERINTENDENT OR AUTHORIZED AGENT, AS DEFINED IN ARTICLE 105.06 OF THE STANDARD SPECIFICATIONS, MUST BE AVAILABLE IN CASE OF EMERGENCIES ON A TWENTY-FOUR (24) HOUR BASIS. THE CONTRACTOR SHALL CONTACT THE CITY OF DECATUR OFFICE OF PUBLIC WORKS A MINIMUM OF SEVENTY-TWO (72) HOURS IN ADVANCE OF BEGINNING WORK
- 7. ALL WORK TO BE PERFORMED ON, OVER, UNDER, OR ADJACENT TO THE RAILROAD RIGHT-OF-WAY SHALL COMPLY WITH THE NORFOLK SOUTHERN RAILWAY COMPANY ("RAILROAD", "NSR" OR "NS") PUBLIC PROJECTS MANUAL (APPENDIX E, SPECIAL PROVISIONS FOR THE PROTECTION OF RAILWAY INTERESTS, AND APPENDIX H1, OVERHEAD GRADE SEPARATION DESIGN CRITERIA). WHEN IN CONFLICT WITH OTHER PROJECT SPECIFICATIONS, THE MOST STRINGENT SHALL APPLY.
- 8. FOR PROJECTS REQUIRING MORE THAN 30 CONSECUTIVE DAYS OF FLAGGING, CONTRACTOR SHALL PROVIDE THE FLAGMAN A SMALL WORK AREA WITH A DESK/COUNTER AND CHAIR WITHIN THE FIELD/SITE TRAILER, INCLUDING THE USE OF BATHROOM FACILITIES, WHERE THE FLAGMAN CAN CHECK IN/OUT WITH THE PROJECT, AS WELL AS TO THE FLAGMAN'S HOME TERMINAL. THE WORK AREA SHALL PROVIDE ACCESS TO TWO (2) ELECTRICAL OUTLETS FOR RECHARGING RADIO(S), AND A LAPTOP COMPUTER; AND HAVE THE ABILITY TO PRINT OFF NEEDED DOCUMENTATION AND ORDERS AS NEEDED AT THE FIELD/SITE TRAILER. THIS SHOULD AID IN MAXIMIZING THE FLAGMAN'S TIME AND EFFICIENCY ON THE PROJECT.
- THE CONTRACTOR SHALL TAKE ALL NECESSARY SAFETY PRECAUTIONS TO PROTECT AND PROVIDE ACCESS TO ABUTTING PROPERTIES AND UTILITIES.
- 10. THE ADJUSTMENT OF EXISTING FACILITIES OWNED BY PRIVATE UTILITIES WITHIN THE LIMITS OF THE IMPROVEMENTS SHALL BE DONE BY THEIR RESPECTIVE OWNERS AND ARE NOT PART OF THIS
- 11. THE CONTRACTOR WILL NOT BE ALLOWED TO SET UP A YARD OR FIELD OFFICE ON PUBLIC OR PRIVATE PROPERTY WITHOUT WRITTEN PERMISSION OF THE ENGINEER AND THE PROPERTY OWNER INVOLVED.
- 12. DURING CONSTRUCTION OPERATIONS, WHENEVER LOOSE MATERIAL IS DEPOSITED IN THE FLOW LINE OF GUTTERS, DRAINAGE STRUCTURES, DITCHES, ETC., SUCH THAT THE NATURAL FLOW LINE OF WATER IS OBSTRUCTED, THE LOOSE MATERIAL SHALL BE REMOVED AT THE CLOSE OF EACH WORKING DAY. AT THE CONCLUSION OF THE CONSTRUCTION OPERATIONS, ALL DRAINAGE STRUCTURES AND FLOW LINES SHALL BE FREE FROM DIRT AND DEBRIS.
- 13. ALL ROADWAY WIDTHS AND RADII SHOWN ON THE PLANS ARE TO THE EDGE OF PAVEMENT UNLESS OTHERWISE NOTED.
- 14. ALL REINFORCEMENT BARS, DOWEL BARS, AND TIE BARS SHOULD BE EPOXY COATED UNLESS OTHERWISE NOTED IN THE PLANS.
- 15. ALL STATION-OFFSET CALL OUTS AND CURVE DATA ON THE PLANS REFER TO THE PROPOSED CENTERLINE/BASELINE UNLESS OTHERWISE SHOWN.
- 16. IT SHALL BE THE CONTRACTOR'S RESPONSIBILITY TO VERIFY ALL DIMENSIONS, GRADES, ELEVATIONS, AND CONDITIONS EXISTING IN THE FIELD PRIOR TO ORDERING MATERIAL AND BEGINNING CONSTRUCTION. IF THE CONTRACTOR DOES NOT CONCUR WITH THE ELEVATION PROVIDED ON THE DRAWINGS, THE CONTRACTOR MUST NOTIFY THE ENGINEER IN WRITING PRIOR TO CONSTRUCTION. NO CONSTRUCTION WILL BE ALLOWED TO BEGIN UNTIL THESE CONFLICTS ARE RESOLVED. EXISTING CONDITIONS WERE TAKEN FROM THE BEST AVAILABLE INFORMATION. INFORMATION SHOWN CONCERNING FEATURES AND UTILITIES IS NOT GUARANTEED ALL INCLUSIVE OR CORRECT. THE CONTRACTOR IS TO VERIFY THE FEATURES PRIOR TO CONSTRUCTION.
- 17. NO WORK SHALL COMMENCE UNTIL TRAFFIC CONTROL REQUIREMENTS ARE MET.
- 18. ANY WORK ON HOLIDAYS OR WEEKENDS WILL NEED PRIOR APPROVAL FROM THE ENGINEER.
- 19. THE CONTRACTOR SHALL BE REQUIRED TO DISPOSE OF ALL SIDEWALK, CURB AND GUTTER PAVEMENT, AND ALL OTHER MATERIALS EXCAVATED OR REMOVED DUE TO CONSTRUCTION OPERATIONS.
- 20. THE CONTRACTOR IS REQUIRED TO REPAIR AND RESTORE ANY EXISTING ROADWAY ELEMENTS TO REMAIN IN PLACE THAT ARE DAMAGED BY CONSTRUCTION OPERATIONS DURING CONSTRUCTION. ANY DAMAGE SHALL BE REPAIRED AT THE CONTRACTOR'S OWN EXPENSE.

GENERAL NOTES (CONT.):

- 21. APPROVAL FOR STOCKPILE LOCATIONS MUST BE OBTAINED FROM THE ENGINEER PRIOR TO PLACEMENT.
- 22. THE CONTRACTOR SHALL MAINTAIN ACCESS TO ABUTTING PROPERTIES AND EXISTING UTILITY ACCESS EASEMENTS DURING THE CONSTRUCTION OF THIS PROJECT, EXCEPT FOR PERIODS OF SHORT DURATION AS APPROVED BY THE ENGINEER. SHOULD CLOSURE OF ACCESS BE REQUIRED, THE CONTRACTOR SHALL NOTIFY THE PROPERTY OWNER 24 HOURS IN ADVANCE OF THE SHORT DURATION CLOSURE.
- 23. ALL EMBANKMENTS, SUB-GRADE, BASE COURSE, AND BINDER MATERIAL SHALL BE PLACED AND COMPACTED TO THE SATISFACTION OF THE ENGINEER PRIOR TO PLACING ADDITIONAL AGGREGATE SUBGRADE OR PAVING MATERIAL
- 24. THE CONTRACTOR SHALL NOT CROSS OR DAMAGE COMPLETED BASE COURSE OR EXISTING PAVEMENT, NOT SCHEDULED TO BE REMOVED, WITH TRACK EQUIPMENT, LOADED SCRAPERS, OR OTHER HEAVY EQUIPMENT.
- 25. AN ESTIMATED QUANTITY WITH A THICKNESS OF 12 INCHES WAS ASSUMED FOR AGGREGATE SUBGRADE IMPROVEMENT (CU YD) FOR USE AT THE LOCATIONS WHERE THERE MAY BE UNSTABLE AND/OR UNSUITABLE SOIL. THE ACTUAL NEED FOR REMOVAL AND REPLACEMENT WITH AGGREGATE SUBGRADE IMPROVEMENT (CU YD) SHALL BE DETERMINED IN THE FIELD AT THE TIME OF CONSTRUCTION BY THE CONTRACTOR'S GEOTECHNICAL ENGINEER. ALL POTENTIALLY UNSTABLE SOILS SHOULD BE TESTED WITH A STATIC CONE PENETROMETER AND TREATED IN ACCORDANCE WITH ARTICLE 301.04 OF THE STANDARD SPECIFICATIONS AND THE UNDERCUT GUIDELINES IN THE IDOT SUBGRADE STABILITY MANUAL. IF UNSTABLE AND/OR UNSUITABLE SOIL IS NOT ENCOUNTERED, THEN THE QUANTITY SHALL BE DEDUCTED AND NO ADDITIONAL COMPENSATION WILL BE DUE TO THE CONTRACTOR.
- 26. THE CONTRACTOR WILL BE REQUIRED TO TAKE SPECIAL PRECAUTION AND CARE IN CONNECTION WITH EXCAVATING AND SHORING PITS, IN INSTALLING TEMPORARY SOIL RETENTION SYSTEMS, AND IN DRIVING PILES OR SHEETING FOR FOOTINGS ADJACENT TO TRACKS TO PROVIDE ADEQUATE LATERAL SUPPORT FOR THE TRACKS AND THE LOADS WHICH THEY CARRY, WITHOUT DISTURBANCE OF TRACK ALIGNMENT AND SURFACE, AND TO AVOID OBSTRUCTING TRACK CLEARANCES WITH WORKING EQUIPMENT, TOOLS OR OTHER MATERIAL. ALL PLANS AND CALCULATIONS FOR SHORING SHALL BE PREPARED AND SIGNED BY A LICENSED STRUCTURAL ENGINEER. THE ENGINEER WILL BE RESPONSIBLE FOR THE ACCURACY FOR ALL CONTROLLING DIMENSIONS AS WELL AS THE SELECTION OF SOIL DESIGN VALUES WHICH WILL ACCURATELY REFLECT THE ACTUAL FIELD CONDITIONS. THE PROCEDURE FOR DOING SUCH WORK, INCLUDING NEED OF AND PLANS AND CALCULATIONS FOR SHORING, SHALL FIRST BE APPROVED BY THE ENGINEER AND THE RAILROAD ENGINEER, BUT SUCH APPROVAL SHALL NOT RELIEVE THE CONTRACTOR FROM LIABILITY.
- 27. THE CONTRACTOR WILL BE REQUIRED TO MAINTAIN ALL DITCHES AND DRAINAGE STRUCTURES FREE OF SILT OR OTHER OBSTRUCTIONS WHICH MAY RESULT FROM HIS OPERATIONS AND PROVIDE AND MAINTAIN ANY EROSION CONTROL MEASURES AS REQUIRED. THE CONTRACTOR WILL PROMPTLY REPAIR ERODED AREAS WITHIN RAILROAD RIGHTS-OF-WAY AND REPAIR ANY OTHER DAMAGE TO THE PROPERTY OF THE RAILROAD OR ITS TENANTS.
- 28. THE ENGINEER HAS PERFORMED ADVANCE COORDINATION WITH ALL KNOWN PERMITTING AGENCIES. THE CONTRACTOR SHALL BE RESPONSIBLE FOR FINAL COORDINATION DURING CONSTRUCTION, INCLUDING MEETING ALL REQUIREMENTS (INCLUDING OBTAINING FINAL PERMITS AND AGREEMENTS). PERMITTING DOCUMENTS CAN BE PROVIDED TO THE CONTRACTOR UPON WRITTEN REQUEST. COMPLIANCE WITH ALL PERMITTING REQUIREMENTS WILL NOT BE PAID FOR SEPARATELY
- 29. THE ENGINEER HAS PERFORMED ADVANCE COORDINATION WITH RAILROAD COMPANIES, INCLUDING ILLINOIS CENTRAL RAILROAD (CANADIAN NATIONAL) AND NORFOLK SOUTHERN, PRIOR TO ANY EXCAVATION, THE CONTRACTOR IS REQUIRED TO PERFORM FINAL COORDINATION DURING CONSTRUCTION, INCLUDING MEETING ALL RAILROAD REQUIREMENTS, OBTAINING FINAL PERMITS AND AGREEMENTS, AND OBTAINING FINAL RAILROAD APPROVAL. ADVANCE PERMITTING DOCUMENTS CAN BE PROVIDED TO THE CONTRACTOR UPON WRITTEN REQUEST. COMPLIANCE WITH ALL PERMITTING REQUIREMENTS WILL NOT BE PAID FOR SEPARATELY, BUT RATHER WILL BE CONSIDERED INCLUDED WITH THE COST OF THE UTILITY OR STRUCTURE BEING CONSTRUCTED UNDER OR ADJACENT TO THE EXISTING RAILROAD TRACKS, INCLUDING, BUT NOT LIMITED TO FLAGMEN, SHORING DESIGN AND CALCULATIONS, DEWATERING, GROUND MONITORING, RAIL MONITORING, VIBRATION MONITORING, INSURANCE, SIGNAGE, AND TEMPORARY LIGHTING. JACKING AND BORING OPERATIONS SHALL BE PROGRESSED ON A 24-HOUR BASIS WITHOUT STOPPAGE UNTIL THE LEADING EDGE OF THE PIPE HAS REACHED THE RECEIVING PIT. ADDITIONALLY, THE CONTRACTOR IS PERMITTED TO MAKE USE OF THE GEOTECHNICAL SOIL BORINGS AND REPORT THAT HAVE ALREADY BEEN PERFORMED BY THE ENGINEER. HOWEVER, THE CONTRACTOR IS RESPONSIBLE FOR ANY ADDITIONAL GEOTECHNICAL ANALYSIS, DESIGN, AND SOIL BORINGS THAT MAY BE REQUIRED TO MEET THE RAILROAD PERMITTING REQUIREMENTS. THIS INCLUDES POTENTIAL SETTLEMENT AND DEWATERING CALCULATIONS AND GROUNDWATER MONITORING
- 30. PAVEMENT PATCHING QUANTITIES ARE PROVIDED FOR RESTORATION OF THE PAVEMENT SURFACE WHERE REQUIRED FOR THE REMOVAL AND INSTALLATION OF EXISTING AND PROPOSED UTILITIES SUCH AS WATER MAIN, STORM SEWER, LIGHTING, ETC. THE PAVEMENT PATCHING LOCATIONS ARE TO BE USED TO RESTORE THE EXISTING PAVEMENT IN KIND (PCC OR HMA), AND LOCATIONS SHALL BE AS SHOWN IN THE SCHEDULE OF QUANTITIES AND AS APPROVED BY THE RESIDENT ENGINEER.
- 31. WORK WITHIN THE PROPERTIES OWNED BY ILLINOIS CENTRAL RAILROAD OR NORFOLK SOUTHERN REQUIRES A RIGHT-OF-ENTRY FROM EACH RESPECTIVE OWNER.
- 32. A FLAGMAN IS REQUIRED ANYTIME THE CONTRACTOR DOES ANY WORK ON OR NEAR RAILROAD PROPERTY WITHIN TWENTY-FIVE (25) FEET HORIZONTALLY OF THE CENTERLINE OR ANY WORK OVER ANY RAILROAD TRACK. THE IC AND NS, HOWEVER RESERVE THE RIGHT TO REQUIRE A FLAGMAN FOR WORK ON RAILROAD PROPERTY, WHICH IS MORE THAN TWENTY-FIVE (25) FEET FROM THE CENTERLINE OF A RAILROAD TRACK WHEN THERE ARE OTHER CONDITIONS, OR CONSIDERATIONS THAT WOULD DICTATE THE NEED FOR A FLAGMAN TO SAFEGUARD THE RAILROAD'S OPERATIONS. THE FINAL DECISION FOR THE NEED OF RAILROAD FLAGGING SHALL BE WITH THE RESPECTIVE RAILROAD AND SUBJECT TO THE APPROVAL OF THE CITY OF DECATUR.

GENERAL NOTES (CONT.):

33. FOR NORFOLK SOUTHERN RAILWAY COMPANY COORDINATION AND INQUIRIES, CONTACT INFORMATION IS AS FOLLOWS:

BRIAN TAYLOR

ENGINEER PUBLIC IMPROVEMENTS

NORFOLK SOUTHERN CORPORATION

1200 PEACHTREE STREET, NE

ATLANTA, GA 30309

(678) 333-4274 (P)

(404) 529-2589 (F)

GEORGE.TAYLOR3@NSCORP.COM

- 34. THE RAILROAD WILL BE PROVIDED AS-BUILT DRAWINGS SHOWING THE ACTUAL CLEARANCES AS CONSTRUCTED. DEPTH, SIZE, AND LOCATION OF ALL FOUNDATION COMPONENTS SHALL BE SHOWN ON THE DRAWINGS.
- 35. THE PAVEMENT MARKING REMOVAL GRINDING AND PAVEMENT MARKING REMOVAL WATERBLASTING ARE TO BE USED AT THE DISCRETION OF THE ENGINEER AND IN ACCORDANCE WITH SECTION 783 OF THE STANDARD SPECIFICATIONS.

UTILITY NOTES:

- UTILITY LOCATIONS SHOWN ON THESE PLANS MAY NOT BE CORRECT OR COMPLETE. BEFORE EXCAVATION, THE CONTRACTOR SHALL CALL "J.U.L.I.E" (JOINT UTILITY LOCATION INFORMATION FOR EXCAVATION) AT LEAST FORTY-EIGHT (48) HOURS IN ADVANCE AT 1-800-892-0123 FOR FIELD LOCATIONS OF BURIED ELECTRIC. TELEPHONE. AND GAS FACILITIES.
- 2. EXCEPT WHERE DESIGNATED OTHERWISE, THE LOCATIONS AND/OR DEPTHS OF UNDERGROUND UTILITIES SHOWN HAVE BEEN TAKEN FROM OFFICE RECORD INFORMATION FURNISHED BY THE UTILITY OWNERS. ALL UNDERGROUND UTILITIES MUST BE CONSIDERED APPROXIMATE. THE CONTRACTOR SHALL BE RESPONSIBLE FOR THE PROTECTION OF ALL UNDERGROUND OR SURFACE UTILITIES EVEN THOUGH THEY MAY NOT BE SHOWN IN THE PLANS. ANY UTILITY THAT IS DAMAGED DURING CONSTRUCTION SHALL BE REPAIRED OR REPLACED TO THE SATISFACTION OF THE ENGINEER. THIS WORK SHALL BE AT THE CONTRACTOR'S EXPENSE.
- 3. J.U.L.I.E. DOES NOT LOCATE BURIED RAILROAD SIGNAL AND COMMUNICATIONS LINES. THE CONTRACTOR SHALL CONTACT THE RAILROAD'S REPRESENTATIVE 2 DAYS IN ADVANCE OF WORK AT LOCATIONS WHERE EXCAVATION, PILE DRIVING, OR HEAVY LOADS MAY DAMAGE THE RAILROAD'S UNDERGROUND FACILITIES. UPON REQUEST FROM THE CONTRACTOR OR SPONSOR, RAILROAD FORCES WILL LOCATE AND PAINT, MARK, OR FLAG THE RAILROAD'S UNDERGROUND FACILITIES. J.U.L.I.E. DOES NOT LOCATE ARCHER DANIELS MIDLAND (ADM) UTILITIES. THE CONTRACTOR SHALL CONTACT ADM.
- 4. THE LOCATION OF EXISTING DRAINAGE STRUCTURES, STORM SEWERS, WATER MAINS, SANITARY SEWERS, AND ANY OTHER PUBLIC OR PRIVATE UTILITIES AS SHOWN ON THE PLANS IS APPROXIMATE AND THEIR EXACT LOCATION IS TO BE DETERMINED IN THE FIELD BY THE CONTRACTOR
- 5. THE CONTRACTOR SHALL COORDINATE WORK WITH PRIVATE UTILITY COMPANIES AND THEIR CONTRACTORS FOR ADJUSTMENTS, SUPPORTS, AND RELOCATION. UTILITY WORK WILL GENERALLY BE CONDUCTED PRIOR TO ROADWAY WORK, BUT CERTAIN ITEMS MAY NEED TO PROCEED IN CONCERT WITH CONSTRUCTION OPERATIONS. IT IS THE CONTRACTOR'S RESPONSIBILITY TO CONTACT AFFECTED UTILITIES AND COORDINATE WORK WITHIN THE CONSTRUCTION SCHEDULE.
- 6. UTILITY OWNERS ARE ACTIVELY ENGAGED IN RELOCATION OF UTILITIES AND FUTURE LOCATIONS ARE NOT SHOWN IN THESE PLANS. IT WILL BE THE CONTRACTORS RESPONSIBILITY TO DETERMINE CONFLICTS FOR WATCH AND PROTECT.
- THE CONTRACTOR SHALL BE RESPONSIBLE FOR CONTACTING THE OWNERS OF ALL UTILITIES PRIOR TO CONSTRUCTION TO DETERMINE THE LOCATION OF ALL UTILITY EQUIPMENT. THE CONTRACTOR SHALL COOPERATE WITH ALL UTILITY OWNERS IN ACCORDANCE WITH THE STANDARD SPECIFICATIONS IF UTILITY RELOCATION, ADJUSTMENT, OR PROTECTION IS NECESSARY.
- 8. UNLESS OTHERWISE NOTED, THE CONTRACTOR SHALL MAINTAIN IN SERVICE ALL EXISTING WATER MAINS, SEWERS, CULVERTS, DITCHES, DRAINS, MANHOLES, AND CATCH BASINS THIS INCLUDES, BUT IS NOT LIMITED TO, BYPASS PUMPING. THE LOCATION OF MATERIALS AND DIMENSIONS OF EXISTING FACILITIES AND OBSTRUCTIONS ARE BASED UPON LOCATION RECORDS AND ARE SHOWN ON THE DRAWINGS STRICTLY AS AID TO THE CONTRACTOR, BUT MUST NOT BE CONSTRUED AS BEING ACCURATE, CORRECT OR COMPLETE. ALL STRUCTURES ABOVE OR BELOW GROUND THAT ARE ENCOUNTERED DURING CONSTRUCTION ARE TO BE PROPERLY SUPPORTED AND MAINTAINED.
- 9. THE CONTRACTOR SHALL PROTECT EXISTING AND NEW UTILITIES WHEN CONSIDERED NECESSARY BY METHODS APPROVED BY THE ENGINEER AND SHALL SUPPORT THE UTILITIES PROPERLY TO PREVENT SETTLEMENT, DISPLACEMENT, OR DAMAGE TO THE UTILITIES.

USER NAME = Jacqueline.Ng	DESIGNED -	EU	REVISED -
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PLOT SCALE = 2.0000 / in.	CHECKED -	WBS	REVISED -
PLOT DATE = 10/29/2021	DATE -	10/22/2021	REVISED -

SCALE:

- 3. THE CONTRACTOR IS RESPONSIBLE FOR MAINTAINING DRAINAGE FLOW WITHOUT DISRUPTION TO THE FLOW ON THE JOB SITE FROM COMMENCEMENT TO COMPLETION OF CONSTRUCTION. METHODS USED BY THE CONTRACTOR SHALL BE SUBJECT TO THE APPROVAL OF THE ENGINEER.
- 4. WHEN EXISTING DRAINAGE FACILITIES ARE DISTURBED, THE CONTRACTOR SHALL PROVIDE AND MAINTAIN TEMPORARY OUTLETS AND CONNECTIONS FOR ALL PRIVATE OR PUBLIC DRAINS, SEWERS, INLETS OR CATCH BASINS. CONTRACTOR SHALL PROVIDE FACILITIES TO TAKE IN ALL STORM WATER WHICH WILL BE RECEIVED BY THESE DRAINS AND SEWERS AND DISCHARGE THE SAME. CONTRACTOR SHALL PROVIDE AND MAINTAIN EFFICIENT PUMPING, IF NECESSARY, AND A TEMPORARY OUTLET AND BE PREPARED AT ALL TIMES TO DISPOSE OF THE WATER FROM THESE TEMPORARY CONNECTIONS UNTIL SUCH TIME AS THE PERMANENT CONNECTIONS ARE BUILT AND IN SERVICE. THIS WORK WILL NOT BE PAID FOR DIRECTLY BUT SHALL BE INCLUDED IN THE CONTRACT.
- 5. DURING CONSTRUCTION, IF THE CONTRACTOR ENCOUNTERS OR OTHERWISE BECOMES AWARE OF ANY SEWERS, UNDERDRAINS OR FIELD DRAINS WITHIN THE RIGHT-OF-WAY OTHER THAN THOSE SHOWN ON THE PLANS. HE SHALL INFORM THE ENGINEER WHO SHALL DIRECT THE WORK NECESSARY TO MAINTAIN, ABANDONED OR REPLACE THE FACILITIES IN SERVICE AND TO PROTECT THEM FROM DAMAGE DURING CONSTRUCTION IF MAINTAINED. EXISTING FACILITIES TO BE MAINTAINED THAT ARE DAMAGED BECAUSE OF THE NON-COMPLIANCE OF THIS PROVISION SHALL BE REPLACED AT THE CONTRACTOR'S EXPENSE.
- 6. EXCAVATION FOR STORM SEWER CONSTRUCTION IS REQUIRED IN AREAS CONTAINING REGULATED SUBSTANCES AS IDENTIFIED IN THE SOIL MANAGEMENT PLAN. SEE SPECIAL PROVISIONS FOR REMOVAL AND DISPOSAL OF SOIL AND GROUNDWATER IN THESE AREAS.
- 7. CLSM (SPECIAL) SHALL BE USED IN LIEU OF TRENCH BACKFILL AT LOCATIONS WHERE TWO DRAINAGE STRUCTURES OCCUR ADJACENT TO EACH OTHER, IN AREAS WITH A PARTIAL REMOVAL OF A DRAINAGE STRUCTURE OR OTHER AREAS WHERE DEEMED NECESSARY BY THE ENGINEER. SEE SCHEDULE FOR ANTICIPATED LOCATIONS.
- 8. ONLY PRECAST CONCRETE ADJUSTMENT RINGS, MAXIMUM OF 12" IN HEIGHT, WILL BE ALLOWED IN THE ADJUSTMENT OF CATCH BASIN, MANHOLES, INLETS AND VALVE VAULT STRUCTURES. COMMON BRICK WILL NOT BE ALLOWED.
- FOR STORM SEWER CONSTRUCTED UNDER THE ROADWAY, SIDEWALKS, OR ANY PAVEMENT THE BACKFILLING FOR TRENCH BACKFILL SHALL BE METHOD 1 (550.07 A). METHODS TWO (550.07 B) AND THREE (550.07 C) WILL NOT BE ALLOWED.
- 10. THE LOCATIONS OF EXISTING DRAINAGE STRUCTURES, STORM SEWERS AND SANITARY SEWERS AS SHOWN ON THE PLANS ARE APPROXIMATE, AND THE EXACT LOCATION IS TO BE DETERMINED IN THE FIELD BY THE CONTRACTOR AND SHALL NOTIFY THE ENGINEER OF ANY DISCREPANCIES.
- 11. LENGTHS AND SIZES OF EXISTING STORM SEWERS AND STRUCTURES AS SHOWN ON THE PLANS SHALL BE VERIFIED IN THE FIELD PRIOR TO INSTALLATION OF PROPOSED DRAINAGE ITEMS. THE INVERTS OF PROPOSED DRAINAGE ITEMS CONNECTING TO EXISTING SEWERS OR STRUCTURES MAY REQUIRE REVISIONS TO MEET EXISTING FIELD CONDITIONS. ANY ADJUSTMENTS SHALL BE AS DIRECTED BY THE ENGINEER.
- 12. EXISTING DRAINAGE STRUCTURES TO BE LEFT IN PLACE SHALL BE PROTECTED DURING CONSTRUCTION. IF IN THE OPINION OF THE ENGINEER, THE DRAINAGE STRUCTURES ARE DAMAGED DUE TO THE CONTRACTOR'S OPERATION, THEY SHALL BE REPLACED IN KIND AT NO ADDITIONAL COST.
- 13. ALL ABANDONED AND REMOVED SEWER PENETRATIONS SHALL BE PLUGGED. THIS WORK SHALL BE INCLUDED IN THE COST OF THE STORM SEWER BEING REMOVED/ABANDONED. SEE SPECIAL PROVISIONS.
- 14. CONTRACTOR SHALL FOLLOW CONSTRUCTION REQUIREMENTS OF SECTION 611 WHEN EXISTING FIELD TILE IS ENCOUNTERED. ALL FIELD TILES ENCOUNTERED SHALL BE CAREFULLY PRESERVED, REPAIRED AND CONNECTED TO THE PROPOSED DRAINAGE STRUCTURES, SEWERS OR DITCHES AS DIRECTED BY THE ENGINEER. PAYMENT FOR THIS WORK SHALL BE INCLUDED IN THE VARIOUS DRAINAGE ITEMS OR AS DIRECTED BY THE ENGINEER
- 15. EXISTING STRUCTURE AND PIPE INFORMATION PROVIDED IN PLANS FOR INFORMATION ONLY. EXISTING STRUCTURE AND PIPE INFORMATION NOT INCLUDED IN THE SCHEDULES ARE NOT ANTICIPATED TO BE AFFECTED BY PROPOSED CONSTRUCTION.
- 16. STRUCTURES AND STORM SEWERS TO BE CLEANED SHALL BE COMPLETED IN CONJUNCTION WITH MOT FOR THE PROJECT AND COMPLETED AT THE EARLIEST POSSIBLE STAGE.
- 17. SEE DETAIL SHEET FOR LOCATION OF OFFSETS AND TOP OF "RIM" ELEVATIONS FOR DRAINAGE STRUCTURES. INFORMATION PROVIDED TO ASSIST THE CONTRACTOR IN DETERMINING THE APPROXIMATE OVERALL HEIGHT OF EACH STRUCTURE. CONTRACTOR SHALL BE RESPONSIBLE FOR DETERMINING CENTER OF STRUCTURE AND FINAL ELEVATIONS BASED ON LOCATIONS AND INFORMATION PROVIDED AS PART OF THE STRUCTURE COST.
- 18. THE CONTRACTOR SHALL VERIFY WHEN FLAT SLAB TOPS ARE REQUIRED ON MANHOLES AND CATCH BASINS. NO ADDITIONAL COMPENSATION SHALL BE PROVIDED FOR THE USE OF FLAT SLAB TOPS.
- 19. PIPE LENGTHS AND STRUCTURE INVERTS ARE GIVEN TO THE CENTER OF THE STRUCTURE (NODES) AND SHALL BE ADJUSTED TO THE STRUCTURE PERIMETER FOR STRUCTURE SIZE PROVIDED SO THE PIPE SLOPES MATCH THOSE INDICATED IN THE SCHEDULE AND PROFILES. PAYMENT FOR PIPE LENGTH WILL BE PER STANDARD SPECIFICATIONS.
- 20. FOR STRUCTURES HAVING TYPE 8 OR CITY STANDARD 3044 SPECIAL FRAME AND GRATE, A 24" INSIDE DIAMETER BY 4" (MINIMUM) HIGH RISER SHALL BE INSTALLED ON THE FLAT SLAB TO PROVIDE EARTH COVER OVER THE SLAB FOR VEGETATION GROWTH.
- 21. FILL TYPE RETAINING WALLS (MSE AND PRECAST MODULAR) SHALL BE DETAILED AND CONSTRUCTED TO ALLOW FOR PROPOSED ROADWAY DRAINAGE TO BE PLACED PROPERLY AND AS SHOWN IN THE PLANS. ANY REQUESTS FOR MODIFICATION TO DRAINAGE STRUCTURE LOCATIONS TO ACCOMMODATE WALL REINFORCING OR DETAILS SHALL BE SUBMITTED TO THE ENGINEER IN WRITING FOR REVIEW. ANY CHANGES APPROVED BY THE ENGINEER IN WRITING WILL BE COORDINATED BY THE CONTRACTOR AT NO ADDITIONAL COST.
- 22. THE PROPOSED PROJECT WILL NOT INCREASE THE QUANTITY OR ALTER THE FLOW OF RUNOFF TO THE RAILWAY DITCHES OR RAILWAY DRAINAGE STRUCTURES.

SEDIMENTATION AND EROSION CONTROL NOTES:

- SOIL DISTURBANCE SHALL BE CONDUCTED IN SUCH A MANNER AS TO MINIMIZE EROSION. SOIL STABILIZATION MEASURES SHALL CONSIDER THE TIME OF YEAR, SITE CONDITIONS AND THE USE OF TEMPORARY OR PERMANENT MEASURES.
- TEMPORARY SOIL STABILIZATION SHALL BE APPLIED TO DISTURBED AREAS WITHIN 14 CALENDAR DAYS OF THE END OF ACTIVE HYDROLOGIC DISTURBANCE. PERMANENT STABILIZATION SHALL BE DONE WITHIN 14 DAYS AFTER COMPLETION OF FINAL GRADING.
- 3. ALL STORM SEWER FACILITIES THAT ARE OR WILL BE FUNCTIONING DURING CONSTRUCTION SHALL BE PROTECTED, FILTERED OR OTHERWISE TREATED TO REMOVE SEDIMENT.
- 4. ALL TEMPORARY EROSION AND SEDIMENT CONTROL MEASURES SHALL BE REMOVED WITHIN 30 DAYS AFTER FINAL SITE STABILIZATION IS ACHIEVED OR AFTER THE TEMPORARY MEASURES ARE NO LONGER NEEDED. TRAPPED SEDIMENT AND OTHER DISTURBED SOIL AREAS SHALL BE PERMANENTLY STABILIZED.
- ALL TEMPORARY AND PERMANENT EROSION CONTROL MEASURES SHALL BE MAINTAINED AND REPAIRED AS NEEDED. THE CONTRACTOR SHALL BE RESPONSIBLE FOR INSPECTION AND REPAIR DURING CONSTRUCTION.
- THE EROSION CONTROL MEASURES INDICATED ON THE PLANS ARE THE MINIMUM REQUIREMENTS. ADDITIONAL MEASURES MAY BE REQUIRED, AS DIRECTED BY THE ENGINEER OR GOVERNING AGENCY
- THE CONTRACTOR SHALL INSTALL ALL EROSION CONTROL PRIOR TO THE START OF ANY FARTHWORK.
- 8. IF A STOCKPILE IS TO REMAIN IN PLACE FOR MORE THAN THREE DAYS, EROSION CONTROL MEASURES SHALL BE PROVIDED BY THE CONTRACTOR.
- 9. THE DEPARTMENT HAS NOT OBTAINED ANY PERMITS FOR OFFSITE BORROW, WASTE, USE (BWU) AREAS. PRIOR TO WORKING IN BWU AREAS, IF THE CONTRACTOR CHOOSES TO USE ACTIVITIES REQUIRING PERMITS IT IS THE CONTRACTOR'S RESPONSIBILITY TO SECURE THE PROPER PERMITS. IN ADDITION TO THE BORROW REVIEW (BDE 2289) AND USE/WASTE REVIEW (BDE 2290) SUBMITTALS, THE CONTRACTOR SHALL SUBMIT AN EROSION AND SEDIMENT CONTROL (ESC) PLAN FOR EVERY BWU SITE TO THE DEPARTMENT FOR ACCEPTANCE.
- 10. ESTIMATED QUANTITIES OF TEMPORARY EROSION CONTROL ITEMS FOR PRE-STAGE ACTIVITIES ARE SHOWN IN THE SCHEDULE. THESE ACTIVITIES INCLUDE BUILDING REMOVAL, WATERMAIN RELOCATION AND STORM SEWER CONSTRUCTION. SEE PLANS FOR MORE INFORMATION.

LANDSCAPING AND TREE PRESERVATION NOTES:

- ALL TREE REMOVAL AND PRUNING SHALL BE COMPLETED BEFORE CONSTRUCTION
 OPERATIONS COMMENCE IN ANY AREA. AT NO TIME SHALL THE CONTRACTOR PRUNE OR
 REMOVE ANY TREES UNLESS SPECIFICALLY DIRECTED BY THE ENGINEER.
- 2. THE CONTRACTOR SHALL COORDINATE WITH THE ENGINEER AND THE CITY OF DECATUR REGARDING THE TIMING OF TREE REMOVAL PRIOR TO THE CITY OF DECATUR'S SANITARY SEWER IMPROVEMENT PROJECT ON THE EAST LEG OF FARIES PARKWAY.
- 3. EXISTING VEGETATED AREAS (TREES, SHRUBS, VEGETATIVE BUFFERS, TURF AREAS, ETC.)
 WHERE DISTURBANCE IS NOT OCCURRING (INCLUDING AREAS OUTSIDE THE PROJECT LIMITS)
 SHALL NOT BE DISTURBED TO ENSURE THAT EXISTING VEGETATION IS PRESERVED TO
 MINIMIZE SOIL EROSION AND TO ELIMINATE SOIL COMPACTION. NO MATERIALS ARE TO BE
 STORED OR VEHICLES DRIVEN OR PARKED WITHIN THESE UNDISTURBED AREAS AT ANY TIME.
- 4. PRUNE TREE LIMBS THAT MIGHT BE DAMAGED BY EQUIPMENT OPERATIONS AT LEAST ONE WEEK PRIOR TO THE START OF CONSTRUCTION BY A CERTIFIED ARBORIST. ANY TREE LIMBS THAT ARE BROKEN BY CONSTRUCTION EQUIPMENT AFTER THE INITIAL PRUNING MUST BE PRUNED CORRECTLY WITHIN 72 HOURS.
- 5. TREES SHALL NOT BE CLEARED FROM APRIL 1 THROUGH SEPTEMBER 30 TO AVOID ADVERSELY AFFECTING THE INDIANA AND NORTHERN LONG-EARED BATS.

AECOM

345 EAST ASH AVENUE
DECATUR, II. 62526

USER NAME = Jacqueline.Ng	DESIGNED -	EU	REVISED -
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PLOT SCALE = 2.0000 ' / in.	CHECKED -	WBS	REVISED -
PLOT DATE = 10/29/2021	DATE -	10/22/2021	REVISED -

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				CONSTRUCTION CODE										
CODE NO.	ITEM	UNIT	TOTAL	ROADWAY 0004 URBAN	RETAINING WALL 0044 058-W003	RETAINING WALL 0044 058-W004	RETAINING WALL 0044 058-W006	RETAINING WALL 0044 058-W007	BRIDGE 0008 058-9202	BUILDING DEMOLITION 0044 URBAN	HIGHWAY LIGHTING 0021 URBAN			
	· · · · ·													
20100110	TREE REMOVAL (6 TO 15 UNITS DIAMETER)	UNIT	110	86						24				
20100210	TREE REMOVAL (OVER 15 UNITS DIAMETER)	UNIT	284	224						60				
20100500	TREE REMOVAL, ACRES	ACRE	3.00	2.75						0.25				
20200100	EARTH EXCAVATION	CU YD	60,180	60,180										
20201200	REMOVAL AND DISPOSAL OF UNSUITABLE MATERIAL	CU YD	3,010	3,010										
20400800	FURNISHED EXCAVATION	CU YD	33,310	33,310							-			
20800150	TRENCH BACKFILL	CU YD	10,927.4	10,927.4										
21101615	TOPSOIL FURNISH AND PLACE, 4"	SQ YD	41,241	41,241										
21400100	GRADING AND SHAPING DITCHES	FOOT	1,100	1,100										
25000110	SEEDING, CLASS 1A	ACRE	5.50	5.50										
25000210	SEEDING, CLASS 2A	ACRE	3.00	3.00										
25000400	NITROGEN FERTILIZER NUTRIENT	POUND	778	778										
25000500	PHOSPHORUS FERTILIZER NUTRIENT	POUND	778	778										
25000600	POTASSIUM FERTILIZER NUTRIENT	POUND	778	778										

"	AECOM
	345 EAST ASH AVENUE DECATUR, (L 62526 PHONE: (217) 775-6065

USER NAME = busanskyl	DESIGNED	-	LMB	REVISED -	
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PLOT SCALE = 2,0000 ' / in.	CHECKED	-	WBS	REVISED -	
PLOT DATE = 5/6/2021	DATE	-	4/30/2021	REVISED -	

CHARAGOV OF CHARITITIES									F.A.U. RTE.	SECTION	COUNTY	TOTAL SHEETS	SHEET NO.
	SUMMARY OF QUANTITIES							7448	09-00933-01-BR	MACON	1019	5	
											CONTRA	ACT NO.	95893
	SCALE: N/A	SHEET	1	OF	32	SHEETS	STA.	TO STA.	ILLINOIS FED. AID PROJECT				

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				ROADWAY	RETAINING WALL	RETAINING WALL	RETAINING WALL	RETAINING WALL	BR I DGE	BUILDING DEMOLITION	HIGHWAY LIGHTING	
CODE			TOTAL	0004	0044	0044	0044	0044	0008	0044	0021	
NO.	ITEM	UNIT	TOTAL	URBAN	058-W003	058-W004	058-W006	058-W007	058-9202	URBAN	URBAN	
NO.	7.1.674	UNIT										
25003110	INTERSEEDING, CLASS 1A	ACRE	2.25	2.25								
25100115	MULCH, METHOD 2	ACRE	4.50	4.50								
25100630	EROSION CONTROL BLANKET	SQ YD	14,482	14,482								
25100635	HEAVY DUTY EROSION CONTROL BLANKET	SQ YD	858	858								
28000250	TEMPORARY EROSION CONTROL SEEDING	POUND	5,223	3,123						2,100		
28000305	TEMPORARY DITCH CHECKS	FOOT	510	510					BILLIF			

28000400	PERIMETER EROSION BARRIER	FOOT	17,176	13,677						3,499		
28000500	INLET AND PIPE PROTECTION	EACH	46	46								
28000510	INLET FILTERS	EACH	166	166								
28001100	TEMPORARY EROSION CONTROL BLANKET	SQ YD	46,161	20,753						25,408		
28001200	TEMPORARY HEAVY DUTY EROSION CONTROL BLANKET	SQ YD	4,355	4,355								
28100105	STONE RIPRAP, CLASS A3	SQ YD	3,413	3,413					· · · · · · · · · · · · · · · · · · ·			
28100107	STONE RIPRAP, CLASS A4	SQ YD	1,237	1,237								
28200200	FILTER FABRIC	SQ YD	4,651	4,651								

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	345 EAST ASH AVEYUR DECATUR, IL 62526 PHONE: (217) 775-6065

USER NAME = busanskyl	DESIGNED	-	LMB	REVISED	-
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PLOT DATE = 5/6/2021	DATE	-	4/30/2021	REVISED	-

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SUMMARY OF QUANTITIES									7448 09-00933-01-BR		MACON	1019	6
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				ROADWAY	RETAINING WALL	RETAINING WALL	RETAINING WALL	RETAINING WALL	BRIDGE	BUILDING DEMOLITION	HIGHWAY LIGHTING
CODE			TOTAL	0004	0044	0044	0044	0044	0008	0044	0021
NO.	ITEM	UNIT		URBAN	058-W003	058-W004	058-W006	058-W007	058-9202	URBAN	URBAN
30300001	AGGREGATE SUBGRADE IMPROVEMENT	CU YD	200	200							
31101200	SUBBASE GRANULAR MATERIAL, TYPE B 4"	SQ YD	10,861	10,861							ļ
35100700	AGGREGATE BASE COURSE, TYPE A 8"	SQ YD	15,458	15,458							
35101100	ACCRECATE BACE COURSE TYPE A 124	50 VP	47.007	47,007							
35101100	AGGREGATE BASE COURSE, TYPE A 12"	SQ YD	47,997	47,997							
40200100	AGGREGATE SURFACE COURSE, TYPE A	TON	10	10							
40200500	AGGREGATE SURFACE COURSE, TYPE A 6"	SQ YD	1,459	1,459							
40600275	BITUMINOUS MATERIALS (PRIME COAT)	POUND	26,879.2	26,879.2							
40600290	BITUMINOUS MATERIALS (TACK COAT)	POUND	1,847.7	1,847.7							
40600990	TEMPORARY RAMP	SQ YD	1,053	1,053							
			1								
40602978	HOT-MIX ASPHALT BINDER COURSE, IL- 9.5, N50	TON	1,409.1	1,409.1							
40604050	HOT-MIX ASPHALT SURFACE COURSE, IL-9.5, MIX "C", N50	TON	1,075.9	1,075.9							
40700100	BITUMINOUS MATERIALS (TACK COAT)	POUND	2866.4	2866.4							
42000080	PAVEMENT CONNECTOR (PCC) FOR BRIDGE APPROACH SLAB	SQ YD	168	168							
12000501	DODTI AND CEMENT CONCRETE DAVISMENT 10 11 (LOINTED)	50.72	40.023	40.023							
42000501	PORTLAND CEMENT CONCRETE PAVEMENT 10" (JOINTED)	SQ YD	40,921	40,921							

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	345 EAST ASH AVENUE DECATUR, IL 62526

USER NAME = busanskyl	DESIGNED	-	LMB	REVISED	-
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PLOT SCALE = 2.0000 ' / in.	CHECKED	-	WBS	REVISED	-
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		SU	MINIA	ARY	OF QU	7448	09-00933-01-BR		MACON	1019	7			
											CONTRA	CT NO.	95893	
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CODE	I TEM	LINIT	TOTAL	ROADWAY 0004 URBAN	RETAINING WALL 0044 058-W003	RETAINING WALL 0044 058-W004	RETAINING WALL 0044 058-W006	RETAINING WALL 0044 058-W007	BR I DGE 0008 058 - 9202	BUILDING DEMOLITION 0044 URBAN	HIGHWAY LIGHTING 0021 URBAN
NO.	ITEM	UNIT		ORDAN	030-4003	038- ₩004	038-9000	038-W007	030-9202	OKBAN	ONDAN
42001300	PROTECTIVE COAT	SQ YD	58,539	58,539							
42300100	PORTLAND CEMENT CONCRETE DRIVEWAY PAVEMENT, 5 INCH	SQ YD	1,218	1,218							
42400200	PORTLAND CEMENT CONCRETE SIDEWALK 5 INCH	SQ FT	35,945.5	35,945.5							
42400800	DETECTABLE WARNINGS	SQ FT	416	416							
44000100	PAVEMENT REMOVAL	SQ YD	54,472	38,733						15,739	
44000157	HOT-MIX ASPHALT SURFACE REMOVAL, 2"	SQ YD	2,213	2,213							
44000200	DRIVEWAY PAVEMENT REMOVAL	SQ YD	3,389	3,389							
44000300	CURB REMOVAL	FOOT	120	120							
44000500	COMBINATION CURB AND GUTTER REMOVAL	FOOT	13,498	13,498							
44000600	SIDEWALK REMOVAL	SQ FT	5,186	3,632						1,554	
44001980	CONCRETE BARRIER REMOVAL	FOOT	117	117	to,						
44003100	MEDIAN REMOVAL	SQ FT	5,911	5,911							
14201301	CLASS C PATCHES, TYPE I, 6 INCH	SQ YD	5	5 .							
44201305	CLASS C PATCHES, TYPE II, 6 INCH	SQ YD	30	30							

** DENOTES NON-PARTICIPATING ITEM

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	345 EAST ASH AVENUE DECATUR, IL 62526 PHONE: (2171 775-6065

USER NAME = busanskyl	DESIGNED	-	LMB	REVISED	-
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PLOT DATE = 5/6/2021	DATE	-	4/30/2021	REVISED	-

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SUMMARY OF QUANTITIES							7448	09-00933-01-BR	MACON	1019	8	
										CONTRA	CT NO.	95893
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CODE			TOTAL	ROADWAY	RETAINING WALL	RETAINING WALL 0044	RETAINING WALL 0044	RETAINING WALL	BR I DGE 0008	BUILDING DEMOLITION 0044	HIGHWAY LIGHTING 0021
NO.	I TEM	UNIT		URBAN	058-W003	058-W004	058-W006	058-W007	058-9202	URBAN	URBAN
44201309	CLASS C PATCHES, TYPE III, 6 INCH	SQ YD	93	93							
14201311	CLASS C PATCHES, TYPE IV, 6 INCH	SQ YD	185	185							
14201373	CLASS C PATCHES, TYPE I, 12 INCH	SQ YD	9	9							
	CLASS C PATCHES, TYPE II, 12 INCH	SQ YD	28	28							
14201381	CLASS C PATCHES, TYPE III, 12 INCH	SQ YD	34	34							
4201383	CLASS C PATCHES, TYPE IV, 12 INCH	SQ YD	822	822						,	
14201713	CLASS D PATCHES, TYPE I, 6 INCH	SQ YD	4	4							
4201717	CLASS D PATCHES, TYPE II, 6 INCH	SQ YD	22	22							
4201721	CLASS D PATCHES, TYPE III, 6 INCH	SQ YD	38	38							
4201723	CLASS D PATCHES, TYPE IV, 6 INCH	SQ YD	264	264							
8100300	AGGREGATE SHOULDERS, TYPE A 4"	SQ YD	489	489							
0102400	CONCRETE REMOVAL	CU YD	71.7	25.9						45.8	
0104400	CONCRETE HEADWALL REMOVAL	EACH	1	1							
0105220	PIPE CULVERT REMOVAL	FOOT	223	223							

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	345 EAST ASH AVENUE DECATUR, IL 62526 PHONE: (217) 775-6065

USER NAME = busanskyl	DESIGNED	-	LMB	REVISED	-
	DRAWN	-	LMB	REVISED	•
PLOT SCALE = 2.0000 ' / in.	CHECKED	-	WBS	REVISED	-
PLOT DATE = 5/6/2021	DATE	-	4/30/2021	REVISED	-

OURTHANDY OF QUARTETING									SECTION	COUNTY	SHEETS	NO.	
SUMMARY OF QUANTITIES							7448	09-00933-01-8R	MACON	1019	9		
										CONTR	ACT NO.	95893	
SCALE: N/A	SHEET	5	OF	32	SHEETS	STA.	TO STA.		ILLINOIS FED. AID PROJECT				

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	NO.	ITEM	UN
	50200100	STRUCTURE EXCAVATION	CU
	50300225	CONCRETE STRUCTURES	CU
	50300255	CONCRETE SUPERSTRUCTURE	CU
	50300260	BRIDGE DECK GROOVING	SQ
	50300300	PROTECTIVE COAT	SQ
	50301350	CONCRETE SUPERSTRUCTURE (APPROACH SLAB)	CU
	50500105	FURNISHING AND ERECTING STRUCTURAL STEEL	LS
	50500505	STUD SHEAR CONNECTORS	EA
	50800205	REINFORCEMENT BARS, EPOXY COATED	POL
	50800530	MECHANICAL SPLICERS	EA
		MECHANICAL SPETCERS	EA
,	50901720	BICYCLE RAILING	FO
:	50901730	BRIDGE FENCE RAILING	FO
*	50901735	BRIDGE FENCE RAILING (SIDEWALK)	FO
-	50901750	PARAPET RAILING	FO

AECOM

* DENOTES SPECIALTY ITEM

JSER NAME = busanskyl DESIGNED - LMB REVISED -DRAWN - LMB REVISED -PLOT SCALE = 2.0000 ' / in. CHECKED - WBS REVISED -DATE - 4/30/2021 REVISED -

** DENOTES NON-PARTICIPATING ITEM

SUMMARY OF QUANTITIES SCALE: N/A SHEET 6 OF 32 SHEETS STA.

417

CONSTRUCTION CODE

RETAINING

WALL

0044

058-W007

404

544

14,900

BRIDGE

8000

058-9202

129

317.3

509.2

1,518

2,305

199.9

1

6,723

282,620

112

60

205

205

265

TO STA.

BUILDING

DEMOLITION

0044

URBAN

HIGHWAY

LIGHTING

0021

URBAN

RETAINING WALL

0044

058-W006

505

260.0

612

41,560

RETAINING

WALL

0044

058-W004

3,971

424.8

679.1

2,301

111,340

603

584

COUNTY TOTAL SHEET NO.

MACON 1019 10 SECTION 09-00933-01-BR CONTRACT NO. 95893

STATE 0	F ILLINOIS
DEPARTMENT OF	TRANSPORTATION

RETAINING

WALL

0044

058-W003

3,890

250.0

536.0

1,221

76,840

55

100

ROADWAY

0004

URBAN

14

71.5

235

12,590

TOTAL

8,913

992.1

2,055.8

1,518

6,674

199.9

1

7,267

539,850

112

718

205

205

1,366

				CONSTRUCTION CODE									
				ROADWAY	RETAINING WALL	RETAINING WALL	RETAINING WALL	RETAINING WALL	BRIDGE	BUILDING DEMOLITION	HIGHWAY LIGHTING		
CODE			TOTAL	0004	0044	0044	0044	0044	0008	0044	0021		
NO.	ITEM	UNIT		URBAN	058-W003	058-W004	058-W006	058-W007	058-9202	URBAN	URBAN		
51100100	SLOPE WALL 4 INCH	SQ YD	36						36				
51201900	FURNISHING STEEL PILES HP14X89	FOOT	4,154						4,154				
51202305	DRIVING PILES	FOOT	4,154						4,154				
51203900	TEST PILE STEEL HP14X89	EACH	3						3				
51204650	PILE SHOES	EACH	117					55	62				
51500100	NAME PLATES	EACH	5		1	1	1	1	1				
52100010	ELASTOMERIC BEARING ASSEMBLY, TYPE I	EACH	18						18				
52100510	ANCHOR BOLTS, 3/4"	EACH	36						36				
52100540	ANCHOR BOLTS, 1 1/2"	EACH	18						18				
52200020	TEMPORARY SOIL RETENTION SYSTEM	SQ FT	1,764			1,243			521				
52200100	FURNISHING SOLDIER PILES (HP SECTION)	FOOT	824					824					
52200105	FURNISHING SOLDIER PILES (W SECTION)	FOOT	1,407					1,407					
52200150	DRIVING SOLDIER PILES	FOOT	1,689					1,689					
52200200	DRILLING AND SETTING SOLDIER PILES (IN SOIL)	CU FT	3,328					3,328					
		% 0042	2,320					3,32					

11	AECOM
	345 EAST ASH AVENUE DECATUR, IL 62526 PHONE: (217) 775-6065

USER NAME = busanskyl	DESIGNED	-	LMB	REVISED	-
	DRAWN	-	LMB	REVISED	-
PLOT SCALE = 2.0000 ' / in.	CHECKED	-	WBS	REVISED	-
PLOT DATE = 5/6/2021	DATE	-	4/30/2021	REVISED	-

STATE OF ILLINOIS DEPARTMENT OF TRANSPORTATION

		SU	MMA	ARY	OF QUANTITIE	:S
SCALE: N/A	SHEET	7	OF	32	SHEETS STA.	TO STA.

COUNTY TOTAL SHEET NO.

MACON 1019 11

CONTRACT NO. 95893 F.A.U. SECTION RTE. 99-00933-01-BR

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			CONSTRUCTION CODE							
			ROADWAY	RETAINING WALL	RETAINING WALL	RETAINING WALL	RETAINING WALL	BRIDGE	BUILDING DEMOLITION	HIGHWAY LIGHTING
		TOTAL	0004	0044	0044	0044	0044	0008	0044	0021
ITEM	UNIT		URBAN	058-W003	058-W004	058-W006	058-W007	058-9202	URBAN	URBAN
UNTREATED TIMBER LAGGING	SQ FT	3,016					3,016			
MECHANICALLY STABILIZED EARTH RETAINING WALL	SQ FT	14,467			10,612	3,855				
PRECAST MODULAR RETAINING WALL	SQ FT	35,689		19,343	16,346					
CONCRETE STRUCTURES (RETAINING WALL)	CU YD	159.4					159.4			
	F007	2.6								11.111111111111111111111111111111111111
PIPE CULVERTS, CLASS A, TYPE 1 12"	FOOT	36	36							
PIPE CULVERTS, CLASS A, TYPE 1 15"	FOOT	26	26							
PIPE CULVERTS, CLASS A, TYPE 2 72"	FOOT	98	98							
PRECAST REINFORCED CONCRETE FLARED END SECTIONS 12"	EACH	2	2							
PRECAST REINFORCED CONCRETE FLARED END SECTIONS 15"	EACH	1	1							
PRECAST REINFORCED CONCRETE FLARED END SECTIONS 36"	EACH	2	2							
PRECAST REINFORCED CONCRETE FLARED END SECTIONS 48"	EACH	1	1							
PRECAST REINFORCED CONCRETE FLARED END SECTIONS 72"	EACH	1	1							
CONCRETE COLLAR	CU YD	6.2	6.2							
STORM SEWERS, CLASS A, TYPE 2 12"	FOOT	4,966	4,966							
	UNTREATED TIMBER LAGGING MECHANICALLY STABILIZED EARTH RETAINING WALL PRECAST MODULAR RETAINING WALL CONCRETE STRUCTURES (RETAINING WALL) PIPE CULVERTS, CLASS A, TYPE 1 12" PIPE CULVERTS, CLASS A, TYPE 1 15" PIPE CULVERTS, CLASS A, TYPE 2 72" PRECAST REINFORCED CONCRETE FLARED END SECTIONS 12" PRECAST REINFORCED CONCRETE FLARED END SECTIONS 36" PRECAST REINFORCED CONCRETE FLARED END SECTIONS 36" PRECAST REINFORCED CONCRETE FLARED END SECTIONS 48" PRECAST REINFORCED CONCRETE FLARED END SECTIONS 72" CONCRETE COLLAR	UNTREATED TIMBER LAGGING SQ FT MECHANICALLY STABILIZED EARTH RETAINING WALL SQ FT CONCRETE STRUCTURES (RETAINING WALL) CU YD PIPE CULVERTS, CLASS A, TYPE 1 12" FOOT PIPE CULVERTS, CLASS A, TYPE 1 15" FOOT PIPE CULVERTS, CLASS A, TYPE 2 72" FOOT PRECAST REINFORCED CONCRETE FLARED END SECTIONS 12" EACH PRECAST REINFORCED CONCRETE FLARED END SECTIONS 36" EACH PRECAST REINFORCED CONCRETE FLARED END SECTIONS 36" EACH PRECAST REINFORCED CONCRETE FLARED END SECTIONS 48" EACH PRECAST REINFORCED CONCRETE FLARED END SECTIONS 48" EACH CONCRETE COLLAR CU YD	UNIT UNTREATED TIMBER LAGGING SQ FT 3.016 MECHANICALLY STABILIZED EARTH RETAINING WALL SQ FT 14,467 PRECAST MODULAR RETAINING WALL CONCRETE STRUCTURES (RETAINING WALL) PIPE CULVERTS, CLASS A, TYPE 1 12" FOOT 36 PIPE CULVERTS, CLASS A, TYPE 1 15" FOOT 26 PIPE CULVERTS, CLASS A, TYPE 2 72" FOOT 98 PRECAST REINFORCED CONCRETE FLARED END SECTIONS 12" EACH 2 PRECAST REINFORCED CONCRETE FLARED END SECTIONS 36" EACH 1 PRECAST REINFORCED CONCRETE FLARED END SECTIONS 48" EACH 1 PRECAST REINFORCED CONCRETE FLARED END SECTIONS 48" EACH 1 PRECAST REINFORCED CONCRETE FLARED END SECTIONS 72" EACH 1 CONCRETE COLLAR CONCRETE COLLAR CU YD 6.2	NOTAL O004 URBAN	NALL WALL WALL 10044 0044 0044 NOTE WALL WALL WALL OD OD OD OD OD OD OD	TOTAL 1014 0044 0044 0044 0044 0044 0044 004	NOTE NOTE	TITEM 1004 1004 1004 1004 1004 1004 1004 100	MINITERATE TEMPORE LACTINES LACTINES

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"	AECOM
	345 EAST ASH AVENUE DECATUR, II. 62526 PHONE: (217) 775-6065

USER NAME = busanskyl	DESIGNED	-	LMB	REVISED	-
	DRAWN	-	LMB	REVISED	-
PLOT SCALE = 2.0000 ' / in.	CHECKED	-	WBS	REVISED	-
 PLOT DATE = 5/6/2021	DATE	-	4/30/2021	REVISED	-

STATE OF ILLINOIS
DEPARTMENT OF TRANSPORTATION

								F.A.U. RTE.	SECTION	COUNTY	TOTAL SHEETS	SHEET NO.
	SUMMARY OF QUANTITIES						S	7448	09-00933-01-BR	MACON	1019	12
										CONT	RACT NO.	95893
S	HEET	8	OF	32	SHEETS	STA.	TO STA.		ILLINOIS FE	D. AID PROJECT		

						· · · · · · · · · · · · · · · · · · ·	CONSTRUC	TION CODE			
				ROADWAY	RETAINING WALL	RETAINING WALL	RETAINING WALL	RETAINING WALL	BR I DGE	BUILDING DEMOLITION	HIGHWAY LIGHTING
CODE			TOTAL	0004	0044	0044	0044	0044	0008	0044	0021
NO.	ITEM	UNIT		URBAN	058-W003	058-W004	058-W006	058-W007	058-9202	URBAN	URBAN
550A0360	STORM SEWERS, CLASS A, TYPE 2 15"	FOOT	1,966	1,966							
			·								
550A0380	STORM SEWERS, CLASS A, TYPE 2 18"	FOOT	1,346	1,346							
550A0410	STORM SEWERS, CLASS A, TYPE 2 24"	FOOT	819	819							
550A0430	STORM SEWERS, CLASS A, TYPE 2 30"	FOOT	67	67							
55010150											
550A0450	STORM SEWERS, CLASS A, TYPE 2 36"	FOOT	175	175							
550A0480	STORM SEWERS, CLASS A, TYPE 2 48"	FOOT	277	277							
550A0710	STORM SEWERS, CLASS A, TYPE 3 24"	FOOT	142	142							
550A0750	STORM SEWERS, CLASS A, TYPE 3 36"	FOOT	451	451							
550A0770	STORM SEWERS, CLASS A, TYPE 3 42"	FOOT	431	431							
550B0040	STORM SEWERS, CLASS B, TYPE 1 10"	FOOT	20	20							
550B0640	STORM SEWERS, CLASS B, TYPE 3 12"	FOOT	72	72							
t. 55103000		5007	1.00				:				
* 56103000	DUCTILE IRON WATER MAIN 6"	FOOT	138	138							
£ 56103100	DUCTILE IRON WATER MAIN 8"	FOOT	438	438							
56103300	DUCTILE IRON WATER MAIN 12"	FOOT	25	25							

:1	AECOM
	345 EAST ASH AVENUE DECATUR, IL 62526

USER NAME = busanskyl	DESIGNED	-	LMB	REVISED -
	DRAWN	-	LMB	REVISED -
PLOT SCALE = 2.0000 ' / in.	CHECKED	-	WBS	REVISED -
PLOT DATE = 5/6/2021	DATE	-	4/30/2021	REVISED -

STATE OF ILLINOIS
DEPARTMENT OF TRANSPORTATION

SCALE: N/A

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	St	JMM/	AHY	OF QU	ANTITIES	S	7448	09-00
							i	
SHEET	9	OF	32	SHEETS	STA.	TO STA.		

COUNTY TOTAL SHEET NO.

MACON 1019 13

CONTRACT NO. 95893 SECTION 00933-01-BR

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				CONSTRUCTION CODE									
CODE NO.	ITEM	UNIT	TOTAL	ROADWAY 0004 URBAN	RETAINING WALL 0044 058-W003	RETAINING WALL 0044 058-W004	RETAINING WALL 0044 058-W006	RETAINING WALL 0044 058-W007	BR1DGE 0008 058-9202	BUILDING DEMOLITION 0044 URBAN	HIGHWAY LIGHTING 0021 URBAN		
NO.	I I LIVI	ONT											
56103400	DUCTILE IRON WATER MAIN 16"	FOOT	228	228									
56103520	DUCTILE IRON WATER MAIN 24"	FOOT	1,425	1,425									
56103526	DUCTILE IRON WATER MAIN 30"	FOOT	751	751									
										11.01%			
56105000	WATER VALVES 8"	EACH	3	3									
56105200	WATER VALVES 12"	EACH	1	1									
56105300	WATER VALVES 16"	EACH	3	3									
56105420	WATER VALVES 24"	EACH	2	2									
56105435	WATER VALVES 30"	EACH	1	1									
56107000	REMOVE AND RELOCATE WATER MAIN 4"	FOOT	70	70									
56107100	REMOVE AND RELOCATE WATER MAIN 6"	FOOT	20	20									
56107200	REMOVE AND RELOCATE WATER MAIN 8"	FOOT	20	20									
56107400	REMOVE AND RELOCATE WATER MAIN 12"	FOOT	20	20									
56107500	REMOVE AND RELOCATE WATER MAIN 16"	FOOT	20	20									
56107615	REMOVE AND RELOCATE WATER MAIN 24"	FOOT	20	20									

41	AECOM
	345 EAST ASH AVENUE DECATUR, IL 62526 PHONE: (217) 775-6065

USER NAME = Jacqueline,Ng	DESIGNED	-	LMB	REVISED -
	DRAWN	-	LMB	REVISED -
PLOT SCALE = 2,0000 ' / in.	CHECKED	-	WBS	REVISED -
PLOT DATE = 10/29/2021	DATE	-	10/22/2021	REVISED -

				MARY OF QUANTITIES OF 32 SHEETS STA. TO STA.		F.A.U. RTE.	SECTION	COUNTY	TOTAL	SHEET NO.		
		SU	MMA	ARY	OF QU	ANTITIES	5	7448	09-00933-01-BR	MACON	1019	14
										CONTRA	CT NO.	95893
SCALE: N/A	SHEET	10	OF	32	SHEETS	STA.	TO STA.		ILLINOIS FED. A	ID PROJECT		

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				CONSTRUCTION CODE							
CODE			TOTAL	ROADWAY 0004	RETAINING WALL	RETAINING WALL 0044	RETAINING WALL	RETAINING WALL 0044	BR I DGE 0008	BUILDING DEMOLITION 0044	HIGHWAY LIGHTING 0021
NO.	ITEM	UNIT		URBAN	058-W003	058-W004	058-W006	058-W007	058-9202	URBAN	URBAN
56107630	REMOVE AND RELOCATE WATER MAIN 30"	FOOT	20	20							
56400510	FIRE HYDRANTS TO BE REMOVED AND REPLACED	EACH	2	2							
56400810	FIRE HYDRANT EXTENSION	FOOT	10	10							
56400820	FIRE HYDRANT WITH AUXILIARY VALVE AND VALVE BOX	EACH	8	8							
58600101	GRANULAR BACKFILL FOR STRUCTURES	CU YD	235.5	19.9					215.6		
58700300	CONCRETE SEALER	SQ FT	6,408					3,773	2,635		
59100100	GEOCOMPOSITE WALL DRAIN	SQ YD	227					227			
60108104	PIPE UNDERDRAINS, TYPE 1, 4"	FOOT	200	200							
60146304	PIPE UNDERDRAINS FOR STRUCTURES 4"	FOOT	1,836		652	690		494			
60200305	CATCH BASINS, TYPE A, 4'-DIAMETER, TYPE 3 FRAME AND GRATE	EACH	2	2							
60200310	CATCH BASINS, TYPE A, 4'-DIAMETER, TYPE 3V FRAME AND GRATE	EACH	1	1							
60200705	CATCH BASINS, TYPE A, 4'-DIAMETER, TYPE 6 FRAME AND GRATE	EACH	3	3							
60200805	CATCH BASINS, TYPE A, 4'-DIAMETER, TYPE 8 GRATE	EACH	4	4							
50201005	CATCH BASINS, TYPE A, 4'-DIAMETER, TYPE 10 FRAME AND GRATE	EACH	2	2							

"	
	AECOM
	345 EAST ASH AVENUE DECATUR, IL 62526

USER NAME = Jacqueline.Ng	DESIGNED -		LMB	REVISED	-
	DRAWN -	,	LMB	REVISED	-
PLOT SCALE = 2.0000 ' / in.	CHECKED -		WBS	REVISED	-
PLOT DATE = 10/29/2021	DATE -		10/22/2021	REVISED	_

STATE OF ILLINOIS
DEPARTMENT OF TRANSPORTATION

SCALE: N/A

	RTE.	SECTION					
	SUMI	7448	09-00933-01-BR				
SHEET 1	11 0	F 32	SHEETS	STA.	TO STA		BLIMOIS

A.U. SECTION COUNTY TOTAL SHEET NO.
7448 09-00933-01-BR MACON 1019 15
CONTRACT NO. 95893

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				CONSTRUCTION CODE								
CODE	ITEM	LINIT	TOTAL	ROADWAY 0004 URBAN	RETAINING WALL 0044 058-W003	RETAINING WALL 0044 058-W004	RETAINING WALL 0044 058-W006	RETAINING WALL 0044 058-W007	BRIDGE 0008 058-9202	BUILDING DEMOLITION 0044 URBAN	HIGHWAY LIGHTING 0021 URBAN	
NO.	1 E V	UNIT		ONDAN	038-4003	050*#004	030 - 11000	038-#007	030-3202	ORBAN	ONDAIN	
50207105	CATCH BASINS, TYPE C, TYPE 3 FRAME AND GRATE	EACH	12	12								
50207115	CATCH BASINS, TYPE C, TYPE 3V FRAME AND GRATE	EACH	8	8								
50207605	CATCH BASINS, TYPE C, TYPE 8 GRATE	EACH	2	2								
60207805	CATCH BASINS, TYPE C, TYPE 10 FRAME AND GRATE	EACH	9	9								
60207905	CATCH BASINS, TYPE C, TYPE 11 FRAME AND GRATE	EACH	1	1								
60208210	CATCH BASINS, TYPE C, TYPE 20 FRAME AND GRATE	EACH	17	17		-						
60218300	MANHOLES, TYPE A, 4'-DIAMETER, TYPE 1 FRAME, OPEN LID	EACH	2	2								
60218400	MANHOLES, TYPE A, 4'-DIAMETER, TYPE 1 FRAME, CLOSED LID	EACH	10	10								
60218500	MANHOLES, TYPE A, 4'-DIAMETER, TYPE 3 FRAME AND GRATE	EACH	10	10								
60219200	MANHOLES, TYPE A, 4'-DIAMETER, TYPE 10 FRAME AND GRATE	EACH	6	6								
60219510	MANHOLES, TYPE A, 4'-DIAMETER, TYPE 20 FRAME AND GRATE	EACH	1	1								
60219570	MANHOLES, TYPE A, 4'-DIAMETER, TYPE 3V FRAME AND GRATE	EACH	6	6								
50221100	MANHOLES, TYPE A, 5'-DIAMETER, TYPE 1 FRAME, CLOSED LID	EACH	3	3								
 50221200	MANHOLES, TYPE A, 5'-DIAMETER, TYPE 3 FRAME AND GRATE	EACH	6	6								

"	AECOM
	345 EAST ASH AVENUE DECATUR, IL 62526

USER NAME = Jacqueline.Ng	DESIGNED	-	LMB	REVISED	-
	DRAWN	-	LMB	REVISED	•
PLOT SCALE = 2.0000 ' / in.	CHECKED	-	WBS	REVISED	-
PLOT DATE = 10/29/2021	DATE	-	10/22/2021	REVISED	-

		S	UMMARY	OF QU	ANTITIES	S
SCALE: N/A	SHEET	12	OF 32	SHEETS	STA.	то

RTE.	SECTION	COUNTY	SHEETS	NO	
7448	09-00933-01-BR		MACON	1019	16
			CONTRA	CT NO.	9589
	ILLINOIS	FED. All	D PROJECT		

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					T	T	CONSTRUC	TION CODE	I		
CODE NO.	ITEM	LINIT	TOTAL	ROADWAY 0004 URBAN	RETAINING WALL 0044 058-W003	RETAINING WALL 0044 058-W004	RETAINING WALL 0044 058-W006	RETAINING WALL 0044 058-W007	BRIDGE 0008 058-9202	BUILDING DEMOLITION 0044 URBAN	HIGHWAY LIGHTING 0021 URBAN
NO.	I I EIVI	UNIT		ORDAN	030-4003	030-11004	030-4000	030-11007	030-3202	ONDAR	ONDAN
60221700	MANHOLES, TYPE A, 5'-DIAMETER, TYPE 8 GRATE	EACH	1	1							
60221900	MANHOLES, TYPE A, 5'-DIAMETER, TYPE 10 FRAME AND GRATE	EACH	1	1							
60222270	MANHOLES, TYPE A, 5'-DIAMETER, TYPE 3V FRAME AND GRATE	EACH	9	9							
60223800	MANHOLES, TYPE A, 6'-DIAMETER, TYPE 1 FRAME, CLOSED LID	EACH	3	3							
60223810	MANHOLES, TYPE A, 6'-DIAMETER, TYPE 3 FRAME AND GRATE	EACH	3	3							
60224005	MANHOLES, TYPE A, 6'-DIAMETER, TYPE 8 GRATE	EACH	2	2							WARRING TO THE TOTAL THE TOTAL TO THE TOTAL TOTAL TO THE
60224120	MANHOLES, TYPE A, 6'-DIAMETER, TYPE 3V FRAME AND GRATE	EACH	1	1							
60224444	MANHOLES, TYPE A, 7'-DIAMETER, TYPE 10 FRAME AND GRATE	EACH	1	1							
60224447	MANHOLES, TYPE A, 7'-DIAMETER, TYPE 3 FRAME AND GRATE	EACH	2	2							
60224454	MANHOLES, TYPE A, 8'-DIAMETER, TYPE 3 FRAME AND GRATE	EACH	4	4							
60224459	MANHOLES, TYPE A, 8'-DIAMETER, TYPE 1 FRAME, CLOSED LID	EACH	5	5							
60224469	MANHOLES, TYPE A, 9'-DIAMETER, TYPE 1 FRAME, CLOSED LID	EACH	1	1							
60224477	MANHOLES, TYPE A, 9'-DIAMETER, TYPE 3 FRAME AND GRATE	EACH	2	2							
60240220	INLETS, TYPE B, TYPE 3 FRAME AND GRATE	EACH	10	10							

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	345 EAST ASH AVENUE DECATUR, IL 62526

USER NAME = Jacqueline.Ng	DESIGNED	-	LMB	REVISED	-
	DRAWN	-	LMB	REVISED	-
PLOT SCALE = 2,0000 ' / in.	CHECKED	-	WBS	REVISED	-
PLOT DATE = 10/29/2021	DATE	-	10/22/2021	REVISED	-

STATE OF ILLINOIS
DEPARTMENT OF TRANSPORTATION

 							F.A.U. RTE.	SECTION	COUNTY	TOTAL SHEETS	SHEET NO.
	SU	WIWAH	Y U	r uu	ANTITIES		7448	09-00933-01-BR	MACON	1019	17
									CONTR	ACT NO.	95893
SHEET	13	OF 3	32 \$	HEETS	STA.	TO STA.		ILLINOIS FED. AII	D PROJECT		

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CODE			TOTAL	ROADWAY	RETAINING WALL 0044	RETAINING WALL 0044	RETAINING WALL 0044	RETAINING WALL 0044	BR I DGE	BUILDING DEMOLITION	HIGHWAY LIGHTING
NO.	ITEM	UNIT		URBAN	058-W003	058-W004	058-W006	058-W007	058-9202	URBAN	URBAN
60240305	INLETS, TYPE B, TYPE 10 FRAME AND GRATE	EACH	5	5							
60240310	INLETS, TYPE B, TYPE 11 FRAME AND GRATE	EACH	1	1							
60250600	CATCH BASINS TO BE ADJUSTED WITH NEW TYPE 3 FRAME AND GRATE	EACH	8	8							
60251200	CATCH BASINS TO BE ADJUSTED WITH NEW TYPE 8 GRATE	EACH	1	1							
60255500	MANHOLES TO BE ADJUSTED	EACH	2	2							
60255800	MANHOLES TO BE ADJUSTED WITH NEW TYPE 1 FRAME, CLOSED LID	EACH	7	7							
60256400	MANHOLES TO BE ADJUSTED WITH NEW TYPE 8 GRATE	EACH	1	1							
60260100	INLETS TO BE ADJUSTED	EACH	1	1							
60261000	INLETS TO BE ADJUSTED WITH NEW TYPE 8 GRATE	EACH	1	1							
60265700	VALVE VAULTS TO BE ADJUSTED	EACH	2	2							
60266600	VALVE BOXES TO BE ADJUSTED	EACH	26	26							
60500040	REMOVING MANHOLES	EACH	39	39							
60500050	REMOVING CATCH BASINS	EACH	26	26							
60500060	REMOVING INLETS	EACH	44	44					***************************************		

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	345 EAST ASH AVENUE DECATUR, IL 62526

USER NAME = Jacqueline.Ng	DESIGNED	-	LMB	REVISED	-
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PLOT SCALE = 2.0000 ' / in.	CHECKED	-	WBS	REVISED	-
PLOT DATE == 10/29/2021	DATE	-	10/22/2021	REVISED	-

STATE OF ILLINOIS DEPARTMENT OF TRANSPORTATION

						_	F.A.U. RTE.	SECTION	COUNTY	SHEETS	SHEET NO.
	St	JMM/	ARY	OF QU	ANTITIE	S	7448	09-00933-01-BR	MACON	1019	18
									CONTRA	ACT NO.	95893
SHEET	14	OF	32	SHEETS	STA.	TO STA.		ILLINOIS FED. AI	D PROJECT		

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CODE NO.	ITEM	UNIT	TOTAL	ROADWAY 0004 URBAN	RETAINING WALL 0044 058-W003	RETAINING WALL 0044 058-W004	RETAINING WALL 0044 058-W006	RETAINING WALL 0044 058-W007	BRIDGE 0008 058-9202	BUILDING DEMOLITION 0044 URBAN	HIGHWAY LIGHTING 0021 URBAN
60500105	FILLING MANHOLES	EACH	3	3							
60500205	FILLING CATCH BASINS	EACH	1	1							
60500305	FILLING INLETS	EACH	1	1							
60600095	CLASS SI CONCRETE (OUTLET)	CU YD	5.0	5.0							
60600605	CONCRETE CURB, TYPE B	FOOT	705.5	705.5							
50602800	CONCRETE GUTTER, TYPE B	FOOT	3,655.5	3,655.5							
60603800	COMBINATION CONCRETE CURB AND GUTTER, TYPE B-6.12	FOOT	1,517.5	1,517.5	!						
60605000	COMBINATION CONCRETE CURB AND GUTTER, TYPE B-6.24	FOOT	15,775.5	15,775.5							
60605500	COMBINATION CONCRETE CURB AND GUTTER, TYPE B-6.24 (VARIABLE WIDTH GUTTER FLAG)	FOOT	326.0	326.0							
60609200	COMBINATION CONCRETE CURB AND GUTTER, TYPE M-6.12	FOOT	484.5	484.5							
60610400	COMBINATION CONCRETE CURB AND GUTTER, TYPE M-6.24	FOOT	669.0	669.0							
50618320	CONCRETE MEDIAN SURFACE, 6 INCH	SQ FT	37,264	37,264							
50624600	CORRUGATED MEDIAN	SQ FT	2,744	2,744							
60920012	PIPE CULVERTS TO BE CLEANED 12"	FOOT	383	383							

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	345 EAST ASH AVENUE DECATUR, IL 62526 PHONE: (217) 775-6065

USER NAME = Jacqueline.Ng	DESIGNED	-	LMB	REVISED	-
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PLOT DATE = 10/29/2021	DATE		10/22/2021	REVISED	

STATE OF ILLINOIS DEPARTMENT OF TRANSPORTATION

		F.A.U. RTE.	SECTION	COUNTY	TOTAL SHEETS	SHEET NO.
SUMMARY OF QUANTITIES		7448	09-00933-01-BR	MACON	1019	19
				CONTR	ACT NO.	95893
SHEET 15 OF 32 SHEETS STA.	TO STA.		ILLINOIS FED. A	ID PROJECT		

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							CONSTRUC	TION CODE			
CODE			TOTAL	ROADWAY	RETAINING WALL 0044	RETAINING WALL 0044	RETAINING WALL 0044	RETAINING WALL 0044	BRIDGE 0008	BUILDING DEMOLITION	HIGHWAY LIGHTING
NO.	ITEM	UNIT	TOTAL	URBAN	058-W003	058-W004	058-W006	058-W007	058-9202	URBAN	URBAN
60920054	PIPE CULVERTS TO BE CLEANED 54"	FOOT	491	491							
60920072	PIPE CULVERTS TO BE CLEANED 72"	FOOT	466	466							
63000001	STEEL PLATE BEAM GUARDRAIL, TYPE A, 6 FOOT POSTS	FOOT	12.5	12.5							
63100045	TRAFFIC BARRIER TERMINAL, TYPE 2	EACH	2	2							
63100085	TRAFFIC BARRIER TERMINAL, TYPE 6	EACH	2	2							
63100167	TRAFFIC BARRIER TERMINAL, TYPE 1 (SPECIAL) TANGENT	EACH	2	2							
63200310	GUARDRAIL REMOVAL	FOOT	1,522	1,393						129	
63700900	CONCRETE BARRIER BASE	FOOT	72	72							
66900200	NON-SPECIAL WASTE DISPOSAL	CU YD	4,565	4,565							
66900400	SPECIAL WASTE GROUNDWATER DISPOSAL	GALLON	400							400	
66900530	SOIL DISPOSAL ANALYSIS	EACH	5	5							
66901000	BACKFILL PLUGS	CU YD	180							180	
66901001	REGULATED SUBSTANCES PRE-CONSTRUCTION PLAN	L SUM	1	1							
66901003	REGULATED SUBSTANCES FINAL CONSTRUCTION REPORT	L SUM	1	1							

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345 EAST ASH AVENUE
DECATUR, IL 62526

USER NAME = Jacqueline.Ng	DESIGNED	-	LMB	REVISED	•
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PLOT SCALE = 2.0000 ' / in.	CHECKED	-	WBS	REVISED	-
 PLOT DATE = 10/29/2021	DATE	-	10/22/2021	REVISED	-

STATE OF ILLINOIS
DEPARTMENT OF TRANSPORTATION

							F.A.U. RTE.	SECTION	COUNTY	TOTAL SHEETS	SHEET NO.
	SU	MMA	ARY	OF QU	ANTITIES		7448	09-00933-01-BR	MACON	1019	20
									CONTRA	CT NO.	95893
SHEET	16	OF	32	SHEETS	STA.	TO STA.		ILLINOIS FED. AI	D PROJECT		

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				ROADWAY	RETAINING WALL	RETAINING WALL	RETAINING WALL	RETAINING WALL	BR I DGE	BUILDING DEMOLITION	HIGHWAY LIGHTING		
CODE			TOTAL	0004	0044	0044	0044	0044	0008	0044	0021		
NO.	ITEM	UNIT	TOTAL	URBAN	058-W003	058-W004	058-W006	058-W007	058-9202	URBAN	URBAN		
66901005	ENGINEERED BARRIER	SQ YD	140							140			
66901006	REGULATED SUBSTANCES MONITORING	CAL DA	30	30									
67000400	ENGINEER'S FIELD OFFICE, TYPE A	CAL MO	34	34									
0,000.00	Literature of Field Strice, The A	C/12 140	3,	<u> </u>									
67100100	MOBILIZATION	L SUM	1	1									
70103815	TRAFFIC CONTROL SURVEILLANCE	CAL DA	1,020	1,020									
70300211	TEMPORARY PAVEMENT MARKING LETTERS AND SYMBOLS - PAINT	SQ FT	32	32									
70300221	TEMPORARY PAVEMENT MARKING - LINE 4" - PAINT	FOOT	2936	2,936									
70300241	TEMPORARY PAVEMENT MARKING - LINE 6"- PAINT	FOOT	1608	1,608									
70300261	TEMPORARY PAVEMENT MARKING - LINE 12"- PAINT	FOOT	158	158									
70300281	TEMPORARY PAVEMENT MARKING - LINE 24"- PAINT	FOOT	46	46									
70306100	TEMPORARY PAVEMENT MARKING LETTERS AND SYMBOLS - TYPE	SQ FT	356	356									
	III TATE												
70306120	TEMPORARY PAVEMENT MARKING - LINE 4" - TYPE III TAPE	FOOT	122,611	122,611									
70306130	TEMPORARY PAVEMENT MARKING - LINE 6" - TYPE III TAPE	FOOT	8,862	8,862									
70306160	TEMPORARY PAVEMENT MARKING - LINE 12"- TYPE III TAPE	FOOT	8,771	8,771									

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	345 EAST ASH AVENUE DECATUR, IL 62526

USER NAME = Jacqueline.Ng	DESIGNED	-	LMB	REVISED -	-
	DRAWN	-	LMB	REVISED -	-
PLOT SCALE = 2.0000 ' / in.	CHECKED	-	WBS	REVISED .	•
PLOT DATE = 10/29/2021	DATE	-	10/22/2021	REVISED -	-

					F.A.U. RTE.	SECTION	COUNTY	TOTAL SHEETS	SHEET NO.			
		SU	MMA	IRY	OF QU	7448	09-00933-01-BR	MACON	1019	21		
							CONTRA	CT NO.	95893			
SCALE: N/A	SHEET	17	OF	32	SHEETS	STA.	TO STA.		ILLINOIS FED. A	ID PROJECT		

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CODE NO.	ITEM	UNIT	TOTAL	ROADWAY 0004 URBAN	RETAINING WALL 0044 058-W003	RETAINING WALL 0044 058-W004	RETAINING WALL 0044 058-W006	RETAINING WALL 0044 058-W007	BR I DGE 0008 058 - 9202	BUILDING DEMOLITION 0044 URBAN	HIGHWAY LIGHTING 0021 URBAN		
70306210	TEMPORARY PAVEMENT MARKING - LINE 24"- TYPE !!! TAPE	FOOT	881	881									
70300210	TEM ORAN TAVENENT MAINTING - ETNE 24 - THE TIT TATE	1001	001										
70400100	TEMPORARY CONCRETE BARRIER	FOOT	1,013	1,013									
70400125	PINNING TEMPORARY CONCRETE BARRIER	EACH	1,161	1,161									
70400200	RELOCATE TEMPORARY CONCRETE BARRIER	FOOT	3,825	3,825									
70600255	IMPACT ATTENUATORS, TEMPORARY (FULLY REDIRECTIVE, NARROW), TEST LEVEL 2	EACH	4	4									
70600322	IMPACT ATTENUATORS, RELOCATE (FULLY REDIRECTIVE, NARROW), TEST LEVEL 2	EACH	15	15									
72000100	SIGN PANEL - TYPE 1	SQ FT	447	447									
72000200	SIGN PANEL - TYPE 2	SQ FT	107	107									
72800100	TELESCOPING STEEL SIGN SUPPORT	FOOT	1,013	1,013									
73303000	OVERHEAD SIGN STRUCTURE - MONOTUBE	FOOT	91.1	91.1									
73400200	DRILLED SHAFT CONCRETE FOUNDATIONS	CU YD	14.7	14.7									
73700200	REMOVE CONCRETE FOUNDATION - GROUND MOUNT	EACH	1	1	-								
78009000	MODIFIED URETHANE PAVEMENT MARKING - LETTERS AND SYMBOLS	SQ FT	1,692	1,692									
78009004	MODIFIED URETHANE PAVEMENT MARKING - LINE 4"	FOOT	28,486	28,486									

AECOM
345 EAST ASH AVENUE
DECATUR, IL 62526

USER NAME = Jacqueline.Ng	DESIGNED	-	LMB	REVISED	-
	DRAWN	-	LMB	REVISED	•
PLOT SCALE = 2.0000 ' / in.	CHECKED	-	WBS	REVISED	-
PLOT DATE = 10/29/2021	DATE	-	10/22/2021	REVISED	-

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	SUMMARY OF QUANTITIES 72									MACON	1019	22
										CONTRA	ACT NO.	95893
 SCALE: N/A	SHEET	18	OF	32	SHEETS	STA.	TO STA.		ILLINOIS FED. A	ID PROJECT		-

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				ROADWAY	RETAINING WALL	RETAINING WALL	RETAINING WALL	RETAINING WALL	BRIDGE	BUILDING DEMOLITION	H I GHWAY L I GHT I NO
CODE NO.	ITEM	UNIT	TOTAL	0004 URBAN	0044 058-W003	0044 058-W004	0044 058-W006	0044 058-W007	0008 058-9202	0044 URBAN	0021 URBAN
NO.	1 T LIVI	ONT		0.107.111				000007	000 0202		
78009006	MODIFIED URETHANE PAVEMENT MARKING - LINE 6"	FOOT	8,201	8,201							
78009008	MODIFIED URETHANE PAVEMENT MARKING - LINE 8"	FOOT	755	755							
78009012	MODIFIED URETHANE PAVEMENT MARKING - LINE 12"	FOOT	2,572	2,572							
78009024	MODIFIED URETHANE PAVEMENT MARKING - LINE 24"	FOOT	617	617							
78100100	RAISED REFLECTIVE PAVEMENT MARKER	EACH	442	442							
78200011	BARRIER WALL REFLECTORS, TYPE C	EACH	202	202							
78200020	CURB REFLECTORS	EACH	436	436							
78300200	RAISED REFLECTIVE PAVEMENT MARKER REMOVAL	EACH	290	290							
78300201	PAVEMENT MARKING REMOVAL - GRINDING	SQ FT	1792	1,792							
78300202	PAVEMENT MARKING REMOVAL - WATER BLASTING	SQ FT	5,060	5,060							
80400100	ELECTRIC SERVICE INSTALLATION	EACH	1								1
80400200	ELECTRIC UTILITY SERVICE CONNECTION	L SUM	1								1
80500100	SERVICE INSTALLATION, TYPE A	EACH	2								2
81028350	UNDERGROUND CONDUIT, PVC, 2" DIA.	FOOT	4,387								4,387

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USER NAME = Jacqueline.Ng	DESIGNED	-	LMB	REVISED	•
	DRAWN	-	LMB	REVISED	-
PLOT SCALE == 2,0000 ' / in.	CHECKED	-	WBS	REVISED	-
PLOT DATE = 10/29/2021	DATE	-	10/22/2021	REVISED	-

STATE OF ILLINOIS
DEPARTMENT OF TRANSPORTATION

 CUMMADV OF QUANTITIES							F.A.U. RTE.	SECTION	COUNTY TOTAL SHEET NO.		
SUMMARY OF QUANTITIES							7448	09-00933-01-BR	MACON	1019	23
 									CONTRA	ACT NO.	95893
SHEET	19	OF	32	SHEETS	STA.	TO STA.		ILLINOIS FED. AII	PROJECT		

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CODE NO.	ITEM	UNIT	TOTAL	ROADWAY 0004 URBAN	RETAINING WALL 0044 058-W003	RETAINING WALL 0044 058-W004	RETAINING WALL 0044 058-W006	RETAINING WALL 0044 058-W007	BRIDGE 0008 058-9202	BUILDING DEMOLITION 0044 URBAN	HIGHWAY LIGHTING 0021 URBAN
I NO.	1 1 EM	UNII		ONDAN	030-4003	030-11004	030-4000	030-4007	030-3202	ORBAN	ONDAIN
81028370	UNDERGROUND CONDUIT, PVC, 3" DIA.	FOOT	258								258
81028390	UNDERGROUND CONDUIT, PVC, 4" DIA.	FOOT	228								228
81028400	UNDERGROUND CONDUIT, PVC, 5" DIA.	FOOT	128								128
81200230	CONDUIT EMBEDDED IN STRUCTURE, 2" DIA., PVC	FOOT	2,976								2,976
81300550	JUNCTION BOX, STAINLESS STEEL, ATTACHED TO STRUCTURE, 12" X 12" X 6"	EACH	3								3
81300720	JUNCTION BOX, STAINLESS STEEL, ATTACHED TO STRUCTURE, 16" X 12" X 8"	EACH	2								2
81400100	HANDHOLE	EACH	10								10
81400300	DOUBLE HANDHOLE	EACH	2								2
81500130	GULFBOX JUNCTION REMOVAL	EACH	8								8
81702120	ELECTRIC CABLE IN CONDUIT, 600V (XLP-TYPE USE) 1/C NO.	FOOT	35,044								35,044
82110007	LUMINAIRE, LED, ROADWAY, OUTPUT DESIGNATION G	EACH	43								43
82500350	LIGHTING CONTROLLER, BASE MOUNTED, 240VOLT, 100AMP	EACH	1								1
83008500	LIGHT POLE, ALUMINUM, 40 FT. M.H., 12 FT. MAST ARM	EACH	34								34
33050580	LIGHT POLE, ALUMINUM, 40 FT. M.H., 2-12 FT. MAST ARMS	EACH	2								2

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	345 EAST ASH AVENUE DECATUR, IL 62526

USER NAME = Jacquefine.Ng	DESIGNED	-	LMB	REVISED	-
	DRAWN	-	LMB	REVISED	
PLOT SCALE = 2.0000 ' / in.	CHECKED	-	WBS	REVISED	-
PLOT DATE = 10/29/2021	DATE	-	10/22/2021	REVISED	•

STATE OF ILLINOIS
DEPARTMENT OF TRANSPORTATION

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SCALE: N/A	SHEET	20	OF	32	SHEETS	STA.	TO STA.

F.A.U. RTE. 7448 SECTION 09-00933-01-BR

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							CONSTRUC	CTION CODE			
CODE			TOTAL	ROADWAY	RETAINING WALL 0044	RETAINING WALL 0044	RETAINING WALL 0044	RETAINING WALL 0044	BRIDGE 0008	BUILDING DEMOLITION	HIGHWAY LIGHTING 0021
NO.	ITEM	UNIT		URBAN	058-W003	058-W004	058-W006	058-W007	058-9202	URBAN	URBAN
83600300	LIGHT POLE FOUNDATION, 30" DIAMETER	FOOT	114								114
83800205	BREAKAWAY DEVICE, TRANSFORMER BASE, 15 INCH BOLT CIRCLE	EACH	19								19
85700200	FULL-ACTUATED CONTROLLER AND TYPE IV CABINET	EACH	2								2
86200200	UNINTERRUPTABLE POWER SUPPLY, STANDARD	EACH	2								2
87301225	ELECTRIC CABLE IN CONDUIT, SIGNAL NO. 14 3C	FOOT	4,409								4,409
87301245	ELECTRIC CABLE IN CONDUIT, SIGNAL NO. 14 5C	FOOT	9,066								9,066
87301805	ELECTRIC CABLE IN CONDUIT, SERVICE, NO. 6 2 C	FOOT	32								32
87301900	ELECTRIC CABLE IN CONDUIT, EQUIPMENT GROUNDING CONDUCTOR, NO. 6 1C	FOOT	1,712								1,712
87501000	TRAFFIC SIGNAL POST, 14 FT.	EACH	9								9
87600100	PEDESTRIAN PUSH-BUTTON POST, TYPE I	EACH	4								4
87700180	STEEL MAST ARM ASSEMBLY AND POLE, 28 FT.	EACH	1								1
87702930	STEEL COMBINATION MAST ARM ASSEMBLY AND POLE 40 FT.	EACH	1								1
87702940	STEEL COMBINATION MAST ARM ASSEMBLY AND POLE 42 FT.	EACH	1								1
87702950	STEEL COMBINATION MAST ARM ASSEMBLY AND POLE 44 FT.	EACH	1								1

** DENOTES NON-PARTICIPATING ITEM

% 0042

AECON
345 EAST ASH AVENUE DECATUR, IL 62526 PHONE: (217) 775-6065

USER NAME = Jacqueline.Ng	DESIGNED	-	LMB	REVISED	-
	DRAWN	-	LMB	REVISED	
PLOT SCALE = 2.0000 ' / in.	CHECKED	-	WBS	REVISED	•
PLOT DATE = 10/29/2021	DATE	-	10/22/2021	REVISED	-

STATE OF ILLINOIS
DEPARTMENT OF TRANSPORTATION

		SU	IMMA	ARY	OF QU	ANTITIES	
SCALE: N/A	SHEET	21	OF	32	SHEETS	STA.	TO STA.

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						CONSTRUC	TION CODE			
			ROADWAY	RETAINING WALL	RETAINING WALL	RETAINING WALL	RETAINING WALL	BRIDGE	BUILDING DEMOLITION	H I GHWAY L I GHT I NO
ITEM	UNIT	TOTAL	URBAN	058-W003	058-W004		058-W007		URBAN	URBAN
STEEL COMBINATION MAST ARM ASSEMBLY AND POLE 52 FT.	EACH	1								1
CONCRETE FOUNDATION, TYPE A	FOOT	27								27
CONCRETE FOUNDATION, TYPE C	FOOT	6								6
CONCRETE FOUNDATION, TYPE E 36-INCH DIAMETER	FOOT	73								73
SIGNAL HEAD, POLYCARBONATE, LED, 1-FACE, 3-SECTION, BRACKET MOUNTED	EACH	16								16
SIGNAL HEAD, POLYCARBONATE, LED, 1-FACE, 3-SECTION, MAST ARM MOUNTED	EACH	16								16
PEDESTRIAN SIGNAL HEAD, POLYCARBONATE, LED, 1-FACE, BRACKET MOUNTED WITH COUNT DOWN TIMER	EACH	12								12

TRAFFIC SIGNAL BACKPLATE, RETROREFLECTIVE	EACH	16								16
PEDESTRIAN PUSH-BUTTON	EACH	12								12
TEMPORARY TRAFFIC SIGNAL INSTALLATION	EACH	2								2
REMOVE ELECTRIC CABLE FROM CONDUIT	FOOT	11,684								11,684
REMOVE EXISTING TRAFFIC SIGNAL EQUIPMENT	EACH	1								1
REMOVE EXISTING HANDHOLE	EACH	2								2
REMOVE EXISTING DOUBLE HANDHOLE	EACH	7								7
	CONCRETE FOUNDATION, TYPE A CONCRETE FOUNDATION, TYPE C CONCRETE FOUNDATION, TYPE E 36-INCH DIAMETER SIGNAL HEAD, POLYCARBONATE, LED, 1-FACE, 3-SECTION, BRACKET MOUNTED SIGNAL HEAD, POLYCARBONATE, LED, 1-FACE, 3-SECTION, MAST ARM MOUNTED PEDESTRIAN SIGNAL HEAD, POLYCARBONATE, LED, 1-FACE, BRACKET MOUNTED WITH COUNT DOWN TIMER TRAFFIC SIGNAL BACKPLATE, RETROREFLECTIVE PEDESTRIAN PUSH-BUTTON TEMPORARY TRAFFIC SIGNAL INSTALLATION REMOVE ELECTRIC CABLE FROM CONDUIT REMOVE EXISTING TRAFFIC SIGNAL EQUIPMENT REMOVE EXISTING TRAFFIC SIGNAL EQUIPMENT	STEEL COMBINATION MAST ARM ASSEMBLY AND POLE 52 FT. EACH CONCRETE FOUNDATION, TYPE A CONCRETE FOUNDATION, TYPE C CONCRETE FOUNDATION, TYPE E 36-INCH DIAMETER FOOT SIGNAL HEAD, POLYCARBONATE, LED, 1-FACE, 3-SECTION, EACH SIGNAL HEAD, POLYCARBONATE, LED, 1-FACE, 3-SECTION, EACH SIGNAL HEAD, POLYCARBONATE, LED, 1-FACE, 3-SECTION, EACH PEDESTRIAN SIGNAL HEAD, POLYCARBONATE, LED, 1-FACE, EACH TRAFFIC SIGNAL BACKPLATE, RETROREFLECTIVE EACH TRAFFIC SIGNAL BACKPLATE, RETROREFLECTIVE EACH TEMPORARY TRAFFIC SIGNAL INSTALLATION EACH REMOVE ELECTRIC CABLE FROM CONDUIT FOOT REMOVE EXISTING TRAFFIC SIGNAL EQUIPMENT EACH REMOVE EXISTING HANDHOLE EACH	STEEL COMBINATION MAST ARM ASSEMBLY AND POLE 52 FT. EACH 1 CONCRETE FOUNDATION, TYPE A FOOT 27 CONCRETE FOUNDATION, TYPE C FOOT 6 CONCRETE FOUNDATION, TYPE E 36-INCH DIAMETER FOOT 73 SIGNAL HEAD, POLYCARBONATE, LED, 1-FACE, 3-SECTION, EACH 16 SIGNAL HEAD, POLYCARBONATE, LED, 1-FACE, 3-SECTION, EACH 16 SIGNAL HEAD, POLYCARBONATE, LED, 1-FACE, 3-SECTION, EACH 16 PEDESTRIAN SIGNAL HEAD, POLYCARBONATE, LED, 1-FACE, EACH 12 TRAFFIC SIGNAL BACKPLATE, RETROREFLECTIVE EACH 16 PEDESTRIAN PUSH-BUTTON EACH 12 REMOVE ELECTRIC CABLE FROM CONDUIT FOOT 11,684 REMOVE ELECTRIC CABLE FROM CONDUIT EACH 1 REMOVE EXISTING TRAFFIC SIGNAL EQUIPMENT EACH 1 REMOVE EXISTING TRAFFIC SIGNAL EQUIPMENT EACH 2	TOTAL UNIT TOTAL UNIT TOTAL UNIT TOTAL UNIT 0004 URBAN STEEL COMBINATION MAST ARM ASSEMBLY AND POLE 52 FT. EACH 1 CONCRETE FOUNDATION, TYPE A FOOT 27 CONCRETE FOUNDATION, TYPE C FOOT 6 CONCRETE FOUNDATION, TYPE E 36-INCH DIAMETER FOOT 73 SIGNAL HEAD, POLYCARBONATE, LED, 1-FACE, 3-SECTION, EACH 16 SIGNAL HEAD, POLYCARBONATE, LED, 1-FACE, 3-SECTION, EACH 16 PEDESTRIAN SIGNAL HEAD, POLYCARBONATE, LED, 1-FACE, EACH 12 TRAFFIC SIGNAL BACKPLATE, RETROREFLECTIVE EACH 16 TRAFFIC SIGNAL BACKPLATE, RETROREFLECTIVE EACH 12 TEMPORARY TRAFFIC SIGNAL INSTALLATION EACH 2 REMOVE ELECTRIC CABLE FROM CONDUIT FOOT 11,684 REMOVE EXISTING TRAFFIC SIGNAL EQUIPMENT EACH 2	TOTAL NO.04	TOTAL WALL WALL WALL O. 0.004 0.004 0.00	TOTAL TOTAL ROADWAY RETAINING RETAIN	RECAINING SETAINING SETAIN

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	345 EAST ASH AVENUE DECATUR, IL 62526

USER NAME = Jacqueline.Ng	DESIGNED	-	LMB	REVISED	-
	DRAWN	-	LM8	REVISED	-
PLOT SCALE = 2.0000 ' / in.	CHECKED	-	WBS	REVISED	-
PLOT DATE == 10/29/2021	DATE	-	10/22/2021	REVISED	-

					F.A.U. RTE.	SECTION	COUNTY	TOTAL SHEETS	SHEET NO.			
SUMMARY OF QUANTITIES									09-00933-01-BR	MACON	1019	26
										CONTRA	ACT NO.	95893
SCALE: N/A	SHEET	22	OF	32	SHEETS	STA.	TO STA.		ILLINOIS FED.	AID PROJECT		

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ITEM G CONCRETE FOUNDATION T DRIVEWAY PAVEMENT, 4" T DRIVEWAY PAVEMENT REMOVAL AL NO. 1 AL NO. 2 AL NO. 3	UNIT EACH SQ YD SQ YD L SUM L SUM	TOTAL 11 1,366 914 1 1	ROADWAY 0004 URBAN 1,366 914	RETAINING WALL 0044 058-W003	RETAINING WALL 0044 058-W004	RETAINING WALL 0044 058-W006	RETAINING WALL 0044 058-W007	BRIDGE 0008 058-9202	BUILDING DEMOLITION 0044 URBAN	HIGHWAY LIGHTING 0021 URBAN
G CONCRETE FOUNDATION T DRIVEWAY PAVEMENT, 4" T DRIVEWAY PAVEMENT REMOVAL AL NO. 1 AL NO. 2 AL NO. 3	EACH SQ YD SQ YD L SUM L SUM	1,366	1,366		030-4004	030-#000		030-3202	1	
T DRIVEWAY PAVEMENT, 4" T DRIVEWAY PAVEMENT REMOVAL AL NO. 1 AL NO. 2 AL NO. 3	SQ YD SQ YD L SUM	1,366								11
T DRIVEWAY PAVEMENT REMOVAL AL NO. 1 AL NO. 2 AL NO. 3	SQ YD L SUM L SUM	914								
AL NO. 2 AL NO. 3	L SUM	1	914							
AL NO. 2 AL NO. 3	L SUM	1								
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AL NO. 4									1	
	L SUM	1							1	
AL NO. 5	L SUM	1							1	
AL NO. 6	L SUM	1							1	
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	34S EAST ASH AVENUE DECATUR, IL 62526

USER NAME = Jacqueline,Ng	DESIGNED	-	LMB	REVISED	-
	DRAWN	-	LMB	REVISED	-
PLOT SCALE = 2.0000 ' / in.	CHECKED	-	WBS	REVISED	-
PLOT DATE = 10/29/2021	DATE	-	10/22/2021	REVISED	-
	PLOT SCALE = 2.0000 ' / in.	DRAWN PLOT SCALE = 2.0000 ' / in. CHECKED	DRAWN - PLOT SCALE = 2,0000 ' / in. CHECKED -	DRAWN - LMB PLOT SCALE = 2.0000 ' / in. CHECKED - WBS	DRAWN - LMB REVISED

STATE OF ILLINOIS
DEPARTMENT OF TRANSPORTATION

		su	MMA	RY	OF QU	ANTITIES	S
SCALE: N/A	SHEET	23	OF	32	SHEETS	STA.	TO STA.

					RETAINING	RETAINING	RETAINING	RETAINING		BUILDING	H I GHWAY
				ROADWAY	WALL	WALL	WALL	WALL	BR I DGE	DEMOLITION	LIGHTING
CODE			TOTAL	0004	0044	0044	0044	0044	0008	0044	0021
NO.	ITEM	UNIT		URBAN	058-W003	058-W004	058-W006	058-W007	058-9202	URBAN	URBAN
Z0015500	DEBRIS REMOVAL	L SUM	1							1	
**Z0018500	DRAINAGE STRUCTURES TO BE CLEANED	EACH	63	63							
Z0022800	FENCE REMOVAL	FOOT	1,523							1,523	
Z0023400	FILLING EXISTING CISTERNS	EACH	1							1	
Z0023800	FILLING EXISTING SEPTIC TANK	EACH	8							8	
Z0023900	FILLING EXISTING WELLS	EACH	6							6	
Z0030850	TEMPORARY INFORMATION SIGNING	SQ FT	1,146	1,146							
* 20033020	LUMINAIRE SAFETY CABLE ASSEMBLY	EACH	43								43
* Z0033052	COMMUNICATIONS VAULT	EACH	3	3							
* Z0036200	PAINT CURB	FOOT	2,077	2,077							
* Z0045100	PRESSURE CONNECTION 12" X 12"	EACH	1	1							
* Z0045300	PRESSURE CONNECTION 16" X 6"	EACH	1	1							
* Z0045400	PRESSURE CONNECTION 16" X 16"	EACH	1	1							
≵ Z0045812	PRESSURE CONNECTION 24" X 24"	EACH	2	2							

** DENOTES NON-PARTICIPATING ITEM

% 0042



USER NAME = Jacqueline.Ng	DESIGNED	-	LMB	REVISED	-
	DRAWN	-	LMB	REVISED	•
PLOT SCALE = 2.0000 ' / in.	CHECKED	-	WBS	REVISED	-
PLOT DATE = 10/29/2021	DATE	-	10/22/2021	REVISED	-

STATE OF ILLINOIS
DEPARTMENT OF TRANSPORTATION

								F.A.U. RTE.	SECTION	COUNTY	TOTAL SHEETS	SHEET NO.
		SU	MMA	RY	OF QUA	ANTITIES		7448	09-00933-01-BR	MACON	1019	28
										CONTRA	ACT NO.	95893
CALE: N/A	SHEET	24	OF	32	SHEETS	STA.	TO STA.		ILLINOIS FED. AI	D PROJECT		

CONSTRUCTION CODE

MODEL: Default

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							CONSTRUC	TION CODE			
CODE	I.T.F.M.	UNIT	TOTAL	ROADWAY 0004 URBAN	RETAINING WALL 0044 058-W003	RETAINING WALL 0044 058-W004	RETAINING WALL 0044 058-W006	RETAINING WALL 0044 058-W007	BR I DGE 0008 058 - 9202	BUILDING DEMOLITION 0044 URBAN	HIGHWAY LIGHTING 0021 URBAN
NO.	ITEM	UNIT		UKDAN	038-W003	038-W004	038-W006	038-W007	038-9202	UKBAN	URDAN
Z0048665	RAILROAD PROTECTIVE LIABILITY INSURANCE	L SUM	1	1							
Z0049799	PROTECTING OR RESETTING SURVEY MARKERS	EACH	1	1							
Z0049902	REMOVAL AND DISPOSAL OF NON-FRIABLE ASBESTOS, BUILDING NO. 2	L SUM	1							1	
Z0049903	REMOVAL AND DISPOSAL OF NON-FRIABLE ASBESTOS, BUILDING NO. 3	L SUM	1							1	
Z0049904	REMOVAL AND DISPOSAL OF NON-FRIABLE ASBESTOS, BUILDING NO. 4	L SUM	1							1	
Z0056668	STORM SEWERS, TYPE 2, WATER MAIN QUALITY PIPE, 12"	FOOT	668	668							
Z0056669	STORM SEWERS, TYPE 2, WATER MAIN QUALITY PIPE, 15"	FOOT	270	270							
Z0056670	STORM SEWERS, TYPE 2, WATER MAIN QUALITY PIPE, 18"	FOOT	244	244							
Z0056672	STORM SEWERS, TYPE 2, WATER MAIN QUALITY PIPE, 24"	FOOT	429	429							
Z0056678	STORM SEWERS, TYPE 2, WATER MAIN QUALITY PIPE, 36"	FOOT	92	92							
Z0056696	STORM SEWERS, TYPE 3, WATER MAIN QUALITY PIPE, 42"	FOOT	121	121							
Z0062456	TEMPORARY PAVEMENT	SQ YD	2,568	2,568							
Z0064600	SELECTIVE CLEARING	ACRE	2.00							2.00	
Z0068200	STEEL CASINGS 30"	FOOT	50	50							

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	345 EAST A	ASH AV	6	_	_		

USER NAME = Jacqueline.Ng	DESIGNED	-	LMB	REVISED	-
!	DRAWN	-	LMB	REVISED	-
PLOT SCALE = 2.0000 ' / in.	CHECKED	-	WBS	REVISED	-
PLOT DATE = 10/29/2021	DATE	-	10/22/2021	REVISED	-

							F.A.U. RTE.	SECT	ION		COUNTY	TOTAL SHEETS	SHEET NO.
	S	MMU	ARY	OF QU	ANTITIES		7448	09-00933	3-01-BR		MACON	1019	29
				***************************************							CONTR	ACT NO.	95893
SCALE: N/A	SHEET 25	OF	32	SHEETS	STA.	TO STA.			ILLINOIS	FED. AID PR	OJECT		

				ROADWAY	RETAINING WALL	RETAINING WALL	RETAINING WALL	RETAINING WALL	BRIDGE
CODE			TOTAL	0004	0044	0044	0044	0044	0008
NO.	ITEM	UNIT		URBAN	058-W003	058-W004	058-W006	058-W007	058-9202
Z0068410	STEEL CASINGS 48"	FOOT	94	94					
70070202	SURVEY MARKER VAULT	EACH	1	1					
20070202	JOHNET MAINEN VACET	LACIT	1	:					
Z0073510	TEMPORARY TRAFFIC SIGNAL TIMING	EACH	2						
Z0076600	TRAINEES	HOUR	2.000	2 ,000					
Z0076604	TRAINEES TRAINING PROGRAM GRADUATE	HOUR	2,000	2 ,000					
Z0077803	REMOVE WOOD POST	EACH	7	7					
X0100026	SPECIAL EXCAVATION	CU YD	28	28					
X0300558	SANITARY SEWER REMOVAL AND REPLACEMENT 8"	FOOT	390	390					
X0301797	GATE REMOVAL	EACH	11						
X0322463	CONNECTION TO EXISTING SEWER	EACH	3	3				:	
X0322791	FILL EXISTING SANITARY SEWERS	CU YD	4	4					
X0322917	PROPOSED STORM SEWER CONNECTION TO EXISTING MANHOLE	EACH	5	5					
		2.13.1							
X0322918	PROPOSED MANHOLE/CATCH BASIN CONNECTION OVER EXISTING STORM SEWER	EACH	5	5					
X0324636	WATER VALVE BOXES TO BE ABANDONED	EACH	9	9					
7.0327030	THE TOTAL TO BE ADMINISTRATED	57011							

** DENOTES NON-PARTICIPATING ITEM

% 0042

AECOM

345 EAST ASM AVENUE
DECATUR. II: 62526

USER NAME = Jacqueline.Ng	DESIGNED	-	LMB	REVISED	•
	DRAWN	-	LMB	REVISED	•
PLOT SCALE = 2.0000 ' / in.	CHECKED	-	WBS	REVISED	•
PLOT DATE = 10/29/2021	DATE	-	10/22/2021	REVISED	-

STATE OF ILLINOIS
DEPARTMENT OF TRANSPORTATION

						F.A.U. RTE.	SECTION		COUNTY	SHEETS	NO.		
		SU	MMA	RY	OF QUA	ANTITIES		7448	09-00933-01-BR		MACON	1019	30
											CONTRA	CT NO.	95893
SCALE: N/A	SHEET	26	OF	32	SHEETS	STA.	TO STA.		ILLINOIS	FED. All) PROJECT		

CONSTRUCTION CODE

BUILDING DEMOLITION

0044

URBAN

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HIGHWAY LIGHTING

> 0021 URBAN

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CODE NO.	ITEM	UNIT	TOTAL	ROADWAY 0004 URBAN	RETAINING WALL 0044 058-W003	RETAINING WALL 0044 058-W004	RETAINING WALL 0044 058-W006	RETAINING WALL 0044 058-W007	BR I DGE 0008 058 - 9202	BUILDING DEMOLITION 0044 URBAN	HIGHWAY LIGHTING 0021 URBAN
.,	· · · · · · · · · · · · · · · · · · ·	011.2									
X0325207	TELEVISION INSPECTION OF SEWER	FOOT	8,285	8,285							
X0325318	LIGHTWEIGHT CELLULAR CONCRETE FILL	CU YD	39,821		18,134	21,687					
X0327000	TEMPORARY CONNECTION TO EXISTING STORM SEWER	EACH	6	6							
X0327024	FIRE HYDRANTS TO BE REMOVED AND SALVAGED	EACH	5	5							
X0327547	ABANDON EXISTING UTILITIES	L SUM	1							1	
X0327645	TEMPORARY SOIL RETENTION SYSTEM (SPECIAL)	SQ FT	8,670	3,364	1,200	4,046			60		
X0327902	MAILBOX REMOVE AND REPLACE	EACH	4	4				!			
X1200015	VALVE VAULTS TO BE ABANDONED	EACH	3	3							
X1200221	NON-PRESSURE CONNECTION TO EXISTING WATER MAIN	EACH	5	5							
X1200246	WATERMAIN CASING PIPE	FOOT	255	255							
X1200252	GATE VALVE 18" WITH VAULT, 5' DIAMETER	EACH	1	1							
X1200253	WATERMAIN IN CASING PIPE, DUCTILE IRON, 16"	FOOT	50	50							
X1200257	WATERMAIN IN CASING PIPE, DUCTILE IRON, 24"	FOOT	255	255							
X1200260	WATERMAIN IN CASING PIPE, DUCTILE IRON, 30"	FOOT	94	94							

"	AECOM
	345 EAST ASH AVENUE DECATUR, IL 62526

USER NAME = Jacqueline.Ng	DESIGNED	-	LMB	REVISED	-
	DRAWN	-	LMB	REVISED	-
PLOT SCALE = 2.0000 ' / in.	CHECKED	-	WBS	REVISED	-
PLOT DATE = 10/29/2021	DATE	-	10/22/2021	REVISED	-

		F.A.U. RTE.	SECTION	COUNTY	COUNTY TOTAL SH				
	SUMMA	7448	09-00933-01-BR	MACON	1019	31			
	***************************************			CONTR	CONTRACT NO. 9589				
SCALE: N/A	SHEET 27 OF	32 SHEETS	STA.	TO STA.		ILLINOIS FEI	D. AID PROJECT		

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			CONSTRUCTION CODE								
CODE NO.	ITEM	UNIT	TOTAL	ROADWAY 0004 URBAN	RETAINING WALL 0044 058-W003	RETAINING WALL 0044 058-W004	RETAINING WALL 0044 058-W006	RETAINING WALL 0044 058-W007	BRIDGE 0008 058-9202	BUILDING DEMOLITION 0044 URBAN	HIGHWAY LIGHTING 0021 URBAN
										- Allen and a second a second and a second a	
X1400251	STEEL LUMINAIRE MAST ARM ASSEMBLY 15 FT.	EACH	1								1
K1400399	VIDEO DETECTION SYSTEM COMPLETE	EACH	2								2
X1700036	CONCRETE BARRIER BASE (SPECIAL NO. 1)	FOOT	497	497							
X1700072	CONCRETE BARRIER , VERTICAL FACE (SPECIAL)	FOOT	28	28							
X1700073	CONCRETE BARRIER WALL (SPECIAL NO. 1)	FOOT	497	497							
(2010400	STUMP REMOVAL ONLY	UNIT	60	60							
X2130010	EXPLORATION TRENCH, SPECIAL	FOOT	250	250							
(4240430	PORTLAND CEMENT CONCRETE SIDEWALK 5 INCH, SPECIAL	SQ FT	6,432		532	5,900					
X4402400	CURB REMOVAL (SPECIAL)	FOOT	138	138		15.111.15					
(4404700	SIDEWALK REMOVAL (SPECIAL)	SQ FT	2,969	2,969							
X5400504	PRECAST CONCRETE BOX CULVERTS 2' X 2' (SPECIAL)	FOOT	22	22							
(550A562	TEMPORARY STORM SEWERS, CLASS A, TYPE 2 12"	FOOT	225	225							
(5509900	ABANDON AND FILL EXISTING STORM SEWER	FOOT	874	874							
X5510100	STORM SEWER REMOVAL	FOOT	7,016	7,016							

** DENOTES NON-PARTICIPATING ITEM

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,	AECOM
	345 EAST ASH AVENUE
	DECATUR, IL 62526
	DHONE: /7171 775-6065

USER NAME = Jacqueline.Ng	DESIGNED - LMB	REVISED -
	DRAWN - LMB	REVISED -
PLOT SCALE = 2.0000 ' / in.	CHECKED - WBS	REVISED -
PLOT DATE = 10/29/2021	DATE - 10/22/2021	REVISED -

										SECTION	COUNTY	SHEETS	NO.		
		SUMMARY OF QUANTITIES									MACON	1019	32		
											CONTRA	CONTRACT NO. 95893			
ı	SCALE: N/A	SHEET	28	OF	32	SHEETS	STA.	TO STA.	ILLINOIS FED. AID PROJECT						

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				CONSTRUCTION CODE							
				ROADWAY	RETAINING WALL	RETAINING WALL	RETAINING WALL	RETAINING WALL	BR I DGE	BUILDING DEMOLITION	HIGHWAY LIGHTING
CODE			TOTAL	0004	0044	0044	0044	0044	0008	0044	0021
NO.	ITEM	UNIT		URBAN	058-W003	058-W004	058-W006	058-W007	058-9202	URBAN	URBAN
X5520040	STORM SEWERS JACKED IN PLACE, 15" (SPECIAL)	FOOT	103	103							
X5520090	STORM SEWERS JACKED IN PLACE, 24" (SPECIAL)	FOOT	50	50							
X5537800	STORM SEWERS TO BE CLEANED 12"	FOOT	783	783							
X5537900	STORM SEWERS TO BE CLEANED 15"	FOOT	416	416							
X5538000	STORM SEWERS TO BE CLEANED 18"	FOOT	728	728							
X5538200	STORM SEWERS TO BE CLEANED 24"	FOOT	1,537	1,537							
X5538600	STORM SEWERS TO BE CLEANED 36"	FOOT	707	707							
X5538700	STORM SEWERS TO BE CLEANED 42"	FOOT	309	309							
X5538800	STORM SEWERS TO BE CLEANED 48"	FOOT	1,596	1,596							
X5610004	DUCTILE IRON WATER MAIN FITTINGS	POUND	32,500	32,500							
X5610656	WATER MAIN TO BE ABANDONED, 6"	FOOT	387	387							
X5610658	WATER MAIN TO BE ABANDONED, 8"	FOOT	55	55							
X5610662	WATER MAIN TO BE ABANDONED, 12"	FOOT	925	925							
VEC10000	WATER MAIN TO BE ABANDONED, 16"	FOOT	756	756							

"	AECO	M	
	345 EAST ASH AVENUE DECATUR, IL 62526 PHONE: (217) 775-6065		

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PLOT DATE = 10/29/2021	DATE -		10/22/2021	REVISED	_

٦						F.A.U. RTE.	SECTION	N COUNTY S		SHEET NO.		
	SUMMARY OF QUANTITIES								7448 09-00933-01-BR		1019	33
							CONTRACT NO. 95893					
ı	SCALE: N/A	SHEET 29	OF	32	SHEETS	STA.	TO STA.		ILLINOIS FED. A	ID PROJECT		

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				CONSTRUCTION CODE								
CODE NO .	ITEM	UNIT	TOTAL	ROADWAY 0004 URBAN	RETAINING WALL 0044 058-W003	RETAINING WALL 0044 058-W004	RETAINING WALL 0044 058-W006	RETAINING WALL 0044 058-W007	BRIDGE 0008 058-9202	BUILDING DEMOLITION 0044 URBAN	HIGHWAY LIGHTING 0021 URBAN	
		OWI										
X5610674	WATER MAIN TO BE ABANDONED, 24"	FOOT	2,335	2,335								
X5610700	WATER MAIN REMOVAL	FOOT	650	650								
X5610746	WATER MAIN LINE STOP 6"	EACH	1	1								
X5610748	WATER MAIN LINE STOP 8"	EACH	1	1								
X5610752	WATER MAIN LINE STOP 12"	EACH	1	1								
X5610756	WATER MAIN LINE STOP 16"	EACH	1	1								
X5610764	WATER MAIN LINE STOP 24"	EACH	1	1								
X5620110	WATER SERVICE LINE RELOCATED	FOOT	20	20								
X5632000	ABANDON EXISTING FORCE MAIN, FILL WITH CLSM	FOOT	1,775	1,775								
X5930100	CONTROLLED LOW-STRENGTH MATERIAL, SPECIAL	CU YD	188.4	188.4								
X6011605	PIPE DRAINS 4" (SPECIAL)	FOOT	160	160								
X6020075	INLETS, TYPE B, TYPE 3V FRAME AND GRATE	EACH	10	10								
X6020296	MANHOLES, TYPE A, 8'-DIAMETER, WITH SPECIAL FRAME AND GRATE	EACH	5	5								
X6022712	CATCH BASINS, TYPE A, 4'-DIAMETER, WITH SPECIAL FRAME AND GRATE	EACH	7	7								

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11	AECON
	345 EAST ASH AVENUE DECATUR, IL 62526 PHONE: (217) 775-6065

USER NAME = Jacqueline,Ng	DESIGNED	-	LMB	REVISED	-
	DRAWN	-	LMB	REVISED	-
PLOT SCALE = 2.0000 ' / in.	CHECKED	-	WBS	REVISED	-
PLOT DATE = 10/29/2021	DATE	-	10/22/2021	REVISED	-

					RTE.	SECTION	COUNTY	SHEETS	NO.			
		SU	MMA	\RY	OF QU	ANTITIES	5	7448	09-00933-01-BR	MACON	1019	34
										CONTRA	ACT NO.	95893
SCALE: N/A	SHEET	30	OF	32	SHEETS	STA.	TO STA.		ILLINOIS FED. A	D PROJECT		

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				CONSTRUCTION CODE								
CODE			TOTAL	ROADWAY	RETAINING WALL	RETAINING WALL	RETAINING WALL	RETAINING WALL	BR I DGE 0008	BUILDING DEMOLITION 0044	HIGHWAY LIGHTING 0021	
NO.	ITEM	UNIT		URBAN	058-W003	058-W004	058-W006	058-W007	058-9202	URBAN	URBAN	
X6022810	MANHOLES, SANITARY, 4'-DIAMETER, TYPE 1 FRAME, CLOSED LID	EACH	2	2								
X6023508	INLETS, TYPE A, WITH SPECIAL FRAME AND GRATE	EACH	4	4								
X6024875	TEMPORARY INLET	EACH	3	3								
X6025300	CATCH BASINS TO BE ADJUSTED (SPECIAL)	EACH	2	2								
X6026050	SANITARY MANHOLES TO BE ADJUSTED	EACH	2	2								
X6026054	SANITARY MANHOLES TO BE REMOVED	EACH	3	3								
X6026057	SANITARY MANHOLES TO BE RECONSTRUCTED WITH NEW TYPE 1 FRAME, CLOSED LID	EACH	3	3								
X6026623	VALVE BOX	EACH	17	17								
X6026627	VAULTS TO BE REMOVED	EACH	1	1								
X6026632	VALVE BOXES TO BE REMOVED	EACH	3	3								
X6029510	CATCH BASINS, TYPE C, WITH SPECIAL FRAME AND GRATE	EACH	4	4								
X6060500	CORRUGATED MEDIAN REMOVAL	SQ FT	4,328	4,328								
X6090505	CONCRETE THRUST BLOCKS (SPECIAL)	EACH	54	54								
X6640200	TEMPORARY CHAIN LINK FENCE	FOOT	1,290	752						538		

** DENOTES NON-PARTICIPATING ITEM

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п	AECOM
	345 EAST ASH AVENUE DECATUR, IL 62526

USER NAME = Jacqueline.Ng	DESIGNED	-	LMB	REVISED	-
	DRAWN	-	LMB	REVISED	-
PLOT SCALE = 2.0000 ' / in.	CHECKED	-	WBS	REVISED	-
PLOT DATE = 10/29/2021	DATE	-	10/22/2021	REVISED	-

								RTE.	SECTION	COUNTY	SHEETS	NO.
		SU	JMM/	ARY	OF QU	ANTITIES		7448	09-00933-01-BR	MACON	1019	35
								CONTRACT NO. 95893				
SCALE: N/A	SHEET	31	OF	32	SHEETS	STA.	TO STA.		ILLINOIS FED. AI	D PROJECT		

				CONSTRUCTION CODE								
CODE NO,	ITEM	UNIT	TOTAL	ROADWAY 0004 URBAN	RETAINING WALL 0044 058-W003	RETAINING WALL 0044 058-W004	RETAINING WALL 0044 058-W006	RETAINING WALL 0044 058-W007	BR I DGE 0008 058 - 9202	BUILDING DEMOLITION 0044 URBAN	HIGHWAY LIGHTING 0021 URBAN	
X6640300	CHAIN LINK FENCE REMOVAL	F00T	1 702	1 700								
X0040300	CHAIN LINK FENCE REMOVAL	FOOT	1,782	1,782								
* X6640535	CHAIN LINK FENCE, 6' ATTACHED TO STRUCTURE	FOOT	490					490				
X7010216	TRAFFIC CONTROL AND PROTECTION, (SPECIAL)	L SUM	1	1								
X7010238	CHANGEABLE MESSAGE SIGN, SPECIAL	CAL MO	170	170								
70300150	SHORT TERM PAVEMENT MARKING REMOVAL	SQ FT	58,255	58,255								
* X7240300	SIGN REMOVAL	EACH	34								34	
* X8108242	UNDERGROUND CONDUIT, HDPE, 4" DIA.	FOOT	505	505								
* X8108244	UNDERGROUND CONDUIT, HDPE, 4" DIA., SCHEDULE 80	FOOT	179	179								
* X8250510	LIGHTING CONTROLLER FOUNDATION	EACH	1								1	
* X8870300	EMERGENCY VEHICLE PRIORITY SYSTEM	EACH	2								2	
* XX004689	SANITARY SERVICE TO BE ADJUSTED	EA	1	1								
* XX008829	REMOVAL AND DISPOSAL OF EXISTING FORCE MAIN	FOOT	40	40								
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** DENOTES NON-PARTICIPATING ITEM


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AECOM

345 EAST ASH AVENUE
DECATUR. II. 62526

USER NAME = Jacqueline.Ng	DESIGNED	-	LMB	REVISED	-
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PLOT SCALE = 2.0000 ' / in.	CHECKED	-	WBS	REVISED	-
PLOT DATE = 10/29/2021	DATE	-	10/22/2021	REVISED	-

	SUMMARY OF QUANTITIES								F.A.U. RTE.	SECTION	COUNTY	TOTAL	SHEET NO.
									7448	09-00933-01-BR	MACON	1019	36
										CONTRACT NO. 95893			
	SCALE: N/A	SHEET	32	OF	32	SHEETS	STA.	TO STA.		ILLINOIS FED. AID PROJECT			

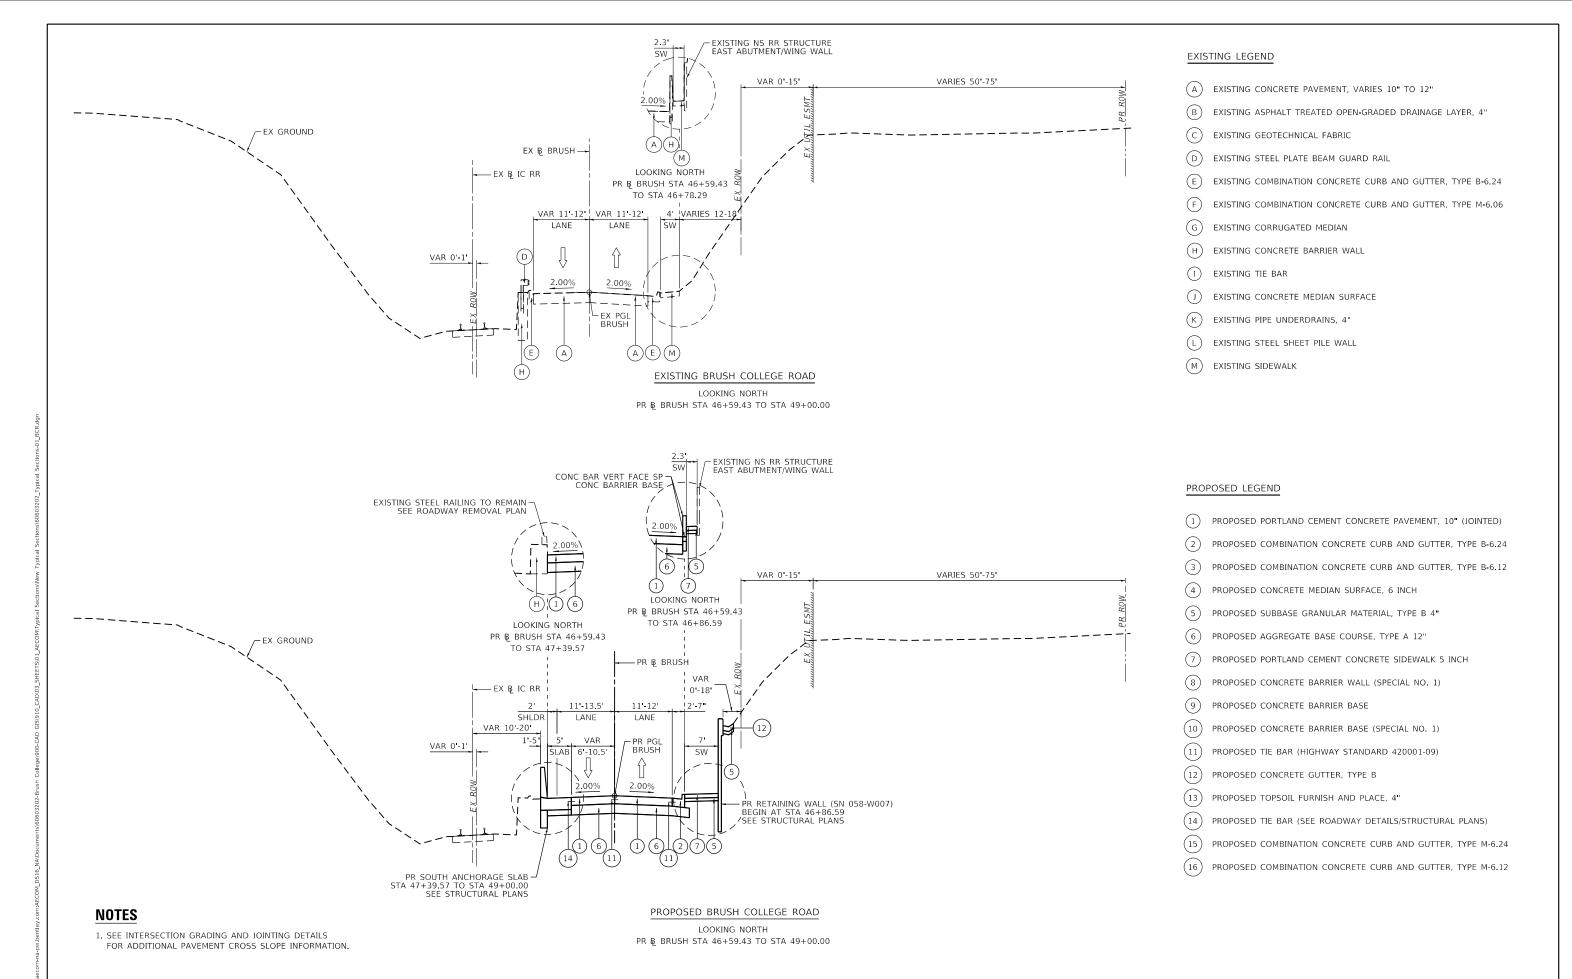


AECOM245 EAST ASH AVENUE
DECATUR, II. 67236
PHONE: (217) 775-6065

 USER NAME
 = mawhinneyk
 DESIGNED
 LMB
 REVISED

 PLOT SCALE
 = 20.0000 ' / in.
 CHECKED
 WBS
 REVISED

 PLOT DATE
 = 2021-04-30
 DATE
 4/30/2021
 REVISED

STATE OF ILLINOIS DEPARTMENT OF TRANSPORTATION

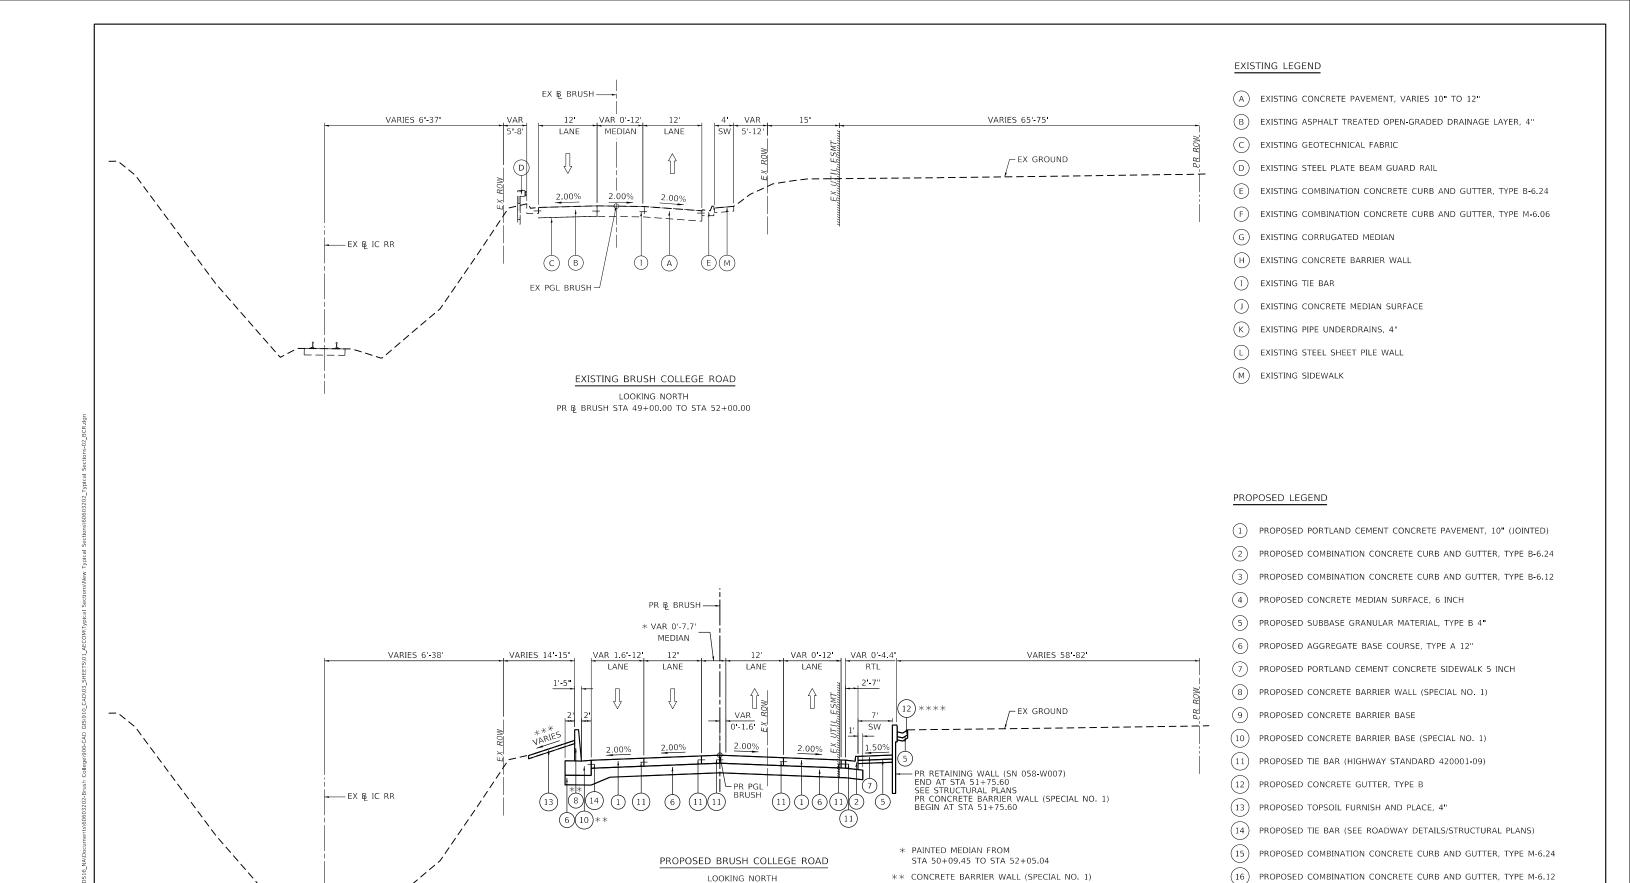

SER NAME = elif.ulger DESIGNED -REVISED DRAWN LMB REVISED OT SCALE = 20.0000 ' / in. HECKED REVISED LOT DATE = 4/27/2021 REVISED 4/30/2021

STATE OF ILLINOIS **DEPARTMENT OF TRANSPORTATION**

PR & BRUSH STA 49+00.00 TO STA 52+00.00

AND CONCRTE BARRIER BASE (SPECIAL NO. 1)

FROM STA 49+00.07 TO STA 51+99.97 *** SEE BRUSH COLLEGE ROAD CROSS SECTION

**** PR CONCRETE GUTTER, TYPE B

STA 46+86.59 TO STA 51+75.41

SHEETS FOR SLOPE GRADING INFORMATION


SECTION COUNTY 7448 09-00933-01-BR MACON 1019 38 CONTRACT NO. 95893

BRUSH COLLEGE ROAD TYPICAL SECTIONS SCALE: 1"=10' SHEET 2 OF 18 SHEETS STA. 49+00.00 TO STA. 52+00.00

NOTES

1. SEE INTERSECTION GRADING AND JOINTING DETAILS

FOR ADDITIONAL PAVEMENT CROSS SLOPE INFORMATION.

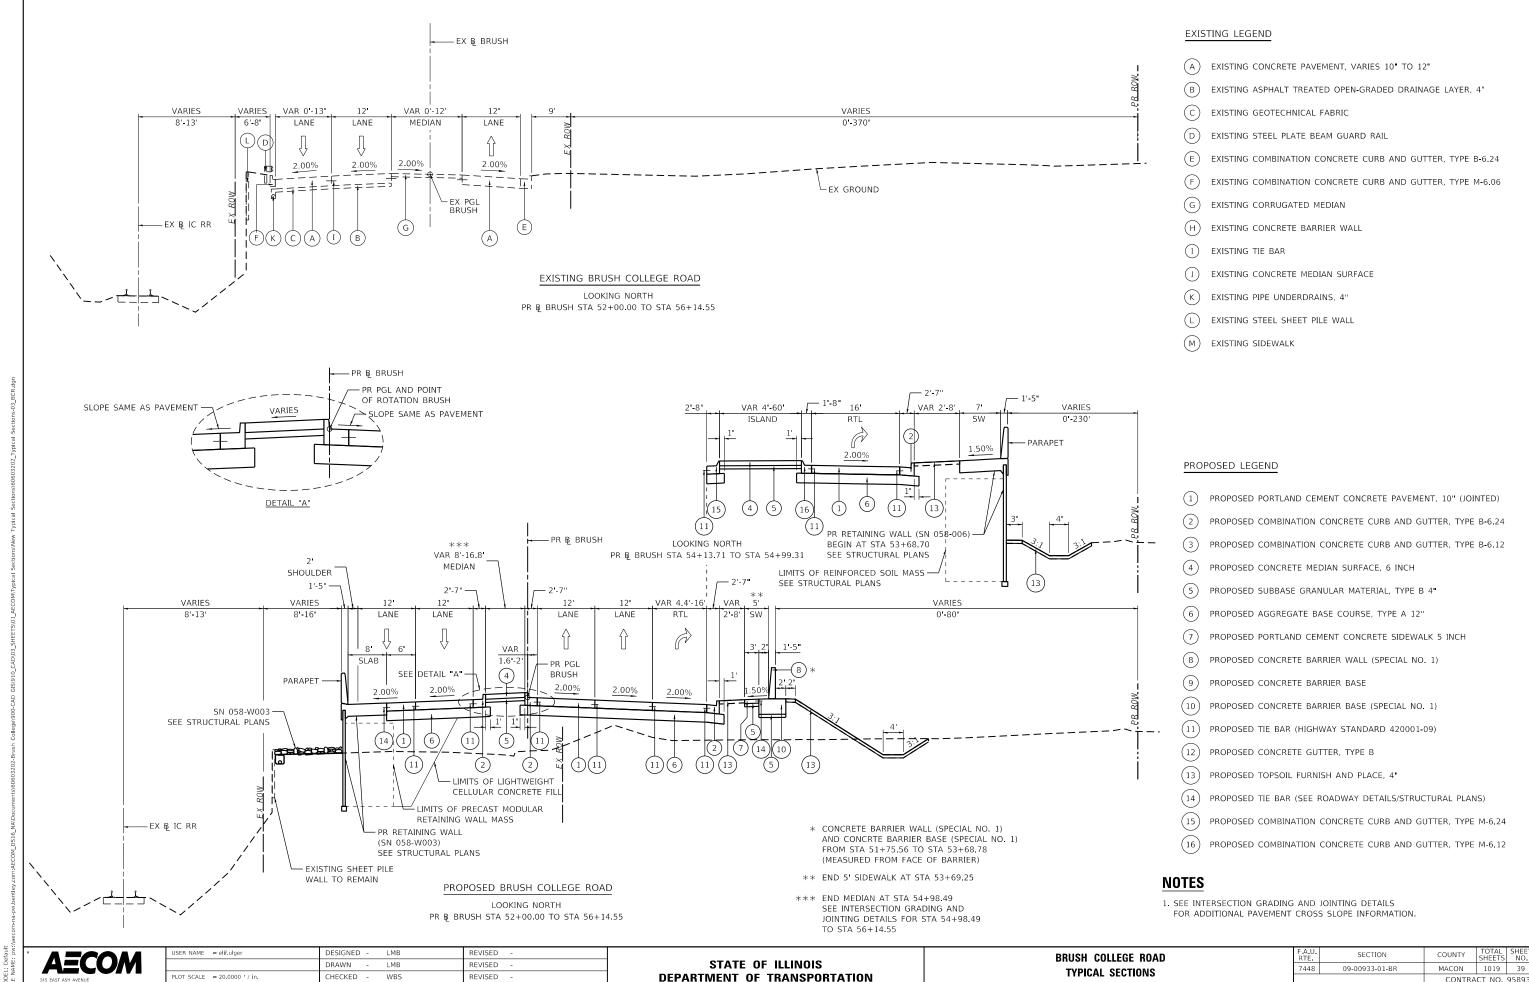


CONTRACT NO. 95893

SCALE: 1"=10' SHEET 3 OF 18 SHEETS STA. 52+00.00 TO STA. 56+14.55


LOT DATE = 4/27/2021

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4/30/2021

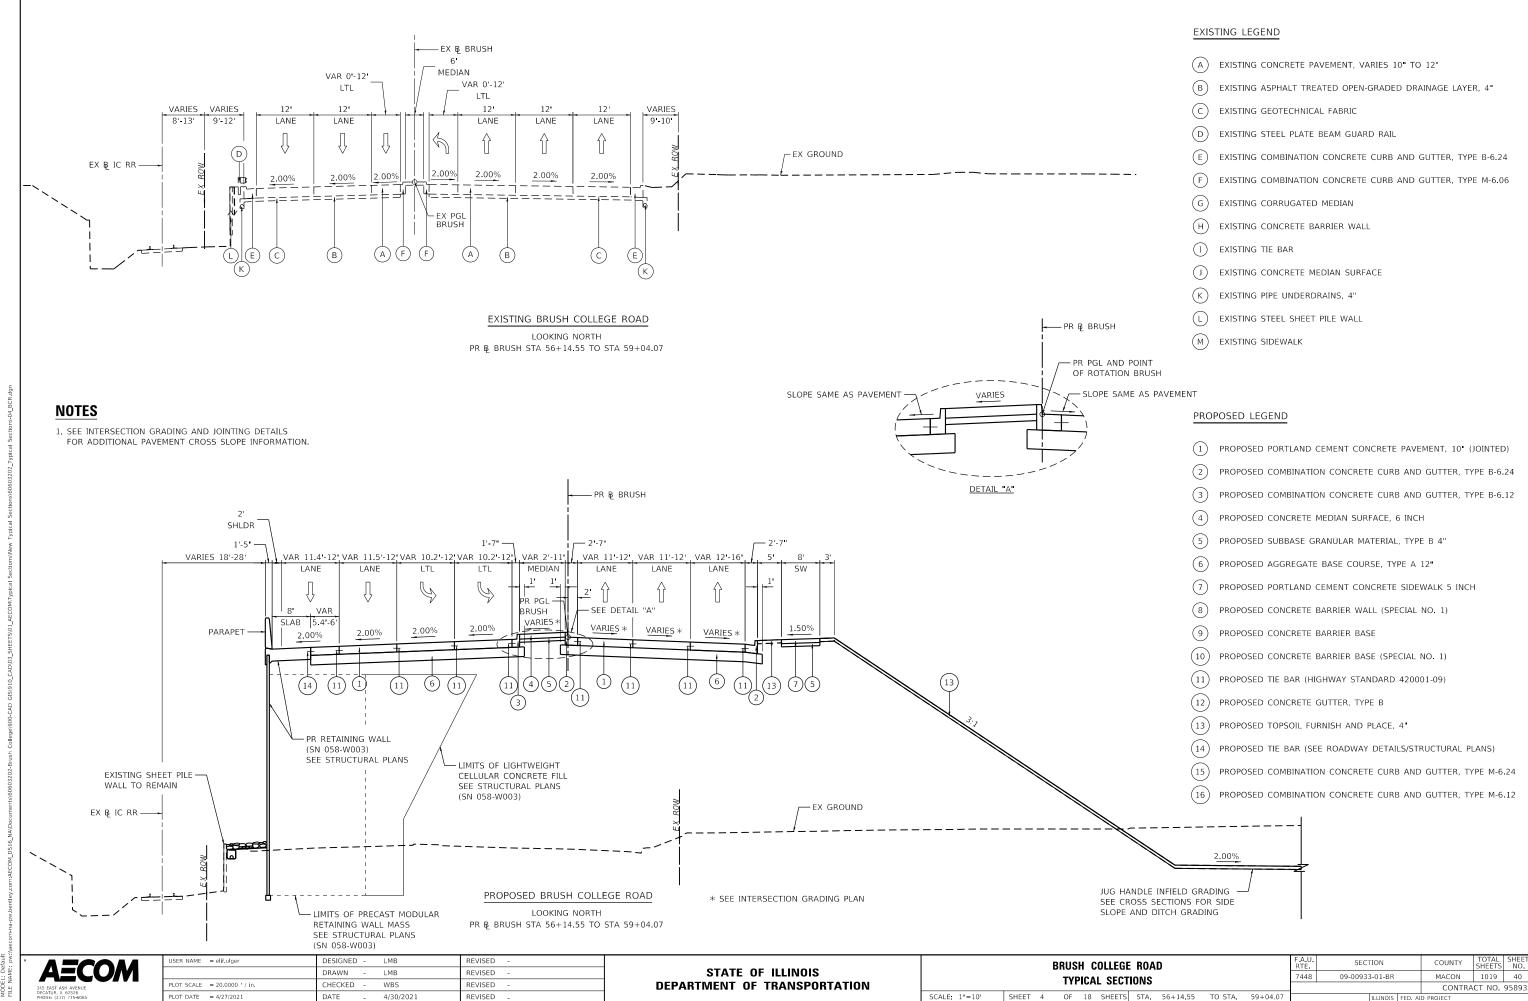

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DEPARTMENT OF TRANSPORTATION

SCALE: 1"=10' SHEET 5 OF 18 SHEETS STA. 59+04.07 TO STA. 64+67.08

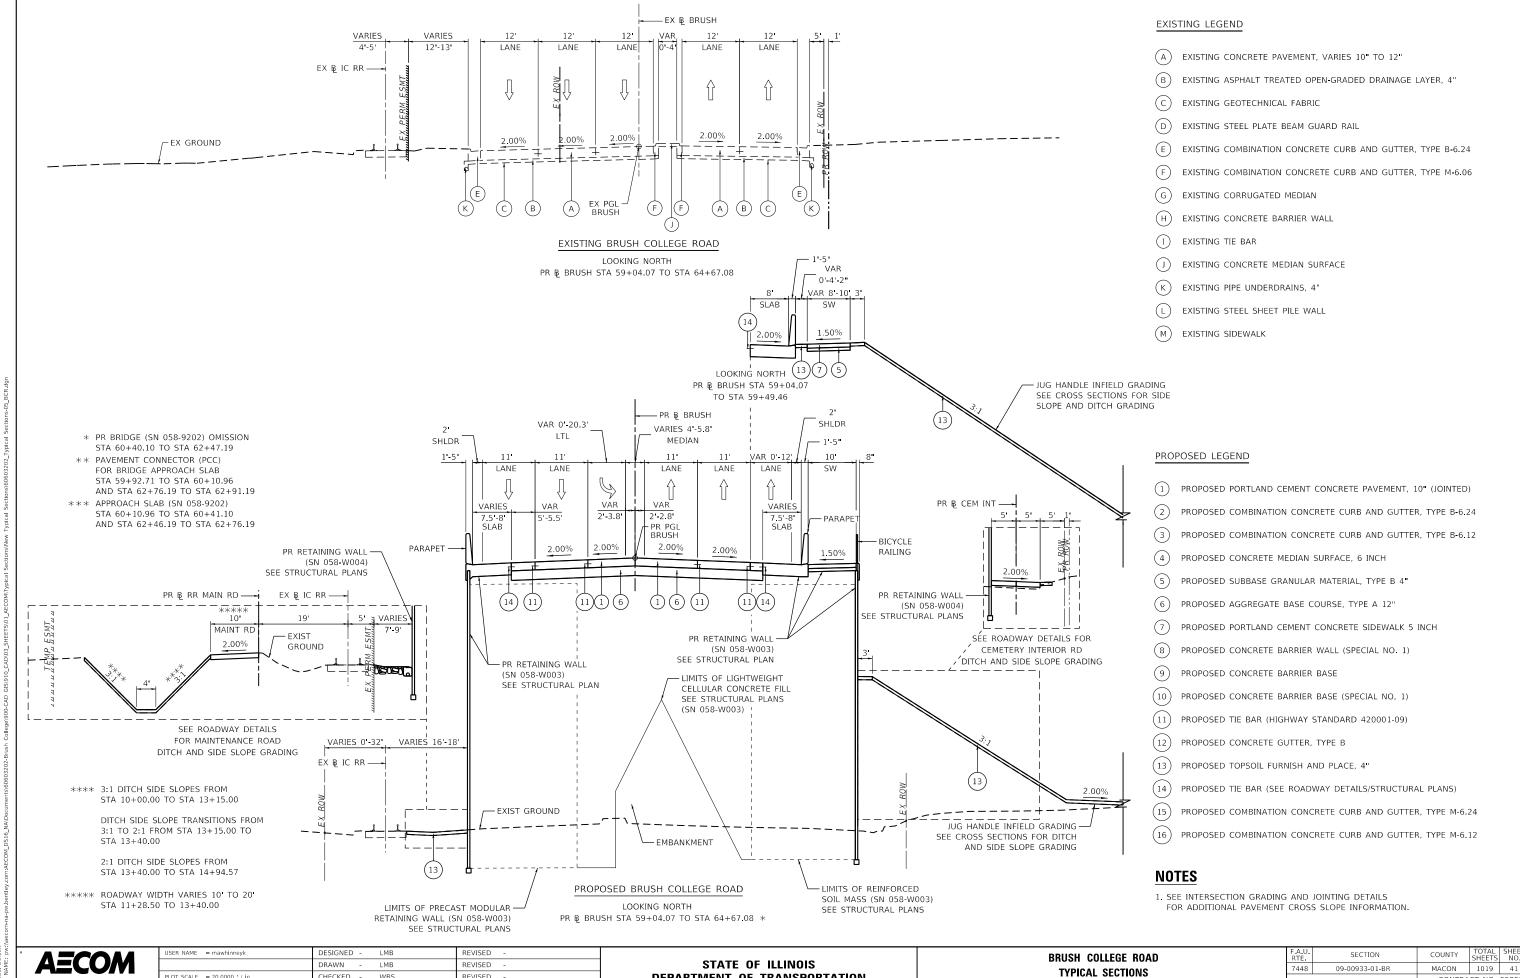CONTRACT NO. 95893

OT SCALE = 20.0000 ' / in.

LOT DATE = 10/29/2021


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345 EAST ASH AVENUE
DECATUR, IL 03276

OSEK NAME = elli.ulger	DESIGNED -	LIND	KENIZED -
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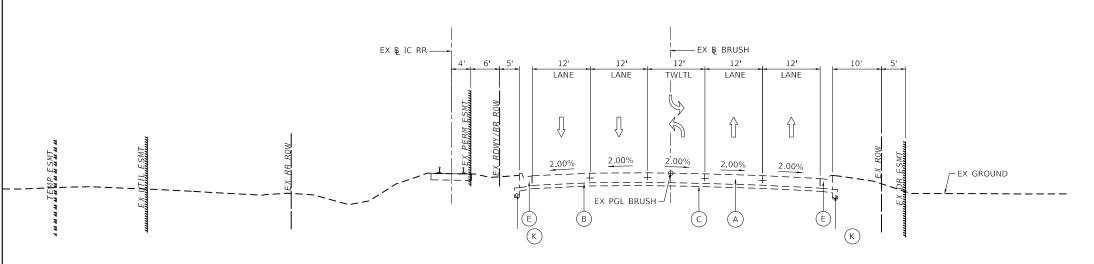
STATE OF ILLINOIS
DEPARTMENT OF TRANSPORTATION

	BRUSH COLLEGE ROAD											
	7448	09-00933-01-BR										
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SCALE: 1"=10'	SHEET 6	OF	18 9	SHEETS	STA.	64+67.08	TO STA.	69+25.33		ILLINOIS	FED.	

COUNTY

MACON 1019 42

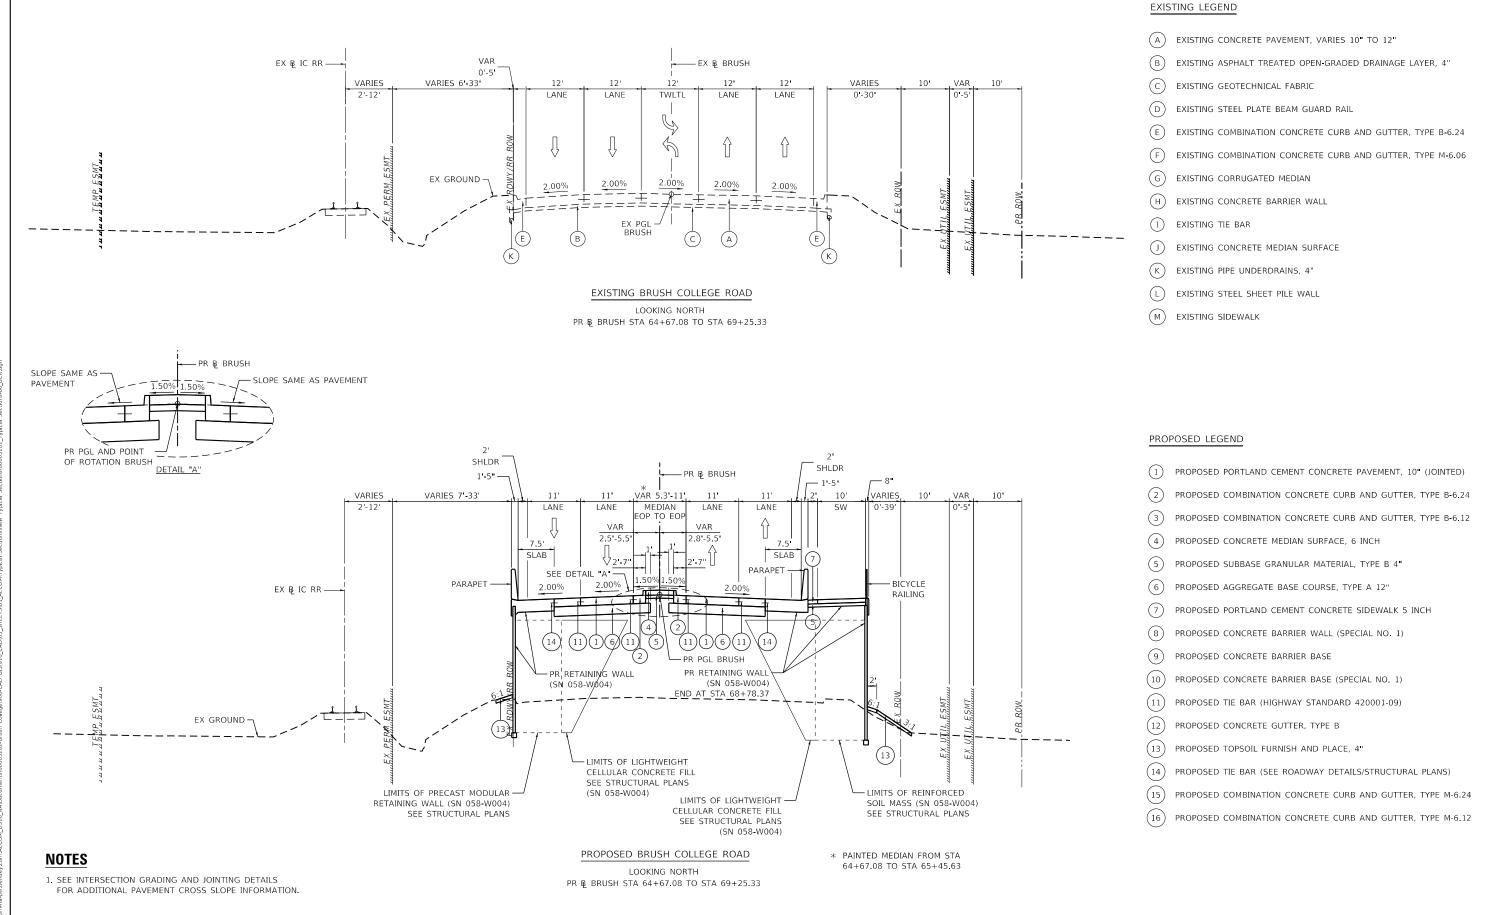CONTRACT NO. 95893



EXISTING BRUSH COLLEGE ROAD

LOOKING NORTH PR & BRUSH STA 69+25.33 TO STA 75+44.21

PROPOSED LEGEND

EXISTING LEGEND

(A) EXISTING CONCRETE PAVEMENT, VARIES 10" TO 12"

C EXISTING GEOTECHNICAL FABRIC

(G) EXISTING CORRUGATED MEDIAN (H) EXISTING CONCRETE BARRIER WALL

(K) EXISTING PIPE UNDERDRAINS, 4"

L EXISTING STEEL SHEET PILE WALL

J EXISTING CONCRETE MEDIAN SURFACE

1 EXISTING TIE BAR

(M) EXISTING SIDEWALK

D EXISTING STEEL PLATE BEAM GUARD RAIL

(B) EXISTING ASPHALT TREATED OPEN-GRADED DRAINAGE LAYER, 4"

(E) EXISTING COMBINATION CONCRETE CURB AND GUTTER, TYPE B-6.24 (F) EXISTING COMBINATION CONCRETE CURB AND GUTTER, TYPE M-6.06

- 1) PROPOSED PORTLAND CEMENT CONCRETE PAVEMENT, 10" (JOINTED)
- 2) PROPOSED COMBINATION CONCRETE CURB AND GUTTER, TYPE B-6.24
- 3) PROPOSED COMBINATION CONCRETE CURB AND GUTTER, TYPE B-6.12
- 4) PROPOSED CONCRETE MEDIAN SURFACE, 6 INCH
- 5 PROPOSED SUBBASE GRANULAR MATERIAL, TYPE B 4"
- (6) PROPOSED AGGREGATE BASE COURSE, TYPE A 12"
- 7) PROPOSED PORTLAND CEMENT CONCRETE SIDEWALK 5 INCH
- 8 PROPOSED CONCRETE BARRIER WALL (SPECIAL NO. 1)
- 9 PROPOSED CONCRETE BARRIER BASE
- (10) PROPOSED CONCRETE BARRIER BASE (SPECIAL NO. 1)
- (11) PROPOSED TIE BAR (HIGHWAY STANDARD 420001-09)
- (12) PROPOSED CONCRETE GUTTER, TYPE B
- (13) PROPOSED TOPSOIL FURNISH AND PLACE, 4"
- (14) PROPOSED TIE BAR (SEE ROADWAY DETAILS/STRUCTURAL PLANS)
- (15) PROPOSED COMBINATION CONCRETE CURB AND GUTTER, TYPE M-6.24
- (16) PROPOSED COMBINATION CONCRETE CURB AND GUTTER, TYPE M-6.12

-PR & BRUSH EX & IC RR -4 - 10 VAR 11-12 VAR 11-12 VAR 11-12 VAR 11-12 VAR 11-12 TWLTL LANE LANE LANE LANE VÂR VARIES VARIES 6 (11) (11)PR PGL BRUSH -

NOTES

1. SEE INTERSECTION GRADING AND JOINTING DETAILS FOR ADDITIONAL PAVEMENT CROSS SLOPE INFORMATION. PROPOSED BRUSH COLLEGE ROAD

USER NAME = elif.ulger	DESIGNED	-	LMB	REVISED -	
	DRAWN	-	LMB	REVISED -	
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PLOT DATE = 4/27/2021	DATE	_	4/30/2021	REVISED -	


STATE OF ILLINOIS **DEPARTMENT OF TRANSPORTATION**

* SEE INTERSECTION GRADING PLAN


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SCALE: 1"=10'	SHEET	7	OF	18	SHEETS	STA.	69+25.33	TO STA.	75+44.21


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	7448	09-00933-01-BR	MACON	1019	43	
				CONTRA	CT NO.	9589
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LOOKING NORTH PR & BRUSH STA 69+25.33 TO STA 75+44.21

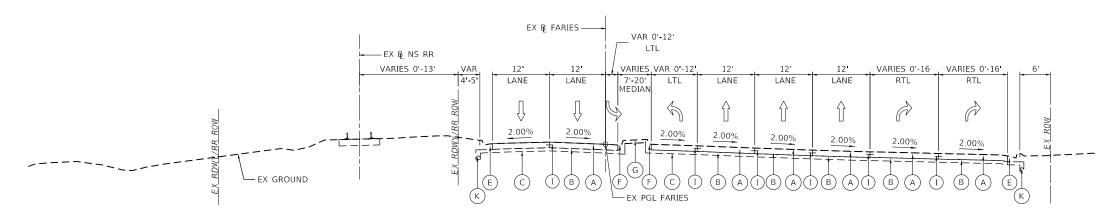

LOOKING EAST
PR & FARIES STA 205+18.73 TO STA 208+90.03



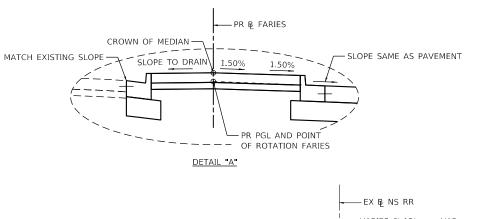

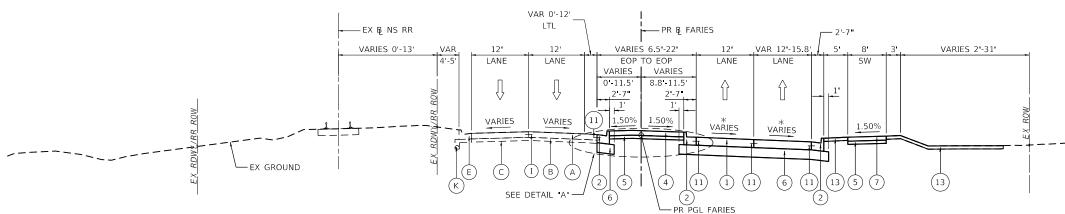NOTES

 SEE INTERSECTION GRADING AND JOINTING DETAILS FOR ADDITIONAL PAVEMENT CROSS SLOPE INFORMATION.

PROPOSED FARIES PARKWAY

LOOKING EAST ** PR & FARIES STA 205+18.73 TO STA 208+90.03

* SEE INTERSECTION GRADING PLAN

** NS RR CROSSING OMISSION
STA 207+10.38 TO STA 208+39.94
SEE ROADWAY DETAILS FOR CROSSING INFORMATION

EXISTING LEGEND

- (A) EXISTING CONCRETE PAVEMENT, VARIES 10" TO 12"
- B EXISTING ASPHALT TREATED OPEN-GRADED DRAINAGE LAYER, 4"
- (C) EXISTING GEOTECHNICAL FABRIC
- (D) EXISTING STEEL PLATE BEAM GUARD RAIL
- (E) EXISTING COMBINATION CONCRETE CURB AND GUTTER, TYPE B-6.24
- (F) EXISTING COMBINATION CONCRETE CURB AND GUTTER, TYPE M-6.06
- G EXISTING CORRUGATED MEDIAN
- (H) EXISTING CONCRETE BARRIER WALL
- I EXISTING TIE BAR
- J EXISTING CONCRETE MEDIAN SURFACE
- (K) EXISTING PIPE UNDERDRAINS, 4"
- L EXISTING STEEL SHEET PILE WALL
- (M) EXISTING SIDEWALK

PROPOSED LEGEND

- 1) PROPOSED PORTLAND CEMENT CONCRETE PAVEMENT, 10" (JOINTED)
- (2) PROPOSED COMBINATION CONCRETE CURB AND GUTTER, TYPE B-6.24
- (3) PROPOSED COMBINATION CONCRETE CURB AND GUTTER, TYPE B-6.12
- (4) PROPOSED CONCRETE MEDIAN SURFACE, 6 INCH
- (5) PROPOSED SUBBASE GRANULAR MATERIAL, TYPE B 4"
- 6 PROPOSED AGGREGATE BASE COURSE, TYPE A 12"
- (7) PROPOSED PORTLAND CEMENT CONCRETE SIDEWALK 5 INCH
- 8 PROPOSED CONCRETE BARRIER WALL (SPECIAL NO. 1)
- 9) PROPOSED CONCRETE BARRIER BASE
- (10) PROPOSED CONCRETE BARRIER BASE (SPECIAL NO. 1)
- (11) PROPOSED TIE BAR (HIGHWAY STANDARD 420001-09)
- (12) PROPOSED CONCRETE GUTTER, TYPE B
- (13) PROPOSED TOPSOIL FURNISH AND PLACE, 4"
- (14) PROPOSED TIE BAR (SEE ROADWAY DETAILS/STRUCTURAL PLANS)
- 15) PROPOSED COMBINATION CONCRETE CURB AND GUTTER, TYPE M-6.24
- 6) PROPOSED COMBINATION CONCRETE CURB AND GUTTER, TYPE M-6.12

* AECOM

 USER NAME
 = elif.ulger
 DESIGNED
 LMB
 REVISED

 DRAWN
 LMB
 REVISED

 PLOT SCALE
 = 20,0000 ' / in.
 CHECKED
 WBS
 REVISED

 PLOT DATE
 = 4/27/2021
 DATE
 4/30/2021
 REVISED


STATE OF ILLINOIS
DEPARTMENT OF TRANSPORTATION

FARIES PARKWAY
TYPICAL SECTIONS


SCALE: 1"=10' SHEET 8 OF 18 SHEETS STA. 205+18.73 TO STA. 208+90.03 | ILLINOIS FED. AID (


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MODEL; Default

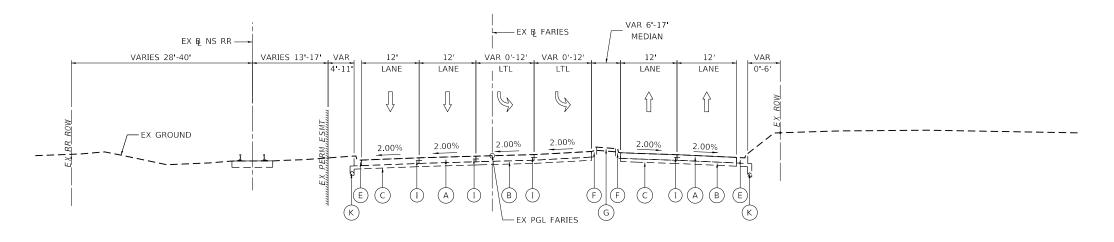

LOOKING EAST PR & FARIES STA 208+90.03 TO STA 215+41.69



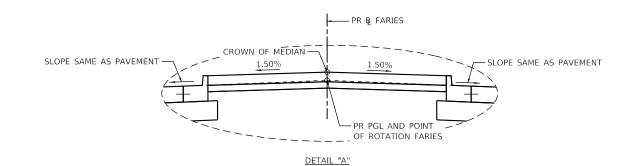

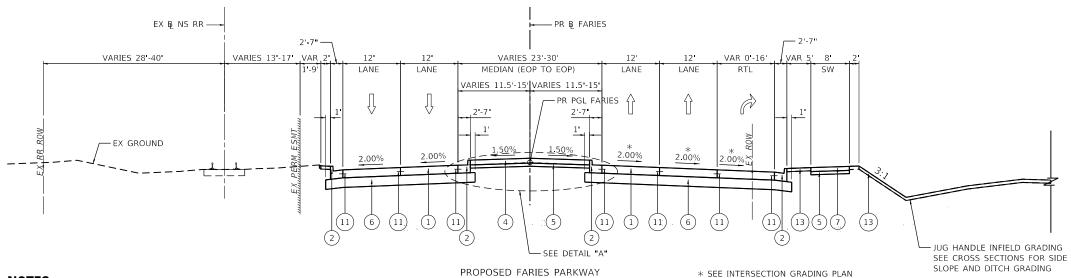EXISTING LEGEND

- (A) EXISTING CONCRETE PAVEMENT, VARIES 10" TO 12"
- B) EXISTING ASPHALT TREATED OPEN-GRADED DRAINAGE LAYER, 4"
- (C) EXISTING GEOTECHNICAL FABRIC
- (D) EXISTING STEEL PLATE BEAM GUARD RAIL
- (E) EXISTING COMBINATION CONCRETE CURB AND GUTTER, TYPE B-6.24
- F EXISTING COMBINATION CONCRETE CURB AND GUTTER, TYPE M-6.06
- G EXISTING CORRUGATED MEDIAN
- (H) EXISTING CONCRETE BARRIER WALL
- (I) EXISTING TIE BAR
- J EXISTING CONCRETE MEDIAN SURFACE
- (K) EXISTING PIPE UNDERDRAINS, 4"
- L EXISTING STEEL SHEET PILE WALL
- (M) EXISTING SIDEWALK

PROPOSED LEGEND

- 1) PROPOSED PORTLAND CEMENT CONCRETE PAVEMENT, 10" (JOINTED)
- 2 PROPOSED COMBINATION CONCRETE CURB AND GUTTER, TYPE B-6.24
- 3) PROPOSED COMBINATION CONCRETE CURB AND GUTTER, TYPE B-6.12
- 4 PROPOSED CONCRETE MEDIAN SURFACE, 6 INCH
- 5) PROPOSED SUBBASE GRANULAR MATERIAL, TYPE B 4"
- (6) PROPOSED AGGREGATE BASE COURSE, TYPE A 12"
- 7) PROPOSED PORTLAND CEMENT CONCRETE SIDEWALK 5 INCH
- 8 PROPOSED CONCRETE BARRIER WALL (SPECIAL NO. 1)
- 9 PROPOSED CONCRETE BARRIER BASE
- (10) PROPOSED CONCRETE BARRIER BASE (SPECIAL NO. 1)
- (11) PROPOSED TIE BAR (HIGHWAY STANDARD 420001-09)
- 12) PROPOSED CONCRETE GUTTER, TYPE B
- (13) PROPOSED TOPSOIL FURNISH AND PLACE, 4"
- (14) PROPOSED TIE BAR (SEE ROADWAY DETAILS/STRUCTURAL PLANS)
- (15) PROPOSED COMBINATION CONCRETE CURB AND GUTTER, TYPE M-6.24
- (16) PROPOSED COMBINATION CONCRETE CURB AND GUTTER, TYPE M-6.12

NOTES

1. SEE INTERSECTION GRADING AND JOINTING DETAILS FOR ADDITIONAL PAVEMENT CROSS SLOPE INFORMATION.

LOOKING EAST

** PR F FARIES STA 208+90.03 TO STA 215+41.69

* SEE INTERSECTION GRADING PLAN FOR THE FARIES/JUG HANDLE INTERSECTION


** IC RR CROSSING OMISSION
STA 209+72.15 TO STA 209+91.46
SEE ROADWAY DETAILS FOR CROSSING INFORMATION

 AECOM
345 EAST ASH AVENUE DECATUR, IL 62526


USER NAME = elif.ulger	DESIGNED - LMB	REVISED -
	DRAWN - LMB	REVISED -
PLOT SCALE = 20.0000 ' / in.	CHECKED - WBS	REVISED -
PLOT DATE = 4/27/2021	DATE - 4/30/2021	REVISED -


FARIES PARKWAY												
			TYP	L SECT	IONS			-				
SCALE: 1"=10'	SHEET	9	OF	18	SHEETS	STA.	208+90.03	TO STA.	215+41.69			

	F.A.U. RTE	SECTION	COUNTY	TOTAL SHEETS	SHE
	7448	09-00933-01-BR	MACON	1019	45
			CONTRA	CT NO.	9589
1 00			•	-	

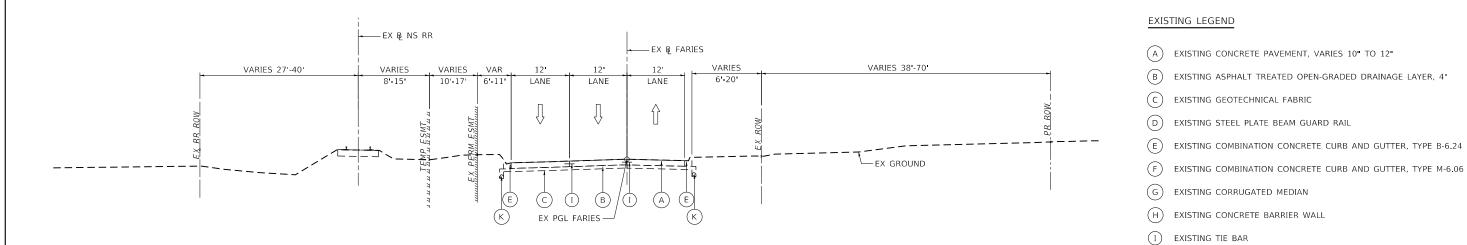

PR & FARIES STA 215+41.69 TO STA 224+20.94

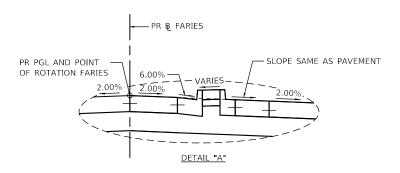

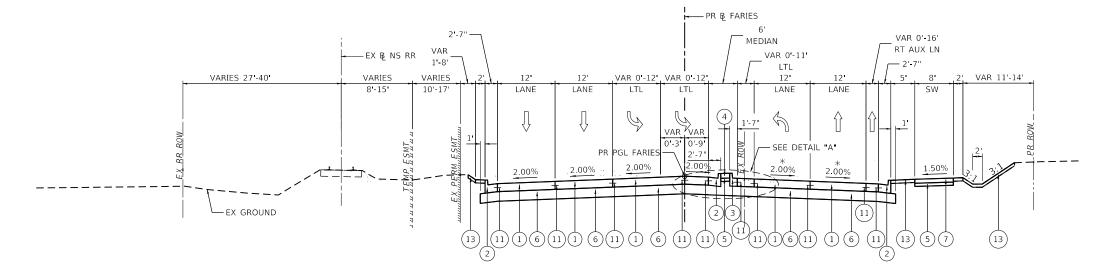

PROPOSED FARIES PARKWAY

LOOKING EAST PR & FARIES STA 215+41.69 TO STA 224+20.94 * SEE INTERSECTION GRADING PLAN FOR THE FARIES/JAMES INTERSECTION

NOTES

1. SEE INTERSECTION GRADING AND JOINTING DETAILS FOR ADDITIONAL PAVEMENT CROSS SLOPE INFORMATION.

> SER NAME = elif.ulger DESIGNED -REVISED DRAWN LMB REVISED REVISED LOT DATE = 4/27/2021 REVISED 4/30/2021

STATE OF ILLINOIS **DEPARTMENT OF TRANSPORTATION** **FARIES PARKWAY** TYPICAL SECTIONS

SECTION COUNTY 7448 09-00933-01-BR MACON 1019 46 CONTRACT NO. 95893

PROPOSED LEGEND

(M) EXISTING SIDEWALK


- (1) PROPOSED PORTLAND CEMENT CONCRETE PAVEMENT, 10" (JOINTED)
- 2) PROPOSED COMBINATION CONCRETE CURB AND GUTTER, TYPE B-6.24
- (3) PROPOSED COMBINATION CONCRETE CURB AND GUTTER, TYPE B-6.12
- 4) PROPOSED CONCRETE MEDIAN SURFACE, 6 INCH

J EXISTING CONCRETE MEDIAN SURFACE

(K) EXISTING PIPE UNDERDRAINS, 4" (L) EXISTING STEEL SHEET PILE WALL

- (5) PROPOSED SUBBASE GRANULAR MATERIAL, TYPE B 4"
- 6 PROPOSED AGGREGATE BASE COURSE, TYPE A 12"
- 7) PROPOSED PORTLAND CEMENT CONCRETE SIDEWALK 5 INCH
- 8 PROPOSED CONCRETE BARRIER WALL (SPECIAL NO. 1)
- 9 PROPOSED CONCRETE BARRIER BASE
- (10) PROPOSED CONCRETE BARRIER BASE (SPECIAL NO. 1)
- (11) PROPOSED TIE BAR (HIGHWAY STANDARD 420001-09)
- (12) PROPOSED CONCRETE GUTTER, TYPE B
- (13) PROPOSED TOPSOIL FURNISH AND PLACE, 4"
- (14) PROPOSED TIE BAR (SEE ROADWAY DETAILS/STRUCTURAL PLANS)
- (15) PROPOSED COMBINATION CONCRETE CURB AND GUTTER, TYPE M-6.24
- (16) PROPOSED COMBINATION CONCRETE CURB AND GUTTER, TYPE M-6.12

SCALE: 1"=10' SHEET 10 OF 18 SHEETS STA. 215+41.69 TO STA. 224+20.94

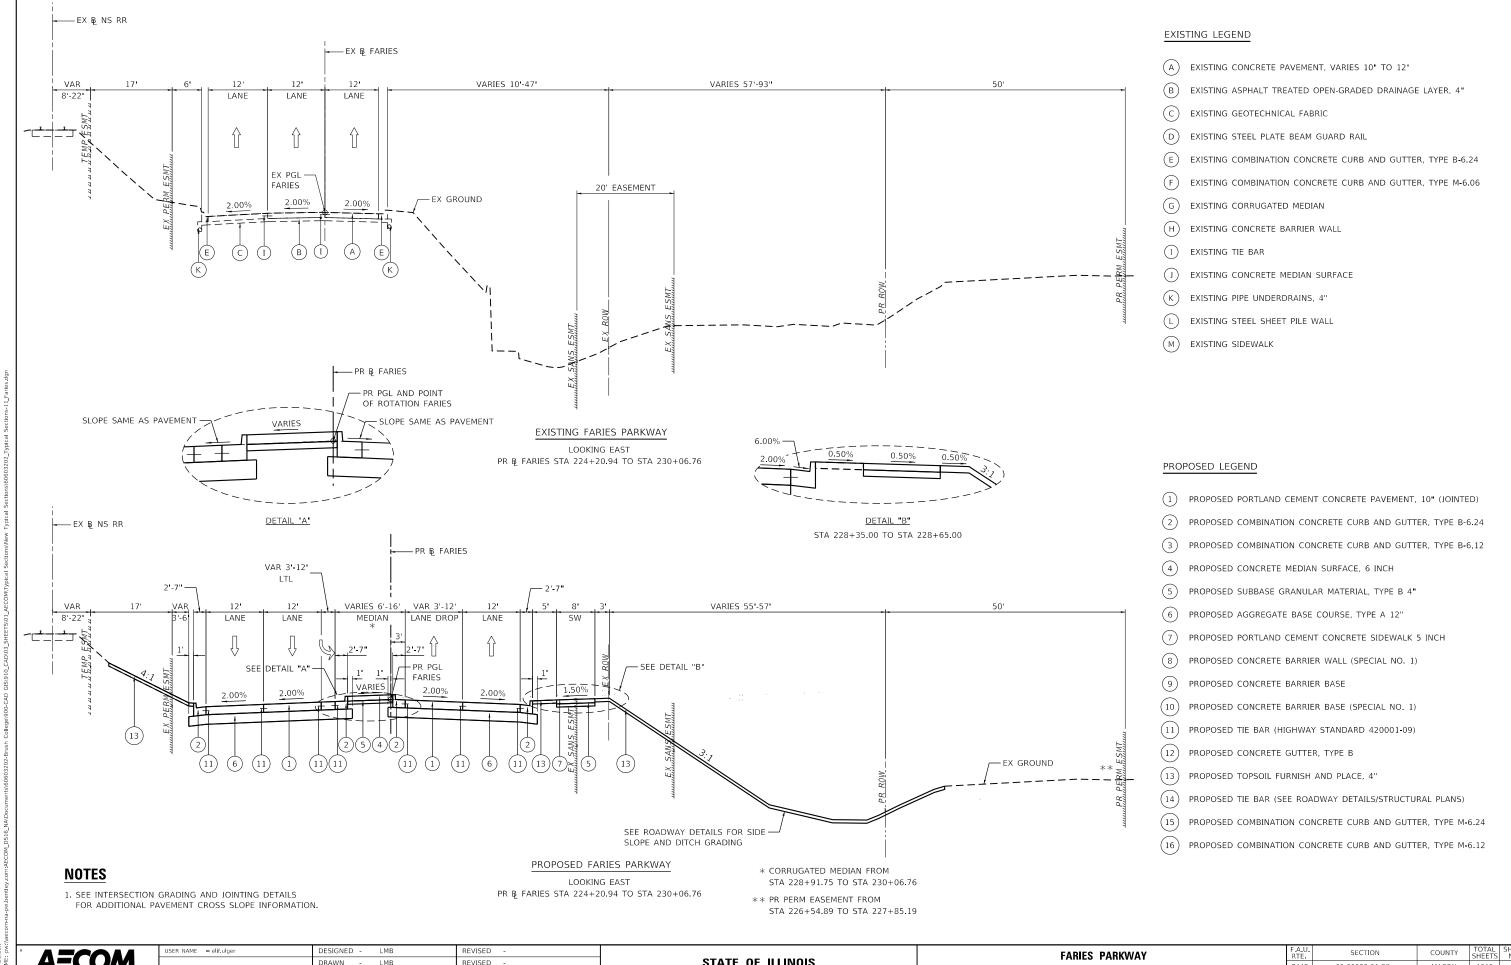

MODEL: Default

FARIES PARKWAY


TYPICAL SECTIONS

SCALE: 1"=10' SHEET 11 OF 18 SHEETS STA. 224+20.94 TO STA. 230+06.76

7448 09-00933-01-BR MACON 1019 47

CONTRACT NO. 95893

LOOKING EAST PR & FARIES STA 230+06.67 TO STA 235+41.47

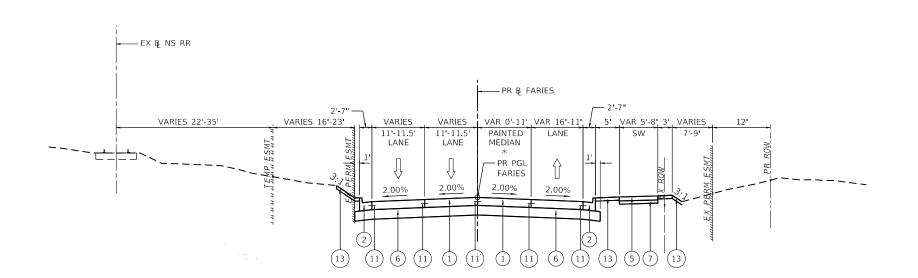

* PAINTED MEDIAN ENDS AT STA 234+87.68 LTL FROM STA 234+87.68 TO STA 235+41.46

PROPOSED FARIES PARKWAY

LOOKING EAST PR & FARIES STA 230+06.67 TO STA 235+41.47

NOTES

1. SEE INTERSECTION GRADING AND JOINTING DETAILS FOR ADDITIONAL PAVEMENT CROSS SLOPE INFORMATION.

USER NAME = elif.ulger	DESIGNED -	LMB	REVISED -
	DRAWN -	LMB	REVISED -
PLOT SCALE = 20.0000 / in.	CHECKED -	WBS	REVISED -
PLOT DATE = 4/27/2021	DATE -	4/30/2021	REVISED -

STATE OF ILLINOIS

		FA	RIES	PARK	WAY	
				L SECT		
т.	10	0.5	10	CHEETC	CTA	22

		F.A.U. RTE	SECTION	COUNTY	TOTAL SHEETS	SHEET NO.
		7448	09-00933-01-BR	MACON	1019	48
				CONTRA	CT NO.	95893
STA.	235+41.47		ILLINOIS FED. A	ID PROJECT		

PROPOSED LEGEND

EXISTING LEGEND

(A) EXISTING CONCRETE PAVEMENT, VARIES 10" TO 12"

C EXISTING GEOTECHNICAL FABRIC

G EXISTING CORRUGATED MEDIAN (H) EXISTING CONCRETE BARRIER WALL

J EXISTING CONCRETE MEDIAN SURFACE

(K) EXISTING PIPE UNDERDRAINS, 4" L EXISTING STEEL SHEET PILE WALL

I EXISTING TIE BAR

(M) EXISTING SIDEWALK

D EXISTING STEEL PLATE BEAM GUARD RAIL

B EXISTING ASPHALT TREATED OPEN-GRADED DRAINAGE LAYER, 4"

(E) EXISTING COMBINATION CONCRETE CURB AND GUTTER, TYPE B-6.24 (F) EXISTING COMBINATION CONCRETE CURB AND GUTTER, TYPE M-6.06

- (1) PROPOSED PORTLAND CEMENT CONCRETE PAVEMENT, 10" (JOINTED)
- PROPOSED COMBINATION CONCRETE CURB AND GUTTER, TYPE B-6.24
- PROPOSED COMBINATION CONCRETE CURB AND GUTTER, TYPE B-6.12
- 4) PROPOSED CONCRETE MEDIAN SURFACE, 6 INCH
- PROPOSED SUBBASE GRANULAR MATERIAL, TYPE B 4"
- PROPOSED AGGREGATE BASE COURSE, TYPE A 12"
- PROPOSED PORTLAND CEMENT CONCRETE SIDEWALK 5 INCH
- (8) PROPOSED CONCRETE BARRIER WALL (SPECIAL NO. 1)
- 9 PROPOSED CONCRETE BARRIER BASE
- PROPOSED CONCRETE BARRIER BASE (SPECIAL NO. 1)
- (11)PROPOSED TIE BAR (HIGHWAY STANDARD 420001-09)
- (12) PROPOSED CONCRETE GUTTER, TYPE B
- PROPOSED TOPSOIL FURNISH AND PLACE, 4"
- PROPOSED TIE BAR (SEE ROADWAY DETAILS/STRUCTURAL PLANS)
- PROPOSED COMBINATION CONCRETE CURB AND GUTTER, TYPE M-6.24
- PROPOSED COMBINATION CONCRETE CURB AND GUTTER, TYPE M-6.12

DEPARTMENT OF TRANSPORTATION

SCALE: 1"=10' SHEET 12 OF 18 SHEETS STA 230+06.67 TO ST

PROPOSED PORTLAND CEMENT CONCRETE PAVEMENT, 10" (JOINTED)

2 PROPOSED COMBINATION CONCRETE CURB AND GUTTER, TYPE B-6.24

(3) PROPOSED COMBINATION CONCRETE CURB AND GUTTER, TYPE B-6.12

4) PROPOSED CONCRETE MEDIAN SURFACE, 6 INCH

5 PROPOSED SUBBASE GRANULAR MATERIAL, TYPE B 4"

6 PROPOSED AGGREGATE BASE COURSE, TYPE A 12"

7 PROPOSED PORTLAND CEMENT CONCRETE SIDEWALK 5 INCH

8 PROPOSED CONCRETE BARRIER WALL (SPECIAL NO. 1)

9 PROPOSED CONCRETE BARRIER BASE

(10) PROPOSED CONCRETE BARRIER BASE (SPECIAL NO. 1)

11) PROPOSED TIE BAR (HIGHWAY STANDARD 420001-09)


12 PROPOSED CONCRETE GUTTER, TYPE B

(13) PROPOSED TOPSOIL FURNISH AND PLACE, 4"

14) PROPOSED TIE BAR (SEE ROADWAY DETAILS/STRUCTURAL PLANS)

(15) PROPOSED COMBINATION CONCRETE CURB AND GUTTER, TYPE M-6.24

16) PROPOSED COMBINATION CONCRETE CURB AND GUTTER, TYPE M-6.12

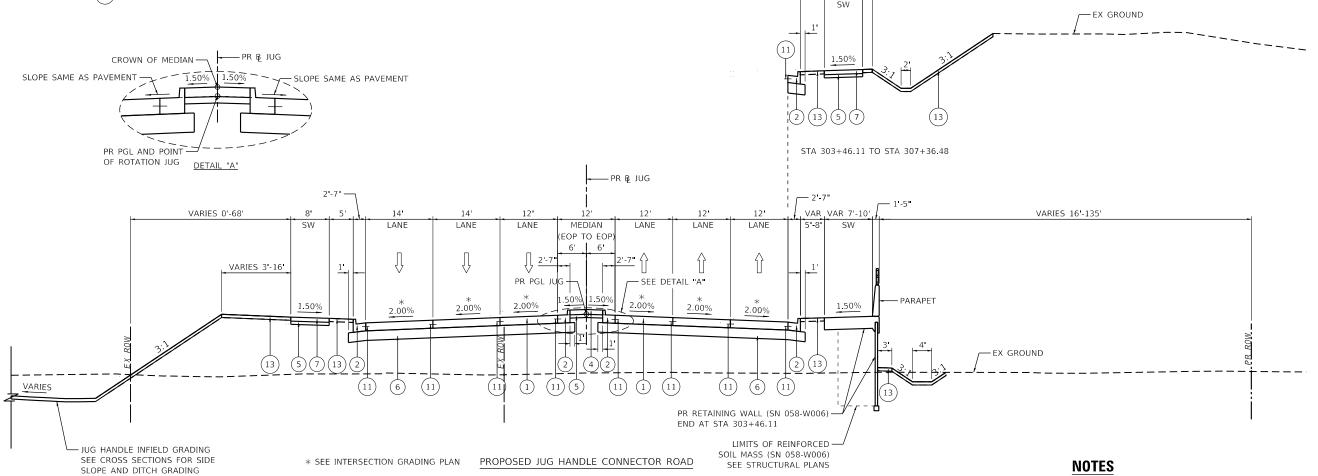

AECOM

345 EAST ASH AVENUE
DECATUR. II. 6/25/26

 USER NAME
 = elif.ulger
 DESIGNED
 LMB
 REVISED

 PLOT SCALE
 = 20,0000 ' / in.
 CHECKED
 WBS
 REVISED

 PLOT DATE
 = 4/27/2021
 DATE
 4/30/2021
 REVISED

STATE OF ILLINOIS
DEPARTMENT OF TRANSPORTATION

LOOKING EAST

PR & JUG STA 300+75.91 TO STA 307+36.48

JUG HANDLE CONNECTOR ROAD
TYPICAL SECTIONS

SCALE: 1"=10' SHEET 13 OF 18 SHEETS STA. 300+75.91 TO STA. 307+36.48

F.A.U. SECTION COUNTY TOTAL SHEETS NO.

7448 09-00933-01-BR MACON 1019 49

CONTRACT NO. 95893

6.48 | ILLINOIS | FED. AID PROJECT

1. SEE INTERSECTION GRADING AND JOINTING DETAILS

FOR ADDITIONAL PAVEMENT CROSS SLOPE INFORMATION.


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EXISTING EAST LOGAN STREET

₽ EAST LOGAN STREET

LOOKING EAST PR & E LOGAN STREET STA 601+50.00 TO STA 609+44.38

MIX DESIGN INFORMATION									
LOCATION .	E LOGAN ST / N JAMES ST / E	HARRISON AVE (WEST LEG) /							
LOCATION	CEMETERY ACCESS RD								
	HMA BINDER (2 1/2") &	HMA SURFACE (1 1/2") &							
MIXTURE USE(S)	BOTTOM LIFT HMA	TOP LIFT HMA DRIVEWAY							
	DRIVEWAY PAVT	PAVT							
AC/PG	PG 64-22	PG 70-22							
DESIGN AIR VOIDS	4.0% @ N=50	4.0% @ N=50							
MIXTURE COMPOSITION (GRADATION MIXTURE)	IL-9.5	IL-9.5							
FRICTION AGGREGATE	N/A	MIX C							
MIXTURE WEIGHT	112 LB / SY / IN	112 LB / SY / IN							
QUALITY MANAGEMENT PROGRAM	QC/QA	QC/QA							
SUBLOT SIZE	N/A	N/A							
NUMBER OF ROLLER PASSES	N/A	N/A							

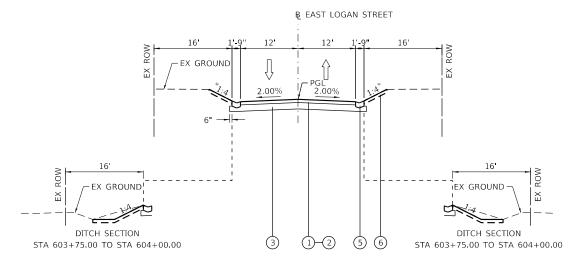

PROPOSED EAST LOGAN STREET

PR & EAST LOGAN STREET STA 601+50.00 TO STA 609+44.38

TRANSITION FROM CONC GUTTER B-6.24 TO CONC GUTTER TYPE B, SEE ROADWAY PLAN SHEETS.

EXISTING LEGEND

- A EXISTING GROUND
- B OIL AND CHIP SURFACE
- C AGGREGATE SUBBASE

PROPOSED LEGEND

- 1 PROPOSED HMA SURFACE COURSE, IL-9.5, MIX "C", N50 (1 1/2")
- 2 PROPOSED HMA BINDER COURSE, IL-9.5, N50 (2 1/2")
- PROPOSED AGGREGATE BASE COURSE, TY A 8"
- PROPOSED AGGREGATE SHOULDERS, TYPE A 4"
- 5 PROPOSED CONCRETE GUTTER, TYPE B
- 6 PROPOSED TOPSOIL FURNISH AND PLACE, 4"

* SEE CROSS SECTIONS FOR GRADING LIMITS AND SLOPES

whks

DESIGNED -REVISED EJT DRAWN EJT REVISED RKA REVISED PLOT DATE = 4/27/2021 REVISED 4/30/2021

STATE OF ILLINOIS **DEPARTMENT OF TRANSPORTATION**

EAST LOGAN STREET TYPICAL SECTIONS SHEET 14 OF 18 SHEETS STA. 601+50.00 TO STA. 607+50.00

SECTION 7448 09-00933-01-BR MACON 1019 50 CONTRACT NO. 95893

EXISTING NORTH JAMES STREET

LOOKING NORTH

PR & NORTH JAMES STREET STA 404+28.00 TO 407+75.00

* SEE CROSS SECTIONS FOR GRADING LIMITS AND SLOPES

₽ NORTH JAMES STREET 23' & VARIES LEFT TURN EX GROUND -2.00% 2.00%


PROPOSED NORTH JAMES STREET

LOOKING NORTH

PR & NORTH JAMES STREET STA 405+50.00 TO 407+75.00

* SEE CROSS SECTIONS FOR GRADING LIMITS AND SLOPES

₽ NORTH JAMES STREET

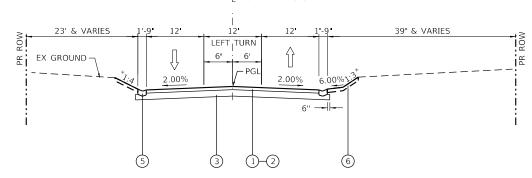

PROPOSED NORTH JAMES STREET

LOOKING NORTH PR & NORTH JAMES STREET STA 404+28.00 TO 405+50.00

* SEE CROSS SECTIONS FOR GRADING LIMITS AND SLOPES

EXISTING LEGEND

- A EXISTING GROUND
- B OIL AND CHIP SURFACE
- C AGGREGATE SUBBASE

PROPOSED LEGEND

- 1 PROPOSED HMA SURFACE COURSE, IL-9.5, MIX "C", N50 (1 1/2")
- 2 PROPOSED HMA BINDER COURSE, IL-9.5, N50 (2 1/2")
- PROPOSED AGGREGATE BASE COURSE, TY A 8"
- 4 PROPOSED AGGREGATE SHOULDERS, TYPE A 4"
- 5 PROPOSED CONCRETE GUTTER, TYPE B
- 6 PROPOSED TOPSOIL FURNISH AND PLACE, 4"

MIX DESIGN INFORMATION									
LOCATION	E LOGAN ST / N JAMES ST / E HARRISON AVE (WEST LEG)								
LOCATION	CEMETERY	ACCESS RD							
	HMA BINDER (2 1/2") &	HMA SURFACE (11/2") &							
MIXTURE USE(S)	BOTTOM LIFT HMA	TOP LIFT HMA DRIVEWAY							
	DRIVEWAY PAVT	PAVT							
AC/PG	PG 64-22	PG 70-22							
DESIGN AIR VOIDS	4.0% @ N=50	4.0% @ N=50							
MIXTURE COMPOSITION (GRADATION MIXTURE)	IL-9.5	IL-9.5							
FRICTION AGGREGATE	N/A	MIX C							
MIXTURE WEIGHT	112 LB / SY / IN	112 LB / SY / IN							
QUALITY MANAGEMENT PROGRAM	QC/QA	QC/QA							
SUBLOT SIZE	N/A	N/A							
NUMBER OF ROLLER PASSES	N/A	N/A							


JSER NAME = gjameson	DESIGNED -	EJT	REVISED -
	DRAWN -	EJT	REVISED -
PLOT SCALE = 20.0000 ' / in.	CHECKED -	RKA	REVISED -
PLOT DATE = 4/27/2021	DATE -	4/30/2021	REVISED -

STATE OF ILLINOIS **DEPARTMENT OF TRANSPORTATION**

NORTH JAMES STREET	
TYPICAL SECTIONS	

	F.A.U. RTE	SECT	ΓΙΟΝ		COUNTY	TOTAL SHEETS	SHEE
	7448	09-00933	3-01-BR		MACON	1019	51
				CONTRA	CT NO.	9589	
)			ILLINO1S	FED. AI	D PROJECT		


SHEET 15 OF 18 SHEETS STA. 404+28.00 TO STA. 407+75.00

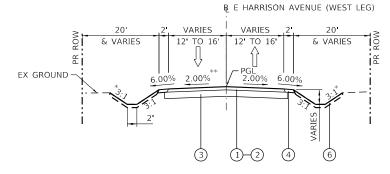

PROPOSED E HARRISON AVENUE (WEST LEG)

LOOKING NORTH
STA 800+00.00 TO STA 801+68.00
AND
STA 803+85.00 TO STA 807+61.64


* SEE CROSS SECTIONS FOR GRADING LIMITS AND SLOPES
** SEE SUPERELEVATION TABLE FOR LEFT LANE SUPERELEVATION

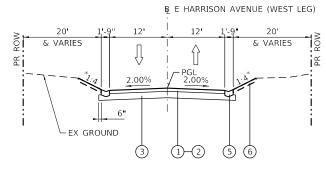

PROPOSED E HARRISON AVENUE (WEST LEG)

LOOKING NORTH STA 800+09.00 TO STA 803+85.00


* SEE CROSS SECTIONS FOR GRADING LIMITS AND SLOPES

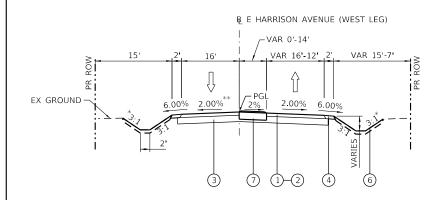

PROPOSED E HARRISON AVENUE (WEST LEG)

LOOKING EAST STA 807+61.64 TO STA 810+00.00

* SEE CROSS SECTIONS FOR GRADING LIMITS AND SLOPES
** SEE SUPERELEVATION TABLE FOR LEFT LANE SUPERELEVATION

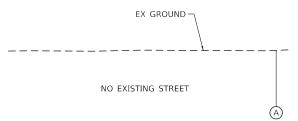

EXISTING E HARRISON AVENUE (WEST LEG)

LOOKING NORTH STA 800+00.00 TO STA 810+00.00

EXISTING LEGEND

- A EXISTING GROUND
- B OIL AND CHIP SURFACE
- C AGGREGATE SUBBASE

PROPOSED LEGEND

- 1 PROPOSED HMA SURFACE COURSE, IL-9.5, MIX "C", N50 (1 1/2")
- 2 PROPOSED HMA BINDER COURSE, IL-9.5, N50 (2 1/2")
- PROPOSED AGGREGATE BASE COURSE, TY A 8"
- 4 PROPOSED AGGREGATE SHOULDERS, TYPE A 4"
- 5 PROPOSED CONCRETE GUTTER, TYPE B
- 6 PROPOSED TOPSOIL FURNISH AND PLACE, 4"
- 7 CORRUGATED MEDIAN, 9"

LEFT LAN	E SUPERELEVATION - E	HARRISON AVENUE (V	/EST LEG)
STA T	O STA	LT SUPER 7	TO LT SUPER
804+10.26	804+56.02	2% (NC)	0%
804+56.02	804+78.90 (PC)	0%	-1%
804+78.90 (PC)	805+01.78	-1%	-2% (FULL)
805+01.78	807+38.76	-2% (FULL)	-2% (FULL)
807+38.76	807+61.64 (PT)	-2% (FULL)	-1%
807+61.64 (PT)	807+84.52	-1%	0%
807+84.52	808+30.28	0%	2% (NC)

MIX DESIG	GN INFORMATION			
LOCATION	E LOGAN ST / N JAMES ST / E	HARRISON AVE (WEST LEG) /		
LOCATION MIXTURE USE(S) AC/PG DESIGN AIR VOIDS MIXTURE COMPOSITION (GRADATION MIXTURE) FRICTION AGGREGATE MIXTURE WEIGHT QUALITY MANAGEMENT PROGRAM SUBLOT SIZE	CEMETERY	ACCESS RD		
	HMA BINDER (2 1/2") &	HMA SURFACE (1 1/2") &		
MIXTURE USE(S)	BOTTOM LIFT HMA	TOP LIFT HMA DRIVEWAY		
	DRIVEWAY PAVT	PAVT		
AC/PG	PG 64-22	PG 70-22		
DESIGN AIR VOIDS	4.0% @ N=50	4.0% @ N=50		
MIXTURE COMPOSITION (GRADATION MIXTURE)	IL-9.5	IL-9.5		
FRICTION AGGREGATE	N/A	MIX C		
MIXTURE WEIGHT	112 LB / SY / IN	112 LB / SY / IN		
QUALITY MANAGEMENT PROGRAM	QC/QA	QC/QA		
SUBLOT SIZE	N/A	N/A		
NUMBER OF ROLLER PASSES	N/A	N/A		

gn firm 84001036 **whks** engineers + planners + land surveyors

R NAME = gjameson	DESIGNED -	EJT	REVISED -
	DRAWN -	EJT	REVISED -
T SCALE = 20.0000 ' / in.	CHECKED -	RKA	REVISED -
T DATE = 4/27/2021	DATE -	4/30/2021	REVISED -


STATE OF ILLINOIS
DEPARTMENT OF TRANSPORTATION

SCALE:

Е	E HARRISON AVENUE (WEST LEG)								F.A.U. RTE	SECTI	ON		COUNTY	TOTAL SHEETS	SHE
TYPICAL SECTIONS							7448	09-00933-	01-BR		MACON	1019	52		
	TTFICAL SECTIONS												CONTRA	ACT NO.	9589
SHEET	16	ΩE	18	SHEETS	STA	800+00 00	TO STA	810+00.00		n	LIMOIC	EED AT	D BROIECT		

EXISTING E HARRISON AVE (EAST LEG)


LOOKING EAST PR & E HARRISON (EAST) STA 701+00.00 TO STA 708+41.73

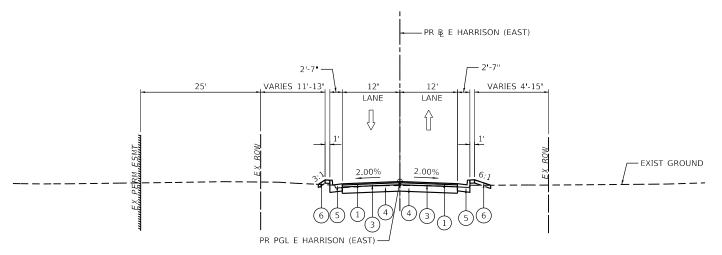

PROPOSED E HARRISON AVE (EAST LEG)

LOOKING EAST

PR № E HARRISON (EAST) STA 700+73.73 TO STA 702+50.00

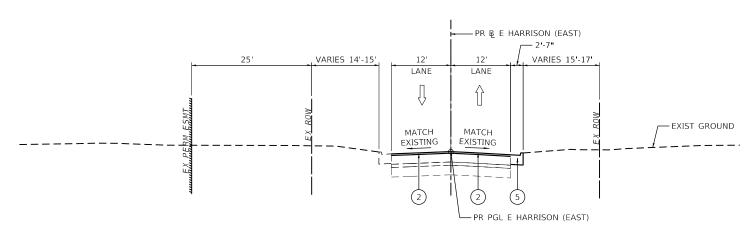

NOTES

1. SEE INTERSECTION GRADING AND JOINTING DETAILS FOR ADDITIONAL PAVEMENT CROSS SLOPE INFORMATION.

PROPOSED E HARRISON AVE (EAST LEG)

LOOKING EAST

PR № E HARRISON (EAST) STA 702+50.00 TO STA 708+41.73

EXISTING LEGEND

- A EXISTING BITUMINOUS CONCRETE SURFACE COURSE
- B EXISTING BITUMINOUS CONCRETE
- C EXISTING AGGREGATE BASE
- (D) EXISTING COMBINATION CONCRETE CURB AND GUTTER, TYPE B-6.24

PROPOSED LEGEND

- 1 PROPOSED HOT-MIX ASPHALT SURFACE COURSE, IL-9.5, MIX "C", N50, 1.5"
- PROPOSED HOT-MIX ASPHALT SURFACE COURSE, IL-9.5, MIX "C", N50, 2"
- 3) PROPOSED HOT-MIX ASPHALT BINDER COURSE, IL-9.5, N50, 2.5"
- PROPOSED AGGREGATE BASE COURSE, TYPE A 8"
- PROPOSED COMBINATION CONCRETE CURB AND GUTTER, TYPE B-6.24
- 6 PROPOSED TOPSOIL FURNISH AND PLACE, 4"

MIX DESIGN INFORMATION											
LOCATION E HARRISON AVE (EAST LEG)											
MIXTURE USE(S)	HMA BINDER (2½")	HMA SURFACE (1½")	HMA SURFACE (2")								
AC/PG	PG 64-22	PG 70-22	PG 70-22								
DESIGN AIR VOIDS	4.0% @ N=50	4.0% @ N=50	4.0% @ N=50								
MIXTURE COMPOSITION (GRADATION MIXTURE)	IL-9.5	IL-9.5	IL-9.5								
FRICTION AGGREGATE	N/A	MIX C	MIX C								
MIXTURE WEIGHT	112 LB / SY / IN	112 LB / SY / IN	112 LB / SY / IN								
QUALITY MANAGEMENT PROGRAM	QC/QA	QC/QA	QC/QA								
SUBLOT SIZE	N/A	N/A	N/A								
NUMBER OF ROLLER PASSES	N/A	N/A	N/A								




USER NAME = elif.ulger	DESIGNED	-	LMB	REVISED -	
	DRAWN	-	LMB	REVISED -	
PLOT SCALE = 20.0000 ' / in.	CHECKED	-	WBS	REVISED -	
PLOT DATE = 4/27/2021	DATE	-	4/30/2021	REVISED -	

Ī	E HARRISON AVENUE (EAST LEG)										SEC	TION		COUNTY	TOTAL SHEETS	SHEET NO.
I	TYPICAL SECTIONS									7448 09-00933-01-BR			MACON	1019	53	
ļ														CONTRA	CT NO.	95893
I	SCALE: 1'=10'	SHEET 17	OF	18	SHEETS	STA.	701+00.00	TO STA.	708+41.73			ILLINOIS	FED. AI	D PROJECT		

EXISTING CEMETERY ACCESS ROAD

LOOKING NORTH PR & CEMETARY ACCESS STA 900+00 TO STA 904+52

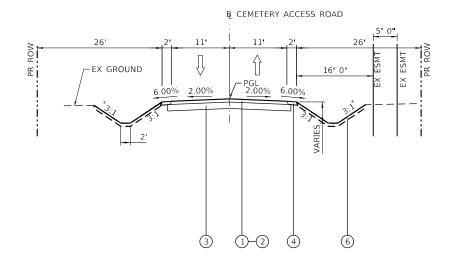

MIX DESIGN INFORMATION E LOGAN ST / N JAMES ST / E HARRISON AVE (WEST LEG) / CEMETERY ACCESS RD HMA BINDER (2 1/2") & HMA SURFACE (11/2") & MIXTURE USE(S) BOTTOM LIFT HMA TOP LIFT HMA DRIVEWAY DRIVEWAY PAVT PAVT PG 64-22 PG 70-22 DESIGN AIR VOIDS 4.0% @ N=50 4.0% @ N=50 MIXTURE COMPOSITION (GRADATION MIXTURE) IL-9.5 IL-9.5 FRICTION AGGREGATE N/A MIX C MIXTURE WEIGHT 112 LB / SY / IN 112 LB / SY / IN QUALITY MANAGEMENT PROGRAM QC/QA QC/QA SUBLOT SIZE N/A N/A

N/A

EXISTING LEGEND

- A EXISTING GROUND
- B OIL AND CHIP SURFACE
- C AGGREGATE SUBBASE

PROPOSED LEGEND

- 1 PROPOSED HMA SURFACE COURSE, IL-9.5, MIX "C", N50 (1 1/2")
- 2 PROPOSED HMA BINDER COURSE, IL-9.5, N50 (2 1/2")
- 3 PROPOSED AGGREGATE BASE COURSE, TY A 8"
- PROPOSED AGGREGATE SHOULDERS, TYPE A 4"
- 5) PROPOSED CONCRETE GUTTER, TYPE B
- 6 PROPOSED TOPSOIL FURNISH AND PLACE, 4"

PROPOSED CEMETARY ACCESS ROAD

LOOKING NORTH PR & CEMETARY ACCESS STA 900+00 TO STA 904+52

* SEE CROSS SECTIONS FOR GRADING LIMITS AND SLOPES

sign firm . 184001036	whks	
enginee	ers + planners + land surveyors	

NUMBER OF ROLLER PASSES

USER NAME = gjameson	DESIGNED	-	EJT	REVISED -	
	DRAWN	-	EJT	REVISED -	
PLOT SCALE = 20.0000 ' / in.	CHECKED	-	RKA	REVISED -	
PLOT DATE = 4/27/2021	DATE	-	4/30/2021	REVISED -	
					Ξ

N/A

STATE OF ILLINOIS **DEPARTMENT OF TRANSPORTATION**

	CE	MET	ERY	ACCES	S RO	AD			F.A.U. RTE
		TVE	אחוכ	L SECT	ONG				7448
		• • • •	IUA	L SLUI	IUIVS				
SHEET	18	OF	18	SHEETS	STA.	900+00.00	TO STA.	904+52.12	

SECTION COUNTY MACON 1019 54 09-00933-01-BR CONTRACT NO. 95893

01,dan	1
Schedule	1
oadway	!
H	ı
50603202	1
NRoadway	
AECON	
SHEETS\01	
CAD\03	
GIS/910	
1900-CAD	
sh College)	,
603202-Brush	
ents/606	
VA\Docum	
0516	
com:AECOM	
w.bentlev.c	•
ecom-na-pv	

ROAD	OWAY SCH	HEDULE	SUBBASE GRANULAR MATERIAL, TYPE B 4"	AGGREGATE BASE COURSE, TYPE A 8"	AGGREGATE BASE COURSE, TYPE A 12"	AGGREGATE SURFACE COURSE, TYPE A	AGGREGATE SURFACE COURSE, TYPE A 6"	BITUMINOUS MATERIALS PRIME COAT)	BITUMINOUS MATERIALS TACK COAT)	HOT-MIX ASPHALT BINDER COURSE, IL- 9.5, N50	HOT-MIX ASPHALT SURFACE COURSE, IL-9.5, MIX "C", N50	BITUMINOUS MATERIALS TACK COAT)	PAVEMENT CONNECTOR PCC) FOR BRIDGE APPROACH SLAB	PORTLAND CEMENT CONCRETE PAVEMENT 10" (JOINTED)	PROTECTIVE COAT	PORTLAND CEMENT CONCRETE DRIVEWAY PAVEMENT, 5 INCH	PORTLAND CEMENT CONCRETE SIDEWALK 5 NCH	DETECTABLE WARNINGS	AGGREGATE SHOULDERS, TYPE A 4"	CONCRETE CURB, TYPE B
SHEET	ROAD	STATION STATION	SQ YD	SQ YD	SQ YD	TON	SQ YD	POUND	POUND	TON	TON	POUND	SQ YD	SQ YD	SQ YD	SQ YD	SQ FT	SQ FT	SQ YD	FOOT
1		46+59.44 52+00.00	494	0	2293	0	0	0.0	0.0	0.0	0.0	0.0	0	1895	2968	0	3582.5	0	0	0.0
2		52+00.00 57+75.00	1447	454	6911	0	0	1019.8	0.0	54.0	32.4	173.7	0	5886	8239	0	2792.5	97	0	0.0
3	BRUSH	57+75.00 62+50.00	258	0	1839	0	0	0.0	0.0	0.0	0.0	0.0	106	1698	2179	0	1477.0	0	0	0.0
4	Brosii	62+50.00 68+00.00	217	0	2209	0	907	0.0	0.0	0.0	0.0	0.0	62	2006	2485	0	622.5	0	9	0.0
5		68+00.00 73+50.00	121	147	4000	0	0	330.5	48.1	17.4	16.5	55.5	0	3590	4326	117	525.0	35	2	51.5
6		73+50.00 76+25.97	0	2083	1396	0	0	0.0	0.0	0.0	0.0	0.0	0	1242	1405	49	0.0	0	0	28.0
7		205+18.73208+00.00	387	0	867	0	19	0.0	139.7	0.0	17.5	0.0	0	700	1569	233	1111.5	45	0	82.0
8		208+00.0 213+25.00	1536	0	3396	0	30	0.0	142.5	0.0	17.8	0.0	0	2672	5359	0	3809.5	0	0	0.0
9	FARIES	213+25.0 219+00.00	1102	0	7649	0	0	0.0	0.0	0.0	0.0	0.0	0	6619	8428	0	5070.0	97	0	0.0
10		219+00.0 224+75.00	492	391	5415	0	0	878.5	0.0	48.4	29.1	155.4	0	4631	6245	359	3522.0	56	0	315.0
11		224+75.0 230+50.00	870	0	4092	0	0	0.0	0.0	0.0	0.0	0.0	0	3233	4678	0	4590.0	0	0	0.0
12		230+50.0 235+41.47	341	0	2812	0	0	0.0	0.0	0.0	0.0	0.0	0	2420	3176	121	3069.0	0	0	75.5
13	JUG	301+75.00306+50.00	1028	267	5118	0	43	599.3	0.0	30.7	18.4	98.5	0	4329	5985	0	5656.0	86	0	0.0
14	LOGAN	601+50.00607+50.00	0	1900	0	0	309	3600.0	0.0	227.8	136.7	360.0	0	0	233	0	0.0	0	0	0.0
15	JAMES	607+50.00407+75.00	0	2417	0	0	328	4765.8	0.0	301.6	181.0	476.6	0	0	173	0	0.0	0	0	0.0
16	HARRISON W	800+00.00804+50.00	0	1831	0	0	48	3526.3	0.0	223.2	133.9	352.7	0	0	121	0	0.0	0	57	0.0
17		804+50.0810+00.00	0	3602	0	0	0	7508.3	0.0	286.9	172.2	750.9	0	0	255	0	118.0	0	216	0.0
18	HARRISON E	701+00.00705+00.00	0	1245	0	0	0	1223.5	638.4	59.5	115.2	191.0	0	0	406	181	0.0	0	0	68.0
19		705+00.0 708+41.73	0	0	0	0	0	0.0	879.0	0.0	109.4	0.0	0	0	309	158	0.0	0	0	85.5
20	CEMETERY	900+00.00904+52.12	2 0	1121	0	10	0	2521.3	0.0	159.6	95.8	252.2	0	0	0	0	0.0	0	205	0.0
	TC	DTAL	8293	15458	47997	10	1684	25973.2	1847.7	1409.1	1075.9	2866.4	168	40921	58539	1218	35945.5	416	489	705.5

				CONCRETE GUTTER, TYPE B	COMBINATION CONCRETE CURB AND GUTTER, TYPE B-6.12	COMBINATION CONCRETE CURB AND GUTTER, TYPE B-6.24	COMBINATION CONCRETE CURB AND GUTTER, TYPE B-6.24 (VARIABLE WIDTH GUTTER FLAG)	COMBINATION CONCRETE CURB AND GUTTER, TYPE M-6.12	COMBINATION CONCRETE CURB AND GUTTER, TYPE M-6.24	CONCRETE MEDIAN SURFACE, 6 INCH	CORRUGATED MEDIAN	STEEL PLATE BEAM GUARDRAIL, TYPE A, 6 FOOT POSTS	TRAFFIC BARRIER TERMINAL, TYPE 2	TRAFFIC BARRIER TERMINAL, TYPE 6	TRAFFIC BARRIER TERMINAL, TYPE 1 (SPECIAL) TANGENT	CONCRETE BARRIER BASE	BARRIER WALL REFLECTORS, TYPE C	HOT-MIX ASPHALT DRIVEWAY PAVEMENT, 4"	CONCRETE BARRIER BASE (SPECIAL NO. 1)	CONCRETE BARRIER , VERTICAL FACE (SPECIAL)	CONCRETE BARRIER WALL (SPECIAL NO. 1)
SHEET	ROAD	STATION	STATION	FOOT	FOOT	FOOT	FOOT	FOOT	FOOT	SQ FT	SQ FT	FOOT	EACH	EACH	EACH	FOOT	EACH	SQ YD	FOOT	FOOT	FOOT
1		46+59.44	52+00.00	490.0	0.0	482.5	33.0	0.0	0.0	0	0	0	0	0	0	28	5	0	325	28	325
2		52+00.00	57+75.00	218.5	155.0	1562.0	0.0	259.5	393.5	10223	0	0	0	0	0	0	3	0	172	0	172
3	BRUSH	57+75.00	62+50.00	0.0	126.5	265.5	0.0	0.0	0.0	841	0	0	0	1	1	44	0	0	0	0	0
4	Bixesii	62+50.00	68+00.00	0.0	0.0	507.5	0.0	0.0	0.0	1324	0	12.5	2	0	0	0	0	0	0	0	0
5		68+00.00	73+50.00	0.0	0.0	1105.5	0.0	0.0	0.0	494	62	0	0	1	1	0	0	0	0	0	0
6		73+50.00	76+25.97	0.0	0.0	388.5	0.0	0.0	0.0	0	0	0	0	0	0	0	0	0	0	0	0
7		205+18.73	208+00.00	0.0	302.5	481.5	0.0	0.0	0.0	2369	0	0	0	0	0	0	0	0	0	0	0
8		208+00.00	213+25.00	0.0	0.0	1935.5	0.0	0.0	0.0	10008	0	0	0	0	0	0	0	0	0	0	0
9	FARIES	213+25.00	219+00.00	0.0	353.5	1783.0	137.0	153.0	234.5	4847	0	0	0	0	0	0	0	0	0	0	0
10		219+00.00	224+75.00	140.5	455.5	1462.5	156.0	0.0	0.0	900	0	0	0	0	0	0	0	0	0	0	0
11		224+75.00		0.0	124.5	1923.0	0.0	0.0	0.0	2668	568	0	0	0	0	0	0	0	0	0	0
12		230+50.00	235+41.47	0.0	0.0	990.0	0.0	0.0	0.0	0	0	0	0	0	0	0	0	0	0	0	0
13	JUG	301+75.00	306+50.00	93.5	0.0	1922.5	0.0	72.0	41.0	3590	0	0	0	0	0	0	0	0	0	0	0
14	LOGAN		607+50.00	1200.0	0.0	0.0	0.0	0.0	0.0	0	0	0	0	0	0	0	0	41	0	0	0
15	JAMES	607+50.00	407+75.00	889.0	0.0	0.0	0.0	0.0	0.0	0	0	0	0	0	0	0	0	0	0	0	0
16	HARRISON W	800+00.00		624.0	0.0	0.0	0.0	0.0	0.0	0	0	0	0	0	0	0	0	0	0	0	0
17		804+50.00	810+00.00	0.0	0.0	73.0	0.0	0.0	0.0	0	2114	0	0	0	0	0	0	1325	0	0	0
18	HARRISON E	701+00.00	705+00.00	0.0	0.0	551.0	0.0	0.0	0.0	0	0	0	0	0	0	0	0	0	0	0	0
19		705+00.00	708+41.73	0.0	0.0	342.0	0.0	0.0	0.0	0	0	0	0	0	0	0	0	0	0	0	0
20	CEMETERY	900+00.00	904+52.12	0.0	0.0	0.0	0.0	0.0	0.0	0	0	0	0	0	0	0	0	0	0	0	0
	ТО	TAL		3655.5	1517.5	15775.5	326.0	484.5	669.0	37264	2744	12.5	2	2	2	72	8	1366	497	28	497

"	AECOM
	345 EAST ASH AVENUE DECATUR, IL 62526 PHONE (217) 775-6065

USER NAME = mawhinneyk	DESIGNED -	-	LMB	REVISED	-
	DRAWN -	-	LMB	REVISED	=
PLOT SCALE = 20.0000 / in.	CHECKED -	-	WBS	REVISED	=
PLOT DATE = 10/29/2021	DATE -	-	10/22/2021	REVISED	-

STATE (OF ILLINOIS
DEPARTMENT O	F TRANSPORTATION

ROADWAY SCHEDULE 7448 09-00933-01-BR MACON 1019 55 SCALE: N/A SHEET 1 OF 16 SHEETS STA. TO STA. ILLINOIS FED. AID PROJECT									F.A.U. RTE	SECTION		COUNTY	TOTAL SHEETS	SHEET NO.
				KUAI	DVVF	AY SCH	EDULE		7448	09-00933-01-l	3R	MACON	1019	55
SCALE: N/A SHEET 1 OF 16 SHEETS STA. TO STA. ILLINOIS FED. AID PROJECT												CONTRA	CT NO.	95893
	SCALE: N/A	SHEET	1	OF	16	SHEETS	STA.	TO STA.		ILLING	DIS FED. A	ID PROJECT		

PATCH	ING SCHE	DULE														
					CLASS C PATCHES, TYPE I, 6 INCH	CLASS C PATCHES, TYPE II, 6 INCH	CLASS C PATCHES, TYPE III, 6 INCH	CLASS C PATCHES, TYPE IV, 6 INCH	CLASS C PATCHES, TYPE I, 12 INCH	CLASS C PATCHES, TYPE II, 12 INCH	CLASS C PATCHES, TYPE III, 12 INCH	CLASS C PATCHES, TYPE IV, 12 INCH	CLASS D PATCHES, TYPE I, 6 INCH	CLASS D PATCHES, TYPE II, 6 INCH	CLASS D PATCHES, TYPE III, 6 INCH	CLASS D PATCHES, TYPE IV, 6 INCH
SHEET	ROAD	STATION	STATION	STAGE	SQ YD	SQ YD	SQ YD	SQ YD	SQ YD	SQ YD	SQ YD	SQ YD	SQ YD	SQ YD	SQ YD	SQ YD
1		46+59.44	52+00.00	N/A	0	0	0	0	0	0	0	0	0	0	0	0
2		52+00.00	57+75.00	STAGE 1	0	0	0	0	0	0	0	0	0	15	0	0
3		57+75.00	62+50.00	PRE-STAGE C	0	0	0	0	0	0	16	0	0	0	0	0
4	BRUSH	62+50.00	68+00.00	PRE-STAGE C	0	0	0	0	0	0	0	53	0	0	0	0
		02 1 30.00	00100.00	STAGE 1	0	0	0	0	0	0	0	0	0	0	20	0
5		68+00.00	73+50.00	PRE-STAGE A	0	0	0	0	0	8	0	168	0	0	0	0
6		73+50.00	76+25.97	N/A	0	0	0	0	0	0	0	0	0	0	0	0
7		205+18.73	208+00.00	PRE-STAGE B	0	0	0	0	0	0	0	49	0	0	0	0
				PRE-STAGE B	0	0	0	0	0	0	0	270	0	0	0	0
				PRE-STAGE C	0	0	0	0	5	13	0	161	0	0	0	0
8		208+00.00	213+25.00	PRE-STAGE D	0	0	0	0	0	0	18	94	0	0	0	0
				PRE-STAGE E	0	0	0	0	0	7	0	27	0	0	0	0
	FARIES			STAGE 1	0	0	0	0	0	0	0	0	0	7	0	0
9		213+25.00	219+00.00	N/A	0	0	0	0	0	0	0	0	0	0	0	0
10		219+00.00	224+75.00	PRE-STAGE B	0	11	0	95	0	0	0	0	0	0	18	55
10		219+00.00	224+75.00	STAGE 3	0	19	0	51	0	0	0	0	0	0	0	0
11		224+75.00	230+50.00	N/A	0	0	0	0	0	0	0	0	0	0	0	0
12		230+50.00	235+41.47	STAGE 3	0	0	0	0	4	0	0	0	0	0	0	0
13	JUG	301+75.00	306+50.00	STAGE 1	5	0	25	0	0	0	0	0	4	0	0	0
14	LOGAN	601+50.00	607+50.00	N/A	0	0	0	0	0	0	0	0	0	0	0	0
15	JAMES	607+50.00	407+75.00	N/A	0	0	0	0	0	0	0	0	0	0	0	0
16	HADDICON W	800+00.00	804+50.00	N/A	0	0	0	0	0	0	0	0	0	0	0	0
17	HARRISON W	804+50.00	810+00.00	N/A	0	0	0	0	0	0	0	0	0	0	0	0
18		701+00.00	705+00.00	STAGE 1	0	0	0	39	0	0	0	0	0	0	0	79
10	HARRISON E	/01+00.00	705+00.00	STAGE 3	0	0	22	0	0	0	0	0	0	0	0	37
19		705+00.00	708+41.73	STAGE 1	0	0	46	0	0	0	0	0	0	0	0	93
20	CEMETERY	900+00.00	904+52.12	N/A	0	0	0	0	0	0	0	0	0	0	0	0
		TOTAL	-		5	30	93	185	9	28	34	822	4	22	38	264

NOTES

- 1. TO BE USED DURING PROPOSED AND EXISTING UTILITY RELOCATION AND INSTALLATION WHERE PAVEMENT RESTORATION IS REQUIRED.
 2. THE EXISTING PAVEMENT IS TO BE REPLACED IN KIND (PORTLAND CEMENT CONCRETE OR HOT-MIX ASPHALT) AND MATCH EXISTING PAVEMENT THICKNESSES.

SURVEY MARKER SCHEDULE

SHEET	ROAD	STATION	OFFSET, RT/LT	PROTECTING OR RESETTING SURVEY MARKERS	SURVEY MARKER VAULT
				EACH	EACH
8	FARIES	210+50.06	11.37', LT	1	1

TOTAL	1	1

AECOM
<i>,</i> — — — — — — — — — — — — — — — — — — —
345 EAST ASH AVENUE DECATUR, IL 62526

USER NAME = busanskyl	DESIGNED -	LMB	REVISED -
	DRAWN -	LMB	REVISED -
PLOT SCALE = 20.0000 ' / in.	CHECKED -	WBS	REVISED -
PLOT DATE = 5/5/2021	DATE -	4/30/2021	REVISED -

								F.A.U. RTE	SEC ⁻	TION		COUNTY	TOTAL SHEETS	SHEE NO.
ROADWAY SCHEDULE									09-0093	3-01-BR		MACON	1019	56
												CONTRA	CT NO.	95893
SCALE: N/A	SHEET	2	OF	16	SHEETS	STA.	TO STA.			ILLINOIS	FED. All	D PROJECT		

REMOVAL SCHEDULE

				TREE REMOVAL (6 TO 15 UNITS DIAMETER)	TREE REMOVAL (OVER 15 UNITS DIAMETER)	TREE REMOVAL, ACRES	PAVEMENT REMOVAL	HOT-MIX ASPHALT SURFACE REMOVAL, 2"	DRIVEWAY PAVEMENT REMOVAL	CURB REMOVAL	COMBINATION CURB AND GUTTER REMOVAL	SIDEWALK REMOVAL	CONCRETE BARRIER REMOVAL	MEDIAN REMOVAL	CONCRETE REMOVAL	GUARDRAIL REMOVAL	REMOVE CONCRETE FOUNDATION - GROUND MOUNT	HOT-MIX ASPHALT DRIVEWAY PAVEMENT REMOVAL	REMOVE WOOD POST	MAILBOX REMOVE AND REPLACE	STUMP REMOVAL ONLY	CURB REMOVAL (SPECIAL)	SIDEWALK REMOVAL (SPECIAL)	CORRUGATED MEDIAN REMOVAL	CHAIN LINK FENCE REMOVAL	SPECIAL WASTE GROUNDWATER DISPOSAL
SHEET	ROAD	STATION	STATION	UNIT	UNIT	ACRE	SQ YD	SQ YD	SQ YD	FOOT	FOOT	SQ FT	FOOT	SQ FT	CU YD	FOOT	EACH	SQ YD	EACH	EACH	UNIT	FOOT	SQ FT	SQ FT	FOOT	GALLON
1		46+59.44	52+00.00	0	0	0.00	1657	0	0	120	764	2043	117	0	0.0	461	0	0	0	0	0	0	0	0	0	0
2		52+00.00	57+75.00	0	24	0.00	4241	0	148	0	1029	1458	0	0	0.0	569	0	0	0	0	0	0	2469	191	488	0
3	BRUSH	57+75.00	62+50.00	0	0	0.00	1846	0	83	0	930	131	0	997	0.0	160	1	0	0	0	0	0	500	560	0	0
4] Bi(03i1	62+50.00	68+00.00	0	0	0.00	4012	0	100	0	1395	0	0	634	0.0	0	0	0	0	0	0	0	0	0	0	0
5		68+00.00	73+50.00	0	0	0.00	4047	0	243	0	1090	0	0	0	0.0	0	0	0	0	0	0	0	0	0	0	0
6		73+50.00	76+25.97	0	0	0.00	1292	0	76	0	361	0	0	0	0.0	0	0	0	0	0	0	0	0	0	0	0
7		205+18.73	208+00.00	0	0	0.00	1210	156	161	0	782	0	0	2382	0.0	0	0	0	0	0	0	0	0	0	0	0
8		208+00.00	213+25.00	0	0	0.00	6055	250	43	0	1724	0	0	1898	0.0	0	0	0	0	0	0	0	0	660	0	0
9	FARIES	213+25.00	219+00.00	0	0	0.00	3051	0	184	0	1553	0	0	0	0.0	0	0	0	0	0	0	0	0	2917	332	0
10	TARIES	219+00.00	224+75.00	22	0	0.50	2349	0	1733	0	1035	0	0	0	0.0	0	0	0	0	2	32	138	0	0	403	0
11		224+75.00	230+50.00	0	0	1.25	2369	0	26	0	1123	0	0	0	2.5	203	0	0	0	0	0	0	0	0	0	0
12		230+50.00	235+41.47	0	0	0.25	2162	0	114	0	918	0	0	0	0.0	0	0	0	0	0	0	0	0	0	0	0
13	JUG	301+75.00	306+50.00	0	18	0.00	1142	0	106	0	0	0	0	0	0.0	0	0	0	0	0	0	0	0	0	0	0
14	LOGAN	601+50.00	607+50.00	0	0	0.00	1814	0	28	0	0	0	0	0	0.0	0	0	45	0	2	0	0	0	0	0	0
15	JAMES	607+50.00	407+75.00	6	20	0.75	762	0	0	0	0	0	0	0	4.7	0	0	0	7	0	0	0	0	0	347	0
16	HARRISON W	800+00.00	804+50.00	26	60	0.00	261	0	0	0	0	0	0	0	0.0	0	0	0	0	0	28	0	0	0	66	0
17	TIARRISON W	804+50.00	810+00.00	0	0	0.00	0	0	0	0	0	0	0	0	3.7	0	0	844	0	0	0	0	0	0	66	0
18	HARRISON E	701+00.00	705+00.00	0	0	0.00	463	756	175	0	491	0	0	0	0.0	0	0	25	0	0	0	0	0	0	0	0
19	TIANNISON E	705+00.00	708+41.73	0	0	0.00	0	1051	169	0	303	0	0	0	0.0	0	0	0	0	0	0	0	0	0	0	0
20	CEMETERY	900+00.00	904+52.12	32	102	0.00	0	0	0	0	0	0	0	0	0.0	0	0	0	0	0	0	0	0	0	80	0
	1880 Bru	ısh College Rd		0	0	0.00	1916	0	0	0	0	922	0	0	0.0	0	0	0	0	0	0	0	0	0	0	0
	1940 Bru	ısh College Rd		0	0	0.00	3320	0	0	0	0	632	0	0	1.8	0	0	0	0	0	0	0	0	0	0	70
	1980 Bru	ısh College Rd		0	0	0.00	7004	0	0	0	0	0	0	0	15.0	0	0	0	0	0	0	0	0	0	0	150
	391	5 E Faries		12	0	0.00	1246	0	0	0	0	0	0	0	0.0	0	0	0	0	0	0	0	0	0	0	30
	392!	5 E Faries		12	60	0.00	1967	0	0	0	0	0	0	0	0.0	129	0	0	0	0	0	0	0	0	0	100
	3941	. E Faries		0	0	0.00	286	0	0	0	0	0	0	0	0.0	0	0	0	0	0	0	0	0	0	0	0
	414	7 E Faries		0	0	0.25	0	0	0	0	0	0	0	0	29.0	0	0	0	0	0	0	0	0	0	0	50
Under IC RR				0	0	0.00	0	0	0	0	0	0	0	0	0.0	0	0	0	0	0	0	0	0	0	0	0
	4083	3 E Faries		0	0	0.00	0	0	0	0	0	0	0	0	0.0	0	0	0	0	0	0	0	0	0	0	0
																	1									
		TOTAL		110	284	3.00	54472	2213	3389	120	13498	5186	117	5911	56.7	1522	1	914	7	4	60	138	2969	4328	1782	400

"	AECOM
	345 EAST ASH AVENUE DECATUR, IL 62526 PHONE: (217) 775-6065

DRAWN - LMB REVISED -	USER NAME = busanskyl	DESIGNED - LMB	REVISED -
		DRAWN - LMB	REVISED -
PLOT DATE = 5/5/2021 DATE - 4/30/2021 REVISED -	PLOT SCALE = 20.0000 ' / in.	CHECKED - WBS	REVISED -
	PLOT DATE = 5/5/2021	DATE - 4/30/2021	REVISED -

								F.A.U. RTE	SECT	ΓΙΟΝ		COUNTY	TOTAL SHEETS	SHEET NO.
			KUAL	JWA	Y SCH	EDULE		7448	09-00933	3-01-BR		MACON	1019	57
												CONTRA	CT NO.	95893
ALE: N/A	SHEET	3	OF	16	SHEETS	STA.	TO STA.			ILLINOIS	FED. All	D PROJECT		

REMOVAL SCHEDULE

				BACKFILL PLUGS	ENGINEERED BARRIER	FENCE REMOVAL	FILLING EXISTING CISTERNS	FILLING EXISTING SEPTIC TANK	FILLING EXISTING WELLS	SELECTIVE CLEARING	GATE REMOVAL	TEMPORARY CHAIN LINK FENCE
SHEET	ROAD	CU YD	SQ YD	FOOT	EACH	EACH	EACH	ACRE	EACH	FOOT		
1		46+59.44	52+00.00	0	0	0	0	0	0	0.00	0	0
2]	52+00.00	57+75.00	0	0	0	0	0	0	0.00	0	0
3	BRUSH	57+75.00	62+50.00	0	0	0	0	0	0	0.00	0	0
4	BROSII	62+50.00	68+00.00	0	0	0	0	0	0	0.00	0	0
5		68+00.00	73+50.00	0	0	0	0	0	0	0.00	0	0
6		73+50.00	76+25.97	0	0	0	0	0	0	0.00	0	0
7		205+18.73	208+00.00	0	0	0	0	0	0	0.00	0	0
8		208+00.00	213+25.00	0	0	0	0	0	0	0.00	0	0
9	FARIES	213+25.00	219+00.00	0	0	0	0	0	0	0.00	0	0
10	TARIES	219+00.00	224+75.00	0	0	0	0	0	0	0.00	0	0
11		224+75.00	230+50.00	0	0	0	0	0	0	0.00	0	0
12		230+50.00	235+41.47	0	0	0	0	0	0	0.00	0	0
13	JUG	301+75.00	306+50.00	0	0	0	0	0	0	0.00	0	0
14	LOGAN	601+50.00	607+50.00	0	0	0	0	0	0	0.00	0	0
15	JAMES	607+50.00	407+75.00	0	0	0	0	0	0	0.00	0	0
16	HARRISON W	800+00.00	804+50.00	0	0	0	0	0	0	0.00	0	0
17	TIARRIUSON W	804+50.00	810+00.00	0	0	0	0	0	0	0.00	0	0
18	HARRISON E	701+00.00	705+00.00	0	0	0	0	0	0	0.00	0	0
19	TIARRISON E	705+00.00	708+41.73	0	0	0	0	0	0	0.00	0	0
20	CEMETERY	900+00.00	904+52.12	0	0	0	0	0	0	0.00	0	0
	1880 Bru	sh Col l ege Rd		0	0	0	0	1	1	0.25	0	0
	1940 Bru	sh Col l ege Rd		0	0	305	0	1	0	0.25	2	0
	1980 Bru	sh College Rd		90	140	811	0	2	1	0.25	3	0
	3915	E Faries		0	0	0	0	1	1	0.25	0	0
	3925	E Faries		0	0	0	0	1	1	0.00	0	0
	3941	E Faries		0	0	375	0	1	1	0.75	3	298
	4147	7 E Faries		40	0	32	1	1	1	0.25	1	240
	Und	ler IC RR		50	0	0	0	0	0	0.00	0	
	4083	B E Faries		0	0	0	0	0	0	0.00	2	0
				1	1							
		TOTAL		180	140	1523	1	8	6	2.00	11	538

11	AECOM
	345 EAST ASH AVENUE DECATUR, IL 62526

USER NAME = busanskyl	DESIGNED	-	LMB	REVISED -
	DRAWN	-	LMB	REVISED -
PLOT SCALE = 20.0000 ' / in.	CHECKED	-	WBS	REVISED -
PLOT DATE = 5/6/2021	DATE	-	4/30/2021	REVISED -

STATE	0F	ILLINOIS
DEPARTMENT	0F	TRANSPORTATION

								F.A.U. RTE	SEC ⁻	TION		COUNTY	TOTAL SHEETS	SHEET NO.
			ROAI	JVVP	AY SCH	EDULE		7448	09-0093	3-01-BR		MACON	1019	58
												CONTR	ACT NO.	95893
ALE: N/A	SHEET	4	OF	16	SHEETS	STA.	TO STA.			ILLINOIS	FED. AID	PROJECT		

-pw.bentley.com.AECOM_DS16_NA(Documents)60603202-Brush Callege(900-CAD_GIS)910_CAD(03_SHEETS)01_AECOM/Removal60603202_SHT_Removal_Schedule_02.dgr

ALIGNMENT					EAR	TH EXCAVA 20200100	TION		EXCAVATIO		SED IN EMI ITEM) EXCAVATION	BANKMENT (I	NOT A PAY		EMBANKMI	ENT (NOT A (NOTE 2)	PAY ITEM)				RK BALANCE DRTAGE (-) (20400800		
ALI				CU YD	CU YD	CU YD	CU YD	CU YD	CU YD	CU YD	CU YD	CU YD	CU YD	CU YD	CU YD	CU YD	CU YD	CU YD	CU YD	CU YD	CU YD	CU YD	CU YD
	STATION	то	STATION	STAGE 1	STAGE 2	STAGE 3	STAGE 4	STAGE 5	STAGE 1	STAGE 2	STAGE 3A	STAGE 4C	STAGE 5	STAGE 1	STAGE 2	STAGE 3A	STAGE 4C	STAGE 5	STAGE 1	STAGE 2	STAGE 3A	STAGE 4C	STAGE 5
	46+59.43	ТО	46+75.00	10	0	0	0	0	8	0	0	0	0	0	0	0	0	0	+8	0	0	0	0
	46+75.00	TO	47+00.00	20	0	0	0	0	15	0	0	0	0	0	0	0	0	0	+15	0	0	0	0
	47+00.00	TO	47+25.00	30	0	0	0	0	23	0	0	0	0	0	0	0	0	0	+23	0	0	0	0
	47+25.00	TO	47+50.00	36	0	0	0	0	27	0	0	0	0	0	0	0	0	0	+27	0	0	0	0
	47+50.00	TO	47+75.00	37	0	0	0	0	28	0	0	0	0	0	0	0	0	0	+28	0	0	0	0
	47+75.00	TO	48+00.00	40	0	0	0	0	30	0	0	0	0	0	0	0	0	0	+30	0	0	0	0
	48+00.00	TO	48+25.00	42	0	0	0	0	32	0	0	0	0	0	0	0	0	0	+32	0	0	0	0
	48+25.00	TO	48+50.00	45	0	0	0	0	34	0	0	0	0	0	0	0	0	0	+34	0	0	0	0
	48+50.00	TO	48+75.00	50	0	0	0	0	38	0	0	0	0	1	0	0	0	0	+37	0	0	0	0
	48+75.00	TO	49+00.00	61	0	0	0	0	46	0	0	0	0	2	0	0	0	0	+44	0	0	0	0
	49+00.00	TO	49+25.00	74	0	0	0	0	56	0	0	0	0	4	0	0	0	0	+52	0	0	0	0
	49+25.00	TO	49+50.00	88	0	0	0	0	66	0	0	0	0	5	0	0	0	0	+61	0	0	0	0
	49+50.00	TO	49+75.00	106	0	0	0	0	80	0	0	0	0	6	0	0	0	0	+74	0	0	0	0
	49+75.00	TO	50+00.00	133	0	0	0	0	100	0	0	0	0	8	0	0	0	0	+92	0	0	0	0
	50+00.00	TO	50+25.00	160	0	0	0	0	120	0	0	0	0	10	0	0	0	0	+110	0	0	0	0
	50+25.00	TO	50+50.00	180	0	0	0	0	135	0	0	0	0	11	0	0	0	0	+124	0	0	0	0
	50+50.00	TO	50+75.00	191	0	0	0	0	143	0	0	0	0	12	0	0	0	0	+131	0	0	0	0
	50+75.00	TO	51+00.00	191	0	0	0	0	143	0	0	0	0	13	0	0	0	0	+130	0	0	0	0
	51+00.00	TO	51+25.00	181	0	0	0	0	136	0	0	0	0	13	0	0	0	0	+123	0	0	0	0
ROAD	51+25.00	TO	51+50.00	162	0	0	0	0	122	0	0	0	0	12	0	0	0	0	+110	0	0	0	0
	51+50.00	TO	51+75.00	129	0	0	0	0	97	0	0	0	0	11	0	0	0	0	+86	0	0	0	0
EGE	51+75.00	TO	52+00.00	55	39	0	0	0	41	29	0	0	0	16	14	0	0	12	+25	+15	0	0	-12
COLLE	52+00.00	TO	52+25.00	1	69	0	0	0	1	52	0	0	0	11	59	0	0	32	-10	-8	0	0	-32
	52+25.00	TO	52+50.00	0	33	0	0	0	0	25	0	0	0	0	177	0	0	50	0	-153	0	0	- 50
BRUSH	52+50.00	TO	52+75.00	0	54	0	0	0	0	41	0	0	0	0	107	0	0	71	0	-66	0	0	-71
BRI	52+75.00	TO	53+00.00	0	59	0	0	0	0	44	0	0	0	0	217	0	0	89	0	-173	0	0	-89
	53+00.00	TO	53+25.00	0	19	0	0	0	0	14	0	0	0	0	310	0	0	106	0	-296	0	0	-106
	53+25.00	TO	53+50.00	0	20	0	0	0	0	15	0	0	0	0	427	0	0	124	0	-412	0	0	-124
	53+50.00	TO	53+75.00	0	18	0	0	0	0	14	0	0	0	0	462	0	0	138	0	-449	0	0	-138
	53+75.00	TO	54+00.00	0	13	0	0	0	0	10	0	0	0	0	518	0	0	108	0	-508	0	0	-108
	54+00.00	TO	54+25.00	0	13	0	0	0	0	10	0	0	0	0	633	0	0	75	0	-623	0	0	-75
	54+25.00	TO	54+50.00	0	7	0	0	0	0	5	0	0	0	0	710	0	0	88	0	- 705	0	0	-88
	54+50.00	TO	54+75.00	0	0	0	0	0	0	0	0	0	0	0	776	0	0	117	0	-776	0	0	-117
	54+75.00	TO	55+00.00	0	0	0	0	0	0	0	0	0	0	0	723	0	0	162	0	-723	0	0	-162
	55+00.00	TO	55+25.00	0	0	0	0	0	0	0	0	0	0	0	751	0	0	205	0	-751	0	0	-205
	55+25.00	TO	55+50.00	0	0	0	0	0	0	0	0	0	0	0	768	0	0	196	0	-768	0	0	-196
	55+50.00	TO	55+75.00	0	0	0	0	0	0	0	0	0	0	0	788	0	0	186	0	- 788	0	0	-186
	55+75.00	TO	56+00.00	0	0	0	0	0	0	0	0	0	0	0	818	0	0	201	0	-818	0	0	-201
	56+00.00	TO	56+25.00	0	0	0	0	0	0	0	0	0	0	0	843	0	0	193	0	-843	0	0	-193
	56+25.00	TO	56+50.00	0	0	0	0	0	0	0	0	0	0	0	806	0	0	190	0	-806	0	0	-190
	56+50.00	TO	56+75.00	0	0	0	0	0	0	0	0	0	0	0	828	0	0	205	0	-828	0	0	-205
	56+75.00	TO	57+00.00	0	0	0	0	0	0	0	0	0	0	0	0	0	0	1,125	0	0	0	0	-1,125
	57+00.00	TO	57+25.00	0	0	0	0	8	0	0	0	0	6	0	0	0	0	1,967	0	0	0	0	-1,961
	57+25.00	TO	57+50.00	0	0	0	0	17	0	0	0	0	13	0	0	0	0	1,928	0	0	0	0	-1,915
	57+50.00	ТО	57+75.00	0	0	0	0	18	0	0	0	0	14	0	0	0	0	1,995	0	0	0	0	-1,982

NOTES

- 1. ESTIMATED SHRINKAGE FACTOR=25%
 2. APPROXIMATE EMBANKMENT QUANTITY IS SHOWN FOR INFORMATION ONLY
 3. APPROXIMATE EARTHWORK BALANCE IS USED TO ESTIMATE FURNISHED EXCAVATION
 4. EARTH EXCAVATION TOTAL IS ROUNDED UP TO THE NEAREST 5 CU YD
 5. ESTIMATED 5% OF EARTH EXCAVATION CONSIDERED UNUSABLE FOR EMBANKMENT AND PAID FOR AS REMOVAL AND DISPOSAL OF UNSUITABLE MATERIAL
 6. ESTIMATED EARTH EXCAVATION QUANTITY DESIGNATED AS NON-SPECIAL WASTE DISPOSAL NOT TO BE REUSED AS FURNISHED EXCAVATION



USER NAME = busanskyl	DESIGNED	-	LMB	REVISED	=
	DRAWN	-	LMB	REVISED	=
PLOT SCALE = 20.0000 / in.	CHECKED	-	WBS	REVISED	=
PLOT DATE = 5/5/2021	DATE	_	4/30/2021	REVISED	-

								F.A.U. RTE	SECTION		COUNTY	TOTAL SHEETS	SHEET NO.
			ROAL	JVVP	Y SCH	EDULE		7448	09-00933-01-BF	₹	MACON	1019	59
											CONTRA	CT NO.	95893
SCALE: N/A	SHEET	5	OF	16	SHEETS	STA.	TO STA.		ILLINO!	FED. AI	D PROJECT		

STATING TO STATING	ALIGNMENT					EAR	TH EXCAVA 20200100	TION		EXCAVATIO		SED IN EME ITEM) EXCAVATION	BANKMENT (NOT A PAY		EMBANKM	ENT (NOT A (NOTE 2)	PAY ITEM)				RK BALANCE DRTAGE (-) (20400800		
Value Value Valu	ALI				CU YD	CU YD	CU YD	CU YD	CU YD	CU YD	CU YD	CU YD	CU YD	CU YD	CU YD	CU YD	CU YD	CU YD	CU YD	CU YD	CU YD	CU YD	CU YD	CU YD
Section Section Sect		STATION	то	STATION	STAGE 1	STAGE 2	STAGE 3	STAGE 4	STAGE 5	STAGE 1	STAGE 2	STAGE 3A	STAGE 4C	STAGE 5	STAGE 1	STAGE 2	STAGE 3A	STAGE 4C	STAGE 5	STAGE 1	STAGE 2	STAGE 3A	STAGE 4C	STAGE 5
\$\$\frac{\$\frac{9}{2}\text{0}}{\frac{9}{2}\text{0}}\$\$\frac{9}{2}\text{0}}\$\frac{9}{2}\text{0}{2}\text{0}{2}\text{0}{2}\text{0}{2}\text{0}{2}\text{0}{2}\text{0}{2}\text{0}{2}\text{0}{2}\text{0}{2}\text{0}{2}\text{0}{2}\text{0}{2}\text{0}{2}\text{0}{2}\text{0}{2}\text{0}{2}\text{0}{2}\text{0}{2}\text{0}{2}\text{0}{2}\text{0}{2}\text{0}{2}\text{0}{2}\text{0}{2}\text{0}{2}\text{0}{2}\text{0}{2}\text{0}{2}\text{0}{2}\text{0}{2}\text{0}{2}\text{0}{2}\text{0}{2}\text{0}{2}\text{0}{2}\text{0}{2}\text{0}{2}\text{0}{2}\text{0}{2}\text{0}{2}\text{0}{2}\text{0}{2}\text{0}{2}\text{0}{2}\text{0}{2}\text{0}{2}\text{0}{2}\text{0}{2}\text{0}{2}\text{0}{2}\text{0}{2}\text{0}{2}\text{0}{2}\text{0}{2}\text{0}{2}\text{0}{2}\text{0}{2}\text{0}{2}\text{0}{2}\text{0}{2}\text{0}{2}\text{0}{2}\text{0}{2}\text{0}{2}\text{0}{2}\text{0}{2}\text{0}{2}\text{0}{2}\text{0}{2}\text{0}{2}\text{0}{2}\text{0}{2}\text{0}{2}\text{0}{2}\text{0}{2}\text{0}{2}\text{0}{2}\text{0}{2}\text{0}{2}\text{0}{2}\text{0}{2}\text{0}{2}\text{0}{2}\text{0}{2}\text{0}{2}\text{0}{2}\text{0}{2}\text{0}{2}\text{0}{2}\text{0}{2}\text{0}{2}\text{0}{2}\text{0}{2}\text{0}{2}\text{0}{2}\text{0}{2}\text{0}{2}\text{0}{2}\text{0}{2}\text{0}{2}\text{0}{2}\text{0}{2}\text{0}{2}\text{0}{2}\text{0}{2}\text{0}{2}\text{0}{2}\text{0}{2}\text{0}{2}\text{0}{2}\text{0}{2}\text{0}{2}\text{0}{2}\text{0}{2}\text{0}{2}\text{0}{2}\text{0}{2}\text{0}{2}\text{0}{2}\text{0}{2}\text{0}{2}\text{0}{2}\text{0}{2}\text{0}{2}\text{0}{2}\text{0}{2}\text{0}{2}\text{0}{2}\text{0}{2}\text{0}{2}\text{0}{2}\text{0}{2}\text{0}{2}\text{0}{2}\text{0}{2}\text{0}{2}\text{0}{2}\text{0}{2}\text{0}{2}\text{0}{2}\text{0}{2}\text{0}{2}\text{0}{2}\text{0}{2}\text{0}{2}\text{0}{2}\text{0}{2}\text{0}{2}\text{0}{2}\text{0}{2}\text{0}{2}\text{0}{2}\text{0}{2}\text{0}{2}\text{0}{2}\text{0}{2}\text{0}{2}\text{0}{2}\text{0}{2}\text{0}{2}\text{0}{2}\text{0}{2}\text{0}{2}\text{0}{2}\text{0}{2}\text{0}{2}\text{0}{2}\text{0}{2}\text{0}{2}\text{0}{2}\text{0}{2}\text{0}{2}\text{0}{2}\text{0}{2}\text{0}{2}\text{0}{2}\text{0}{2}\tex		57+75.00	ТО	58+00.00	0	0	0	0	27	0	0	0	0	20	0	0	0	0	2,085	0	0	0	0	-2,065
Selection 1		58+00.00	TO	58+25.00	0	0	0	0	88	0	0	0	0	66	0	0	0	0	2,173	0	0	0	0	-2,107
\$\ \ \ \ \ \ \ \ \ \ \ \ \ \ \ \ \ \ \		58+25.00	TO	58+50.00	0	0	0	0	189	0	0	0	0	142	0	0	0	0	2,213	0	0	0	0	-2,071
Second 10 Second 10 58+50.00	TO	58+75.00	0	0	0	0	283	0	0	0	0	212	0	0	0	0	2,173	0	0	0	0	-1,961
Second 100		58+75.00	TO	59+00.00	0	0	0	0	379	0	0	0	0	284	0	0	0	0	2,161	0	0	0	0	-1,877
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## 14		59+25.00	ТО	59+50.00	0	0	0	0	445	0	0	0	0	334	0	0	0	0	2,073	0	0	0	0	-1,739
091-93 20 10 091-25 29 0 0 0 0 0 0 0 0 0		59+50.00		59+75.00	0	0	0	0	351	0	0	0	0	263	0	0	0	0	1,863	0	0	0	0	-1,600
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NOTES

- 1. ESTIMATED SHRINKAGE FACTOR=25%
 2. APPROXIMATE EMBANKMENT QUANTITY IS SHOWN FOR INFORMATION ONLY
 3. APPROXIMATE EARTHWORK BALANCE IS USED TO ESTIMATE FURNISHED EXCAVATION
 4. EARTH EXCAVATION TOTAL IS ROUNDED UP TO THE NEAREST 5 CU YD
 5. ESTIMATED 5% OF EARTH EXCAVATION CONSIDERED UNUSABLE FOR EMBANKMENT AND PAID FOR AS REMOVAL AND DISPOSAL OF UNSUITABLE MATERIAL
 6. ESTIMATED EARTH EXCAVATION QUANTITY DESIGNATED AS NON-SPECIAL WASTE DISPOSAL NOT TO BE REUSED AS FURNISHED EXCAVATION

"	AECOM
	345 EAST ASH AVENUE DECATUR, IL 62526 PHONE: (217) 775-6065

USER NAME = busanskyl	DESIGNED -		LMB	REVISED	-
	DRAWN -	-	LMB	REVISED	-
PLOT SCALE = 20.0000 ' / in.	CHECKED -	-	WBS	REVISED	-
PLOT DATE = 5/5/2021	DATE -		4/30/2021	REVISED	-

								F.A.U. RTE	SECTION	COUNTY	TOTAL SHEETS	SHEET NO.
			KUAL	JVVP	Y SCH	FDULE		7448	09-00933-01-BR	MACON	1019	60
										CONTRA	CT NO.	95893
SCALE: N/A	SHEET	6	OF	16	SHEETS	STA.	TO STA.		ILLINOIS FED. AI	D PROJECT		

ALIGNMENT					EAR	TH EXCAVA 20200100	TION		EXCAVATIO		JSED IN EME ITEM) EXCAVATION	,	NOT A PAY		EMBANKMI	ENT (NOT A (NOTE 2)	PAY ITEM)				RK BALANCE DRTAGE (-) (20400800	WASTE (+)	
, ALI				CU YD	CU YD	CU YD	CU YD	CU YD	CU YD	CU YD	CU YD	CU YD	CU YD	CU YD	CU YD	CU YD	CU YD	CU YD	CU YD	CU YD	CU YD	CU YD	CU YD
	STATION	то	STATION	STAGE 1	STAGE 2	STAGE 3	STAGE 4	STAGE 5	STAGE 1	STAGE 2	STAGE 3A	STAGE 4C	STAGE 5	STAGE 1	STAGE 2	STAGE 3A	STAGE 4C	STAGE 5	STAGE 1	STAGE 2	STAGE 3A	STAGE 4C	STAGE 5
	70+50.00	TO	70+75.00	0	0	57	0	0	0	0	43	0	0	0	0	8	0	0	0	0	+35	0	0
	70+75.00	ТО	71+00.00	0	0	64	0	0	0	0	48	0	0	0	0	3	0	0	0	0	+45	0	0
	71+00.00	TO	71+25.00	0	0	66	0	0	0	0	50	0	0	0	0	2	0	0	0	0	+48	0	0
	71+25.00	ТО	71+50.00	0	0	63	0	0	0	0	47	0	0	0	0	2	0	0	0	0	+45	0	0
	71+50.00	TO	71+75.00	0	0	58	0	0	0	0	44	0	0	0	0	2	0	0	0	0	+42	0	0
	71+75.00	TO	72+00.00	0	0	49	0	0	0	0	37	0	0	0	0	1	0	0	0	0	+36	0	0
	72+00.00	ТО	72+25.00	13	0	22	12	0	10	0	17	9	0	0	0	0	2	0	+10	0	+17	+7	0
	72+25.00	TO	72+50.00	29	0	0	23	0	22	0	0	17	0	3	0	0	5	0	+19	0	0	+12	0
ROAD	72+50.00	ТО	72+75.00	43	0	0	20	0	32	0	0	15	0	5	0	0	6	0	+27	0	0	+9	0
l m	72+75.00	TO	73+00.00	42	0	0	19	0	32	0	0	14	0	3	0	0	5	0	+29	0	0	+9	0
COLLEGE	73+00.00	TO	73+25.00	23	0	0	19	0	17	0	0	14	0	3	0	0	2	0	+14	0	0	+12	0
点 [73+25.00	ТО	73+50.00	14	0	0	17	0	11	0	0	13	0	4	0	0	0	0	+7	0	0	+13	0
±	73+50.00	TO	73+75.00	14	0	0	14	0	11	0	0	11	0	4	0	0	0	0	+7	0	0	+11	0
BRUSH	73+75.00	TO	74+00.00	14	0	0	13	0	11	0	0	10	0	3	0	0	4	0	+8	0	0	+6	0
º [74+00.00	TO	74+25.00	17	0	0	16	0	13	0	0	12	0	2	0	0	8	0	+11	0	0	+4	0
	74+25.00	TO	74+50.00	20	0	0	22	0	15	0	0	17	0	1	0	0	4	0	+14	0	0	+13	0
	74+50.00	TO	74+75.00	22	0	0	28	0	17	0	0	21	0	1	0	0	0	0	+16	0	0	+21	0
	74+75.00	TO	75+00.00	25	0	0	32	0	19	0	0	24	0	1	0	0	0	0	+18	0	0	+24	0
	75+00.00	TO	75+25.00	26	0	0	32	0	20	0	0	24	0	0	0	0	0	0	+20	0	0	+24	0
	75+25.00	ТО	75+44.21	21	0	0	24	0	16	0	0	18	0	0	0	0	0	0	+16	0	0	+18	0
	BRUSH CO	OLLEGE SU	B-TOTALS	3,233	344	483	291	3,052	2,425	258	362	218	2,289	169	10,737	238	36	34,560	2,256	-10,479	124	182	-32,271
	404+27.90	ТО	404+50.00	37	0	0	0	0	28	0	0	0	0	0	0	0	0	0	+28	0	0	0	0
	404+50.00	то	404+75.00	74	0	0	0	0	56	0	0	0	0	0	0	0	0	0	+56	0	0	0	0
-	404+75.00	то	405+00.00	104	0	0	0	0	78	0	0	0	0	0	0	0	0	0	+78	0	0	0	0
-	405+00.00	то	405+25.00	139	0	0	0	0	104	0	0	0	0	0	0	0	0	0	+104	0	0	0	0
	405+25.00	ТО	405+50.00	143	0	0	0	0	107	0	0	0	0	0	0	0	0	0	+107	0	0	0	0
	405+50.00	TO	405+75.00	144	0	0	0	0	108	0	0	0	0	0	0	0	0	0	+108	0	0	0	0
	405+75.00	TO	406+00.00	156	0	0	0	0	117	0	0	0	0	0	0	0	0	0	+117	0	0	0	0
	406+00.00	TO	406+25.00	154	0	0	0	0	116	0	0	0	0	0	0	0	0	0	+116	0	0	0	0
YEET	406+25.00	TO	406+50.00	169	0	0	0	0	127	0	0	0	0	0	0	0	0	0	+127	0	0	0	0
STR	406+50.00	TO	406+75.00	190	0	0	0	0	143	0	0	0	0	0	0	0	0	0	+143	0	0	0	0
JAMES	406+75.00	ТО	407+00.00	228	0	0	0	0	171	0	0	0	0	0	0	0	0	0	+171	0	0	0	0
A N	407+00.00	TO	407+25.00	263	0	0	0	0	197	0	0	0	0	0	0	0	0	0	+197	0	0	0	0
	407+25.00	TO	407+50.00	291	0	0	0	0	218	0	0	0	0	0	0	0	0	0	+218	0	0	0	0
	407+50.00	TO	407+75.00	322	0	0	0	0	242	0	0	0	0	0	0	0	0	0	+242	0	0	0	0
	407+75.00	TO	408+00.00	366	0	0	0	0	275	0	0	0	0	0	0	0	0	0	+275	0	0	0	0
	408+00.00	ТО	408+25.00	443	0	0	0	0	332	0	0	0	0	0	0	0	0	0	+332	0	0	0	0
	408+25.00	TO	408+50.00	522	0	0	0	0	392	0	0	0	0	0	0	0	0	0	+392	0	0	0	0
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	JAME	ES SUB-TO	TALS	3,745	0	0	0	0	2,809	0	0	0	0	0	0	0	0	0	2,809	0	0	0	0

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 6. ESTIMATED EARTH EXCAVATION QUANTITY DESIGNATED AS NON-SPECIAL WASTE DISPOSAL NOT TO BE REUSED AS FURNISHED EXCAVATION



USER NAME = busanskyl	DESIGNED -	-	LMB	REVISED	-
	DRAWN -	-	LMB	REVISED	-
PLOT SCALE = 20.0000 / in.	CHECKED -	-	WBS	REVISED	-
PLOT DATE = 5/5/2021	DATE -	-	4/30/2021	REVISED	-

								F.A.U. RTE	SECTION		COUNTY	TOTAL SHEETS	SHEET NO.
			ROA	DWF	Y SCH	EDULE		7448	09-00933-01-BR		MACON	1019	61
											CONTRA	CT NO.	95893
SCALE: N/A	SHEET	7	OF	16	SHEETS	STA.	TO STA.		ILLINOIS F	ED. AID	PROJECT		

ALIGNMENT					EAR	TH EXCAVA 20200100	TION		EXCAVATIO		SED IN EME ITEM) EXCAVATION	BANKMENT (NOT A PAY		EMBANKM	ENT (NOT A (NOTE 2)	. PAY ITEM)				RK BALANCE DRTAGE (-) (20400800		
ALI				CU YD	CU YD	CU YD	CU YD	CU YD	CU YD	CU YD	CU YD	CU YD	CU YD	CU YD	CU YD	CU YD	CU YD	CU YD	CU YD	CU YD	CU YD	CU YD	CU YD
	STATION	то	STATION	STAGE 1	STAGE 2	STAGE 3	STAGE 4	STAGE 5	STAGE 1	STAGE 2	STAGE 3A	STAGE 4C	STAGE 5	STAGE 1	STAGE 2	STAGE 3A	STAGE 4C	STAGE 5	STAGE 1	STAGE 2	STAGE 3A	STAGE 4C	STAGE 5
	205+18.40	ТО	205+25.00	0	0	8	4	0	0	0	6	3	0	0	0	0	0	0	0	0	+6	+3	0
	205+25.00	TO	205+50.00	0	0	31	15	0	0	0	23	11	0	0	0	1	0	0	0	0	+22	+11	0
	205+50.00	TO	205+75.00	0	0	34	20	0	0	0	26	15	0	0	0	3	0	0	0	0	+23	+15	0
	205+75.00	TO	206+00.00	0	0	36	20	0	0	0	27	15	0	0	0	3	0	0	0	0	+24	+15	0
	206+00.00	TO	206+25.00	0	0	40	9	0	0	0	30	7	0	0	0	2	0	0	0	0	+28	+7	0
	206+25.00	TO	206+50.00	0	0	42	0	0	0	0	32	0	0	0	0	4	0	0	0	0	+28	0	0
	206+50.00	TO	206+75.00	0	0	39	6	0	0	0	29	5	0	0	0	10	0	0	0	0	+19	+5	0
	206+75.00	TO	207+00.00	0	0	36	11	0	0	0	27	8	0	0	0	14	0	0	0	0	+13	+8	0
	207+00.00	TO	207+25.00	0	0	34	6	0	0	0	26	5	0	0	0	14	0	0	0	0	+12	+5	0
	207+25.00	TO	207+50.00	0	0	31	0	0	0	0	23	0	0	0	0	18	0	0	0	0	+5	0	0
	207+50.00	TO	207+75.00	0	0	17	4	0	0	0	13	3	0	0	0	26	0	0	0	0	-13	+3	0
	207+75.00	TO	208+00.00	0	0	9	10	0	0	0	7	8	0	0	0	19	2	0	0	0	-12	+6	0
	208+00.00	TO	208+25.00	0	0	18	10	0	0	0	14	8	0	0	0	5	8	0	0	0	+9	-1	0
	208+25.00	TO	208+50.00	0	0	26	10	0	0	0	20	8	0	0	0	16	10	0	0	0	+4	-3	0
	208+50.00	TO	208+75.00	0	0	27	11	0	0	0	20	8	0	0	0	28	7	0	0	0	-8	+1	0
	208+75.00	TO	209+00.00	0	0	29	20	0	0	0	22	15	0	0	0	27	13	0	0	0	-5	+2	0
	209+00.00	TO	209+25.00	0	0	35	30	0	0	0	26	23	0	0	0	25	13	0	0	0	+1	+10	0
	209+25.00	TO	209+50.00	0	0	44	28	0	0	0	33	21	0	0	0	20	9	0	0	0	+13	+12	0
	209+50.00	TO	209+75.00	0	0	24	13	0	0	0	18	10	0	0	0	8	5	0	0	0	+10	+5	0
	209+75.00	TO	210+00.00	0	0	16	12	0	0	0	12	9	0	0	0	5	9	0	0	0	+7	0	0
\ A \	210+00.00	TO	210+25.00	0	0	32	27	0	0	0	24	20	0	0	0	21	16	0	0	0	+3	+4	0
PARKWAY	210+25.00	TO	210+50.00	0	0	27	32	0	0	0	20	24	0	0	0	45	15	0	0	0	-25	+9	0
	210+50.00	TO	210+75.00	0	0	25	31	0	0	0	19	23	0	0	0	66	18	0	0	0	-47	+5	0
IES	210+75.00	TO	211+00.00	0	0	31	26	0	0	0	23	20	0	0	0	48	19	0	0	0	-25	+1	0
FARIES	211+00.00	TO	211+25.00	0	0	74	27	0	0	0	56	20	0	0	0	17	18	0	0	0	+39	+2	0
	211+25.00	TO	211+50.00	0	0	133	34	0	0	0	100	26	0	0	0	5	15	0	0	0	+95	+11	0
	211+50.00	TO	211+75.00	0	0	149	36	0	0	0	112	27	0	0	0	1	12	0	0	0	+111	+15	0
	211+75.00	TO	212+00.00	0	0	172	35	0	0	0	129	26	0	0	0	1	11	0	0	0	+128	+15	0
	212+00.00	TO	212+25.00	0	0	216	36	0	0	0	162	27	0	0	0	0	10	0	0	0	+162	+17	0
	212+25.00	TO	212+50.00	0	0	249	34	0	0	0	187	26	0	0	0	0	10	0	0	0	+187	+16	0
	212+50.00	TO	212+75.00	0	0	273	29	0	0	0	205	22	0	0	0	0	11	0	0	0	+205	+11	0
	212+75.00	ТО	213+00.00	0	0	288	26	0	0	0	216	20	0	0	0	0	12	0	0	0	+216	+8	0
	213+00.00	ТО	213+25.00	0	0	297	22	0	0	0	223	17	0	0	0	0	12	0	0	0	+223	+5	0
	213+25.00	TO	213+50.00	0	0	296	19	0	0	0	222	14	0	0	0	0	10	0	0	0	+222	+4	0
	213+50.00	TO	213+75.00	0	118	167	23	0	0	89	125	17	0	0	0	0	8	0	0	+89	+125	+9	0
	213+75.00	TO	214+00.00	0	225	23	31	0	0	169	17	23	0	0	3	0	12	0	0	+166	+17	+11	0
	214+00.00	ТО	214+25.00	0	211	0	38	0	0	158	0	29	0	0	6	0	10	0	0	+152	0	+19	0
	214+25.00	ТО	214+50.00	0	240	0	42	0	0	180	0	32	0	0	5	0	4	0	0	+175	0	+28	0
	214+50.00	ТО	214+75.00	0	298	0	42	0	0	224	0	32	0	0	4	0	3	0	0	+220	0	+29	0
	214+75.00	TO	215+00.00	0	333	0	42	0	0	250	0	32	0	0	4	0	1	0	0	+246	0	+31	0
	215+00.00	TO	215+25.00	0	292	0	41	0	0	219	0	31	0	0	5	0	1	0	0	+214	0	+30	0
	215+25.00	ТО	215+50.00	0	241	0	38	0	0	181	0	29	0	0	5	0	1	0	0	+176	0	+28	0
	215+50.00	ТО	215+75.00	0	251	0	39	0	0	188	0	29	0	0	6	0	0	0	0	+182	0	+29	0
	215+75.00	ТО	216+00.00	0	132	111	45	0	0	99	83	34	0	0	4	0	0	0	0	+95	+83	+34	0
	216+00.00	TO	216+25.00	0	0	197	44	0	0	0	148	33	0	0	0	0	0	0	0	0	+148	+33	0

NOTES

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 3. APPROXIMATE EARTHWORK BALANCE IS USED TO ESTIMATE FURNISHED EXCAVATION
 4. EARTH EXCAVATION TOTAL IS ROUNDED UP TO THE NEAREST 5 CU YD
 5. ESTIMATED 5% OF EARTH EXCAVATION CONSIDERED UNUSABLE FOR EMBANKMENT AND PAID FOR AS REMOVAL AND DISPOSAL OF UNSUITABLE MATERIAL
 6. ESTIMATED EARTH EXCAVATION QUANTITY DESIGNATED AS NON-SPECIAL WASTE DISPOSAL NOT TO BE REUSED AS FURNISHED EXCAVATION



USER NAME = busanskyl	DESIGNED	-	LMB	REVISED	=
	DRAWN	-	LMB	REVISED	=
PLOT SCALE = 20.0000 / in.	CHECKED	-	WBS	REVISED	=
PLOT DATE = 5/5/2021	DATE	_	4/30/2021	REVISED	-

								F.A.U. RTE	SECTION	COUNTY	TOTAL SHEETS	SHEET NO.
			ROAI	DVV	AY SCH	EDULE		7448	09-00933-01-BR	MACON	1019	62
										CONTRA	CT NO.	95893
CALE: N/A	SHEET	8	OF	16	SHEETS	STA.	TO STA.		ILLINOIS FED. AI	D PROJECT		

ALIGNMENT					EAR	TH EXCAVA 20200100	TION		EXCAVATIO		SED IN EME ITEM) EXCAVATION	BANKMENT (NOT A PAY		EMBANKM	ENT (NOT A (NOTE 2)	PAY ITEM)				RK BALANCE DRTAGE (-) (20400800)
ALIC				CU YD	CU YD	CU YD	CU YD	CU YD	CU YD	CU YD	CU YD	CU YD	CU YD	CU YD	CU YD	CU YD	CU YD	CU YD	CU YD	CU YD	CU YD	CU YD	CU YD
	STATION	то	STATION	STAGE 1	STAGE 2	STAGE 3	STAGE 4	STAGE 5	STAGE 1	STAGE 2	STAGE 3A	STAGE 4C	STAGE 5	STAGE 1	STAGE 2	STAGE 3A	STAGE 4C	STAGE 5	STAGE 1	STAGE 2	STAGE 3A	STAGE 4C	STAGE 5
	216+25.00	ТО	216+50.00	0	0	164	41	0	0	0	123	31	0	0	0	0	0	0	0	0	+123	+31	0
	216+50.00	TO	216+75.00	0	0	154	44	0	0	0	116	33	0	0	0	0	0	0	0	0	+116	+33	0
	216+75.00	ТО	217+00.00	0	0	154	47	0	0	0	116	35	0	0	0	0	0	0	0	0	+116	+35	0
	217+00.00	TO	217+25.00	0	0	162	51	0	0	0	122	38	0	0	0	0	0	0	0	0	+122	+38	0
	217+25.00	TO	217+50.00	0	0	179	55	0	0	0	134	41	0	0	0	0	0	0	0	0	+134	+41	0
	217+50.00	TO	217+75.00	0	0	186	57	0	0	0	140	43	0	0	0	0	0	0	0	0	+140	+43	0
	217+75.00	ТО	218+00.00	0	0	182	60	0	0	0	137	45	0	0	0	0	0	0	0	0	+137	+45	0
	218+00.00	TO	218+25.00	0	0	173	61	0	0	0	130	46	0	0	0	0	0	0	0	0	+130	+46	0
	218+25.00	TO	218+50.00	0	0	158	60	0	0	0	119	45	0	0	0	0	0	0	0	0	+119	+45	0
	218+50.00	TO	218+75.00	0	0	153	60	0	0	0	115	45	0	0	0	0	0	0	0	0	+115	+45	0
	218+75.00	TO	219+00.00	0	0	150	50	0	0	0	113	38	0	0	0	0	0	0	0	0	+113	+38	0
	219+00.00	TO	219+25.00	0	0	139	40	0	0	0	104	30	0	0	0	0	0	0	0	0	+104	+30	0
	219+25.00	TO	219+50.00	0	0	134	41	0	0	0	101	31	0	0	0	0	0	0	0	0	+101	+31	0
	219+50.00	TO	219+75.00	0	0	133	50	0	0	0	100	38	0	0	0	0	0	0	0	0	+100	+38	0
	219+75.00	TO	220+00.00	0	0	132	54	0	0	0	99	41	0	0	0	0	0	0	0	0	+99	+41	0
	220+00.00	TO	220+25.00	0	0	124	48	0	0	0	93	36	0	0	0	0	0	0	0	0	+93	+36	0
	220+25.00	ТО	220+50.00	0	0	93	40	0	0	0	70	30	0	0	0	6	0	0	0	0	+64	+30	0
	220+50.00	ТО	220+75.00	0	0	79	34	0	0	0	59	26	0	0	0	12	0	0	0	0	+47	+26	0
	220+75.00	TO	221+00.00	0	0	90	36	0	0	0	68	27	0	0	0	10	0	0	0	0	+58	+27	0
	221+00.00	ТО	221+25.00	0	0	78	35	0	0	0	59	26	0	0	0	10	0	0	0	0	+49	+26	0
¥	221+25.00	ТО	221+50.00	0	0	58	31	0	0	0	44	23	0	0	0	16	0	0	0	0	+28	+23	0
×	221+50.00	ТО	221+75.00	0	0	69	30	0	0	0	52	23	0	0	0	11	0	0	0	0	+41	+23	0
PARKWAY	221+75.00	ТО	222+00.00	0	0	85	30	0	0	0	64	23	0	0	0	1	0	0	0	0	+63	+23	0
	222+00.00	ТО	222+25.00	0	0	87	28	0	0	0	65	21	0	0	0	0	0	0	0	0	+65	+21	0
FARIES	222+25.00	TO	222+50.00	0	0	105	28	0	0	0	79	21	0	0	0	0	1	0	0	0	+79	+20	0
"	222+50.00	TO	222+75.00	0	0	124	28	0	0	0	93	21	0	0	0	0	1	0	0	0	+93	+20	0
	222+75.00	ТО	223+00.00	94	0	64	24	0	71	0	48	18	0	0	0	0	1	0	+71	0	+48	+17	0
	223+00.00	TO	223+25.00	255	0	0	14	0	191	0	0	11	0	1	0	0	10	0	+190	0	0	+1	0
	223+25.00	TO	223+50.00	336	0	0	17	0	252	0	0	13	0	1	0	0	18	0	+251	0	0	-5	0
	223+50.00	ТО	223+75.00	355	0	0	37	0	266	0	0	28	0	0	0	0	12	0	+266	0	0	+16	0
	223+75.00	ТО	224+00.00	380	0	0	47	0	285	0	0	35	0	0	0	0	8	0	+285	0	0	+27	0
	224+00.00	ТО	224+25.00	398	0	0	56	0	299	0	0	42	0	0	0	0	7	0	+299	0	0	+35	0
	224+25.00	TO	224+50.00	199	0	236	42	0	149	0	177	32	0	0	0	0	4	0	+149	0	+177	+28	0
	224+50.00	ТО	224+75.00	0	0	491	18	0	0	0	368	14	0	0	0	0	2	0	0	0	+368	+12	0
	224+75.00	TO	225+00.00	0	0	486	15	0	0	0	365	11	0	0	0	0	2	0	0	0	+365	+9	0
	225+00.00	TO	225+25.00	0	0	408	11	0	0	0	306	8	0	0	0	0	3	0	0	0	+306	+5	0
	225+25.00	ТО	225+50.00	0	0	240	8	0	0	0	180	6	0	0	0	0	5	0	0	0	+180	+1	0
	225+50.00	TO	225+75.00	0	0	65	6	0	0	0	49	5	0	0	0	113	10	0	0	0	-64	-6	0
	225+75.00	ТО	226+00.00	0	0	3	6	0	0	0	2	5	0	0	0	310	17	0	0	0	-308	-13	0
	226+00.00	ТО	226+25.00	0	0	6	5	0	0	0	5	4	0	0	0	421	22	0	0	0	-417	-18	0
	226+25.00	ТО	226+50.00	0	0	13	4	0	0	0	10	3	0	0	0	473	30	0	0	0	-463	-27	0
	226+50.00	ТО	226+75.00	0	0	9	4	0	0	0	7	3	0	0	0	594	38	0	0	0	-587	-35	0
	226+75.00	ТО	227+00.00	0	0	6	3	0	0	0	5	2	0	0	0	687	39	0	0	0	-683	-37	0
	227+00.00	TO	227+25.00	0	0	28	3	0	0	0	21	2	0	0	0	613	36	0	0	0	-592	-34	0
	227+25.00	TO	227+50.00	0	0	42	3	0	0	0	32	2	0	0	0	458	31	0	0	0	-427	-29	0

NOTES

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USER NAME = busanskyl	DESIGNED	-	LMB	REVISED -
	DRAWN	-	LMB	REVISED -
PLOT SCALE = 20.0000 / in.	CHECKED	-	WBS	REVISED -
PLOT DATE = 5/5/2021	DATE	_	4/30/2021	REVISED -

								F.A.U. RTE	SECTION		COUNTY	TOTAL SHEETS	SHEET NO.
			KUAI	JWA	Y SCH	FDULE		7448	09-00933-01-BR		MACON	1019	63
											CONTRA	CT NO.	95893
ALE: N/A	SHEET	9	OF	16	SHEETS	STA.	TO STA.		ILLINOIS	FED. AID	PROJECT		

ALIGNMENT					EAR	RTH EXCAVA 20200100	TION		EXCAVATIO		SED IN EME ITEM) EXCAVATION	BANKMENT (I	NOT A PAY		EMBANKM	ENT (NOT A (NOTE 2)	PAY ITEM)				K BALANCE RTAGE (-) (20400800)
- ALIG				CU YD	CU YD	CU YD	CU YD	CU YD	CU YD	CU YD	CU YD	CU YD	CU YD	CU YD	CU YD	CU YD	CU YD	CU YD	CU YD	CU YD	CU YD	CU YD	CU YD
	STATION	то	STATION	STAGE 1	STAGE 2	STAGE 3	STAGE 4	STAGE 5	STAGE 1	STAGE 2	STAGE 3A	STAGE 4C	STAGE 5	STAGE 1	STAGE 2	STAGE 3A	STAGE 4C	STAGE 5	STAGE 1	STAGE 2	STAGE 3A	STAGE 4C	STAGE 5
	227+50.00	то	227+75.00	0	0	33	4	0	0	0	25	3	0	0	0	346	26	0	0	0	-321	-23	0
	227+75.00	ТО	228+00.00	0	0	40	6	0	0	0	30	5	0	0	0	307	20	0	0	0	-277	-16	0
	228+00.00	ТО	228+25.00	0	0	33	8	0	0	0	25	6	0	0	0	291	16	0	0	0	-266	-10	0
	228+25.00	ТО	228+50.00	0	0	13	10	0	0	0	10	8	0	0	0	291	12	0	0	0	-281	-5	0
	228+50.00	ТО	228+75.00	0	0	13	12	0	0	0	10	9	0	0	0	304	9	0	0	0	-294	0	0
	228+75.00	ТО	229+00.00	0	0	17	13	0	0	0	13	10	0	0	0	322	7	0	0	0	-309	+3	0
	229+00.00	TO	229+25.00	0	0	35	15	0	0	0	26	11	0	0	0	374	4	0	0	0	-348	+7	0
	229+25.00	TO	229+50.00	0	0	50	17	0	0	0	38	13	0	0	0	408	2	0	0	0	-371	+11	0
	229+50.00	ТО	229+75.00	0	0	39	19	0	0	0	29	14	0	0	0	381	2	0	0	0	-352	+12	0
	229+75.00	TO	230+00.00	0	0	27	22	0	0	0	20	17	0	0	0	372	1	0	0	0	-352	+16	0
	230+00.00	TO	230+25.00	0	0	26	23	0	0	0	20	17	0	0	0	389	1	0	0	0	-370	+16	0
	230+25.00	TO	230+50.00	0	0	25	27	0	0	0	19	20	0	0	0	377	1	0	0	0	- 358	+19	0
	230+50.00	TO	230+75.00	0	0	26	33	0	0	0	20	25	0	0	0	328	0	0	0	0	-309	+25	0
	230+75.00	ТО	231+00.00	0	0	29	34	0	0	0	22	26	0	0	0	284	0	0	0	0	-262	+26	0
	231+00.00	ТО	231+25.00	0	0	30	35	0	0	0	23	26	0	0	0	243	0	0	0	0	-221	+26	0
\(\frac{1}{2} \)	231+25.00	ТО	231+50.00	0	0	29	35	0	0	0	22	26	0	0	0	173	0	0	0	0	-151	+26	0
PARKWAY	231+50.00	ТО	231+75.00	0	0	28	36	0	0	0	21	27	0	0	0	69	0	0	0	0	-48	+27	0
SP	231+75.00	ТО	232+00.00	0	0	28	37	0	0	0	21	28	0	0	0	8	0	0	0	0	+13	+28	0
FARIES	232+00.00	ТО	232+25.00	0	0	25	37	0	0	0	19	28	0	0	0	5	0	0	0	0	+14	+28	0
4	232+25.00	ТО	232+50.00	0	0	23	37	0	0	0	17	28	0	0	0	5	0	0	0	0	+12	+28	0
	232+50.00	ТО	232+75.00	0	0	23	38	0	0	0	17	29	0	0	0	3	0	0	0	0	+14	+29	0
	232+75.00	ТО	233+00.00	0	0	22	34	0	0	0	17	26	0	0	0	1	0	0	0	0	+16	+26	0
	233+00.00	ТО	233+25.00	0	0	20	29	0	0	0	15	22	0	0	0	4	1	0	0	0	+11	+21	0
	233+25.00	ТО	233+50.00	0	0	25	37	0	0	0	19	28	0	0	0	4	1	0	0	0	+15	+27	0
	233+50.00	ТО	233+75.00	0	0	27	46	0	0	0	20	35	0	0	0	1	0	0	0	0	+19	+35	0
	233+75.00	ТО	234+00.00	0	0	25	44	0	0	0	19	33	0	0	0	2	0	0	0	0	+17	+33	0
	234+00.00	ТО	234+25.00	0	0	25	40	0	0	0	19	30	0	0	0	2	0	0	0	0	+17	+30	0
	234+25.00	ТО	234+50.00	0	0	26	36	0	0	0	20	27	0	0	0	1	0	0	0	0	+19	+27	0
	234+50.00	ТО	234+75.00	0	0	28	32	0	0	0	21	24	0	0	0	0	0	0	0	0	+21	+24	0
	234+75.00	ТО	235+00.00	0	0	28	30	0	0	0	21	23	0	0	0	0	0	0	0	0	+21	+23	0
	235+00.00	ТО	235+25.00	0	0	25	28	0	0	0	19	21	0	0	0	0	0	0	0	0	+19	+21	0
	235+25.00	TO	235+41.47	0	0	14	17	0	0	0	11	13	0	0	0	0	0	0	0	0	+11	+13	0
	FARIF	S SUB-TO	OTALS	2,017	2,341	9,635	3,411	0	1,513	1,756	7,226	2,558	0	2	42	9,482	705	0	1,511	1,714	-2,256	1,853	0

NOTES

- 1. ESTIMATED SHRINKAGE FACTOR=25%
 2. APPROXIMATE EMBANKMENT QUANTITY IS SHOWN FOR INFORMATION ONLY
 3. APPROXIMATE EARTHWORK BALANCE IS USED TO ESTIMATE FURNISHED EXCAVATION
 4. EARTH EXCAVATION TOTAL IS ROUNDED UP TO THE NEAREST 5 CU YD
 5. ESTIMATED 5% OF EARTH EXCAVATION CONSIDERED UNUSABLE FOR EMBANKMENT AND PAID FOR AS REMOVAL AND DISPOSAL OF UNSUITABLE MATERIAL
 6. ESTIMATED EARTH EXCAVATION QUANTITY DESIGNATED AS NON-SPECIAL WASTE DISPOSAL NOT TO BE REUSED AS FURNISHED EXCAVATION



USER NAME = busanskyl	DESIGNED -	LMB	REVISED -
	DRAWN -	LMB	REVISED -
PLOT SCALE = 20.0000 ' / in.	CHECKED -	WBS	REVISED -
PLOT DATE = 5/6/2021	DATE -	4/30/2021	REVISED -

								F.A.U. RTE	SECTION		COUNTY	TOTAL SHEETS	SHEET NO.
			ROAI	DWF	AY SCH	EDULE		7448	09-00933-01-BR		MACON	1019	64
											CONTRA	CT NO.	95893
CALE: N/A	SHEET	10	OF	16	SHEETS	STA.	TO STA.		ILLINOIS F	FED. AID	PROJECT		

NOTES:

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NOT TO BE REUSED AS FURNISHED EXCAVATION



USER NAME = busanskyl	DESIGNED -	LMB	REVISED -
	DRAWN -	LMB	REVISED -
PLOT SCALE = 20.0000 ' / in.	CHECKED -	WBS	REVISED -
PLOT DATE = 5/5/2021	DATE -	4/30/2021	REVISED -

			DO 41	214/		FRUE		F.A.U. RTE	SECTION	N		COUNTY	TOTAL SHEETS	SHEET NO.
			ROA	UVVF	AY SUH	EDULE		7448	09-00933-01	1-BR		MACON	1019	65
												CONTRA	ACT NO.	95893
CALE: N/A	SHEET	11	OF	16	SHEETS	STA.	TO STA.		ILLII	INOIS	FED. AII	D PROJECT		

ALIGNMENT					EAR	TH EXCAVA 20200100	TION		EXCAVATION		ISED IN EMB ITEM) EXCAVATION	·	NOT A PAY		EMBANKME	ENT (NOT A (NOTE 2)	PAY ITEM)				K BALANCE ORTAGE (-) (20400800	WASTE (+) NOTE 3)	
- ALIC				CU YD	CU YD	CU YD	CU YD	CU YD	CU YD	CU YD	CU YD	CU YD	CU YD	CU YD	CU YD	CU YD	CU YD	CU YD	CU YD	CU YD	CU YD	CU YD	CU YD
	STATION	то	STATION	STAGE 1	STAGE 2	STAGE 3	STAGE 4	STAGE 5	STAGE 1	STAGE 2	STAGE 3A	STAGE 4C	STAGE 5	STAGE 1	STAGE 2	STAGE 3A	STAGE 4C	STAGE 5	STAGE 1	STAGE 2	STAGE 3A	STAGE 4C	STAGE 5
	600+75.00	ТО	601+00.00	0	194	0	0	0	0	146	0	0	0	0	4	0	0	0	0	+142	0	0	0
	601+00.00	ТО	601+25.00	0	88	0	0	0	0	66	0	0	0	0	0	0	0	0	0	+66	0	0	0
	601+25.00	ТО	601+50.00	0	55	0	0	0	0	41	0	0	0	0	0	0	0	0	0	+41	0	0	0
	601+50.00	ТО	601+75.00	0	48	0	0	0	0	36	0	0	0	0	0	0	0	0	0	+36	0	0	0
	601+75.00	TO	602+00.00	0	42	0	0	0	0	32	0	0	0	0	0	0	0	0	0	+32	0	0	0
	602+00.00	TO	602+25.00	0	41	0	0	0	0	31	0	0	0	0	0	0	0	0	0	+31	0	0	0
	602+25.00	ТО	602+50.00	0	40	0	0	0	0	30	0	0	0	0	1	0	0	0	0	+29	0	0	0
	602+50.00	TO	602+75.00	0	39	0	0	0	0	29	0	0	0	0	2	0	0	0	0	+27	0	0	0
	602+75.00	TO	603+00.00	0	39	0	0	0	0	29	0	0	0	0	1	0	0	0	0	+28	0	0	0
	603+00.00	TO	603+25.00	0	40	0	0	0	0	30	0	0	0	0	0	0	0	0	0	+30	0	0	0
	603+25.00	TO	603+50.00	0	40	0	0	0	0	30	0	0	0	0	0	0	0	0	0	+30	0	0	0
	603+50.00	TO	603+75.00	0	43	0	0	0	0	32	0	0	0	0	0	0	0	0	0	+32	0	0	0
	603+75.00	TO	604+00.00	0	48	0	0	0	0	36	0	0	0	0	0	0	0	0	0	+36	0	0	0
	604+00.00	TO	604+25.00	0	46	0	0	0	0	35	0	0	0	0	0	0	0	0	0	+35	0	0	0
	604+25.00	TO	604+50.00	0	39	0	0	0	0	29	0	0	0	0	1	0	0	0	0	+28	0	0	0
Ш	604+50.00	TO	604+75.00	0	40	0	0	0	0	30	0	0	0	0	1	0	0	0	0	+29	0	0	0
STREET	604+75.00	TO	605+00.00	0	42	0	0	0	0	32	0	0	0	0	0	0	0	0	0	+32	0	0	0
l S	605+00.00	TO	605+25.00	0	44	0	0	0	0	33	0	0	0	0	0	0	0	0	0	+33	0	0	0
LOGAN	605+25.00	TO	605+50.00	0	50	0	0	0	0	38	0	0	0	0	0	0	0	0	0	+38	0	0	0
9	605+50.00	ТО	605+75.00	0	52	0	0	0	0	39	0	0	0	0	0	0	0	0	0	+39	0	0	0
	605+75.00	TO	606+00.00	0	54	0	0	0	0	41	0	0	0	0	0	0	0	0	0	+41	0	0	0
	606+00.00	TO	606+25.00	0	60	0	0	0	0	45	0	0	0	0	0	0	0	0	0	+45	0	0	0
	606+25.00	ТО	606+50.00	0	63	0	0	0	0	47	0	0	0	0	0	0	0	0	0	+47	0	0	0
	606+50.00	TO	606+75.00	0	59	0	0	0	0	44	0	0	0	0	0	0	0	0	0	+44	0	0	0
	606+75.00	TO	607+00.00	0	60	0	0	0	0	45	0	0	0	0	0	0	0	0	0	+45	0	0	0
	607+00.00	TO	607+25.00	0	55	0	0	0	0	41	0	0	0	0	0	0	0	0	0	+41	0	0	0
	607+25.00	ТО	607+50.00	0	46	0	0	0	0	35	0	0	0	0	0	0	0	0	0	+35	0	0	0
	607+50.00	TO	607+75.00	0	44	0	0	0	0	33	0	0	0	0	0	0	0	0	0	+33	0	0	0
	607+75.00	TO	608+00.00	0	48	0	0	0	0	36	0	0	0	0	0	0	0	0	0	+36	0	0	0
	608+00.00	TO	608+25.00	0	49	0	0	0	0	37	0	0	0	0	0	0	0	0	0	+37	0	0	0
	608+25.00	TO	608+50.00	0	58	0	0	0	0	44	0	0	0	0	0	0	0	0	0	+44	0	0	0
	608+50.00	TO	608+75.00	0	78	0	0	0	0	59	0	0	0	0	0	0	0	0	0	+59	0	0	0
	608+75.00	ТО	609+00.00	0	106	0	0	0	0	80	0	0	0	0	0	0	0	0	0	+80	0	0	0
	LOGA	N SUB-TO	TALS	0	1,850	0	0	0	0	1,388	0	0	0	0	10	0	0	0	0	1,378	0	0	0

NOTES

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USER NAME = busanskyl	DESIGNED -	LMB	REVISED -
	DRAWN -	LMB	REVISED -
PLOT SCALE = 20.0000 ' / in.	CHECKED -	WBS	REVISED -
PLOT DATE = 5/5/2021	DATE -	4/30/2021	REVISED -

STATE	0F	ILLINOIS
DEPARTMENT	0F	TRANSPORTATION

								F.A.U. RTE	SECTION	COUNTY	TOTAL SHEETS	SHEET NO.
			ROAI	DWF	Y SCH	EDULE		7448	09-00933-01-BR	MACON	1019	66
										CONTRA	CT NO.	95893
SCALE: N/A	SHEET	12	OF	16	SHEETS	STA.	TO STA.		ILLINOIS FED. A	ID PROJECT		

ALIGNMENT					EAR	TH EXCAVA 20200100	TION		EXCAVATIO		SED IN EME ITEM) EXCAVATION	BANKMENT (I	NOT A PAY		EMBANKMI	ENT (NOT A (NOTE 2)	PAY ITEM)				K BALANCE DRTAGE (-) (20400800		1
ALI	STATION	то	STATION	CU YD STAGE 1	CU YD STAGE 2	CU YD STAGE 3	CU YD STAGE 4	CU YD STAGE 5	CU YD STAGE 1	CU YD STAGE 2	CU YD STAGE 3A	CU YD STAGE 4C	CU YD STAGE 5	CU YD STAGE 1	CU YD STAGE 2	CU YD STAGE 3A	CU YD STAGE 4C	CU YD STAGE 5	CU YD STAGE 1	CU YD STAGE 2	CU YD STAGE 3A	CU YD STAGE 4C	CU YD STAGE 5
	800+00.00	TO	800+25.00	92	0	0	0	0	69	0	0	0	0	0	0	0	0	0	+69	0	0	0	0
	800+25.00	ТО	800+50.00	107	0	0	0	0	80	0	0	0	0	0	0	0	0	0	+80	0	0	0	0
	800+50.00	ТО	800+75.00	145	0	0	0	0	109	0	0	0	0	0	0	0	0	0	+109	0	0	0	0
	800+75.00	ТО	801+00.00	94	0	0	0	0	71	0	0	0	0	0	0	0	0	0	+71	0	0	0	0
	801+00.00	ТО	801+25.00	33	0	0	0	0	25	0	0	0	0	0	0	0	0	0	+25	0	0	0	0
	801+25.00	ТО	801+50.00	26	0	0	0	0	20	0	0	0	0	0	0	0	0	0	+20	0	0	0	0
	801+50.00	ТО	801+75.00	27	0	0	0	0	20	0	0	0	0	0	0	0	0	0	+20	0	0	0	0
	801+75.00	TO	802+00.00	27	0	0	0	0	20	0	0	0	0	0	0	0	0	0	+20	0	0	0	0
	802+00.00	ТО	802+25.00	29	0	0	0	0	22	0	0	0	0	0	0	0	0	0	+22	0	0	0	0
	802+25.00	ТО	802+50.00	42	0	0	0	0	32	0	0	0	0	0	0	0	0	0	+32	0	0	0	0
	802+50.00	ТО	802+75.00	44	0	0	0	0	33	0	0	0	0	0	0	0	0	0	+33	0	0	0	0
	802+75.00	ТО	803+00.00	35	0	0	0	0	26	0	0	0	0	0	0	0	0	0	+26	0	0	0	0
	803+00.00	ТО	803+25.00	37	0	0	0	0	28	0	0	0	0	0	0	0	0	0	+28	0	0	0	0
	803+25.00	TO	803+50.00	36	0	0	0	0	27	0	0	0	0	0	0	0	0	0	+27	0	0	0	0
	803+50.00	ТО	803+75.00	43	0	0	0	0	32	0	0	0	0	0	0	0	0	0	+32	0	0	0	0
	803+75.00	ТО	804+00.00	69	0	0	0	0	52	0	0	0	0	0	0	0	0	0	+52	0	0	0	0
	804+00.00	ТО	804+25.00	92	0	0	0	0	69	0	0	0	0	0	0	0	0	0	+69	0	0	0	0
G	804+25.00	ТО	804+50.00	98	0	0	0	0	74	0	0	0	0	0	0	0	0	0	+74	0	0	0	0
LEG)	804+50.00	TO	804+75.00	112	0	0	0	0	84	0	0	0	0	0	0	0	0	0	+84	0	0	0	0
TS:	804+75.00	ТО	805+00.00	177	0	0	0	0	133	0	0	0	0	0	0	0	0	0	+133	0	0	0	0
(WEST	805+00.00	ТО	805+25.00	318	0	0	0	0	239	0	0	0	0	0	0	0	0	0	+239	0	0	0	0
8	805+25.00	ТО	805+50.00	493	0	0	0	0	370	0	0	0	0	0	0	0	0	0	+370	0	0	0	0
RIS	805+50.00	ТО	805+75.00	702	0	0	0	0	527	0	0	0	0	0	0	0	0	0	+527	0	0	0	0
HARRISON	805+75.00	ТО	806+00.00	950	0	0	0	0	713	0	0	0	0	0	0	0	0	0	+713	0	0	0	0
+	806+00.00	ТО	806+25.00	1,175	0	0	0	0	881	0	0	0	0	0	0	0	0	0	+881	0	0	0	0
	806+25.00	ТО	806+50.00	1,266	0	0	0	0	950	0	0	0	0	0	0	0	0	0	+950	0	0	0	0
	806+50.00	ТО	806+75.00	1,082	0	0	0	0	812	0	0	0	0	0	0	0	0	0	+812	0	0	0	0
	806+75.00	ТО	807+00.00	524	0	0	0	0	393	0	0	0	0	0	0	0	0	0	+393	0	0	0	0
	807+00.00	ТО	807+25.00	113	0	0	0	0	85	0	0	0	0	0	0	0	0	0	+85	0	0	0	0
	807+25.00	ТО	807+50.00	69	0	0	0	0	52	0	0	0	0	0	0	0	0	0	+52	0	0	0	0
	807+50.00	ТО	807+75.00	48	0	0	0	0	36	0	0	0	0	0	0	0	0	0	+36	0	0	0	0
	807+75.00	TO	808+00.00	44	0	0	0	0	33	0	0	0	0	0	0	0	0	0	+33	0	0	0	0
	808+00.00	TO	808+25.00	97	0	0	0	0	73	0	0	0	0	0	0	0	0	0	+73	0	0	0	0
	808+25.00	TO	808+50.00	136	0	0	0	0	102	0	0	0	0	0	0	0	0	0	+102	0	0	0	0
	808+50.00	ТО	808+75.00	100	0	0	0	0	75	0	0	0	0	1	0	0	0	0	+74	0	0	0	0
-	808+75.00	TO	809+00.00	54	0	0	0	0	41	0	0	0	0	15	0	0	0	0	+26	0	0	0	0
	809+00.00	TO	809+25.00	26	0	0	0	0	20	0	0	0	0	50	0	0	0	0	-31	0	0	0	0
	809+25.00	TO	809+50.00	18	0	0	0	0	14	0	0	0	0	88	0	0	0	0	-75	0	0	0	0
	809+50.00	TO	809+75.00	9	0	0	0	0	7	0	0	0	0	112	0	0	0	0	-105	0	0	0	0
	809+75.00	ТО	810+00.00	0	0	0	0	0	0	0	0	0	0	104	0	0	0	0	-104	0	0	0	0
	HARRISO	V (W) SUE	B-TOTALS	8,589	0	0	0	0	6,442	0	0	0	0	370	0	0	0	0	6,072	0	0	0	0

NOTES:

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USER NAME = busanskyl	DESIGNED -	LMB	REVISED -
	DRAWN -	LMB	REVISED -
PLOT SCALE = 20.0000 ' / in.	CHECKED -	WBS	REVISED -
PLOT DATE = 5/5/2021	DATE -	4/30/2021	REVISED -

			200					F.A.U. RTE	SECTION	COUNTY	TOTAL SHEETS	SHEET NO.
			ROAI	JVVF	AY SCH	EDULE		7448	09-00933-01-BR	MACON	1019	67
										CONTRA	CT NO.	95893
SCALE: N/A	SHEET	13	OF	16	SHEETS	STA.	TO STA.		ILLINOIS FE	ED. AID PROJECT		

ALIGNMENT					EAR	TH EXCAVA 20200100	TION		EXCAVATIO		JSED IN EME ITEM) EXCAVATION		NOT A PAY		EMBANKME	ENT (NOT A (NOTE 2)	PAY ITEM)				RK BALANCE DRTAGE (-) (20400800	WASTE (+) (NOTE 3)	
- ALIG				CU YD	CU YD	CU YD	CU YD	CU YD	CU YD	CU YD	CU YD	CU YD	CU YD	CU YD	CU YD	CU YD	CU YD	CU YD	CU YD	CU YD	CU YD	CU YD	CU YD
	STATION	то	STATION	STAGE 1	STAGE 2	STAGE 3	STAGE 4	STAGE 5	STAGE 1	STAGE 2	STAGE 3A	STAGE 4C	STAGE 5	STAGE 1	STAGE 2	STAGE 3A	STAGE 4C	STAGE 5	STAGE 1	STAGE 2	STAGE 3A	STAGE 4C	STAGE 5
	700+75.00	TO	701+00.00	0	0	1	0	0	0	0	1	0	0	0	0	90	0	0	0	0	-89	0	0
	701+00.00	TO	701+25.00	0	0	1	0	0	0	0	1	0	0	0	0	65	0	0	0	0	-64	0	0
	701+25.00	TO	701+50.00	0	0	1	0	0	0	0	1	0	0	0	0	53	0	0	0	0	-52	0	0
	701+50.00	TO	701+75.00	0	0	2	0	0	0	0	2	0	0	0	0	40	0	0	0	0	-39	0	0
	701+75.00	TO	702+00.00	0	0	2	0	0	0	0	2	0	0	0	0	17	0	0	0	0	-16	0	0
	702+00.00	TO	702+25.00	0	0	3	0	0	0	0	2	0	0	0	0	5	0	0	0	0	-3	0	0
	702+25.00	TO	702+50.00	0	0	3	0	0	0	0	2	0	0	0	0	2	0	0	0	0	+	0	0
	702+50.00	TO	702+75.00	4	0	2	0	0	3	0	2	0	0	0	0	1	0	0	+3	0	+1	0	0
	702+75.00	TO	703+00.00	7	0	0	0	0	5	0	0	0	0	0	0	0	0	0	+5	0	0	0	0
	703+00.00	TO	703+25.00	7	0	0	0	0	5	0	0	0	0	0	0	0	0	0	+5	0	0	0	0
	703+25.00	ТО	703+50.00	7	0	0	0	0	5	0	0	0	0	0	0	0	0	0	+5	0	0	0	0
	703+50.00	ТО	703+75.00	7	0	0	0	0	5	0	0	0	0	0	0	0	0	0	+5	0	0	0	0
	703+75.00	TO	704+00.00	7	0	0	0	0	5	0	0	0	0	0	0	0	0	0	+5	0	0	0	0
LEG)	704+00.00	ТО	704+25.00	7	0	0	0	0	5	0	0	0	0	0	0	0	0	0	+5	0	0	0	0
	704+25.00	TO	704+50.00	7	0	0	0	0	5	0	0	0	0	0	0	0	0	0	+5	0	0	0	0
(EAST	704+50.00	ТО	704+75.00	7	0	0	0	0	5	0	0	0	0	0	0	0	0	0	+5	0	0	0	0
	704+75.00	ТО	705+00.00	7	0	0	0	0	5	0	0	0	0	0	0	0	0	0	+5	0	0	0	0
	705+00.00	ТО	705+25.00	7	0	0	0	0	5	0	0	0	0	0	0	0	0	0	+5	0	0	0	0
HARRISON	705+25.00	TO	705+50.00	7	0	0	0	0	5	0	0	0	0	0	0	0	0	0	+5	0	0	0	0
₹ [705+50.00	ТО	705+75.00	7	0	0	0	0	5	0	0	0	0	0	0	0	0	0	+5	0	0	0	0
	705+75.00	ТО	706+00.00	7	0	0	0	0	5	0	0	0	0	0	0	0	0	0	+5	0	0	0	0
	706+00.00	ТО	706+25.00	7	0	0	0	0	5	0	0	0	0	0	0	0	0	0	+5	0	0	0	0
	706+25.00	ТО	706+50.00	8	0	0	0	0	6	0	0	0	0	0	0	0	0	0	+6	0	0	0	0
	706+50.00	TO	706+75.00	14	0	0	0	0	11	0	0	0	0	0	0	0	0	0	+11	0	0	0	0
	706+75.00	ТО	707+00.00	18	0	0	0	0	14	0	0	0	0	0	0	0	0	0	+14	0	0	0	0
	707+00.00	ТО	707+25.00	12	0	0	0	0	9	0	0	0	0	0	0	0	0	0	+9	0	0	0	0
	707+25.00	TO	707+50.00	8	0	0	0	0	6	0	0	0	0	0	0	0	0	0	+6	0	0	0	0
	707+50.00	ТО	707+75.00	9	0	0	0	0	7	0	0	0	0	0	0	0	0	0	+7	0	0	0	0
	707+75.00	ТО	708+00.00	8	0	0	0	0	6	0	0	0	0	0	0	0	0	0	+6	0	0	0	0
	708+00.00	ТО	708+25.00	7	0	0	0	0	5	0	0	0	0	0	0	0	0	0	+5	0	0	0	0
	708+25.00	ТО	708+41.73	5	0	0	0	0	4	0	0	0	0	0	0	0	0	0	+4	0	0	0	0
	=====	N. (E) C:-	TOTAL 6	1	1 -	T	T .	_				_							T		T		
	HARRISO	N (E) SUB	3-TOTALS	191	0	15	0	0	143	0	11	0	0	0	0	273	0	0	143	0	-262	0	0

NOTES

- 1. ESTIMATED SHRINKAGE FACTOR=25%
 2. APPROXIMATE EMBANKMENT QUANTITY IS SHOWN FOR INFORMATION ONLY
 3. APPROXIMATE EARTHWORK BALANCE IS USED TO ESTIMATE FURNISHED EXCAVATION
 4. EARTH EXCAVATION TOTAL IS ROUNDED UP TO THE NEAREST 5 CU YD
 5. ESTIMATED 5% OF EARTH EXCAVATION CONSIDERED UNUSABLE FOR EMBANKMENT AND PAID FOR AS REMOVAL AND DISPOSAL OF UNSUITABLE MATERIAL
 6. ESTIMATED EARTH EXCAVATION QUANTITY DESIGNATED AS NON-SPECIAL WASTE DISPOSAL NOT TO BE REUSED AS FURNISHED EXCAVATION



USER NAME = busanskyl	DESIGNED	-	LMB	REVISED -	۱
	DRAWN	-	LMB	REVISED -	
PLOT SCALE = 20.0000 ' / in.	CHECKED	-	WBS	REVISED -	
PLOT DATE = 5/5/2021	DATE	-	4/30/2021	REVISED -	

I			_						F.A.U. RTE	SEC	TION		COUNTY	TOTAL SHEETS	SHEET NO.
I			K	0AD	WA	Y SCH	EDULE		7448	09-0093	3-01-BR		MACON	1019	68
ļ													CONTRA	ACT NO.	95893
	SCALE: N/A	SHEET :	14	OF	16	SHEETS	STA.	TO STA.			ILLINOIS	FED. All	D PROJECT		

ALIGNMENT					EAF	TH EXCAVA 20200100	TION		EXCAVATIO		ISED IN EME ITEM) EXCAVATION		(NOT A PAY		EMBANKM	ENT (NOT A (NOTE 2)	PAY ITEM)				RK BALANCE DRTAGE (-) (20400800	NOTE 3))
ALIG				CU YD	CU YD	CU YD	CU YD	CU YD	CU YD	CU YD	CU YD	CU YD	CU YD	CU YD	CU YD	CU YD	CU YD	CU YD	CU YD	CU YD	CU YD	CU YD	CU YD
	STATION	то	STATION	STAGE 1	STAGE 2	STAGE 3	STAGE 4	STAGE 5	STAGE 1	STAGE 2		STAGE 4C		STAGE 1	STAGE 2		STAGE 4C	STAGE 5	STAGE 1	STAGE 2	STAGE 3A	STAGE 4C	STAGE 5
	900+09.00	TO	900+25.00	24	0	0	0	0	18	0	0	0	0	0	0	0	0	0	+18	0	0	0	0
	900+25.00	ТО	900+50.00	38	0	0	0	0	29	0	0	0	0	0	0	0	0	0	+29	0	0	0	0
	900+50.00	ТО	900+75.00	48	0	0	0	0	36	0	0	0	0	0	0	0	0	0	+36	0	0	0	0
	900+75.00	ТО	901+00.00	46	0	0	0	0	35	0	0	0	0	0	0	0	0	0	+35	0	0	0	0
	901+00.00	TO	901+25.00	50	0	0	0	0	38	0	0	0	0	0	0	0	0	0	+38	0	0	0	0
	901+25.00	ТО	901+50.00	57	0	0	0	0	43	0	0	0	0	0	0	0	0	0	+43	0	0	0	0
l a	901+50.00	ТО	901+75.00	65	0	0	0	0	49	0	0	0	0	0	0	0	0	0	+49	0	0	0	0
ROAD	901+75.00	ТО	902+00.00	69	0	0	0	0	52	0	0	0	0	0	0	0	0	0	+52	0	0	0	0
	902+00.00	ТО	902+25.00	67	0	0	0	0	50	0	0	0	0	0	0	0	0	0	+50	0	0	0	0
ACCESS	902+25.00	ТО	902+50.00	60	0	0	0	0	45	0	0	0	0	0	0	0	0	0	+45	0	0	0	0
	902+50.00	ТО	902+75.00	51	0	0	0	0	38	0	0	0	0	0	0	0	0	0	+38	0	0	0	0
開	902+75.00	ТО	903+00.00	46	0	0	0	0	35	0	0	0	0	0	0	0	0	0	+35	0	0	0	0
CEMETERY	903+00.00	ТО	903+25.00	34	0	0	0	0	26	0	0	0	0	0	0	0	0	0	+26	0	0	0	0
핑	903+25.00	TO	903+50.00	36	0	0	0	0	27	0	0	0	0	0	0	0	0	0	+27	0	0	0	0
	903+50.00	ТО	903+75.00	57	0	0	0	0	43	0	0	0	0	0	0	0	0	0	+43	0	0	0	0
	903+75.00	ТО	904+00.00	70	0	0	0	0	53	0	0	0	0	0	0	0	0	0	+53	0	0	0	0
	904+00.00	ТО	904+25.00	88	0	0	0	0	66	0	0	0	0	0	0	0	0	0	+66	0	0	0	0
	904+25.00	ТО	904+50.00	81	0	0	0	0	61	0	0	0	0	0	0	0	0	0	+61	0	0	0	0
	CEMET	TERY SUB-	-TOTALS	987	0	0	0	0	740	0	0	0	0	0	0	0	0	0	740	0	0	0	0
	GF	RAND TOT	ALS	18,762	24,529	10,133	3,702	3,052	14,072	18,397	7,600	2,777	2,289	541	26,678	9,993	741	34,560	13,531	-8,281	-2,393	2,036	-32,271
		TH EXCAV ED TOTAL 2020010	(NOTE 4)			60,180			_							RK BALANCE RTAGE (-) S	WASTE (+) UB TOTAL				-27,380		
														REMOVA	L AND DISF	POSAL OF UI (NOTE 5) 20201200	NSUITABLE M	MATERIAL			-3,010		
																CIAL WASTE PAY ITEM)					-2,920		
															FURNISHED	EXCAVATIO 20400800	ON (NOTE 3)				-33,310		

NOTES:

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USER NAME = busanskyl	DESIGNED -	LMB	REVISED -
	DRAWN -	LMB	REVISED -
PLOT SCALE = 20.0000 ' / in.	CHECKED -	WBS	REVISED -
PLOT DATE = 5/5/2021	DATE -	4/30/2021	REVISED -

Ī								F.A.U. RTE	SECT	TION	COUNTY	TOTAL SHEETS	SHEET NO.
I			ROA	DWA	AY SCH	EDULE		7448	09-00933	3-01-BR	MACON	1019	69
ļ											CON	RACT NO.	95893
l	SCALE: N/A	SHEET 1	5 OF	16	SHEETS	STA.	TO STA.			ILLINOIS FEE	D. AID PROJECT		

				шШ	шш	L⊃
SHEET	ROAD	STATION	STATION	CU YD	CU YD	CU YD
1		46+59.44	52+00.00	0	0	0
2		52+00.00	57+75.00	0	0	0
3	BRUSH	57+75.00	62+50.00	0	0	0
4	BRUSH	62+50.00	68+00.00	0	909	538
5		68+00.00	73+50.00	0	0	0
6		73+50.00	76+25.97	0	0	0
7		205+18.73	208+00.00	0	0	0
8		208+00.00	213+25.00	0	0	0
9	FARIES	213+25.00	219+00.00	1696	0	105
10	FARIES	219+00.00	224+75.00	0	0	0
11		224+75.00	230+50.00	0	0	0
12		230+50.00	235+41.47	0	0	0
13	JUG	301+75.00	306+50.00	1220	0	90
14	LOGAN	601+50.00	607+50.00	0	0	0
15	JAMES	607+50.00	407+75.00	0	0	0
16	HARRISON W	800+00.00	804+50.00	0	0	0
17	HANNISUN W	804+50.00	810+00.00	0	0	0
18	HARRISON E	701+00.00	705+00.00	0	0	0
19	HARRISON E	705+00.00	708+41.73	0	0	0
20	CEMETERY	900+00.00	904+52.12	0	0	0

SUB-TOTALS	2920	910	735
GRAND TOTAL		4565	

NOTES


1. TOTALS ROUNDED UP TO THE NEAREST 5 CU YD


AECON


345 EAST ASH AVENUE
DECATUR. II. 62326
PHOTH: 2177-73-6065

USER NAME = busanskyl	DESIGNED -	LMB	REVISED -
	DRAWN -	LMB	REVISED -
PLOT SCALE = 20.0000 ' / in.	CHECKED -	WBS	REVISED -
PLOT DATE = 5/5/2021	DATE -	4/30/2021	REVISED -

I R									F.A.U. SECTION			TOTAL SHEETS	SHEET NO.
ROADWAY SCHEDULE								7448	7448 09-00933-01-BR		MACON	1019	70
											CONTRA	CT NO.	95893
SCALE: N/A	SHEET	16	OF	16	SHEETS	STA.	TO STA.		ILLINOIS FED. AID PROJECT				

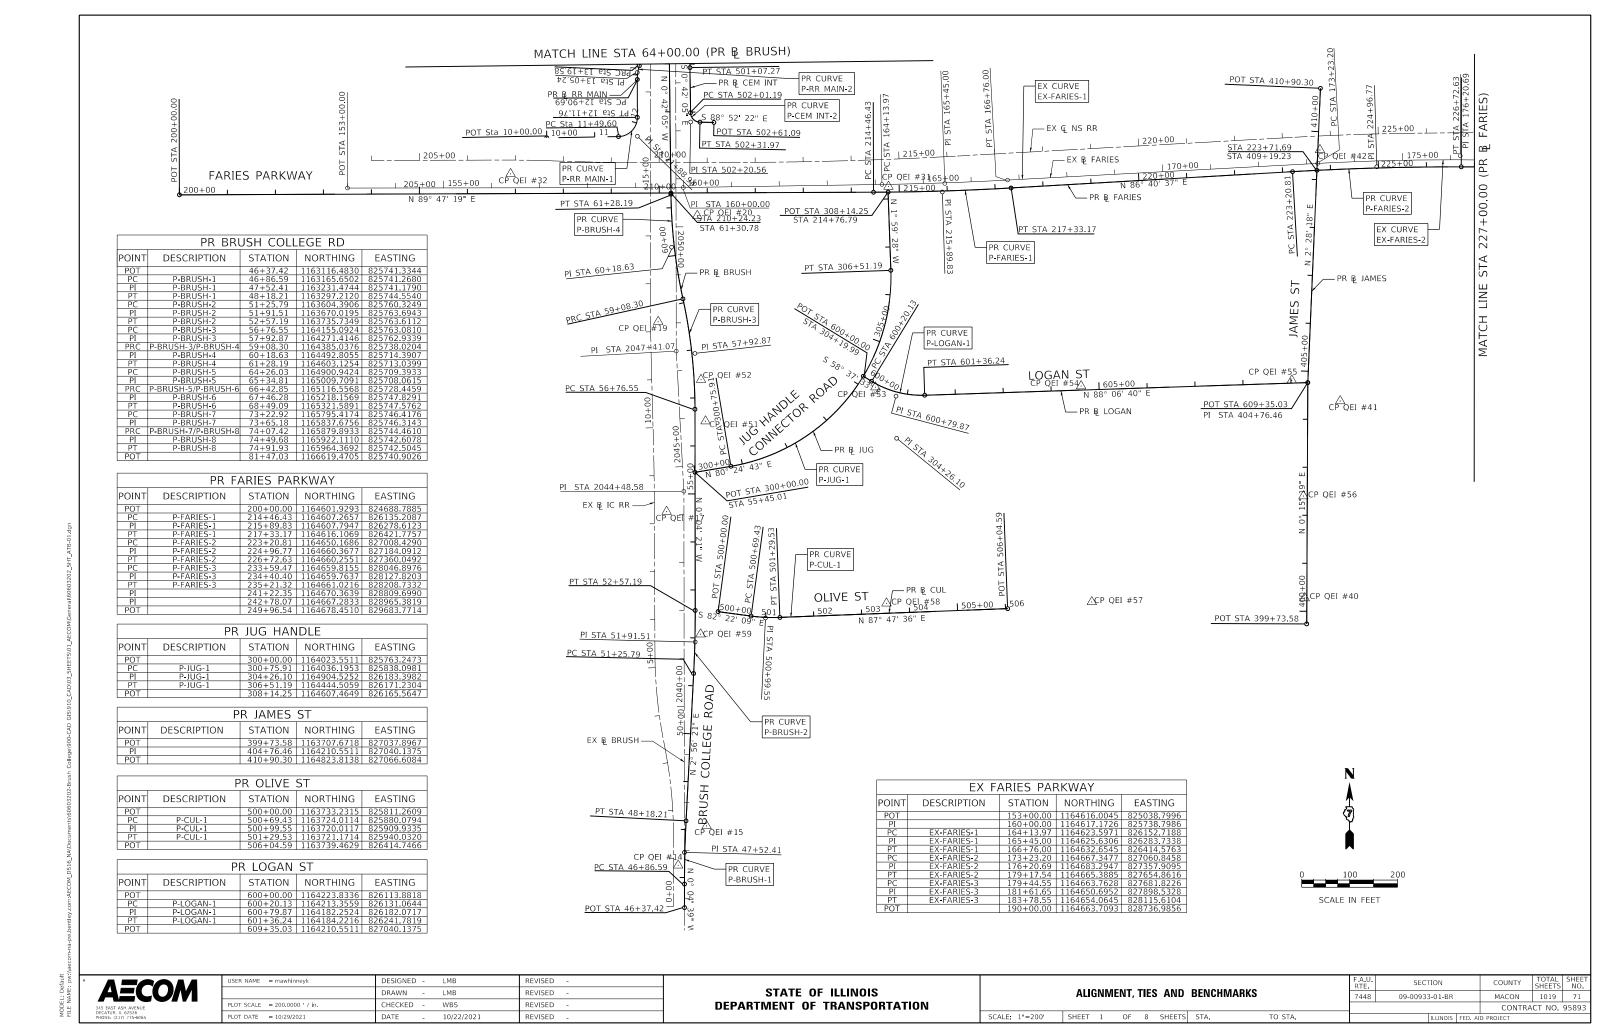

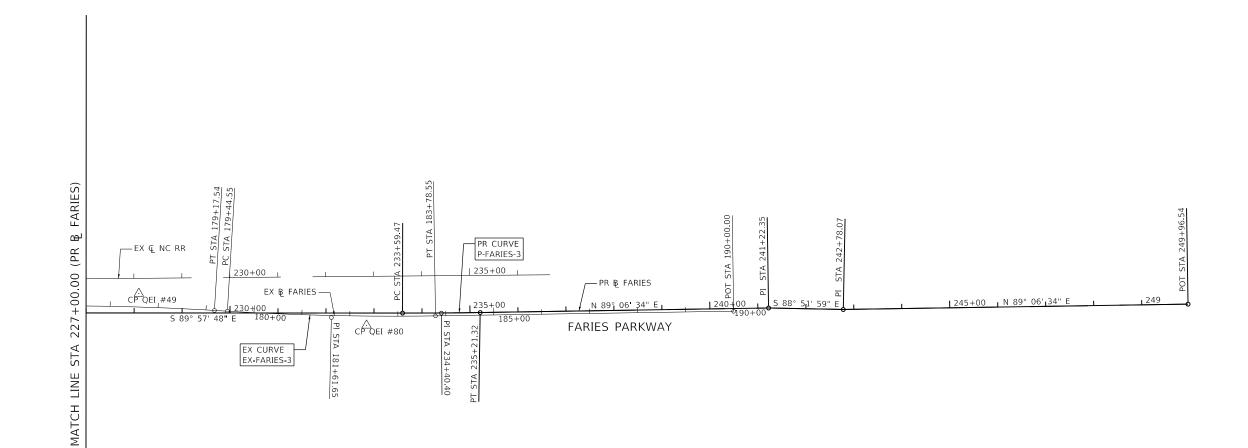

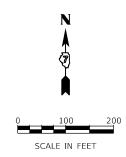

"	AECOM
L	345 EAST ASH AVENUE DECATUR, IL 62526 PHONE: (217) 775-6065

USER NAME = SearsB	DESIGNED	-	LMB	REVISED -
	DRAWN	-	LMB	REVISED -
PLOT SCALE = 200.0000 / in.	CHECKED	-	WBS	REVISED -
PLOT DATE = 4/28/2021	DATE	-	4/30/2021	REVISED -

STATI	E O I	F ILLINOIS
DEPARTMENT	0F	TRANSPORTATION

ALICAIMENT TICE AND DENICUMARIZE										SEC	ΓΙΟΝ		COUNTY	TOTAL SHEETS	SHEET NO.
ALIGNMENT, TIES AND BENCHMARKS								7448 09-00933-01-BR			MACON	1019	72		
												CONTRA	CT NO.	95893	
SCALE: 1"=200'	SHEET	2	OF	8	SHEETS	STA.	TO STA.				ILLINOIS	FED. All	D PROJECT		

PR E HARRISON AVE (EAST LEG)							
POINT	DESCRIPTION	STATION	NORTHING	EASTING			
POT		700+03.50	1165405.8861	825747.3701			
POT		710+02 18	1165408 1359	826749 5464			

PR CEMETERY ACCESS ROAD							
POINT	DESCRIPTION	DESCRIPTION STATION		EASTING			
POT		900+00.00	1164942.3240	826422.8156			
POT		904+65.08	1165407.4006	826422.0266			

	PR CEMETERY INTERIOR							
POINT	DESCRIPTION	STATION	NORTHING	EASTING				
POT		500+00.00	1164937.6615	825799.0007				
PC	P-CEM INT-1	500+26.04	1164937.1551	825772.9624				
PI	P-CEM INT-1	500+44.94	1164936.7876	825754.0682				
PCC	P-CEM INT-1/P-CEM INT-2	500+56.33	1164917.9029	825753.3651				
PI	P-CEM INT-2	500+81.80	1164892.4438	825752.4173				
PT	P-CEM INT-2	501+07.27	1164866.9689	825752.7292				
PC	P-CEM INT-3	502+01.19	1164773.0526	825753.8792				
PI	P-CEM INT-3	502+20.56	1164753.6824	825754.1164				
PT	P-CEM INT-3	502+31.97	1164753.3013	825773.4843				
POT		502+61.09	1164752.7286	825802.5973				

	EX BRUSH COLLEGE RD								
POINT	DESCRIPTION	STATION	NORTHING	EASTING					
POT		2000+00.00	1159535.5040	825740.6950					
PI		2013+56.46	1160891.9632	825742.4823					
PI		2025+23.47	1162058.9720	825743.1589					
PI		2044+48.58	1163984.0806	825739.9520					
PI		2047+41.07	1164276.1391	825724.1069					
PC	EX-BRUSH-1	2054+05.12	1164940.1888	825722.9227					
PI	EX-BRUSH-1	2055+06.63	1165041.6949	825722.7417					
PRC	EX-BRUSH-1/EX-BRUSH-2	2056+07.82	1165142.3000	825736.2377					
PI	EX-BRUSH-2	2056+76.19	1165210.0554	825745.3270					
PT	EX-BRUSH-2	2057+44.34	1165278.4174	825745.1109					
POT		2068+00.19	1166334.2699	825741.7745					

	PR RAILROAD MAINTENANCE ROAD								
POINT	DESCRIPTION	STATION	NORTHING	EASTING					
POT		10+00.00	1164720.5353	825454.2056					
PC	P-RR MAIN-1	11+49.60	1164723.2318	825603.7781					
PI	P-RR MAIN-1	11+88.94	1164723.9408	825643.1102 825643.0571					
PT	P-RR MAIN-1	12+11.76	1164763.2793						
PC	P-RR MAIN-2	12+90.69	1164842.2085	825642.9504					
PI	P-RR MAIN-2	13+05.24	1164856.7540	825642.9308					
PRC	P-RR MAIN-2/P-RR MAIN-3	13+19.58	1164870.7025	825647.0557					
PI	P-RR MAIN-3	13+34.13	1164884.6509	825651.1807					
PT	P-RR MAIN-3	13+48.47	1164899.1964	825651.1610					
POT		15+37.12	1165087.8485	825650.9061					





USER NAME = mawhinneyk	DESIGNED -	LMB	REVISED -
	DRAWN -	LMB	REVISED -
PLOT SCALE = 200.0000 / in.	CHECKED -	WBS	REVISED -
PLOT DATE = 10/29/2021	DATE -	10/22/2021	REVISED -
		,,	

PROPOSED CURVE DATA

PROPOSED BRUSH COLLEGE RD

PROP. CURVE P-BRUSH-2 PROP. CURVE P-BRUSH-1 PI STA. = 51+91.51PI STA = 47 + 52 41 $\Delta = 3^{\circ} 00' 59'' (RT)$ $\Delta = 3^{\circ} 00' 41'' (LT)$ D = 2° 17' 31" D = 2° 17' 31' R = 2.500.00R = 2.500.00T = 65.82T = 65.72I = 131.62I = 131.40E = 0.87E = 0.86e = NC (40 MPH)e = NC (40 MPH)T.R. = N/AT.R. = N/AS.E. RUN = N/A S F RUN = N/A P.C. STA. = 46+86.59P.C. STA. = 51+25.79P.T. STA. = 48 + 18.21P.T. STA. = 52+57.19

PROP. CURVE P-BRUSH-3 PI STA. = 57+92.87 Δ = 12° 17' 41'' (LT) D = 5° 18' 19''R = 1,080.00'T = 116.32'L = 231.75'E = 6.25'e = NC (40 MPH) T.R. = N/AS.E. RUN = N/AP.C. STA. = 56+76.55P.T. STA. = 59+08.30 PROP. CURVE P-BRUSH-4 PI STA. = 60+18.63 $\Delta = 11^{\circ} 39^{\circ} 57^{\circ}$ (RT) $D = 5^{\circ} 18^{\circ} 19^{\circ}$ $R = 1,080.00^{\circ}$ $T = 110.33^{\circ}$ $L = 219.89^{\circ}$ $E = 5.62^{\circ}$ E = NC (40 MPH)T.R. = N/AS.E. RUN = N/AP.C. STA. = 59+08.30P.T. STA. = 61+28.19 PROP. CURVE P-BRUSH-5 PROP. CURVE P-BRUSH-6 PI STA = 65 + 34.81PI STA = 67 + 46.28 $\Delta = 10^{\circ} 56' 28" (LT)$ $\Delta = 11^{\circ} 30' 09'' (RT)$ D = 5° 18' 19" D = 5° 18' 19" R = 1.080.00R = 1.080.00T = 108.77T = 103.43I = 216.82I = 206.24E = 4.94E = 5.46e = NC (40 MPH)e = NC (40 MPH)T.R. = N/AT.R. = N/AS.E. RUN = N/A S = RUN = N/AP.C. STA. = 64+26.03P.C. STA. = 66+42.85P.T. STA. = 66+42.85P.T. STA. = 68+49.09PROPOSED E HARRISON

PROP. CURVE P-BRUSH-7 PI STA. = 73+65.18 Δ = 2° 22' 24" (LT) D = 2° 48' 31" R = 2,040.00' T = 42.26' L = 84.50' E = 0.44' e = NC (40 MPH) T.R. = N/A S.E. RUN = N/A P.C. STA. = 73+22.92 P.T. STA. = 74+07.42

PROPOSED LOGAN ST

PROP. CURVE P LOGAN-1

PI STA = 600 + 79.87

 $D = 28^{\circ} 38' 52''$

R = 200.00'

T = 59.74

L = 116.11

E = 8.73

T.R. = N/A

S.E. RUN = N/A

P.C. STA. = 600+20.13 P.T. STA. = 601+36.24

e = NC

 $\Delta = 33^{\circ} 15' 47'' (LT)$

PROP. CURVE P-BRUSH-8
PI STA. = 74+49.68 $\Delta = 2^{\circ} 22^{\circ} 24^{\circ} (RT)$ $D = 2^{\circ} 48^{\circ} 31^{\circ}$ $R = 2,040.00^{\circ}$ $T = 42.26^{\circ}$ $L = 84.50^{\circ}$ $E = 0.44^{\circ}$ e = NC (40 MPH) T.R. = N/A S.E. RUN = N/AP.C. STA. = 74+07.42
P.T. STA. = 74+91.93

PROPOSED FARIES PARKWAY

PROP. CURVE P-FARIES-1 PI STA. = 215+89.83 Δ = 3° 06' 42" (LT) D = 1° 05' 07" R = 5,280.00' T = 143.40' L = 286.74' E = 1.95' e = NC (40 MPH) T.R. = N/A S.E. RUN = N/A P.C. STA. = 214+46.43 P.T. STA. = 217+33.17

PROPOSED RR MAINT RD

PROP. CURVE P-RR MAIN-1

PI STA. = 11 + 88.94

D = 143° 14' 22'

R = 40.00

T = 39.34

I = 62.16

E = 16.10

TR = N/A

S.E. RUN = N/A

P.C. STA. = 11+49.60

P.T. STA. = 12 + 11.76

e = NC

 $\Delta = 89^{\circ} 02' 41'' (LT)$

PROP. CURVE P-FARIES-2 PI STA. = 224+96.77 Δ = 3° 21' 35" (RT) D = 0° 57' 18" R = 6,000.00' T = 175.96' L = 351.82' E = 2.58' e = NC (40 MPH) T.R. = N/A S.E. RUN = N/A P.C. STA. = 226+72.63

PROP. CURVE P-RR MAIN-2

PI STA. = 13+05.24

D = 57° 17' 45"

 $R = 100.00^{\circ}$

T = 14.55

I = 28.89

E = 1.05

T.R. = N/A

S.E. RUN = N/A

PC STA = 12+90.69

P.T. STA. = 13 + 19.58

e = NC

 $\Delta = 16^{\circ} 33' 07'' (RT)$

PROP. CURVE P-FARIES-3 PI STA. = 234+40.40 Δ = 0° 55' 38" (LT) D = 0° 34' 23" R = 10,000.00' T = 80.92' L = 161.84' E = 0.33' e = NC T.R. = N/A S.E. RUN = N/A P.C. STA. = 233+59.47 P.T. STA. = 235+21.32

PROP. CURVE P-RR MAIN-3

PI STA. = 13 + 34.13

D = 57° 17' 45"

R = 100.00

T = 14.55

I = 28.89

E = 1.05

TR = N/A

S.F. RLIN = N/A

P.C. STA. = 13+19.58

P.T. STA. = 13+48.47

e = NC

 $\Delta = 16^{\circ} 33' 07" (LT)$

S.E. RUN = N/A P.C. STA. = 804+78.90

(W LEG)

PROP. CURVE P HAR-W1

PI STA = 806 + 58 90

D = 31° 49' 52"

R = 180.00'

T = 180.00

L = 282.74

E = 74.56

T.R. = N/A

e = NC

 $\Delta = 90^{\circ} 00' 00'' (RT)$

P.T. STA. = 807 + 61.64

PROPOSED CEMETERY INTERIOR RD

PROP. CURVE P-JUG-1
PI STA. = 304+26.10
Δ = 82° 24' 11" (LT)
D = 14° 19' 26"
R = 400.00'
T = 350.19'
L = 575.28'
E = 131.63'
e = NC
T.R. = N/A
S.E. RUN = N/A
P.C. STA. = 300+75.91
P.T. STA. = 306+51.19

PROPOSED JUGHANDLE

PI STA. = 500+44.94 $\Delta = 86^{\circ} 45^{\circ} 14^{\circ}$ (LT) D = $286^{\circ} 28^{\circ} 44^{\circ}$ R = 20.00° T = 18.90° L = 30.28° E = 7.52° e = NC T.R. = N/A T.R. = N/A P.C. STA. = 500+26.04P.T. STA. = 500+56.33

PROP. CURVE P CEM INT1

PROP. CURVE P_CEM_INT2 PI STA. = 500+81.80 $\Delta = 2^{\circ} 50^{\circ} 0.1^{\circ} (LT)$ $D = 5^{\circ} 33^{\circ} 44^{\circ}$ $R = 1,030.08^{\circ}$ $T = 25.48^{\circ}$ $L = 50.94^{\circ}$ $E = 0.32^{\circ}$ e = NCT.R. = N/A T.R. = N/A P.C. STA. = 500+56.33P.T. STA. = 501+07.27

PROPOSED OLIVE ST

PROP. CURVE P CUL-1

PI STA. = 500+95.55

 $\Delta = 9^{\circ} 50' 15'' (LT)$

 $D = 16^{\circ} 22' 13"$

R = 350.00

T = 30.12

L = 60.09

E = 1.29

e = NC

T.R. = N/A

S.E. RUN = N/A

P.C. STA. = 500+69.43

P.T. STA. = 501+29.53

P.T. STA. = 502 + 31.97

EXISTING CURVE DATA

EXISTING BRUSH COLLEGE RD

EXIST. CURVE EX_BRUSH-1 PI STA. = 2055+06.63 $\Delta = 7^{\circ}$ 44' 34" (RT) $D = 3^{\circ}$ 49' 11" $R = 1.500.00^{\circ}$ $T = 101.51^{\circ}$ $L = 202.70^{\circ}$ $E = 3.43^{\circ}$ e = NC T.R. = N/AS.E. RUN = N/A P.C. STA. = 2056+05.12P.T. STA. = 2056+07.82 EXIST. CURVE EX_BRUSH-2 PI STA. = 2056+76.19 $\Delta = 7^{\circ} 49' 18'' (LT)$ $D = 5^{\circ} 43' 46''$ R = 1,000.00'T = 68.36'L = 136.51'E = 2.33'e = NCT.R. = N/AS.E. RUN = N/A P.C. STA. = 2056+07.82P.T. STA. = 2057+44.34

<u>ua</u>

EXISTING FARIES PARKWAY

SCALE: N/A

PI STA. = $165+4\overline{5}.00$ $\Delta = 2^{\circ}$ 11' 01" (LT) D = 0° 50' 0" R = 6.875.49' T = 131.03' L = 262.03' E = 1.25' e = NC T.R. = N/A S.E. RUN = N/A P.C. STA. = 164+13.97P.T. STA. = 166+76.00

EXIST. CURVE EX FARIES-1

EXIST. CURVE EX_FARIES-2 PI STA. = 176+20.69 $\Delta = 6^{\circ} 31^{\circ} 25^{\circ} (RT)$ $D = 1^{\circ} 05^{\circ} 51^{\circ}$ $R = 5,220.03^{\circ}$ $T = 297.49^{\circ}$ $L = 594.34^{\circ}$ $E = 8.47^{\circ}$ PI STA. = 181+61.65 $\Delta = 4^{\circ} 20' 24'' (LT)$ $D = 1^{\circ} 00' 00''$ R = 5,729.58' T = 217.10' L = 434.00' E = 4.11' e = NC T.R. = N/A S.E. RUN = N/A P.C. STA. = 179+44.55P.T. STA. = 183+78.55

EXIST. CURVE EX FARIES-3

AECOM


345 EAST ASH AVENUE
DECATUR, IL. 05236

USER NAME = mawhinneyk	DESIGNED -	LMB	REVISED -
	DRAWN -	LMB	REVISED -
PLOT SCALE = 100.0000 ' / in.	CHECKED -	WBS	REVISED -
PLOT DATE = 10/29/2021	DATE -	10/22/2021	REVISED -

STATE OF ILLINOIS DEPARTMENT OF TRANSPORTATION


ALIGNMENT, TIES AND BENCHMARKS		F.A.U. RTE. SECTION		COUNTY	TOTAL SHEETS	SHEET NO.
		7448	09-00933-01-BR	MACON	1019	74
				CONTRA	ACT NO.	95893
SHEET 4 OF 8 SHEETS STA.	TO STA.		ILLINOIS FED. AI	D PROJECT		

IRON PIN N 1162177.643 E 825719.651 ELEV. 664.881

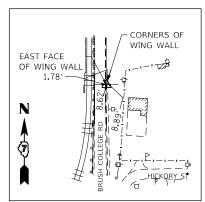


CONTROL POINT QEI#12

CHISELED X N 1162844.236 E 825755.236 ELEV. 653.881

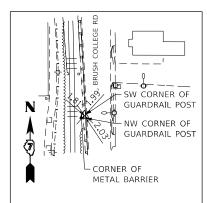


CONTROL POINT QEI#17

CHISILED X N 1163941.636 E 825703.965 ELEV. 674.643

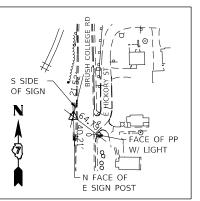


CONTROL POINT QEI#10

IRON PIN N 1162463.418 E 825717.208 ELEV. 666.542

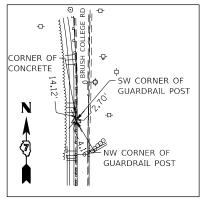


CONTROL POINT QEI#14

CHISELED X N 1163204.627 E 825728.187 ELEV. 654.017

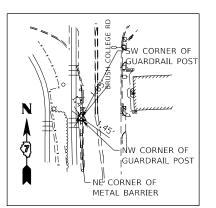


CONTROL POINT QEI#19

CHISILED X N 1164337.473 E 825686.472 ELEV. 673.691

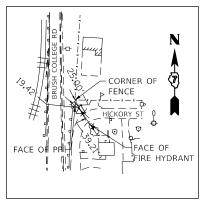


CONTROL POINT QEI#11

IRON PIN N 1162664.709 E 825795.704 ELEV. 653.881

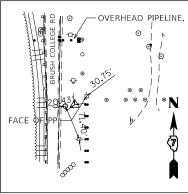

CONTROL POINT QEI#15

IRON PIPE N 1163286.617 E 825787.284 ELEV. 671.824

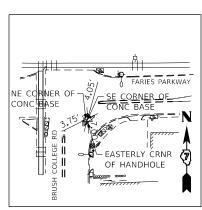

CONTROL POINT QEI#20

CHISILED X N 1164558.386 E 825767.995 ELEV. 674.709




USER NAME = SearsB	DESIGNED -	LMB	REVISED -	Ī
	DRAWN -	LMB	REVISED -	
PLOT SCALE = 200.0000 ' / in.	CHECKED -	WBS	REVISED -	
PLOT DATE = 4/28/2021	DATE -	4/30/2021	REVISED -	

STATE OF ILLINOIS
DEPARTMENT OF TRANSPORTATION


				A.U. RTE	SECTION	COUNTY	TOTAL SHEETS	SHEET NO.
		ALIGNMENT, TIES AND BENCHMARKS	74	7448	09-00933-01-BR	MACON	1019	75
						CONTRA	CT NO.	95893
ı	SCALE: 1"=200"	SHEET 5 OF 8 SHEETS STA. TO	STA.		ILLINOIS FED. AII	D PROJECT		

CHISILED X N 1165106.667 E 825657.910 ELEV. 673.071

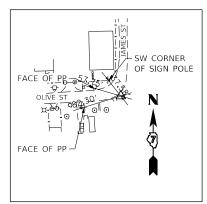


CONTROL POINT QEI#40

IRON PIN N 1163761.580 E 827033.818 ELEV. 677.092

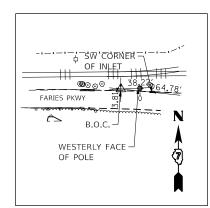


CONTROL POINT QEI#49

IRON PIN N 1164700.484 E 827497.192 ELEV. 657.020

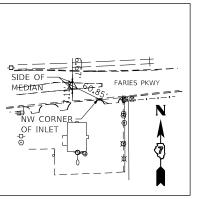


CONTROL POINT QEI#31

CHISILED X N 1164619.180 E 826166.459 ELEV. 674.451

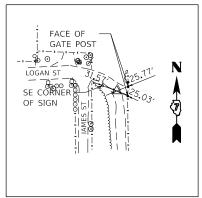


CONTROL POINT QEI#41

MAG NAIL N 1164172.197 E 827107.625 ELEV. 670.115

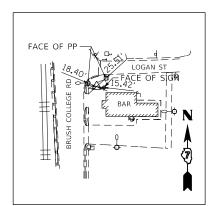


CONTROL POINT QEI#51

MAG NAIL N 1164130.179 E 825785.106 ELEV. 674.647

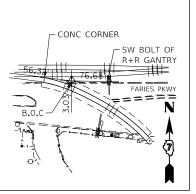


CONTROL POINT QEI#32

IRON PIN N 1164645.578 E 825378.790 ELEV. 674.841

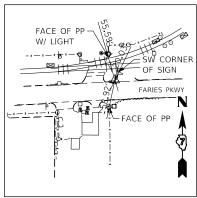

CONTROL POINT QEI#42

CHISILED X N 1164695.475 E 827065.521 ELEV. 665.273

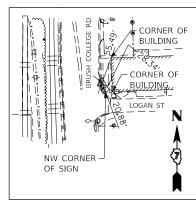

CONTROL POINT QEI#52


CHISILED X N 1164216.652 E 825775.790 ELEV. 674.388



USER NAME = SearsB	DESIGNED	-	LMB	REVISED -	
	DRAWN	-	LMB	REVISED -	
PLOT SCALE = 200.0000 ' / in.	CHECKED	-	WBS	REVISED -	
PLOT DATE = 4/28/2021	DATE	-	4/30/2021	REVISED -	


		F.A.U. RTE	SECTION	COUNTY	TOTAL SHEETS	SHEET NO.
	ALIGNMENT, TIES AND BENCHMARKS	7448	09-00933-01-BR	MACON	1019	76
				CONTRA	ACT NO.	95893
SCALE: 1"=200"	SHEET 6 OF 8 SHEETS STA. TO STA.		ILLINOIS FED. AI	D PROJECT		

IRON PIN W/ CAP N 1164200.994 E 826139.165 ELEV. 677.607

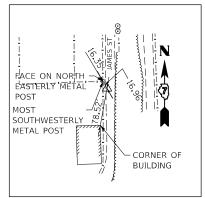


CONTROL POINT QEI#56

MAG SPIKE N 1163974.112 E 827031.133 ELEV. 673.549

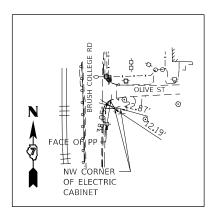


CONTROL POINT QEI#59

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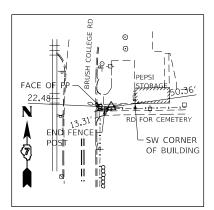
CONTROL POINT QEI#54

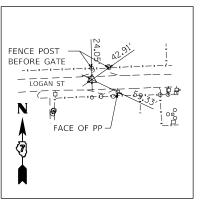MAG NAIL N 1164203.403 E 826567.716 ELEV. 675.133




CONTROL POINT QEI#57

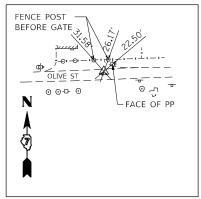MAG NAIL N 1163753.411 E 826590.052 ELEV. 677.238




CONTROL POINT QEI#60

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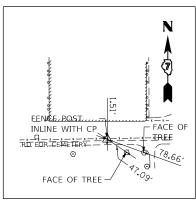
CONTROL POINT QEI#55

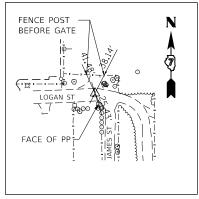MAG NAIL N 1164215.121 E 827006.956 ELEV. 671.783



CONTROL POINT QEI#58

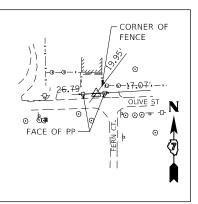IRON PIN W/ CAP N 1163750.601 E 826162.119 ELEV. 675.440




CONTROL POINT QEI#61

MAG SPIKE N 1164949.123 E 826087.356 ELEV. 671.361




USER NAME = SearsB	DESIGNED -	LMB	REVISED -	
	DRAWN -	LMB	REVISED -	
PLOT SCALE = 200.0000 ' / in.	CHECKED -	WBS	REVISED -	
PLOT DATE = 4/28/2021	DATE -	4/30/2021	REVISED -	

		F.A.U. RTE	SECTION	COUNTY	TOTAL SHEETS	SHEET NO.
	ALIGNMENT, TIES AND BENCHMARKS	7448	09-00933-01-BR	MACON	1019	77
				CONTRA	ACT NO.	95893
SCALE: 1"=200"	SHEET 7 OF 8 SHEETS STA. TO STA.		ILLINOIS FED. AI	ID PROJECT		

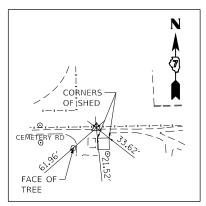


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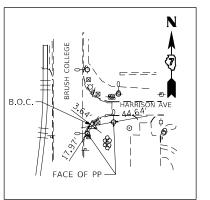
CONTROL POINT QEI#65

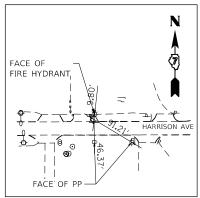IRON PIN W/ CAP N 1165425.520 E 826385.129 ELEV. 666.553




CONTROL POINT QEI#68

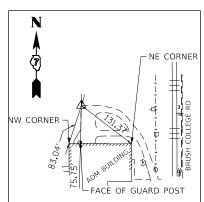MAG NAIL N 1165686.001 E 825502.395 ELEV. 670.010




CONTROL POINT QEI#63

IRON PIN W/ CAP N 1165369.010 E 825794.641 ELEV. 671.94

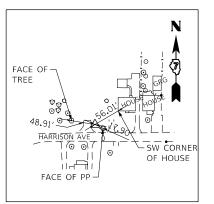


CONTROL POINT QEI#66

IRON PIN W/ CAP N 1165114.741 E 825315.478 ELEV. 672.161

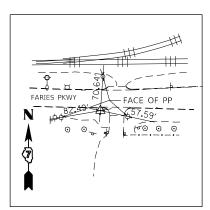


CONTROL POINT QEI#80

IRON PIN W/ CAP N 1164634.261 E 827971.959 ELEV. 663.946

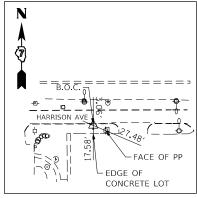


CONTROL POINT QEI#64

IRON PIN W/ CAP N 1165388.605 E 826059.483 ELEV. 668.267

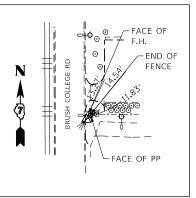

CONTROL POINT QEI#67

IRON PIN W/ CAP N 1165824.338 E 825777.261 ELEV. 672.389

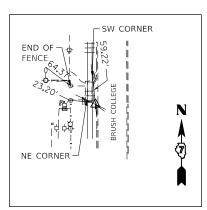


CONTROL POINT QEI#81

CHISILED X N 1166223.788 E 825706.452 ELEV. 672.710



USER NAME = SearsB	DESIGNED -	LMB	REVISED -	
	DRAWN -	LMB	REVISED -	
PLOT SCALE = 200.0000 ' / in.	CHECKED -	WBS	REVISED -	
PLOT DATE = 4/28/2021	DATE -	4/30/2021	REVISED -	

	F.A.U. RTE	SECTION	COUNTY	TOTAL SHEETS	
ALIGNMENT, TIES AND BENCHMARKS	7448	09-00933-01-BR	MACON	1019	78
			CONTRA	ACT NO.	95893
SCALE: 1"=200' SHEET 8 OF 8 SHEETS STA. TO STA.		ILLINOIS FED. AI	D PROJECT		

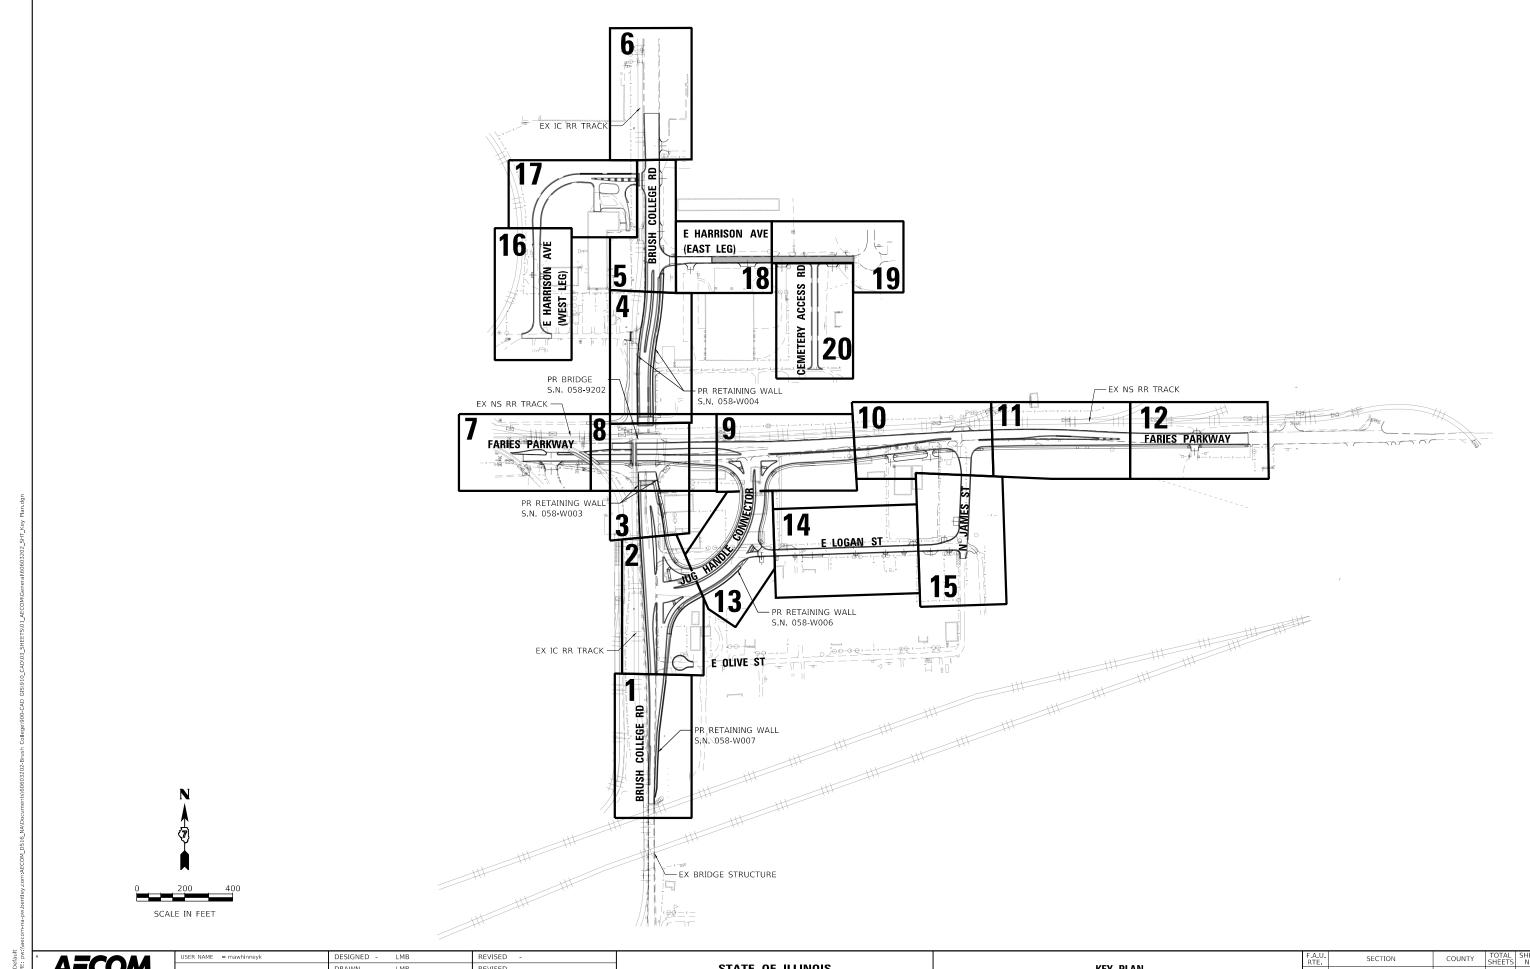



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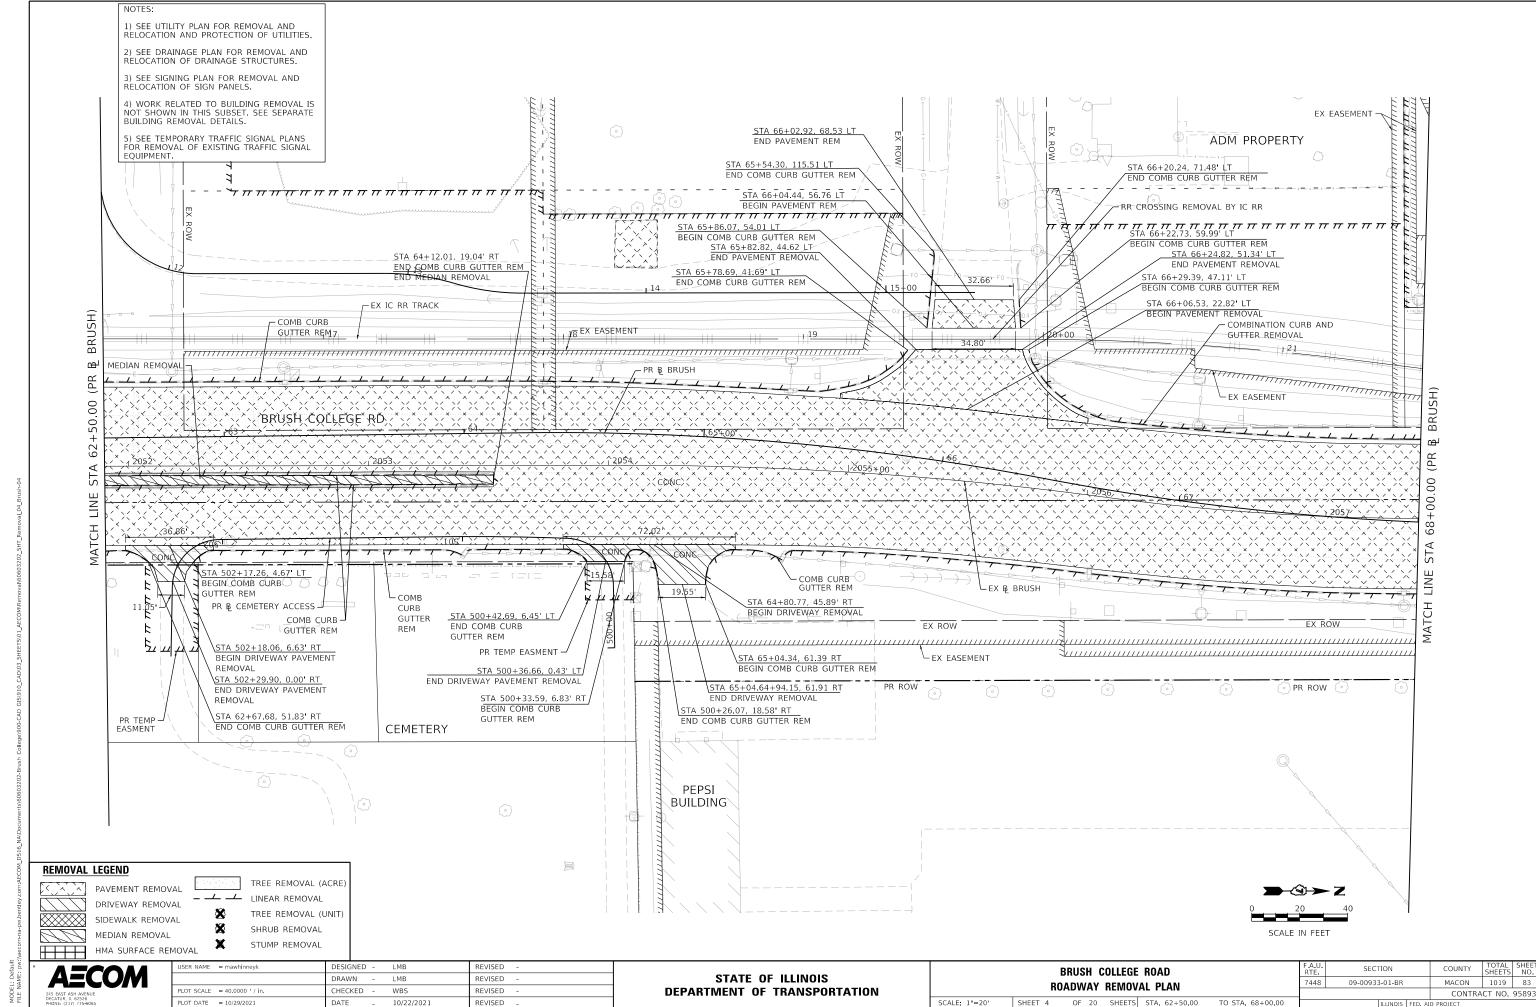
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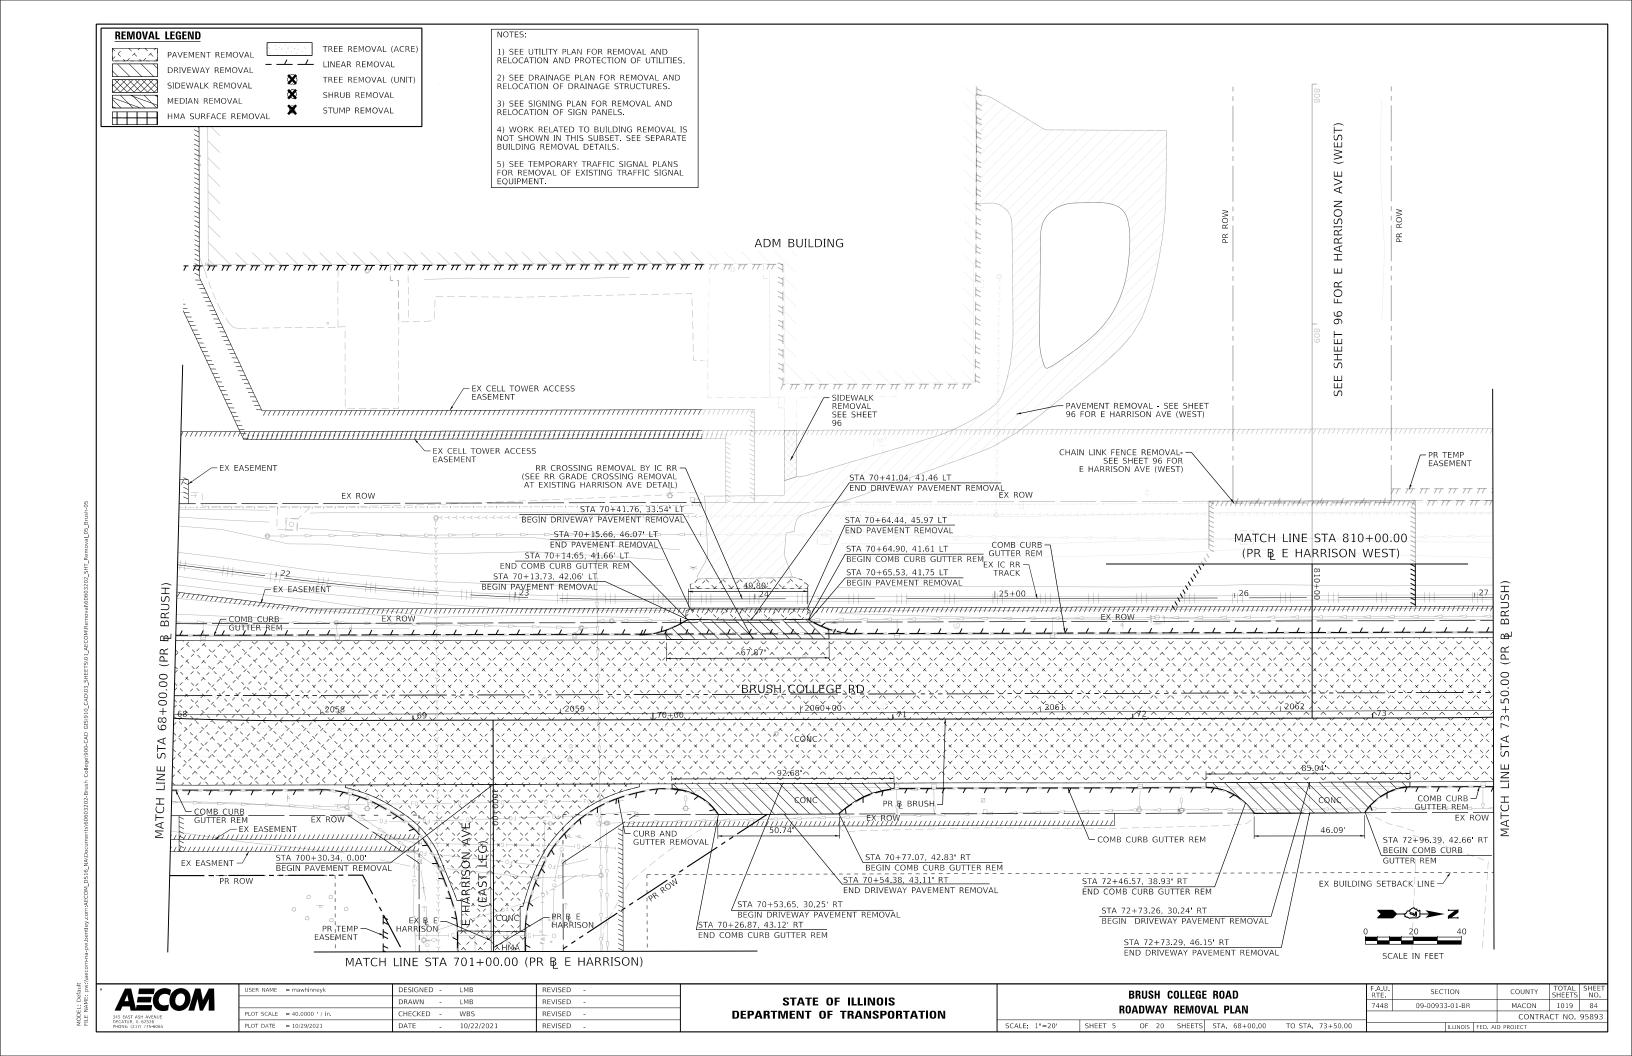
STATE OF ILLINOIS **DEPARTMENT OF TRANSPORTATION**


KEY PLAN 7448 09-00933-01-BR MACON 1019 79 CONTRACT NO. 95893 SCALE: 1"=200' SHEET 1 OF 1 SHEETS STA.





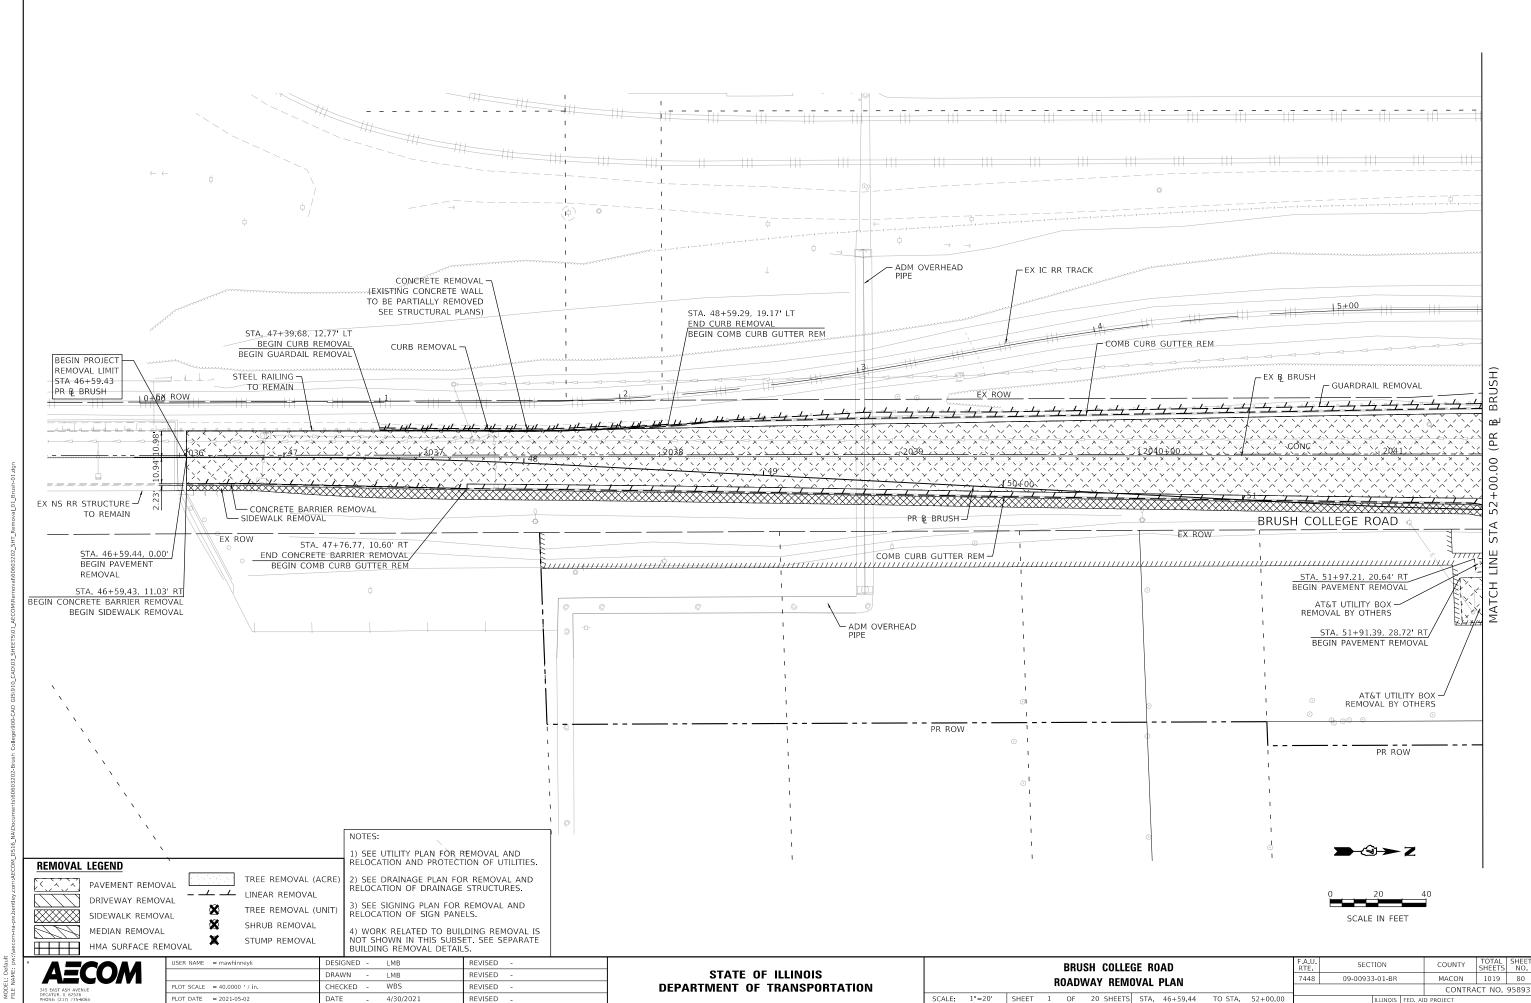

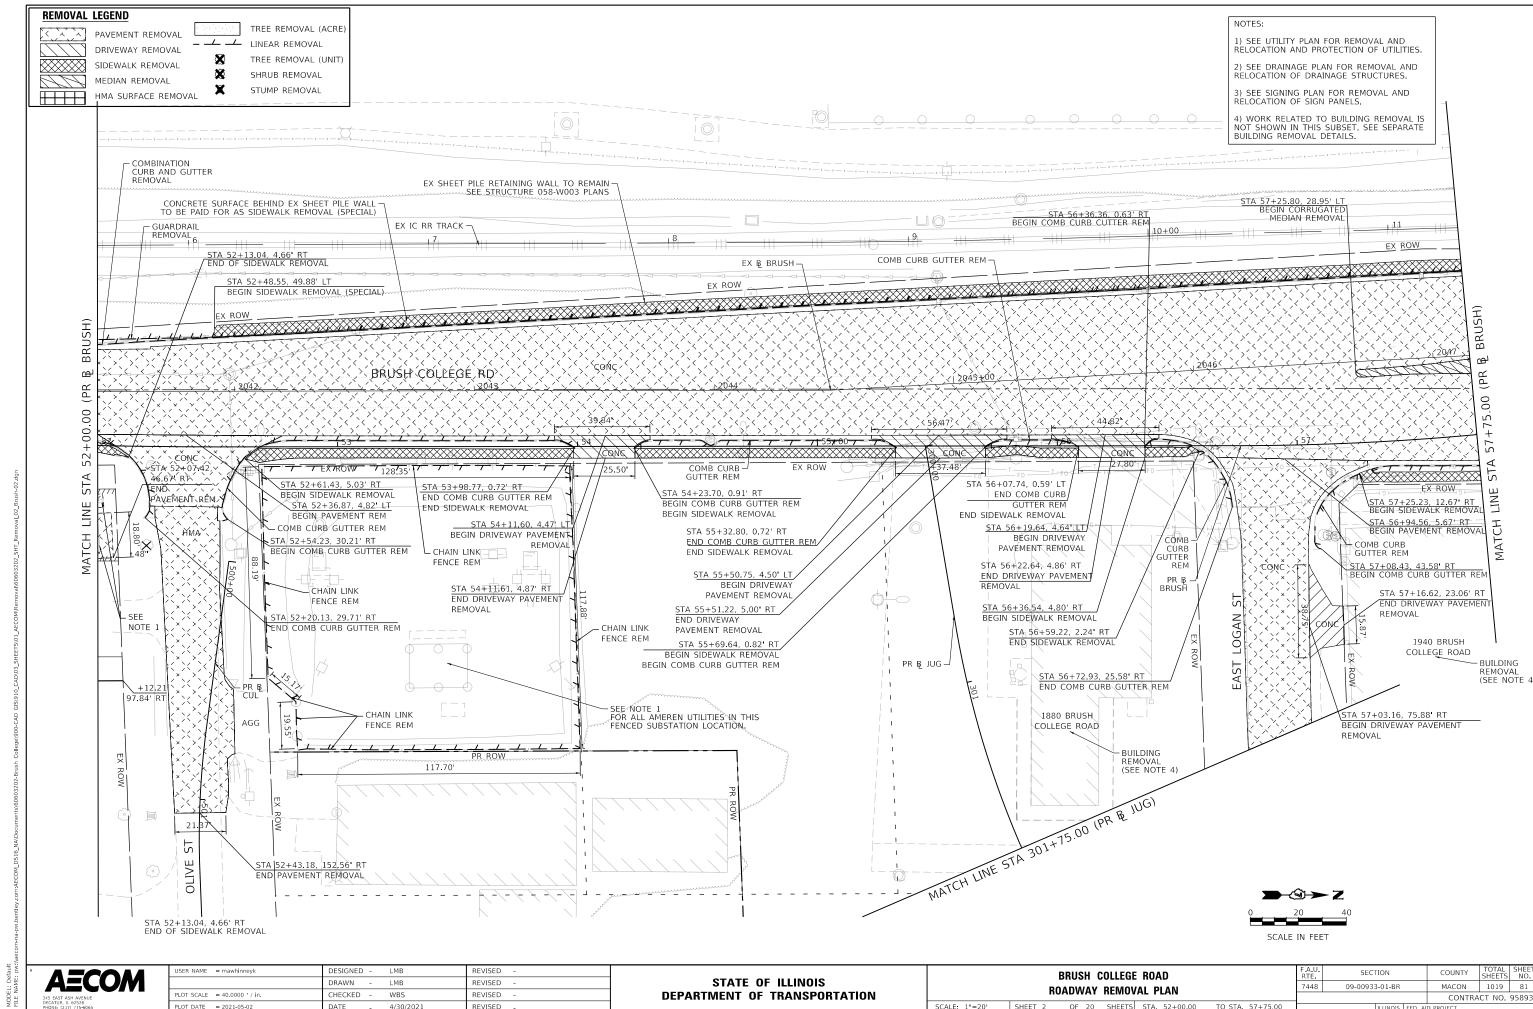


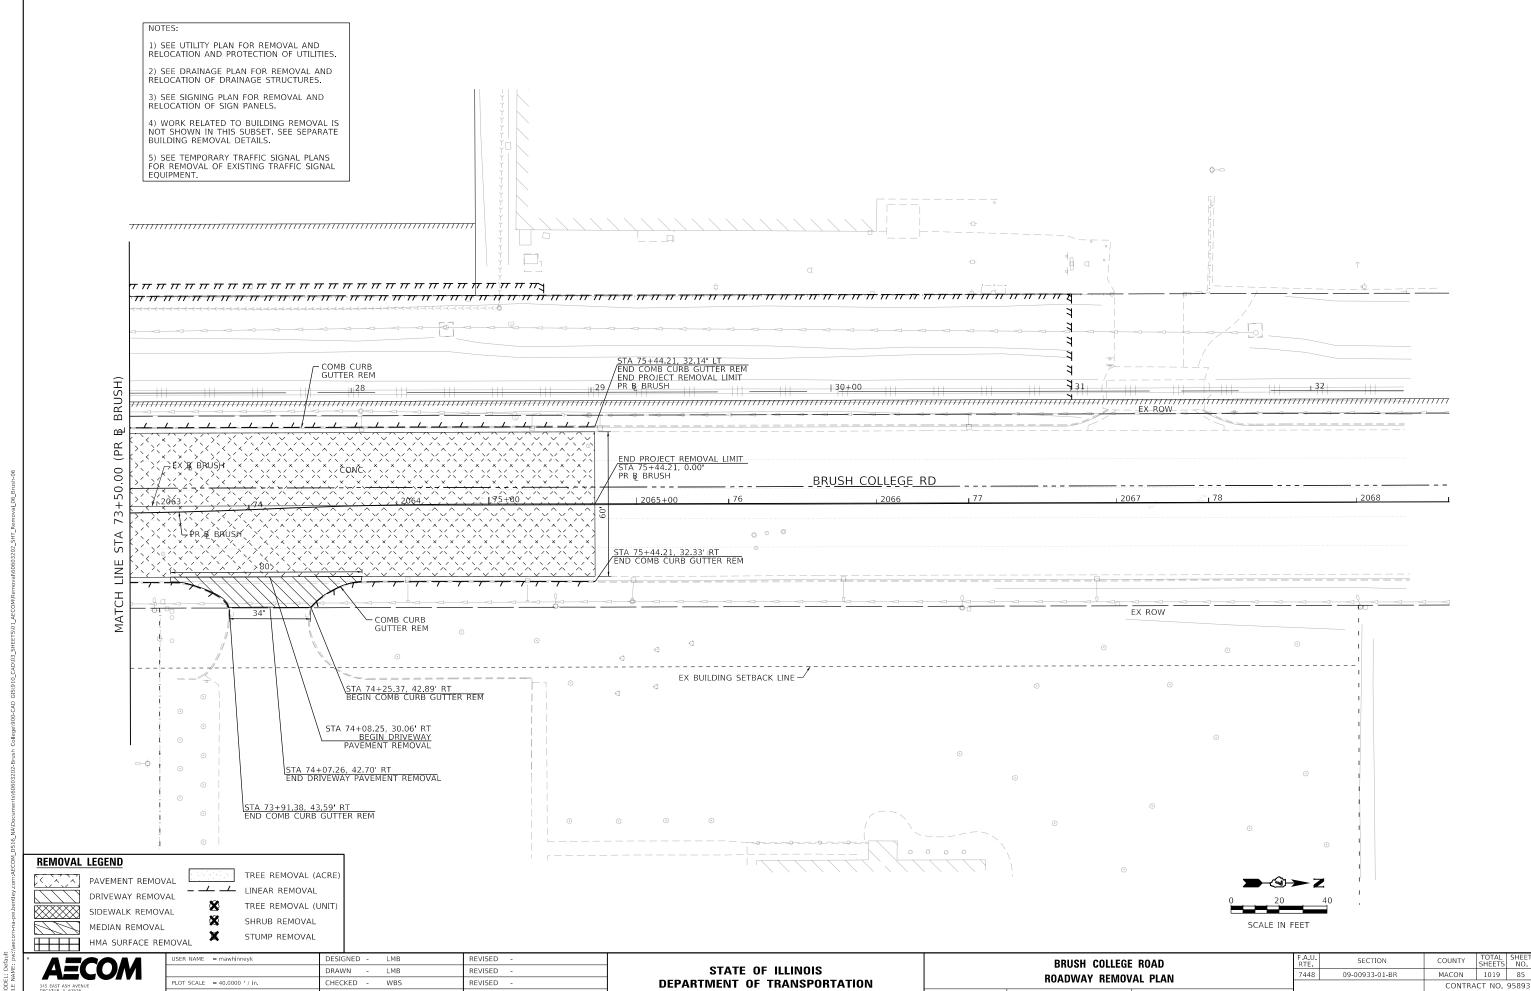

REVISED

OF 20 SHEETS STA. 73+50.00 TO STA. 75+44.21

PLOT DATE = 2021-05-02

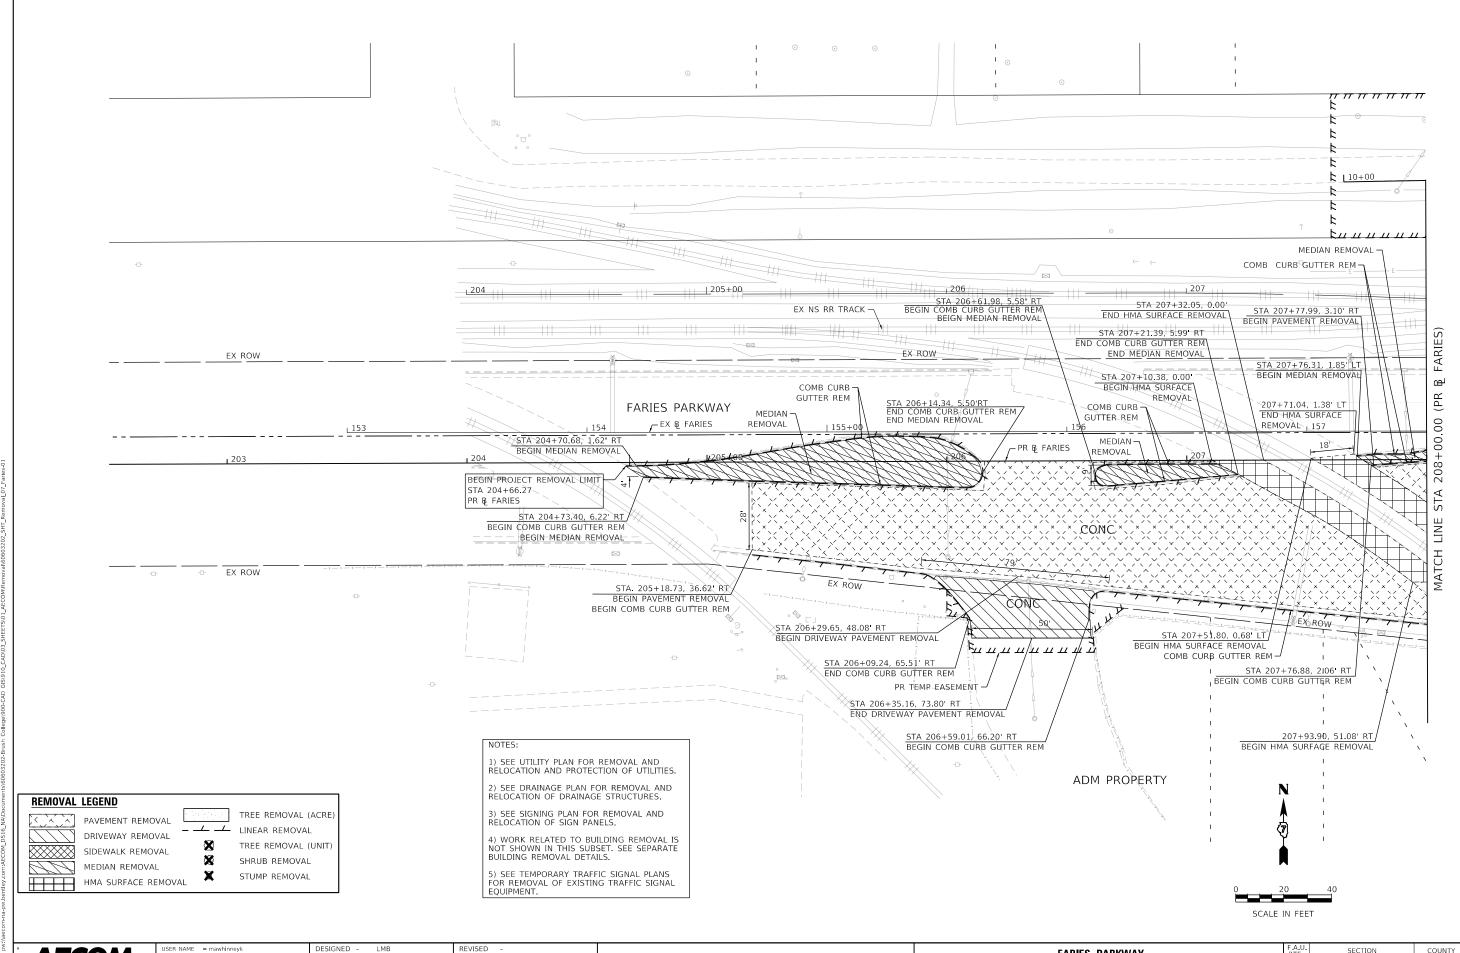

MODEL: Default FILE NAME: pw:\\aecom-na-pw.be

AECOM

345 EAST ASH AVENUE
DECATUR, IL 5/25/6
PHONE: 121/12/75-66/5

USER NAME = mawhinneyk	DESIGNED -	LMB	REVISED -
	DRAWN -	LMB	REVISED -
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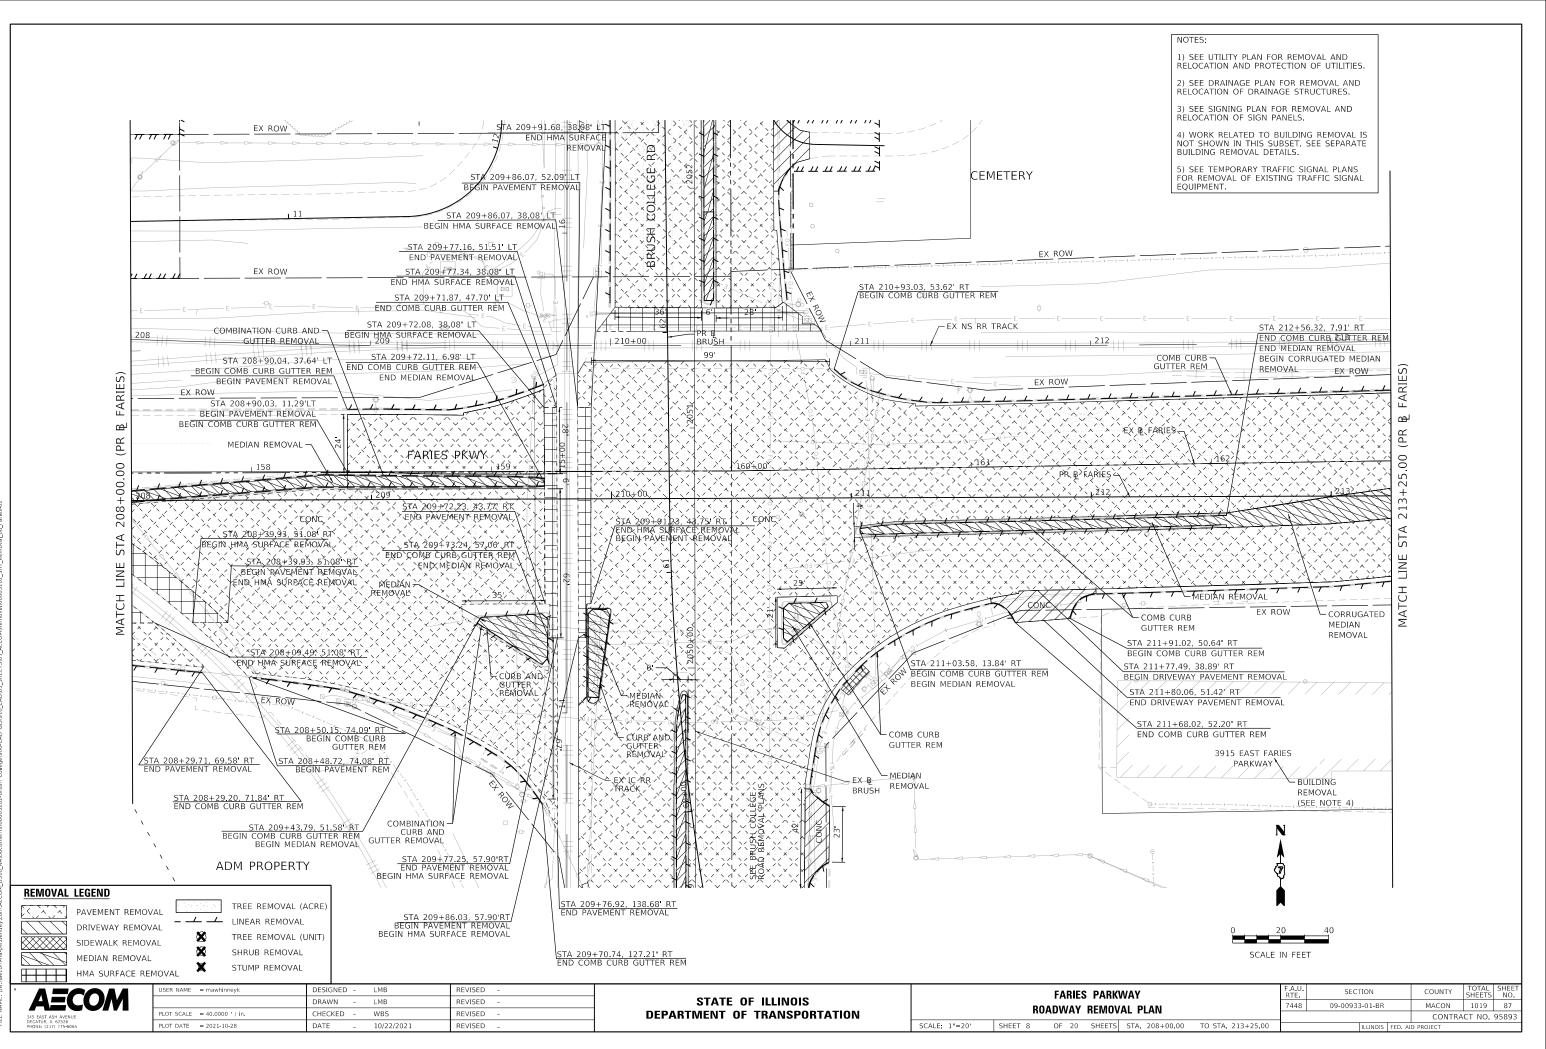
STATE OF ILLINOIS
DEPARTMENT OF TRANSPORTATION


FARIES PARKWAY ROADWAY REMOVAL PLAN								
SCALE: 1"=20"	SHEET 7	OF 20	SHEETS	STA. 204	4+66.27	TO STA. 208+00.00		

F.A.U. SECTION COUNTY TOTAL SHEETS NO.

7448 09-00933-01-B MACON 1019 86

CONTRACT NO. 95893



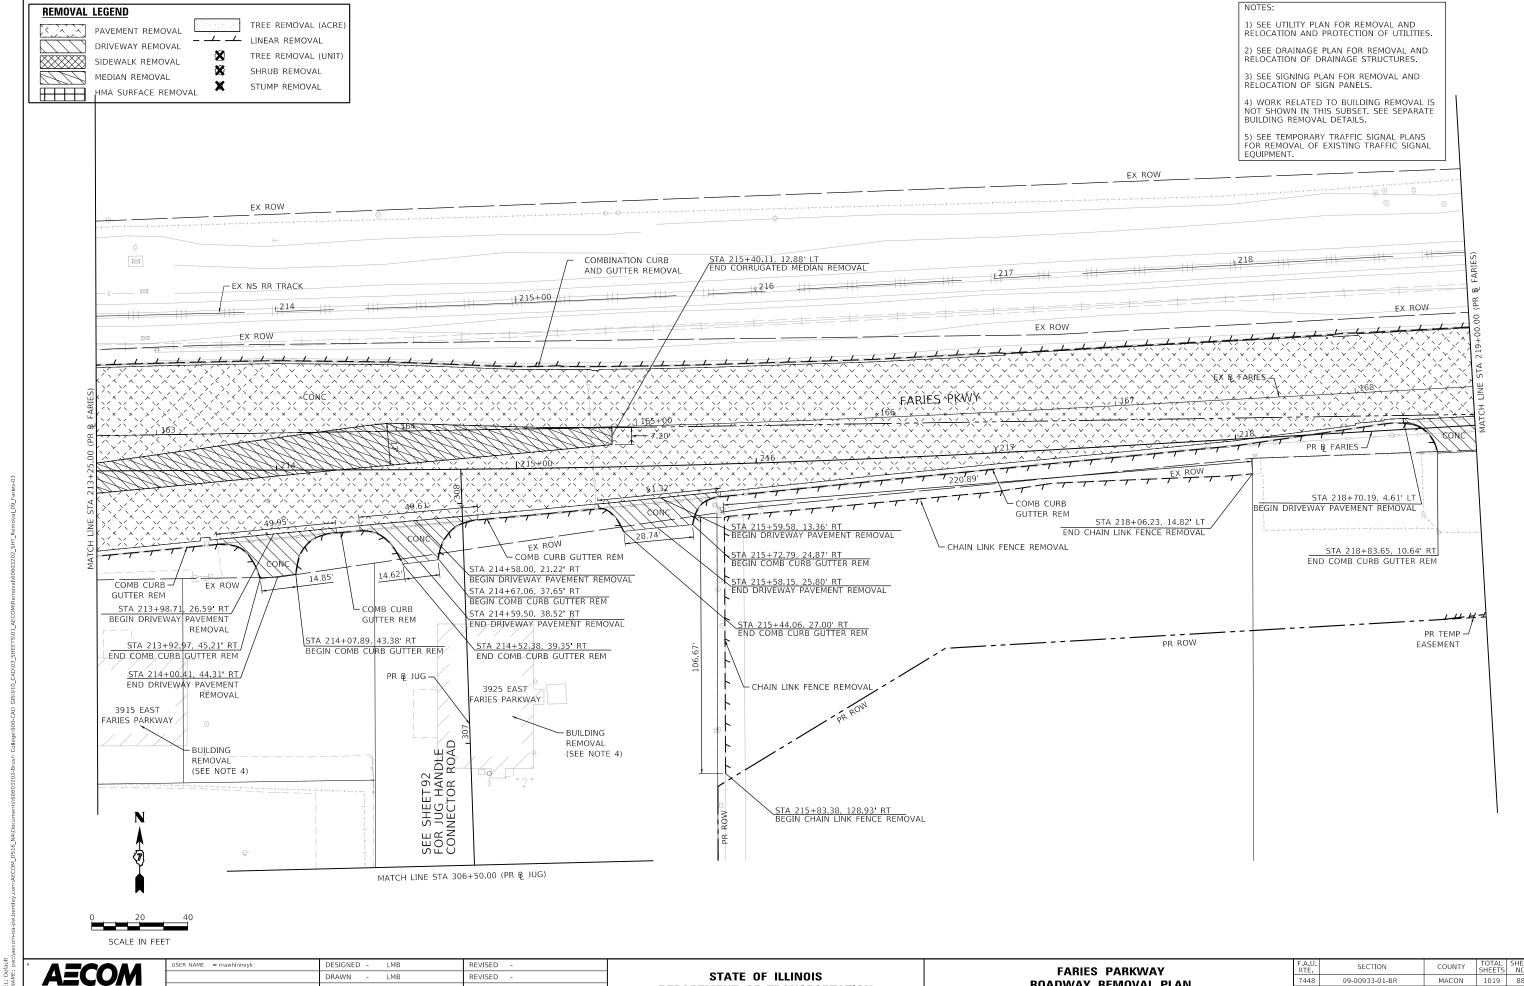


HECKED WBS REVISED PLOT DATE = 2021-05-02


DEPARTMENT OF TRANSPORTATION

ROADWAY REMOVAL PLAN OF 20 SHEETS STA. 213+25.00 TO STA. 219+00.00


SCALE: 1"=20"

7448 09-00933-01-BR MACON 1019 88 CONTRACT NO. 95893

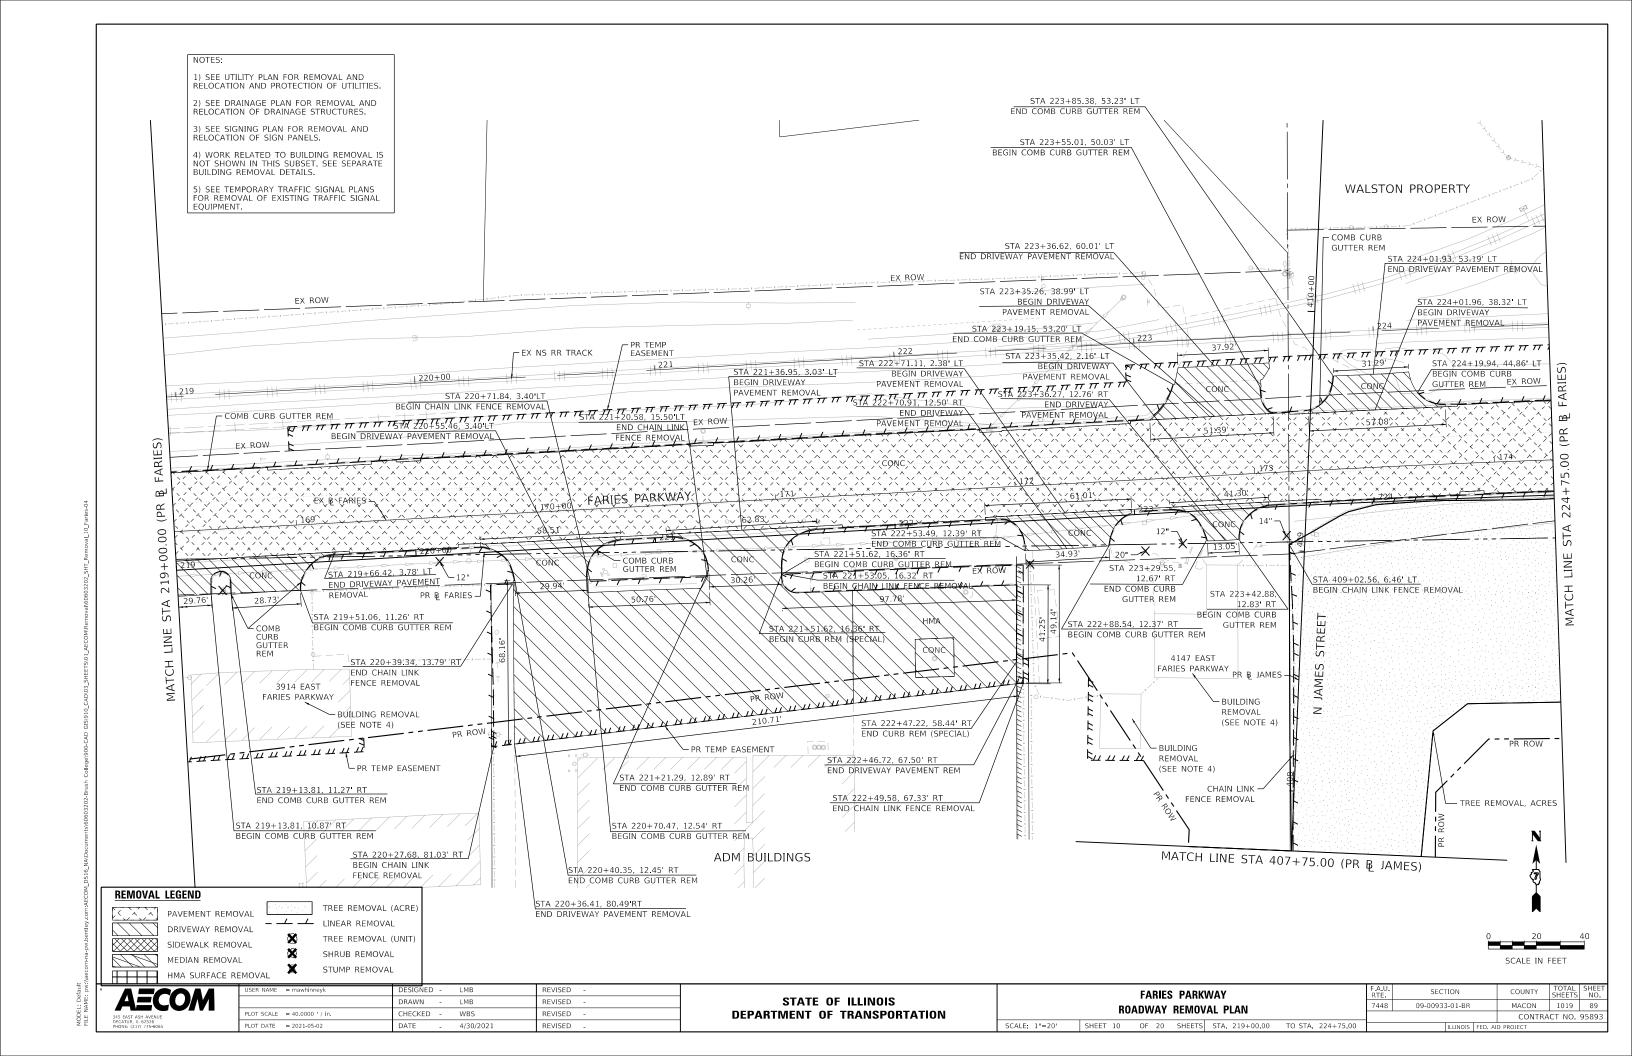

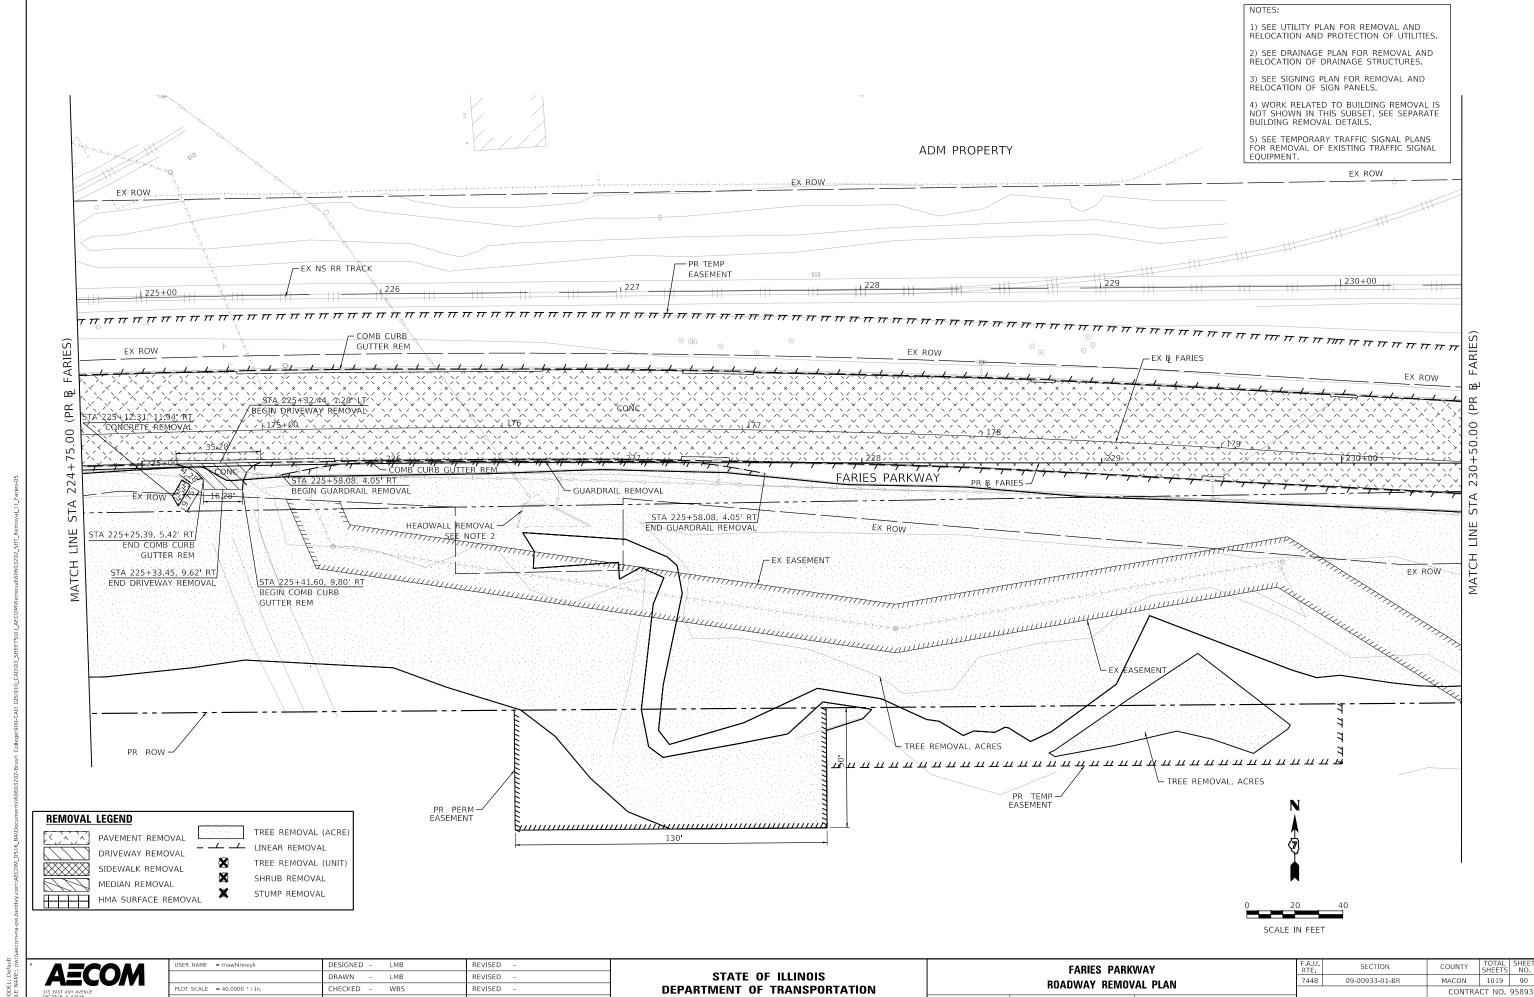

SCALE: 1"=20' SHEET 11 OF 20 SHEETS STA. 224+75.00 TO STA. 230+50.00

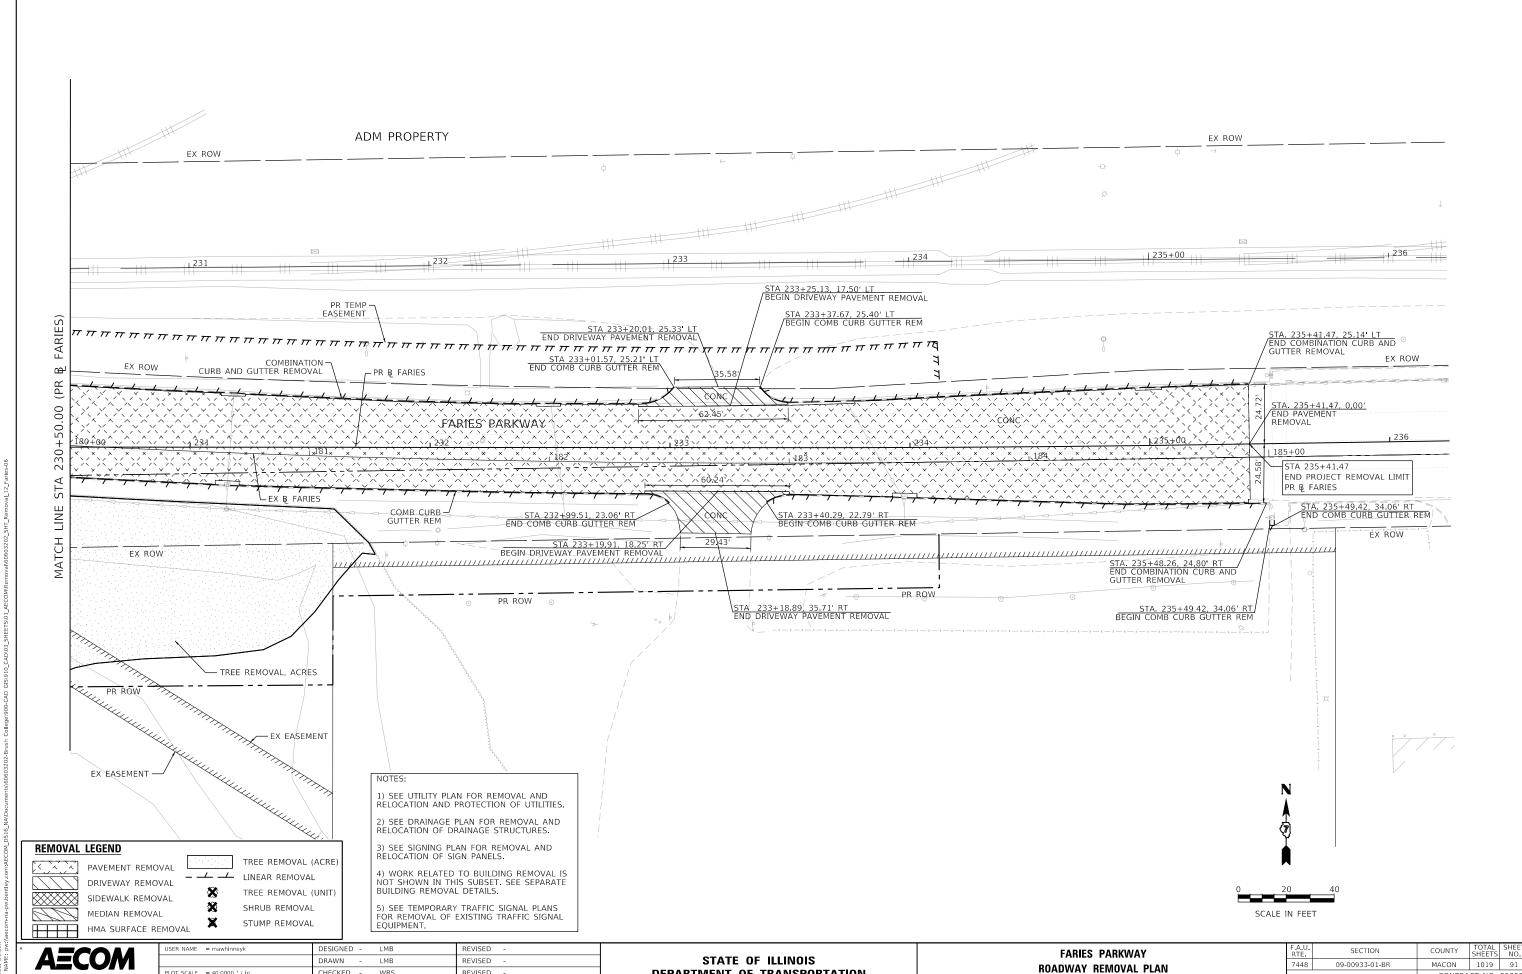

DEPARTMENT OF TRANSPORTATION


SCALE: 1"=20' SHEET 12 OF 20 SHEETS STA. 230+50.00 TO STA. 235+41.47

CONTRACT NO. 95893

HECKED

WBS

REVISED

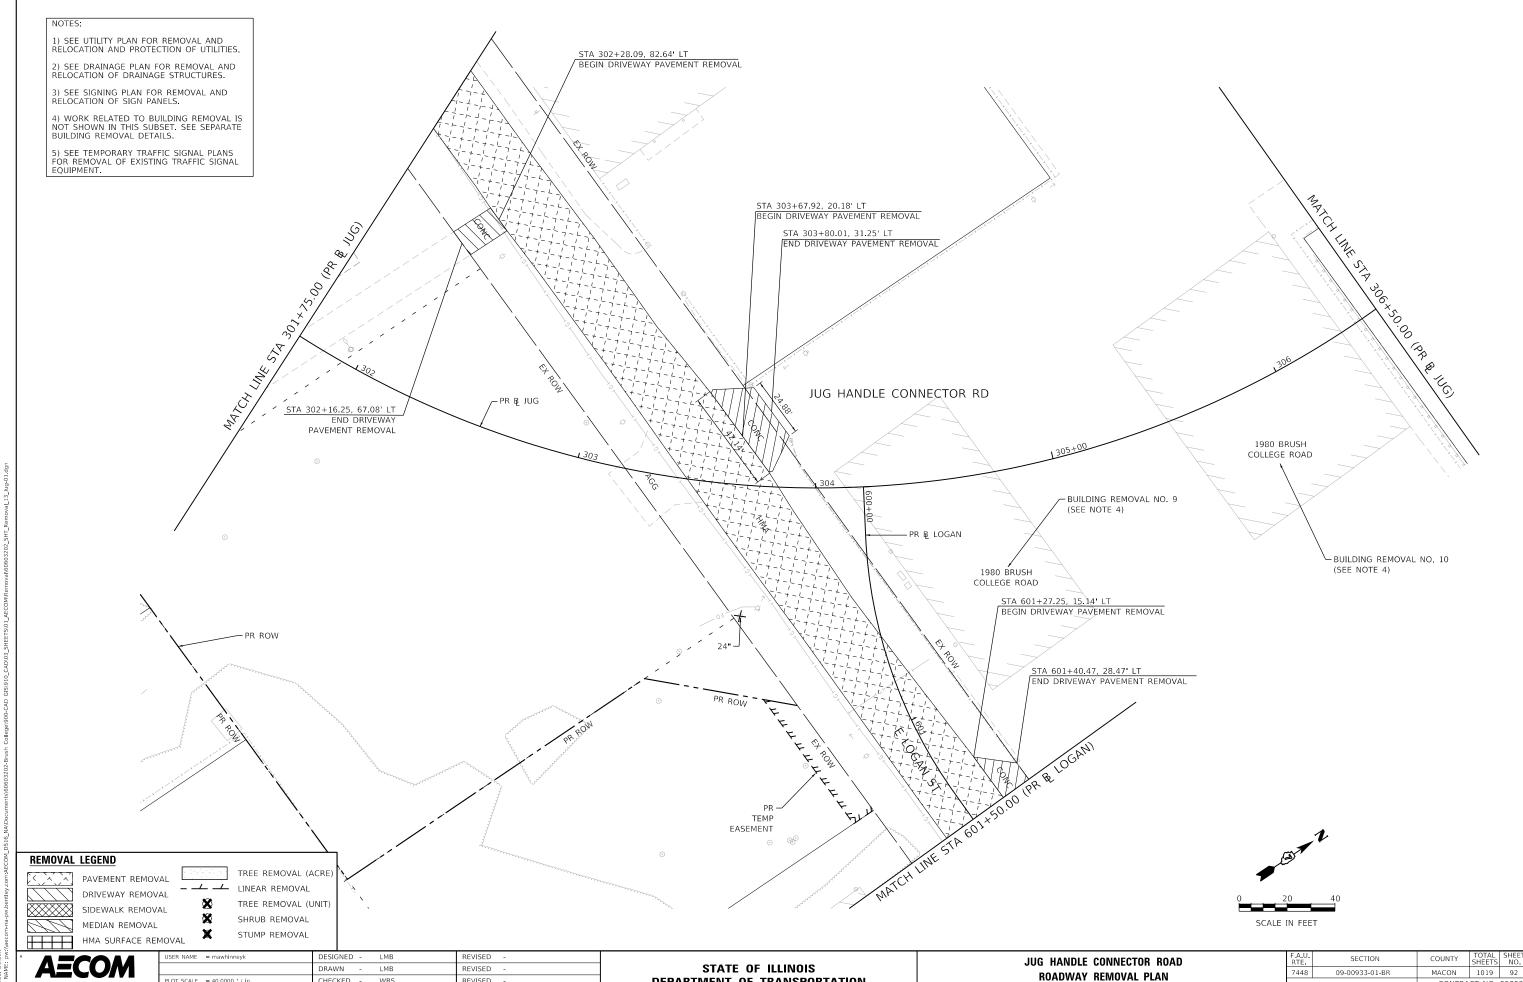

DEPARTMENT OF TRANSPORTATION

SCALE: 1"=20' SHEET 13 OF 20 SHEETS STA. 301+75.00 TO STA. 306+50.00

CONTRACT NO. 95893

CHECKED

DATE


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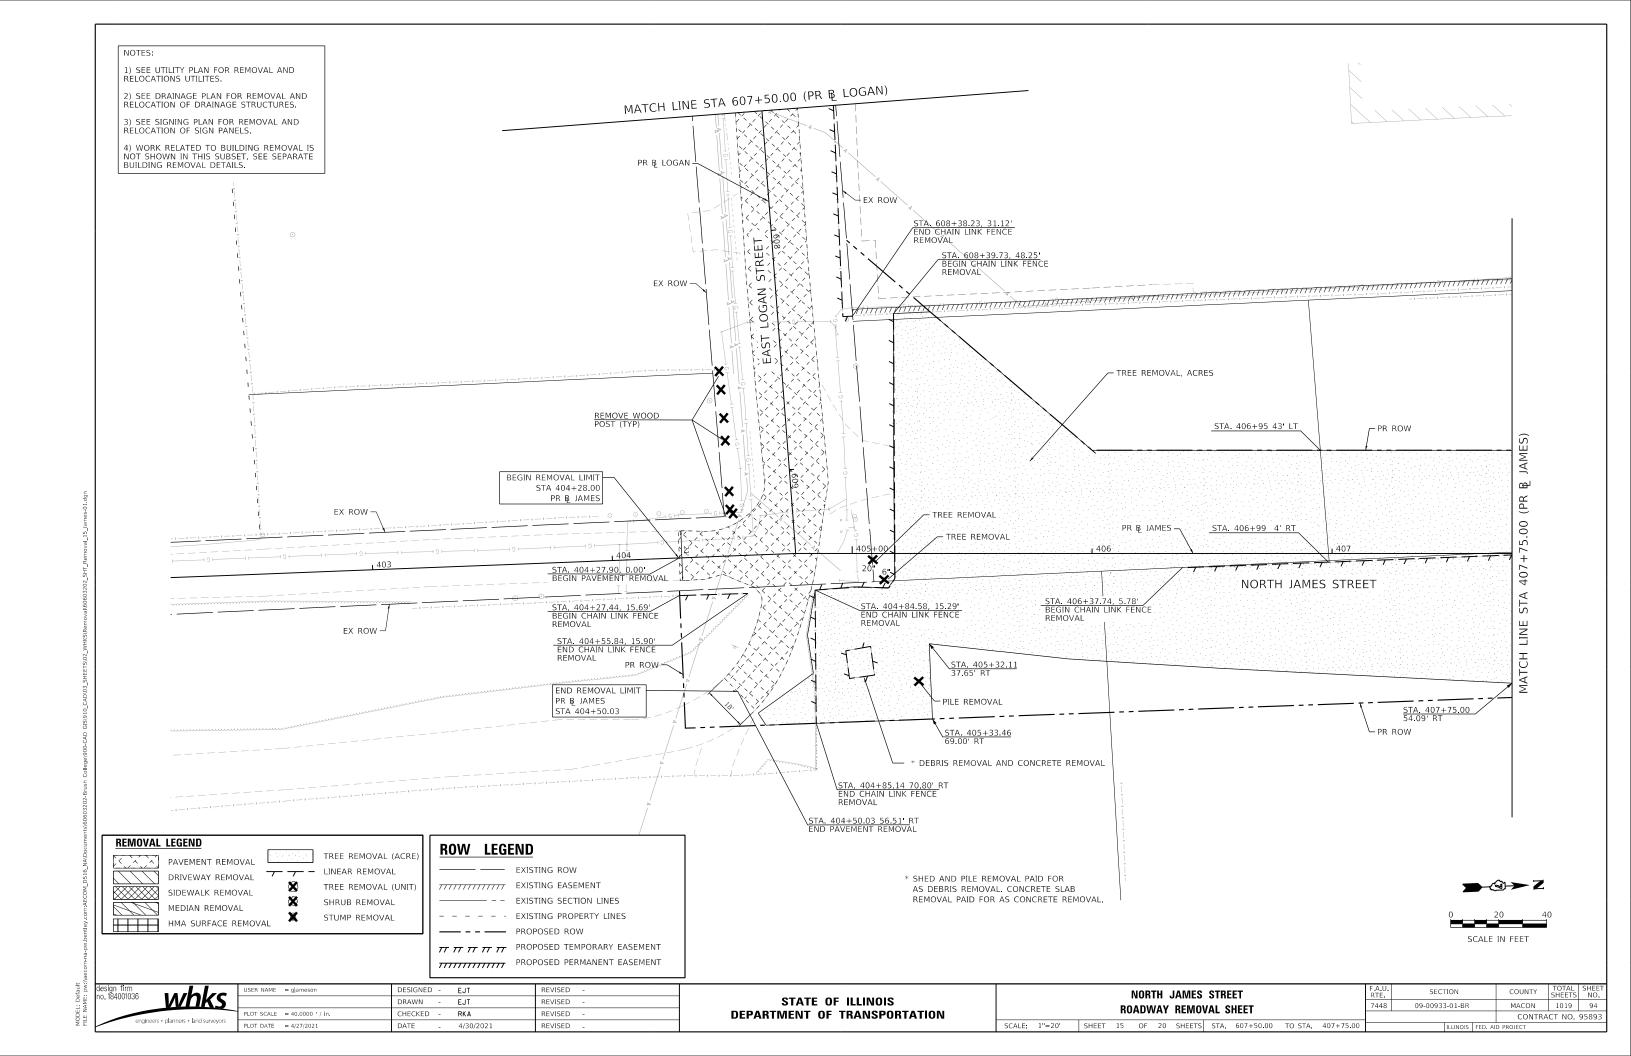
WBS


4/30/2021


REVISED


REVISED



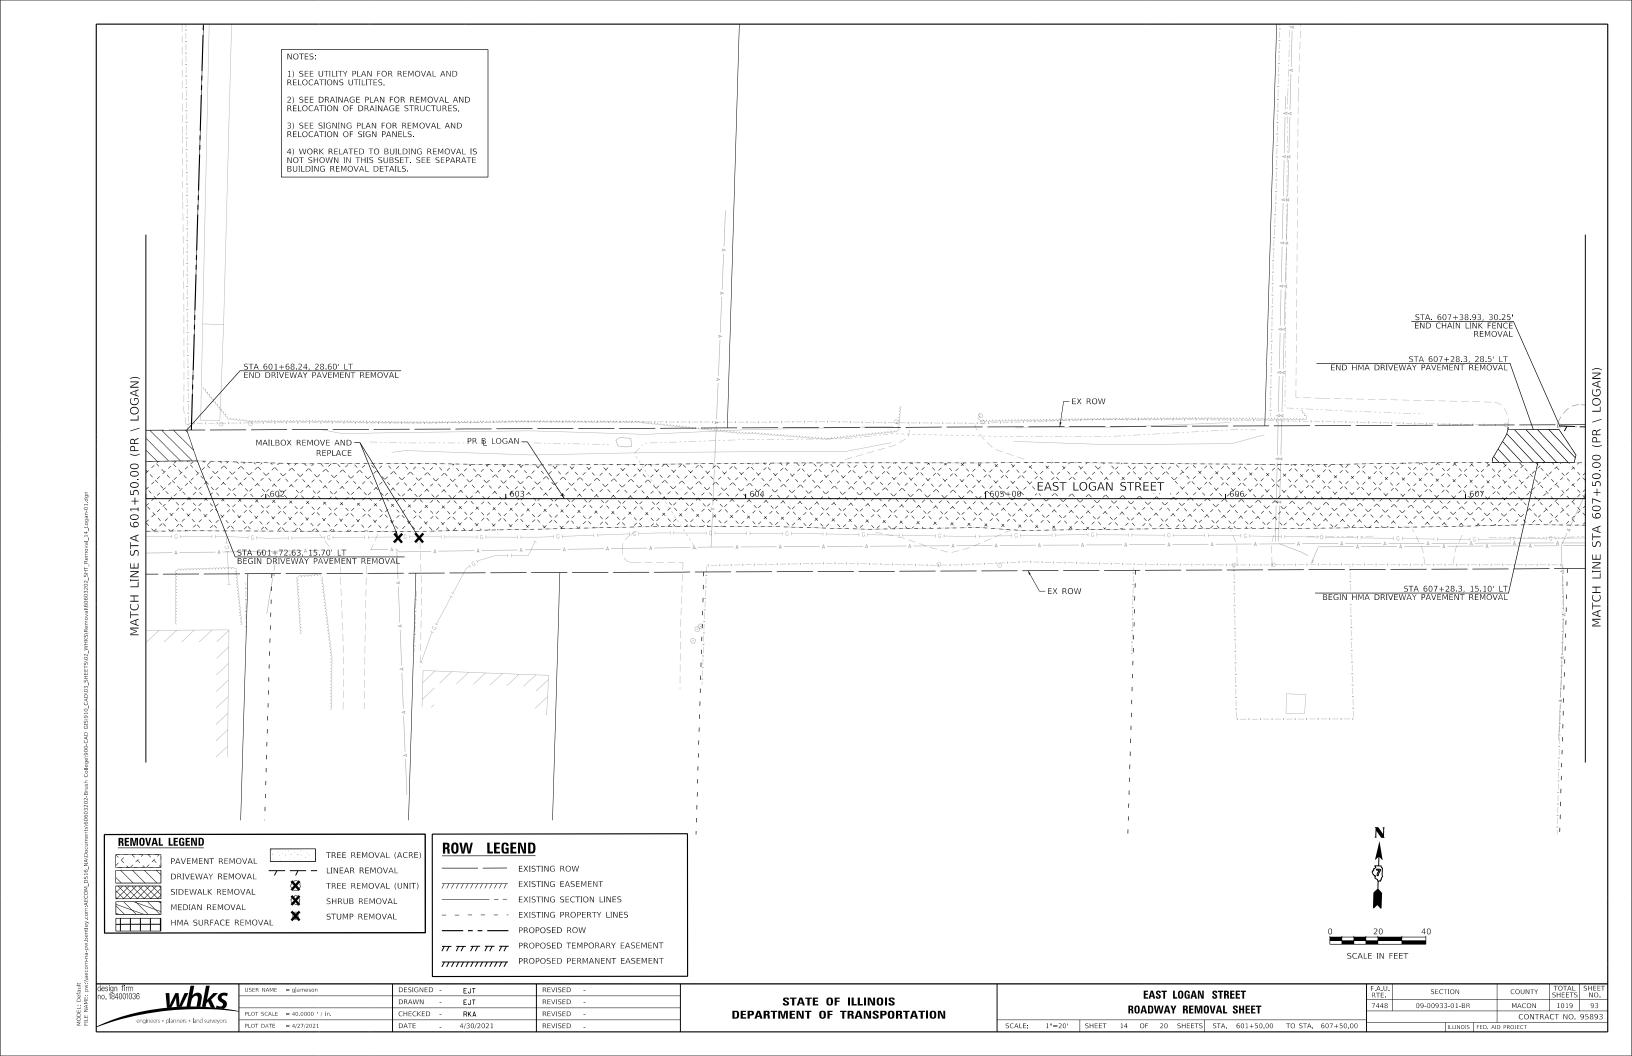

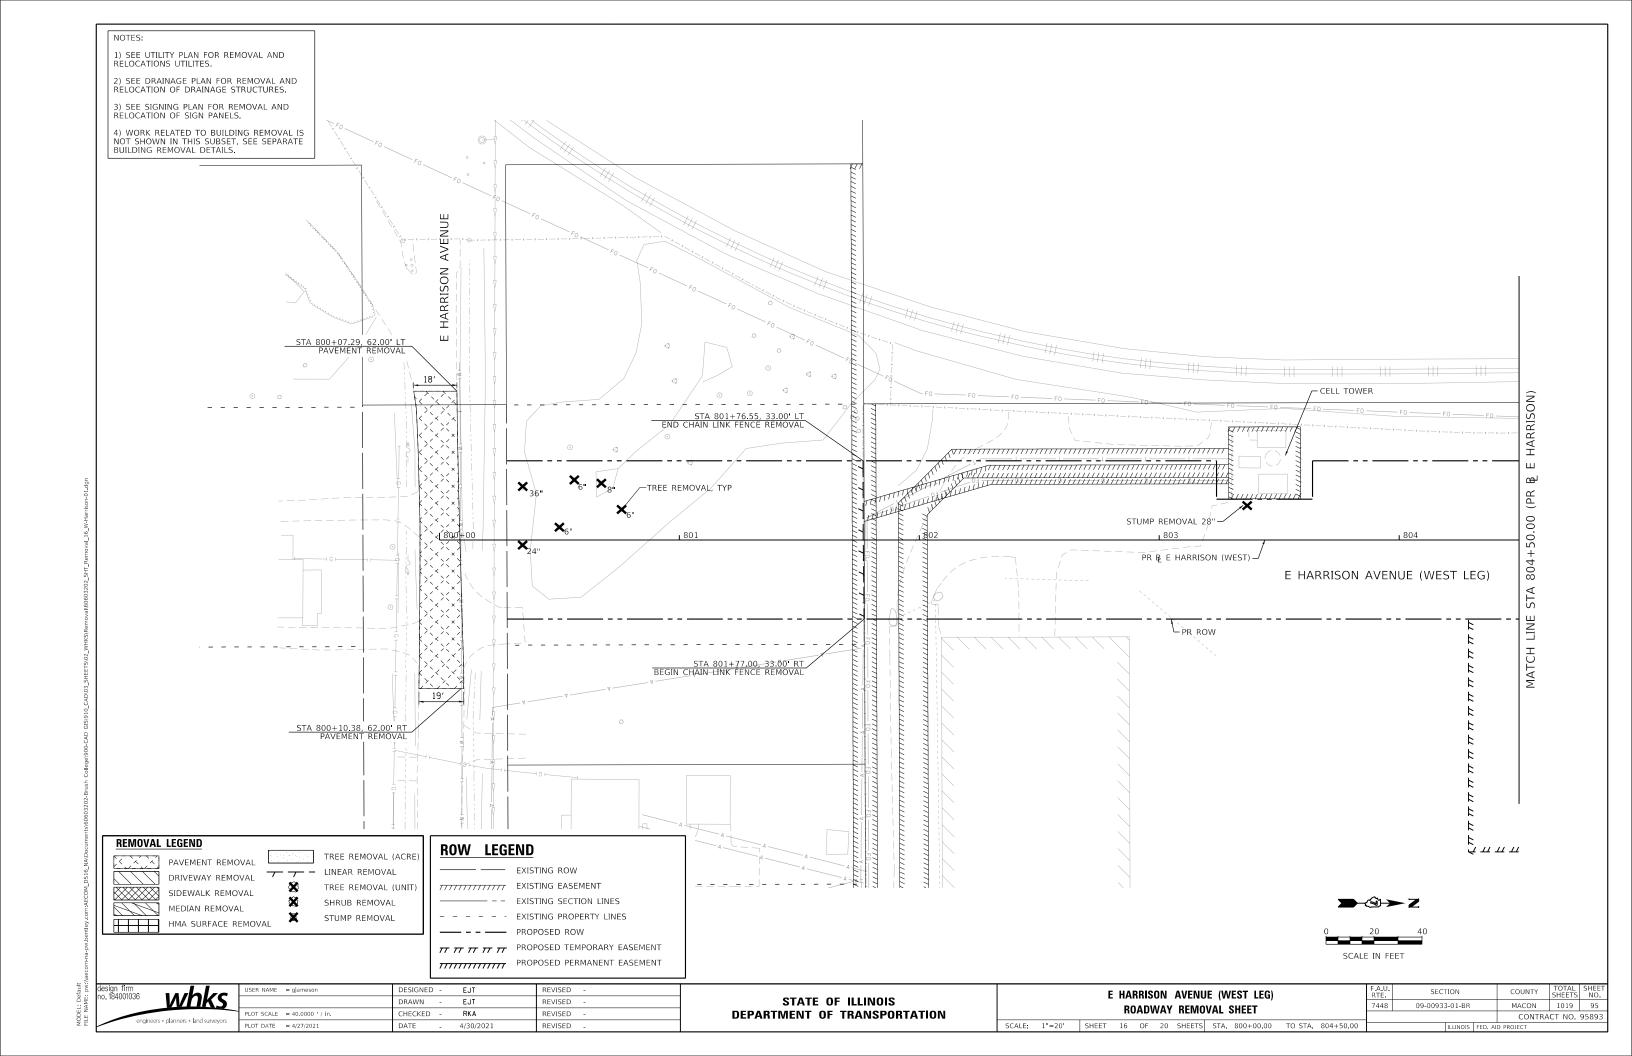

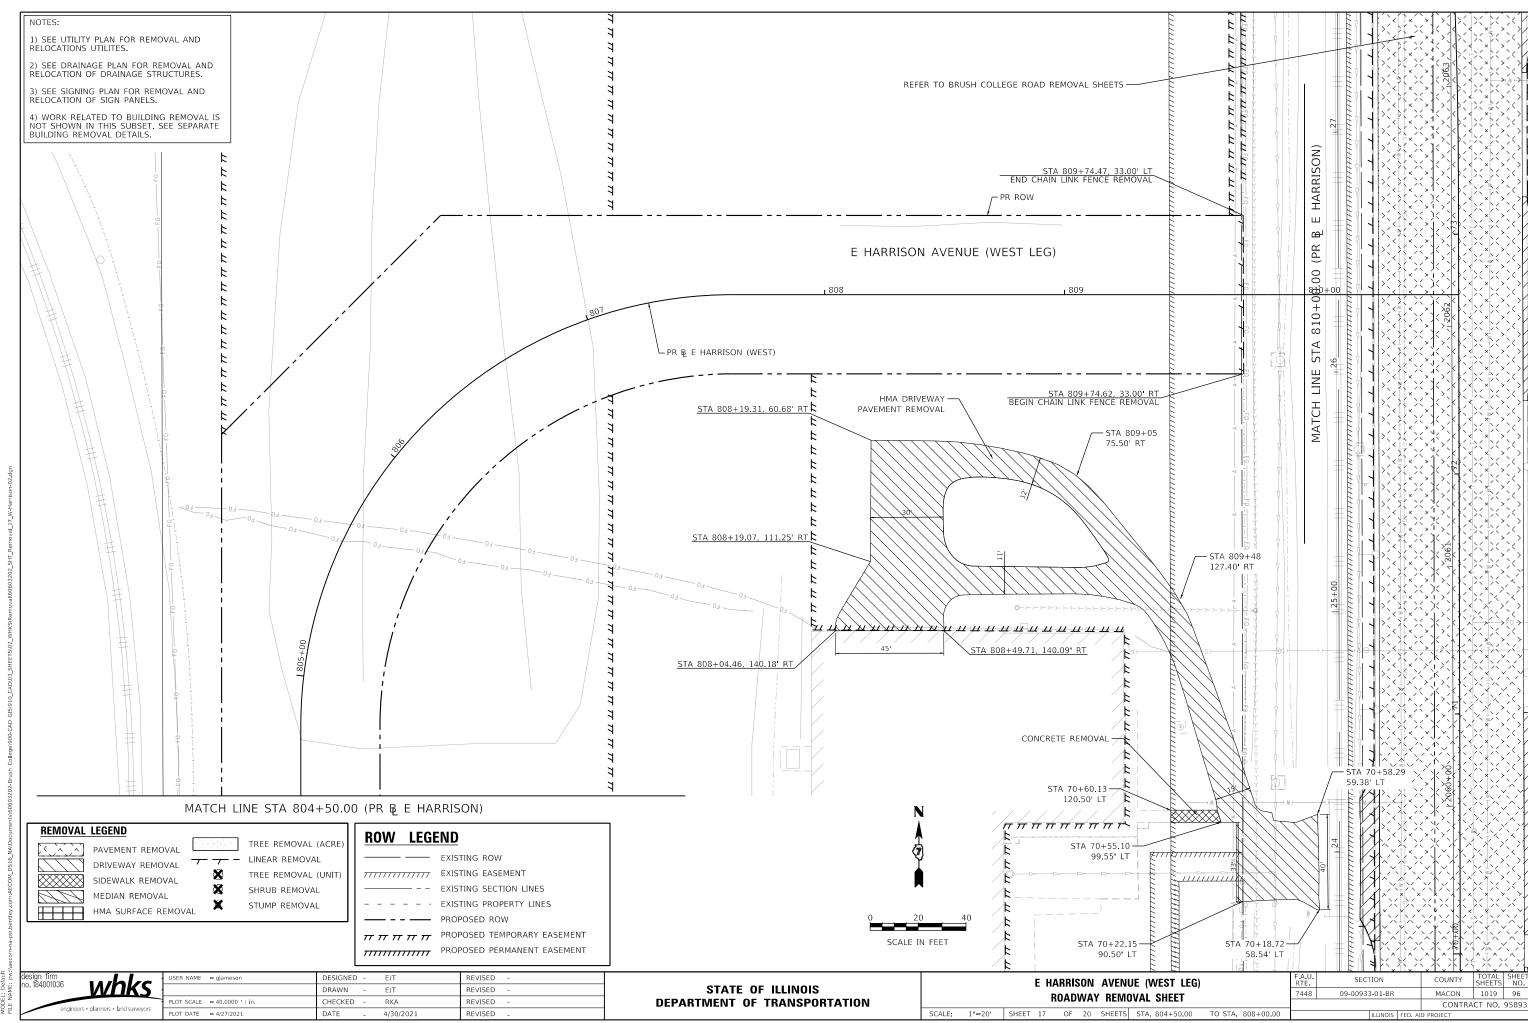

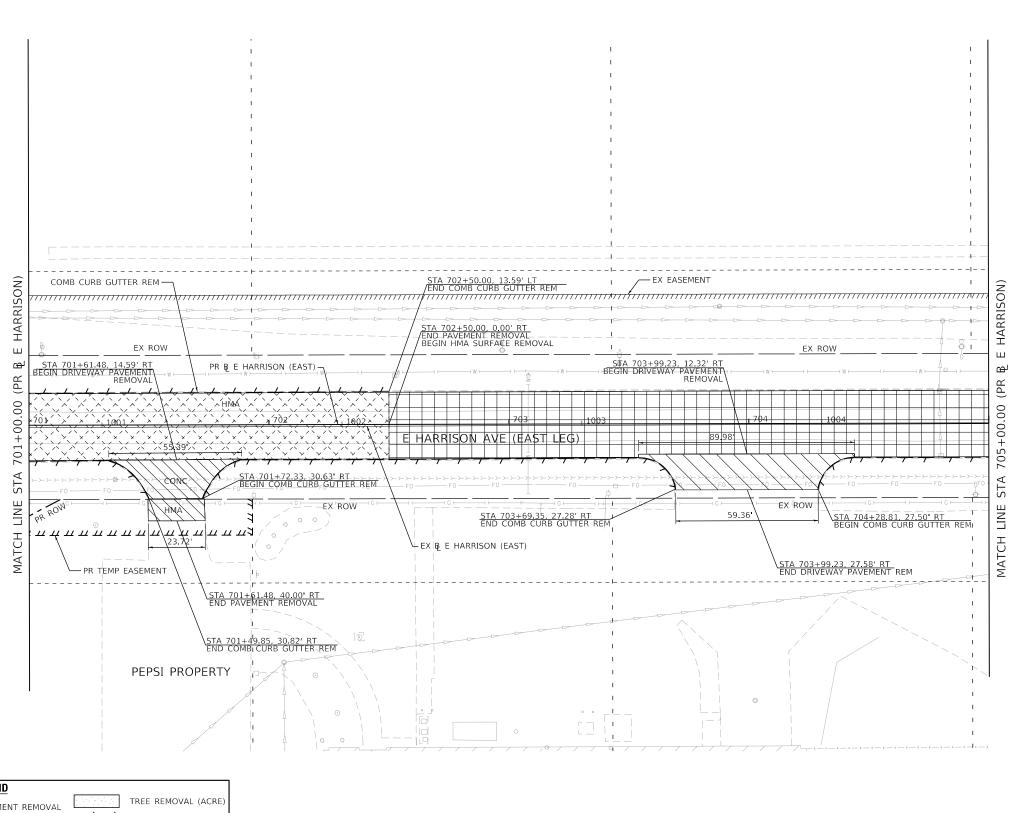

NOTES:

1) SEE UTILITY PLAN FOR REMOVAL AND RELOCATION AND PROTECTION OF UTILITIES.

2) SEE DRAINAGE PLAN FOR REMOVAL AND RELOCATION OF DRAINAGE STRUCTURES.

3) SEE SIGNING PLAN FOR REMOVAL AND RELOCATION OF SIGN PANELS.

4) WORK RELATED TO BUILDING REMOVAL IS NOT SHOWN IN THIS SUBSET. SEE SEPARATE BUILDING REMOVAL DETAILS.

5) SEE TEMPORARY TRAFFIC SIGNAL PLANS FOR REMOVAL OF EXISTING TRAFFIC SIGNAL EQUIPMENT.

SCALE IN FEET

₹	EM	0١	/AL	LEG	iEND

PAVEMENT REMOVAL SIDEWALK REMOVAL MEDIAN REMOVAL HMA SURFACE REMOVAL

DRIVEWAY REMOVAL

- - LINEAR REMOVAL TREE REMOVAL (UNIT) SHRUB REMOVAL STUMP REMOVAL


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	DRAWN -	LMB	REVISED -
PLOT SCALE = 40.0000 / in.	CHECKED -	WBS	REVISED -
PLOT DATE = 2021-05-02	DATE -	4/30/2021	REVISED -

STATE OF ILLINOIS **DEPARTMENT OF TRANSPORTATION**

SCALE: 1"=20"

E	НΑ	RRISC	N.	AVENUE	(EAST LEG)		F.A RT
ROADWAY REMOVAL PLAN							
NUADVVAT NEWOVAL FLAN							
SHEET	18	OF	20	SHEETS	STA 701+00 00	TO STA 705+00 00	

SECTION COUNTY 7448 09-00933-01-BR MACON 1019 97 CONTRACT NO. 95893

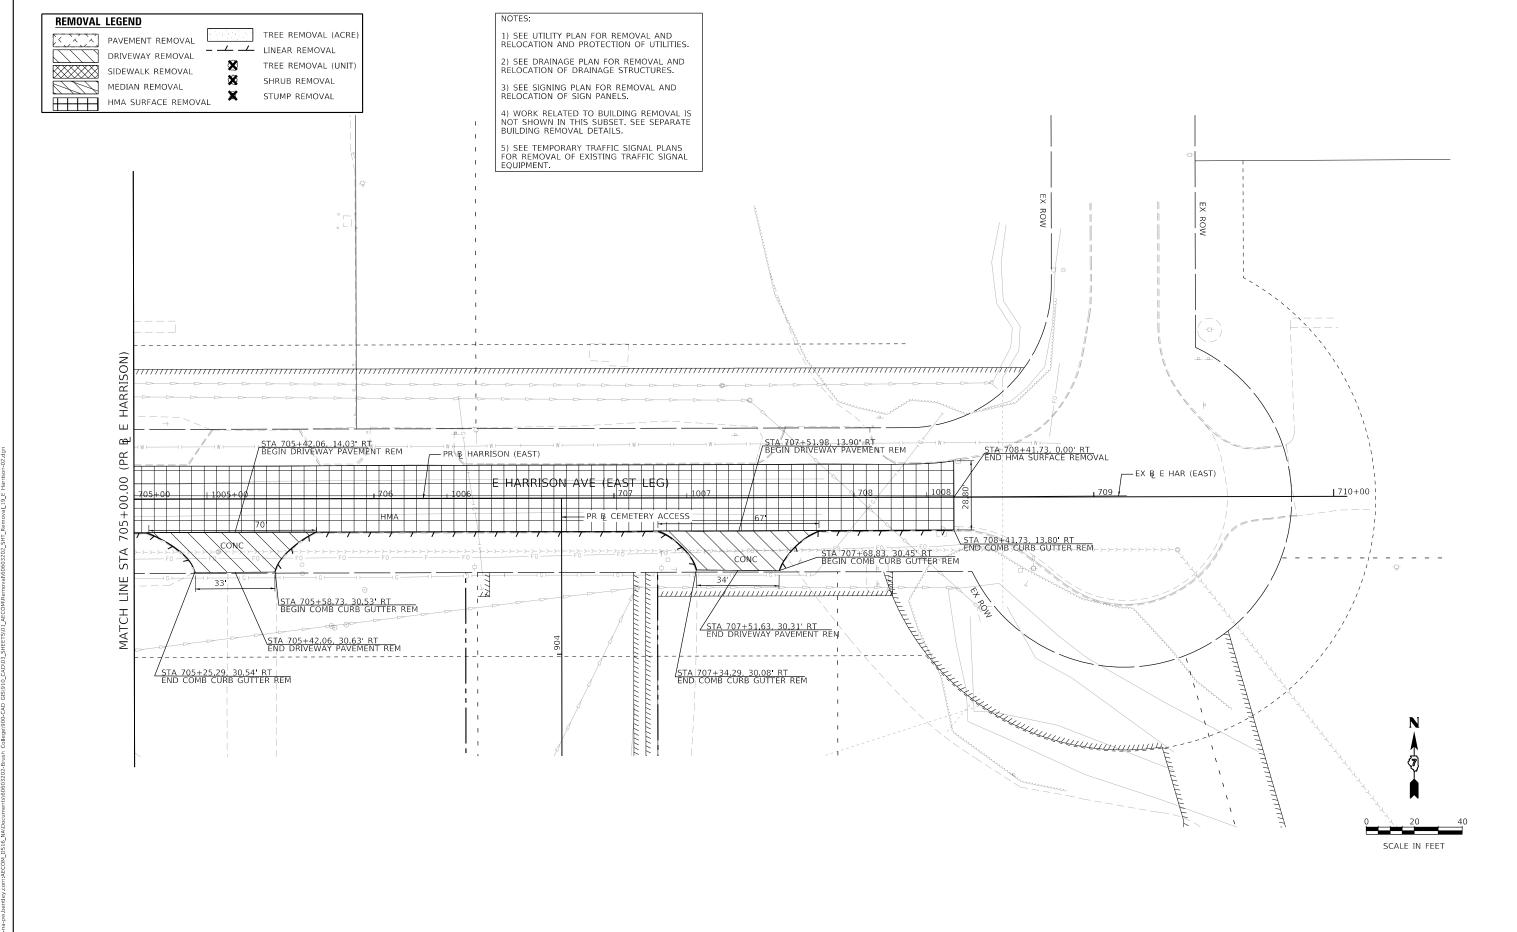

AECOM


345 EAST ASH AVENUE
DECATUR, II. 62576
PHONE: CIJI 7175-6065


 USER NAME
 = mawhinneyk
 DESIGNED
 LMB
 REVISED

 PLOT SCALE
 = 40.0000 ' / in.
 CHECKED
 WBS
 REVISED

 PLOT DATE
 = 2021-05-02
 DATE
 4/30/2021
 REVISED

STATE OF ILLINOIS DEPARTMENT OF TRANSPORTATION

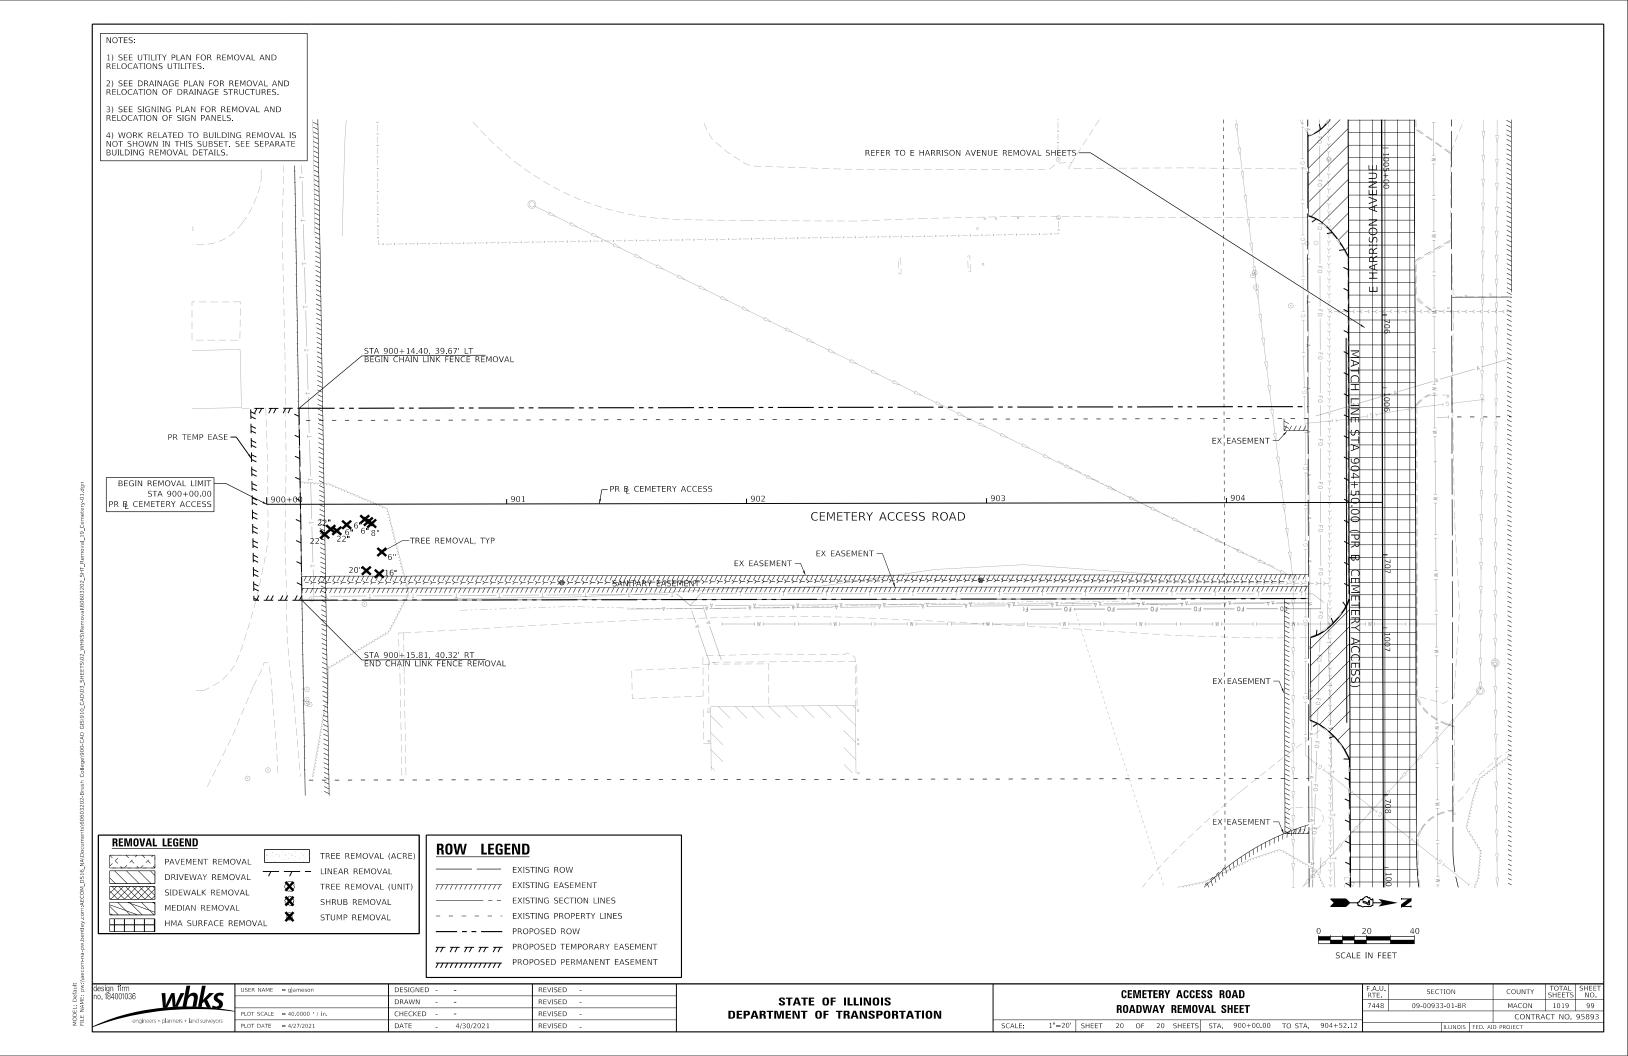

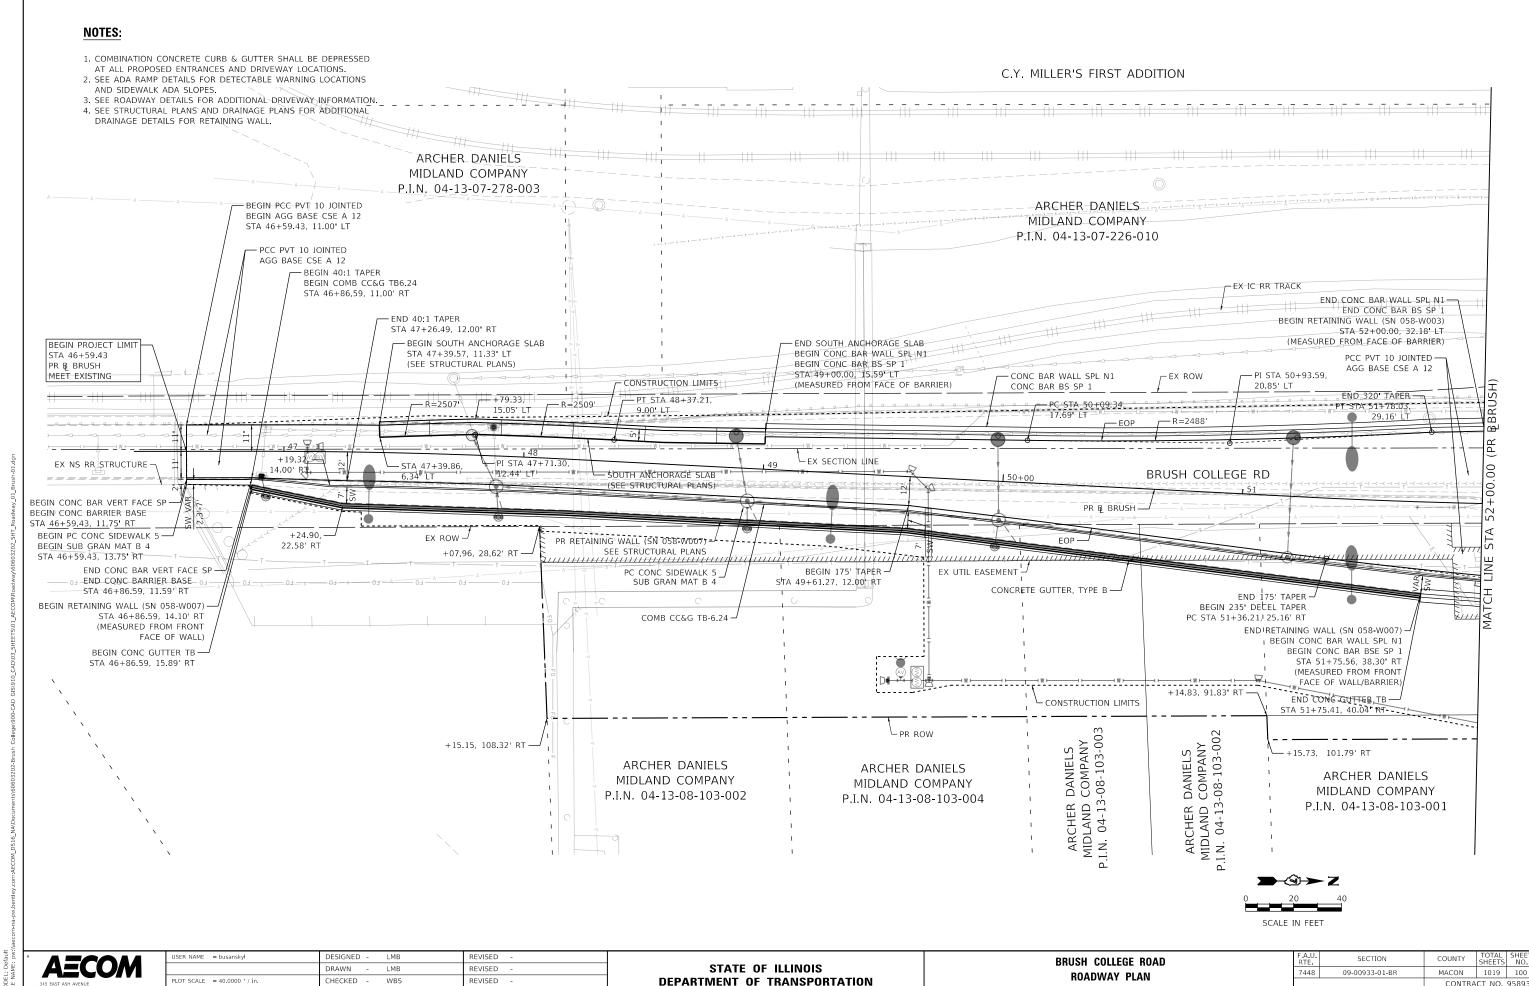

CONTRACT NO. 95893

SCALE: 1"=20' SHEET 1 OF 20 SHEETS STA. 46+59.43 TO STA. 52+00.00

LOT DATE = 5/5/2021

4/30/2021

REVISED