



TEMPORARY PAVEMENT



EROSION CONTROL BLANKET AND
TEMPORARY EROSION CONTROL SEEDING



MULCH, METHOD 2 AND
TEMPORARY EROSION CONTROL SEEDING

LEGEND






PERIMETER EROSION BARRIER PLACED
AROUND OPEN GRATE STRUCTURE AND
END SECTION IN ACCORDANCE WITH 280001-05



INLET FILTERS



TEMPORARY DITCH CHECKS

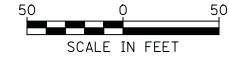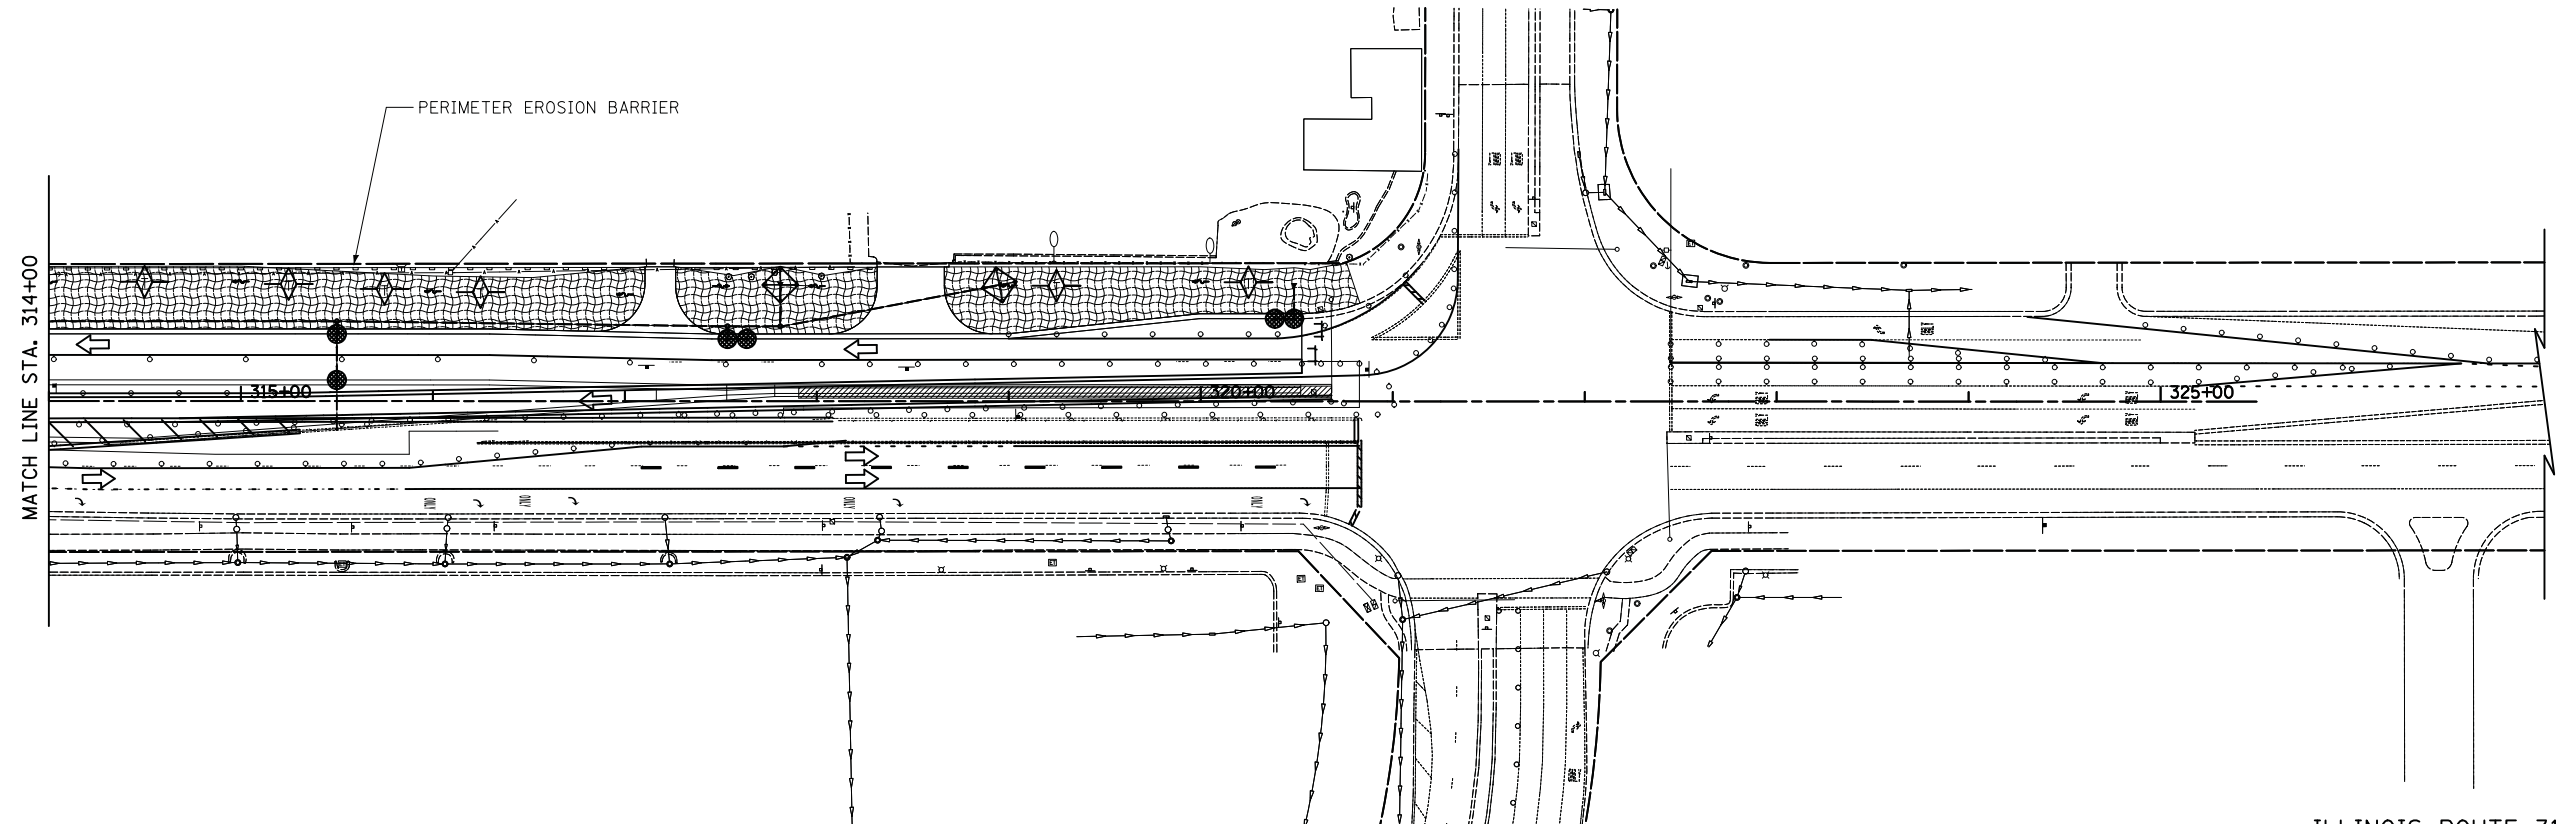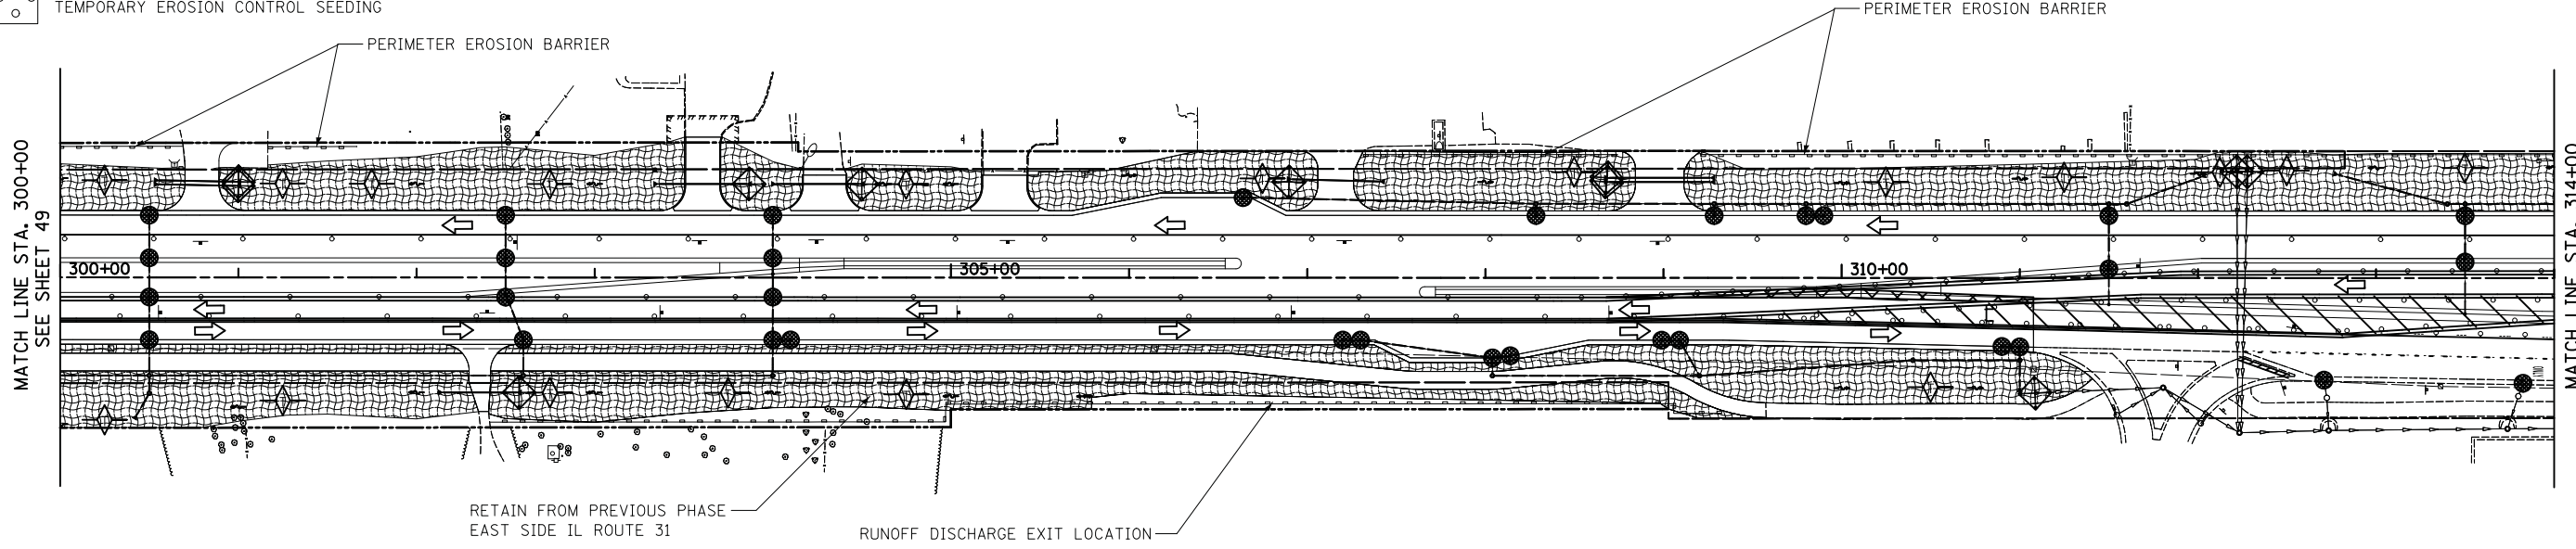

ILLINOIS ROUTE 31

FILE NAME =
... \2278NG.ERD_S2_02.dgn

USER NAME = kwh
PLOT SCALE = 50.0000' / in.
PLOT DATE = 8/5/2013

DESIGNED - KWH
DRAWN - PML
CHECKED - GAB
DATE - 06/24/2013

REVISED -
REVISED -
REVISED -
REVISED -

STATE OF ILLINOIS
DEPARTMENT OF TRANSPORTATION

EROSION AND SEDIMENT CONTROL - STAGE 2 & 3

SCALE: 1" = 50' SHEET NO. 6 OF 6 SHEETS STA. 300+00 TO STA. 320+82.66

F.A.P. RTE.	SECTION	COUNTY	TOTAL SHEETS	SHEET NO.
117	96-00209-00-PV	MCHENRY	151	53
CONTRACT NO.				
FED. ROAD DIST. NO. 1 ILLINOIS FED. AID PROJECT HPP-4064(003)				