


03-05-2021 LETTING ITEM 183

DES PLAINES AVENUE OVER 1-290

SN 016-0706

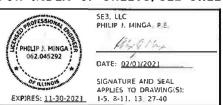



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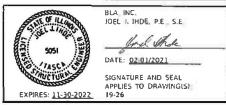
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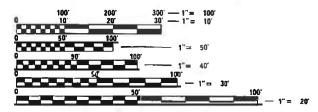




THIS IMPROVEMENT IS LOCATED WITHIN FOREST PARK AND OAK PARK.

DESIGN DESIGNATION (TRAFFIC DATA) - POSTED SPEED

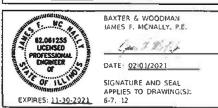- FAI-290 INTERSTATE (193,300) 55 MPH
- RIDGELAND AVE MAJOR COLLECTOR (9,100) 30 MPH
- DES PLAINES AVE MAJOR COLLECTOR (18,700) 30 MPH

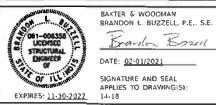

FULL SIZE PLANS HAVE BEEN PREPARED USING STANDARD ENGINEERING SCALES, REDUCED SIZED PLANS WILL NOT CONFORM TO STANDARD SCALES. IN MAKING MEASUREMENTS ON REDUCED PLANS, THE ABOVE SCALES MAY BE USED.

JOINT UTILITY LOCATION INFORMATION FOR EXCAVATORS 1-800-892-0123 OR 811

CONTRACT NO. 62N03

PROJECT MANAGER: J. ALAIN MIDY, PE (847) 221-3056 PROJECT ENGINEER: PRAVEEN KAINI, PE (847) 705-4237

BLA, Inc.



BAXTER WOODMAN

STATE OF ILLINOIS

DEPARTMENT OF TRANSPORTATION

PROPOSED HIGHWAY PLANS

FAI ROUTE 290 (I-290) EISENHOWER EXPRESSWAY AT DES PLAINES AVENUE AND RIDGELAND AVENUE **SECTION: 2020–233–BR BRIDGE REPAIR COOK COUNTY**

C-91-040-21

RIDGELAND AVENUE OVER 1-290

SN 016-0710 BURBANK


> **LOCATION MAP** (NOT TO SCALE)

GROSS LENGTH = 575 FT. = 0.11 MILES NET LENGTH = 575 FT. = 0.11 MILES

D-91-039-21

COOK



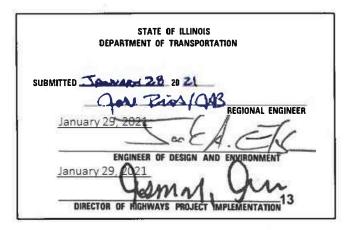

PRINTED BY THE AUTHORITY OF THE STATE OF ILLINOIS

INDEX OF SHEETS

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- 2 INDEX OF SHEETS, HIGHWAY STANDARDS, GENERAL NOTES & COMMITMENTS
- 3-4 SUMMARY OF QUANTITIES
- 5-11 MAINTENANCE OF TRAFFIC
- 12-13 PAVEMENT MARKING PLANS
- 14-18 S.N. 016-0706 DES PLAINES AVE BRIDGE 19-26 S.N. 016-0710 RIDGELAND AVE BRIDGE
- 27-40 DISTRICT ONE DETAILS

HIGHWAY STANDARDS

HIGHWAY	21ANDAKD2
STD NO.	TITLE
000001-08	STANDARD SYMBOLS, ABBREVIATIONS AND PATTERNS
001006	DECIMAL OF AN INCH AND OF A FOOT
701301-04	LANE CLOSURE, 2L, 2W, SHORT TIME OPERATIONS
701311-03	LANE CLOSURE, 2L, 2W, MOVING OPERATIONS - DAY ONLY
701321-18	LANE CLOSURE, 2L, 2W, BRIDGE REPAIR WITH BARRIER
701400-10	APPROACH TO LANE CLOSURE, FREEWAY/EXPRESSWAY
701401-12	LANE CLOSURE, FREEWAY/EXPRESSEWAY
701411-09	LANE CLOSURE, MULTILANE, AT ENTRANCE OR EXIT RAMP, FOR SPEEDS \geq 45 MPH
701428-01	TRAFFIC CONTROL, SETUP AND REMOVAL, FREEWAY/EXPRESSWAY
701446-11	TWO LANE CLOSURE, FREEWAY/EXPRESSWAY
701501-06	URBAN LANE CLOSURE, 2L, 2W, UNDIVIDED
701701-10	URBAN LANE CLOSURE, MULTILANE INTERSECTION
701801-06	SIDEWALK, CORNER OR CROSSWALK CLOSURE
701901-08	TRAFFIC CONTROL DEVICES
704001-08	TEMPORARY CONCRETE BARRIER
720001-01	SIGN PANEL MOUNTING DETAILS
720006-04	SIGN PANEL ERECTION DETAILS
728001-01	TELESCOPING STEEL SIGN SUPPORT
729001-01	APPLICATIONS OF TYPES A AND B METAL POSTS (FOR SIGNS & MARKERS)
780001-05	TYPICAL PAVEMENT MARKINGS

TYPICAL APPLICATIONS RAISED REFLECTIVE PAVEMENT MARKERS

GENERAL NOTES

- 1. THE CONTRACTOR SHALL BE RESPONSIBLE FOR COLLECTING AND MAINTAINING AN ELECTRONIC LOG OF ALL STAKEOUT SURVEY THAT IS PERFORMED ON THE JOB, EITHER BY HIM/HER OR ANY SUB-CONTRACTOR PERFORMING THE STAKEOUT. UPON REQUEST, ALL LOGS SHALL BE SUBMITTED TO THE DEPARTMENT. NO ADDITIONAL COMPENSATION WILL BE ALLOWED FOR THIS WORK BUT SHALL BE CONSIDERED INCLUDED IN THE COST FOR CONSTRUCTION LAYOUT.
- 2. ALL ELEVATIONS IN THE PLANS ARE BASED UPON THE NORTH AMERICAN VERTICAL DATUM OF 1988 (NAVD88).
- 3. ANY REFERENCE TO A STANDARD IN THESE PLANS SHALL BE INTERPRETED TO MEAN THE
- 4. THE CONTRACTOR SHALL CONTACT J.U.L.I.E. AT LEAST 48 HOURS PRIOR TO EXCAVATION TO DETERMINE WHICH UTILITIES ARE IN THE AREA.
- 5. THE CONTRACTOR SHALL REQUEST AND GAIN APPROVAL FROM THE ILLINOIS DEPARTMENT OF TRANSPORTATION'S EXPRESSWAY TRAFFIC OPERATIONS ENGINEER AT WWW.IDOTLCS.COM TWENTY-FOUR (24) HOURS IN ADVANCE OF ALL DAILY LANE, RAMP, AND SHOULDER CLOSURES AND 7 DAYS IN ADVANCE OF ALL PERMANENT AND WEEKEND CLOSURES ON ALL FREEWAYS AND/OR EXPRESSWAYS IN DISTRICT ONE. THIS ADVANCE NOTIFICATION IS CALCULATED BASED ON WORKWEEK OF MONDAY THROUGH FRIDAY AND SHALL NOT INCLUDE WEEKENDS NOR HOLIDAYS.
- 6. TWO WEEKS PRIOR TO PLACEMENT OF PERMANENT PAVEMENT MARKINGS, THE ENGINEER SHALL CONTACT BOTH THE ARTERIAL TRAFFIC FIELD ENGINEER, ERIC CAMPOS AT ERIC CAMPOS@ILLINOIS GOV, AND THE EXPRESSWAY TRAFFIC FIELD ENGINEER AT (847)
- 7. BEFORE BEGINNING ANY WORK, THE CONTRACTOR SHALL RETAIN AND RECORD FOR FUTURE REFERENCE, ALL EXISTING PAVEMENT MARKING LINES (AND RAISED REFLECTIVE PAVEMENT MARKERS) IN ORDER THAT THESE LOCATIONS CAN BE RE-ESTABLISHED FOR STRIPING. EXACT LOCATIONS OF ALL PAVEMENT MARKINGS SHALL BE AS DIRECTED BY THE ENGINEER.
- 8. THE CONTRACTOR AND THE RESIDENT ENGINEER SHALL CONTACT THE VILLAGE OF FOREST PARK PUBLIC WORKS DIRECTOR (JOHN DOSS 708-323-9136 OR JDOSS@FORESTPARK.NET) AT LEAST ONE (1) WEEK PRIOR TO THE PLACEMENT OF ANY TRAFFIC CONTROL DEVICES.
- 9. CONTRACTOR SHALL OBTAIN A NO COST VILLAGE OF OAK PARK PERMIT# 202100097 FOR THE INSTALLATION OF THE DETOUR FOR RIDGELAND AVE CLOSURE. CONTRACTOR SHALL REGISTER AS A LICSENCED CONTRACTOR WITH THE VILLAGE & PAY REGISTRATION FEE REGISTRATION IS DONE ONLINE AT HTTPS://VILLAGEVIEWOAK-PARK.US/CITYVIEWPORTAL
- 10. RIDGELAND AVENUE WORK SHALL OCCUR BETWEEN JUNE 14, 2021, AND AUGUST 20,2021.
- 11. TWO WEEKS PRIOR TO STARTING WORK ON RIDGELAND AVENUE THE CONTRACTOR SHALL NOTIFY THE VILLAGE OF OAK PARKS VILLAGE ENGINEER BILL MCKENNA AT MCKENNA@OAK-PARK.US

COMMITMENTS:

NONE

SCALE:



781001-04

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PLOT DATE	= 2/2/2021	2:24:30 PM	DATE	-	02/02/2021	REVISED	-

	INDEX OF SHEETS, HIGHWAY STANDARDS, GENERAL NOTES, AND COMMITMENTS						SECTION		COUNTY	TOTAL SHEETS	SHEET NO.	
							2020-233-BR			COOK	40	2
	GLIVLIIA					CONTRAC	T NO. 6	2N03				
	SHEET	OF	SHEETS	STA.	TO STA.			ILLINOIS	FED. AI	ID PROJECT		

					CONSTRUC	TION CODE
					BRIDGE	BR I DGE
					0047	0047
				URBAN	100% STATE	100% STATE
SP	CODE NO.	ITEM	UNIT	TOTAL QUANTITY	DES PLAINES AVE SN 016-0706	RIDGELAND AVEN SN 016-0710
	50102400	CONCRETE REMOVAL	CU YD	1.0	1.0	
	50157300	PROTECTIVE SHIELD	SQ YD	16	16	
	52000000	PREFORMED JOINT SEAL 1/2"	FOOT	65		65
	52000005	PREFORMED JOINT SEAL 1"	FOOT	162	162	
	52000025	PREFORMED JOINT SEAL 2"	FOOT	65		65
	67000400	ENGINEER'S FIELD OFFICE, TYPE A	CAL MO	12	6	6
	67100100	MOBILIZATION	L SUM	1	0.5	0.5
	70103815	TRAFFIC CONTROL SURVEILLANCE	CAL DA	75		75
	70107025	CHANGEABLE MESSAGE SIGN	CAL DA	40	20	20
	70300900	PAVEMENT MARKING TAPE, TYPE IV = LETTERS AND SYMBOLS	SQ FT	260	186	74
	70300904	PAVEMENT MARKING TAPE, TYPE IV 4"	FOOT	5797	2040	3757
	70300924	PAVEMENT MARKING TAPE, TYPE IV 24"	FOOT	31		31
	70400100	TEMPORARY CONCRETE BARRIER	FOOT	338		338
	70400200	RELOCATE TEMPORARY CONCRETE BARRIER	FOOT	338		338
	70600241	IMPACT ATTENUATORS, TEMPORARY (NON-REDIRECTIVE, NARROW), TEST LEVEL 2	EACH	2		2
	70600341	IMPACT ATTENUATORS, RELOCATE (NON-REDIRECTIVE, NARROW), TEST LEVEL 2	EACH	2		2
	78000100	THERMOPLASTIC PAVEMENT MARKING - LETTERS AND SYMBOLS	SQ FT	83		83
	78000200	THERMOPLASTIC PAVEMENT MARKING - LINE 4"	FOOT	316		316
	78000400	THERMOPLASTIC PAVEMENT MARKING : LINE 6"	FOOT	219		219
	78000650	THERMOPLASTIC PAVEMENT MARKING - LINE 24"	FOOT	47		47
	78009000	MODIFIED URETHANE PAVEMENT MARKING - LETTERS AND SYMBOLS	SQ FT	83	37	46
	78009004	MODIFIED URETHANE PAVEMENT MARKING - LINE 4"	FOOT	923	280	643
	78009006	MODIFIED URETHANE PAVEMENT MARKING = LINE 6"	FOOT	165	141	24
	78100300	REPLACEMENT REFLECTOR	EACH	37	10	27
	78200011	BARRIER WALL REFLECTORS - TYPE C	EACH	216		216
	85000200	MAINTENANCE OF EXISTING TRAFFIC SIGNAL INSTALLATION	EACH	2		2
*	X0320087	DEBRIS SCREEN	SQ YD	426		426
*	78300202	PAVEMENT MARKING REMOVAL - WATER BLASTING	SQ FT	939	187	752
The	SIGNED JWD	REVISED -	1		JMMARY OF QUANTITIES	

* SPECIALTY ITEN DESIGNED JWD REVISED DRAWN JWD REVISED 2 PEN TABLE = D162N03-PLOT.tbl CHECKED - PJM REVISED -PLOT DATE = 2/2/2021 2:24:31 PM DATE - 02/02/2021 REVISED -

STATE OF ILLINOIS **DEPARTMENT OF TRANSPORTATION**

SUMMARY OF QUANTITIES SCALE: SHEET OF SHEETS STA.

TO STA.

COUNTY TOTAL SHEET NO.

COOK 40 3 SECTION 290 2020-233-BR CONTRACT NO. 62N03

REV-SEP

					CONSTRUC	TION CODE
					BRIDGE	BRIDGE
					0047	0047
				URBAN	100% STATE	100% STATE
SP C	CODE NO.	ITEM	UNIT	TOTAL QUANT I TY	DES PLAINES AVE SN 016-0706	RIDGELAND AVENUE SN 016-0710
* X	X0900085	REMOVE EXISTING JOINT	FOOT	65		65
* X	X2700003	GROOVING FOR RECESSED PAVEMENT MARKING 8"	FOOT	70	70	
* X	X5017305	PROTECTIVE SHIELD (PERMANENT)	SQ YD	527		527
* X	X7010216	TRAFFIC CONTROL AND PROTECTION, (SPECIAL)	L SUM	1	0.5	0.5
* X	X7011015	TRAFFIC CONTROL AND PROTECTION (EXPRESSWAYS)	L SUM	1	0.5	0.5
* X	X7030005	TEMPORARY PAVEMENT MARKING REMOVAL	SQ FT	2633	1244	1389
* X	X7800956	PREFORMED PLASTIC PAVEMENT MARKING, TYPE B - INLAID - CONTRAST - LINE 7"	FOOT	70	70	
* Z	Z0001800	APPROACH SLAB REPAIR (PARTIAL DEPTH)	SQ YD	8	8	
* Z	Z0007300	BRIDGE SIDEWALK REPAIR (FULL DEPTH)	SQ FT	449		449
* Z	Z0012754	STRUCTURAL REPAIR OF CONCRETE (DEPTH EQUAL TO OR LESS THAN 5 INCHES)	SQ FT	53		53
* Z	Z0013798	CONSTRUCTION LAYOUT	L SUM	1	0.5	0.5
* Z	Z0016001	DECK SLAB REPAIR (FULL DEPTH, TYPE I)	SQ YD	1	1	
* Z	Z0016200	DECK SLAB REPAIR (PARTIAL)	SQ YD	1	1	
* Z	Z0030850	TEMPORARY INFORMATION SIGNING	SQ FT	262	56	206
* Z	Z0041895	POLYMER CONCRETE	CU FT	35	27.0	7.5
* Z	Z0048665	RAILROAD PROTECTIVE LIABILITY INSURANCE	L SUM	1		1
* Z	Z0073510	TEMPORARY TRAFFIC SIGNAL TIMING	EACH	27	10	17
1						

COUNTY TOTAL SHEET NO.

COOK 40 4 SECTION 2020-233-BR CONTRACT NO. 62N03

REV-SEP

LOT DRIVER = pdfNOLAYERSbw.pltcfg DESIGNED - JWD REVISED SUMMARY OF QUANTITIES STATE OF ILLINOIS DRAWN - JWD PEN TABLE = D162N03-PLOT.tbl REVISED 290 CHECKED - PJM REVISED **DEPARTMENT OF TRANSPORTATION** 5:29:14 PM DATE - 02/02/2021 PLOT DATE = 2/3/2021 REVISED SCALE: SHEET OF SHEETS STA. TO STA.

MAINTENANCE OF TRAFFIC GENERAL NOTES

- TRAFFIC CONDITIONS, CRASHES, AND OTHER UNFORESEEN EMERGENCY CONDITIONS MAY REQUIRE THE ENGINEER TO RESTRICT, MODIFY OR REMOVE LANE CLOSURES OR CHANNELIZATION SHOWN ON THE PLANS. THE CONTRACTOR SHALL MAKE THE NECESSARY ADJUSTMENTS AS DIRECTED BY THE ENGINEER WITHOUT DELAY. COMPLIANCE WITH THIS REQUIREMENT SHALL BE CONSIDERED INCLUDED IN THE CONTRACT UNIT PRICE OF THE MAINTENANCE OF TRAFFIC ITEM. NO ADDITIONAL COMPENSATION WILL BE ALLOWED.
- 2. THE MAINTENANCE OF TRAFFIC PLANS SHALL SERVE AS A GUIDE FOR THE SAFE DIVERSION OF TRAFFIC DURING EXECUTION OF THIS CONTRACT. THE CONTRACTOR MAY MODIFY THE MAINTENANCE OF TRAFFIC PLANS TO MEET CONSTRUCTION NEEDS, BUT NOT AT THE EXPENSE OF PUBLIC SAFETY OR CONVENIENCE. ANY CHANGES TO THE TRAFFIC CONTROL SHALL BE SUBMITTED TO THE ENGINEER FOR REVIEW AND APPROVAL. THE ENGINEER SHALL BE INFORMED IN WRITING A MINIMUM OF 48 HOURS IN ADVANCE OF ANY CHANGE TO THE MAINTENANCE OF TRAFFIC PLANS. CONTROL THE EXPRESSWAY TRAFFIC CONTROL SUPERVISOR AT 847-705-4151. REFER TO THE "KEEPING THE EXPRESSWAY OPEN TO TRAFFIC" SPECIAL PROVISION FOR LANE CLOSURE AND STAGE REQUIREMENTS.
- 3. THE CONTRACTOR SHALL REMOVE ALL CONFLICTING EXISTING PAVEMENT MARKINGS PER STAGE AS NEEDED. THIS REMOVAL OF PAVEMENT MARKINGS ON EXISTING PAVEMENT WILL BE PAID FOR AS "PAVEMENT MARKING WATER BLASTING" (X0327980)
- 4. THE CONTRACTOR SHALL REMOVE ALL TEMPORARY PAVEMENT MARKINGS THAT CONFLICT WITH THE STAGING. REMOVAL OF PAVEMENT MARKING TAPE WILL BE PAID FOR AS "TEMPORARY PAVEMENT MARKING REMOVAL" (X7030005).
- ALL SIGN ASSEMBLIES SHALL BE CERTIFIED BY THE CONTRACTOR AS MEETING THE APPLICABLE REQUIREMENTS OF NCHRP REPORT 350, TEST LEVEL 3 AND SHALL BE APPROVED BY THE ENGINEER.
- 6. THE CONTRACTOR SHALL REMOVE OR COVER ALL EXISTING SIGNS THAT CONFLICT WITH OR DO NOT APPLY TO THE REVISED TRAFFIC PATTERNS AND SHALL RESTORE THE SIGNS AT THE END OF CONSTRUCTION AS DIRECTED BY THE ENGINEER. COMPLIANCE WITH THIS REQUIREMENT SHALL BE CONSIDERED INCLUDED IN THE CONTRACT UNIT PRICE OF THE MAINTENANCE OF TRAFFIC ITEM. NO ADDITIONAL COMPENSATION WILL BE ALLOWED.
- 7. THE CONTRACTOR SHALL PROVIDE 48 HOURS ADVANCE NOTICE TO THE ENGINEER OF ANY CONSTRUCTION WORK THAT MAY IMPACT ANY ROADWAY LIGHTING.
- 8. THE CONTRACTOR SHALL PROPERLY DISPOSE OF ANY EXISTING SIGNS REMOVED, BUT NOT RELOCATED, FROM THE PROJECT. THE CONTRACTOR SHALL PROPERLY STORE RELOCATED SIGNS AS APPROVED BY THE ENGINEER UNTIL THEY ARE PROPERLY RE-ERECTED.
- CONFLICTING PAVEMENT MARKER REFLECTORS SHALL BE REMOVED PER STAGE AS NEEDED. EXISTING
 REFLECTORS THAT ARE DAMAGED SHALL ALSO BE REPLACED. THE REPLACEMENT OF THE REFLECTORS
 WILL BE PAID FOR AS REPLACEMENT REFLECTOR (70100300).
- 10. PLEASE ENSURE OUR FACILITY LOCATIONS ARE IDENTIFIED PRIOR TO PROCEEDING WITH ANY CONSTRUCTION ACTIVITY. THE CONTRACTOR SHALL BE RESPONSIBLE FOR PROTECTING OUR FACILITITIES FROM ALL CONSTRUCTION OPERATIONS, VIBRATIONS, AND HEAVY EQUIPMENT. IT IS REQUESTED THAT DURING CONSTRUCTION, EXTRA CAUTION BE TAKEN TO PROTECT THE SAFETY AND INTEGRITY OF OUR FACILITIES IN ORDER TO MAINTAIN SERVICE. NO ACCESS HATCHES AND MANHOLE COVERS ON MWRD STRUCTURES AND MANHOLES WITHIN THE PROJECT AREA SHALL BE BURIED OR COVERED; NO DEBRIS SHALL ENTER MWRD STRUCTURES, SEWERS, OR FACILITIES. MWRD PERSONNEL SHALL HAVE 24 HOUR-A-DAY UNRESTRICTED ACCESS TO ALL MWRD FACILITIES. FOR ANY QUESTIONS REGARDING ACCESS TO OUR FACILITY OR FIELD LOCATION, PLEASE CONTACT MR. STEVE WHITEHEAD, SENIOR CIVIL ENGINEER, AT (708) 588-4080. WE FURTHER REQUEST THAT MWRD MANHOLES BE LOCATED, PROTECTED, AND/OR ADJUSTED TO GRADE, IF NECESSARY. AUTHORIZATION MAY BE OBTAINED BY CONTACTING MR. CEDRIC ROBERTSON, MANAGING ENGINEER, AT (708) 751-3234.
- 11. THE CONTRACTOR SHALL CONTACT THE DISTRICT ONE TRAFFIC CONTROL SUPERVISOR FOR ARTERIALS AT KALPANA.HANNAN-HOSADURGA@ILLINOIS.GOV AND THE TRAFFIC CONTROL SUPERVISOR FOR EXPRESSWAYS AT CARLOS.MUNOZ@ILLINOIS.GOV A MINIMUM OF SEVENTY-TWO (72) HOURS IN ADVANCE OF BEGINNING WORK.
- 12. EXPANSION JOINT REMOVAL AND REPLACEMENT WILL BE DONE OVER A WEEKEND, USING THE DETOUR PROVIDED. LONG TERM LANE CLOSURES AT DES PLAINES ARE ONLY ALLOWED UNDER A DETOUR ON THE WEEKEND.
- 13. LANE AND RAMP CLOSURES ON I-290 SHALL BE ALLOWED ONLY DURING THE ALLOWABLE HOURS SPECIFIED IN THE KEEPING THE EXPRESSWAY OPEN TO TRAFFIC SPECIAL PROVISION.
- 14. THE FOLLOWING IS A LIST OF MAINTENANCE OF TRAFFIC ASSOCIATED PAY ITEMS, FOR WHICH NOMINAL OR ESTIMATED QUANTITIES HAVE BEEN PROVIDED. THE CONTRACTOR SHALL RECEIVE WRITTEN AUTHORIZATION FROM THE ENGINEER PRIOR TO USE AND PAYMENT FOR THESE ITEMS:
- * CHANGEABLE MESSAGE SIGN
- * PAVEMENT MARKING TAPE, TYPE IV LETTERS AND SYMBOLS
- * PAVEMENT MARKING TAPE, TYPE IV 4"
- * PAVEMENT MARKING TAPE, TYPE IV 24"
- * TEMPORARY CONCRETE BARRIER
- * RELOCATE TEMPORARY CONCRETE BARRIER
- * IMPACT ATTENUATORS, TEMPORARY (NON- REDIRECTIVE, NARROW), TEST LEVEL 2
- * IMPACT ATTENUATORS, RELOCATE (NON- REDIRECTIVE, NARROW), TEST LEVEL 2
- * BARRIER WALL REFLECTORS TYPE C
- * TEMPORARY INFORMATION SIGNING

PEDESTRIAN ACCESS

- 1. A MINIMUM OF ONE SIDEWALK SHALL REMAIN OPEN AT ALL TIMES ACROSS BRIDGES.
- SIDEWALKS SHALL BE CLOSED ANY TIME CONSTRUCTION IS TAKING PLACE ON THE SIDEWALK, ADJACENT PARAPET, PARAPET FENCE, OR ADJACENT ROADWAY/BRIDGE LANE.
- 3. SIGNAGE FOUND ON IDOT HIGHWAY STANDARD 701801 SHALL BE UTILIZED TO CLOSE A SIDEWALK.

PACE BUS COORDINATION

- PACE REQUESTS THE CONTRACTOR AND RESIDENT ENGINEER COORDINATE WITH PACE THROUGHOUT THE PROJECT.
- 2. THE CONTRACTOR WILL NOTIFY THE RESIDENT ENGINEER AND PACE CONTACT PERSON AT LEAST TWO (2) WEEKS PRIOR TO THE RIDGELAND AVENUE MOT BEING IN PLACE, SO PACE CAN NOTIFY THE PUBLIC OF THE RUS STOP CLOSURES AND MAKE OTHER ARRANGEMENTS. AS NECESSARY
- 3. THE CONTRACTOR WILL NOTIFY THE RESIDENT ENGINEER PACE CONTACT PERSON AT LEAST TWO (2) WEEKS PRIOR TO EACH OF THE WEEKEND CLOSURES OF RIDGELAND AVENUE AND DES PLAINES AVENUE, SO THE PUBLIC CAN BE NOTIFIED OF THE IMPACTS TO THE ROUTES.

М

SHEET

SCALE:

 THE PACE CONTACT PERSON IS RICK WILLMAN AT (847) 228-3584 (RICHARD.WILLMAN@PACEBUS.COM).



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I	PEN TABLE	= D162N03-PLOT.tbl		DRAWN	-	JWD	REVISED	-
I	PLOT SCALE	= 2.0000 / in		CHECKED	-	PJM	REVISED	-
I	PLOT DATE	= 2/3/2021	4:51:50 PM	DATE	-	02/02/2021	REVISED	-

IAINTENANCE OF TRAFFIC						F.A.I. SECTION			TOTAL SHEETS	SHEET NO.
GENERAL NOTES					290	2020-233-BR	соок	40	5	
								CONTRACT	F NO. 62	2N03
OF	SHEETS STA.		TO	STA.		ILLINOI	D PROJECT			

PRE-STAGE

CONSTRUCTION:

PRE-STAGE INCLUDES INSTALLATION OF TEMPORARY PROTECTIVE SHIELD.

TRAFFIC:

USE ONLY NIGHTTIME LANE CLOSURES ON I-290 RAMPS & MAINLINE.

APPLICABLE DISTRICT ONE DETAILS AND IDOT HIGHWAY STANDARD DRAWINGS:

TRAFFIC CONTROL DETAILS FOR FREEWAY SINGLE & MULTI-LANE WEAVE TRAFFIC CONTROL DETAILS FOR FREEWAY SHOULDER CLOSURES AND PARTIAL RAMP CLOSURES 701400-09 APPROACH TO LANE CLOSURE, FREEWAY/EXPRESSWAY 701401-12 LANE CLOSURE, FREEWAY/ EXPRESSWAY 701411-09 LANE CLOSURE, MULTILANE, AT ENTRANCE OR EXIT RAMP, FOR SPEEDS \geq 45 MPH 701428-01 TRAFFIC CONTROL SETUP AND REMOVAL FREEWAY/EXPRESSWAY 701446-10 TWO LANE CLOSURE, FREEWAY/EXPRESSWAY

STAGE 1 - DETOUR

CONSTRUCTION:

COMPLETE BRIDGE REPAIRS

TRAFFIC:

DES PLAINES AVENUE WILL BE CLOSED AT THE STRUCTURE OVER I-290. TRAFFIC WILL FOLLOW THE WEEKEND DETOUR SHOWN ON THE DETOUR PLAN (SEE NOTE 1). ACCESS WILL BE PROVIDED FOR THE FOREST PARK CTA STATION.

INSTALL TRAFFIC CONTROL DEVICES IN ACCORDANCE WITH THE MOT PLANS AND APPLICABLE DISTRICT ONE DETAILS AND IDOT HIGHWAY STANDARD DRAWINGS:

SHORT TERM PAVEMENT MARKING LETTERS AND SYMBOLS DETOUR SIGNING FOR CLOSING STATE HIGHWAYS ARTERIAL ROAD INFORMATION SIGN DRIVEWAY ENTRANCE SIGNING 701311-03 LANE CLOSURE, 2L, 2W, MOVING OPERATION - DAY ONLY 701901-08 TRAFFIC CONTROL DEVICES

STAGE 2 - POST DETOUR

CONSTRUCTION:

REPLACE PAVEMENT MARKINGS ON THE BRIDGE DECK

SHORT TERM LANE CLOSURES PERMITTED ONLY

INSTALL TRAFFIC CONTROL DEVICES IN ACCORDANCE WITH THE MOT PLANS AND APPLICABLE DISTRICT ONE DETAILS AND IDOT HIGHWAY STANDARD DRAWINGS:

701311-03 LANE CLOSURE, 2L, 2W, MOVING OPERATION - DAY ONLY 701901-08 TRAFFIC CONTROL DEVICES

NOTE 1


1. DES PLAINES AVENUE DETOUR SHALL NOT OCCUR ON THE SAME WEEKEND AS THE RIDGELAND AVENUE DETOUR INCLUDED IN THIS CONTRACT.


BAXTER WOODMAN


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PLOT DATE = 2/2/2021	DATE - 2/2/2021	FILE - 190508_SHT-MOT_Des Plaines_Se


STATE OF ILLINOIS DEPARTMENT OF TRANSPORTATION

MAIN	ITENANCE OF TRAFFIC - I	F.A.I RTE	SECTION	COUNTY	TOTAL	
	STAGING DESC	290	2020-233-BR	соок	40	
	STAGING DESC			CONTRACT	ΓNO.	
SCALE: 1" = 10'	SHEET 1 OF 1 SHEETS	STA. TO STA.		ILLINOIS FED. A	ID PROJECT BRIDG	GE REPAI

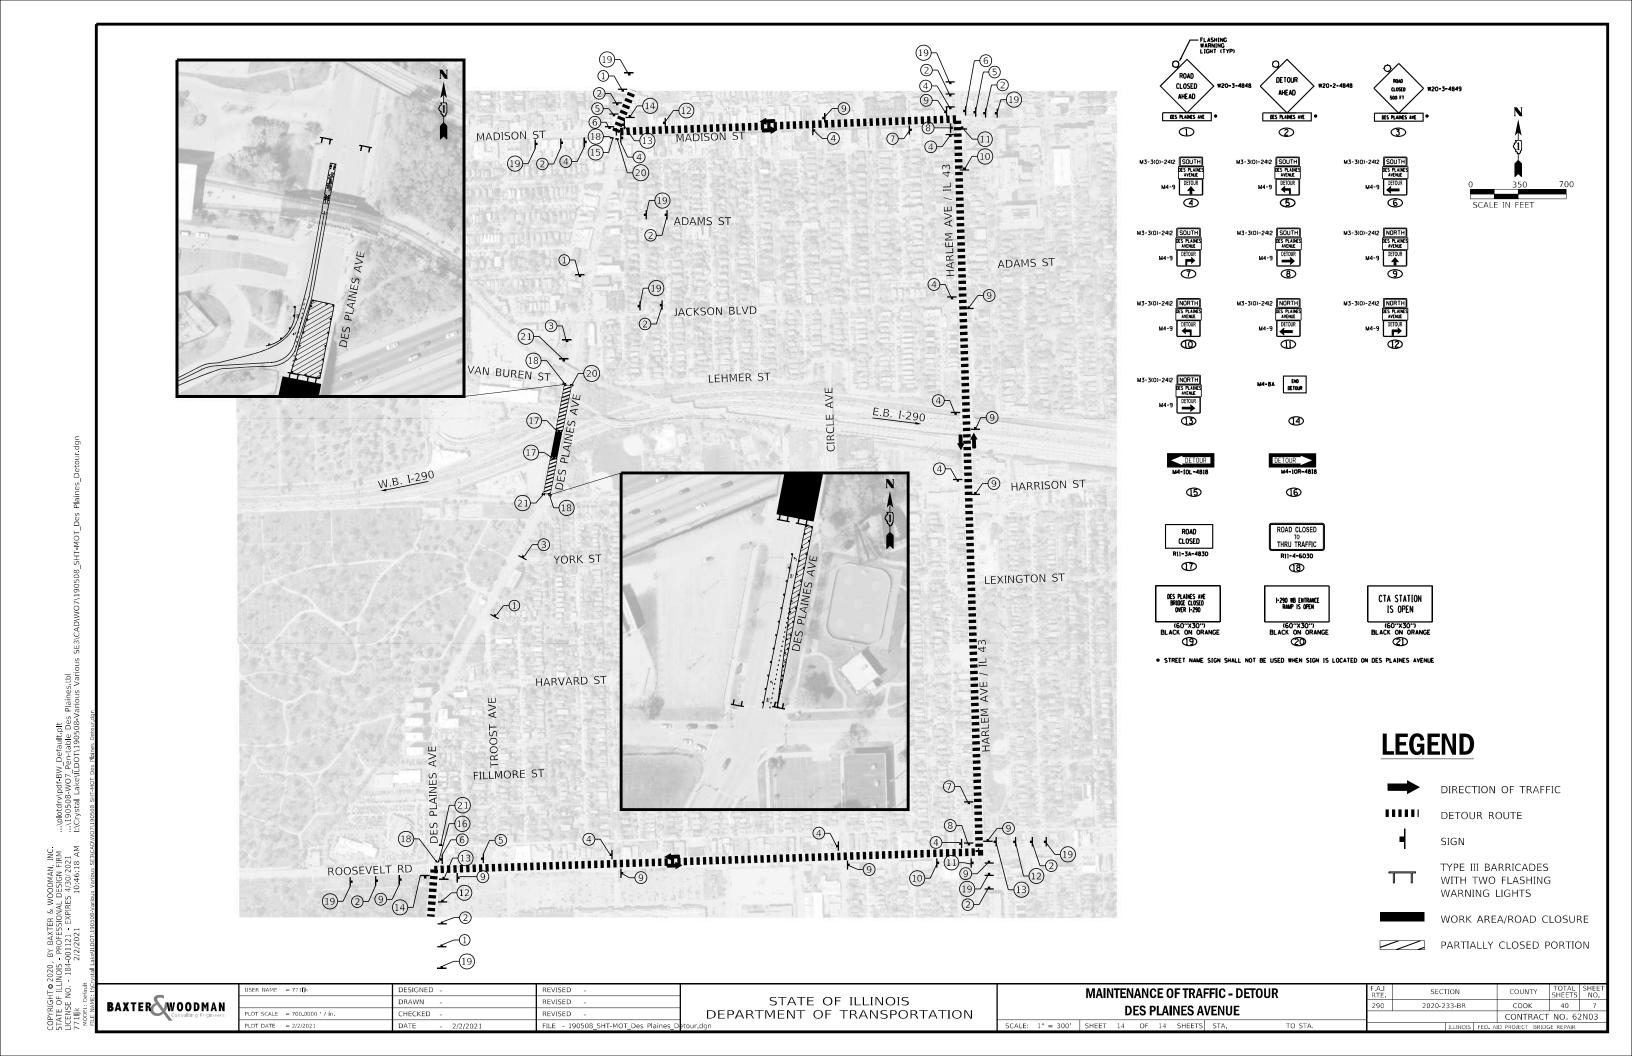

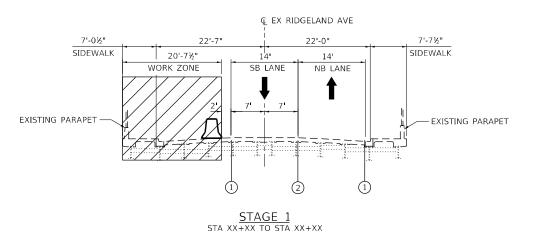

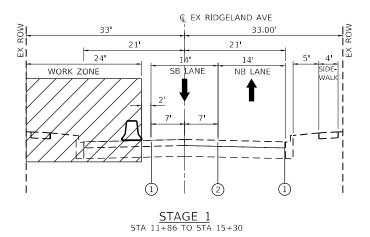

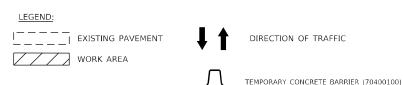

MAINTENANCE OF TRAFFIC STAGING DESCRIPTION

PRE-STAGE

CONSTRUCTION:

PRE-STAGE INCLUDES INSTALLATION OF TEMPORARY PROTECTIVE SHIELD.

USE ONLY NIGHTTIME LANE CLOSURES ON I-290.

APPLICABLE DISTRICT ONE DETAILS AND IDOT HIGHWAY STANDARD DRAWINGS:

TC-8 ENTRANCE AND EXIT RAMP CLOSURE DETAILS

TRAFFIC CONTROL DETAILS FOR FREEWAY SINGLE & MULTI-LANE WEAVE

TC-17 TRAFFIC CONTROL FOR FREEWAY SHOULDER CLOSURES AND PARTIAL RAMP CLOSURES TC-25 TRAFFIC CONTROL DETAILS FOR FREEWAY CENTER LANE CLOSURE SHOULDER LANE

701400-10 APPROACH TO LANE CLOSURE, FREEWAY/EXPRESSWAY

701401-12 LANE CLOSURE, FREEWAY/EXPRESSWAY

701411-09 LANE CLOSURE, MULTILANE, AT ENTRANCE OR EXIT RAMP, FOR SPEEDS ≥ 45 MPH

701428-01 TRAFFIC CONTROL, SETUP AND REMOVAL, FREEWAY/EXPRESSWAY

701446-11 TWO LANE CLOSURE, FREEWAY/EXPRESSWAY

701901-08 TRAFFIC CONTROL DEVICES

STAGE 1

CONSTRUCTION:

REPAIRS ON THE SOUTHBOUND HALF THE BRIDGE.

TRAFFIC ONE LANE IN EACH DIRECTION AND SHIFTED ONTO THE NORTHBOUND HALF OF THE BRIDGE.

INSTALL TRAFFIC CONTROL DEVICES IN ACCORDANCE WITH THE APPLICABLE DETAILS, STANDARDS, AND PLANS,

APPLICABLE DISTRICT ONE DETAILS AND IDOT HIGHWAY STANDARD DRAWINGS:

TC-10 TRAFFIC CONTROL PROTECTION FOR SIDE ROADS, INTERSECTIONS, AND DRIVEWAYS

TC-14 TRAFFIC CONTROL AND PROTECTION AT TURN BAYS (TO REMAIN OPEN TO TRAFFIC)

TC-16 SHORT TERM PAVEMENT MARKING LETTERS AND SYMBOLS

TC-22 ARTERIAL ROAD INFORMATION SIGN

TC-26 DRIVEWAY ENTRANCE SIGNING

701301-04 LANE CLOSURE, 2L, 2W, SHORT TIME OPERATIONS

701311-03 LANE CLOSURE, 2L, 2W, MOVING OPERATIONS - DAY ONLY

701321-18 LANE CLOSURE, 2L, 2W, BRIDGE REPAIR WITH BARRIER

701501-06 URBAN LANE CLOSURE, 2L, 2W, UNDIVIDED

701701-10 URBAN LANE CLOSURE, MULTILANE INTERSECTION

701801-06 SIDEWALK, CORNER OR CROSSWALK CLOSURE 701901-08 TRAFFIC CONTROL DEVICES

704001-08 TEMPORARY CONCRETE BARRIER

STAGE 2

CONSTRUCTION:

REPAIRS ON THE NORTHBOUND HALF THE BRIDGE.

TRAFFIC ONE LANE IN EACH DIRECTION AND SHIFTED ONTO THE SOUTHBOUND HALF OF THE BRIDGE.

INSTALL TRAFFIC CONTROL DEVICES IN ACCORDANCE WITH THE APPLICABLE DETAILS AND STANDARDS.

APPLICABLE DISTRICT ONE DETAILS AND IDOT HIGHWAY STANDARD DRAWINGS:

TC-10 TRAFFIC CONTROL PROTECTION FOR SIDE ROADS, INTERSECTIONS, AND DRIVEWAYS

TC-14 TRAFFIC CONTROL AND PROTECTION AT TURN BAYS (TO REMAIN OPEN TO TRAFFIC)

TC-16 SHORT TERM PAVEMENT MARKING LETTERS AND SYMBOLS TC-22 ARTERIAL ROADINFORMATION SIGN

TC-26 DRIVEWAY ENTRANCE SIGNING

701301-04 LANE CLOSURE, 2L, 2W, SHORT TIME OPERATIONS

701311-03 LANE CLOSURE, 2L, 2W, MOVING OPERATIONS - DAY ONLY 701321-18 LANE CLOSURE, 2L, 2W, BRIDGE REPAIR WITH BARRIER

701501-06 URBAN LANE CLOSURE, 2L, 2W, UNDIVIDED

701701-10 URBAN LANE CLOSURE, MULTILANE INTERSECTION 701801-06 SIDEWALK, CORNER OR CROSSWALK CLOSURE

701901-08 TRAFFIC CONTROL DEVICES


704001-08 TEMPORARY CONCRETE BARRIER

STAGE 3 - DETOUR


CONSTRUCTION:

REPAIRS ON THE EXPANSION JOINTS ACROSS THE BRIDGE

FOR WEEKEND OPERATIONS, CLOSE THE BRIDGE USING THE DETOUR PLAN

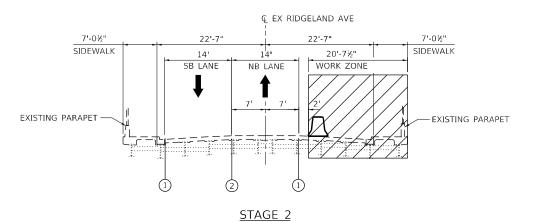

STA XX+XX TO STA XX+XX

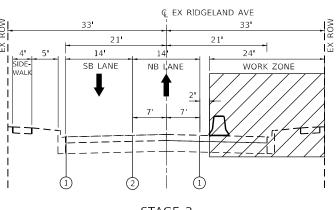

STAGE 2 STA 11+86 TO STA 15+30

- (1) PAVEMENT MARKING TAPE, TYPE IV 4" (SOLID WHITE) (70300904)
- (2) PAVEMENT MARKING TAPE, TYPE IV 4" (DOUBLE YELLOW) 11" C-C (70300904)

COOK

40


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STATE OF ILLINOIS **DEPARTMENT OF TRANSPORTATION**

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WORK AREA

ARROW BOARD



DIRECTION OF TRAFFIC

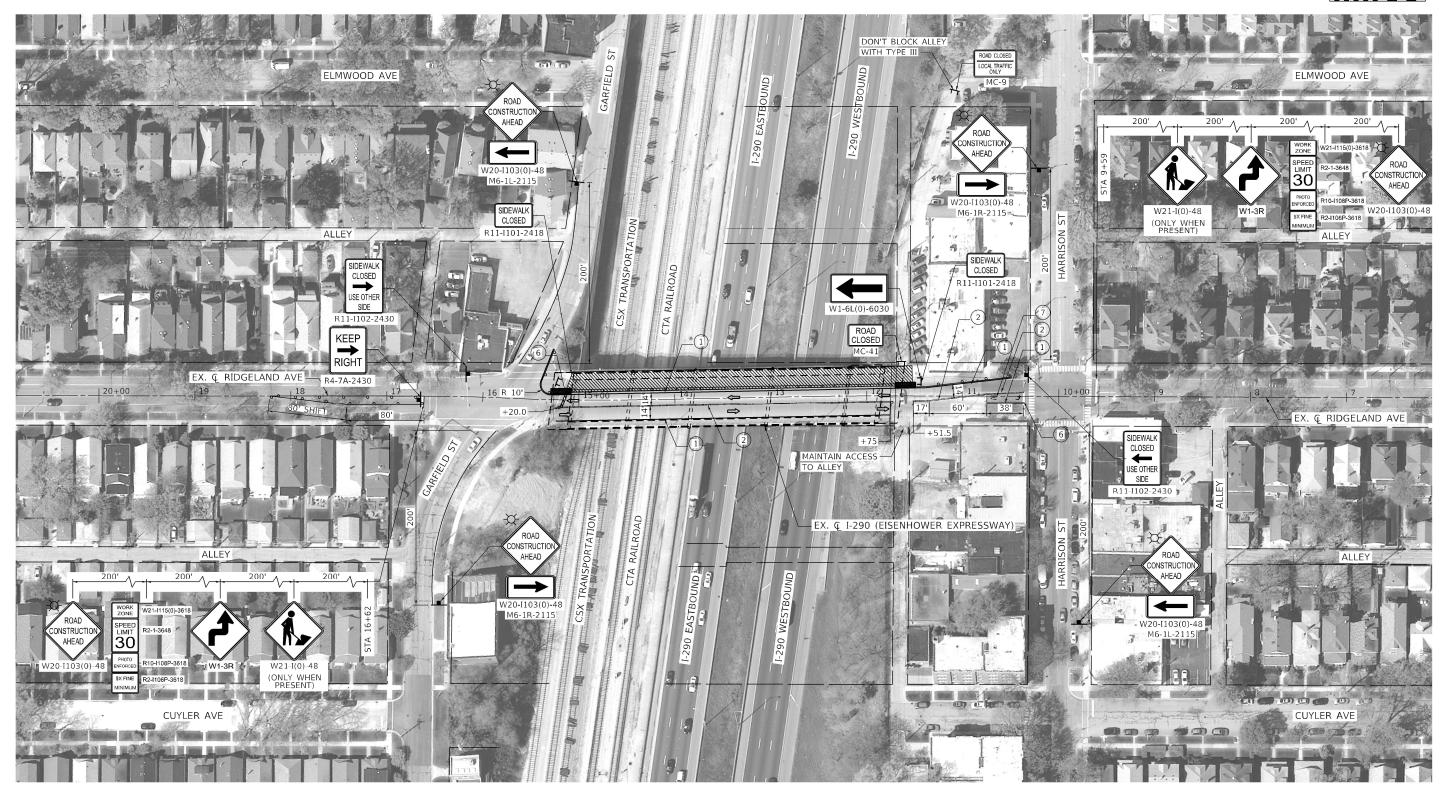TYPE III BARRICADE

IMPACT ATTENUATOR, TEMPORARY (NON-REDIRECTIVE, NARROW) TEST LEVEL 2 (70600241)

TYPE II BARRICADE OR DRUM WITH STEADY BURNING MONO-DIRECTIONAL LIGHT @ 25' CENTERS (10' CENTERS ALONG CURVES)

1 PAVEMENT MARKING TAPE, TYPE IV 4" (SOLID WHITE) (70300904)
2 PAVEMENT MARKING TAPE, TYPE IV 4" (DOUBLE YELLOW) 11" C-C (70300904)

3 PAVEMENT MARKING TAPE, TYPE IV 4" (SOLID YELLOW) (70300904)

(4) PAVEMENT MARKING TAPE, TYPE IV 6" (SOLID WHITE) (70300906)

5) PAVEMENT MARKING TAPE, TYPE IV 12" (SOLID WHITE) (70300912) $\overline{(6)}$ PAVEMENT MARKING TAPE, TYPE IV 24" (SOLID WHITE) (70300924) $\overline{7}$ pavement marking tape, type iv - letters and symbols (solid white) (70300900) UTILIZE IDOT STANDARDS AND DISTRICT ONE DETAILS FOR CLOSURES WHILE INSTALLING PROTECTIVE SHIELDING

WORK ZONE TAPER RATE CALCULATIONS:

S = SPEED IN MPH = 30

MERGING TAPER RATE = $(S^*S)/60 = 15/FT$ SHIFTING TAPER RATE = (MERGING RATE)/2 = 7.5/FTAPPROACH BUFFER = 4S = 120 FTLONGITUDINAL BUFFER = 16 FT MIN.



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STATE OF ILLINOIS **DEPARTMENT OF TRANSPORTATION**

MAINTENANCE OF TRAFFIC					
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SHEET

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				CONTRACT	NO. 62	2N03
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WORK AREA

ARROW BOARD

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DIRECTION OF TRAFFIC

IMPACT ATTENUATOR, TEMPORARY (NON-REDIRECTIVE, NARROW) TEST LEVEL 2 (70600241)

TYPE III BARRICADE

TYPE II BARRICADE OR DRUM WITH STEADY BURNING MONO-DIRECTIONAL LIGHT @ 25' CENTERS (10' CENTERS ALONG CURVES)

1 PAVEMENT MARKING TAPE, TYPE IV 4" (SOLID WHITE) (70300904)
2 PAVEMENT MARKING TAPE, TYPE IV 4" (DOUBLE YELLOW) 11" C-C (70300904)

(7) pavement marking tape, type IV - Letters and Symbols (Solid White) (70300900)

3 PAVEMENT MARKING TAPE, TYPE IV 4" (SOLID YELLOW) (70300904)

(4) PAVEMENT MARKING TAPE, TYPE IV 6" (SOLID WHITE) (70300906)

5) PAVEMENT MARKING TAPE, TYPE IV 12" (SOLID WHITE) (70300912) $\overline{6}$ PAVEMENT MARKING TAPE, TYPE IV 24" (SOLID WHITE) (70300924) UTILIZE IDOT STANDARDS AND DISTRICT ONE DETAILS FOR CLOSURES WHILE INSTALLING PROTECTIVE SHIELDING

WORK ZONE TAPER RATE CALCULATIONS:

S = SPEED IN MPH = 30

MERGING TAPER RATE = $(S^*S)/60 = 15/FT$ SHIFTING TAPER RATE = (MERGING RATE)/2 = 7.5/FTAPPROACH BUFFER = 4S = 120 FTLONGITUDINAL BUFFER = 16 FT MIN.




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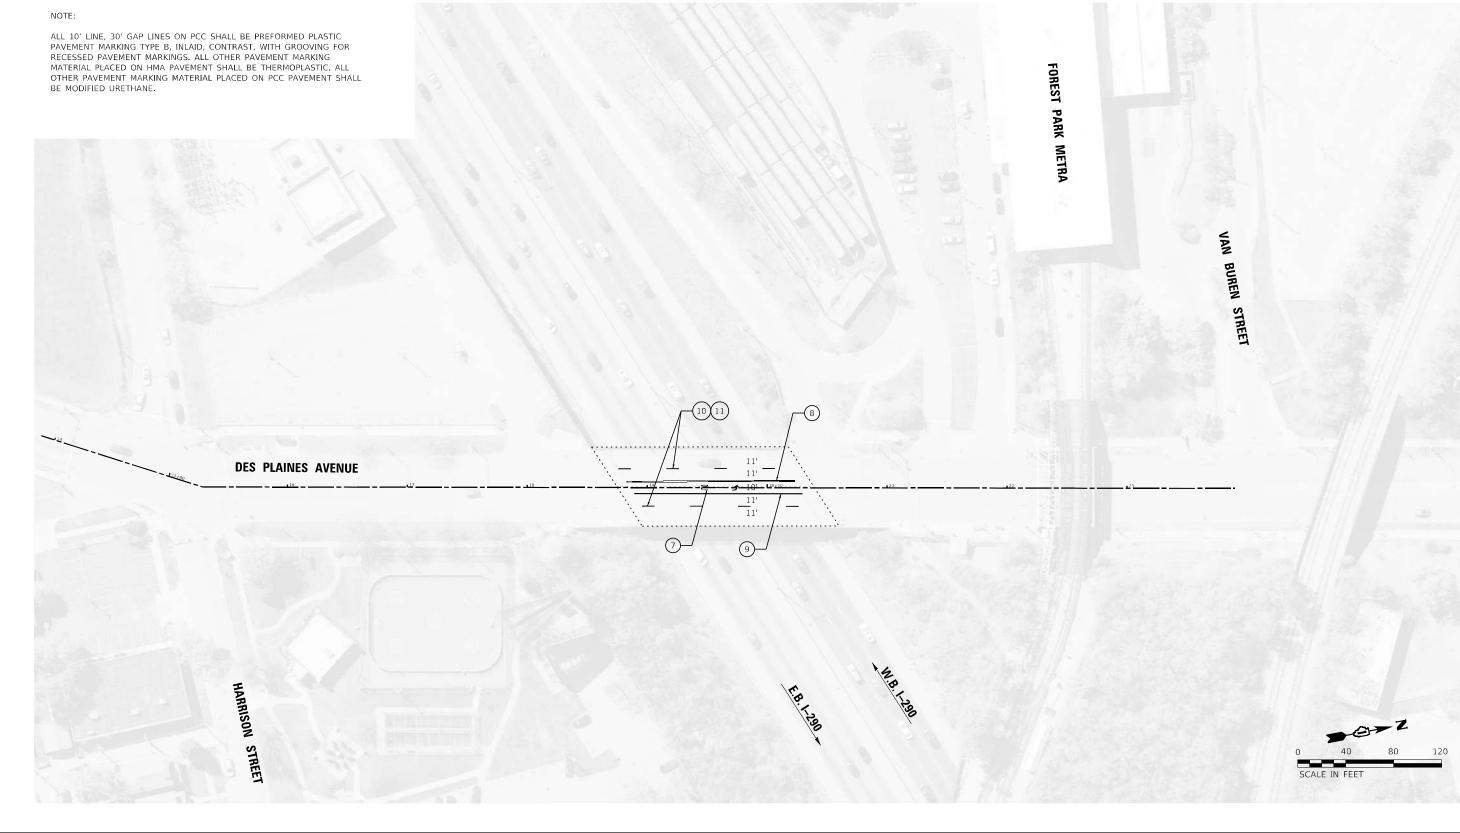
STATE OF ILLINOIS **DEPARTMENT OF TRANSPORTATION**

IAINTENAI DGELAND		TRAFFIC STAGE 2	
OF	SHEETS	STA.	TO STA.

SHEET

F.A.I. RTE.	SECTION	COUNTY	TOTAL SHEETS	SHEET NO.
290	2020-233-BR	соок	40	10
		CONTRACT	NO. 62	2N03



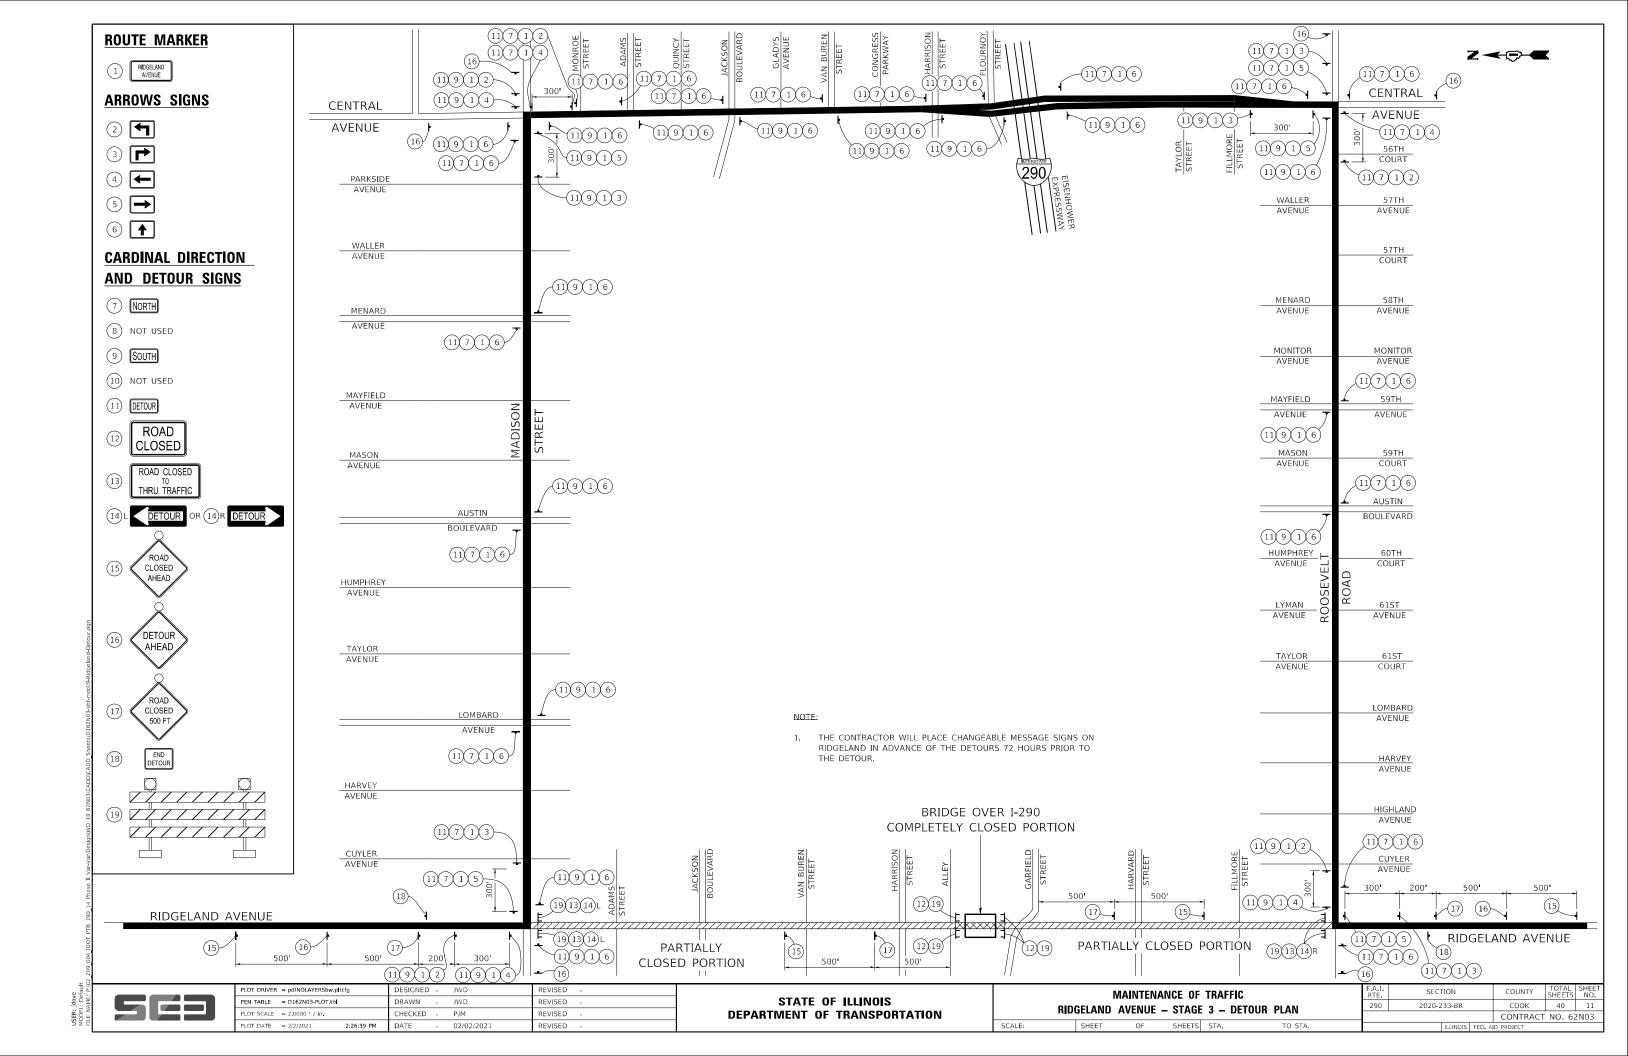

- THERMOPLASTIC PAVEMENT MARKING LETTERS AND SYMBOLS (SOLID WHITE) (78000100)

 THERMOPLASTIC PAVEMENT MARKING LINE 4" (DOUBLE YELLOW) 11" C-C (78000200)

 THERMOPLASTIC PAVEMENT MARKING LINE 6" (SKIP-DASH WHITE) (78000400)

 THERMOPLASTIC PAVEMENT MARKING LINE 6" (SOLID WHITE) (78000400)

- 5 THERMOPLASTIC PAVEMENT MARKING LINE 12" (SOLID WHITE) (78000600)

- 6 THERMOPLASTIC PAVEMENT MARKING LINE 24" (SOLID WHITE) (78000650)
 7 MODIFIED URETHANE PAVEMENT MARKING LETTERS AND SYMBOLS (SOLID WHITE) (78009000)
- 8 MODIFIED URETHANE PAVEMENT MARKING LINE 4" (DOUBLE YELLOW) 11" C-C (78009004)
- 9 MODIFIED URETHANE PAVEMENT MARKING LINE 6" (SKIP-DASH WHITE) (78009006)
- PREFORMED PLASTIC PAVEMENT MARKING, TYPE B INLAID CONTRAST LINE 7" (SKIP-DASH WHITE) (X7800956)
- (1) GROOVING FOR RECESSED PAVEMENT MARKING 9" (X7830076)

BAXTER WOODMAN Consulting Engineers

DRAWN - CJC REVISED CHECKED - JFM REVISED


STATE OF ILLINOIS DEPARTMENT OF TRANSPORTATION

PAVEMENT MARKING PLAN **DES PLAINES AVENUE** SCALE: 1" = 40' SHEET 1 OF 1 SHEETS STA.

SECTION 2020-233-BR COOK CONTRACT NO. 62N03

1. SEE DISTRICT 1 TYPICAL PAVEMENT MARKINGS (TC13).



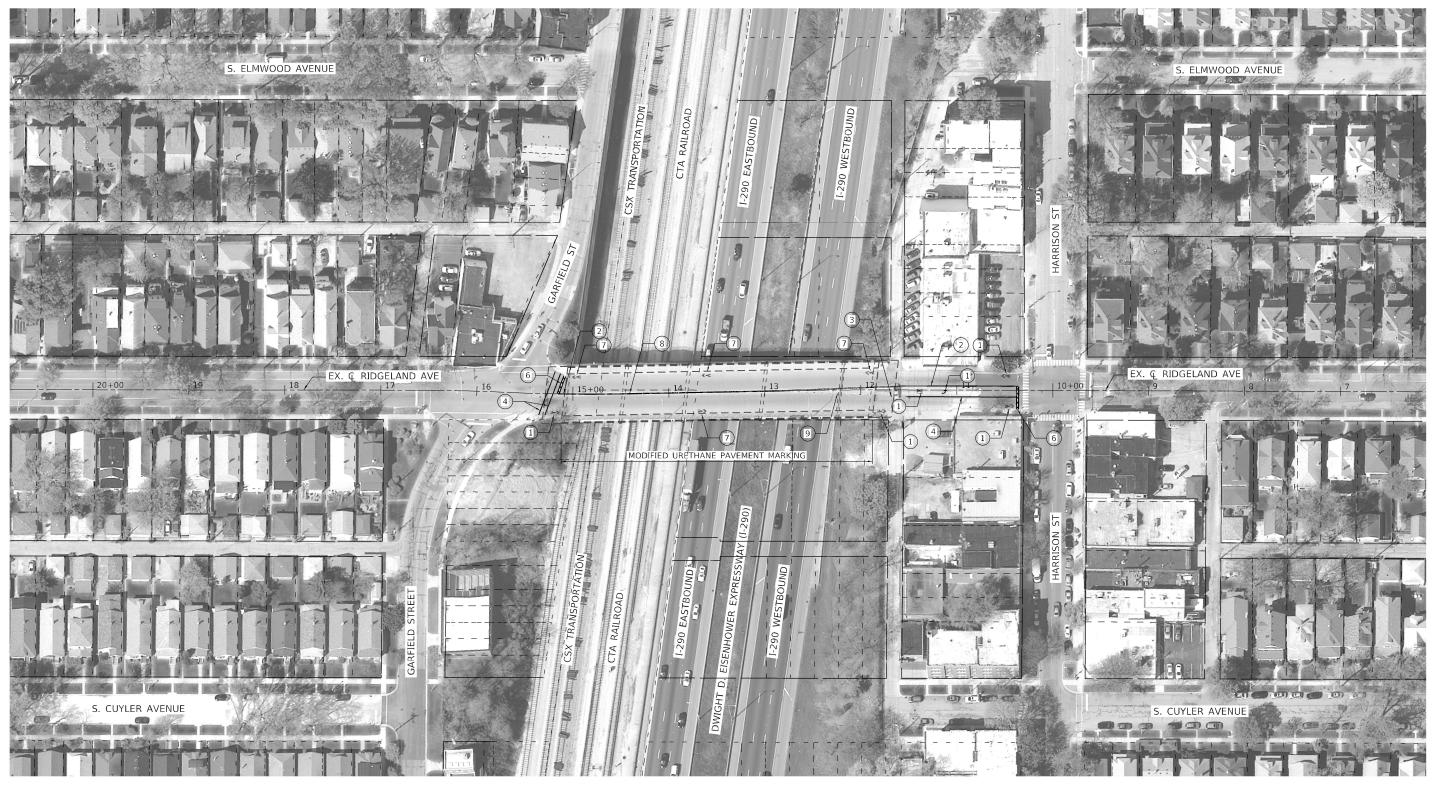

- 1 THERMOPLASTIC PAVEMENT MARKING LETTERS AND SYMBOLS (SOLID WHITE) (78000100)
- 2 THERMOPLASTIC PAVEMENT MARKING LINE 4" (DOUBLE YELLOW) 11" C-C (78000200)
- 3 THERMOPLASTIC PAVEMENT MARKING LINE 6" (SKIP-DASH WHITE) (78000400)
- (4) THERMOPLASTIC PAVEMENT MARKING LINE 6" (SOLID WHITE) (78000400)
- 5 THERMOPLASTIC PAVEMENT MARKING LINE 12" (SOLID WHITE) (78000600)

(6) THERMOPLASTIC PAVEMENT MARKING - LINE 24" (SOLID WHITE) (78000650)

- (7) MODIFIED URETHANE PAVEMENT MARKING LETTERS AND SYMBOLS (SOLID WHITE) (78009000)
- 8 MODIFIED URETHANE PAVEMENT MARKING LINE 4" (DOUBLE YELLOW) 11" C-C (78009004)
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- (1) GROOVING FOR RECESSED PAVEMENT MARKING 9" (X7830076)

NOTE:

1. SEE DISTRICT 1 TYPICAL PAVEMENT MARKINGS (TC13).




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STATE OF ILLINOIS **DEPARTMENT OF TRANSPORTATION**

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F.A.I. RTE.	SEC	TION		COUNTY	TOTAL SHEETS	SHEE NO.
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DEPARTMENT OF TRANSPORTATION

2020-233-BR

STRUCTURE NO. 016-0706 (DES PLAINES AVE.)

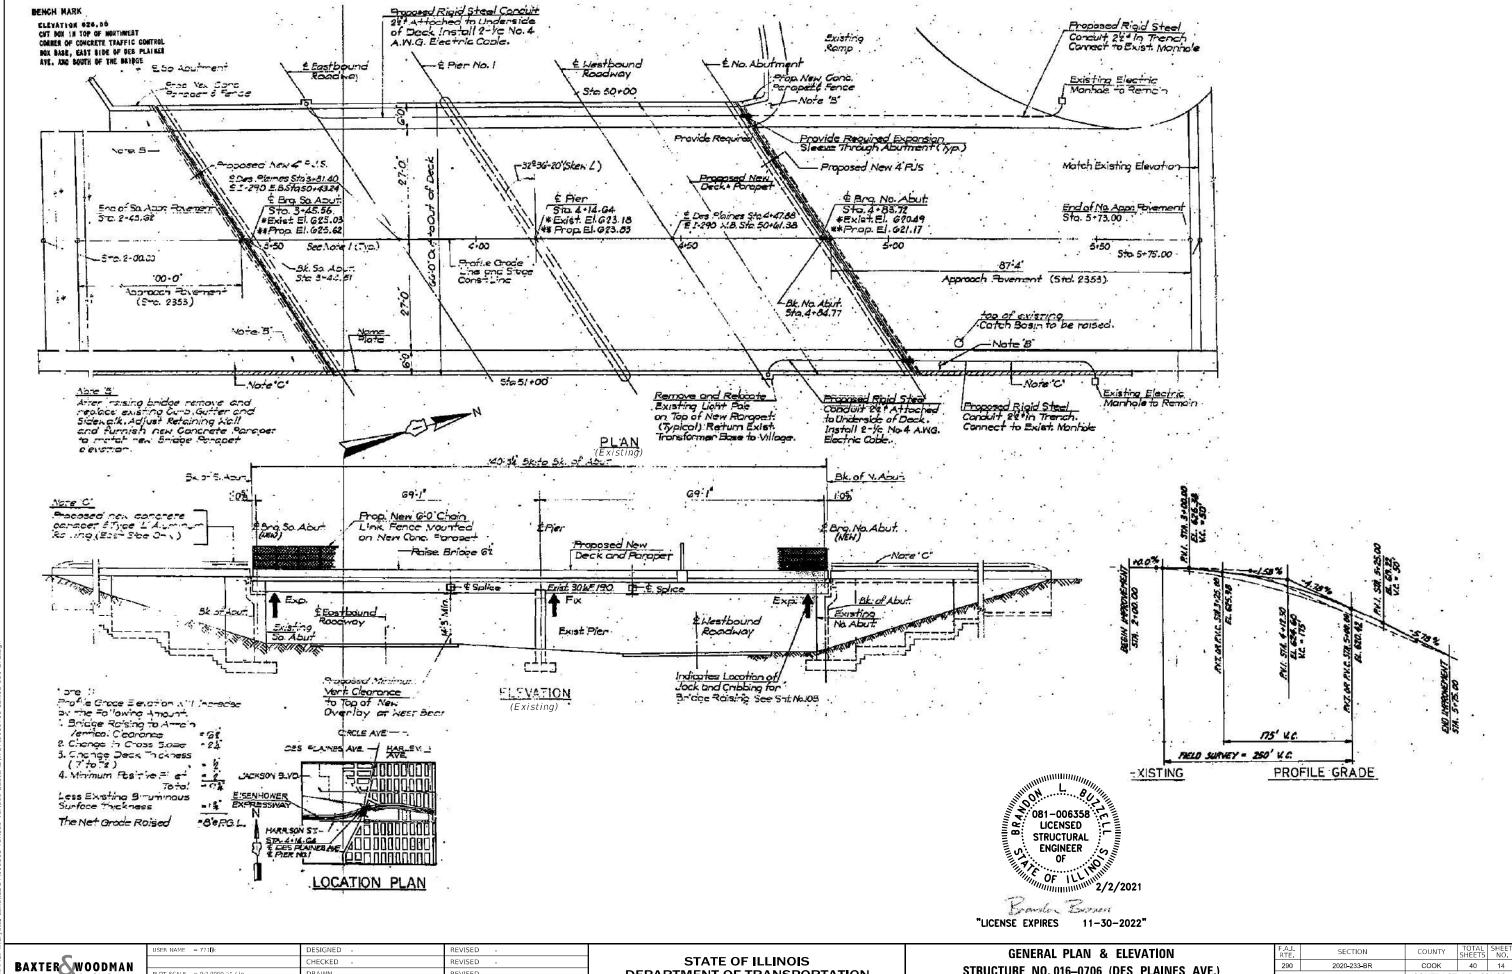COOK 40 14

CONTRACT NO. 62N03

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REVISED

Plan dimensions and details relative to existing plans are subject to nominal construction variations. The Contractor shall field verify existing dimensions and details affecting new construction and make necessary approved adjustments prior to construction or ordering of materials. Such variations shall not be cause for additional compensation for a change in scope of the work, however, the Contractor will be paid for the quantity actually furnished at the unit price bid for the work.

Concrete repairs shall receive final surface finish according to Article 420.09(e)(1). Cost included with the appropriate repair item.

INDEX OF SHEETS


- 1. General Plan and Elevation
- 2. General Data
- 3. Deck & Joint Repair Details
- 4. Protective Shield Details
- 5. Expansion Joint Details

SCOPE OF WORK

- 1. Expansion joint nosing repairs.
- 2. Expansion joints replacement.
- 3. Deck slab repairs.
- 4. Protective shield installation and removal.
- 5. Approach slab repairs.

TOTAL BILL OF MATERIAL

ITEM	UNIT	TOTAL
Concrete Removal	Cu. Yd.	1.0
Protective Shield	Sq. Yd.	16
Preformed Joint Seal 11/2"	Foot	162
Approach Slab Repair (Partial Depth)	Sq. Yd.	8
Deck Slab Repair (Full Depth, Type I)	Sq. Yd.	1
Deck Slab Repair (Partial)	Sq. Yd.	1
Polymer Concrete	Cu. Ft.	27.0

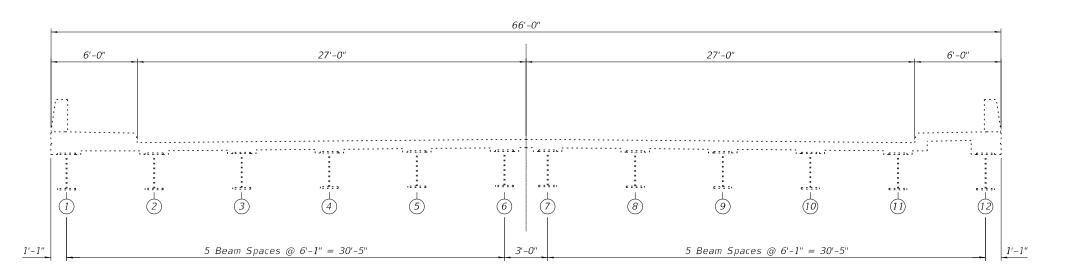

EXISTING BRIDGE CROSS SECTION

Looking south

BAYTERSWOODMAN
BAXTER WOODMAN Consulting Engineers

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COUNTY

COOK 40 15

CONTRACT NO. 62N03

Plan dimensions and details relative to existing plans are subject to nominal construction variations. The Contractor shall field verify existing dimensions and details affecting new construction and make necessary approved adjustments prior to construction or ordering of materials. Such variations shall not be cause for additional compensation for a change in scope of the work, however, the Contractor will be paid for the quantity actually furnished at the unit price bid for the work.

Concrete repairs shall receive final surface finish according to Article 420.09(e)(1). Cost included with the appropriate repair item.

INDEX OF SHEETS


- 1. General Plan and Elevation
- 2. General Data
- 3. Deck & Joint Repair Details
- 4. Protective Shield Details
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SCOPE OF WORK

- 1. Expansion joint nosing repairs.
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TOTAL BILL OF MATERIAL

ITEM	UNIT	TOTAL
Concrete Removal	Cu. Yd.	1.0
Protective Shield	Sq. Yd.	16
Preformed Joint Seal 1"	Foot	162
Approach Slab Repair (Partial Depth)	Sq. Yd.	8
Deck Slab Repair (Full Depth, Type I)	Sq. Yd.	1
Deck Slab Repair (Partial)	Sq. Yd.	1
Polymer Concrete	Cu. Ft.	27.0



EXISTING BRIDGE CROSS SECTION Looking south

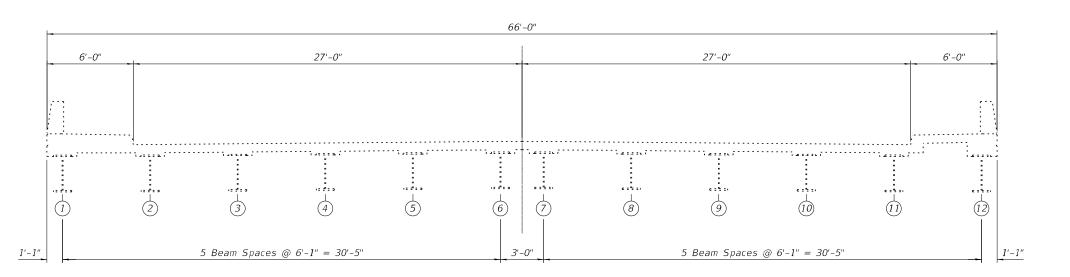i	BAXTER WOODMAN
	Consulting Engineers

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COUNTY COOK 40 15 CONTRACT NO. 62N03 SHEET 2 OF 5 SHEETS

<u>LEGEND</u>

Protective Shield

2 Beam Number

BILL OF MATERIAL

Item	Unit	Total
Protective Shield	Sg. Yd.	16

BAXTER WOODMAN
Consulting Engineers

STATE OF ILLINOIS DEPARTMENT OF TRANSPORTATION

PROTECTIVE SHIELD DETAILS
STRUCTURE NO. 016-0706 (DES PLAINES AVE.)

 F.A.I. RTE.
 SECTION
 COUNTY
 TOTAL SHEETS NO.
 SHEETS NO.


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 CONTRACT NO. 62N03

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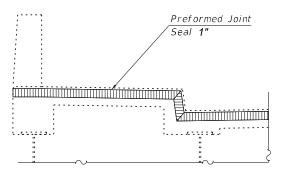
COPYRIGHT © 2020, BY BAXTER & WOODWAN, INC. STATE OF ILLINOIS - PROFESSIONAL DESIGN FIRM ...\plotdrv\pdf-BW_Default.plt LICENSE NO. - 184-001121 - EXPIRES 4/30/2021 ...\190508-WO7_Pen-table Des Plaines.tbl

34-001121 - EXPIRES 4/30/2021\190508-WO7_Pen-table



JOINT DETAIL

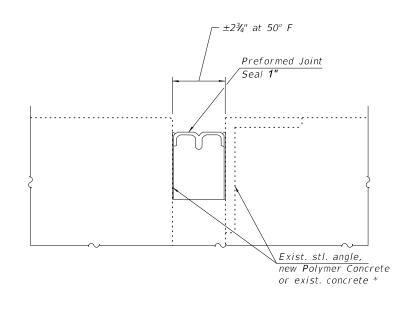* Install Preformed Joint Seal against existing concrete at sidewalks.



See joint detail

TYPICAL SECTION THRU SIDEWALK

Notes:

Removal of the existing seal is included in the cost of Preformed Joint Seal.
See sheet 3 of 8 for Polymer Concrete repair locations.

BAXTER WOODMAN

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STATE OF ILLINOIS DEPARTMENT OF TRANSPORTATION

EXPANSION JOINT DETAILS					
STRUCTURE	NO. 016	-0706	(DES	PLAINES	AVE.)

λ.I. ΓΕ	SECTION	COUNTY	TOTAL SHEETS	SHEET NO.
90	2020-233-BR	соок	40	18
		CONTRACT	NO. 62	2N03

Unit Total


BILL OF MATERIAL

Preformed Joint Seal 1"


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Existing Structure: Structure No. 016-0710 was originally constructed in 1957 under Section 3132-207-VB. Existing structure is a reinforced concrete deck on steel girders. 321'-11" face to face of abutments backwalls. 59'-3" out to out deck. A deck overlay was placed, and the sidewalk, parapets and railings were reconstructed in 1991 under Section 3132-207-VB-BR (80).

One lane of traffic in each direction on Ridgeland Avenue will be maintained during construction. Traffic on I-290 will be maintained using temporary nightly lane closures. See Special Provisons.

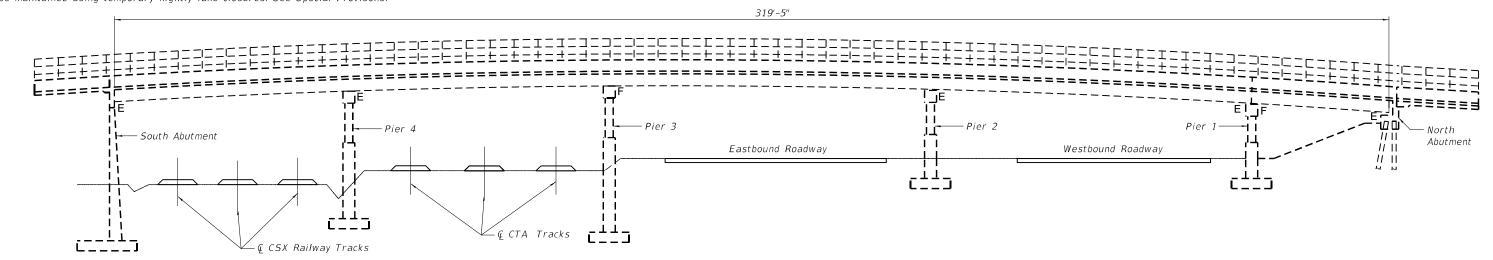

ELEVATION

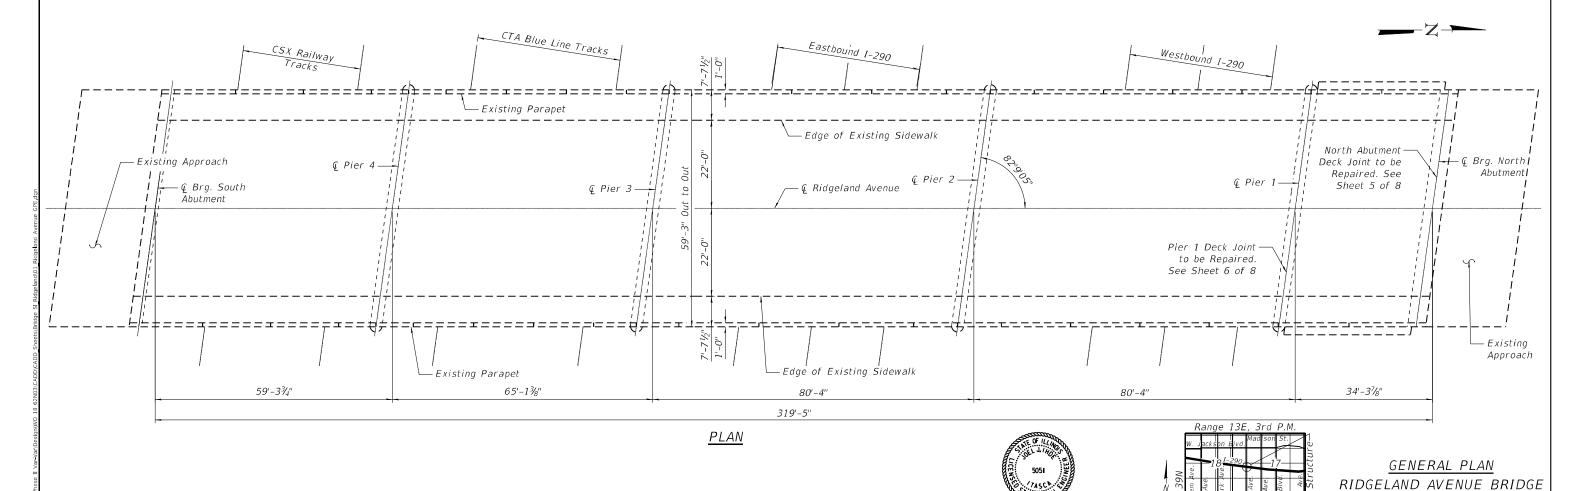

BLA, Inc.

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STATE OF ILLINOIS
DEPARTMENT OF TRANSPORTATION

GENERAL PLAN AND ELEVATION
STRUCTURE NO. 016–0710 (RIDGELAND AVENUE)

DATE SIGNED: 01-22-2021 EXP. DATE: 11-30-2022

		ILL	INOIS FED. AI	D PROJECT		
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AND AVENUE)	290	2020-233	3-BR	соок	40	19
ATION	F.A.I. RTE.	SECTIO	N	COUNTY	TOTAL SHEETS	SHEET NO.
LOCATION SKETCH	<u> </u>					

OVER I-290, CTA and CSX RR

COOK COUNTY

STRUCTURE NO. 016-0710

GENERAL NOTES

Plan dimensions and details relative to existing plans are subject to nominal construction variations. The contractor shall field verify existing dimensions and details affecting new construction and make necessary approved adjustments prior to construction or ordering of materials. Such variations shall not be cause for additional compensation for a change in scope of work, however, the Contractor will be paid for the quantity actually furnished at the unit price bid for the work.

The contractor is alerted to the presence of electrical conduit within the existing parapets. The conduit should be accurately located prior to performing concrete repairs. The contractor is responsible for any damage to the existing light conduits.

INDEX OF SHEETS


- 1. General Plan and Elevation
- 2. General Data
- 3. Sidewalk Repair Plan
- 4. Parapet Repair Details
- 5. North Abutment Joint Repair Details
- 6. Pier 1 Joint Repair Details
- 7. Framing Plan
- 8. Permanent Protective Shield Details

TOTAL BILL OF MATERIAL

Item	Unit	Total
Preformed Joint Seal ¹ 2"	Foot	65
Preformed Joint Seal 2"	Foot	65
Protective Shield (Permanent)	Sq. Yd.	527
Bridge Sidewalk Repair (Full Depth)	Sq. Ft.	449
Structural Repair of Concrete (Depth Equal to or Less Than 5")	Sq. Ft.	53
Polymer Concrete	Cu. Yd.	7.5
Debris Screen	Sq. Yd.	426
Remove Existing Joint	Foot	65

SCOPE OF WORK

- Install Permanent Protective Shield beneath both sidewalks.
 Perform concrete repairs on sidewalks and parapets.
- 3. Repair joints at North Abutment and Pier 1.

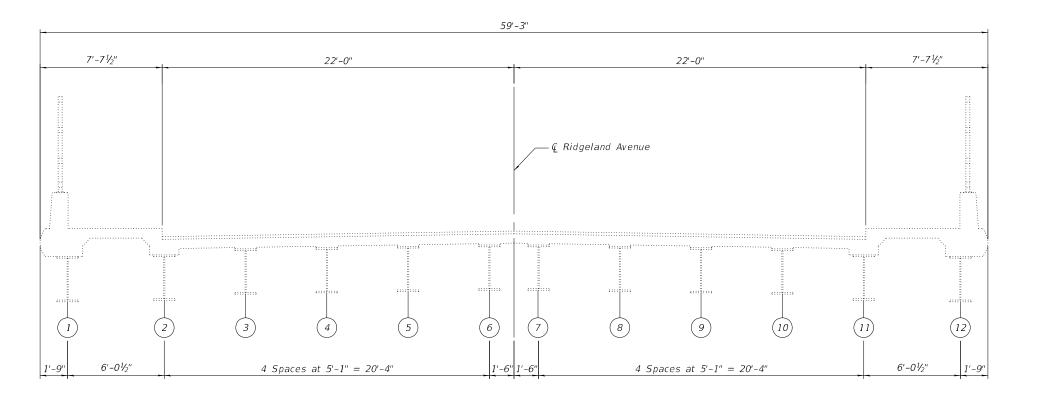

EXISTING BRIDGE CROSS SECTION

(Looking South)

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Notes:

For parapet repairs, see sheet 4 of 8.

Repairs of the existing sidewalks shall include, but may not be limited to, the area shown. The actual areas to be determined by the Engineer at the time of construction.

shown. The actual areas to be determined by the Engineer at the time of construction.

Bridge Sidewalk Repair (Full Depth) shall be performed according to the Guide Bridge


Special Provision for Structural Repair of Concrete and as directed by the Engineer in the field.

Debris Screen shall cover the full height and length of the existing bridge fence railing and shall be installed prior to any concrete removal. See Special Provisions.

<u>LEGE</u>ND



Bridge Sidewalk Repair (Full Depth)

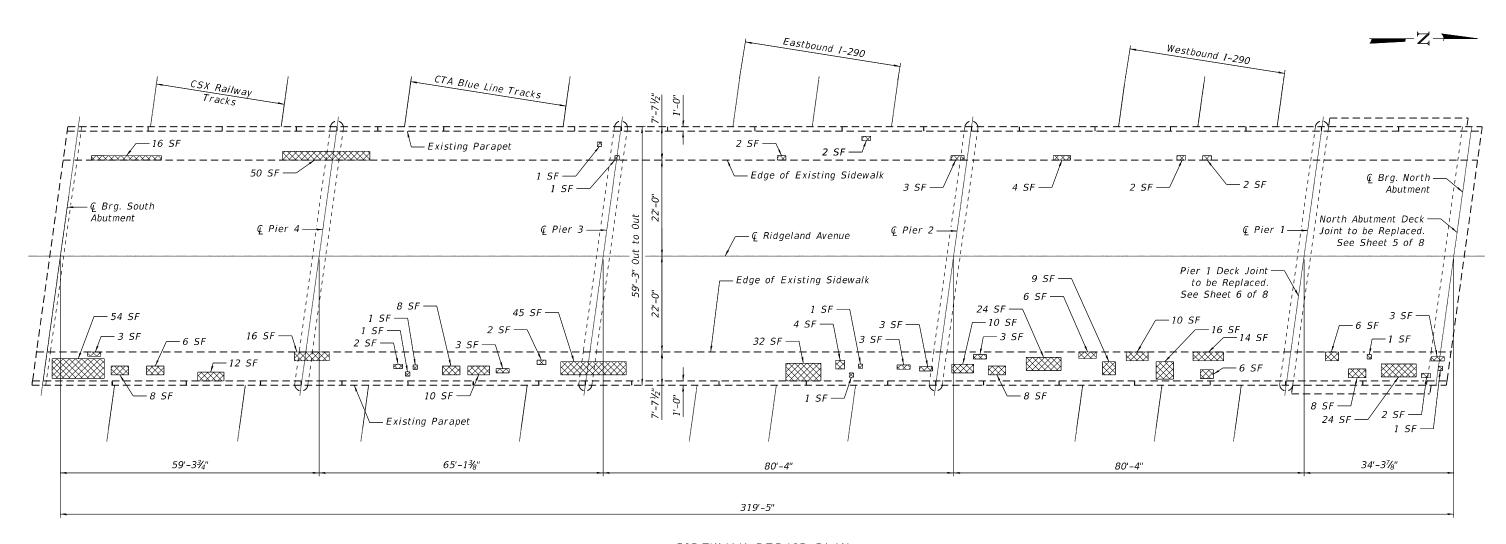

SIDEWALK REPAIR PLAN

BILL OF MATERIAL

Item	Unit	Total	
Bridge Sidewalk Repair (Full Depth)	Sq. Ft.	449	

FILE NAME: P:	BL	BLA,	Inc.
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Notes:

Repairs of the existing parapets shall include, but may not be limited to, the area shown.


The actual areas to be determined by the Engineer at the time of construction.

Debris Screen shall cover the full height and length of the existing bridge fence railing and shall be installed prior to any concrete removal. See Special Provisions.

The contractor is alerted to the presence of electrical conduit within the existing parapets. The conduit should be accurately located prior to performing concrete repairs. Any damages caused by the Contractor to existing utilities shall be repaired by the contractor at no additional cost.


LEGEND

Structural Repair of Concrete (Depth Equal to or Less Than 5")

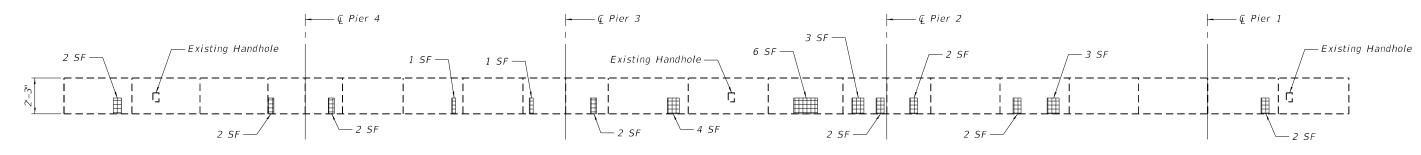

WEST PARAPET ELEVATION

(Looking at Inside Face 4:1 V:H) (Railing omitted for clarity)

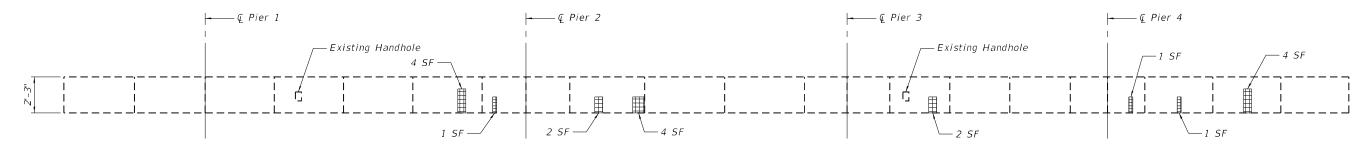

EAST PARAPET ELEVATION

(Looking at Inside Face 4:1 V:H) (Railing omitted for clarity)


BILL OF MATERIAL


Item	Unit	Total
Structural Repair of Concrete (Depth Equal to or Less Than 5")	Sq. Ft.	53



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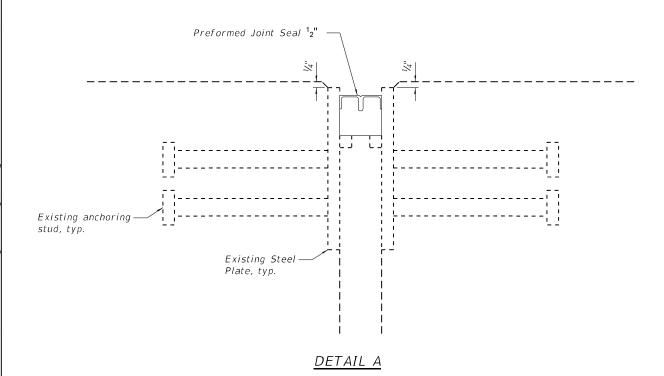
F.A.I. RTE.	SECTION	COUNTY	TOTAL SHEETS	SHEET NO.		
290	2020-233-BR	COOK	40	22		
CONTRACT NO. 62NO3						
ILLINOIS FED. AID PROJECT						



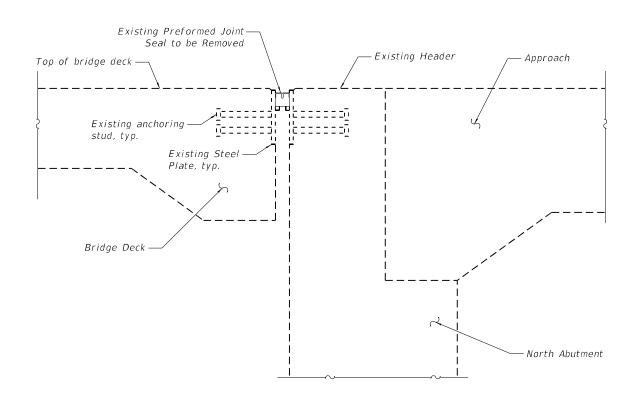

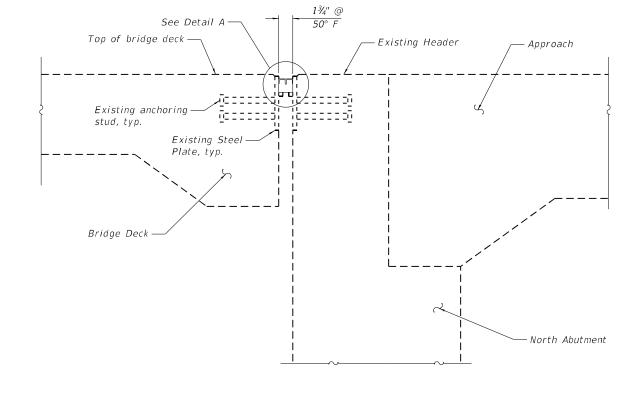JOINT DETAIL


REMOVAL DETAIL



BILL OF MATERIAL

Cost of removing existing seal is included in the cost of Preformed Joint Seal.

<u> </u>		
Item	Unit	Total
Preformed Joint Seal 12"	Foot	65

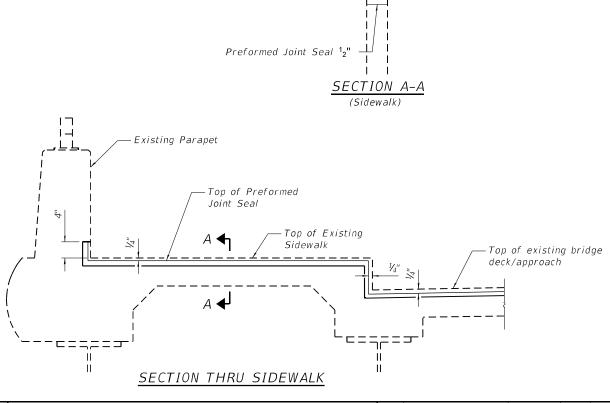

- Existing sidewalk to remain

COUNTY


COOK 40 23


B	BLA,	Inc.
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STATE OF ILLINOIS **DEPARTMENT OF TRANSPORTATION**

SECTION NORTH ABUTMENT JOINT REPAIR DETAILS 2020-233-BR STRUCTURE NO. 016-0710 (RIDGELAND AVENUE) CONTRACT NO. 62NO3



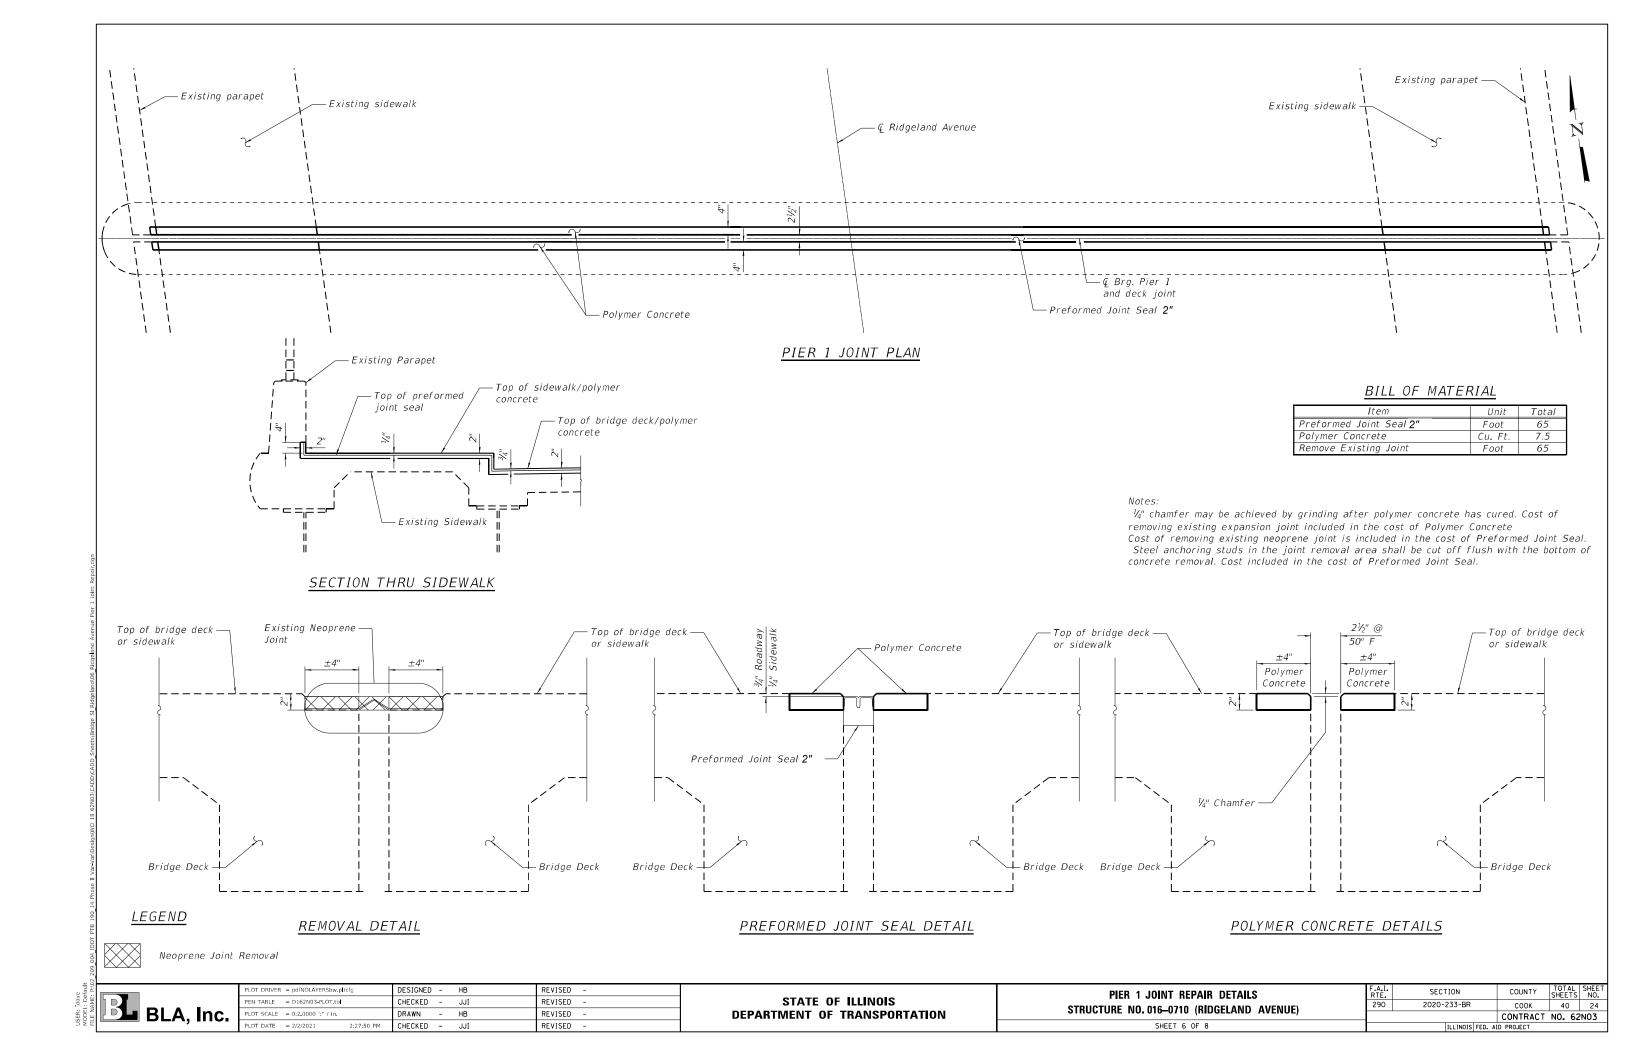

BLA, Inc.

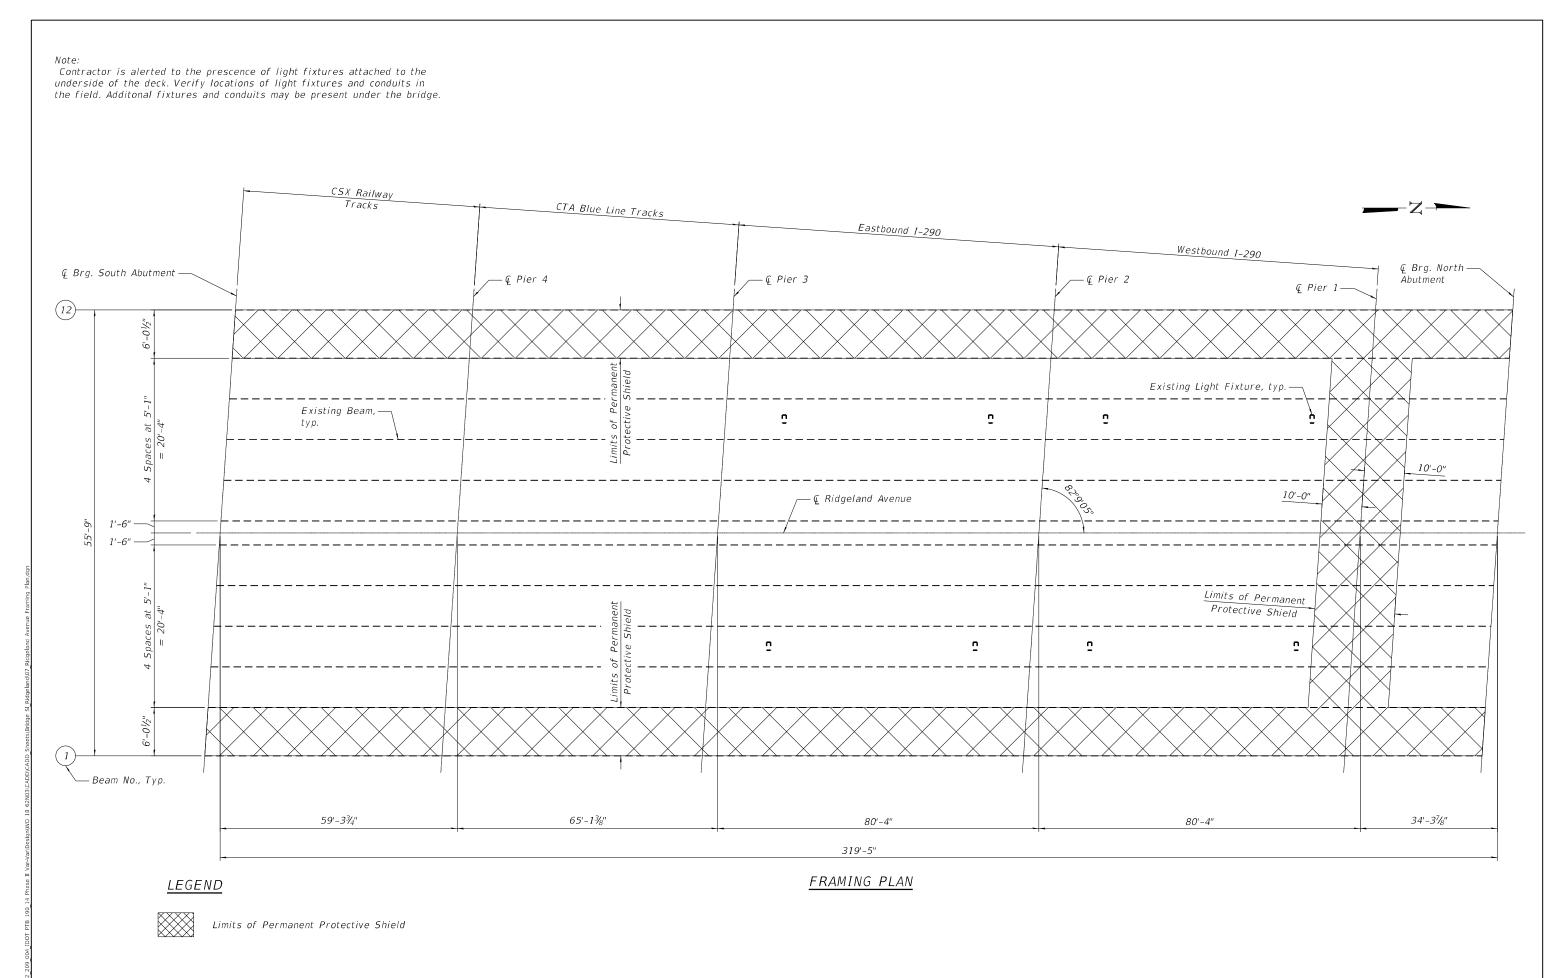PLOT DRIVER = pdfNOLAYERSbw.pltcfg	DESIGNED - HB	REVISED -
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STATE OF ILLINOIS
DEPARTMENT OF TRANSPORTATION

FRAMING PLAN	F.A.I. RTE.	SECTIO
STRUCTURE NO. 016-0710 (RIDGELAND AVENUE)		2020-23
SINGUIGHE NO. 010-0710 (HIDGELAND AVENUE)		
SHEET 7 OF 8		ILI

F.A.I. SECTION COUNTY TOTAL SHEET NO. 290 2020-233-BR COOK 40 25


| CONTRACT NO. 62NO3 | ILLINOIS | FED. AID PROJECT

BILL OF MATERIAL

Item	Unit	Total
Protective Shield (Permanent)	Sq. Yd.	527

TIMBER SPACING

	Timber Sizes (in.)				
Beam	4" x 4" with min.	4" x 6" with min.	6" x 6" with min.		
Spacing	Fb=775 psi	Fb=775 psi	Fb=575 psi		
(ft.)	Fv=135 psi	Fv=135 psi	Fv=125 psi		
	Maximu	ım Timber Spacı	ing (in.)		
4.5	16	16	16		
4.75	16	16	16		
5.0	16	16	16		
5.25	16	16	16		
<i>5.75</i>	16	16	16		
6.0	16	16	16		
6.25	12	16	16		
6.5	12	16	16		
6.75	12	16	16		
7.0	8	16	16		
7.25	8	16	16		
7.5	8	16	16		
7.7 <i>5</i>	8	16	16		
8.0	8	12	16		
8.25	8	12	16		
8.5	6	12	12		
8.75	6	12	12		
9.0	6	8	12		

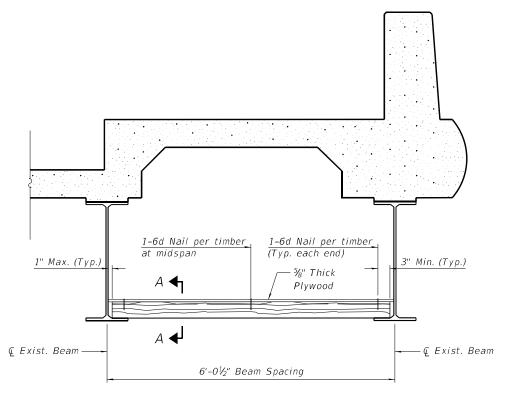

<u>TYPICAL SECTION THRU EXTERIOR BAY</u>



Beam Spacing Varies


TYPICAL SECTION THRU INTERIOR BAY

1-6d Nail per timber

at midspan

1" Max. (Typ.)

⊈ Exist. Beam —

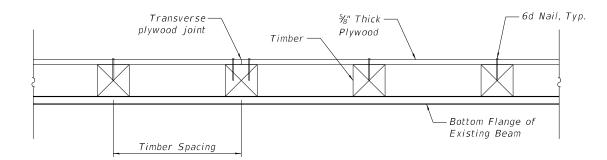

1-6d Nail per timber

5/8" Thick

Plywood

3" Min. (Typ.)

— @ Exist. Beam

(Typ. each end)

SECTION A-A

NOTES

See special provision for Permanent Protective Shield System.

The Contractor shall relocate any conduit attached to the flange prior to the installation of the protective shield system. Under no circumstances shall the protective shielding rest on top of the conduit. Any damages caused by the Contractor to existing utilities shall be repaired by the contractor at no additional cost.

Any work done by the Contractor on the underpass lighting system will require a transfer of maintenance of the effected circuits to the Contractor. Alternatively, the Contractor can avoid a maintenance transfer by hiring the Illinois Department of Transportation's Electrical Maintenance Contractor (EMC) to relocate the conduit.

Where underpass lighting is present on a structure, the Contractor shall adjust the protective shielding to ride above the existing lighting fixtures in order to maintain the existing level of lighting on the roadway underneath. Details shall be approved by the Engineer before installation. A clearance of $1\frac{1}{2}$ " $\pm \frac{1}{4}$ " around the fixture shall be provided for future maintenance.

Timber sizes shown are nominal sizes. Rough sawn timber of the dimensions shown will also be considered acceptable. Any adjustment done to the protective shield system must not change the load carrying capacity or containment specifications as indicated on the permanent protective shielding details in the plans and special provisions. Cost of adjusting shielding is included in the cost of Protective Shield (Permanent).

It shall be the Contractor's responsibility to verify the location of all utilities prior to the start of construction. Contractor must complete work without disturbing any existing lighting and surveillance conduit or junction boxes. If installations are damaged in the process, Contractor shall repair or replace existing electrical installations in compliance with electrical or surveillance construction specifications.

The minimum Fb and Fv values shown are the tabulated design values given in the National Design Specification for Wood Construction for No. 2 Spruce-Pine-Fir without adjustment factors applied. Better grades or other species with equal or higher allowable stresses will also be considered acceptable.

The timber spacings shown have been determined using allowable stresses with all adjustment factors necessary for the anticipated service conditions.

All timber shall be treated.

Plywood shall be \(\frac{1}{8} \)" Exterior type plywood.

Plywood shall be placed such that the face grain is perpendicular to the timber supports. When less than a full sheet (4' width) of plywood is used, the width of the strip used shall not be less than 2'.


Transverse plywood joints shall be supported by timbers.


When 4" x 6" timbers are used, they shall be placed such that the wide face is horizontal and the narrow face is vertical.

Design load = 200 psf.




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RAMP CLOSURE ADVANCE INFORMATION SIGN

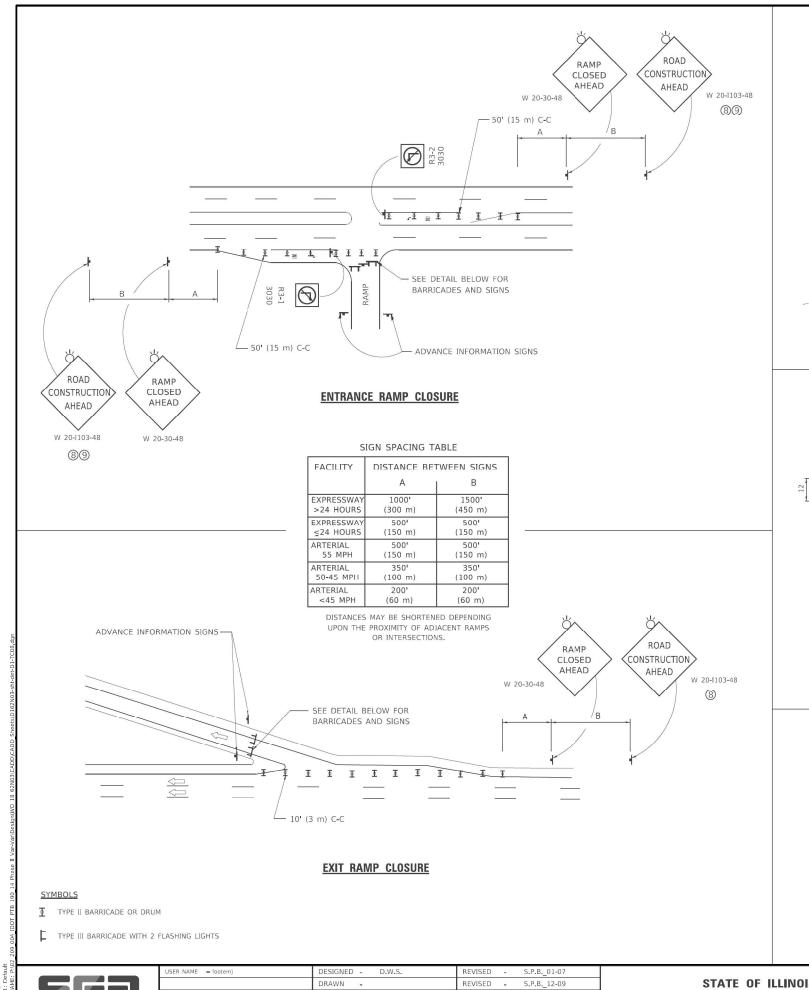
RAMP CLOSURE ADVANCE WARNING SIGN

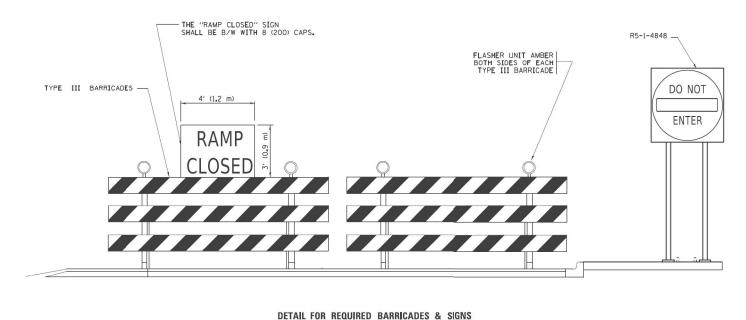

BLACK LEGEND ON ORANGE

BACKGROUND MOUNTED DIAGONALLY E MOD FONT 1 (25) BORDER

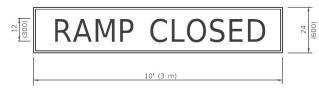THESE SIGNS ARE REQUIRED ON ALL THE EXIT GUIDE SIGNS FOR EXIT RAMPS THAT WILL BE CLOSED FOR MORE THAN FOUR (4) CONSECUTIVE DAYS

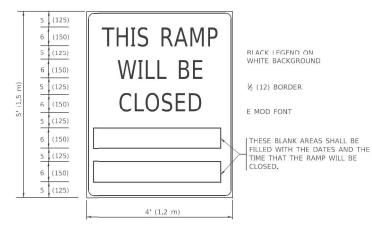

THESE SIGNS ARE REQUIRED ON BOTH SIDES OF THE RAMP, MINIMUM OF 1 WEEK IN ADVANCE OF THE CLOSURE.

THESE SIGNS SHALL BE FABRICATED AND PAID FOR ACCORDING TO THE TEMPORARY INFORMATION SIGNING SPECIAL PROVISION

GENERAL NOTES:

- CONES MAY BE SUBSTITUTED FOR DRUMS OR TYPE II 1 BARRICADES DURING DAY OPERATIONS. CONES SHALL BE A MINIMUM OF 28 (700) HIGH.
- (2) VERTICAL BARRICADES SHALL NOT BE USED FOR RAMP CLOSURES.
- A FLAGGER SHALL BE POSITIONED AT EACH CLOSED RAMP THAT
 IS OPEN TO CONSTRUCTION VEHICLES, PRECEEDED
 NO. 2 FLAGGER SHAND PROPERTY. BY A W20-7 FLAGGER WARNING SIGN.
- ALL ROUTE MARKERS AND TRAILBLAZER ASSEMBLIES WHICH DIRECT MOTORISTS TO A CLOSED ENTRANCE RAMP SHALL BE COVERED WHEN THE RAMP IS CLOSED FOR MORE THAN FOUR (4) DAYS.
- 5 THE SIGNING AND BARRICADING WHICH IS REQUIRED BY THIS DETAIL SHALL BE INCLUDED IN THE COST OF TRAFFIC CONTROL AND PROTECTION (EXPRESSWAYS).

SCALE: NONE

- 6 AUTHORIZATION FROM THE DISTRICT'S BUREAU OF TRAFFIC IS REQUIRED FOR ALL RAMP CLOSURES.
- THE RAMP CLOSURE ADVANCE INFORMATION SIGNS SHALL BE ERECTED IF THE CLOSURE TIME EXCEEDS TWENTY-FOUR (24) HOURS. ADDITIONAL ADVANCE WARNING SIGNS ON EXIT GUIDE SIGNING WILL BE REQUIRED FOR EXIT RAMP CLOSURES THAT EXCEED FOUR (4) DAYS IN LENGTH
- 8 ROAD CONSTRUCTION AHEAD SIGNS MAY BE OMITTED WHEN THIS DETAIL IS USED IN CONJUNCTION WITH OTHER TRAFFIC CONTROL THAT ALREADY INCLUDES A ROAD CONSTRUCTION AHEAD SIGN.
- ARTERIAL ROAD CONSTRUCTION AHEAD SIGNS SHALL BE INSTALLED
 ON THE LEFT SIDE OF TRAFFIC IF THE MEDIAN IS MORE THAN 10 FT WIDE.

ALL DIMENSIONS ARE IN INCHES (MILLIMETERS)
UNLESS OTHERWISE SHOWN.





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	DRAWN -	REVISED	÷	S.P.B12-09
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PLOT DATE = 3/4/2019	DATE - 02-83	REVISED	ŭ.	M.D. 01-18

STATE OF ILLINOIS **DEPARTMENT OF TRANSPORTATION**

ENTRANCE_AND_EXIT_RAMP **CLOSURE DETAILS** SHEET 1

SECTION COUNTY 290 2020-233-BR COOK 40 27 TC-08 CONTRACT NO. 62N03

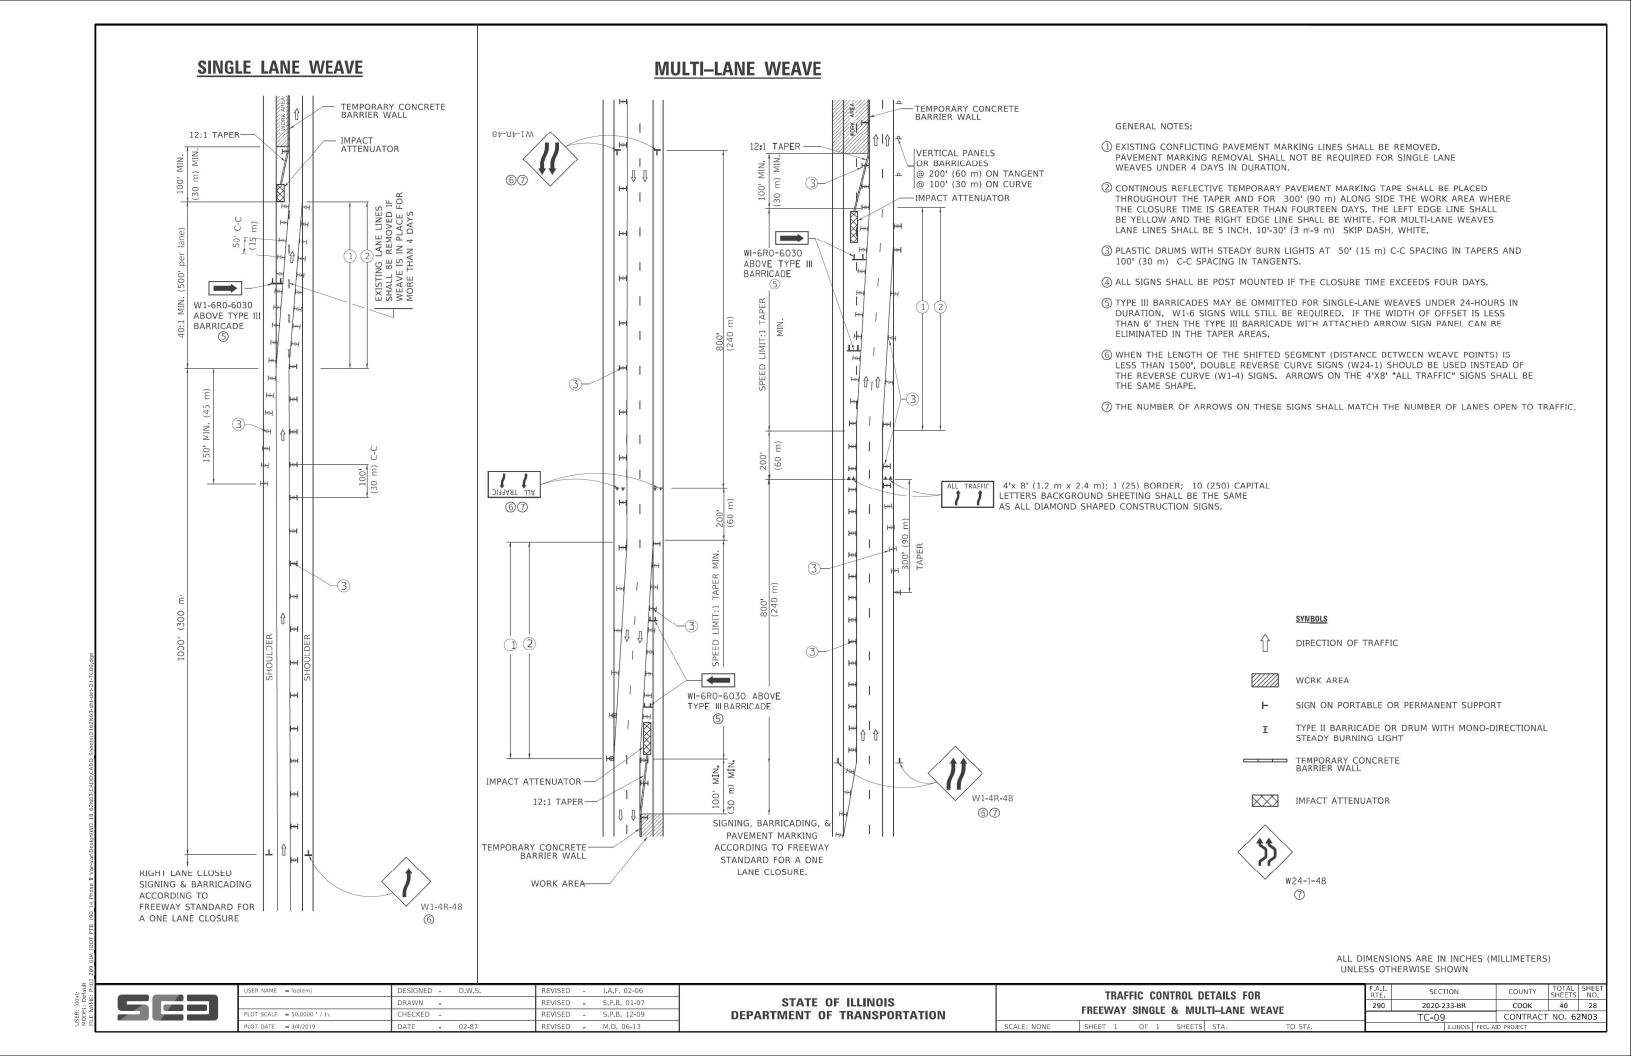

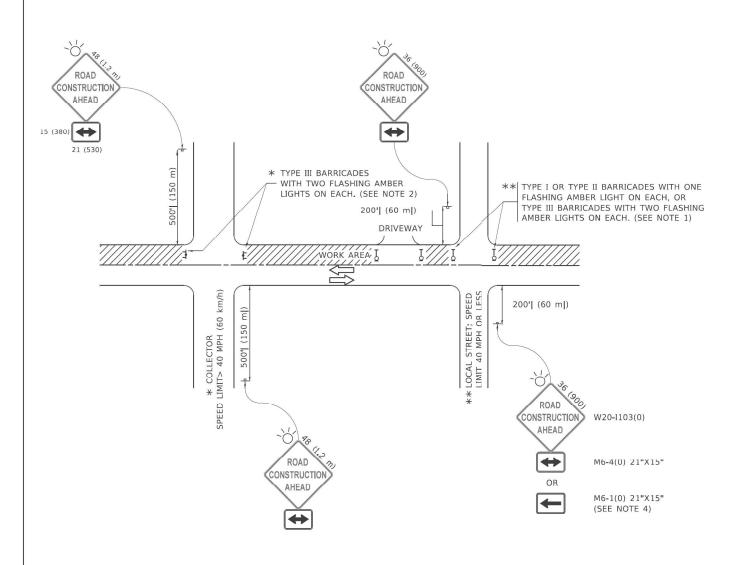

NOTES:

- 1. SIDE ROAD WITH A SPEED LIMIT OF 40 MPH (60 km/h) OR LESS AS SHOWN ON THE DRAWING AND AS DIRECTED BY THE ENGINEER:
- a) ONE "ROAD CONSTRUCTION AHEAD" SIGN 36 x 36 (900x900) WITH A FLASHER MOUNTED ON IT APPROXIMATELY 200' (60 m) IN ADVANCE OF THE MAIN ROUTE.
- b) THE CLOSED PORTION OF THE MAIN ROUTE SHALL BE PROTECTED BY BLOCKING WITH TYPE I, TYPE II OR TYPE III BARRICADES, 1/3 OF THE CROSS SECTION OF THE CLOSED PORTION.
- SIDE ROAD WITH A SPEED LIMIT GREATER THAN 40 MPH (60 km/h) AS SHOWN ON THE DRAWING AND AS DIRECTED BY THE ENGINEER;
- a) ONE "ROAD CONSTRUCTION AHEAD" SIGN 48 x 48 (1.2 m x 1.2 m) WITH A FLASHER MOUNTED ON IT APPROXIMATELY 500' (150 m) IN ADVANCE OF THE MAIN ROUTE.
- THE CLOSED PORTION OF THE MAIN ROUTE SHALL BE PROTECTED BY
 b) BLOCKING WITH TYPE III BARRICADES, 1/2 OF THE CROSS SECTION
 OF THE CLOSED PORTION.
- 3. CONES MAY BE SUBSTITUTED FOR BARRICADES OR DRUMS AT HALF THE SPACING DURING DAY OPERATIONS. CONES SHALL BE A MINIMUM OF 28 (710)
- WHEN THE SIDE ROAD LIES BETWEEN THE BEGINNING OF THE MAINLINE
 4. SIGNING AND THE WORK ZONE, A SINGLE HEADED ARROW (M6-1) SHALL
 BE USED IN LIEU OF THE DOUBLE HEADED ARROW (M6-4).

- 5. WHEN WORK IS BEING PERFORMED ON A SIDE ROAD OR DRIVEWAY, FOLLOW THE APPLICABLE STANDARD(S). THE DIRECTIONAL ARROW (M6-1 OR M6-4) SHALL BE COVERED OR REMOVED WHEN NO LONGER CONSISTENT WITH THE TRAFFIC CONTROL SET-UP.
- 6. ADVANCE WARNING SIGNS ARE TO BE OMITTED ON DRIVEWAYS UNLESS OTHERWISE SPECIFIED IN THE PLANS OR BY THE ENGINEER
- THE TRAFFIC CONTROL AND PROTECTION FOR SIDE ROADS, INTERSECTIONS, AND DRIVEWAYS SHALL BE INCLUDED IN THE COST OF SPECIFIED TRAFFIC CONTROL STANDARDS OR ITEMS.

All dimensions are in inches (millimeters) unless otherwise shown.




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PLOT DATE = 3/4/2019	DATE - 06-89	REVISED _ A. SCHUETZE 09-15-16

STATE OF ILLINOIS
DEPARTMENT OF TRANSPORTATION

	TRAFF	IC	CONT	ROL	AND	PROTEC	TION	FOR
SI	DE RO	ΑD	S, INTI	ERS	ECTION	IS, AND	DRIV	EWAYS
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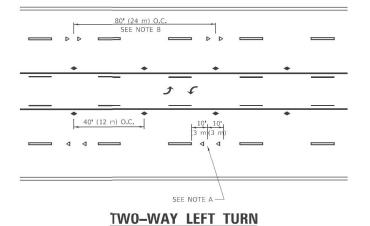
.I.	SECTION		COUNTY	TOTAL SHEETS	SHEET NO.
90	2020-233-BR		соок	40	29
	TC-10		CONTRACT	NO. 62	2N03
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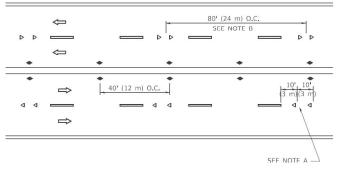
*** REDUCE TO 40' (12 m) O.C. ON CURVES WITH POSTED OR ADVISORY SPEED 45 M.P.H. (70 km/h) OR LESS.

3 @ 40' (12 m) O.C. \bigcirc \Rightarrow LANE REDUCTION TRANSITION

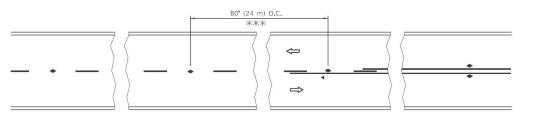SEE FIGURE 3B-14 MUTCD



TW0-LANE/TW0-WAY







80' (24 m) O.C. SEE NOTE B \Rightarrow SEE NOTE A

MULTI-LANE/UNDIVIDED



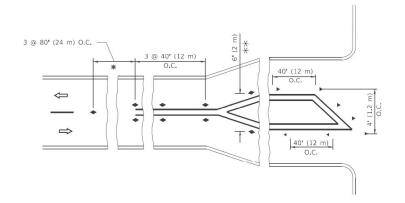

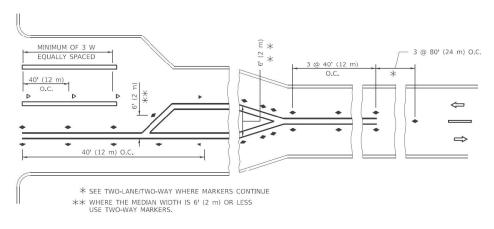

TURN LANES

GENERAL NOTES

- 1. MARKERS USED WITH DASHED LINES SHALL BE
- 2. MARKERS USED ADJACENT TO SOLID LINES SHALL BE OFFSET 2 TO 3 (50 TO 75) TOWARD TRAFFIC AS SHOWN.
- 3. MARKERS THROUGH TANGENTS LESS THAN 500' (150 m) IN LENGTH BETWEEN CURVES SHALL BE INSTAL_ED AT THE
- 4. MARKERS ARE TO BE USED ADJACENT TO BCTH SOLID

LANE MARKER NOTES

- A. USE DOUBLE LANE LINE MARKERS SPACED AS SHOWN.
- B. REDUCE TO 40' (12 m) O.C. ON CURVES WHERE ADVISORY SPEEDS ARE 10 M.P.H (20 km/h) LOWER THAN POSTED SPEEDS.

- 1. DOUBLE LANE LINE MARKERS SHALL BE USED UNLESS SPECIFIED OTHERWISE.
- RAMP DETAIL, MARKERS ARE NOT TO BE SPECIFIED ON RIGHT EDGE LINES.
- INVOLVED.

All dimensions are in inches (millimeters) unless otherwise shown.



REVISED - T. RAMMACHER 03-12-99 DESIGNED -DRAWN -REVISED -T. RAMMACHER 01-06-00 REVISED - C. JUCIUS 09-09-09 OT SCALE = 50.0000 ' / in. CHECKED -

STATE OF ILLINOIS **DEPARTMENT OF TRANSPORTATION**

TYPICAL APPLICATIONS RAISED REFLECTIVE PAVEMENT MARKERS (SNOW-PLOW RESISTANT)

SECTION 290 2020-233-BR COOK 40 30 TC-11 CONTRACT NO. 62N03

SYMBOLS

ONE-WAY AMBER MARKER

TWO-WAY AMBER MARKER

■ ONE-WAY CRYSTAL MARKER (W/O)

- YELLOW STRIPE


WHITE STRIPE


DESIGN NOTES


2. EXCEPT AS SHOWN ON THE LANE REDUCTION TRANSITION AND FREEWAY EXIT


3. THE EXACT MARKER LIMITS, SPACING, AND COLOR SHALL BE INCLUDED IN THE PLANS WHEN STANDARD SPECIFICATIONS ARE NOT BEING USED.


4. MARKERS SHOULD NOT BE USED ALONGSIDE CURBS EXCEPT FOR EXTREMELY

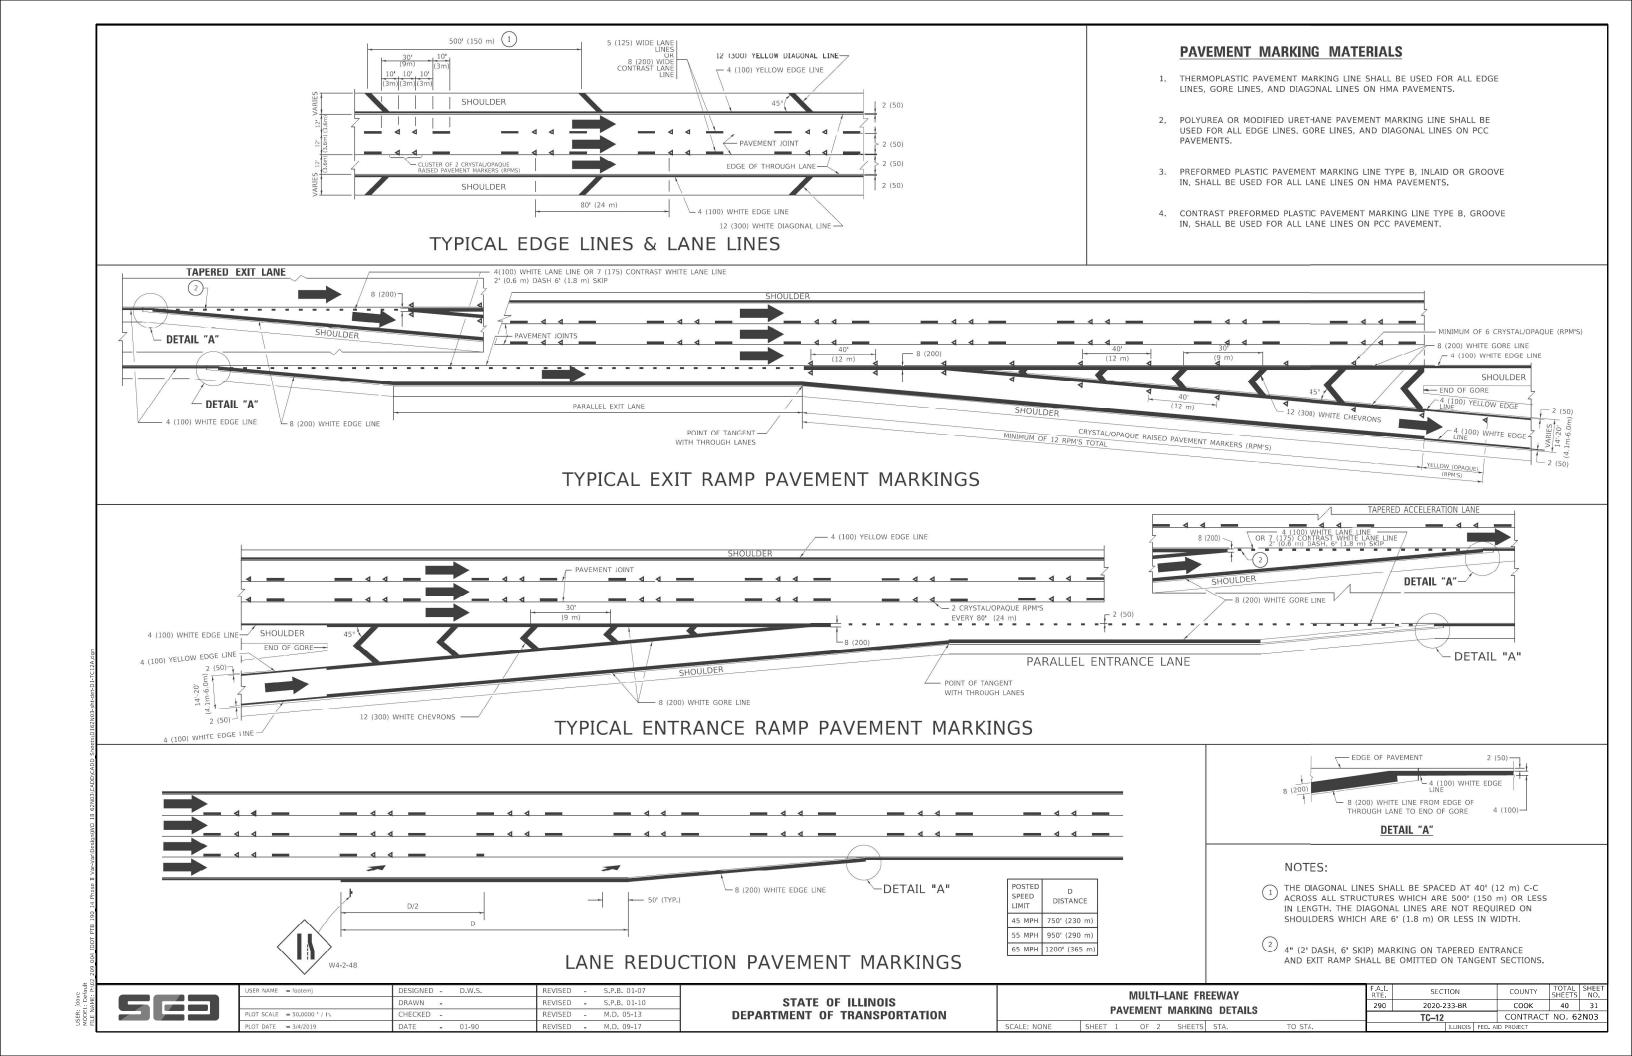

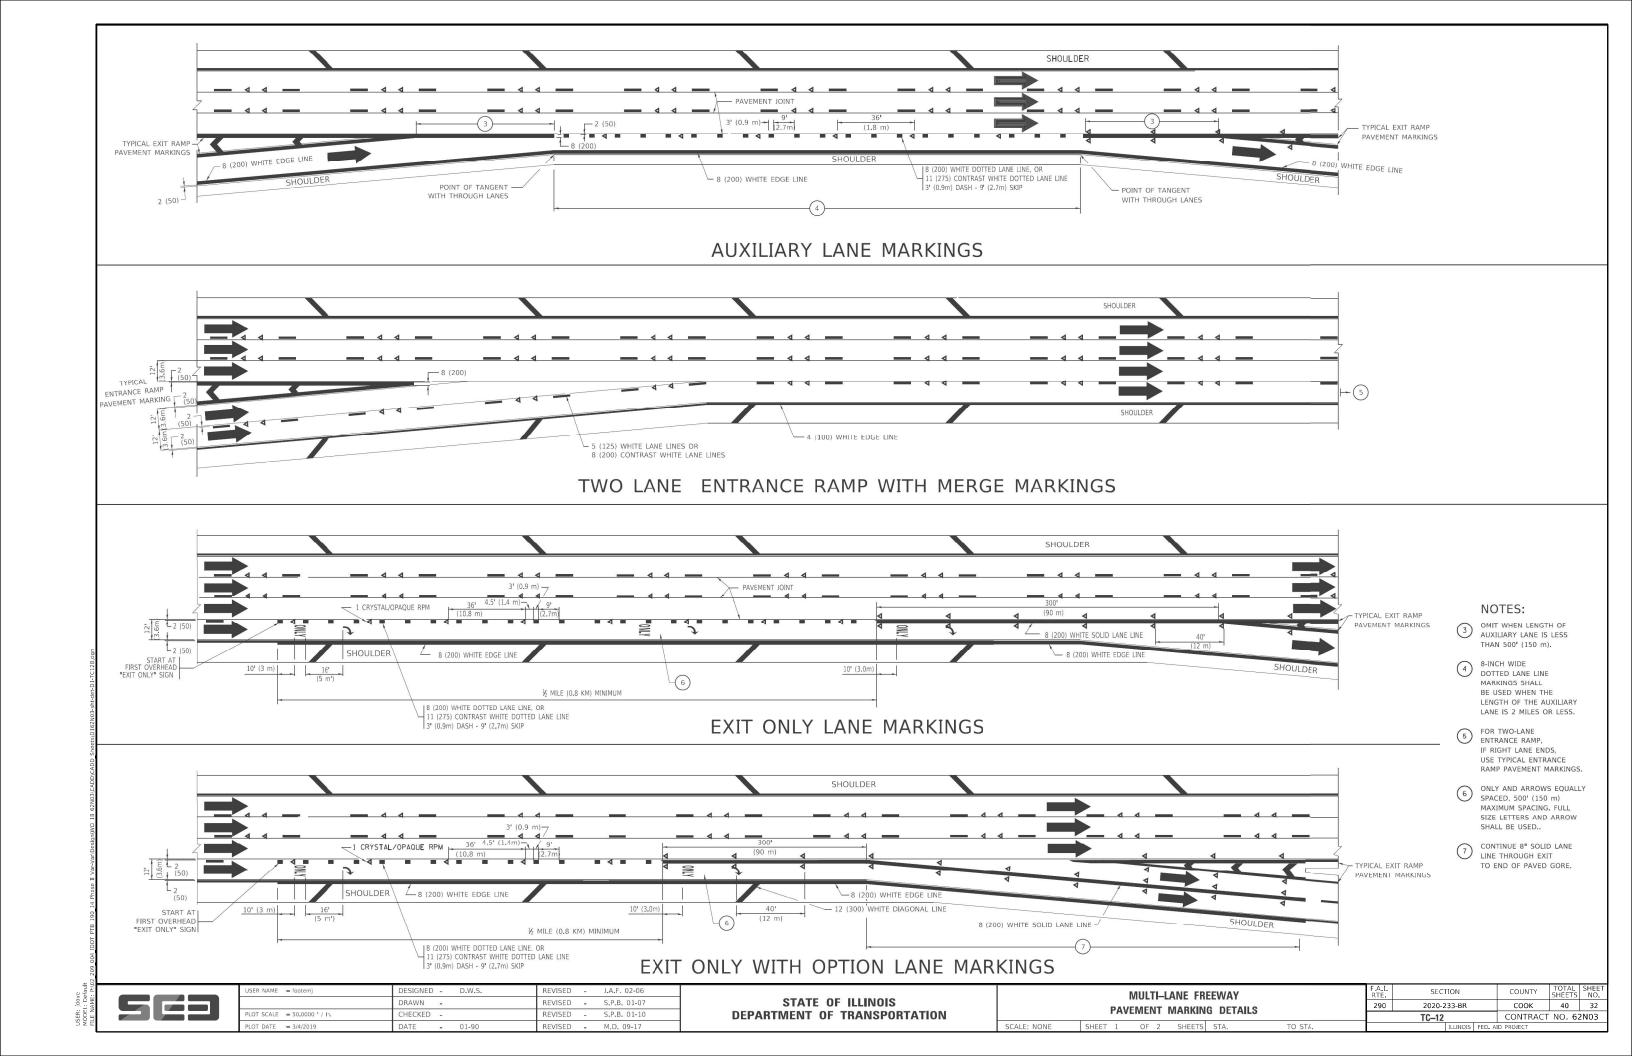

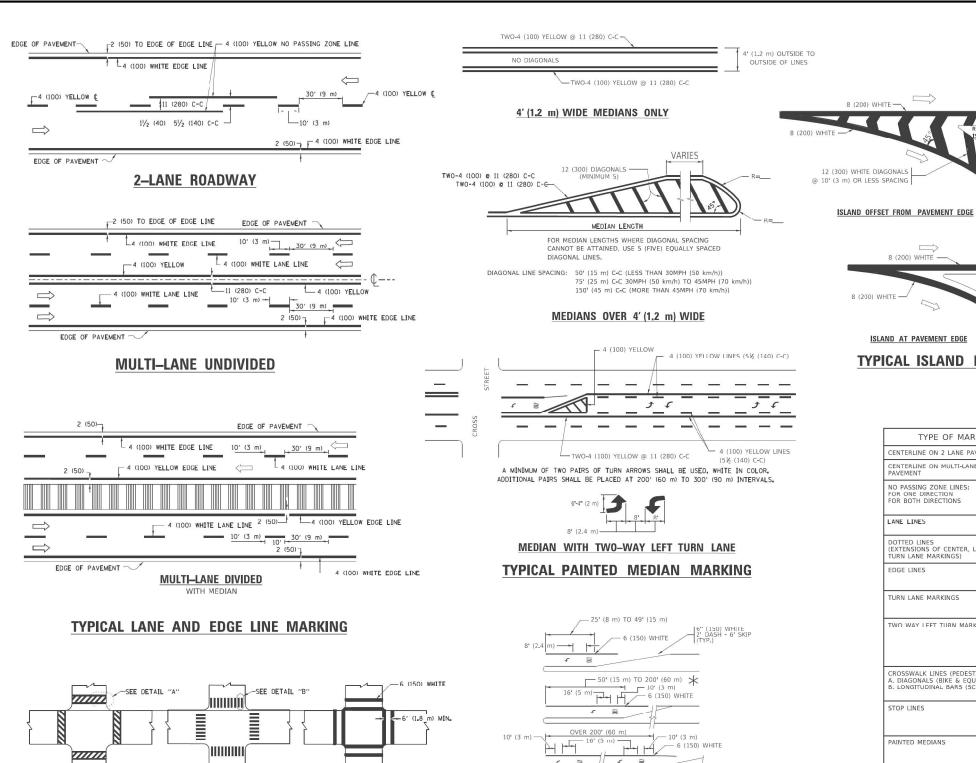

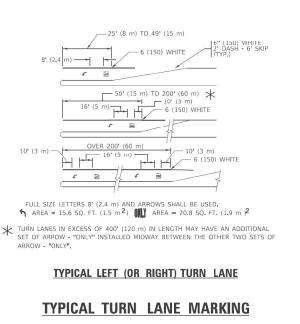

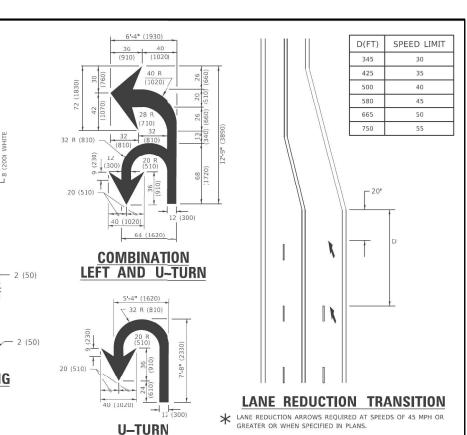

TYPE OF MARKING	WIDTH OF LINE	PATTERN	COLOR	SPACING / REMARKS
CENTERLINE ON 2 LANE PAVEMENT	4 (100)	SKIP-DASH	YELLOW	10' (3 m) LINE WITH 30' (9 m) SPACE
CENTERLINE ON MULTI-LANE UNDIVIDED PAVEMENT	2 @ 4 (100)	SOLID	YELLOW	11 (280) C-C
NO PASSING ZONE LINES: FOR ONE DIRECTION FOR BOTH DIRECTIONS	4 (100) 2 @ 4 (100)	SOLID SOLID	YELLOW YELLOW	5½ (140) C-C FROM SKIP-DASH CENTERLINE 11 (280) C-C OMIT SKIP-DASH CENTERLINE BETWEEN
LANE LINES	4 (100) 5 (125) ON FREEWAYS	SKIP-DASH SKIP-DASH	WHITE WHITE	10' (3 m) LINE WITH 30' (9 m) SPACE
DOTTED LINES (EXTENSIONS OF CENTER, LANE OR TURN LANE MARKINGS)	SAME AS LINE BEING EXTENDED	SKIP-DASH	SAME AS LINE BEING EXTENDED	2' (600) LINE WITH 6' (1,8 m) SPACE
EDGE LINES	4 (100)	SOLID	YELLOW-LEFT WHITE-RIGHT	OUTLINE MEDIANS IN YELLOW
TURN LANE MARKINGS	6 (150) LINE: FULL SIZE LETTERS & SYMBOLS (8' (2.4m))	SOLID	WHITE	SEE TYPICAL TURN LANE MARKING DETAIL
TWO WAY I FFT THRN MARKING	2 @ 4 (100) EACH DIRECTION 8* (2.4m) LEFT ARROW	SKIP-DASH AND SOLID IN PAIRS	YFII OW WHITE	10' (3 m) LINE WITH 30' (9 m) SPACE FOR SKIP-DASH; 5½ (140) C-C BETWEEN SOLID LINE AND SKIP-DASH LINE SEE TYPICAL TWO-WAY LEFT TURN MARKING DETAIL
CROSSWALK LINES (PEDESTRIAN) A. DIAGONALS (BIKE & EQUESTRIAN) B. LONGITUDINAL BARS (SCHOOL)	2 @ 6 (150) 12 (300) @ 45° 12 (300) @ 90°	SOLID SOLID SOLID	WHITE WHITE WHITE	NOT LESS THAN 6' (1.8 m) APART 2' (600) APART 2' (600) APART 5EE TYPICAL CROSSWALK MARKING DETAILS.
STOP LINES	24 (600)	SOLID	WHITE	PLACE 4" (1.2 m) IN ADVANCE OF AND PARALLEL TO CROSSWALK; IF PRESENT: OTHERWISE, PLACE AT DESIRED STOPPING POINT, PARALLEL TO CROSSROAD CENTERLINE, WHERE POSSIBLE
PAINTED MEDIANS	2 @ 4 (100) WITH 12 (300) DIAGONALS @ 45° NO DIAGONALS USED FOR 4* (1.2 m) WIDE MEDIANS	SOLID	YELLOW: TWO WAY TRAFFIC WHITE: ONE WAY TRAFFIC	11 (280) C-C FOR THE DOUBLE LINE SEE TYPICAL PAINTED MEDIAN MARKING.
GORE MARKING AND CHANNELIZING LINES	8 (200) WITH 12 (300) DIAGONALS @ 45°	SOLID	WHITE	DIAGONALS: 15' (4.5 m) C-C (LESS 1HAN 30MPH (50 km/h)) 20' (6 m) C-C 30MPH (50 km/h) TO 45MPH (70 km/h)) 30' (9 m) C-C (OVER 45MPH (70 km/h))
RAILROAD CROSSING	24 (600) TRANSVERSE LINES; "RR" IS 6' (1.8 m) LETTERS; 16 (400) LINE FOR "X"	SOLID	WHITE	SEE STATE STANDARD 780001 AREA OF: "R"=3.6 SQ, FT. (0.33 m /2EACH "X"=54.0 SQ, FT. (5.0 m /2
SHOULDER DIAGONALS (REQUIRED FOR SHOULDERS > 8')	12 (300) @ 45°	SOLID	WHITE - RIGHT YELLOW - LEFT	50' (15 m) C-C (LESS THAN 30MPH (50 km/h)) 75' (25 m) C-C (30 MPH (50 km/h) TO 45MPH (70 km/h)) 150' (45 m) C-C (OVER 45MPH (70 km/h))
U TURN ARROW	SEE DETAIL	SOLID	WHITE	16.3 SF
2 ARROW COMBINATION LEFT AND U TURN	SEE DETAIL	SOLID	WHITE	30.4 SF

WIDTH OF LINE PATTERN

FOR FURTHER DETAILS ON PAVEMENT MARKING REFER TO STANDARD SPECIFICATIONS FOR ROAD AND BRIDGE CONSTRUCTION AND STATE STANDARD 780001.

8 (200) WHITE -

ISLAND AT PAVEMENT EDGE

TYPICAL ISLAND MARKING

TYPE OF MARKING

8 (200) WHITE -

RAISED

All dimensions are in inches (millimeters) unless otherwise shown.

SPACING / REMARKS



BICYCLE & EQUESTRIAN

EVERS DESIGNED -C. JUCIUS 09-09-09 DRAWN REVISED - C. JUCIUS 07-01-13 CHECKED REVISED - C. JUCIUS 12-21-15 OT SCALE = 50.0000 ' / in.

PEDESTRIAN

SCHOOL

-6 (150) WHITE

TYPICAL CROSSWALK MARKING

* MARKINGS SHALL BE INSTALLED PARALLEL TO THE CENTERLINE OF THE ROAD WHICH IT CROSSES

DETAIL "A"

2' (600)


DETAIL "B"

-12 (300) WHITE

STATE OF ILLINOIS **DEPARTMENT OF TRANSPORTATION**

SECTION DISTRICT ONE 290 2020-233-BR COOK 40 33 TYPICAL PAVEMENT MARKINGS TC-13 CONTRACT NO. 62N03


TURN BAY ENTRANCE AT START OF LANE CLOSURE TAPER

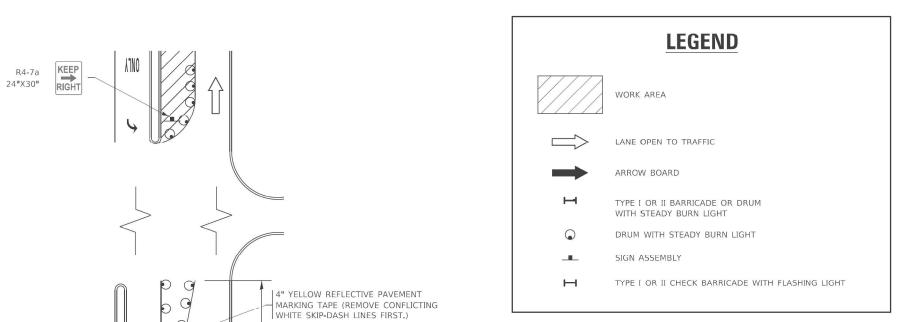

NOTES:

- 1, A) WHEN "L" IS ≤ THE STORAGE LENGTH OF THE TURN LANE (AS SHOWN IN FIG. 1), USE FIGURE 1.
 - B) WHEN "L" IS > THE STORAGE LENGTH OF THE TURN LANE OR THE TURN LANE IS WITHIN THE LANE CLOSURE, USE FIGURE 2,
- 2. CONES MAY BE SUBSTITUTED FOR BARRICADES OR DRUMS AT HALF THE SPACING DURING DAY OPERATIONS, CONES SHALL BE A MINIMUM OF 28 (710) IN HEIGHT,
- 3. LIGHTS WILL NOT BE REQUIRED ON BARRICADES OR DRUMS FOR DAY OPERATIONS. ALL LIGHTS SHALL BE MONODIRECTIONAL.
- 4. REFLECTIVE TEMPORARY PAVEMENT MARKINGS SHALL BE PLACED THROUGHOUT THE BARRICADED AREAS OF EACH TURN BAY AS SHOWN WHERE THE CLOSURE TIME IS GREATER THAN FOURTEEN (14) DAYS.
- 5. THIS APPLICATION ALSO APPLIES WHEN WORK IS BEING PERFORMED IN THE RIGHT LANE(S) AND THE RIGHT TURN BAY IS TO REMAIN OPEN. UNDER THIS CONDITION, "RIGHT TURN LANE" R3-I100R 24 x 24 (600 x 600) AND M6-2R 21 x 15 (530 x 380) SHALL BE USED.
- 6. THESE CONTROLS SHALL SUPPLEMENT MAINLINE TRAFFIC CONTROL FOR LANE CLOSURES.
- 7. THE SIGNS SHALL BE MOUNTED ABOVE THE BARRICADES/DRUMS ON SEPARATE SIGN SUPPORTS THAT MEET NCHRP 350 OR MASH PREOUIREMENTS.
- 8. TRAFFIC CONTROL AND PROTECTION AT TURN BAYS (TO REMAIN OPEN TO TRAFFIC) SHALL BE INCLUDED IN THE COST OF SPECIFIED TRAFFIC CONTROL STANDARDS OR ITEMS.

TURN BAY ENTRANCE WITHIN A LANE CLOSURE

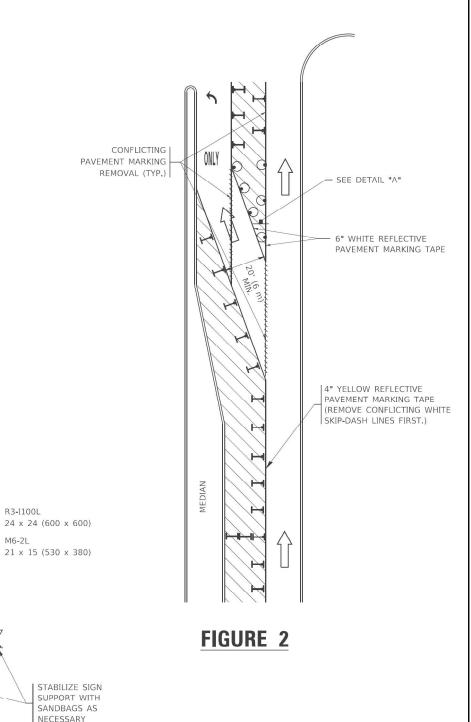

DETAIL A

TURN

LANE

All dimensions are in inches (millimeters) unless otherwise shown.



SEE DETAIL "A" -

USER NAME = footemj	DESIGNED	- T.	RAMMACHER 09-08-94	REVISED	-	R. BORO 09-14-09
	DRAWN		A. HOUSEH 11-07-95	REVISED	£ .	A. SCHUETZE 07-01-13
PLOT SCALE = 50.0000 ' / in.	CHECKED		A. HOUSEH 10-12-96	REVISED	- 1	A. SCHUETZE 09-15-16
PLOT DATE = 3/4/2019	DATE	-Τ.	RAMMACHER 01-06-00	REVISED	ĕ	


FIGURE 1

- ARROW BOARD

STATE OF ILLINOIS **DEPARTMENT OF TRANSPORTATION**


TRAFF						TION AT	TURN BAYS
SCALE: NONE	SHEET	1	OF	1	SHEETS	STA.	TO STA.

F.A.I. RTE	SECTION	COUNTY	TOTAL SHEETS	SHEET NO.	
290	2020-233-BR	соок	40	34	
	TC-14		CONTRACT	NO. 62	2N03
	TILLINOIS	FFD. A	ID PROJECT		

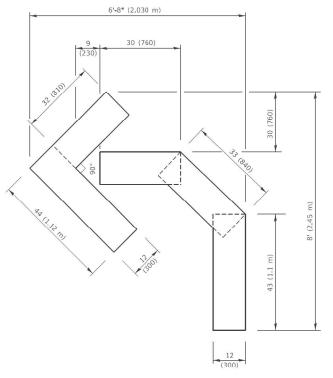


QUANTITY

4 (100) LINE = 45.5 ft. (13.9 m) 15.2 sq. ft. (1.41 sq. m)

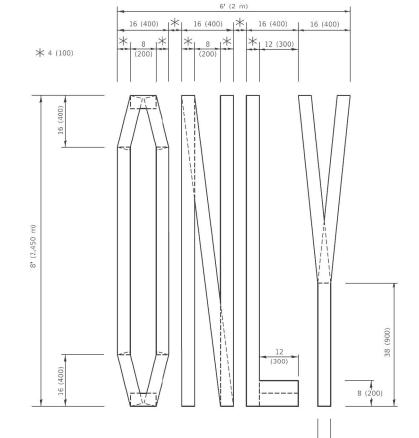

4 (100) LINE = 64.1 ft. (19.5 m) 21.4 sq. ft. (1.99 sq. m)

QUANTITY

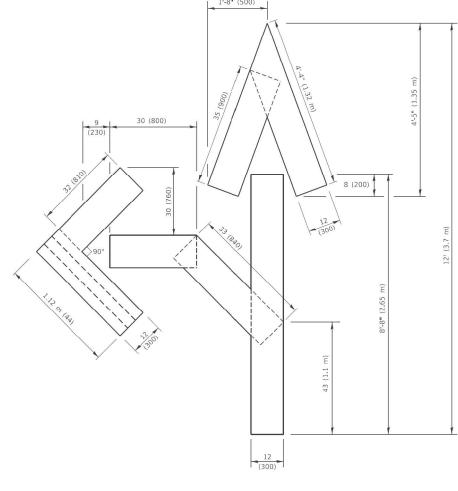


QUANTITY

4 (100) LINE = 82.5 ft. (25.1 m) 27.5 sq. ft. (2.53 sq. m)

NOTE:

ALL QUANTITIES OF PLACEMENT ARE REPRESENTED IN LINEAR FEET OF 4" LINES TO MATCH THE 4" TEMPORARY TAPE PAY ITEM AND REPRESENTS THE TOTAL QUANTITY OF 4" TAPE REQUIRED.

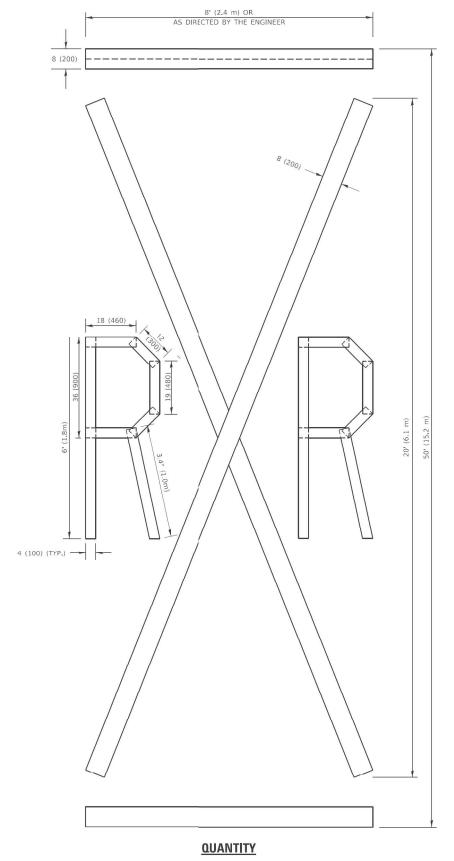

4 (100) LINE = 225.9 ft. (68.9 m) 75.3 sq. ft. (6.99 sq. m)

All dimensions are in inches (millimeters) unless otherwise shown.





USER NAME = footemj	DESIGNED -	REVISED - T. RAMMACHER 03-02-98
	DRAWN -	REVISED - E. GOMEZ 08-28-00
PLOT SCALE = 50.0068 ' / in.	CHECKED -	REVISED - E. GOMEZ 08-28-00
PLOT DATE = 3/4/2019	DATE - 09-18-94	REVISED - A. SCHUETZE 09-15-16


STATE OF ILLINOIS
DEPARTMENT OF TRANSPORTATION

	SHORT	TERM	PAV	EMENT	Γ	MARKING	LETTERS	AND	SYMBOLS	
SCALE:	NONE	SHEE	T 1	OF	1	SHEETS	STA.		TO STA.	

A.I.	SECT	ПОИ	COUNTY	TOTAL SHEETS	SHEET NO.	
290	2020-2	33-BR		соок	40	35
	TC-16		CONTRACT	NO. 62	2N03	
		TELIMOTS	EED A	ID DROJECT		

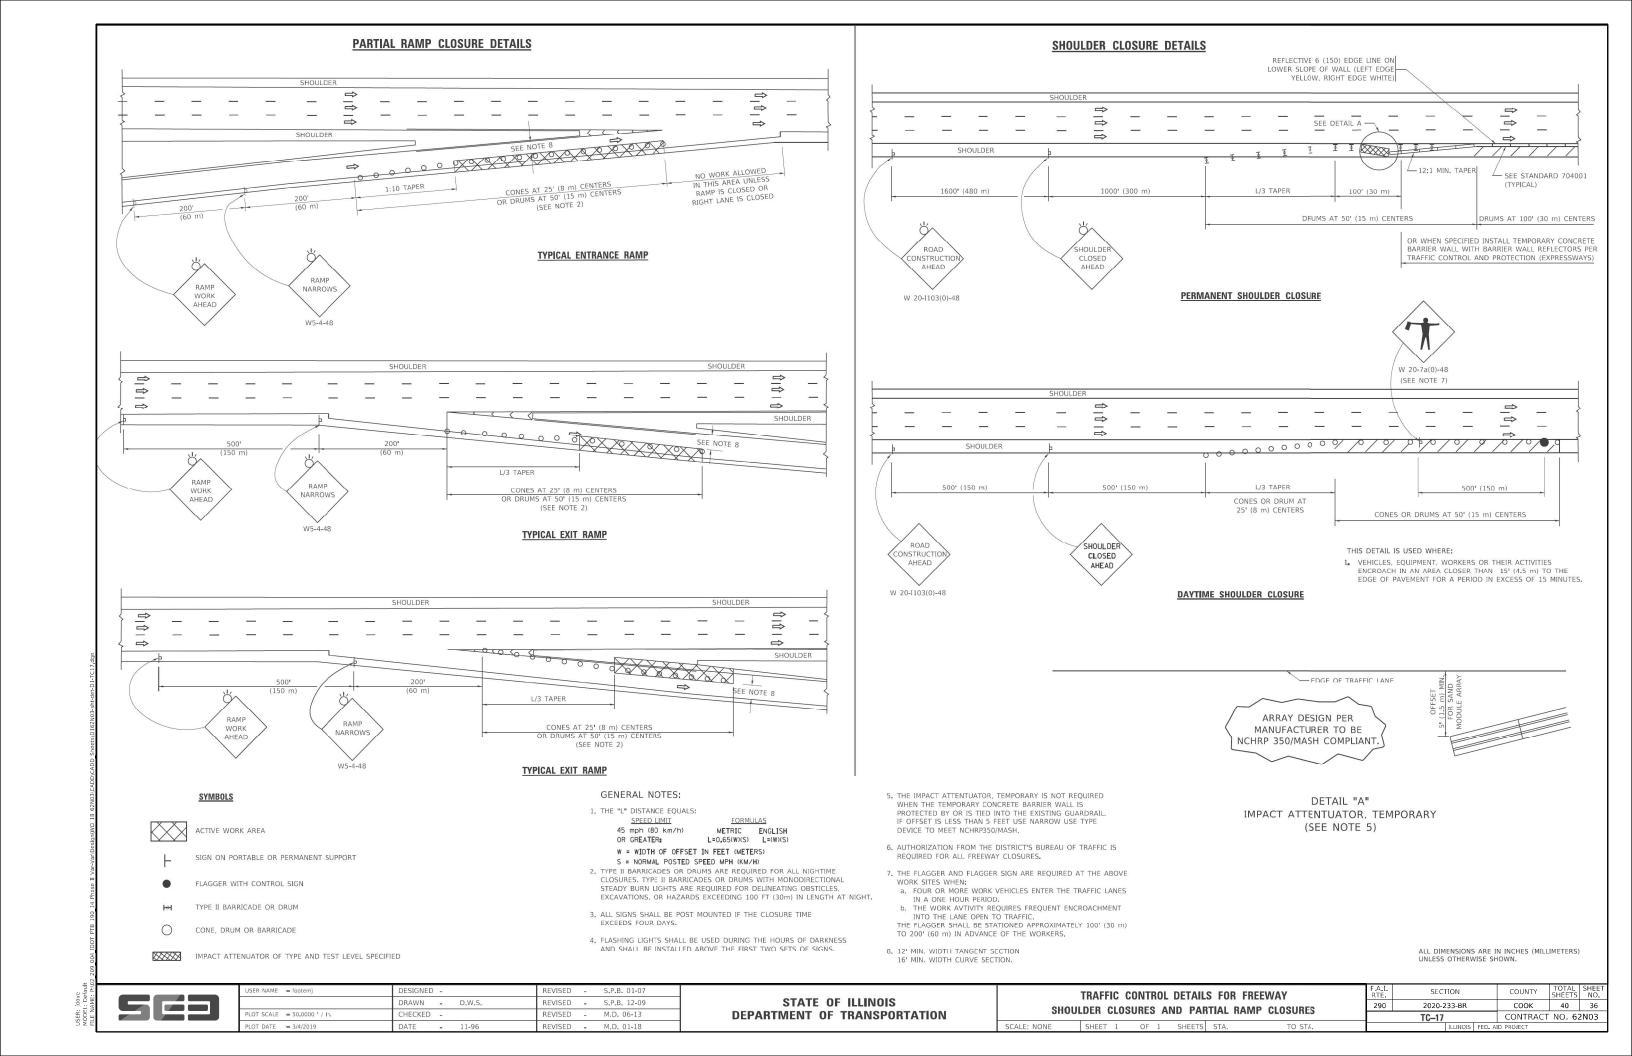

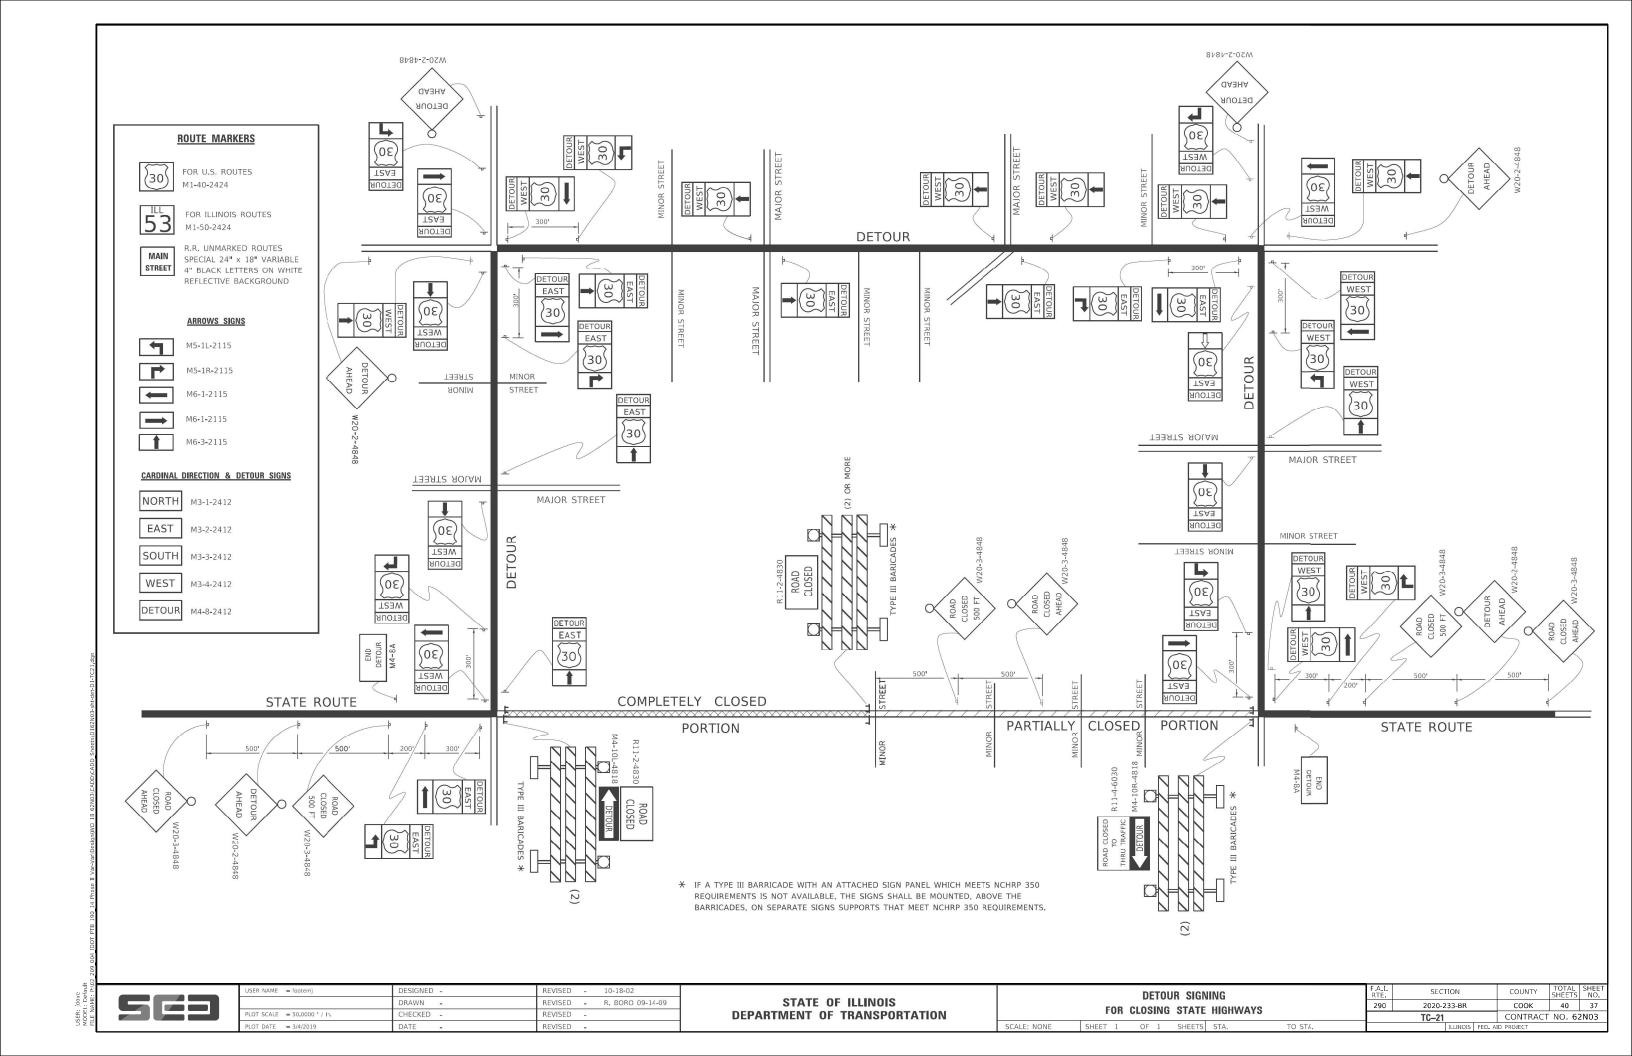

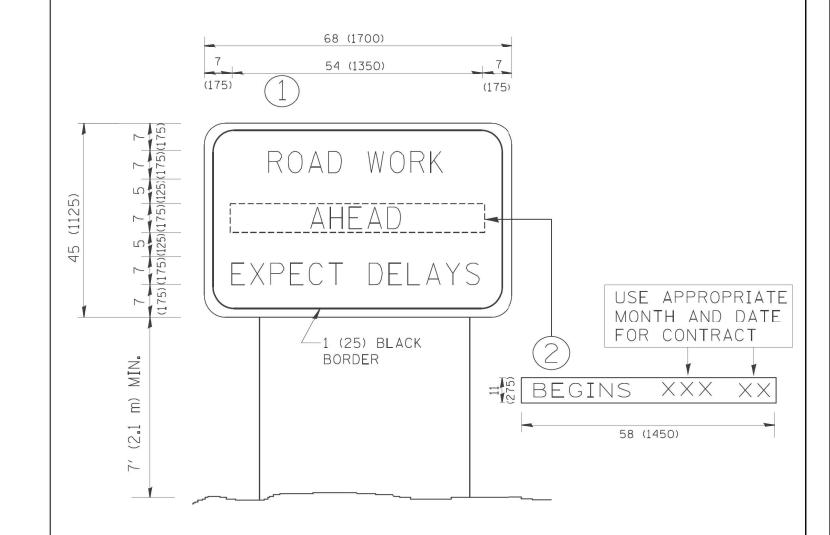

NOTES:

1. USE BLACK LETTERING ON ORANGE BACKGROUND.

SCALE: NONE

- 2. ERECT SIGNS IN ADVANCE OF THE LOCATION FOR THE "ROAD CONSTRUCTION AHEAD" SIGN AT LOCATIONS AS DIRECTED BY THE ENGINEER.
- 3. ERECT SIGN (1) WITH INSTALLED PANEL (2) ONE WEEK PRIOR TO THE START OF CONSTRUCTION.
- 4. REMOVE PANEL (2) SOON AFTER THE START OF CONSTRUCTION.
- 5. SEE SPECIAL PROVISION FOR "TEMPORARY INFORMATION SIGNING" FOR ADDITIONAL INFORMATION.
- 6. ONE SIGN ASSEMBLY EQUALS 25.70 SQ. FT. (2.3 SQ. M.)
- 7. SHALL BE PAID FOR AS TEMPORARY INFORMATION SIGNING.

ALL DIMENSIONS ARE IN INCHES (MILLIMETERS) UNLESS OTHERWISE SHOWN.



USER NAME = gaglianobt	DESIGNED -	REVISED	27	R. MIRS 09-15-97
	DRAWN -	REVISED	-	R. MIRS 12-11-97
PLOT SCALE = 50.000 '/ IN.	CHECKED -	REVISED	- T.	RAMMACHER 02-02-99
PLOT DATE = 1/4/2008	DATE -	REVISED		C. JUCIUS 01-31-07

STATE	OF	ILLINOIS
DEPARTMENT	OF T	TRANSPORTATION

ARTERIAL ROAD				SECTION
INFORMATION			290	2020-233-BR
INFORMATION		TC-22		
SHEET NO. 1 OF 1 SHEETS	STA.	TO STA.		ILLINOIS

A.I. SECTION COUNTY TOTAL SHEETS NO.
90 2020-233-BR COOK 40 38


TC-22 CONTRACT NO. 62N03


CENTER LANE CLOSURE TYPE I CHECK BARRICADES > DRUMS AT 50' (15 m) CENTERS AT 100' (30 m) CENTERS 06) ARROW BOARD DISPLAYING-DOUBLE ARROW PATTERN LANE CLOSE * W9-3a-48 SIGNING & BARRICADING ACCORDING TO FREEWAY STANDARD FOR A ONE LANE CLOSURE INSTALLATION SEQUENCE 1. CLOSE LANES 1&2 NOTES: ACTIVE WORK AREA 1. DRUMS WITH STEADY BURN LIGHTS SHALL BE USED AT 50' (15 m) CENTERS ON ALL TAPERS AND TANGENTS IN 2, ERECT INSIDE LANE 2 TAPER ADVANCE OF WORK AREA. 2. CLOSURE SHALL BE USED ONLY FOR OPERATIONS LASTING 72 HOURS OR LESS. 3. OPEN LANE 2 BY RELOCATING FIRST TAPER 3. CENTER LANE CLOSURE CONFIGURATION NON-ACTIVE IS NOT TO BE USED WITH WORKERS WORK AREA 4. REMOVE CLOSURE IN REVERSE ORDER

SHOULDER LANE

NOTE: CLOSURE SHALL BE USED ONLY FOR OPERATIONS LASTING 72 HOURS OR LESS. ONE SIGN PER 1 MILE (1.6 km) SIGN (2) SIGN 1 I I I I I I I I I 10' (3 m) MIN. \Rightarrow 1111 \Rightarrow WORK AREA └ 700' (210 m) MIN. 3 MILE (4.8 km) SIGNING AND BARRICADING (MAXIMUM) ACCORDING TO FREEWAY STANDARD FOR A TWO

LANE CLOSURE

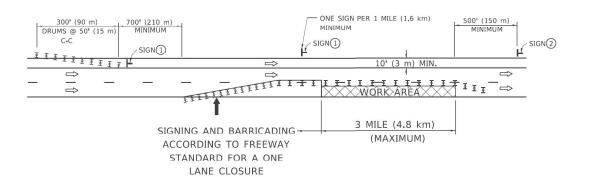

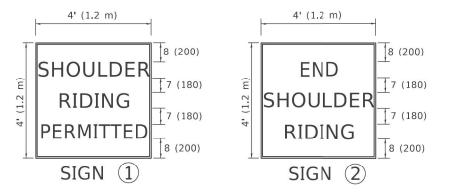

6 (150) SERIES "C" LEGEND BLACK LEGEND WHITE REFLECT. BACKGROUND 1 (25) BORDER

SYMBOLS



■ ARROWBOARD

ACTIVE WORK AREA

F SIGN ON PORTABLE OR PERMANENT SUPPORT *

TYPE II BARRICADE, OR DRUM WITH MONO-DIRECTIONAL STEADY BURN LIGHT

ALL DIMENSIONS ARE IN INCHES (MILLIMETERS) UNLESS OTHERWISE SHOWN

* ALL SIGNS SHALL BE MOUNTED AT A MINIMUM HEIGHT OF 5' (1.5 m).

 USER NAME
 = footemj
 DESIGNED
 REVISED
 J.A.F. 04-03

 DRAWN
 REVISED
 S.P.B. 01-07

 PLOT SCALE
 = 50,0000 ' / h.
 CHECKED
 REVISED
 S.P.B. 12-09

 PLOT DATE
 = 3/4/2019
 DATE
 REVISED


STATE OF ILLINOIS
DEPARTMENT OF TRANSPORTATION

TRAFFIC CONTROL DETAILS FOR FREEWAY
CENTER LANE CLOSURE SHOULDER LANE

 F.A.I. RTE.
 SECTION
 COUNTY
 TOTAL SHEETS
 SHEETS NO.

 290
 2020-233-BR
 COOK
 40
 39

 TC-25
 CONTRACT
 NO.
 62N03

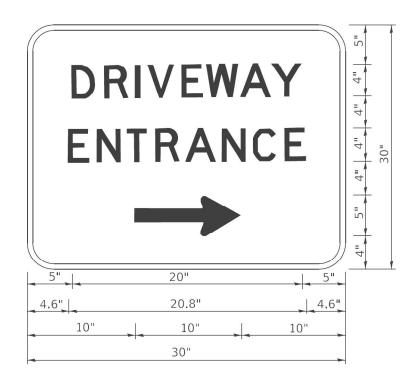

3.0" RADIUS, 0.5" BORDER, WHITE ON GREEN; REFLECTORIZED "DRIVEWAY" D; "ENTRANCE" D; STANDARD ARROW CUSTOM 12.0" x 5.0"

NOTES:

- 1. HALF OF THE SIGNS WILL REQUIRE A LEFT HAND FACING ARROW.
- 2. TWO SIGNS SHALL BE USED AT EACH COMMERCIAL ENTRANCE PLACED BACK-TO-BACK: ONE WITH A RIGHT HAND ARROW (SHOWN) SHALL BE PLACED ON THE NEAR RIGHT SIDE THE DRIVEWAY AND ONE WITH A LEFT HAND ARROW SHALL BE PLACED ON THE FAR LEFT SIDE OF THE DRIVEWAY.
- 3. SIGNS TO BE PAID FOR AS ITEM "TEMPORARY INFORMATION SIGNING".

563

USER NAME = footemj	DESIGNED -	REVISED	-	C. JUCIUS 02-15-07
	DRAWN -	REVISED	÷	
PLOT SCALE = 50.0000 ' / in.	CHECKED -	REVISED	-	
PLOT DATE = 3/4/2019	DATE -	REVISED	-	

STATE	: OF	ILLINOIS	
DEPARTMENT	OF	TRANSPO	RTATION

DRIVEWAY ENTRANCE SIGNING		SECTION		COUNTY	TOTAL SHEETS	SHEET NO.
		2020-233-BR		соок	40	40
		TC-26		CONTRACT NO. 62N03		
SHEET 1 OF 2 SHEETS STA, TO STA.		ILLINOIS FED. AID PROJECT				