## STATE OF ILLINOIS


## **DEPARTMENT OF TRANSPORTATION**


**DIVISION OF HIGHWAYS** 

# **PROPOSED** HIGHWAY PLANS

FAU ROUTE 2775 (OAK PARK AVENUE) SOUTH BOULEVARD TO NORTH BOULEVARD **VIADUCT ENHANCEMENT, SIDEWALK REPLACEMENT** AND ROADWAY LIGHTING SECTION 06-00243-00-BR PROJECT NO. TE-0001(718) **VILLAGE OF OAK PARK COOK COUNTY** 

> **OAK PARK AVENUE VIADUCT** STA, 82 + 31 TO STA, 83 + 41

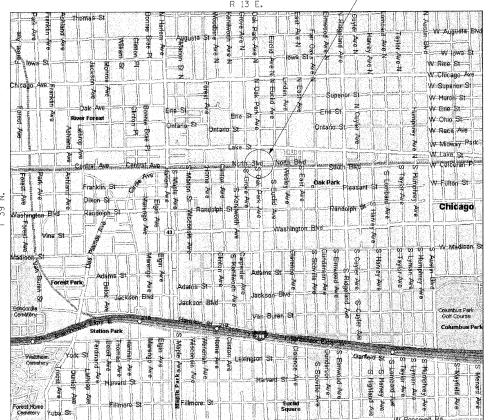

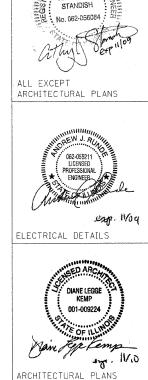

PRINTED BY THE AUTHORITY


OF THE STATE OF ILLINOIS

ANTHONY J.



FED. ROAD DIST. NO.

COOK ILLINOIS CONTRACT NO. 63091

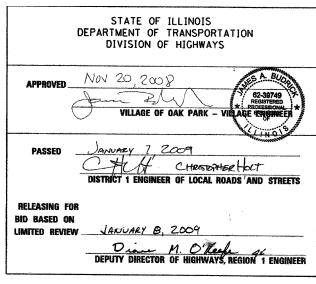



## INDEX OF SHEETS

SHEET NO.	•	DESCRIPTION
1		COVER SHEET/INDEX OF SHEETS
2		GENERAL NOTES, HIGHWAY STANDARDS AND DISTRICT ONE DETAILS
3		SUMMARY OF QUANTITIES
4		OAK PARK AVENUE VIADUCT PLAN
5-10		ARCHITECTURAL PLÂN SHEETS
11		STRUCTURAL SHEETS
12		DETAILS
13-1 <b>5</b>		DISTRICT DETAILS

VILLAGE OF OAK PARK

POLICE DEPARTMENT (708) 386-3800 FIRE DEPARTMENT (708) 386-3300

POSTED SPEED LIMIT

OAK PARK AVENUE 30 M.P.H.



FULL SIZE PLANS HAVE BEEN PREPARED USING STANDARD ENGINEERING SCALES. REDUCED SIZED PLANS WILL NOT CONFORM TO STANDARD SCALES. IN MAKING MEASUREMENTS ON REDUCED PLANS, THE ABOVE SCALES MAY BE USED.

JOINT UTILITY LOCATION INFORMATION FOR EXCAVATION 1-800-892-0123

OR 811

**OAK PARK TOWNSHIP** 

**LOCATION MAP** NO SCALE

GROSS PROJECT LENGTH: 110 FEET = 0.021 MILES NET PROJECT LENGTH: 110 FEET = 0.021 MILES

CONTRACT NO. 63091

### GENERAL NOTES

- THE LOCATION AND ELEVATION OF THE VARIOUS UNDERGROUND UTILITIES AS SHOWN ON THE PLANS ARE APPROXIMATE. THE CONTRACTOR SHALL USE SPECIAL CARE WHEN CONDUCTING CONSTRUCTION OPERATIONS NEAR THEM TO PREVENT DAMAGE.
- 2. 48 HOURS BEFORE STARTING ANY EXCAVATION, THE CONTRACTOR SHALL CALL J.U.L.I.E., THE LOCAL ONE CALL SYSTEM (800-892-0123 OR 811), AND THE VILLAGE OF OAK PARK PUBLIC WORKS (708-358-5700) FOR FIELD LOCATIONS OF VARIOUS UTILITIES AND NOTIFICATION TO RESPECTIVE UTILITY COMPANIES.
- 3. THE CONTRACTOR SHALL COORDINATE VARIOUS CONSTRUCTION ACTIVITIES WITH
- 4. WHERE SECTION OR SUBSECTION MONUMENTS ARE ENCOUNTERED, THE ENGINEER SHALL BE NOTIFIED BEFORE SUCH MONUMENTS ARE REMOVED. THE CONTRACTOR SHALL PROTECT AND CAREFULLY PRESERVE ALL PROPERTY MARKER MONUMENTS UNTIL THE OWNER, AN AUTHORIZED AGENT, OR LAND SURVEYOR HAS WITNESSED OR OTHERWISE REFERENCED THEIR LOCATION. THE CONTRACTOR WILL BE RESPONSIBLE FOR HAVING AN AUTHORIZED SURVEYOR REESTABLISH ANY SECTION OR SUB-SECTION MONUMENTS DISRUPTED BY HIS/HER OPERATIONS.
- 5. BARRICADES: ALL UNBALLASTED TYPE I AND TYPE II BARRICADES SHALL HAVE TWO (2) SANDBAGS ON THE BOTTOM RAIL. A TYPE III BARRICADE SHALL REQUIRE A MINIMUM OF FOUR (4) SANDBAGS.
- 6. THE CONTRACTOR SHALL TAKE ALL NECESSARY PRECAUTIONS FOR THE PROTECTION OF EXISTING PLANT MATERIAL FOR WHICH THE CONTRACT DOES NOT PROVIDE REMOVAL. THE PROTECTION OF EXISTING PLANT MATERIAL AND THE REPAIR OR REPLACEMENT OF EXISTING PLANT MATERIAL DAMAGED BY THE CONTRACTOR SHALL BE DONE IN ACCORDANCE WITH THE REQUIREMENTS OF SECTION 201 OF THE STANDARD SPECIFICATIONS.
- 7. CONTRACTOR SHALL TAKE CARE TO PROTECT EXISTING LANDSCAPING AT LOCATIONS NOT SHOWN IN THE PLANS TO BE REMOVED AND AS DIRECTED BY THE ENGINEER. LANDSCAPING TO BE PROTECTED THAT IS DAMAGED BY THE CONTRACTOR'S OPERATIONS SHALL BE REPLACED IN KIND AT HIS/HER EXPENSE.
- 8. ANY REFERENCE TO STANDARDS THROUGHOUT THE PLANS OR SPECIAL PROVISIONS SHALL BE INTERPRETED TO BE THE LATEST EDITION OF STANDARDS OF THE ILLINOIS DEPARTMENT OF TRANSPORTATION AND THE VILLAGE OF OAK PARK.
- 9. THE CONTRACTOR SHALL BE REQUIRED TO MAINTAIN PEDESTRIAN ACCESS AT ALL TIMES TO ALL PRIVATE AND COMMERCIAL PROPERTIES DURING THE CONSTRUCTION OF THIS PROJECT. ACCESS SHALL BE MAINTAINED AT ALL TIMES TO THE METRA STATION AT OAK PARK AVENUE.
- 10. THE VILLAGE OF OAK PARK WATER DEPARTMENT (708-445-3340 EXT. 3375) SHALL BE RESPONSIBLE FOR TURNING THE WATER MAIN VALVES ON AND OFF. THE CONTRACTOR IS NOT ALLOWED TO TURN THE OAK PARK OWNED WATER MAIN VALVES ON AND OFF. THE CONTRACTOR SHALL CONTACT THE VILLAGE OF OAK PARK FOR A WATER METER IF NECESSARY.

- II. A PROTECTIVE COAT SHALL BE APPLIED TO ALL GUTTER FLACS, FACE OF CURB AND CONCRETE DRIVEWAYS, ALLEY AND SIDEWALK IN ACCORDANCE WITH ARTICLE 408.23 OF THE STANDARD SPECIFICATIONS (INCIDENTAL).
- 12. MEMBRANE CURING COMPOUND SHALL BE APPLIED TO ALL FINISHED CONCRETE FLAT WORK AND CURB AND GUTTER. CURING OF PORTLAND CEMENT CONCRETE SHALL BE DONE IN ACCORDANCE WITH SECTION 1020.13 OF THE STANDARD SPECIFICATIONS FOR ROAD AND BRIDGE CONSTRUCTION IN ILLINOIS. LF MEMBRANE CURING COMPOUND IS CHOSEN AS THE METHOD OF CURING, THE MEMBRANE CURING COMPOUND USED SHALL BE COMPATIBLE WITH PROTECTIVE COAT.
- 13. SPECIAL ATTENTION IS DRAWN TO THE FACT THAT ARTICLE 105.06 OF THE STANDARD SPECIFICATION REQUIRE THE CONTRACTOR TO HAVE A COMPETENT SUPERINTENDENT ON THE PROJECT SITE AT ALL TIMES IRRESPECTIVE OF THE AMOUNT OF WORK SUBLET. THE SUPERINTENDENT SHALL BE CAPABLE OF READING AND UNDERSTANDING THE PLANS AND SPECIFICATIONS, SHALL HAVE FULL AUTHORITY TO EXECUTE ORDERS TO EXPEDITE THE PROJECT, AND SHALL BE RESPONSIBLE FOR SCHEDULING AND HAVE CONTROL OF ALL WORK AS THE AGENT OF THE GENERAL CONTRACTOR. FAILURE TO COMPLY WITH THIS PROVISION WILL RESULT IN A SUSPENSION OF WORK AS PROVIDED IN ARTICLE
- 14. CONTRACTOR SHALL COORDINATE WITH ALL UTILITY COMPANIES SUCH AS BUT NOT LIMITED TO COMED, AT&T, AND GAS COMPANY FOR ADJUSTMENT OF THEIR STRUCTURES WITHIN THE PROJECT LIMIT.
- 15. THE CONTRACTOR SHALL SAW CUT THE EXISTING SIDEWALK AT THE BACK OF CURB. ANY DAMAGE TO THE CURB OR CURB AND GUTTER SHALL BE REPAIRED AT NO COST TO THE CONTRACT. SAW CUTTING SHALL BE INCIDENTAL TO THE CONTRACT.
- 16. A NOMINAL QUANTITY OF INLET FILTERS HAS BEEN PROVIDED TO PROTECT EXISTING DRAINAGE STRUCTURES WITHIN THE PROJECT AREA, THE ACTUAL NEED FOR INLET FILTERS SHALL BE DETERMINED IN THE FIELD BY THE ENGINEER.
- 17. FASTENERS SHALL BE ASTM A325, MECHANICALLY GALVANIZED BOLTS.
- 18. ALL STRUCTURAL STEEL SHALL BE ASTM A992 GRADE 50 (WIDE FLANGE SECTIONS) OR ASTM A36 (PLATES AND ANGLES) UNLESS OTHERWISE NOTED.
- 19. NO FIELD WELDING IS PERMITTED TO THE EXISTING RAILROAD STRUCTURE.
- 20. PLAN DIMENSIONS AND DETAILS RELATIVE TO EXISTING PLANS ARE SUBJECT TO NOMINAL CONSTRUCTION VARIATIONS. THE CONTRACTOR SHALL FIELD VERIFY EXISTING DIMENSIONS AND DETAILS AFFECTING NEW CONSTRUCTION AND MAKE NECESSARY APPROVED ADJUSTMENTS PRIOR TO CONSTRUCTION OR ORDERING OF MATERIALS. SUCH VARIATIONS SHALL NOT BE CAUSE FOR ADDITIONAL COMPENSATION FOR A CHANGE IN SCOPE OF THE WORK, HOWEVER, THE CONTRACTOR WILL BE PAID FOR THE QUANTITY ACTUALLY FURNISHED AT THE UNIT PRICE BID FOR THE WORK.
- 21. CONTRACTOR SHALL COORDINATE WITH UNION PACIFIC RAILROAD, METRA, AND CTA FOR ALL WORK WITHIN RAILROAD R.O.W.
- 22. THE CONTRACTOR SHALL REMOVE AND STORE ITEMS MOUNTED TO THE EXISTING STEEL VIADUCT THAT SHALL BE IMPACTED BY THE PROPOSED WORK. THE CONTRACTOR SHALL REINSTALL THE ITEMS IMMEDIATELY FOLLOWING THE COMPLETION OF THE WORK.
- 23. THE CONTRACTOR SHALL NOTIFY THE RAILROAD COMPANIES PRIOR TO THE START OF WORK. THE CONTRACTOR IS RESPONSIBLE FOR MEETING ALL THE REQUIREMENTS OF THE RAILROAD COMPANIES. BELOW ARE THE CONTACTS:

COMPANY: CHICAGO TRANSIT AUTHORITY (CTA)

CONTACT: DAVID CAPPA (MANAGER, STRUCTURE MAINTENANCE)

TELEPHONE: (773) 722-4130

FAX: (773) 722-4105

OMPANY: UNION PACIFIC RAILROAD

CONTACT: BYRON THIESSE (MANAGER, STRUCTURAL PROJECTS)

TELEPHONE: (312) 496-4729

AX: (402) 233-2893

### HIGHWAY STANDARDS

000001-05	STANDARD SYMBOLS, ABBREVIATIONS AND PATTERNS
280001-04	TEMPORARY EROSION CONTROL SYSTEMS
424001-05	CURB RAMPS FOR SIDEWALKS
701001-02	OFF-RD OPERATIONS, 2L, 2W, MORE THAN 15' (4.5m) AWAY
701006-03	OFF-RD OPERATIONS, 2L, 2W, 15' (4.5m) TO 24" (600mm) FROM PAVEMENT EDGE
701101-02	OFF-RD OPERATIONS, MULTILANE, 15' (4.5m) TO 24" (600mm) FROM PAVEMENT EDGE
701106-02	OFF-RD OPERATIONS, MULTILANE, MORE THAN 15' (4.5m) AWA
701601-06	URBAN LANE CLOSURE MULTILANE, 1W OR 2W WITH NONTRAVERSABLE MEDIAN
701801-04	LANE CLOSURE MULTILANE 1W OR 2W CROSSWALK OR

### DISTRICT STANDARDS

BE-220 ELECTRIC SERVICE INSTALLATION AERIAL, REMOTE DISCONNECT

SIDEWALK CLOSURE

701901-01 TRAFFIC CONTROL DEVICES

BE-702 MISC. ELECTRICAL DETAILS SHEET A

TC-10 TRAFFIC CONTROL AND PROTECTION FOR SIDE ROADS, INTERSECTIONS AND DRIVEWAYS

SHEETS STA.

SCALE: AS SHOWN SHEET NO.

FED. ROAD DIST, NO. ILLINOIS FED. AID PROJECT

\* INDICATES SPECIALTY ITEMS

++ INDICATES SPECIAL PROVISION

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STRAND ASBODIATES, INC. ENGINEERS

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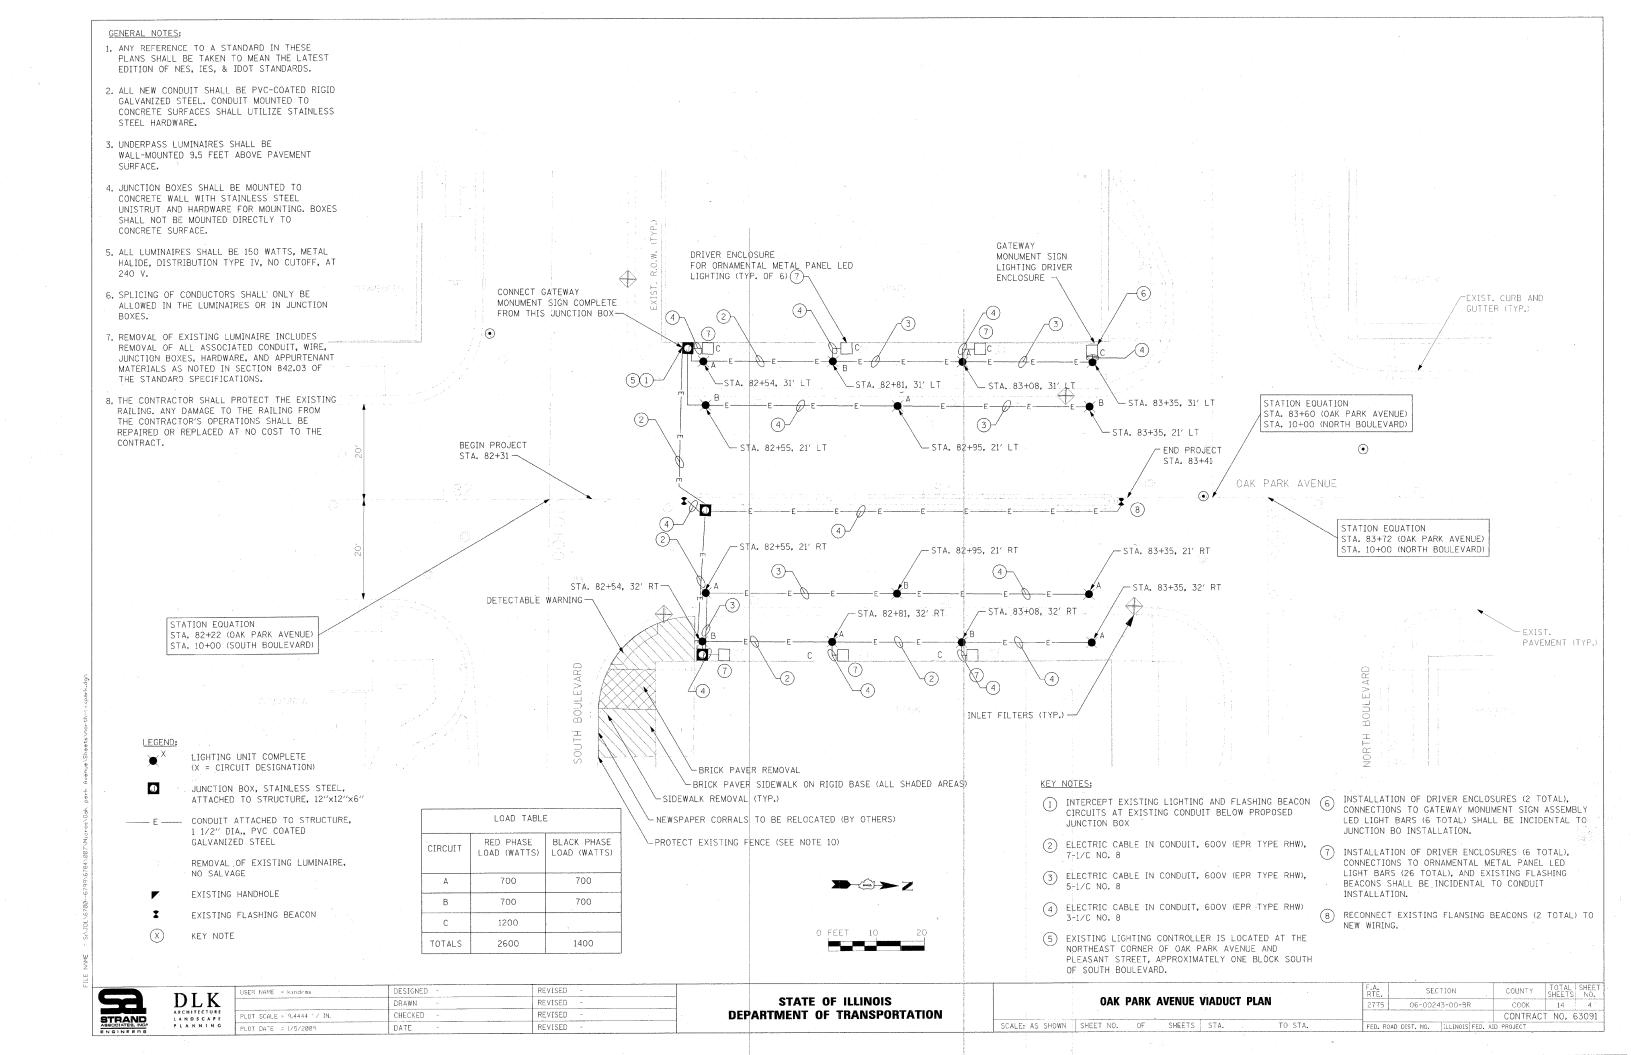
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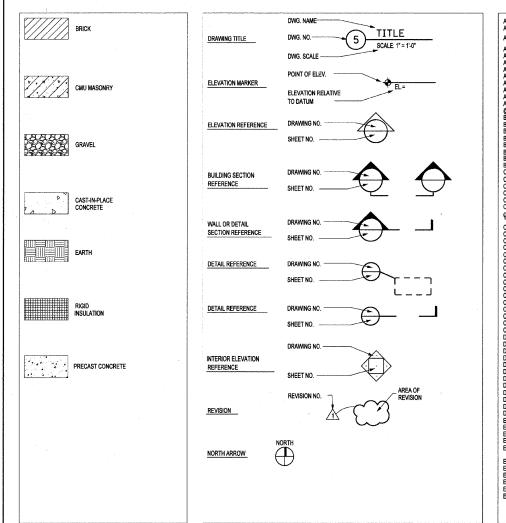
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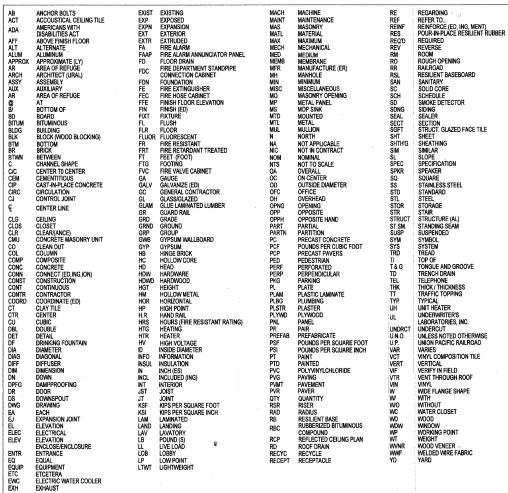
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NO.	OF.	SHEETS	STA.	TO STA.	FED. RO	AD DIST, NO.	TILINOIS FED. A	ID PROJECT		







SHEET	# DESCRIPTION
G1.0	ABBREVIATIONS, SYMBOLS, DRAWING LIST
A1.0	OAK PARK AVE. VIADUCT PLAN
A1.1	OAK PARK AVEVIADUCT ELEVATIONS
A1.2	OAK PARK AVEVIADUCT ELEVATIONS
A2.0	ORNAMENTAL METAL PANEL ENLARGED PLANS AND DETAILS
A2.1	GATEWAY MONUMENT SIGN DETAILS

**MATERIALS KEY** 

**SYMBOLS** 

**ABBREVIATIONS** 

DRAWING LIST


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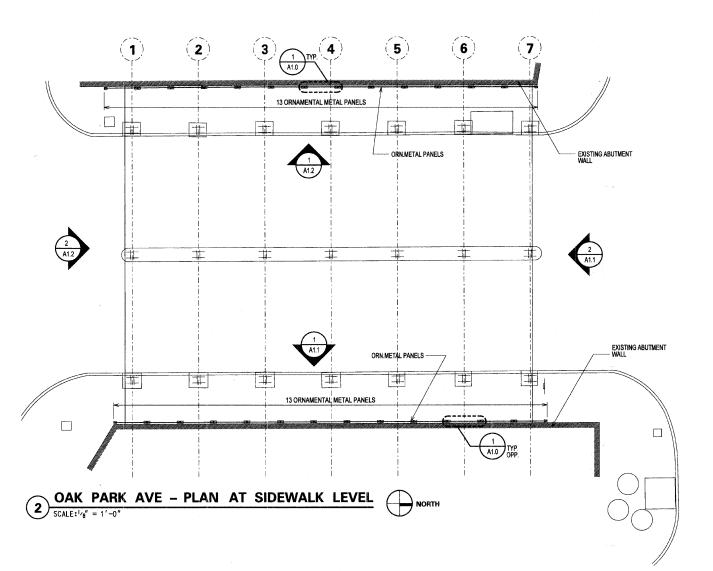
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DEPARTMENT OF TRANSPORTATION

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BILL OF MATERIALS		
ITEM	UNIT	QUANTITY
ORNAMENTAL METAL PANEL	EACH	26
CLEANING AND PAINTING EXISTING STRUCTURES	L SUM (SF)	3300
GATEWAY MONUMENT SIGN COMPLETE *	EACH	16

"GATEWAY MONUMENT SIGN COMPLETE - PANELS CONSIST OF (16) LED FIXTURES
-REFER TO ELECTRICAL DRAWINGS FOR DETAILS AND QUANTITIES.

"GATEWAY MONUMENT SIGN COMPLETE - PANELS CONSIST OF (16) PANELS.


(4) TYPE A, (12) TYPE B - REFER TO SHEET A 2.1 FOR DETAILS AND SIZES.

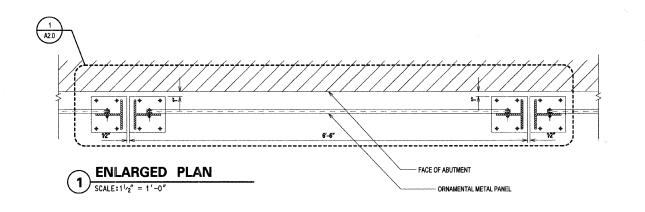
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STRANC	Civic Design

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STATE OF ILLINOIS
DEPARTMENT OF TRANSPORTATION

						(4) TYPE A, (12) T	YPE B - F	EFFR TO SHEET	A 2.1 FOR DETAIL	S AND SIZES.	<b>.</b>	1
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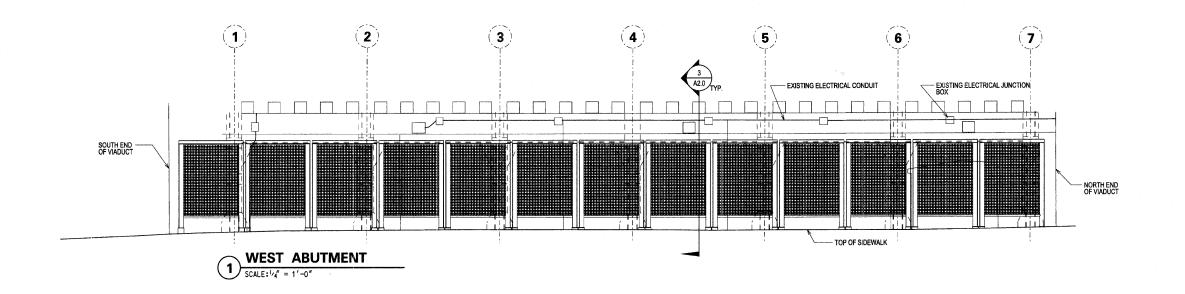
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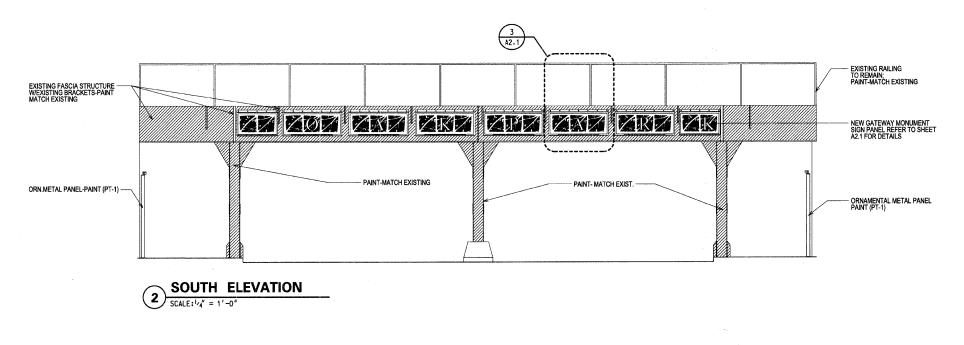
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STATE OF ILLINOIS **DEPARTMENT OF TRANSPORTATION** 

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ı										CONTRAC	T NO.	63091
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EXISTING SURFACE TO BE PAINTED

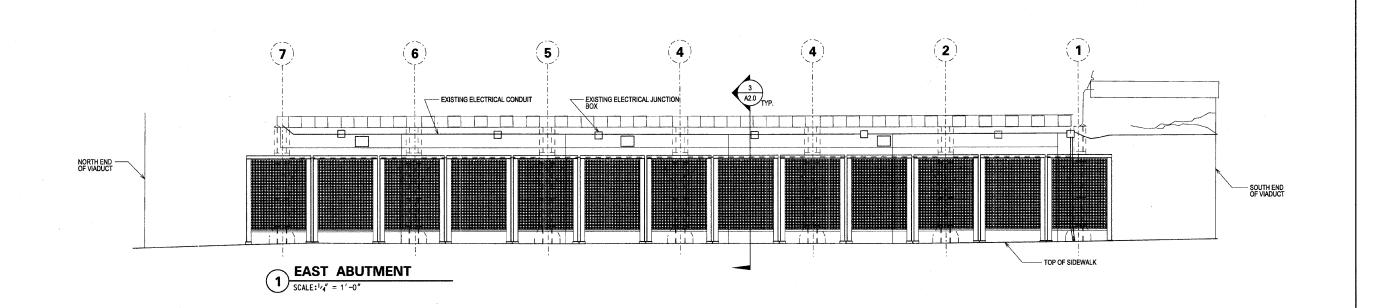
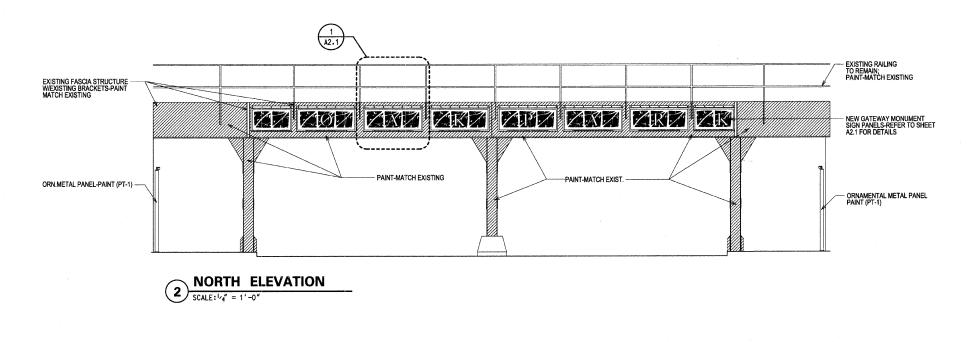
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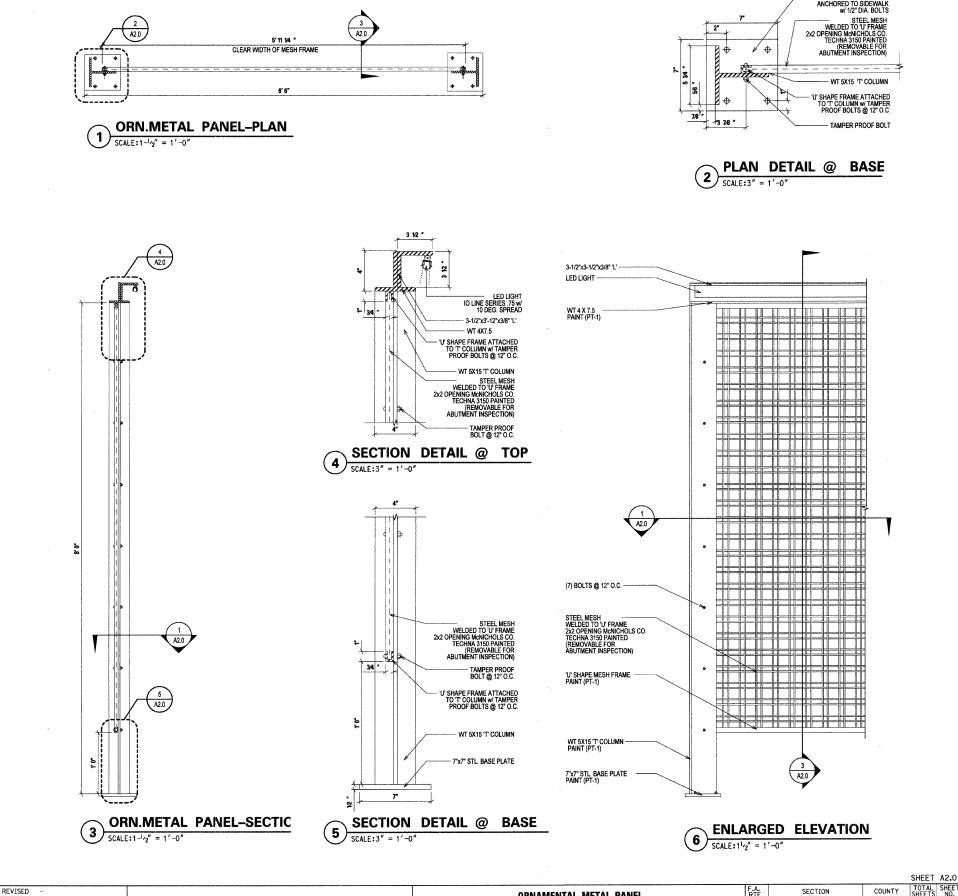
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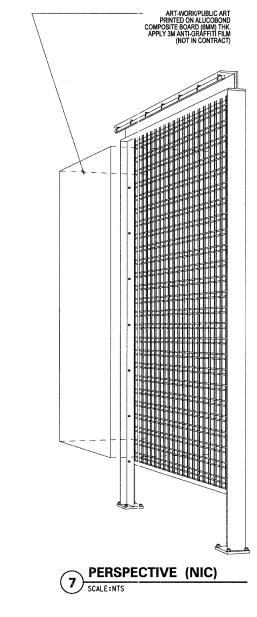
STATE OF ILLINOIS DEPARTMENT OF TRANSPORTATION

COUNTY TOTAL SHEET NO.

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CONTRACT NO. 63091 OAK PARK AVE.-VIADUCT ELEVATIONS 06-00243-00-BR SCALE: AS SHOWN SHEET NO. OF SHEETS STA.






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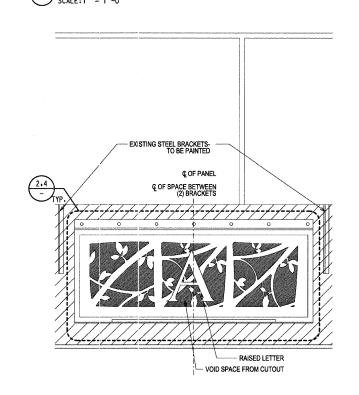
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STATE OF ILLINOIS **DEPARTMENT OF TRANSPORTATION** 


ORNAMENTAL METAL PANEL **ENLARGED PLANS AND DETAILS** SCALE: AS SHOWN SHEET NO. OF SHEETS STA.

| SHEET A2.0 | RTE. | SECTION | COUNTY | TOTAL | SHEET NO. | SHEET




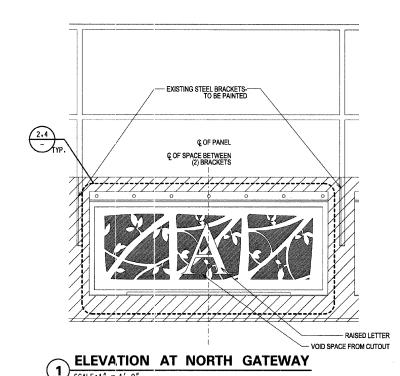


SCALE: 1" = 1'-0" AT SOUTH GATEWAY

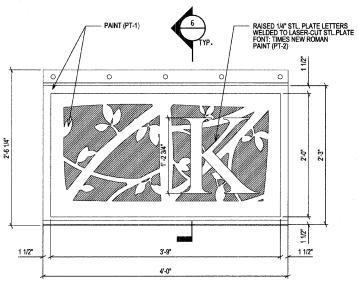

GATEWAY MONUMENT SIGN PANEL TYPE A ELEVATION

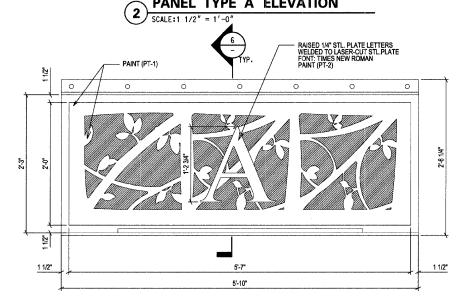


# GATEWAY MONUMENT SIGN PANEL TYPE B ELEVATION

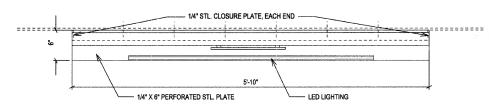

PLAN SECTION AT GATEWAY MONUMENT SIGN

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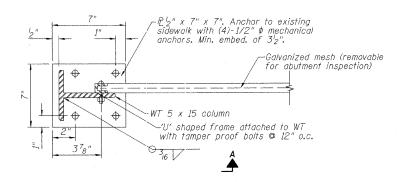


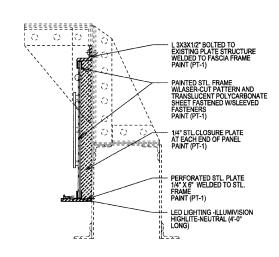SECTION AT GATEWAY MONUMENT SIGN


SCALE:1 1/2" = 1'-0"

										A2.1
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## STATE OF ILLINOIS DEPARTMENT OF TRANSPORTATION





## PLAN DETAIL AT BASE



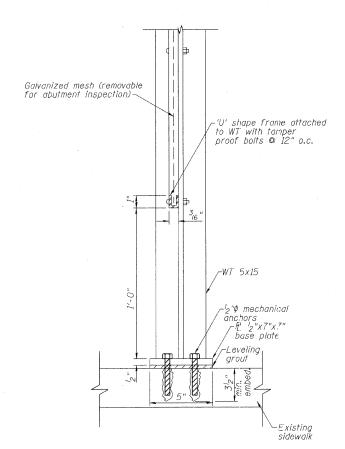

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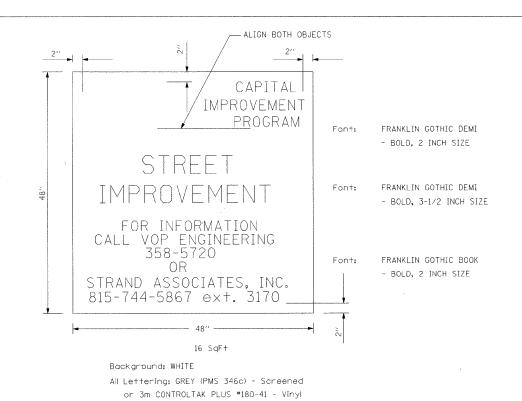
GATEWAY MONUMENT SIGN COMPLETE DETAIL
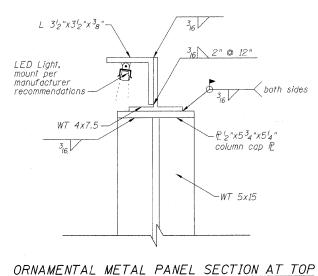
## STRUCTURAL DETAILS
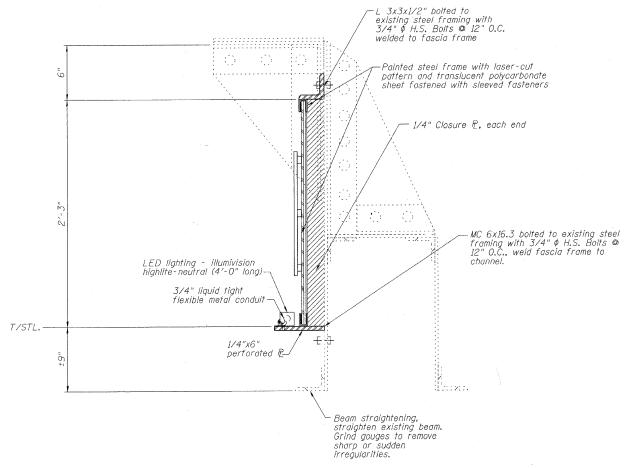
### STRAND ASSOCIATES, INC.

SHEET S1-1

CHEET NO	F.A RTE.	SECTION	COUNTY	TOTAL SHEETS	SHEET NO.
SHEET NO.	2775	06-00243-00-BR	Cook	14	11
SHEETS			CONTRACT	NO. 63	091
	FED. RO	AD DIST. NO ILLINOIS FED. A	ID PROJECT		



Logo Symbol: GREEN (PMS 3525c) - Screened or 3m CONTROLTAK PLUS #180-56 - Vinyl

PROJECT SIGN DETAIL

BRICK PAVER BLOCKS

1" SAND CUSHION

PROTECT EXISTING CONCRETE

CURB AND GUTTER

4" PCC BASE

2" GRANULAR SUBBASE

BRICK PAVER SIDEWALK ON RIGID BASE DETAIL


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STRAND AGGOLATE, INC. ENGINEERS

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	DETAILS							06-00243-00-BR	COOK	14	12
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-	SCALE: AS SHOWN	SHEET NO.		SHEETS	STA.	TO STA.	FED. RO	DAD DIST. NO.   ILLINOIS FED. A	D PROJECT		



-SERVICE CABLES

-PRESSURE DISK

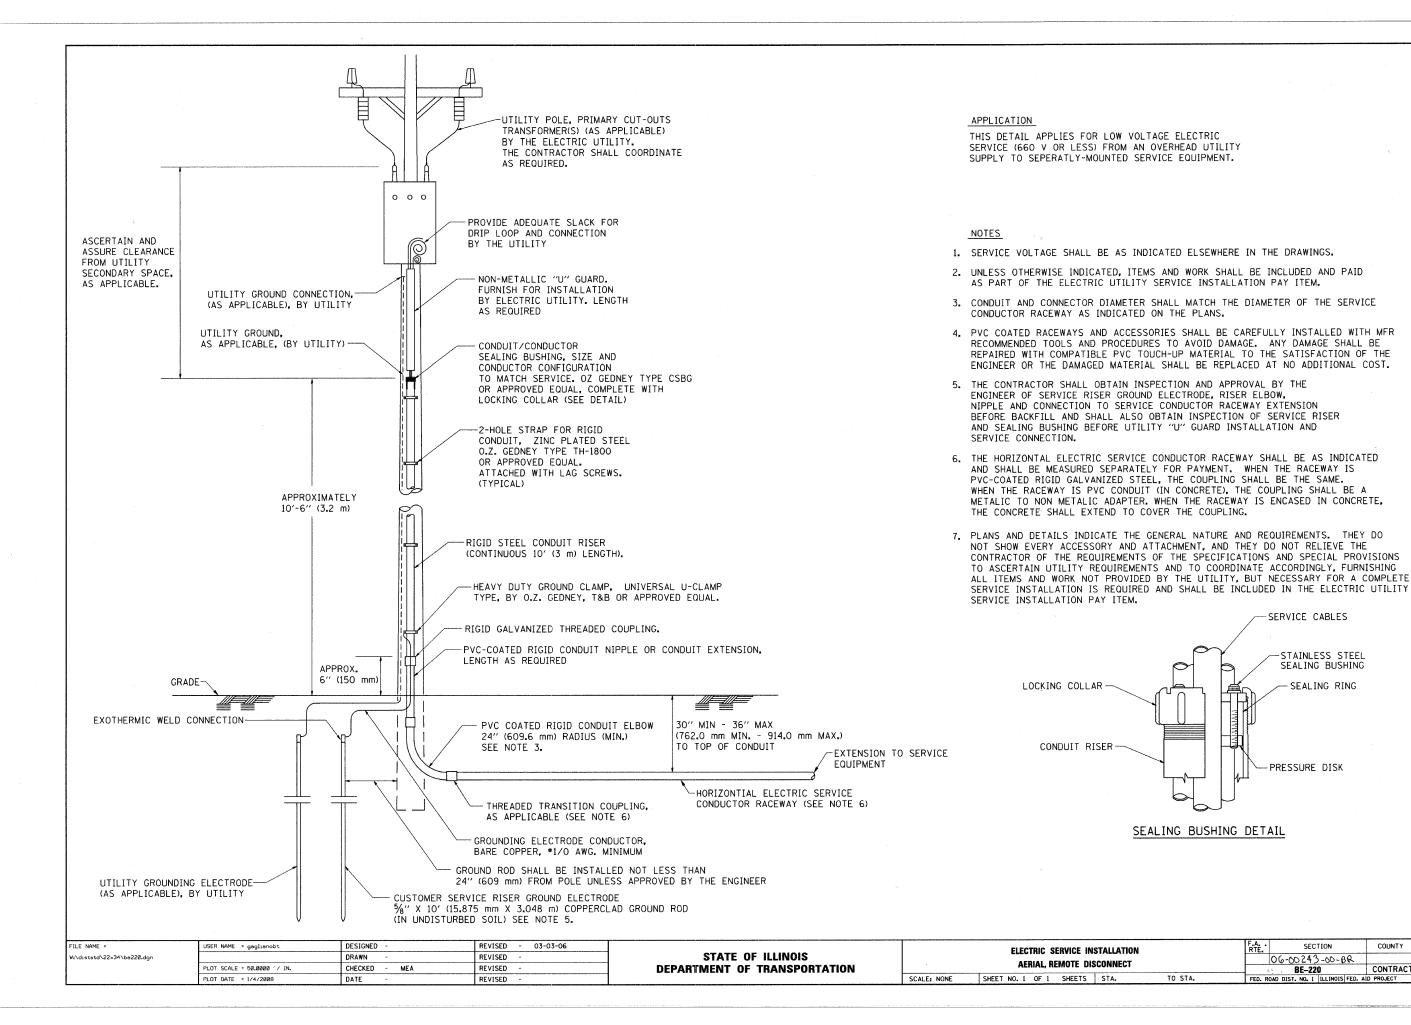SECTION

06-00243-00-BR BE-220

STAINLESS STEEL


SEALING BUSHING

SEALING RING

TOTAL SHEETS NO.


CONTRACT NO. 63091


COUNTY

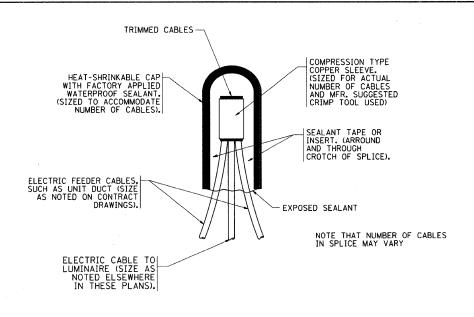

## TYPICAL SPLICE DETAIL

N.T.S.

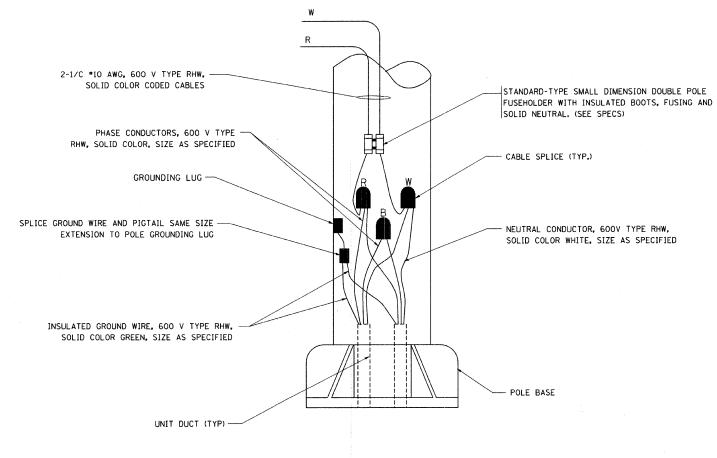

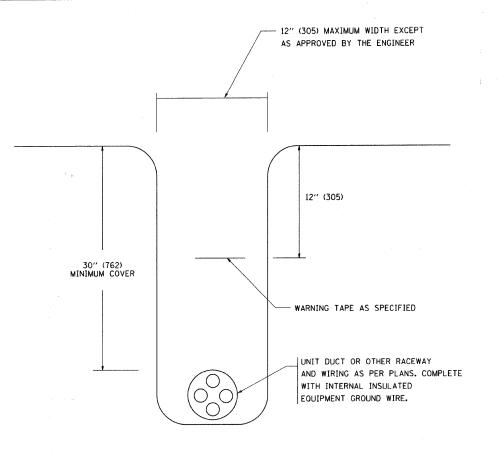

## TYPICAL WIRING IN TRENCH DETAIL

N.T.S.

POLE WIRING DETAIL

N.T.S.

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Wi\diststd\22x34\be702.dgn		DRAWN -	REVISED -	STATE OF ILLINOIS					06-00243-00-BR	14 14
	PLOT SCALE = 50.000 '/ IN.	CHECKED -	REVISED -	DEPARTMENT OF TRANSPORTATION	SHEET A			BE-702	CONTRACT NO. 63091	
	PLOT DATE = 1/4/2008	DATE -	REVISED -		SCALE: NONE	SHEET NO. 1 OF 1 SHEETS	STA.	TO STA.	FED. ROAD DIST. NO. 1 ILLINOIS FED.	AID PROJECT

