
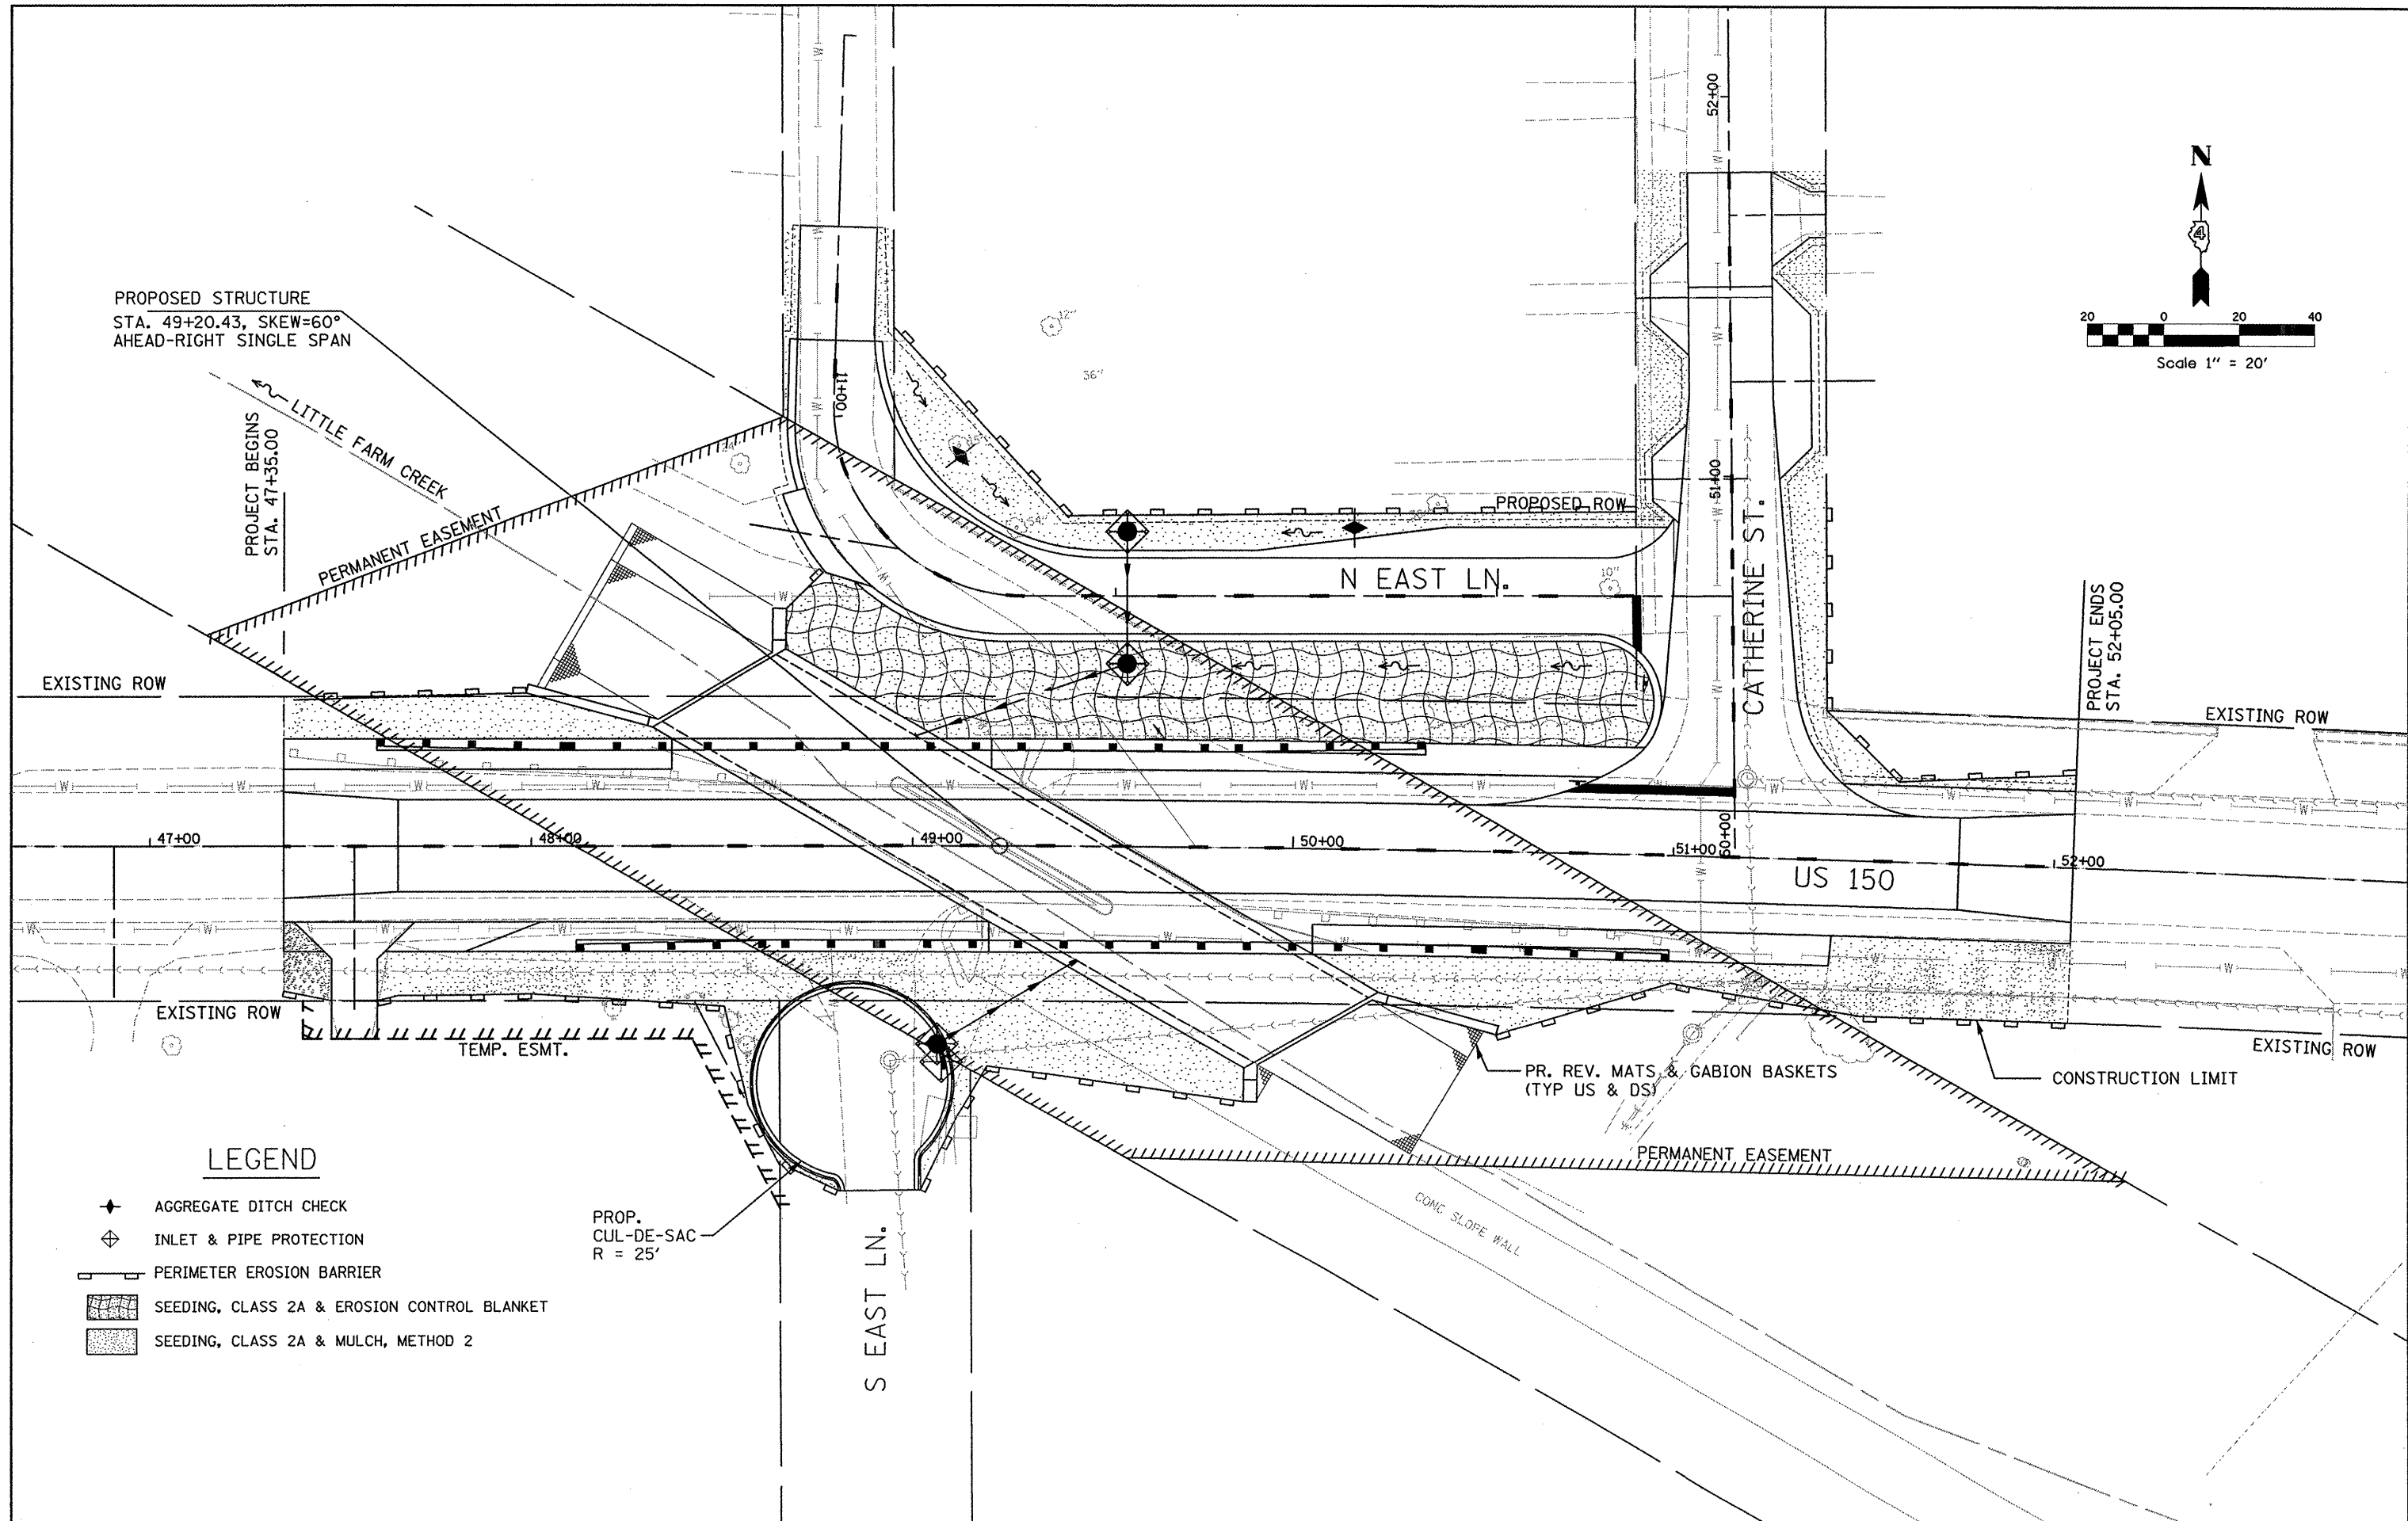


PROPOSED STRUCTURE
 STA. 49+20.43, SKEW=60°
 AHEAD-RIGHT SINGLE SPAN

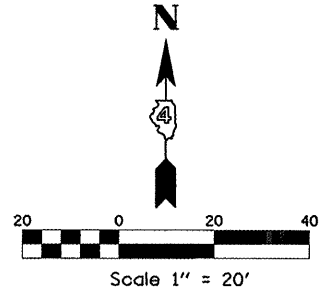

LEGEND

- ◆ AGGREGATE DITCH CHECK
- ⊕ INLET & PIPE PROTECTION
- ▬ PERIMETER EROSION BARRIER
- ▨ SEEDING, CLASS 2A & EROSION CONTROL BLANKET
- ▩ SEEDING, CLASS 2A & MULCH, METHOD 2

PROP.
 CUL-DE-SAC
 R = 25'

FILE NAME = ...\\0900038\0038-erosion.dgn	USER NAME = Plotted by new6	DESIGNED - ST	REVISED -	STATE OF ILLINOIS DEPARTMENT OF TRANSPORTATION	EROSION & SEDIMENT CONTROL PLANS US 150 OVER LITTLE FARM CREEK S.N. 090-0038			F.A.U. RTE.	SECTION	COUNTY	TOTAL SHEETS	SHEET NO.
	PLOT SCALE = 40,0000' / IN.	DRAWN - ST	REVISED -					6757	(105B) BR-2	TAZEWELL	49	133
	PLOT DATE = 7/29/2008	CHECKED - FL	REVISED -					CONTRACT NO. 68086				
	DATE - 12/2007	REVISED -		SCALE: 1" = 20'	SHEET NO. OF SHEETS	STA. 47+35.00 TO STA. 52+05.00	FED. ROAD DIST. NO. [ILLINOIS] FED. AID PROJECT					