
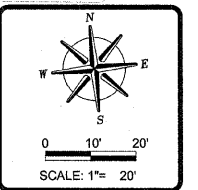


NUMBER	DEGREE OF CURVE - ARC	DEGREE OF CURVE - CHORD	TANGENT	RADIUS	ARC LENGTH	CHORD LENGTH	EXTERNAL	MID ORDINATE
C23	104°10'27"	130°45'36"	13.1706	55.0000	25.8543	25.6169	1.5550	1.5122
C24	88°08'50"	100°34'11"	35.6597	65.0000	65.2309	62.5278	9.1392	8.0126
C25	40°55'32"	41°50'59"	42.4425	140.0000	82.4192	81.2342	6.2921	6.0214
C26	95°29'35"	112°53'07"	45.7763	60.0000	78.2077	72.7876	15.4684	12.2979
C27	104°10'27"	130°45'36"	4.7111	55.0000	9.3992	9.3877	0.2014	0.2007
C28	104°10'27"	130°45'36"	5.1153	55.0000	10.2013	10.1867	0.2374	0.2363

SCALES:  
1" = 20' HOR  
1" = 5' VER

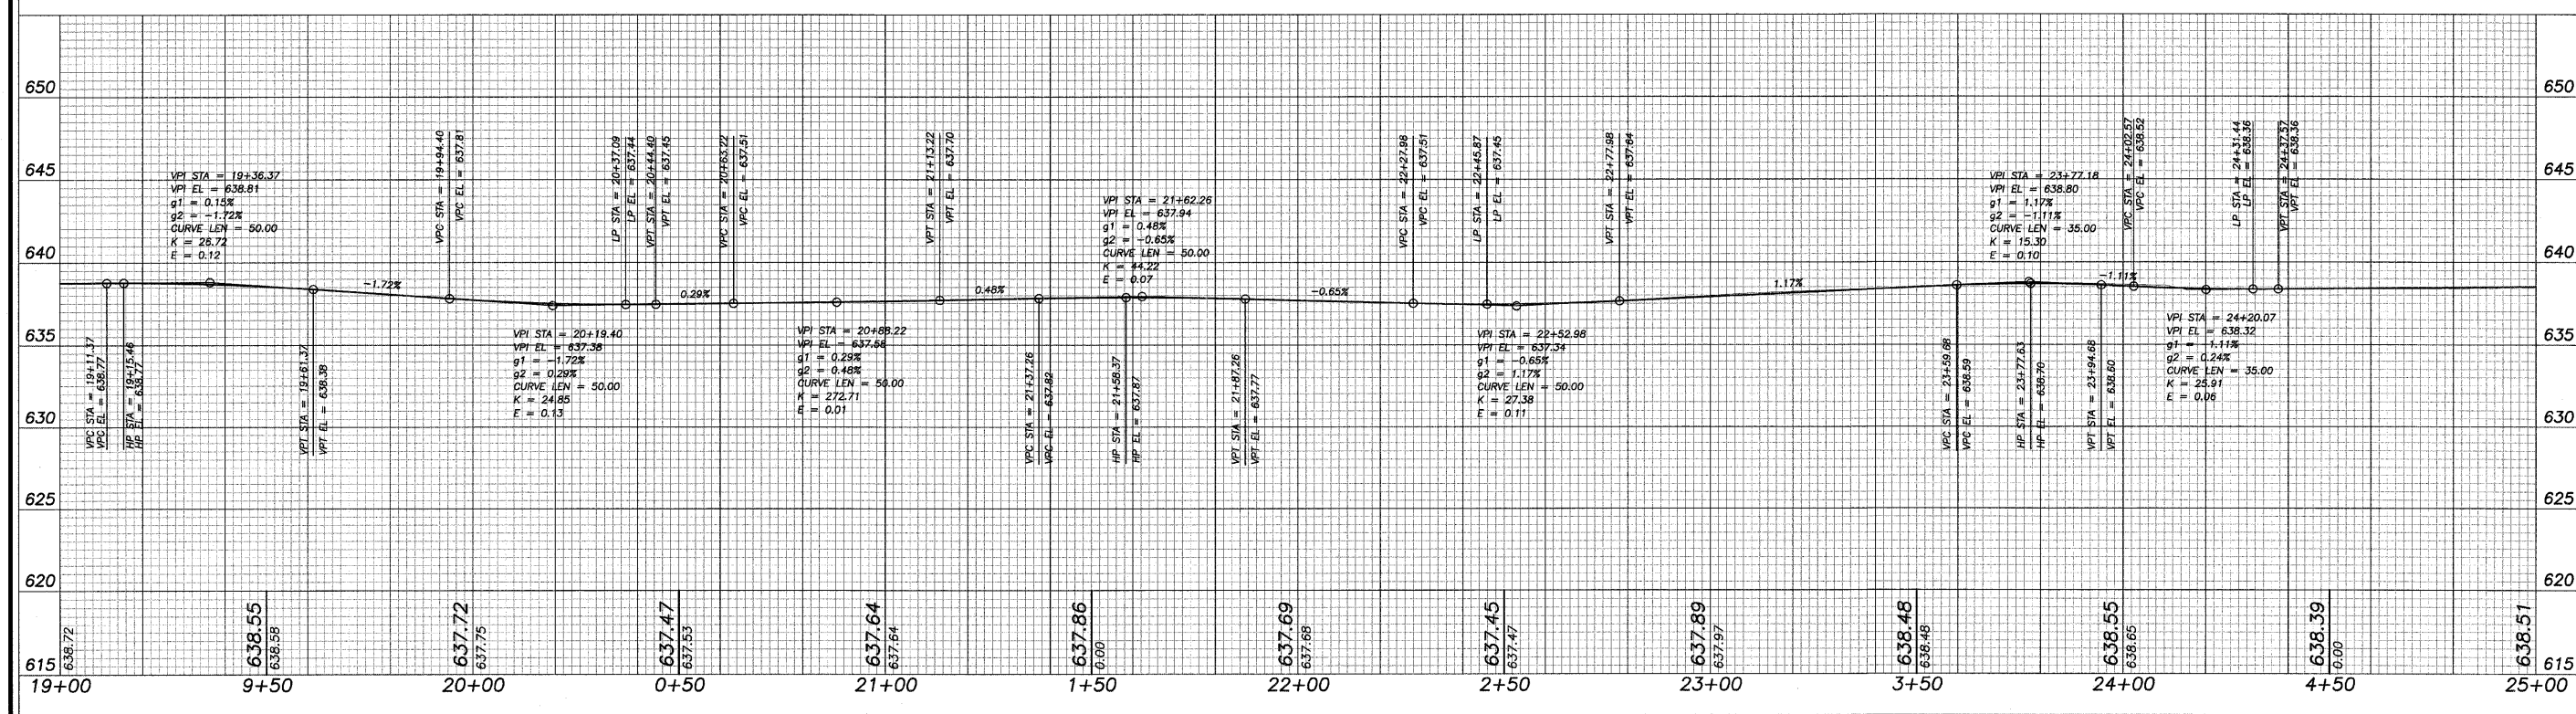

REVISION	DATE	BY
	20 OCT 08	

DESIGNED BY:	DAB
DRAWN BY:	BDS
CHECKED BY:	
DATE:	

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PAVING PLANS  
 OF  
 SHARED MULTI-USE PATH  
 FOR  
 STERLING PARK DISTRICT

SHEET TITLE  
**PLAN & PROFILE**

JOB NUMBER  
 204005

DATE  
 06/10/2008

SHEET NO.  
**7 of 15**