03-06-2020 LETTING ITEM 121

STATE OF ILLINOIS

DEPARTMENT OF TRANSPORTATION

PLANS FOR PROPOSED FEDERAL AID HIGHWAY

FOR INDEX OF SHEETS, SEE SHEET NO. 2 FOR INDEX OF HIGHWAY STANDARDS, SEE SHEET NO. 2 F.A.U. ROUTE 2611 (MAIN STREET)

WILSON AVENUE TO ST. CHARLES ROAD ROADWAY RESURFACING, INTERSECTION IMPROVEMENT, TRAFFIC SIGNALS

SECTION NO.: 19-00161-00-RS PROJECT NO.: ZNRC(423) **VILLAGE OF LOMBARD DUPAGE COUNTY** C-91-358-19

DESIGN SPEED

MAIN ST (WILSON AVE TO MADISON ST) - 40 MPH MAIN ST (MADISON ST TO E WASHINGTON BLVD) - 35 MPH MAIN ST (E WASHINGTON BLVD TO ST CHARLES RD) - 30 MPH

POSTED_SPEED

MAIN ST (WILSON AVE TO MADISON ST) - 35 MPH MAIN ST (MADISON ST TO E WASHINGTON BLVD) - 30 MPH MAIN ST (E WASHINGTON BLVD TO ST CHARLES RD) - 25 MPH

FUNCTIONAL CLASSIFICATION MINOR ARTERIAL (2016 ADT = 18,600)



ENGINEERING SCALES. REDUCED SIZED PLANS WILL NOT CONFORM TO STANDARD SCALES. IN MAKING MEASUREMENTS ON REDUCED PLANS, THE ABOVE SCALES MAY BE USED.


JOINT UTILITY LOCATION INFORMATION FOR EXCAVATION 1-800-892-0123 OR 811

PROJECT LENGTH

GROSS AND NET LENGTH = 7,354.51 FT. (1.393 MILES)

END IMPROVEMENTS STA, 75 + 54,35 MAIN STREET SN: 022-9943 BEGIN IMPROVEMENTS STA. 1 + 99.84 MAIN STREET LOCATION MAP (NOT TO SCALE)

LOCATION OF SECTION INDICATED THUS: -

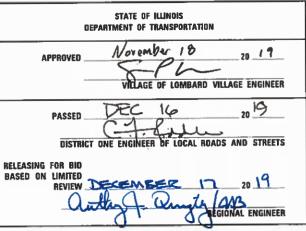

PRINTED BY THE AUTHORITY OF THE STATE OF ILLINOIS

PLANS PREPARED BY

Two Pierce Place, Suite 1400 - Itasca, Illinois 60143 Tel: 630 773.3900 - Fax: 630.773.3975

FOR DRAWINGS 45 TO 57

FOR DRAWINGS 1 TO 44, AND 58 TO 6

CONTRACT NO. 61G29

RAMOS, P.E. **ENGINEER: CARMEN**

PROGRAM

AID

SCHAUMBURG, IL

INDEX OF SHEETS

SHEET NO. DESCRIPTION

	<u> </u>
1	COVER SHEET
2 TO 3	INDEX, GENERAL NOTES, AND STANDARDS
4 TO 13	SUMMARY OF QUANTITIES
14 TO 16	TYPICAL SECTIONS
17 TO 18	ALIGNMENT AND BENCHMARKS
19 TO 26	ROADWAY PLAN AND PROFILE
27	MAINTENANCE OF TRAFFIC GENERAL NOTES
28 TO 30	PAVEMENT MARKING PLAN
31 TO 43	ADA GRADING PLAN
44	RAISED MEDIAN DETAIL
45 TO 57	TRAFFIC SIGNAL PLANS
58 TO 59	CONSTRUCTION DETAILS
60 TO 67	DISTRICT ONE DETAILS

SPECIFICATIONS, STANDARDS AND SPECIAL PROVISIONS

- 1. ALL CONSTRUCTION SHALL BE IN ACCORDANCE WITH THE "STANDARD SPECIFICATIONS FOR ROAD AND BRIDGE CONSTRUCTION" ("STANDARD SPECIFICATIONS"), ADOPTED APRIL 1, 2016; THE "SUPPLEMENTAL SPECIFICATIONS AND RECURRING SPECIAL PROVISIONS", ADOPTED JANUARY 1, 2020; THE LATEST EDITION OF THE "ILLINOIS MANUAL ON UNIFORM TRAFFIC CONTROL DEVICES FOR STREETS AND HIGHWAYS", (IMUTCD); "THE STANDARD SPECIFICATIONS FOR WATER AND SEWER MAIN CONSTRUCTION IN ILLINOIS" JUNE 2014 SEVENTH EDITION, THE DETAILS IN THE PLANS, AND THE SPECIAL PROVISIONS AND IDOT STANDARD DRAWINGS INCLUDED IN THE CONTRACT DOCUMENTS.
- 2. NO WORK SHALL COMMENCE UNTIL TRAFFIC CONTROL REQUIREMENTS ARE MET.
- 3. ALL UTILITY COMPANIES, SCHOOL DISTRICTS ((630-827-4400)(DISTRICT 44) AND (630-469-9100)(DISTRICT 87), LOCAL POLICE (630-873-4400), AND FIRE DEPARTMENTS (630-620-5737) SHALL BE NOTIFIED BY THE CONTRACTOR AT LEAST 72 HOURS PRIOR TO THE START OF CONSTRUCTION.
- 4. IT SHALL BE THE CONTRACTOR'S RESPONSIBILITY TO VERIFY ALL DIMENSIONS AND CONDITIONS EXISTING IN THE FIELD PRIOR TO ORDERING MATERIALS AND BEGINNING CONSTRUCTION.
- 5. THE CONTRACTOR IS PROHIBITED FROM BURNING ANY MATERIAL WITHIN OR ADJACENT TO THE PROJECT LIMITS. ALL EXCESS OR WASTE MATERIAL SHALL BE EITHER HAULED AWAY FROM THE PROJECT SITE BY THE CONTRACTOR AND DEPOSITED AT LOCATIONS PROVIDED BY HIM, OR DISPOSED OF WITHIN THE RIGHT-OF-WAY IN A MANNER OTHER THAN BURNING, SUBJECT TO THE APPROVAL OF THE ENGINEER.

TREE PROTECTION

- 1. THE CONTRACTOR'S ATTENTION IS CALLED TO THE FACT THAT THE PRESERVATION OF EXISTING TREES IS OF THE UTMOST IMPORTANCE TO THE VILLAGE. ALL TREE PROTECTION, TREE REMOVAL, TREE PRUNING AND ROOT PRUNING SHALL BE COMPLETED BEFORE CONSTRUCTION OPERATIONS COMMENCE IN ANY AREA. AT NO TIME SHALL THE CONTRACTOR PRUNE OR REMOVE ANY TREES UNLESS SPECIFICALLY DIRECTED BY THE ENGINEER.
- 2. TEMPORARY FENCE SHALL BE ERECTED ALONG THE DRIP LINE OF EXISTING TREES TO REMAIN WHEN DIRECTED BY THE ENGINEER. AFTER TREES ARE SAFELY FENCED NOTHING IS TO BE STORED, DRIVEN, OR DISTURBED INSIDE THE FENCE. REMOVE PROTECTIVE TEMPORARY FENCE ONLY AFTER ALL CONSTRUCTION WORK HAS BEEN COMPLETED.

HIGHWAY STANDARDS

000001-07 280001-07 424001-11 424006-04 424011-04	STANDARD SYMBOLS, ABBREVIATIONS AND PATTERNS TEMPORARY EROSION CONTROL SYSTEMS PERPENDICULAR CURB RAMPS FOR SIDEWALKS DIAGONAL CURB RAMPS FOR SIDEWALKS CORNER PARALLEL CURB RAMPS FOR SIDEWALKS
424016-05	MID-BLOCK CURB RAMPS FOR SIDEWALKS
424021-05	DEPRESSED CORNER FOR SIDEWALKS
442201-03	CLASS C AND D PATCHES
602001-02	CATCH BASIN TYPE A
602011-02	CATCH BASIN TYPE C
602301-04	INLET - TYPE A
602601-06	PRECAST REINFORCED CONCRETE FLAT SLAB TOP
604001-05	FRAME AND LIDS TYPE 1
604051-04	FRAME AND GRATE TYPE 11
606001-07	CONCRETE CURB TYPE B AND COMBINATION CONCRETE CURB AND GUTTER
606301-04	PC CONCRETE ISLANDS AND MEDIANS
701101-05	OFF-ROAD OPERATIONS, MULTILANE, 15' TO 24" FROM PAVEMENT EDGE
701427-05	LANE CLOSURE, MULTILANE, INTERMITTENT OR MOVING OPERATIONS
701501-06	URBAN LANE CLOSURE, 2L, 2W, UNDIVIDED
701602-10	URBAN LANE CLOSURE, MULTILANE, 2W WITH BIDIRECTIONAL LEFT TURN LANE
701606-10	URBAN SINGLE LANE CLOSURE, MULTILANE, 2W WITH MOUNTABLE MEDIAN
701611-01	URBAN HALF ROAD CLOSURE, MULTILANE, 2W WITH MOUNTABLE MEDIAN
701701-10	URBAN LANE CLOSURE, MULTILANE INTERSECTION
701801-06	SIDEWALK, CORNER OR CROSSWALK CLOSURE
701901-08	TRAFFIC CONTROL DEVICES
780001-05	TYPICAL PAVEMENT MARKINGS
877011-10	STEEL COMBINATION MAST ARM ASSEMBLY AND POLE, 16' THROUGH 55'
878001-10	CONCRETE FOUNDATION DETAILS

PAVING, CURB & GUTTER AND SIDEWALK

- 1. HOT-MIX ASPHALT BINDER COURSE SHALL NOT BE PLACED ADJACENT TO CURB AND GUTTER UNTIL THE CURB AND GUTTER HAS BEEN PROPERLY CURED AND BACKFILLED TO THE SATISFACTION OF THE ENGINEER.
- 2. HOT-MIX ASPHALT SURFACE COURSE SHALL NOT BE PLACED UNTIL ALL EARTH EXCAVATION, TOPSOIL PLACEMENT, AND HOT-MIX ASPHALT BINDER COURSE HAVE BEEN COMPLETED TO THE SATISFACTION OF THE ENGINEER.
- 3. THE THICKNESSES OF HOT-MIX ASPHALT MIXTURES SHOWN ON THE PLANS ARE NOMINAL. DEVIATIONS MAY OCCUR DUE TO IRREGULARITIES IN THE SURFACE, BINDER, OR BASE UPON WHICH THE HOT-MIX ASPHALT MATERIALS ARE PLACED.
- 4. FOR WORK OUTSIDE THE LIMITS OF BRIDGE APPROACH PAVEMENT, ALL REFERENCES IN THE HIGHWAY STANDARDS AND STANDARD SPECIFICATIONS FOR REINFORCEMENT, DOWEL BARS, AND TIE BARS IN PAVEMENT, SHOULDERS, CURB, GUTTER, COMBINATION CURB AND GUTTER, MEDIAN, AND CHAIR SUPPORTS FOR CRC PAVEMENT, SHALL BE EPOXY COATED, UNLESS NOTED ON THE PLAN.

UTILITIES

- 1. THE CONTRACTOR SHALL COORDINATE CONSTRUCTION ACTIVITIES WITH UTILITY COMPANIES. THE LOCATION OF PUBLIC OR PRIVATE UTILITIES SHOWN ON THE PLANS ARE APPROXIMATE AND THE ENGINEER DOES NOT GUARANTEE THEIR ACCURACY.
- 2. COORDINATION OF ANY UTILITY WORK INVOLVED IN THE CONSTRUCTION AREA WILL BE DISCUSSED AT THE PRECONSTRUCTION CONFERENCE.
- BEFORE STARTING ANY EXCAVATION, THE CONTRACTOR SHALL CALL "JULIE" AT 1-800-892-0123 FOR FIELD LOCATIONS OF BURIED ELECTRIC, TELEPHONE, GAS, WATER, SEWER AND CABLE TELEVISION FACILITIES. (48 HOURS NOTIFICATION IS REQUIRED.)
- 4. ANY EXISTING OR PROPOSED SEWER DAMAGED BY THE CONTRACTOR DURING CONSTRUCTION SHALL BE REPLACED BY THE CONTRACTOR TO THE SATISFACTION OF THE ENGINEER.

IDOT DISTRICT ONE STANDARDS

TRAFFIC SIGNAL MOUNTING DETAILS

880006-01

TS-05

BD-08	DETAIL FOR FRAMES AND LIDS ADJUSTMENT WITH MILLING
BD-32	BUTT JOINT AND HMA TAPER DETAILS
TC-10	TRAFFIC CONTROL AND PROTECTION FOR SIDE ROADS, INTERSECTIONS AND DRIVEWAYS
TC-13	DISTRICT ONE TYPICAL PAVEMENT MARKINGS
TC-16	SHORT-TERM PAVEMENT MARKING LETTERS AND SYMBOLS
TC-22	ARTERIAL ROAD INFORMATION SIGN
TC-24	TRAFFIC CONTROL AND PROTECTION AT TURN BAYS (TO REMAIN OPEN TO TRAFFIC)
TC-26	DRIVEWAY ENTRANCE SIGNING

DISTRICT ONE STANDARD TRAFFIC SIGNAL DESIGN DETAILS

STORM & SANITARY SEWER

- 1. DRAINAGE STRUCTURE FLAT-TOPS AND CONES SHALL BE TURNED SO THAT THE FRAMES ARE CLOSEST TO THE CENTERLINE OF THE LANE. ALL FLAT-TOPS AND CONES ARE ASSUMED TO BE ECCENTRIC.
- 2. ALL SEWER AND WATER SERVICES CROSSED BY NEW STORM SEWERS SHALL BE PROPERLY LOCATED AND PROTECTED DURING CONSTRUCTION. ANY DAMAGE TO SAID SERVICES SHALL BE REPAIRED BY THE CONTRACTOR.
- 3. ONLY METHOD 1 UNDER ARTICLE 550.07 OF THE STANDARD SPECIFICATIONS SHALL BE ALLOWED FOR THE PLACEMENT OF TRENCH BACKFILL.

STAKING

- 1. THE CONTRACTOR SHALL PROTECT AND CAREFULLY PRESERVE ALL SECTION OR SUBSECTION MONUMENTS OR PROPERTY OR REFERENCE MARKERS UNTIL THE ENGINEER OR AN AUTHORIZED SURVEYOR HAS WITNESSED OR OTHERWISE REFERENCED THEIR LOCATIONS.
- 2. ALL RADII FOR PROPOSED CURB AND GUTTER ARE TO THE EDGE OF PAVEMENT UNLESS OTHERWISE NOTED.
- 3. THE STATION/OFFSET/ELEVATIONS NOTED FOR ALL DRAINAGE STRUCTURES LOCATED IN THE CURB LINE REFER TO THE POSITION OF THE ADJACENT PROPOSED EDGE OF PAVEMENT. THE CONTRACTOR SHALL BE RESPONSIBLE FOR DETERMINING THE OFFSET NECESSARY FOR EACH STRUCTURE TO SET THE FRAME AND GRATE IN THE PROPER LOCATION. ALL OTHER STRUCTURES ARE DIMENSIONED TO THE CENTER OF STRUCTURE.
- 4. PAVEMENT GRADES: THE ELEVATIONS INDICATED ON THE PLANS ARE FINISHED GRADES OF PROPOSED PAVEMENT, UNLESS OTHERWISE INDICATED.
- 5. THE CONSTRUCTION BASELINE HAS BEEN ESTABLISHED FOR STAKING PURPOSES ONLY AND IS NOT INTENDED TO BE A CENTERLINE OF RIGHT-OF-WAY.

LANDSCAPING

1. RESTORATION WORK WILL BE PAID FOR UP TO TWO FEET ADJACENT TO RECONSTRUCTED CURB AND GUTTER OR SIDEWALK. AREAS OUTSIDE THE TWO FOOT ZONE THAT ARE DAMAGED OR DISTURBED BY THE CONTRACTOR SHALL BE RESTORED BY THE CONTRACTOR AT HIS/HER OWN EXPENSE.

MISCELLANEOUS

- 1. UNLESS OTHERWISE AUTHORIZED BY THE ENGINEER, ALL EXISTING ACCESS POINTS SHALL BE MAINTAINED AT ALL TIMES BY THE CONTRACTOR.
- 2. THE CONTRACTOR SHALL NOT CROSS COMPLETED BINDER COURSE, OR EXISTING PAVEMENT NOT SCHEDULED TO BE REMOVED, WITH CONSTRUCTION EQUIPMENT WHICH MAY DAMAGE THE PAVEMENT.
- 3. THE CONTRACTOR SHALL CONTACT THE IDOT TRAFFIC CONTROL SUPERVISOR AT (847) 705-4470 A MINIMUM OF 72 HOURS IN ADVANCE OF BEGINNING WORK.
- 4. CURB AND GUTTER REMOVAL AND REPLACEMENT, SIDEWALK REMOVAL AND REPLACEMENT, PATCHING, AND STRUCTURES TO BE ADJUSTED WILL BE DETERMINED BY THE ENGINEER IN THE FIELD.

COMMITMENTS

1. THE VILLAGE SHALL NOTIFY THE UNION PACIFIC RAILROAD PRIOR TO THE START OF CONSTRUCTION.

F.A.U. RTE. TOTAL SHEET NO. USER NAME = djkDESIGNED -REVISED KDC SECTION COUNTY **MAIN STREET STATE OF ILLINOIS** REVISED DRAWN -JAB 19-00161-00-RS DUPAGE 67 3 INDEX, GENERAL NOTES, AND STANDARDS REVISED **DEPARTMENT OF TRANSPORTATION** CHECKED -DJK PLOT SCALE = 20.0000 ' / in. CONTRACT NO. 61G29 PLOT DATE = 12/18/2019DATE REVISED SCALE: SHEET 2 OF 2 SHEETS - 12/17/2019 ILLINOIS FED. AID PROJECT

70% FED / 30% LOCAL

ROVISION	TY ITEM	CODE NO.	ITEM	UNIT	TOTAL QUANTITY	0005	0021	0042
SPECIAL PROVISION	SPECIALTY ITEM					RESURFACING	SAFETY (TRAFFIC SIGNALS)	TRAINEES
		20101000	TEMPORARY FENCE	FOOT	80	80		
		20101000	IEMPORART FENCE	1 1001	80	80		
	Х	20101200	TREE ROOT PRUNING	EACH	2	2		
	Х	20101350	TREE PRUNING (OVER 10 INCH DIAMETER)	EACH	2	2		
		20200100	EARTH EXCAVATION	CU YD	51	51		
		20800150	TRENCH BACKFILL	CU YD	13	13		
		21101615	TOPSOIL FURNISH AND PLACE, 4"	SQ YD	634	634		
	х	25000210	SEEDING, CLASS 2A	ACRE	0.25	0.25		
	^		SELUTION GENOS EN	Aone	0.23	0,20		
	Х	25100630	EROSION CONTROL BLANKET	SQ YD	634	634		
		28000250	TEMPORARY EROSION CONTROL SEEDING	POUND	25	25		
		28000510	INLET FILTERS	EACH	75	75		
		31101180	SUBBASE GRANULAR MATERIAL, TYPE B 2"	SQ YD	721	721		
		31101200	SUBBASE GRANULAR MATERIAL, TYPE B 4"	SQ YD	101	101		
		35101500	AGGREGATE BASE COURSE, TYPE B	CU YD	7	7		
		40600290	BITUMINOUS MATERIALS (TACK COAT)	POUND	24287	24287		
		40600400	MIXTURE FOR CRACKS, JOINTS, AND FLANGEWAYS	TON	150	150		
		40600982	HOT-MIX ASPHALT SURFACE REMOVAL - BUTT JOINT	SQ·YD	192	192		

USER NAME = djk	DESIGNED	-	KDC	REVISED	-
	DRAWN	-	JAB	REVISED	-
PLOT SCALE = 1.0000 ' / in.	CHECKED	-	DJK	REVISED	-
PLOT DATE = 12/18/2019	DATE	-	12/17/2019	REVISED	-

		IV	'AIN	STRE	ET		F.A.U. RTE.	SECTION	COUNTY	TOTAL SHEETS	SHEET NO.		
SUMMARY OF QUANTITIES				2611	2611 19-00161-00-RS DUPAGE			4					
	ას	IVIIVIA	ını	טר עט	ANTITIES				CONTRAC	T NO. 6:	G29		
SHEET	1	OF	10	SHEETS	STA.	TO STA.		ILLINOIS FED, AID PROJECT					

70% FED / 30% LOCAL

SPECIAL PROVISION	SPECIALTY ITEM	CODE NO.	ITEM	UNIT	TOTAL QUANTITY	0005	0021	0042
SPECIAL F	SPECIAL					RESURFACING	SAFETY (TRAFFIC SIGNALS)	TRAINEES
				:				
		40600985	PORTLAND CEMENT CONCRETE SURFACE REMOVAL - BUTT JOINT	SQ YD	99	99		
		40602985	HOT MIX ASPHALT BINDER COURSE, IL-9.5, N70	TON	30	30		
		40603200	POLYMERIZED HOT-MIX ASPHALT BINDER COURSE, IL-4.75, N50	TON	1413	1413		
		40604062	HOT-MIX ASPHALT SURFACE COURSE, IL-9.5, MIX "D", N70	TON	3119	3119		
		42001300	PROTECTIVE COAT	SQ YD	1255	1255		
		42300200	PORTLAND CEMENT CONCRETE DRIVEWAY PAVEMENT, 6 INCH	SQ YD	67	67		
		42300400	PORTLAND CEMENT CONCRETE DRIVEWAY PAVEMENT, 8 INCH	SQ YD	89	89		
		42400200	PORTLAND CEMENT CONCRETE SIDEWALK 5 INCH	SQ FT	5759	5759		***************************************
		42400410	PORTLAND CEMENT CONCRETE SIDEWALK 8 INCH	SQ FT	126	126		
X		42400800	DETECTABLE WARNINGS	SQ FT	489	489		
			SAMELIEUT DEMONIA	CO VD	44	44	<u> </u>	
		44000100	PAVEMENT REMOVAL	SQ YD	44	44		
		44000158	HOT-MIX ASPHALT SURFACE REMOVAL, 2 1/4"	SQ YD	33689	33689	****	
		44000200	DRIVEWAY PAVEMENT REMOVAL	SQ YD	222	222		
		44000300	CURB REMOVAL	FOOT	196	196		
		44000500	COMBINATION CURB AND GUTTER REMOVAL	FOOT	1572	1572		
		44000600	SIDEWALK REMOVAL	SQ FT	5727	5727		

	5
	ŏ
₩	
뿘	
₹	
	~

USER NAME ⇔ djk	DESIGNED	-	KDC	REVISED	-
	DRAWN	-	JAB	REVISED	-
PLOT SCALE = 1,0000 ' / in.	CHECKED	-	DJK	REVISED	_
PLOT DATE = 12/18/2019	DATE		12/17/2019	REVISED	_

		N	IAIN	I STRE	ET	
	SU	MMA	RY	OF QU	ANTITIES	
SHEET	2	OF	10	SHEETS	STA.	TO STA.

F.A.U. RTE.	SECTION	COUNTY	TOTAL SHEETS	SHEET NO.
2611	19-00161-00-RS	DUPAGE	67	5
		CONTRACT	NO. 6	1G29
	ILLINOIS FED	. AID PROJECT		

70% FED / 30% LOCAL

			· · · · · · · · · · · · · · · · · · ·	· · · · · · · · · · · · · · · · · · ·			
тү ітем	CODE NO.	ITEM	UNIT	TOTAL QUANTITY	0005	0021	0042
SPECIAL					RESURFACING	SAFETY (TRAFFIC SIGNALS)	TRAINEES
	44003100	MEDIAN REMOVAL	SQ FT	442	442		
	44201761	CLASS D PATCHES TYPE I 10 INCH	SO YD	79	79		
	44201701	CEASS DI ATORES, THE 1, TO INCH	34 15	. 13	, ,		
	44201765	CLASS D PATCHES, TYPE II, 10 INCH	SQ YD	244	244		
	44201769	CLASS D PAICHES, TYPE III, 10 INCH	SQ YD	2/1	2/1		
	44201771	CLASS D PATCHES, TYPE IV, 10 INCH	SQ YD	306	306	-	

	45200100	JOINT OR CRACK ROUTING (PC CONCRETE PAVEMENT AND SHOULDER)	FOOT	4500	4500		
	550A0050	STORM SEWERS, CLASS A, TYPE 1 12"	FOOT	53	53		
	55100500	STORM SEWER REMOVAL 12"	FOOT	7	7		
							-
	56500600	DOMESTIC WATER SERVICE BOXES TO BE ADJUSTED	EACH	1	1		
	60108204	PIPE UNDERDRAINS, TYPE 2, 4"	FOOT	50	50		
			51011				
	60201105	CAICH BASINS, TYPE A, 4'-DIAMETER, TYPE II FRAME AND GRATE	EACH	1	1		
	60206905	CATCH BASINS, TYPE C, TYPE 1 FRAME, OPEN LID	EACH	1	1		
	60236800	INLETS, TYPE A, TYPE 11 FRAME AND GRATE	EACH	1	1		
	60266600	VALVE BOXES TO BE ADJUSTED	EACH	2	2		
	60404800	FRAMES AND GRATES, TYPE 11	EACH	2	2		
	SPECIALTY ITEM	44201761 44201765 44201769 44201771 45200100 550A0050 55100500 60108204 60206905 60236800 60266600	44201761 CLASS D PATCHES, TYPE I, 10 INCH 44201765 CLASS D PATCHES, TYPE II, 10 INCH 44201769 CLASS D PATCHES, TYPE III, 10 INCH 44201771 CLASS D PATCHES, TYPE IV, 10 INCH 45200100 JOINT OR CRACK ROUTING (PC CONCRETE PAVEMENT AND SHOULDER) 550A0050 STORM SEWERS, CLASS A, TYPE I 12" 55100500 STORM SEWER REMOVAL 12" 5600600 DOMESTIC WATER SERVICE BOXES TO BE ADJUSTED 60108204 PIPE UNDERDRAINS, TYPE 2, 4" 60201105 CATCH BASINS, TYPE A, 4"-DIAMETER, TYPE 11 FRAME AND GRATE 60206905 CATCH BASINS, TYPE A, 4"-DIAMETER, TYPE 11 FRAME AND GRATE 60236800 INLETS, TYPE A, TYPE 11 FRAME, OPEN LID	44003100 MEDIAN REMOVAL S0 FT	116M 116M	Color No. Colo	

	÷
	ć
	Ü
8	ź
Ξ	2
2	S
E	č
ō	
3	ú

USER NAME = djk	DESIGNED -	KDC	REVISED -
	DRAWN -	JAB	REVISED -
PLOT SCALE = 1,0000 ' / in,	CHECKED -	DJK	REVISED -
PLOT DATE = 13/19/2010	DATE	12/17/2010	DEVISED

SUMMARY OF QUANTITIES								
	SHEET	3	OF	10	SHEETS	STA.	TO STA.	

F.A.U. RTE.	SECTION	COUNTY	SHEETS	SHEET NO.
2611	19-00161-00-RS	DUPAGE	67	6
		CONTRACT	NO. 6	IG29
	ILLINOIS FED. A	ID PROJECT		

70% FED / 30% LOCAL

				·, · · · · · · · · · · · · · · · · · ·	· · · · · · · · · · · · · · · · · · ·	l		
SPECIAL PROVISION	SPECIALTY ITEM	CODE NO.	ITEM	UNIT	TOTAL QUANTITY	0005	0021	0042
SPECIAL P	SPECIAL					RESURFACING	SAFETY (TRAFFIC SIGNALS)	TRAINEES
		50406400	TOWER WELVES TYPE LOUGED IN	5400		0		
		60406100	FRAMES AND LIDS, TYPE 1, CLOSED LID	EACH	2	2		
		60500050	REMOVING CATCH BASINS .	EACH	2	2		
		60500060	REMOVING INLETS	EACH	1	1		
		60603800	COMBINATION CONCRETE CURB AND GUTTER, TYPE B-6.12	FOOT	1577	1577		
		60619600	CONCRETE MEDIAN, TYPE SB-6.12	SQ FT	156	156		
X	X	66900200	NON-SPECIAL WASTE DISPOSAL	CU YD	25	25		
X	X	66900530	SOIL DISPOSAL ANALYSIS	EACH	1	1		
X	Χ	66901001	REGULATED SUBSTANCES PRE-CONSTRUCTION PLAN	L SUM	1	1		
X	X	66901003	REGULATED SUBSTANCES FINAL CONSTRUCTION REPORT	L SUM	1	1		
X	Х	66901006	REGULATED SUBSTANCES MONITORING	CAL DA	10	10		
		67100100	MOBILIZATION	L SUM	1	1		
		70102620	TRAFFIC CONTROL AND PROTECTION, STANDARD 701501	L SUM	1	1		
		70102625	TRAFFIC CONTROL AND PROTECTION, STANDARD 701606	L SUM	1	1		
		70102632	TRAFFIC CONTROL AND PROTECTION, STANDARD 701602	L SUM	1	1		
		70102634	TRAFFIC CONTROL AND PROTECTION, STANDARD 701611	L SUM	1	1		
		70102635	TRAFFIC CONTROL AND PROTECTION, STANDARD 701701	L SUM	1	1		

USER NAME = djk	DESIGNED	-	KDC	REVISED	-
	DRAWN	_	JAB	REVISED	-
PLOT SCALE = 1.0000 ' / in.	CHECKED	-	DJK	REVISED	-
PLOT DATE = 12/18/2019	DATE	-	12/17/2019	REVISED	-

	SU	MMA	RY	OF QU	ANTITIES	
SHEET	4	OF	10	SHEETS	STA.	TO STA.

RTE.	SECT	COUNTY	SHEETS	NO.		
2611	19-0016	1-00-RS	DUPAGE	67	7	
				CONTRACT	NO. 6	IG29
		ILLINOIS	FED. A	D PROJECT		

70% FED / 30% LOCAL

SPECIAL PROVISION	SPECIALTY ITEM	CODE NO.	ITEM	UNIT	TOTAL QUANTITY	0005	0021	0042
SPECIAL F	SPECIAL					RESURFACING	SAFETY (TRAFFIC SIGNALS)	TRAINEES
						1		
		70102640	TRAFFIC CONTROL AND PROTECTION, STANDARD 701801	L SUM	1	1		
		70107025	CHANGEABLE MESSAGE SIGN	CAL DA	240	240		
		70300100	SHORT TERM PAVEMENT MARKING	F00T	14178	14178		
					_	_		
		70300150	SHORT TERM PAVEMENT MARKING REMOVAL	SQ FT	4726	4726		
-		70300210	TEMPORARY PAVEMENT MARKING LETTERS AND SYMBOLS	SQ FT	577	577		
		70300220	TEMPORARY PAVEMENT MARKING - LINE 4"	F00T	16278	16278		
		70300240	TEMPORARY PAVEMENT MARKING - LINE 6"	FOOT	2920	2920		
		70300260	TEMPORARY PAVEMENT MARKING - LINE 12"	FOOT	301	301		
		70300280	TEMPORARY PAVEMENT MARKING - LINE 24"	FOOT	1754	1754		
	100	70400100	DENOVE CLON CANEL ACCENTALY TYPE A	E A CUI	2	2		
	Х	72400100	REMOVE SIGN PANEL ASSEMBLY - TYPE A	EACH	2	2		
	Х	72400500	RELOCATE SIGN PANEL ASSEMBLY - TYPE A	EACH	2	2		
	X	72800100	TELESCOPING STEEL SIGN SUPPORT	F00T	29	29		
	X	78000100	THERMOPLASTIC PAVEMENT MARKING - LETTERS AND SYMBOLS	SQ FT	577	577		
	Х	78000200	THERMOPLASTIC PAVEMENT MARKING - LINE 4"	FOOT	16278	16278		
	Х	78000400	THERMOPLASTIC PAVEMENT MARKING - LINE 6"	FOOT	2920	2920		
	Х	78000600	THERMOPLASTIC PAVEMENT MARKING - LINE 12"	FOOT	301	301		:

ë	12220-441-500
\$	į
Ε.	3
Θ	U
JEL: \$MODEL	N. C.

USER NAME = djk	DESIGNED	-	KDC	REVISED	-
	DRAWN	-	JAB	REVISED	-
PLOT SCALE = 1,0000 ' / in,	CHECKED	-	DJK	REVISED	-
PLOT DATE = 12/18/2019	DATE	-	12/17/2019	REVISED	-

MAIN STREET										
		SU	MMA	RY	OF QUA	ANTITIES	3			
	SHEET	5	OF	10	SHEETS	STΔ	TO ST			

F.A.U. RTE.	SECTION	COUNTY	TOTAL SHEETS	SHEET NO.	
2611	19-00161-00-RS	DUPAGE	67	8	
			CONTRACT	NO. 6	1G29
	ILLINOIS	FED. A	D PROJECT		

70% FED / 30% LOCAL

SPECIAL PROVISION	SPECIALTY ITEM	CODE NO.	ITEM	UNIT	TOTAL QUANTITY	0005	0021	0042
SPECIAL	SPECIAL					RESURFACING	SAFETY (TRAFFIC SIGNALS)	TRAINEES
-	X	78000650	THERMOPLASTIC PAVEMENT MARKING - LINE 24"	FOOT	1754	1754		
-		18000830	THERMOPLASTIC PAVEMENT MARKING - LINE 24	1001	1137	1134		
	х	78009000	MODIFIED URETHANE PAVEMENT MARKING - LETTERS AND SYMBOLS	SQ FT	37	37		
	X	78009004	MODIFIED URETHANE PAVEMENT MARKING - LINE 4"	FOOT	1523	1523		
	х	78009006	MODIFIED URETHANE PAVEMENT MARKING - LINE 6"	FOOT	490	490	,	
	X	78009012	MODIFIED URETHANE PAVEMENT MARKING - LINE 12"	FOOT	649	649		
	X	78009024	MODIFIED URETHANE PAVEMENT MARKING - LINE 24"	FOOT	183	183		
	Х	81028200	UNDERGROUND CONDUIT, GALVANIZED STEEL, 2" DIA.	FOOT	46		46	
	Х	81028220	UNDERGROUND CONDUIT, GALVANIZED STEEL, 3" DIA.	FOOT	45		45	·
							_	
	X	81028240	UNDERGROUND CONDUIT, GALVANIZED STEEL, 4" DIA.	FOOT	5		5	
	Х	81603047	UNIT DUCT, 600V, 3-1C NO.6, 1/C NO.6 GROUND, (XLP-TYPE USE), 1 1/4" DIA. POLYETHYLENE	FOOT	93		93	
	X	81702130	ELECTRIC CABLE IN CONDUIT, 600V (XLP-TYPE USE) 1/C NO. 6	FOOT	153		153	
X	X	85000200	MAINTENANCE OF EXISTING TRAFFIC SIGNAL INSTALLATION	EACH	2		2	
X	Х	85100500	PAINT NEW TRAFFIC SIGNAL POST	EACH	3		3	
		05100000		FACU				
X	X	85100800	PAINT NEW COMBINATION MAST ARM AND POLE, UNDER 40 FOOT	EACH	1		1	
	Х	87301215	ELECTRIC CABLE IN CONDUIT, SIGNAL NO. 14 2C	FOOT	452		452	
	Х	87301245	ELECTRIC CABLE IN CONDUIT, SIGNAL NO. 14 5C	FOOT	196		196	

	5
	4
*	4
w	
- 22	
•	C
2	-
	•
Ξ	-
Ω	*
\overline{a}	
\simeq	
2.	ú
*	-
	•
- 23	•
TD:	2
0	
=	L

USER NAME = djk	DESIGNED	-	KDC	REVISED	-
	DRAWN	-	JAB	REVISED	-
PLOT SCALE = 1.0000 ' / in.	CHECKED	-	DJK	REVISED	-
PLOT DATE = 12/18/2019	DATE	-	12/17/2019	REVISED	-

STATI	E OF	ILLINOIS
DEPARTMENT	OF	TRANSPORTATION

		SU		AAIN NRY	AIN STREET RY OF QUANTITIES 10 SHEETS STA. TO STA.						

RTE.	SECTION		COUNTY	SHEETS	NO.
2611	19-00161-00-RS		DUPAGE	67	9
			CONTRACT	NO, 63	lG29
	ILLINOIS	FED. A	ID PROJECT		

70% FED / 30% LOCAL

SPECIAL PROVISION	SPECIALTY ITEM	CODE NO.	DE NO. ITEM		TOTAL QUANTITY	0005	0021	0042
SPECIAL (SPECIAL					RESURFACING	SAFETY (TRAFFIC SIGNALS)	TRAINEES
	Х	87301255	ELECTRIC CABLE IN CONDUIT, SIGNAL NO. 14 7C	FOOT	208		208	
	х	87301900	ELECTRIC CABLE IN CONDUIT, EQUIPMENT GROUNDING CONDUCTOR, NO. 6 1C	FOOT	64		64	
X	Х	87702930	STEEL COMBINATION MAST ARM ASSEMBLY AND POLE 40 FT.	EACH	1		1	
X	Х	87800415	CONCRETE FOUNDATION, TYPE E 36-INCH DIAMETER	FOOT	13		13	
	X.	87900200	DRILL EXISTING HANDHOLE	EACH	5		5	
Х	Х	88030020	SIGNAL HEAD, LED, 1-FACE, 3-SECTION, MAST-ARM MOUNTED	EACH	1		1	
X	Х	88200410	TRAFFIC SIGNAL BACKPLATE, LOUVERED, FORMED PLASTIC	EACH	3		3	
Х	Х	88800100	PEDESTRIAN PUSH-BUTTON	EACH	4		4	
	Х	89500100	RELOCATE EXISTING SIGNAL HEAD	EACH	2		2	
	Х	89500200	RELOCATE EXISTING PEDESTRIAN SIGNAL HEAD	EACH	1		1	
	X	89502200	MODIFY EXISTING CONTROLLER	EACH	2		2	
	х	89502300	REMOVE ELECTRIC CABLE FROM CONDUIT	FOOT	630		630	
	х	89502350	REMOVE AND REINSTALL ELECTRIC CABLE FROM CONDUIT	FOOT	114		114	
	v	00500335	DEMONE EVICTING TO FETA CIONNA FOR MODERN	E 4 0 11				
×	X	89502375	REMOVE EXISTING TRAFFIC SIGNAL EQUIPMENT	EACH	2		2	
Х	Х	89502376	REBUILD EXISTING HANDHOLE	EACH	12		12	
	Х	89502385	REMOVE EXISTING CONCRETE FOUNDATION	EACH	1		1	***************************************

	٤
	ă
	ġ
	S
ŝ	ż
ξ	8.5
ž	328
료	3
8	1

USER NAME = djk	DESIGNED	-	KDC	REVISED -	
	DRAWN	-	JAB	REVISED -	
PLOT SCALE = 1.0000 ' / in.	CHECKED	-	DJK	REVISED -	
PLOT DATE = 12/18/2019	DATE	_	12/17/2019	REVISED -	

MAIN STREET							
MAIN STREET SUMMARY OF QUANTITIES SHEET 7 OF 10 SHEETS STA. TO STA.							
 SHEET	7	OF	10	SHEETS	STA.	TO STA.	

F.A.U. RTE.	SECTION	COUNTY	TOTAL SHEETS	SHEET NO.
2611	· 19-00161-00-RS	DUPAGE	67	10
	Management of the second of th	CONTRACT	NO. 6	1G29
	ILLINOIS FED.	AID PROJECT		

70% FED / 30% LOCAL

SPECIAL PROVISION	SPECIALTY ITEM	CODE NO.	ITEM	UNIT	TOTAL QUANTITY	0005	0021	0042
SPECIAL F	SPECIAL					RESURFACING	SAFETY (TRAFFIC SIGNALS)	TRAINEES
	ļ							
X	X	K1005482	SHREDDED BARK MULCH, 4"	SQ YD	99	99		
X	X	X0320586	FLEXIBLE DELINEATORS	EACH	6	6		
X	×	X0323986	RELOCATE EXISTING VIDEO VEHICLE DETECTOR	EACH	4		4	
X		X0325225	BRICK PAVEMENT REMOVAL AND REPLACEMENT	SQ FT	2267	2267		
×		X0326863	BRICK SIDEWALK	SQ FT	320	320		
×		X0327980	PAVEMENT MARKING REMOVAL - WATER BLASTING	SQ FT	3055	3055		
X		X1700011	STAMPED COLORED PORTLAND CEMENT CONCRETE MEDIAN SURFACE 4 INCH	SQ FT	253	253		
X		X2130010	EXPLORATION TRENCH, SPECIAL	FOOT	100	100		
X		X4021000	TEMPORARY ACCESS (PRIVATE ENTRANCE)	EACH	5	5		
	\Box							
Х		X4022000	TEMPORARY ACCESS (COMMERCIAL ENTRANCE)	EACH	5	5		
<u></u>				CO VD	101	101		
X		X4401198	HOT-MIX ASPHALT SURFACE REMOVAL, VARIABLE DEPTH	SQ YD	101	101		
X		X6030310	FRAMES AND LIDS TO BE ADJUSTED (SPECIAL)	EACH	108	108		
X	Х	X7830060	GROOVING FOR RECESSED PAVEMENT MARKING, LETTERS AND SYMBOLS	SQ FT	577	577		
X	X	X7830070	GROOVING FOR RECESSED PAVEMENT MARKING 5"	FOOT	16278	16278		

X	Х	X7830074	GROOVING FOR RECESSED PAVEMENT MARKING 7"	FOOT	2920	2920		
-		V7830079	CHOOMING FOR RECESSED PAVEMENT MARKING 13"	FOOT	301	301		
Х	X	X7830078	GROOVING FOR RECESSED PAVEMENT MARKING 13"	FUUT	J01	201		

	4
	0
ME\$	4
LNA	0000
SOP	2

USER NAME = djk	DESIGNED	-	KDC	REVISED	-
	DRAWN	-	JAB	REVISED	-
PLOT SCALE = 1,0000 ' / in.	CHECKED	-	DJK	REVISED	-
PLOT DATE = 12/18/2019	DATE	_	12/17/2019	REVISED	-

	MAIN STREET									
	SU	MMA	RY	OF QU	ANTITIES					
SHEET	8	OF	10	SHEETS	STA.	TO STA.				

F.A.U. RTE. SECTION		COUNTY	TOTAL SHEETS	SHEET NO.
2611 19-00161-00-RS		DUPAGE	67	11
		CONTRACT	NO. 6	1G29
	ILLINOIS FED. A	ID PROJECT		

70% FED / 30% LOCAL

SPECIAL PROVISION	SPECIALTY ITEM	CODE NO.	ITEM	UNIT	TOTAL QUANTITY	0005	0021	0042
SPECIAL	SPECIAL					RESURFACING	SAFETY (TRAFFIC SIGNALS)	TRAINEES
X	Х	X7830090	GROOVING FOR RECESSED PAVEMENT MARKING 25"	FOOT	1754	1754		
X	Х	X8440102	RELOCATE EXISTING LUMINAIRE	EACH	1		1	
X	X	X8780010	CONCRETE FOUNDATION, TYPE A 10-INCH DIAMETER	FOOT	12		12	
×	X	X8900100	TEMPORARY TRAFFIC SIGNAL INSTALLATION (SPECIAL)	EACH	1		1	
X		XX005293	CONCRETE HEADER BAND	FOOT	322	322		
×		XX006821	CONCRETE TRUCK WASHOUT	L SUM	1	1		
X		XX007759	ADJUST SANITARY SEWER CLEANOUT	EACH	1	1		
×	Х	XX008169	PEDESTRIAN PUSH-BUTTON POST, SPECIAL	EACH	3		3	
X		Z0004514	HOT-MIX ASPHALT DRIVEWAY PAVEMENT, 4"	SQ YD	67	67		
×		Z0013798	CONSTRUCTION LAYOUT	L SUM	1	1		
×		20017400	DRAINAGE & UTILITY STRUCTURES TO BE ADJUSTED	EACH	6	6		
×		Z0017700	DRAINAGE & UTILITY STRUCTURES TO BE RECONSTRUCTED	EACH	3	3		
×		Z0030850	TEMPORARY INFORMATION SIGNING	SQ FT	300	300		
×	х	Z0033028	MAINTENANCE OF LIGHTING SYSTEM	CAL MO	6		6	
×		Z0038119	PORTLAND CEMENT CONCRETE SURFACE REMOVAL 1 1/2"	SQ YD	3438	3438		
X		Z0048665	RAILROAD PROTECTIVE LIABILITY INSURANCE	L SUM	1	1		

...\3328-sht-50Q.dgn

USER NAME = djk	DESIGNED	-	KDC	REVISED	-
	DRAWN	-	JAB	REVISED	-
PLOT SCALE = 1.0000 ' / in.	CHECKED	-	DJK	REVISED	•
PLOT DATE = 12/18/2019	DATE	-	12/17/2019	REVISED	-

STATI	E OF	ILLINOIS
DEPARTMENT	OF	TRANSPORTATION

		SU			STRE	ET ANTITIES	3
SCALE:	SHEET	9	OF	10	SHEETS	STA.	TO STA.

	RTE.	SECTION	COUNTY	SHEETS	NO.
	2611	19-00161-00-RS	DUPAGE	67	12
			CONTRACT	NO. 6	1G29
		ILLINOIS FEE	, AID PROJECT		
-		TECHNOIS TEC	A ALO TROJECT		

70% FED / 30% LOCAL


PROVISION	тү ітем	CODE NO.	ITEM	UNIT	TOTAL QUANTITY	0005	0021	0042
SPECIAL F	SPECIALTY					RESURFACING	SAFETY (TRAFFIC SIGNALS)	TRAINEES
×		Z0062458	TEMPORARY PAVEMENT (VARIABLE DEPTH)	TON	.15	15		
X	х	Z0073510	TEMPORARY TRAFFIC SIGNAL TIMING	EACH	1		1	
Х		Z0076600	TRAINEES	HOUR	500			500
X		Z0076604	TRAINEES TRAINING PROGRAM GRADUATE	HOUR	500			500

MODEL: \$MODELNAME\$

STATE OF ILLINOIS
DEPARTMENT OF TRANSPORTATION

SCALE: SHEET 10 OF 10 SHEETS STA.

TO STA.

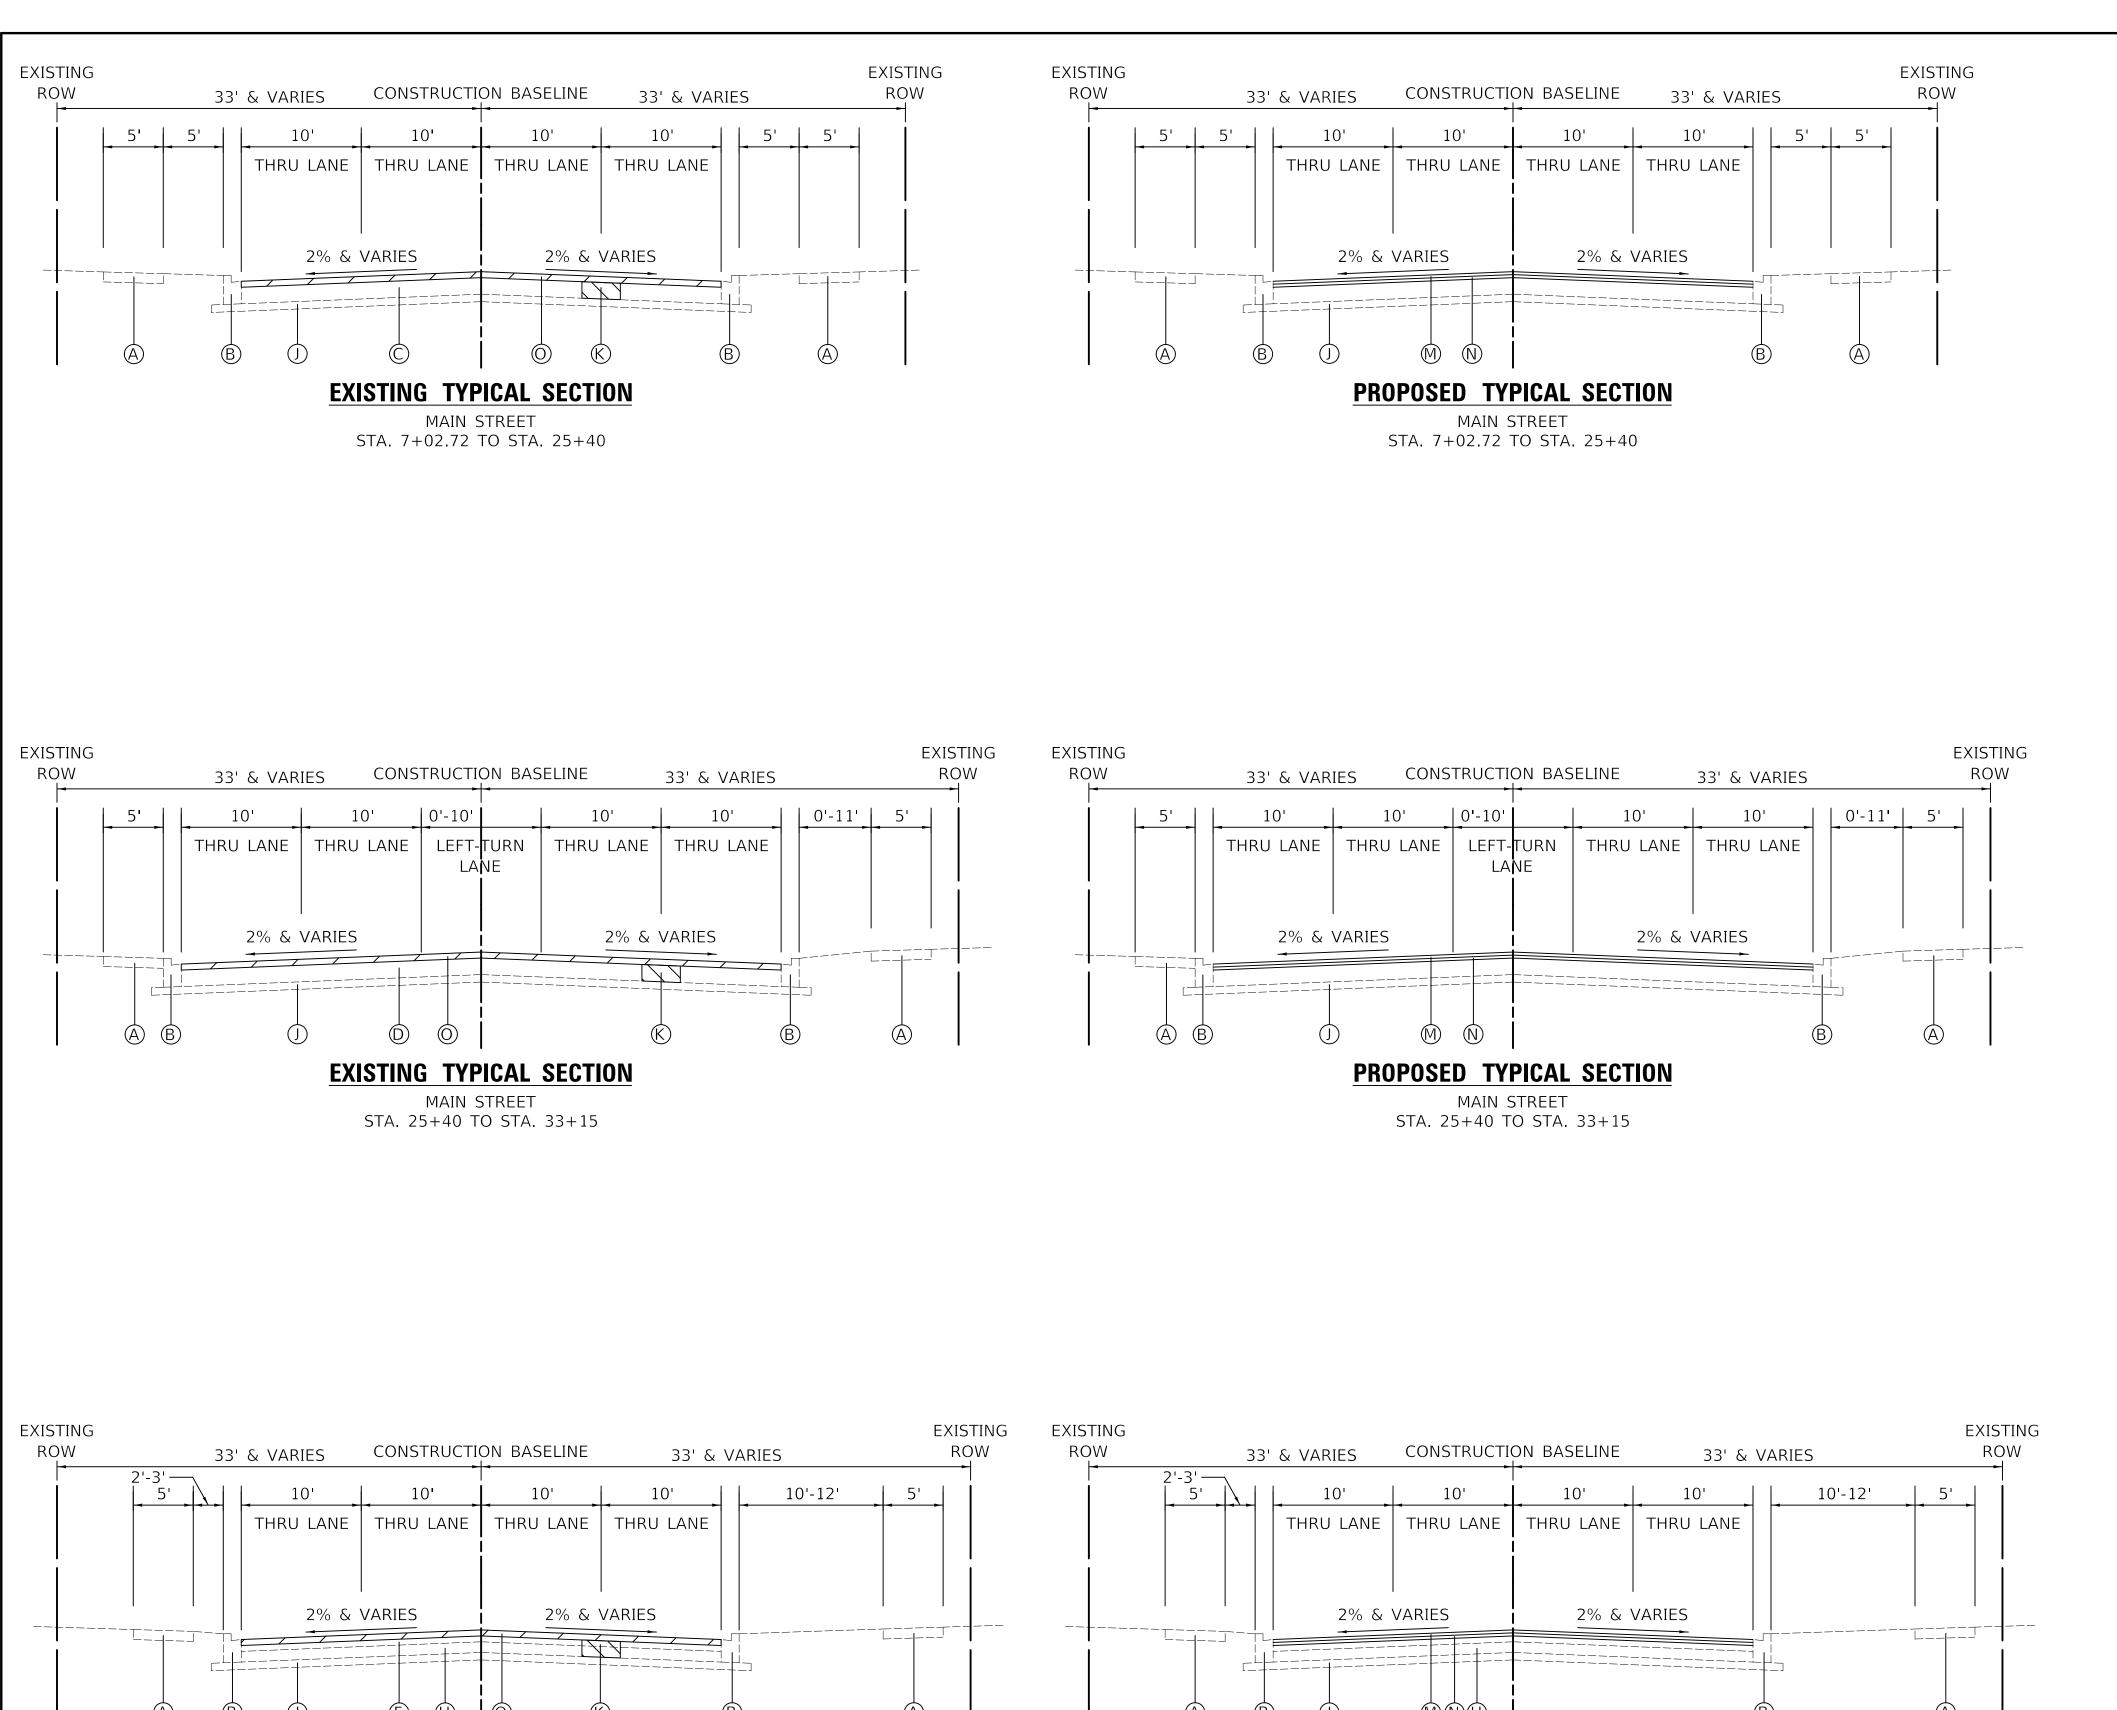

EXISTING TYPICAL SECTION

MAIN STREET

STA. 33+15 TO STA. 36+00

LEGEND

- EXISTING CONCRETE SIDEWALK
- (R) EXISTING COMBINATION CONCRETE CURB
- AND GUTTER, TYPE B-6.12
- © EXISTING HOT-MIX ASPHALT PAVEMENT, VARIES 6"-9"
- (D) EXISTING HOT-MIX ASPHALT PAVEMENT, 11"
- (E) EXISTING HOT-MIX ASPHALT PAVEMENT, 12"
- F) EXISTING HOT-MIX ASPHALT PAVEMENT, 4"
- (G) EXISTING PORTLAND CEMENT CONCRETE PAVEMENT, 10"
- (H) EXISTING PORTLAND CEMENT CONCRETE PAVEMENT, 8" & VARIES
- I) EXISTING PORTLAND CEMENT CONCRETE PAVEMENT, 4" & VARIES
- CONCRETE I
- ① EXISTING AGGREGATE BASE
- PROPOSED CLASS D PATCH
- (LOCATION TO BE DETERMINED IN THE FIELD BY THE ENGINEER)
- (L) EXISTING PAVING BRICK SIDEWALK
- M HOT-MIX ASPHALT SURFACE COURSE, MIX "D", IL-9.5, N70 $1\frac{1}{2}$ "
- \widehat{N} POLYMERIZED HOT-MIX ASPHALT BINDER COURSE, IL-4.75, N50 $\frac{3}{4}$ "
- HOT-MIX ASPHALT SURFACE REMOVAL, $2\frac{1}{4}$ "
- EXISTING RETAINING WALL
- EXISTING RAILING
- R EXISTING BRIDGE ABUTMENT
- \bigcirc PORTLAND CEMENT CONCRETE SURFACE REMOVAL, $1\frac{1}{2}$ "

REMOVAL

CLASS D PATCHES (THICKNESS AS SPECIFIED)

HOT-MIX ASPHALT MIXTURE REQUIREMENTS						
MIXTURE TYPE	AIR VOIDS @ Ndes					
ROADWAY RESURFACING						
HOT-MIX ASPHALT SURFACE COURSE, MIX "D", IL-9.5, N70; $1\frac{1}{2}$ "	4% @ 70 GYR.					
POLYMERIZED HOT-MIX ASPHALT BINDER COURSE, IL-4.75, N50 ¾"	3.5% @ 50 GYR.					
HOT MIX ASPHALT BINDER COURSE, IL-9.5, N70, $1\frac{1}{2}$ " (MIN) (FOR USE AS DIRECTED BY THE ENGINEER)	4% @ 70 GYR.					
CLASS D PATCHES						
CLASS D PATCH (HMA BINDER IL-19mm)	4% @ 70 GYR.					
HOT-MIX ASPHALT DRIVEWAY PAVEMENT, 4"						
HOT-MIX ASPHALT SURFACE COURSE, MIX "D", IL-9.5, N50; $1\frac{1}{2}$ "	4% @ 50 GYR.					
HOT-MIX ASPHALT BINDER COURSE, IL-19.0, N50; 2½" 4% @ 50 GYR.						
TEMPORARY PAVEMENT (VARIABLE DEPTH)						
HOT-MIX ASPHALT BINDER COURSE, IL-9.5, N70; VARIABLE DEPTH	4% @ 70 GYR.					

NOTES:


- 1. THE UNIT WEIGHT TO CALCULATE ALL HOT-MIX ASPHALT SURFACE MIXTURES IS 112 LB/SY-IN.
- 2. THE "AC TYPE" FOR POLYMERIZED HMA MIXES SHALL BE "SBS/SBR PG 76-22" AND FOR NON-POLYMERIZED HMA THE "AC TYPE" SHALL BE "PG 64-22" UNLESS MODIFIED BY DISTRICT ONE SPECIAL PROVISIONS.
- 3. FOR USE OF RECYCLED MATERIALS SEE SPECIAL PROVISIONS.
- 4. THE CONTRACTOR SHALL MILL THE PAVEMENT BEFORE PATCHING.

USER NAME = djk	DESIGNED - KDC	REVISED -	OTATE OF HILINOIS		MAIN STR	EET	F.A.U. RTE.	SECTION	COUNTY TOTAL SHEET SHEETS NO.
DRAW	DRAWN - JAB	REVISED -	STATE OF ILLINOIS				2611	19-00161-00-RS	DUPAGE 67 14
PLOT SCALE = 20.0000 ' / in.	CHECKED - DJK	REVISED -	DEPARTMENT OF TRANSPORTATION	TYPICAL SECTIONS				CONTRACT NO. 61G29	
PLOT DATE = 12/18/2019	DATE - 12/17/2019	REVISED -		SCALE: NTS	SHEET 1 OF 3 SHEETS			ILLINOIS FED.	AID PROJECT

PROPOSED TYPICAL SECTION

MAIN STREET

STA. 33+15 TO STA. 36+00

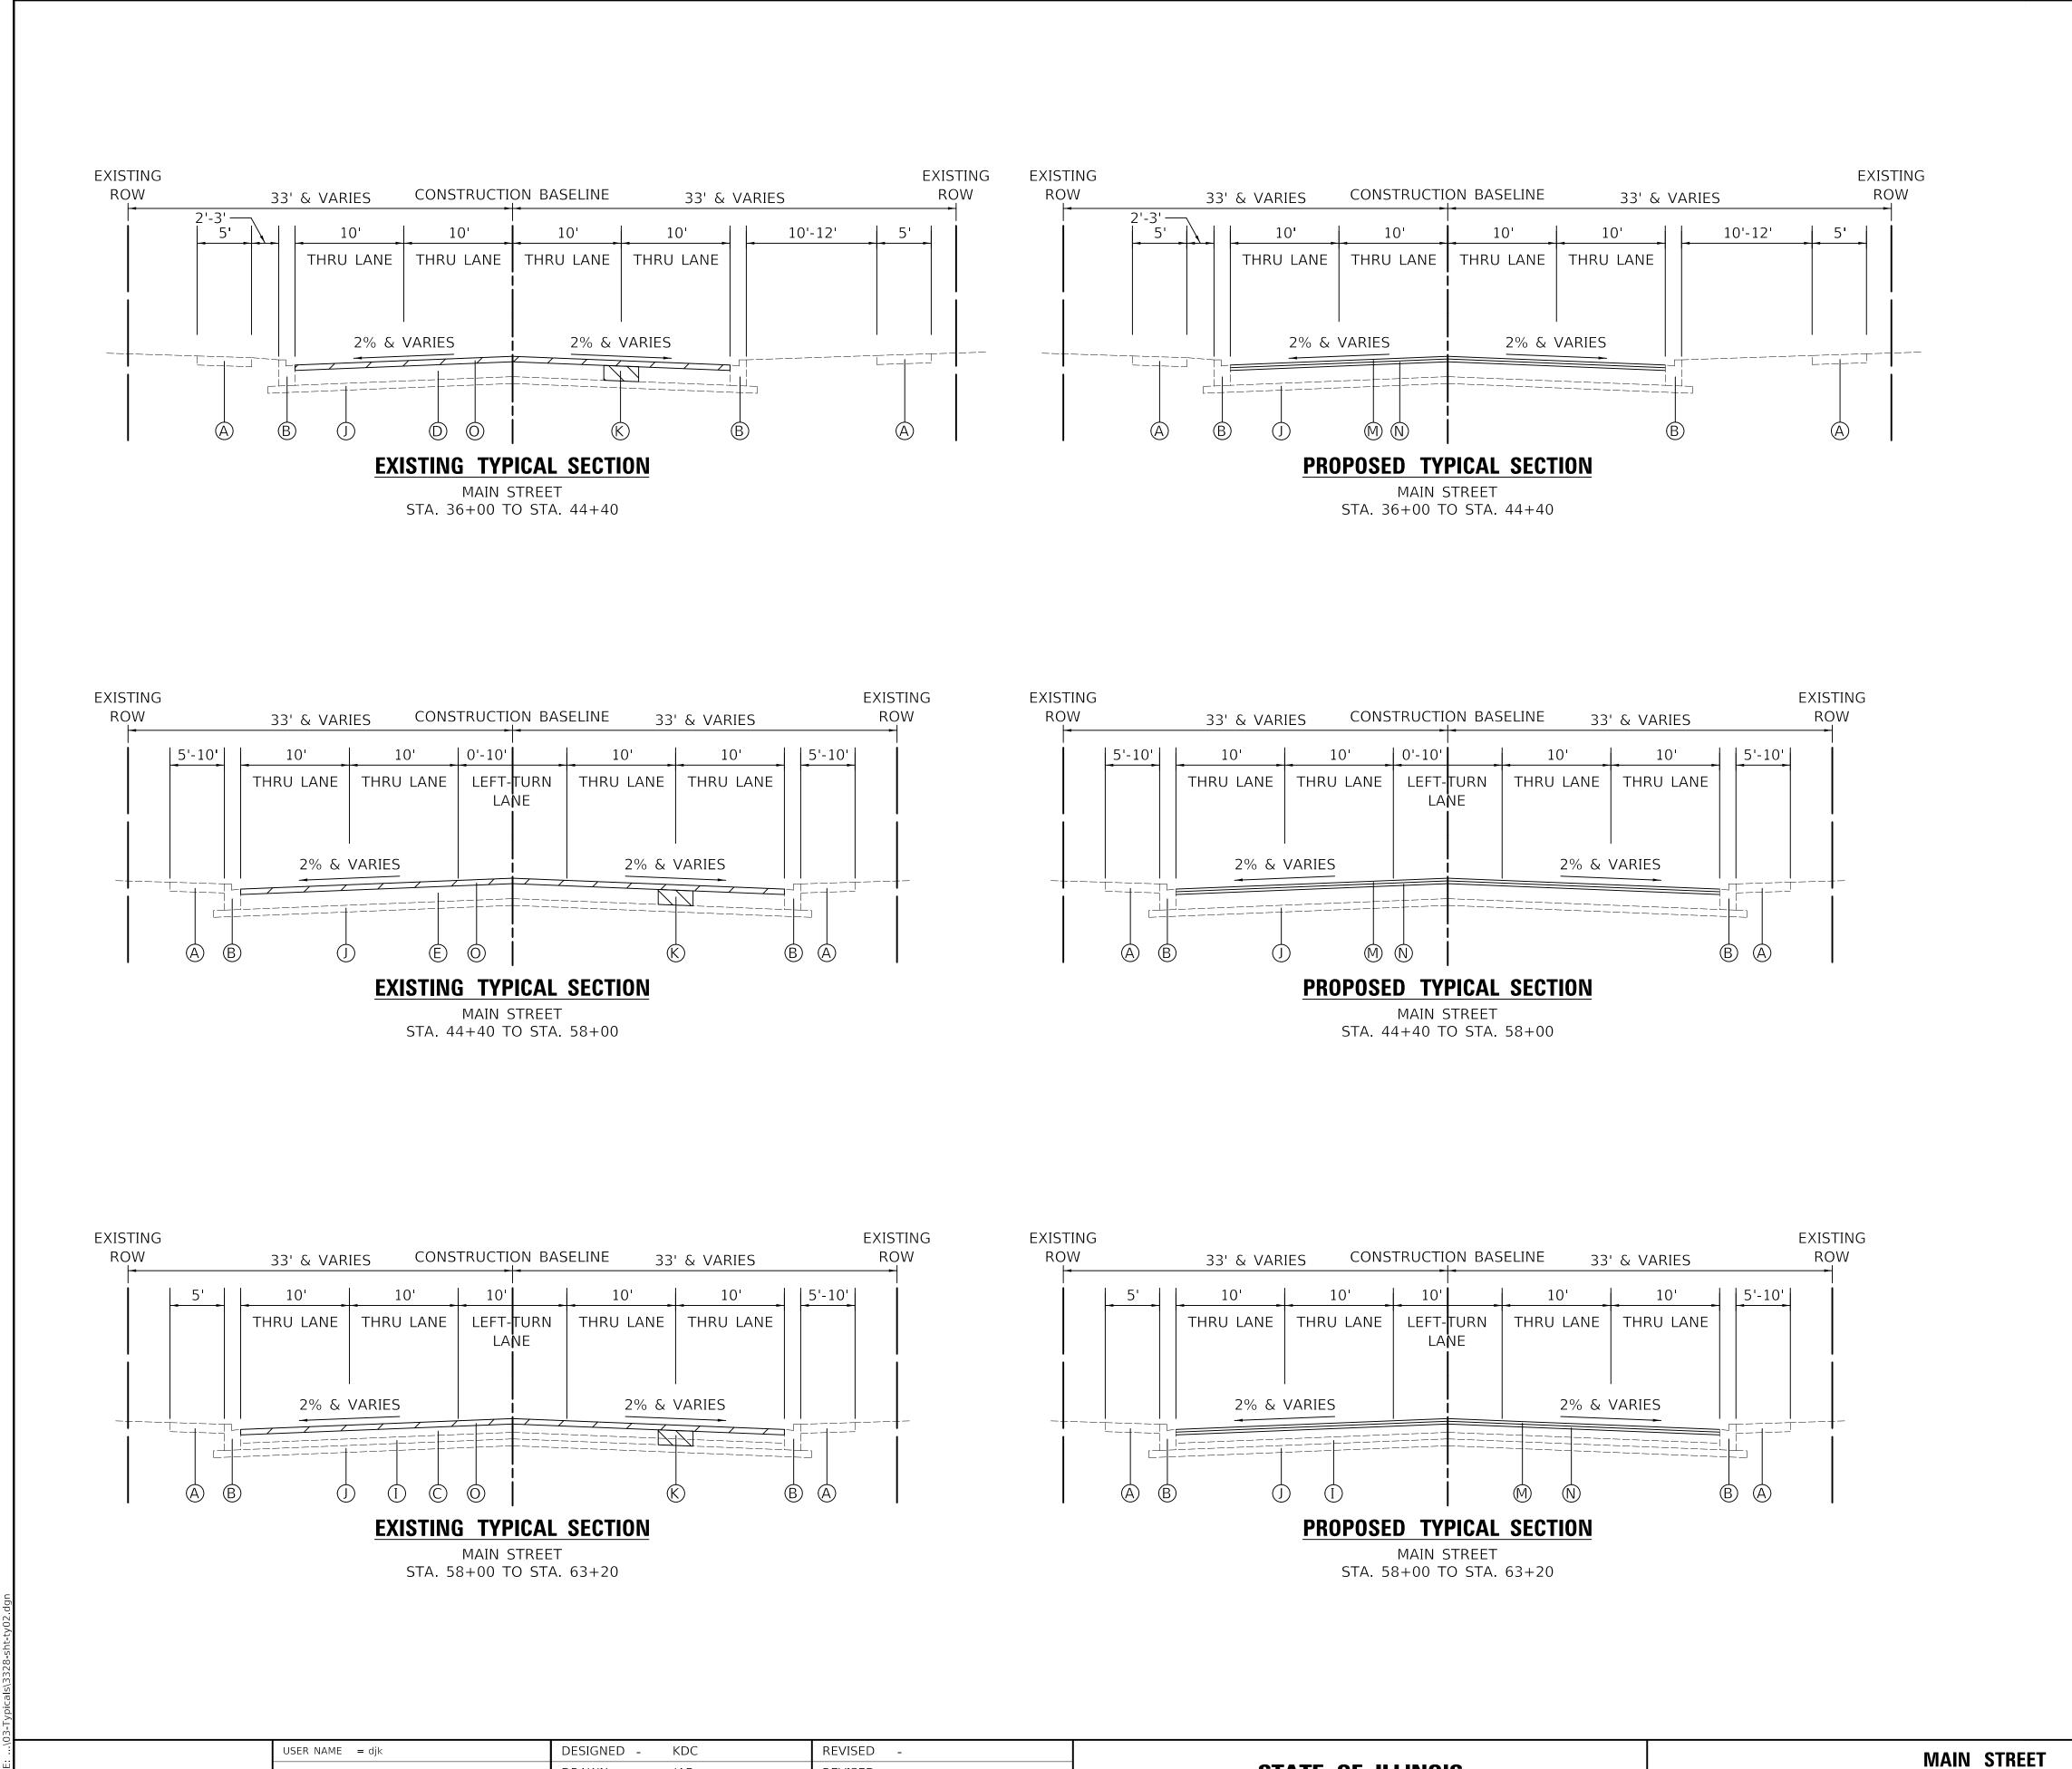

REVISED

REVISED

REVISED

DRAWN

DATE

PLOT SCALE = 20.0000 ' / in.

PLOT DATE = 12/18/2019

CHECKED -

JAB

- 12/17/2019

STATE OF ILLINOIS

DEPARTMENT OF TRANSPORTATION

LEGEND

- A EXISTING CONCRETE SIDEWALK
- B) EXISTING COMBINATION CONCRETE CURB
- AND GUTTER, TYPE B-6.12
- © EXISTING HOT-MIX ASPHALT PAVEMENT, VARIES 6"-9"
- \bigcirc EXISTING HOT-MIX ASPHALT PAVEMENT, 11"
- (E) EXISTING HOT-MIX ASPHALT PAVEMENT, 12"
- (F) EXISTING HOT-MIX ASPHALT PAVEMENT, 4"
- © EXISTING PORTLAND CEMENT CONCRETE PAVEMENT, 10"
- EXISTING PORTLAND CEMENT CONCRETE PAVEMENT, 8" & VARIES

 EXISTING PORTLAND CEMENT CONCRETE PAVEMENT, 4" & VARIES
- (J) EXISTING AGGREGATE BASE
- PROPOSED CLASS D PATCH
- ee (LOCATION TO BE DETERMINED IN THE FIELD BY THE ENGINEER)
- (L) EXISTING PAVING BRICK SIDEWALK
- HOT-MIX ASPHALT SURFACE COURSE, MIX "D", IL-9.5, N70 $1\frac{1}{2}$ "
- $extstyle{\mathbb{N}}$ POLYMERIZED HOT-MIX ASPHALT BINDER COURSE, IL-4.75, N50 $extstyle{3}/ extstyle{4}$ "
-) HOT-MIX ASPHALT SURFACE REMOVAL, $2\frac{1}{4}$ "
- (P) EXISTING RETAINING WALL
- EXISTING RAILING
- R EXISTING BRIDGE ABUTMENT
- $\widehat{\mathsf{S}}$ PORTLAND CEMENT CONCRETE SURFACE REMOVAL, $1\frac{1}{2}$ "

TOTAL SHEET NO.

67 | 15

COUNTY

DUPAGE

ILLINOIS FED. AID PROJECT

CONTRACT NO. 61G29

SECTION


19-00161-00-RS

TYPICAL SECTIONS

SCALE: NTS SHEET 2 OF 3 SHEETS





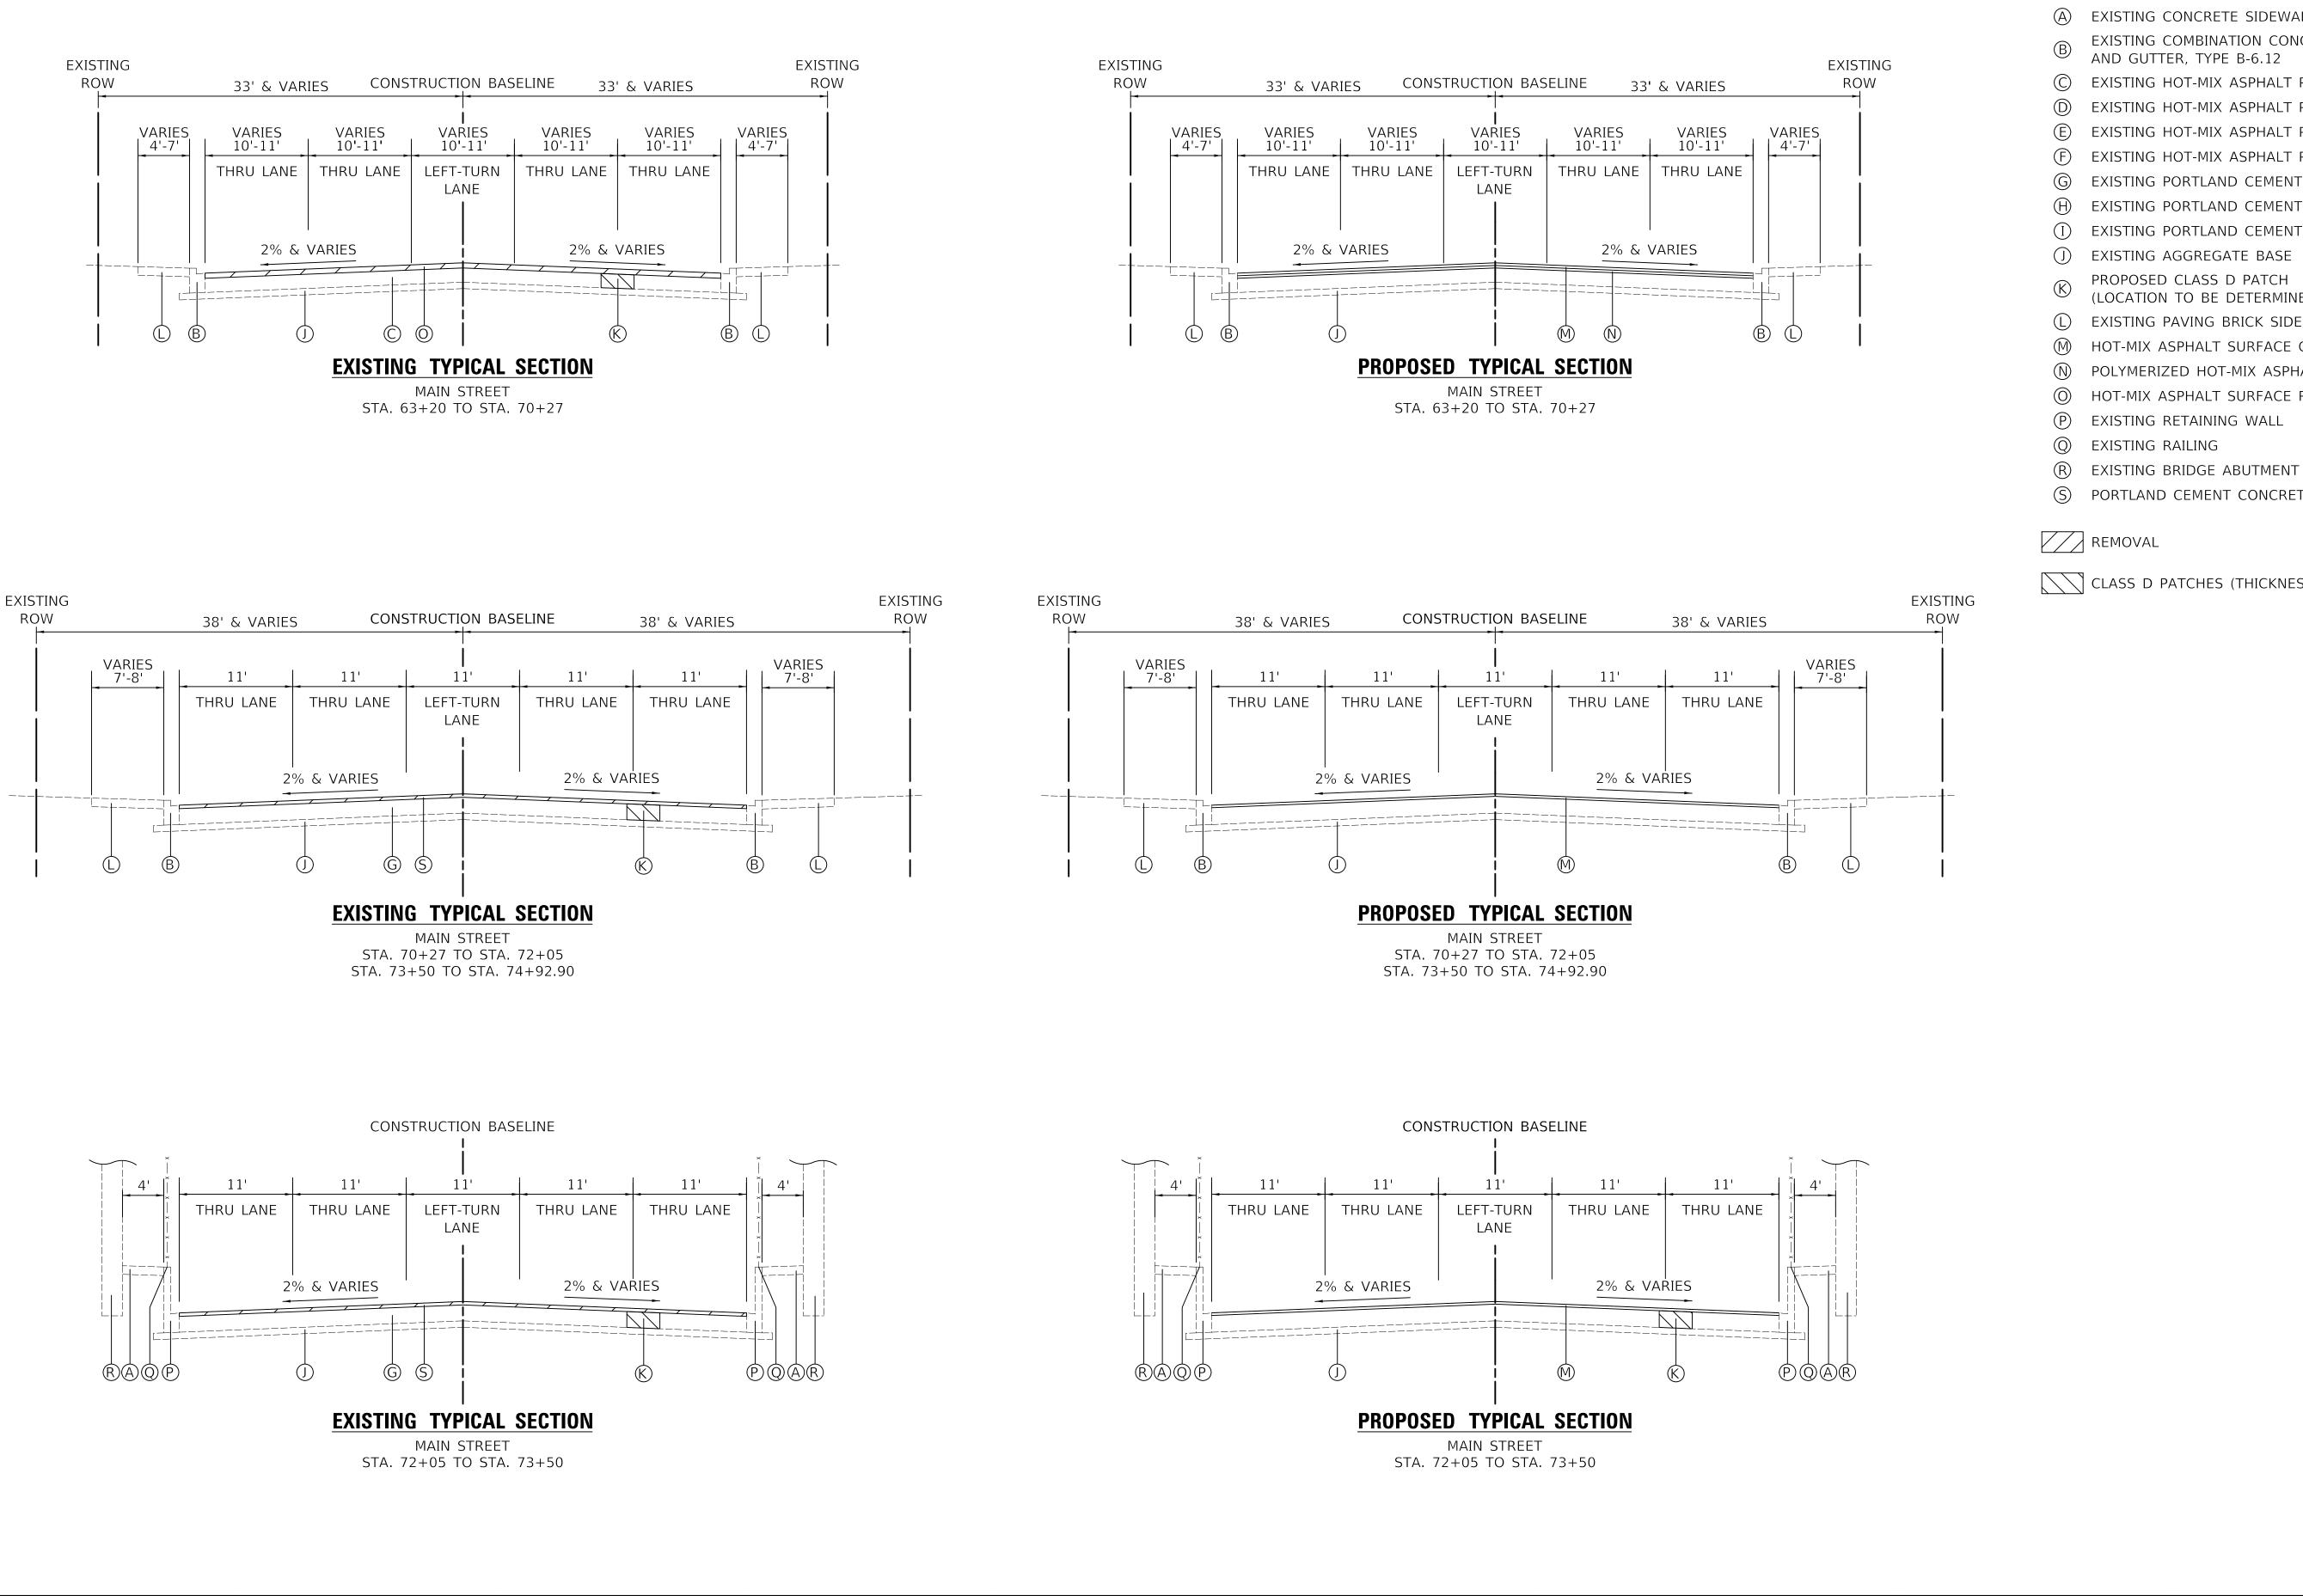

USER NAME = djk

PLOT SCALE = 20.0000 ' / in.

PLOT DATE = 12/18/2019

DESIGNED -

CHECKED -

DRAWN

DATE

KDC

JAB

DJK

- 12/17/2019

REVISED

REVISED

REVISED

REVISED

LEGEND

A EXISTING CONCRETE SIDEWALK

EXISTING COMBINATION CONCRETE CURB

AND GUTTER, TYPE B-6.12

EXISTING HOT-MIX ASPHALT PAVEMENT, VARIES 6"-9"

EXISTING HOT-MIX ASPHALT PAVEMENT, 11"

EXISTING HOT-MIX ASPHALT PAVEMENT, 12"

EXISTING HOT-MIX ASPHALT PAVEMENT, 4"

EXISTING PORTLAND CEMENT CONCRETE PAVEMENT, 10"

EXISTING PORTLAND CEMENT CONCRETE PAVEMENT, 8" & VARIES

EXISTING PORTLAND CEMENT CONCRETE PAVEMENT, 4" & VARIES

EXISTING AGGREGATE BASE

PROPOSED CLASS D PATCH

(LOCATION TO BE DETERMINED IN THE FIELD BY THE ENGINEER)

EXISTING PAVING BRICK SIDEWALK

HOT-MIX ASPHALT SURFACE COURSE, MIX "D", IL-9.5, N70 $1\frac{1}{2}$ "

POLYMERIZED HOT-MIX ASPHALT BINDER COURSE, IL-4.75, N50 ¾"


HOT-MIX ASPHALT SURFACE REMOVAL, 21/4"

EXISTING RETAINING WALL

 \bigcirc PORTLAND CEMENT CONCRETE SURFACE REMOVAL, $1\frac{1}{2}$ "

CLASS D PATCHES (THICKNESS AS SPECIFIED)

F.A.U. RTE. TOTAL SHEET NO. SECTION COUNTY **MAIN STREET STATE OF ILLINOIS** 19-00161-00-RS DUPAGE 67 | 16 TYPICAL SECTIONS **DEPARTMENT OF TRANSPORTATION** CONTRACT NO. 61G29 SHEET 3 OF 3 SHEETS SCALE: NTS ILLINOIS FED. AID PROJECT

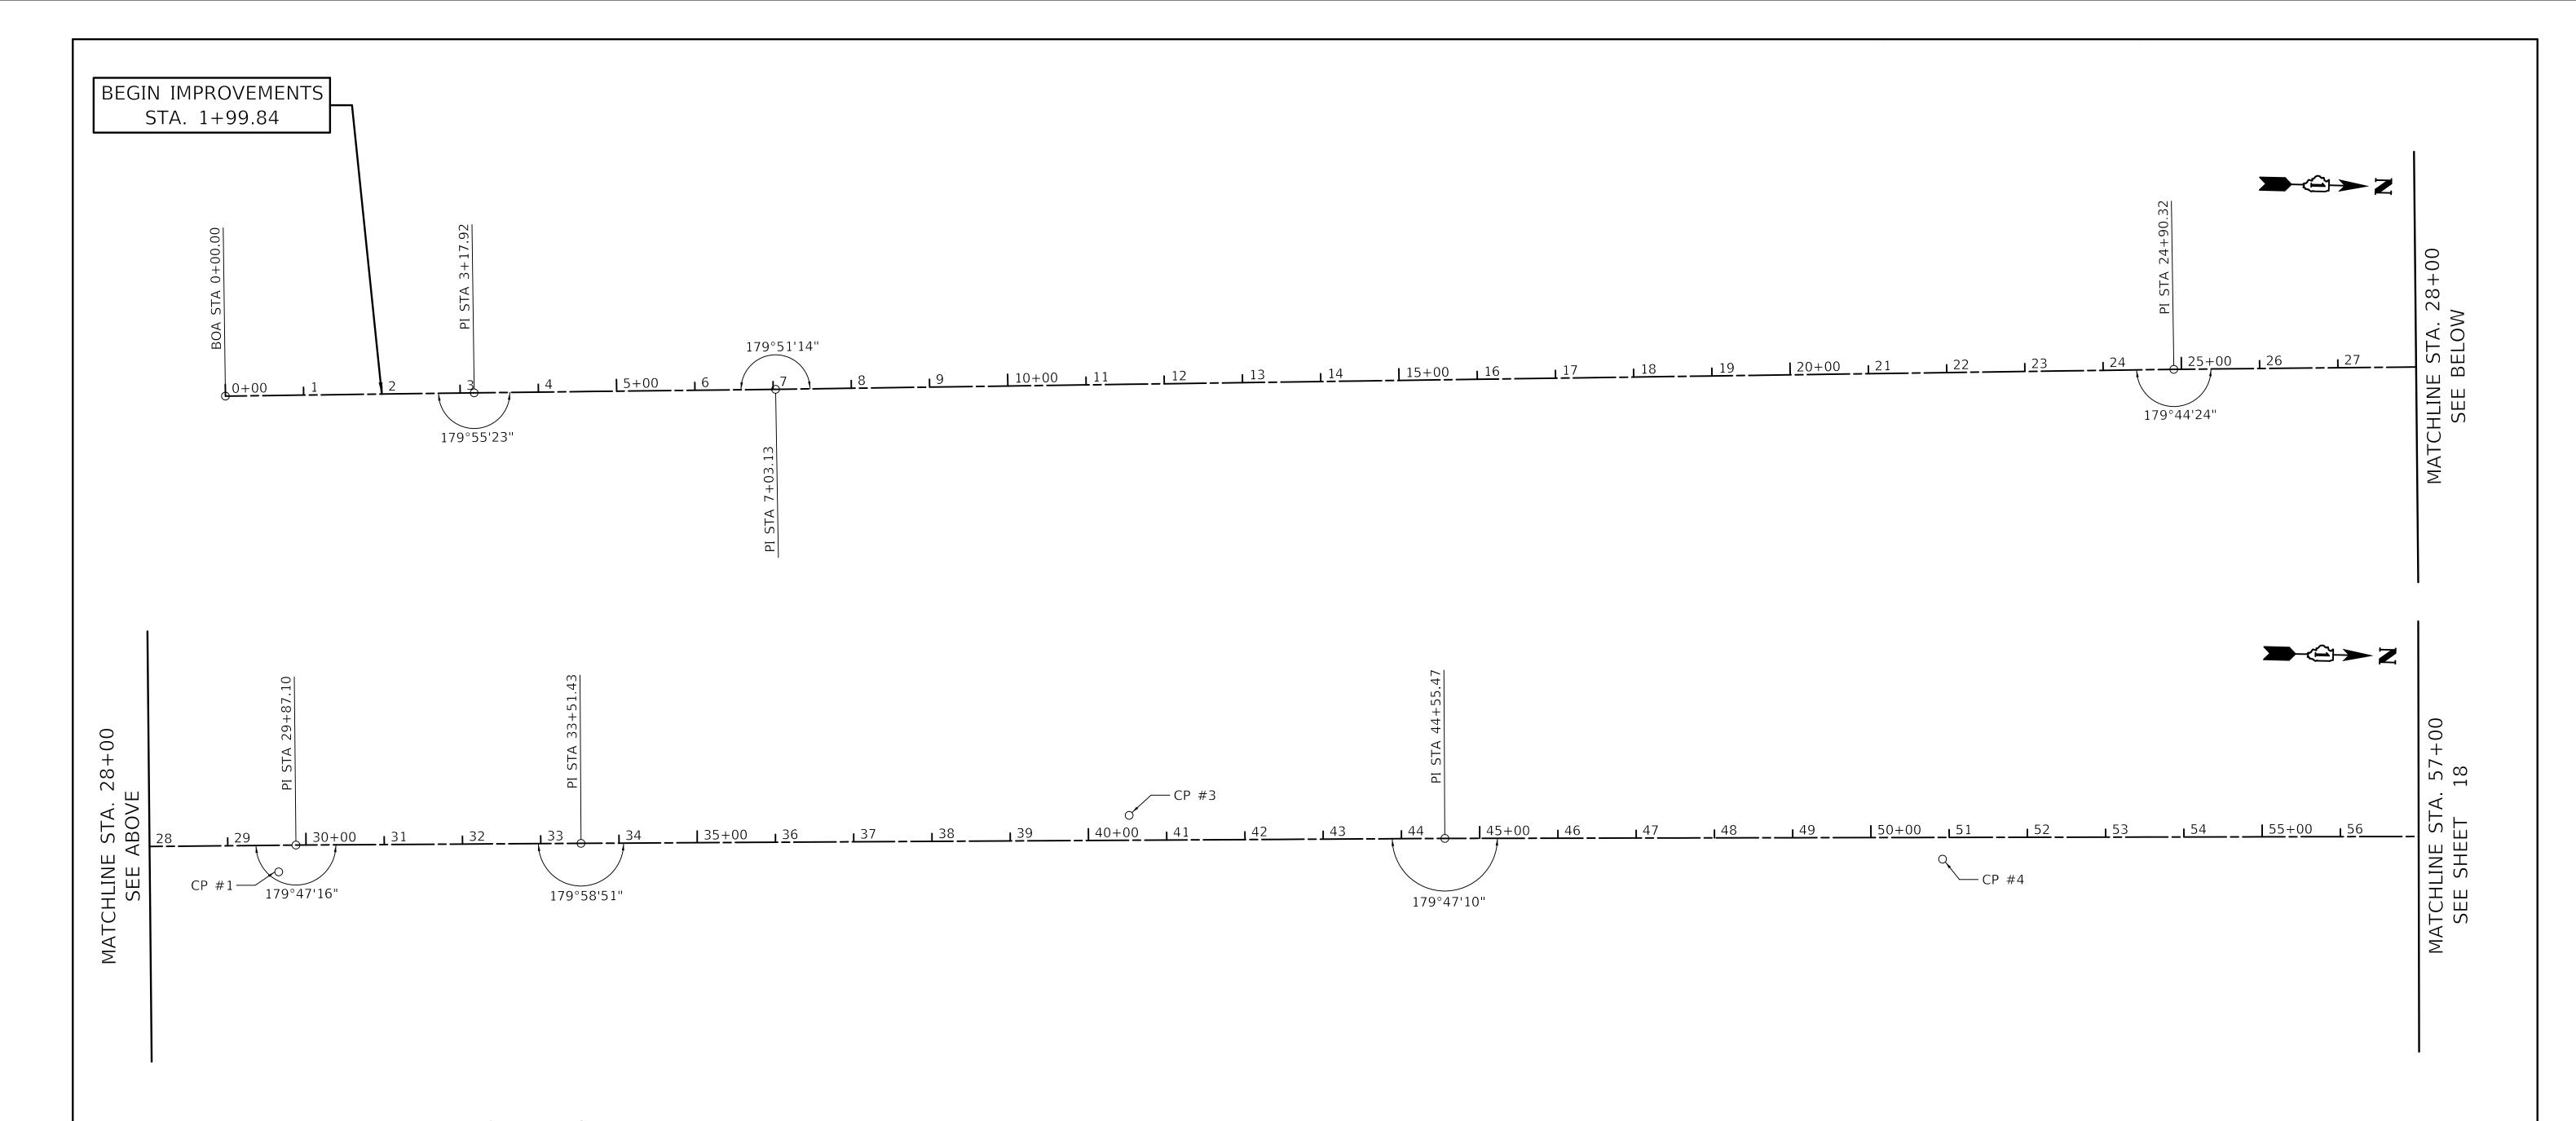

BENCHMARKS

TBM NO.	LOCATION	ELEVATION	DESCRIPTION
1	NORTHWEST CORNER OF MAIN ST AND MADISON ST	736.58	CROSS CUT (SET) IN NW FLANGE BOLT OF FIRE HYDRANT
2	SOUTHWEST CORNER OF MAIN ST AND W WASHINGTON BLVD	721.34	CROSS CUT (SET) IN NW FLANGE BOLT OF FIRE HYDRANT
3	NORTHWEST CORNER OF MAIN ST AND HICKORY ST	702.42	CROSS CUT (SET) IN NW FLANGE BOLT OF FIRE HYDRANT
4	NORTHWEST CORNER OF MAIN ST AND MAPLE ST	707.80	CROSS CUT (SET) IN NW FLANGE BOLT OF FIRE HYDRANT

NOTE: ELEVATIONS ARE BASED ON NGVD29

CONTROL POINTS

STATION NO.	NORTHING	EASTING	STATION	OFFSET
CP #1	1897118.51	1070153.64	29+64.76	34.02' RT
CP #2	1900515.23	1070055.96	63+63.14	27.89' RT
CP #3	1898203.38	1070056.18	40+52.13	31.76' LT
CP #4	1899243.96	1070087.90	50+91.46	50+91.46

MAIN STREET ALIGNMENT DATA

POINT	STATION	NORTHING	EASTING
ВОА	0+00.00	1,894,154.592	1,070,227.432
PI	3+17.92	1,894,472.305	1,070,215.879
PI	7+03.13	1,894,857.277	1,070,202.400
PI	24+90.32	1,896,643.204	1,070,135.306
PI	29+87.10	1,897,139.713	1,070,118.908
PI	33+51.43	1,897,503.890	1,070,108.231
PI	44+55.47	1,898,607.469	1,070,076.243
PI	69+09.30	1,901,060.513	1,070,014.297
PI	70+19.07	1,901,170.283	1,070,015.193
PI	71+72.74	1,901,323.905	1,070,011.396
PI	75+24.10	1,901,674.167	1,070,039.162
EOA	78+38.44	1,901,988.560	1,070,045.145

MAIN STREET




USER NAME = djk	DESIGNED - KDC	REVISED -	CTATE OF HILINOIS	MAIN STREET	F.A.U. RTE.	SECTION	COUNTY	TOTAL SHEETS	SHEET NO.
	DRAWN - JAB	REVISED -	STATE OF ILLINOIS	ALIGNMENT TIES AND BENCHMARKS	2611	19-00161-00-RS	DUPAGE	67	17
PLOT SCALE = 100.0000 ' / in.	CHECKED - DJK	REVISED -	DEPARTMENT OF TRANSPORTATION	ALIGINIZITI TIEG AND BENGTINIATING			CONTRACT	T NO. 6	1G29
PLOT DATE = $12/18/2019$	DATE - 12/17/2019	REVISED -		SCALE: 1"=100' SHEET 1 OF 2 SHEETS		ILLINOIS FED.	AID PROJECT		



E STA. 57+00 IEET 17	57 <u>ı</u> 58	<u>, 59</u>	<u>[60+00</u> <u>[6</u>	<u>1</u> <u>1</u> 62	6364	<u> 65+00</u> <u> 66</u>	676	78°6'59" 170+00 71 170+00 72	 176°33'27"	EOA STA 78+38.44
MATCHLINE SEE SHEE					CP #	2		174°3'5"	PI Sta 75+24.10	END IMPROVEMENTS STA. 75+54.35



USER NAME = djk	DESIGNED - KDC	REVISED -		MAIN STREET	F.A.U. SECTION	COUNTY TOTAL SHEET SHEETS NO.
	DRAWN - JAB	REVISED -	STATE OF ILLINOIS	ALIGNMENT TIES AND BENCHMARKS	2611 19-00161-00-RS	S DUPAGE 67 18
PLOT SCALE = 100.0000 ' / in.	CHECKED - DJK	REVISED -	DEPARTMENT OF TRANSPORTATION	ALIGIVINEIT TIES AID BEITOINVAIRS	·	CONTRACT NO. 61G29
PLOT DATE = 12/18/2019	DATE - 12/17/2019	REVISED -		SCALE: 1"=100' SHEET 2 OF 2 SHEETS	ILLINOIS	S FED. AID PROJECT

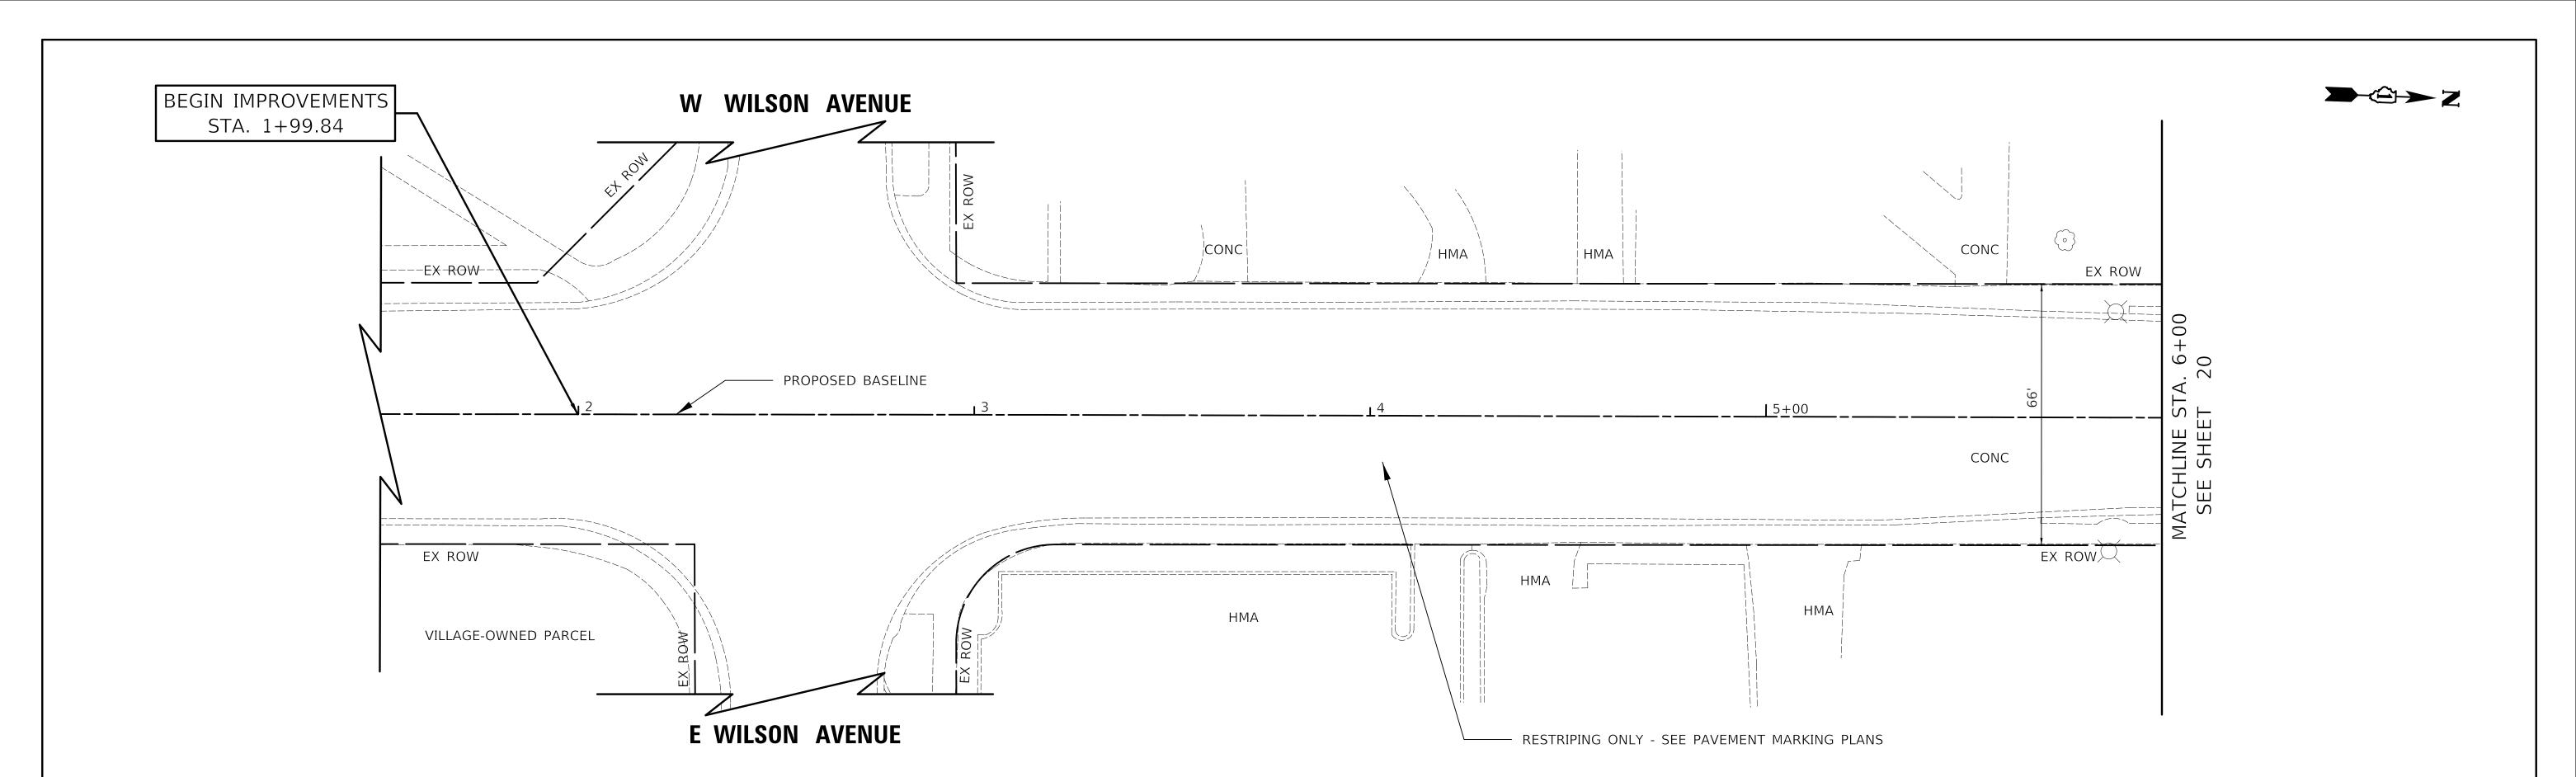



HMA SURFACE REMOVAL, 21/4"

SIDEWALK REMOVAL

FRAMES AND LIDS TO BE ADJUSTED (SPECIAL)

DETECTABLE WARNINGS


PCC SURFACE REMOVAL, 1½"


COMBINATION CONCRETE CURB AND GUTTER REMOVAL COMBINATION CONCRETE CURB AND GUTTER, TYPE B-6.12


DRAINAGE & UTILITY STRUCTURE TO BE ADJUSTED OR VALVE BOXES TO BE ADJUSTED


	0	20	40	6
MAIN STREET	SCAL	E IN FEET		


MAIN STREET REVISED - ROC REVISED - COLUMN SECTION	
DRAWN - JAB REVISED - STATE OF ILLINOIS RESURFACING PLAN RESURFA	UPAGE 67 19
PLOT SCALE = 20.0000 ' / in. CHECKED - DJK REVISED - DEPARTMENT OF TRANSPORTATION	NTRACT NO. 61G29
PLOT DATE = 12/18/2019 DATE - 12/17/2019 REVISED - ILLINOIS FED. AID PROJECT SCALE: 1"=20" SHEET 1 OF 8 SHEETS STA. 1+50 TO STA. 6+00	JJECT

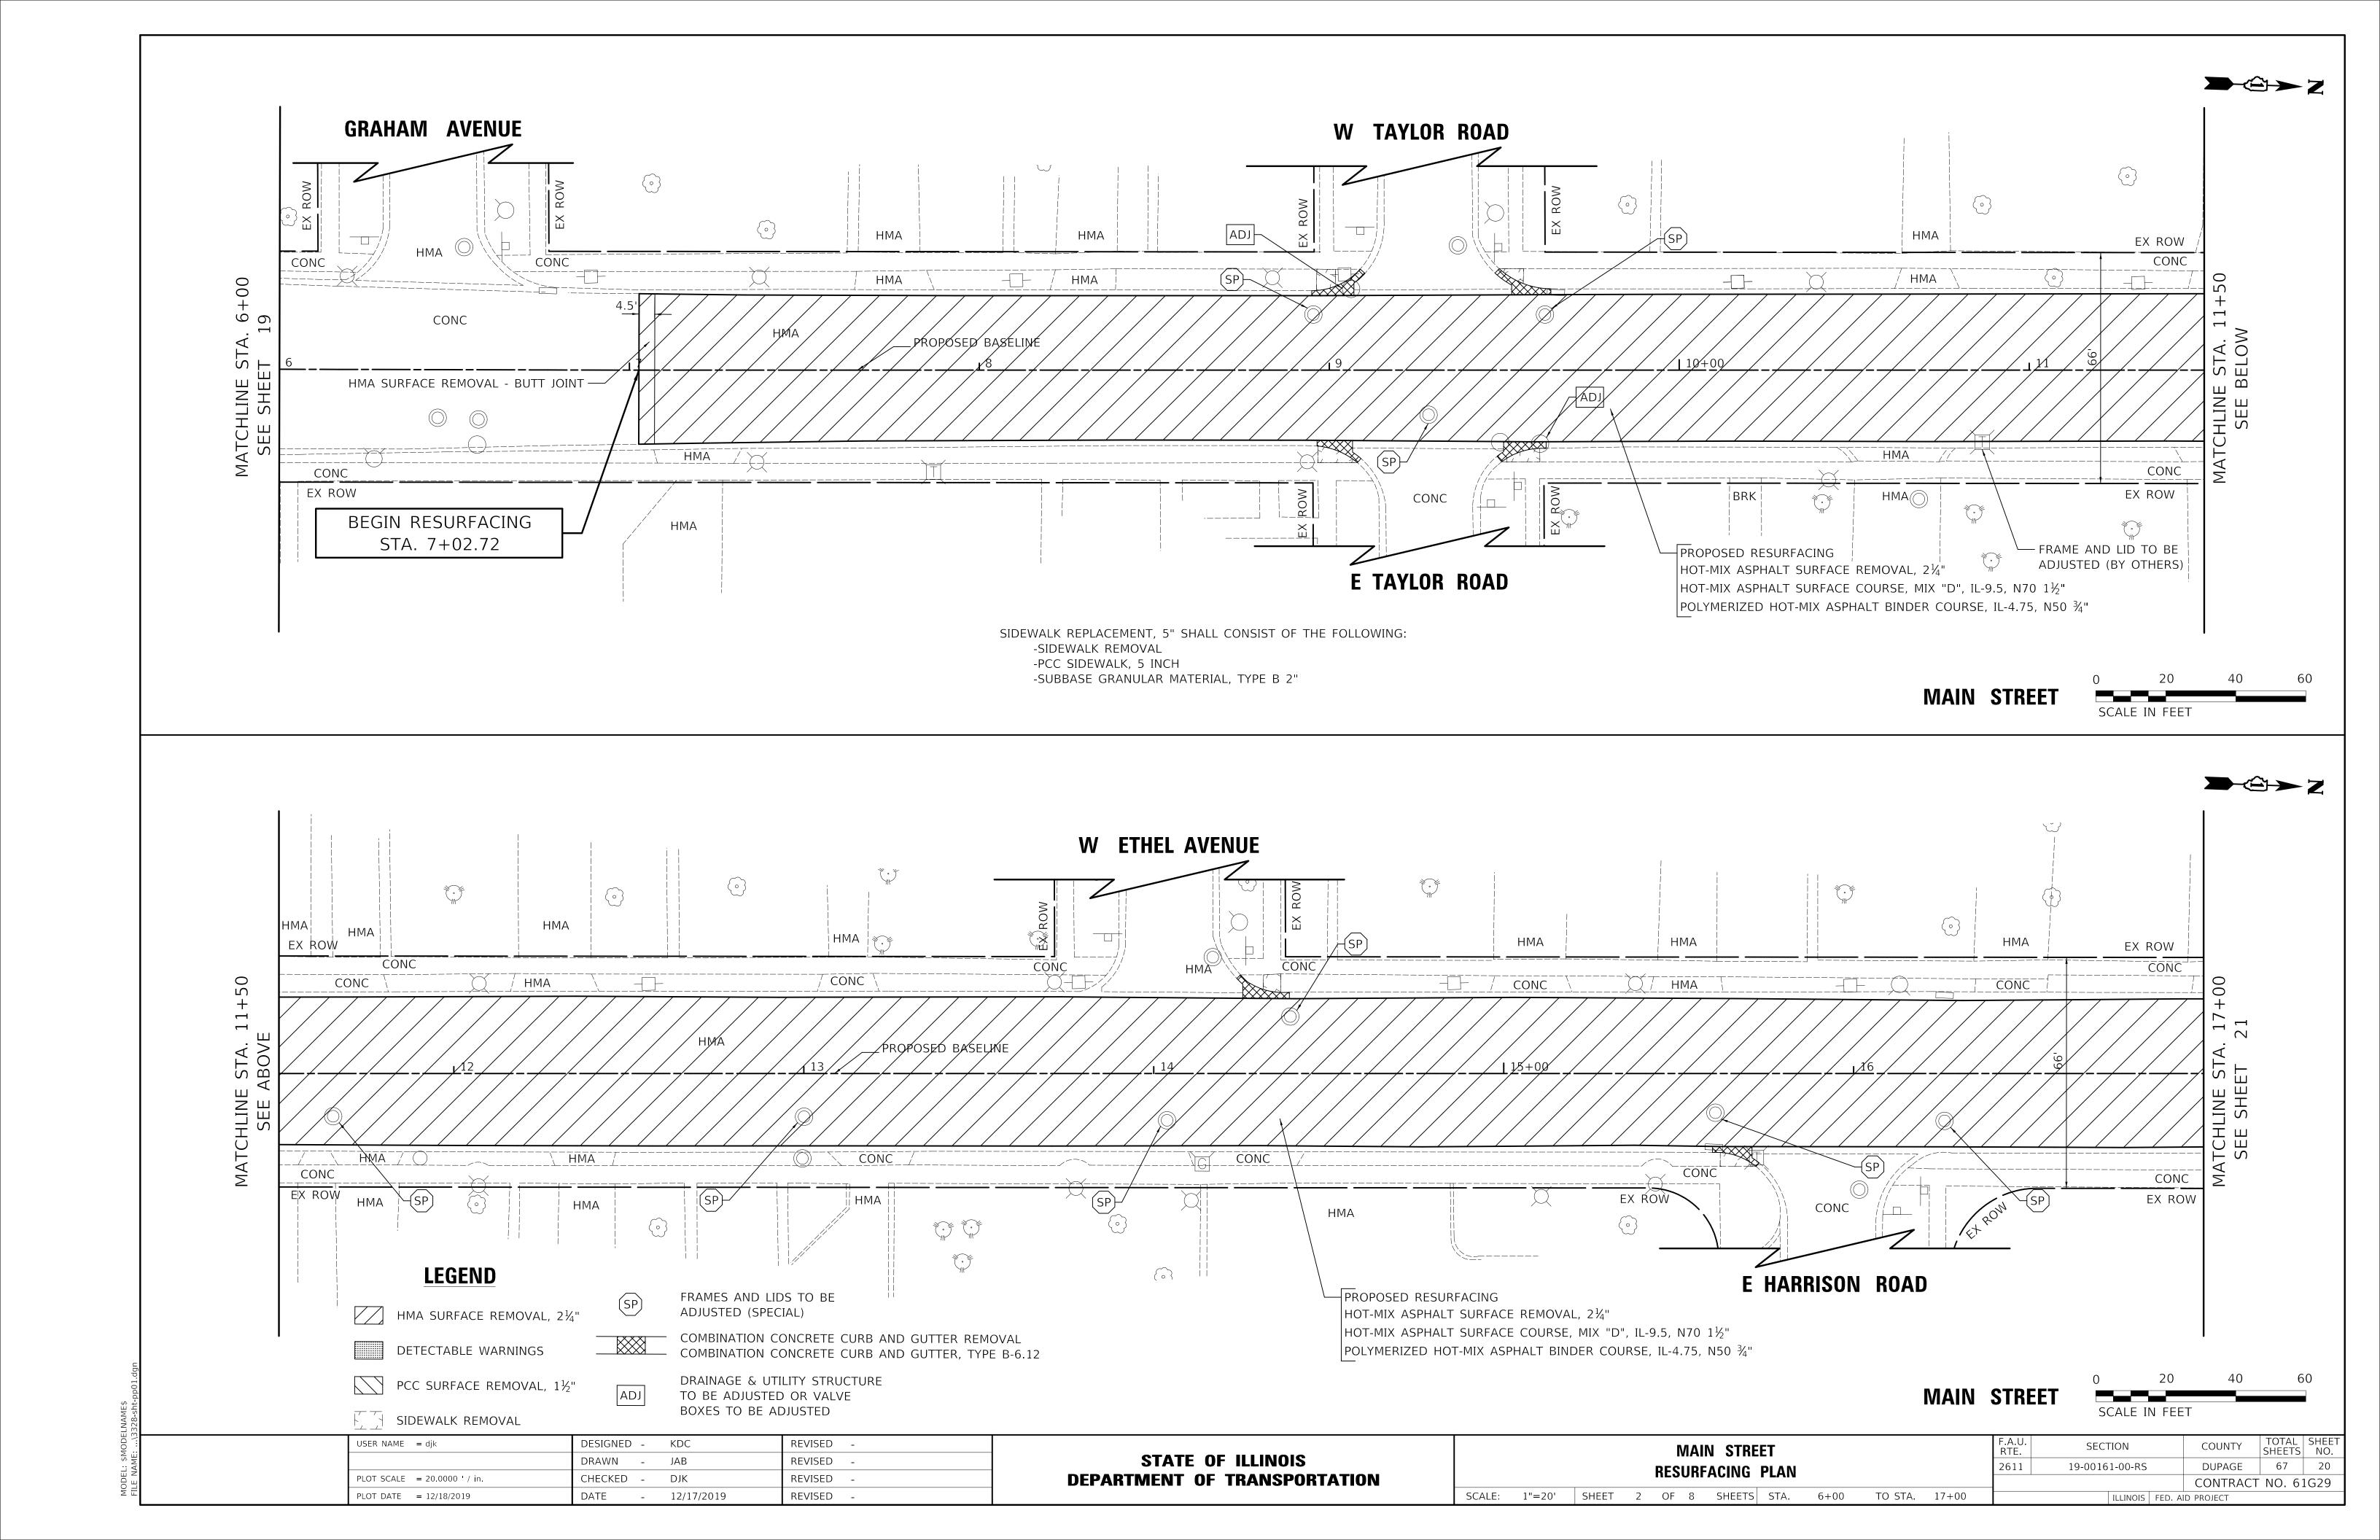


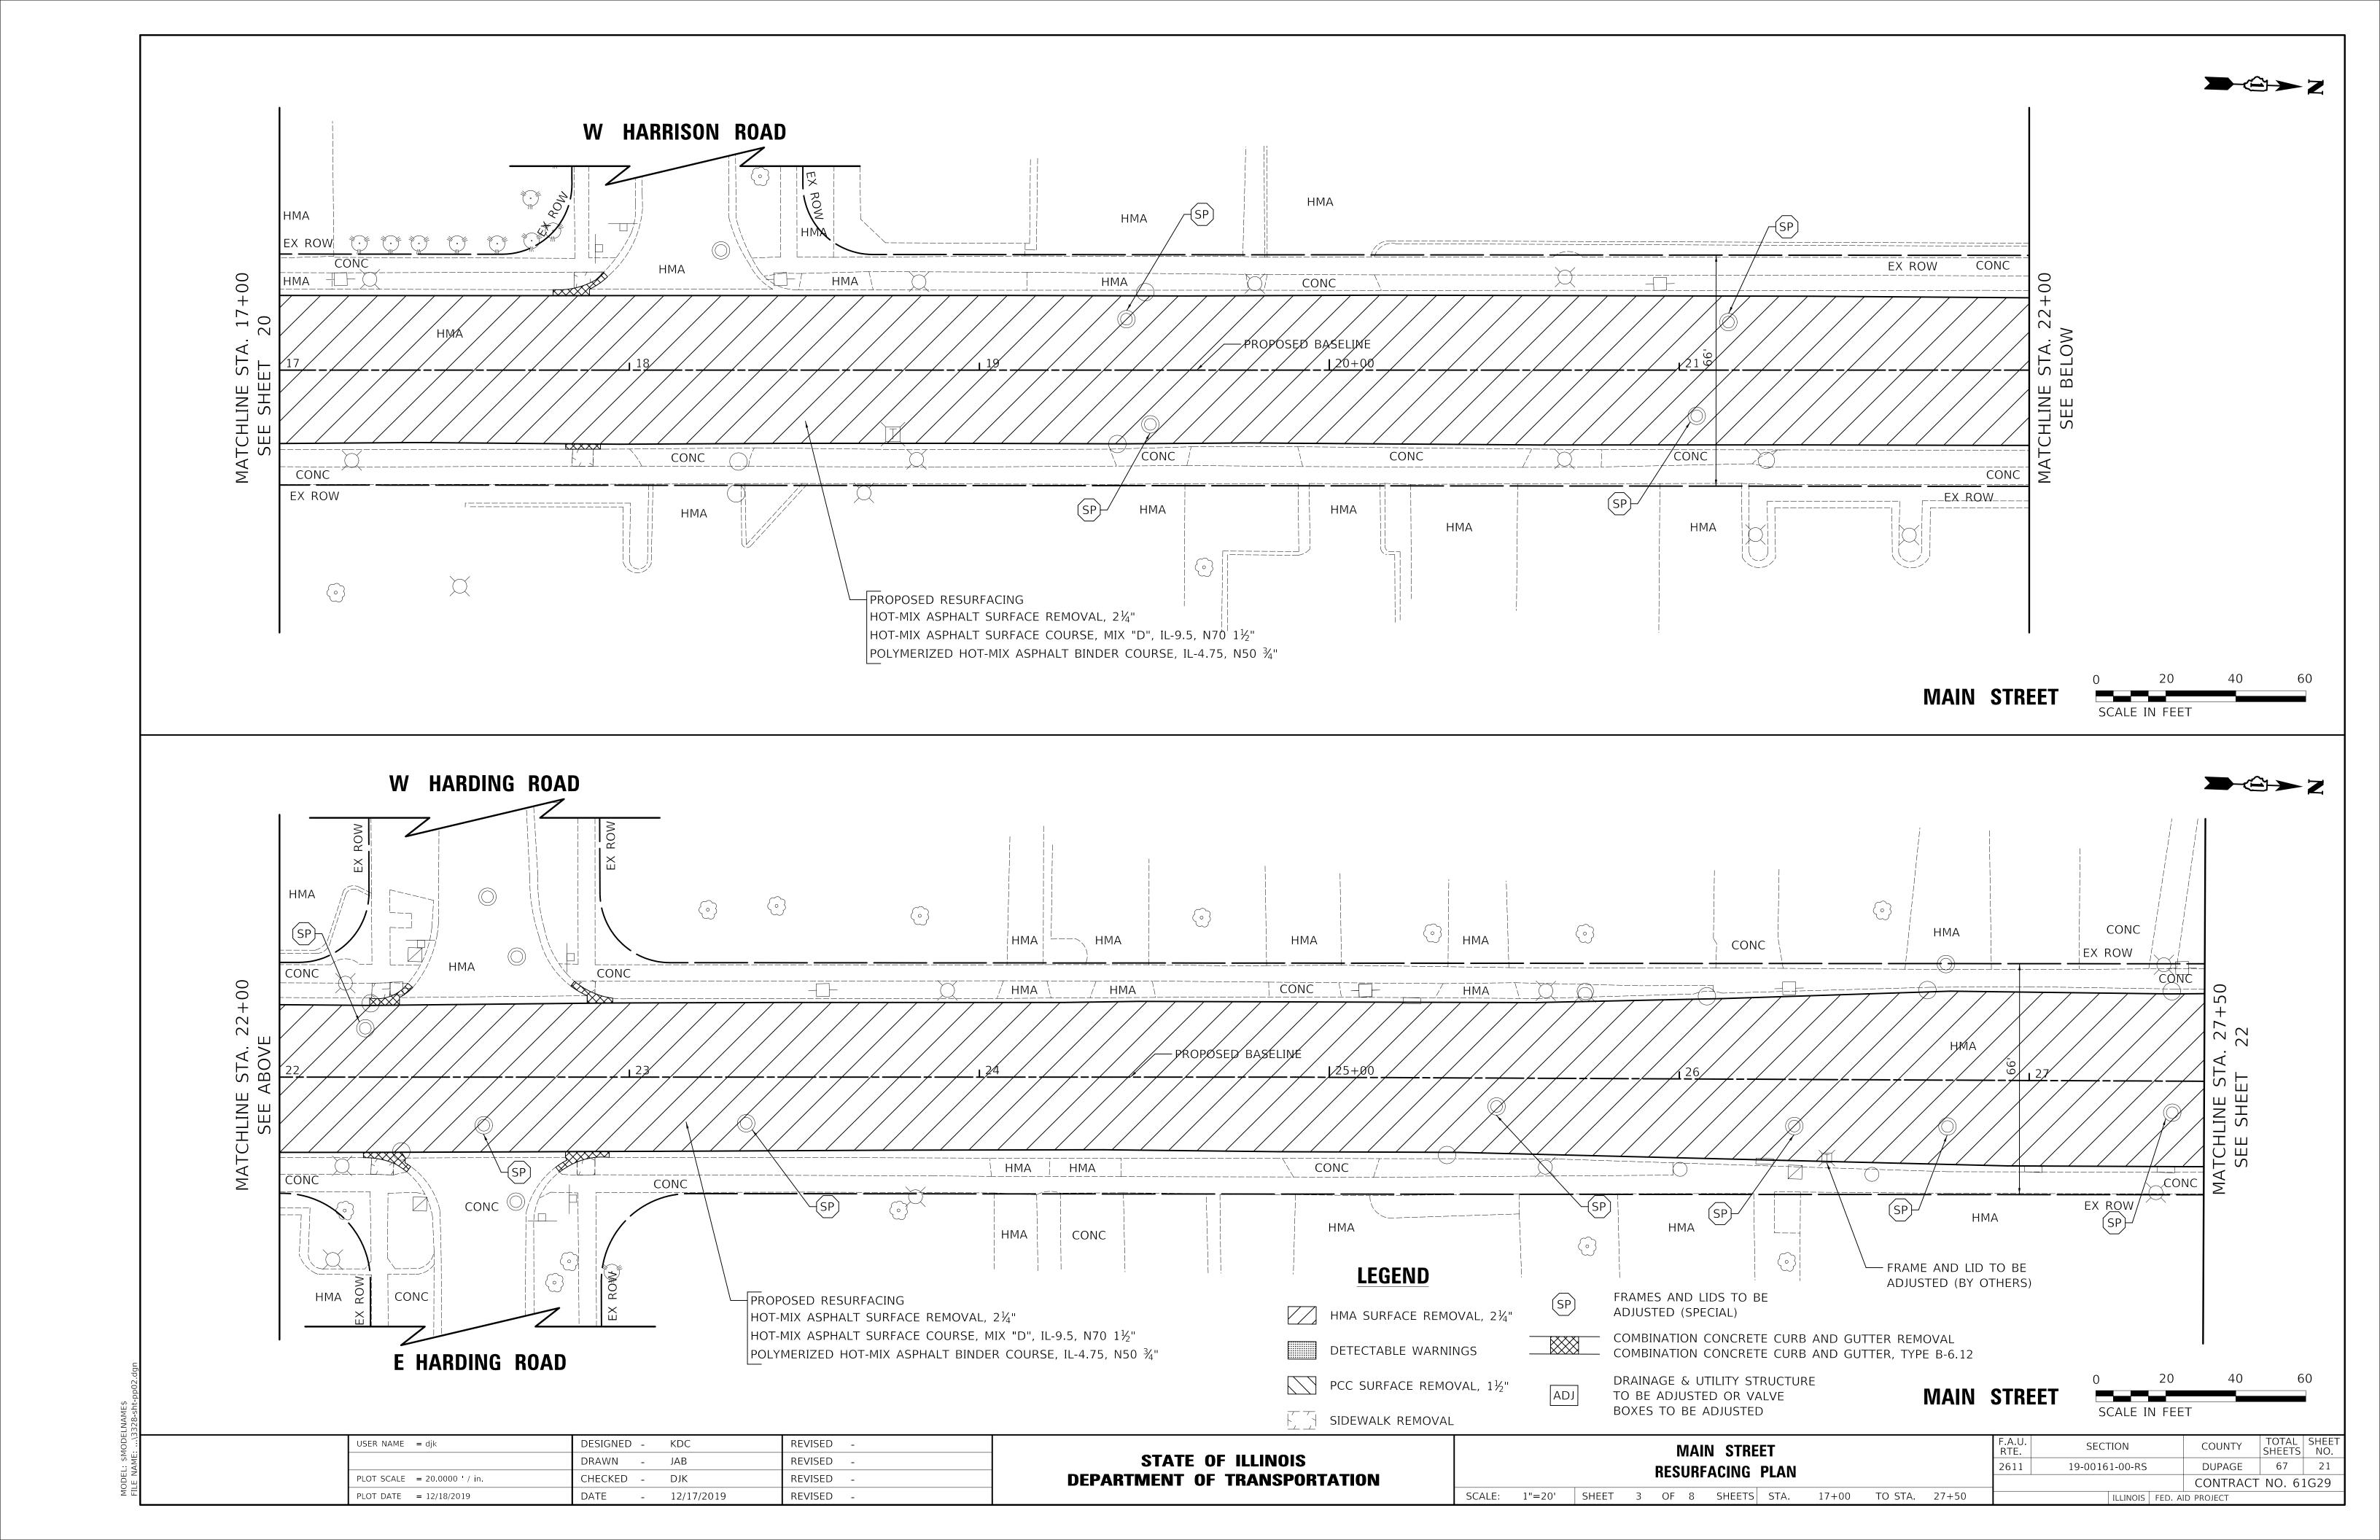


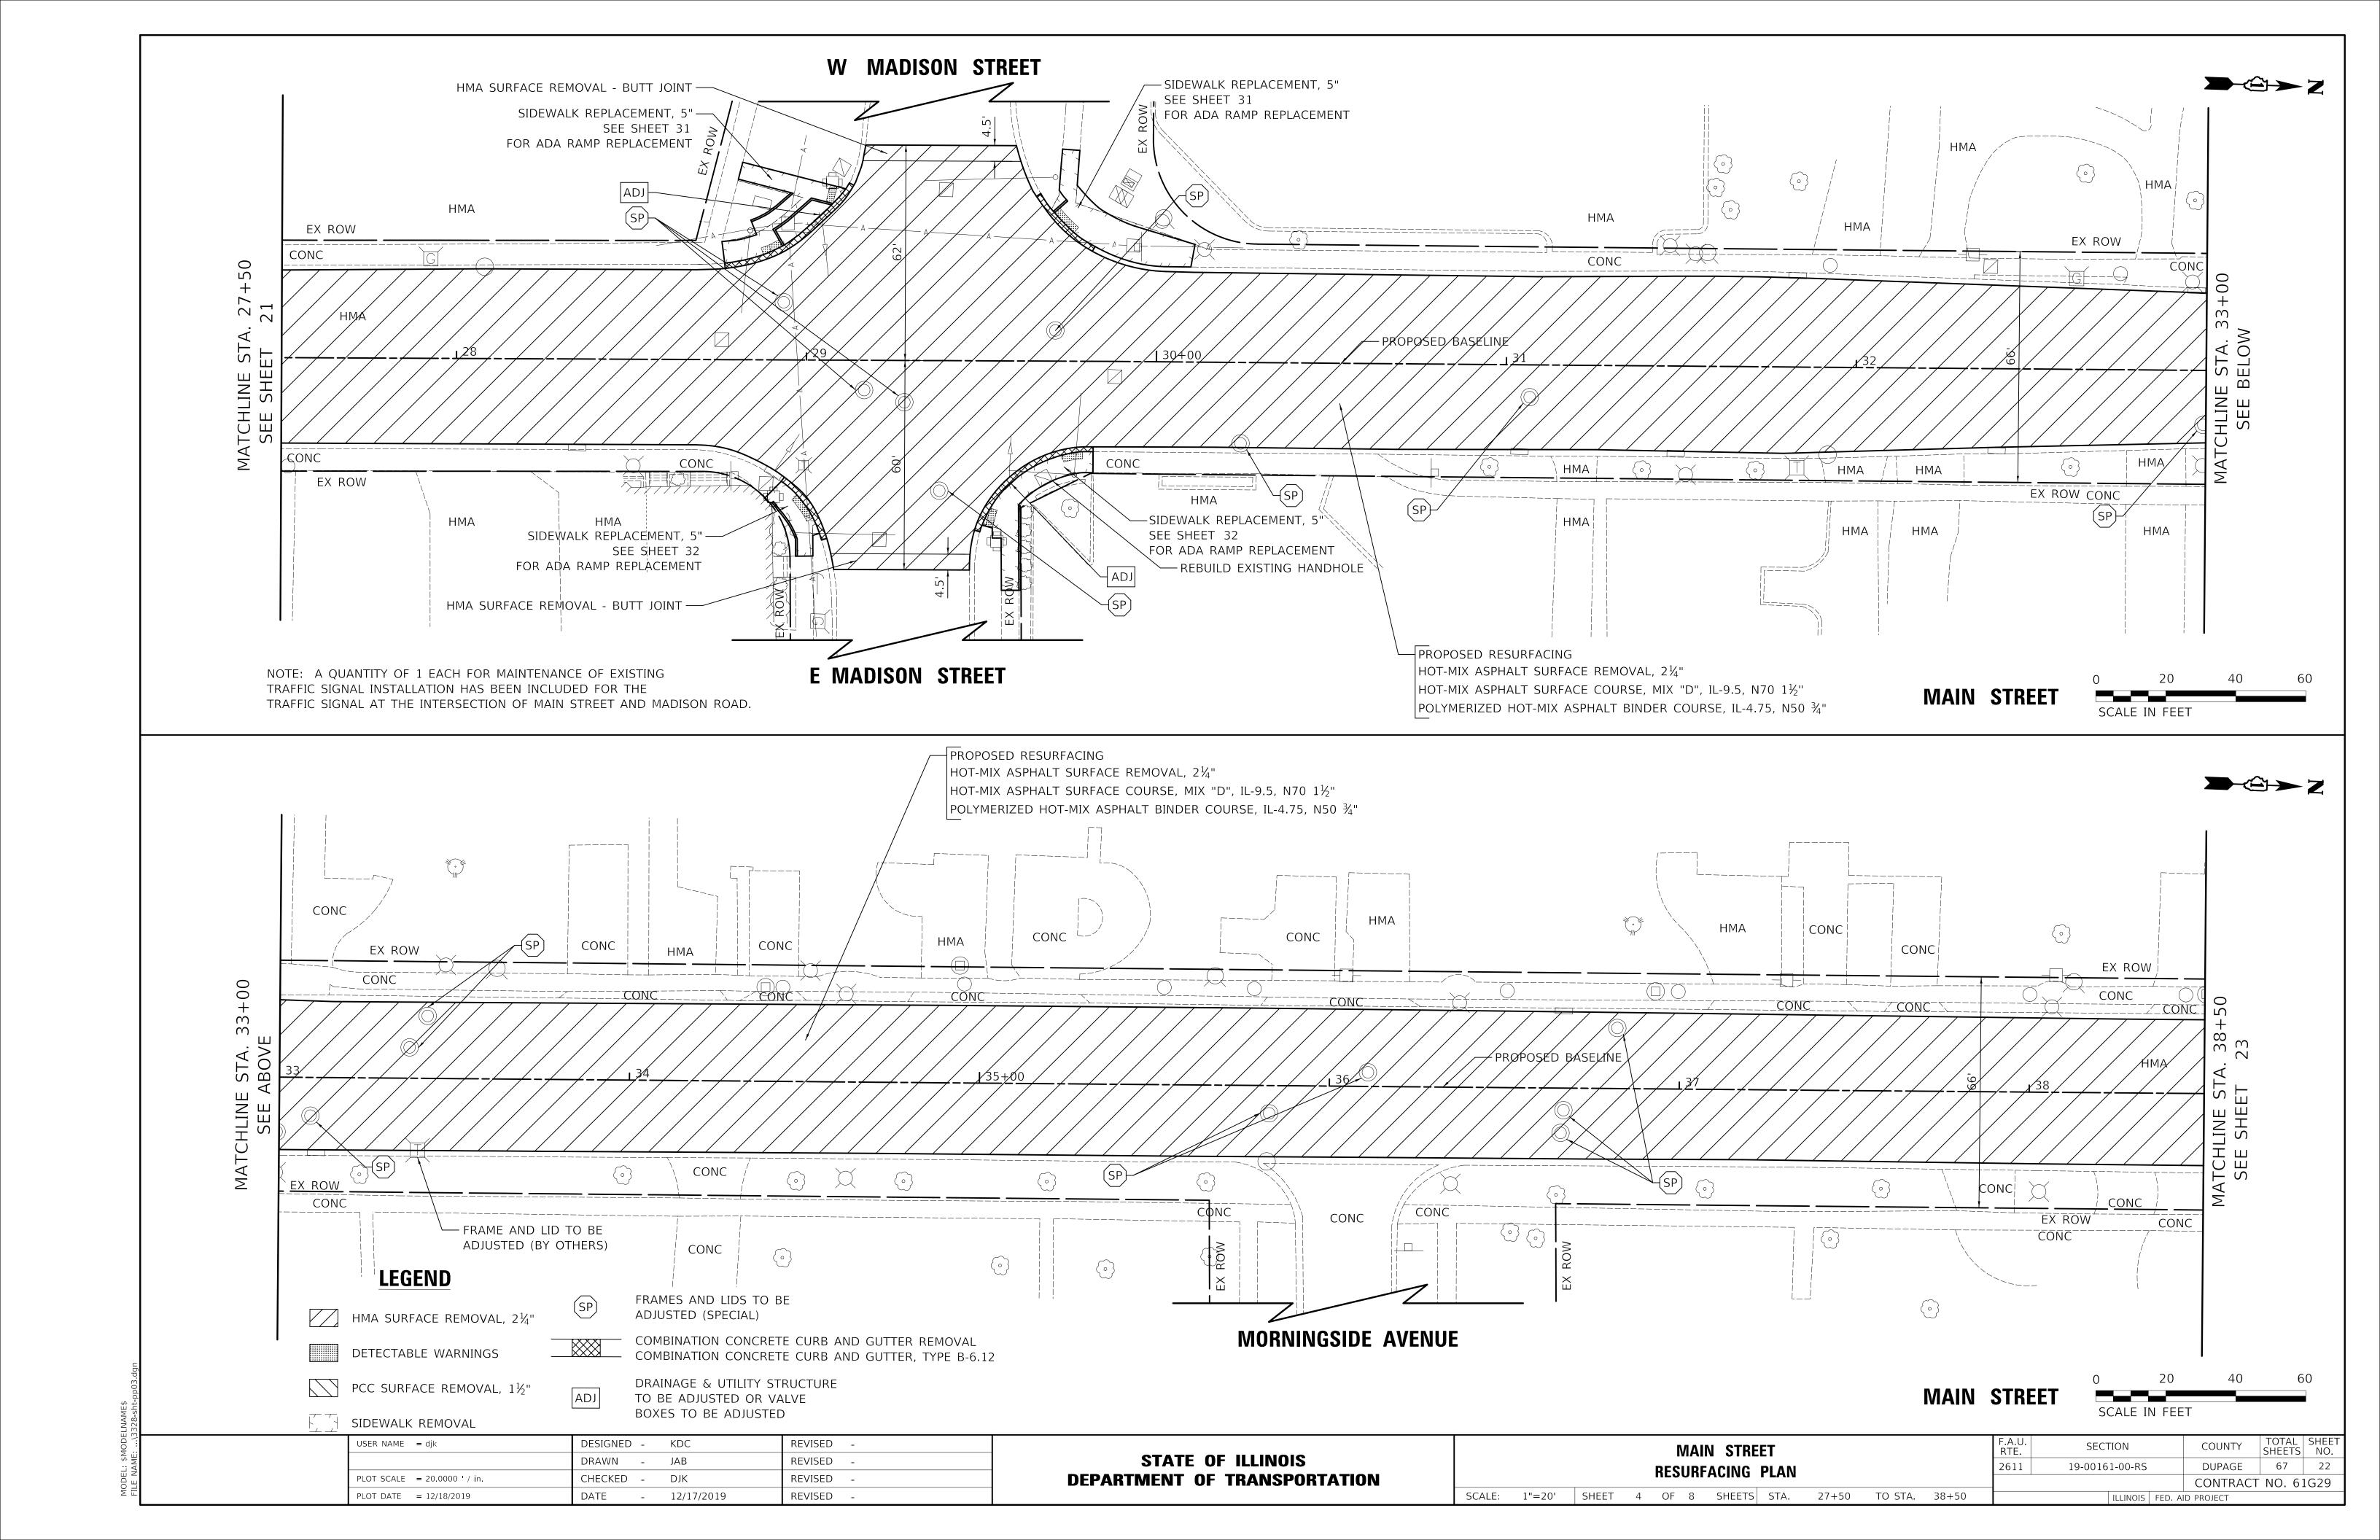

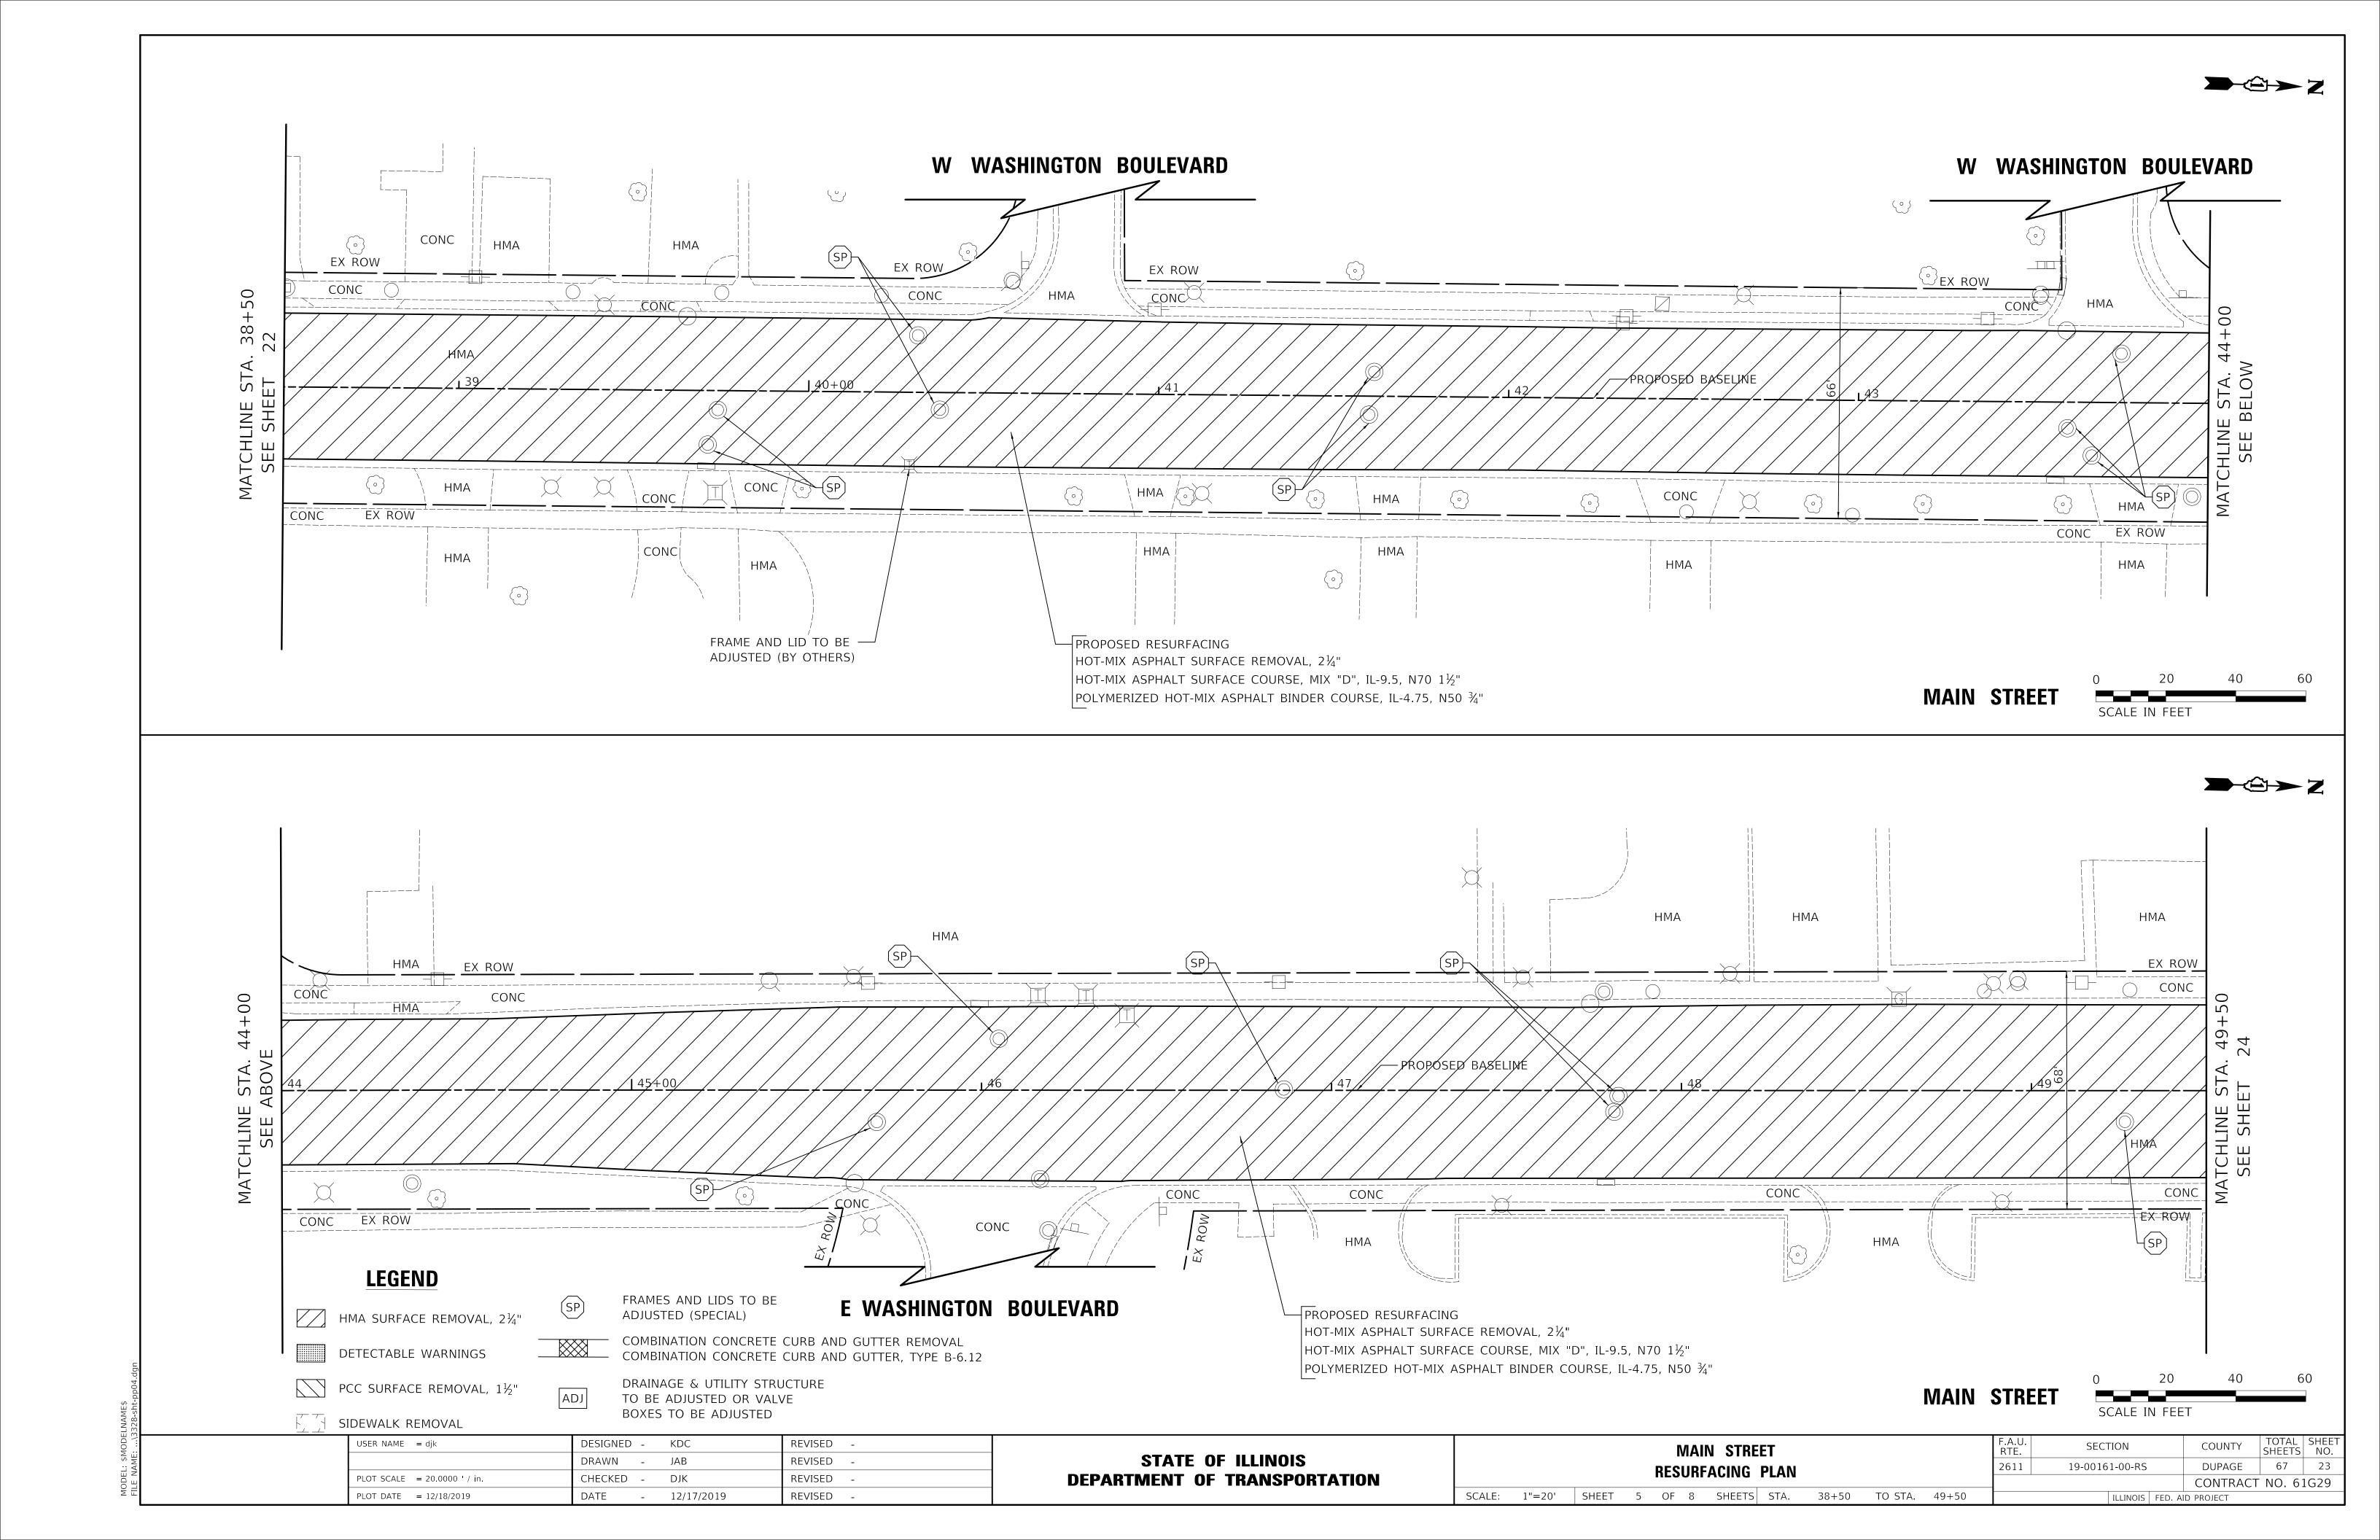

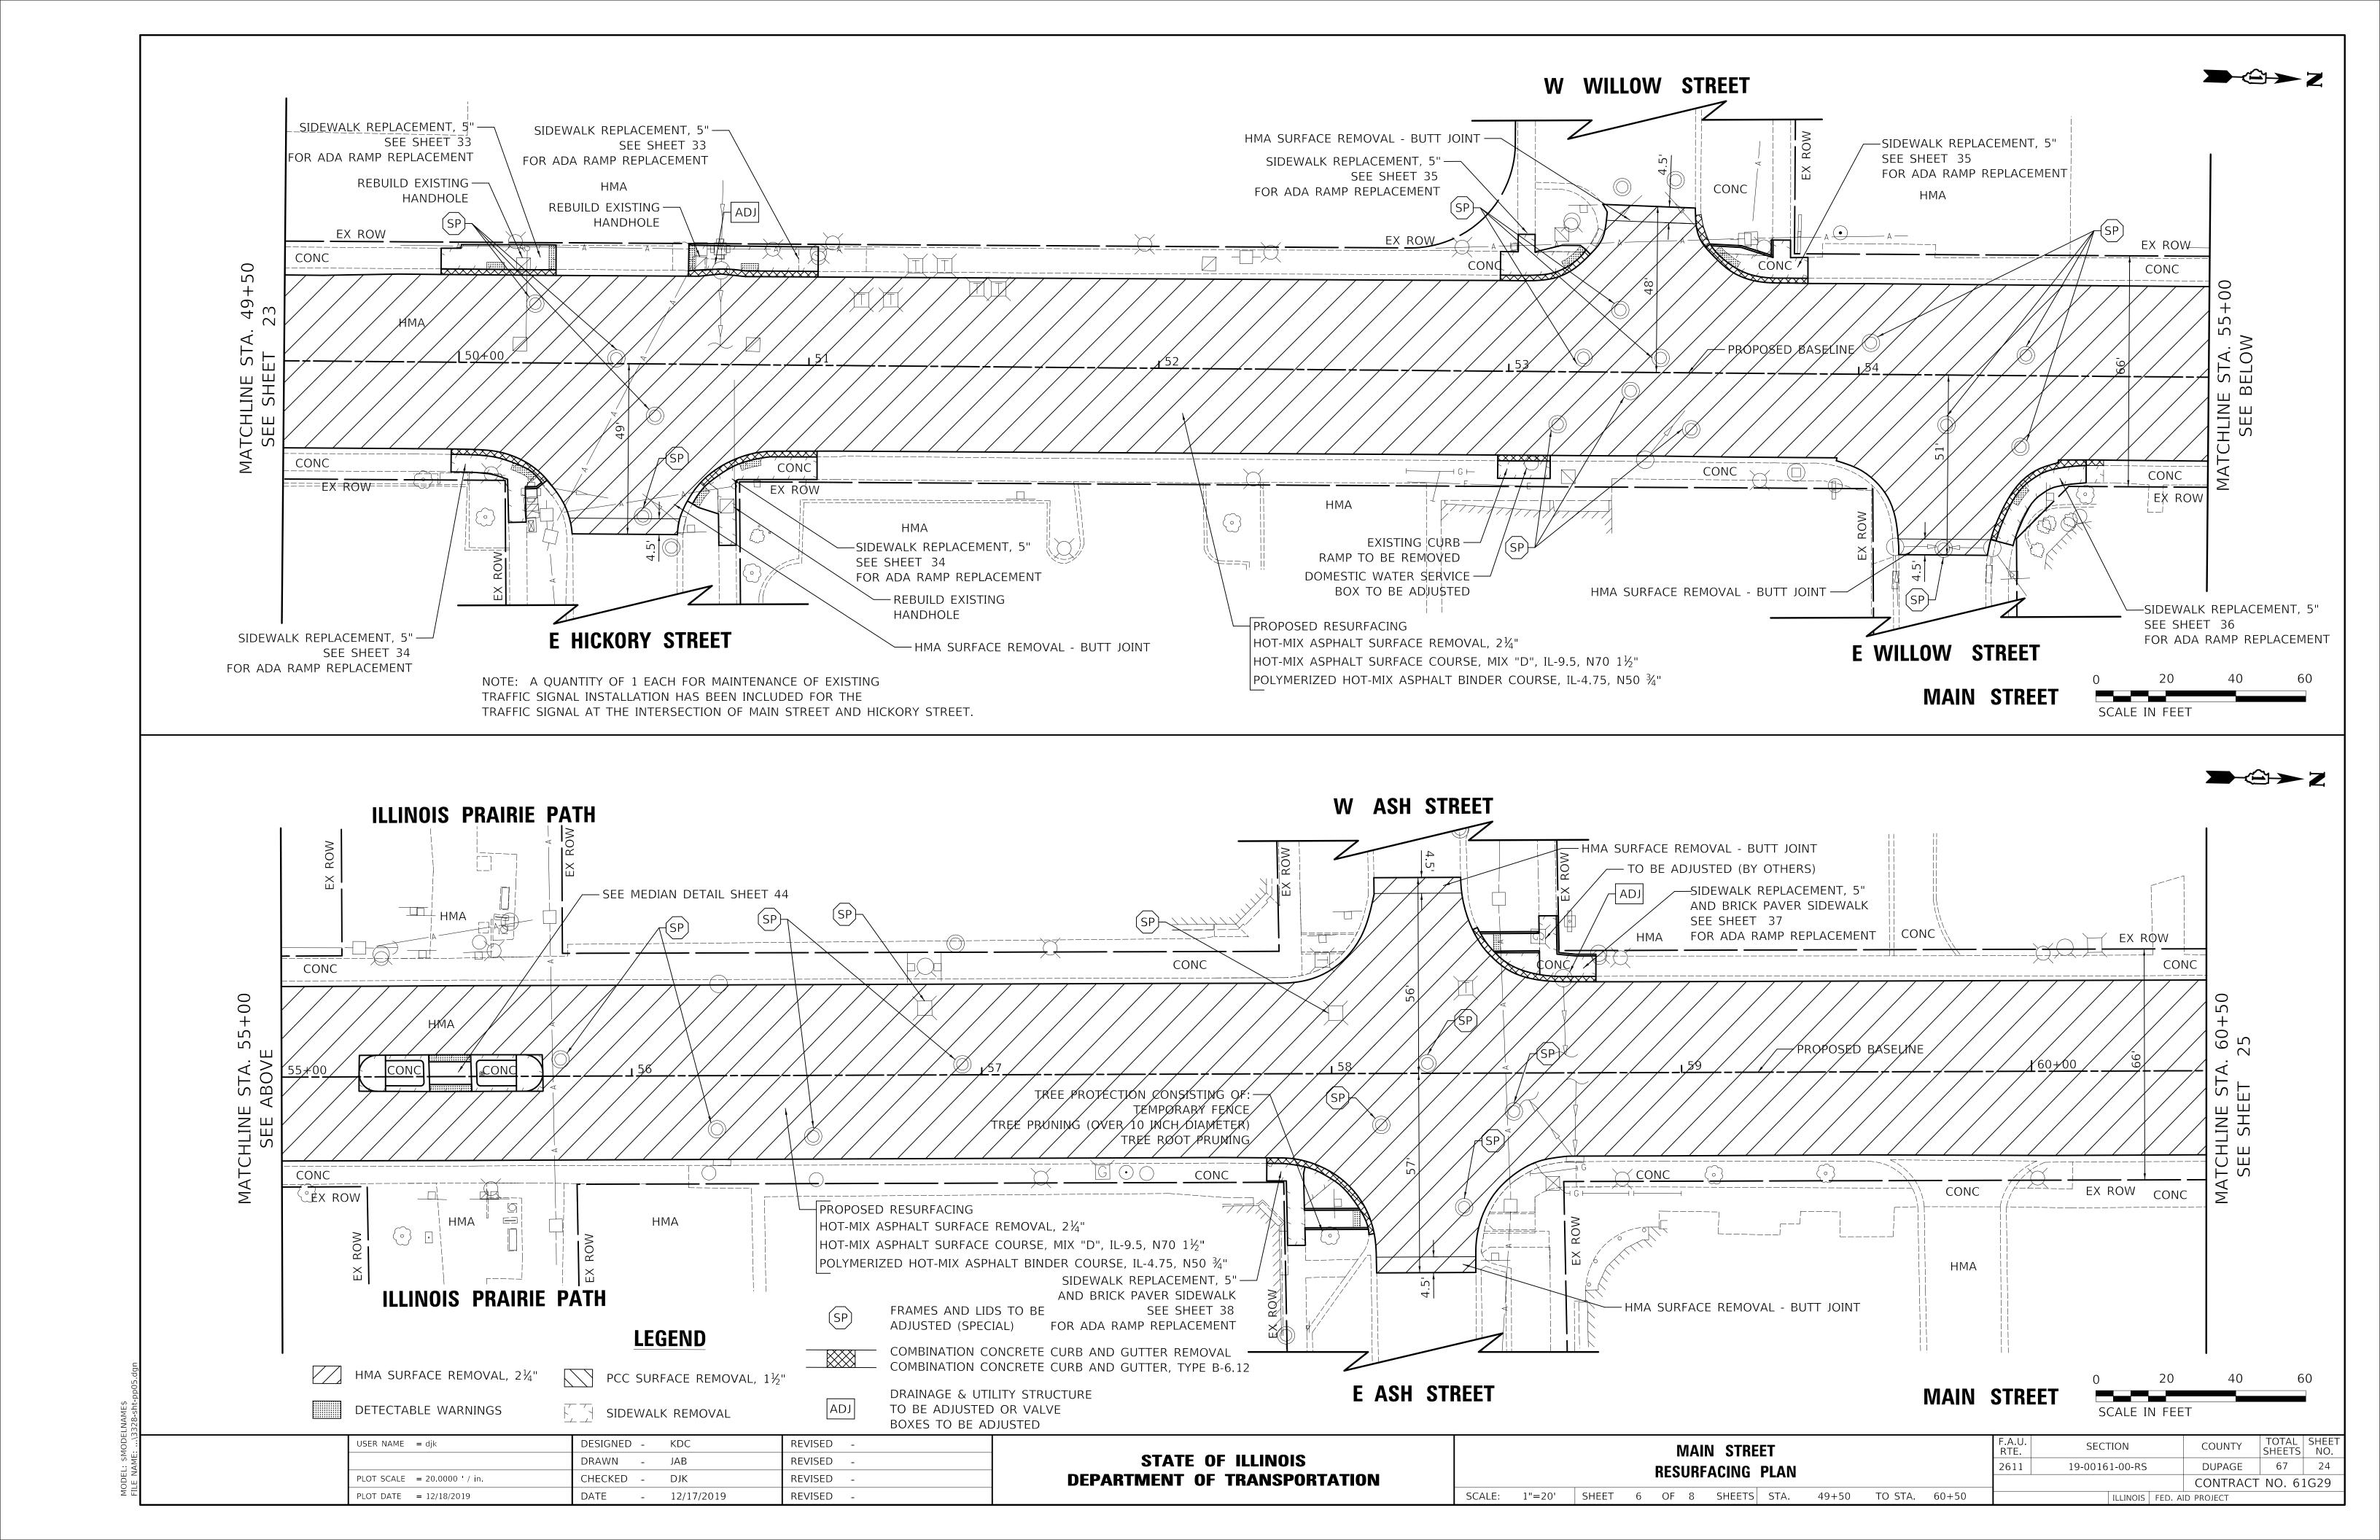

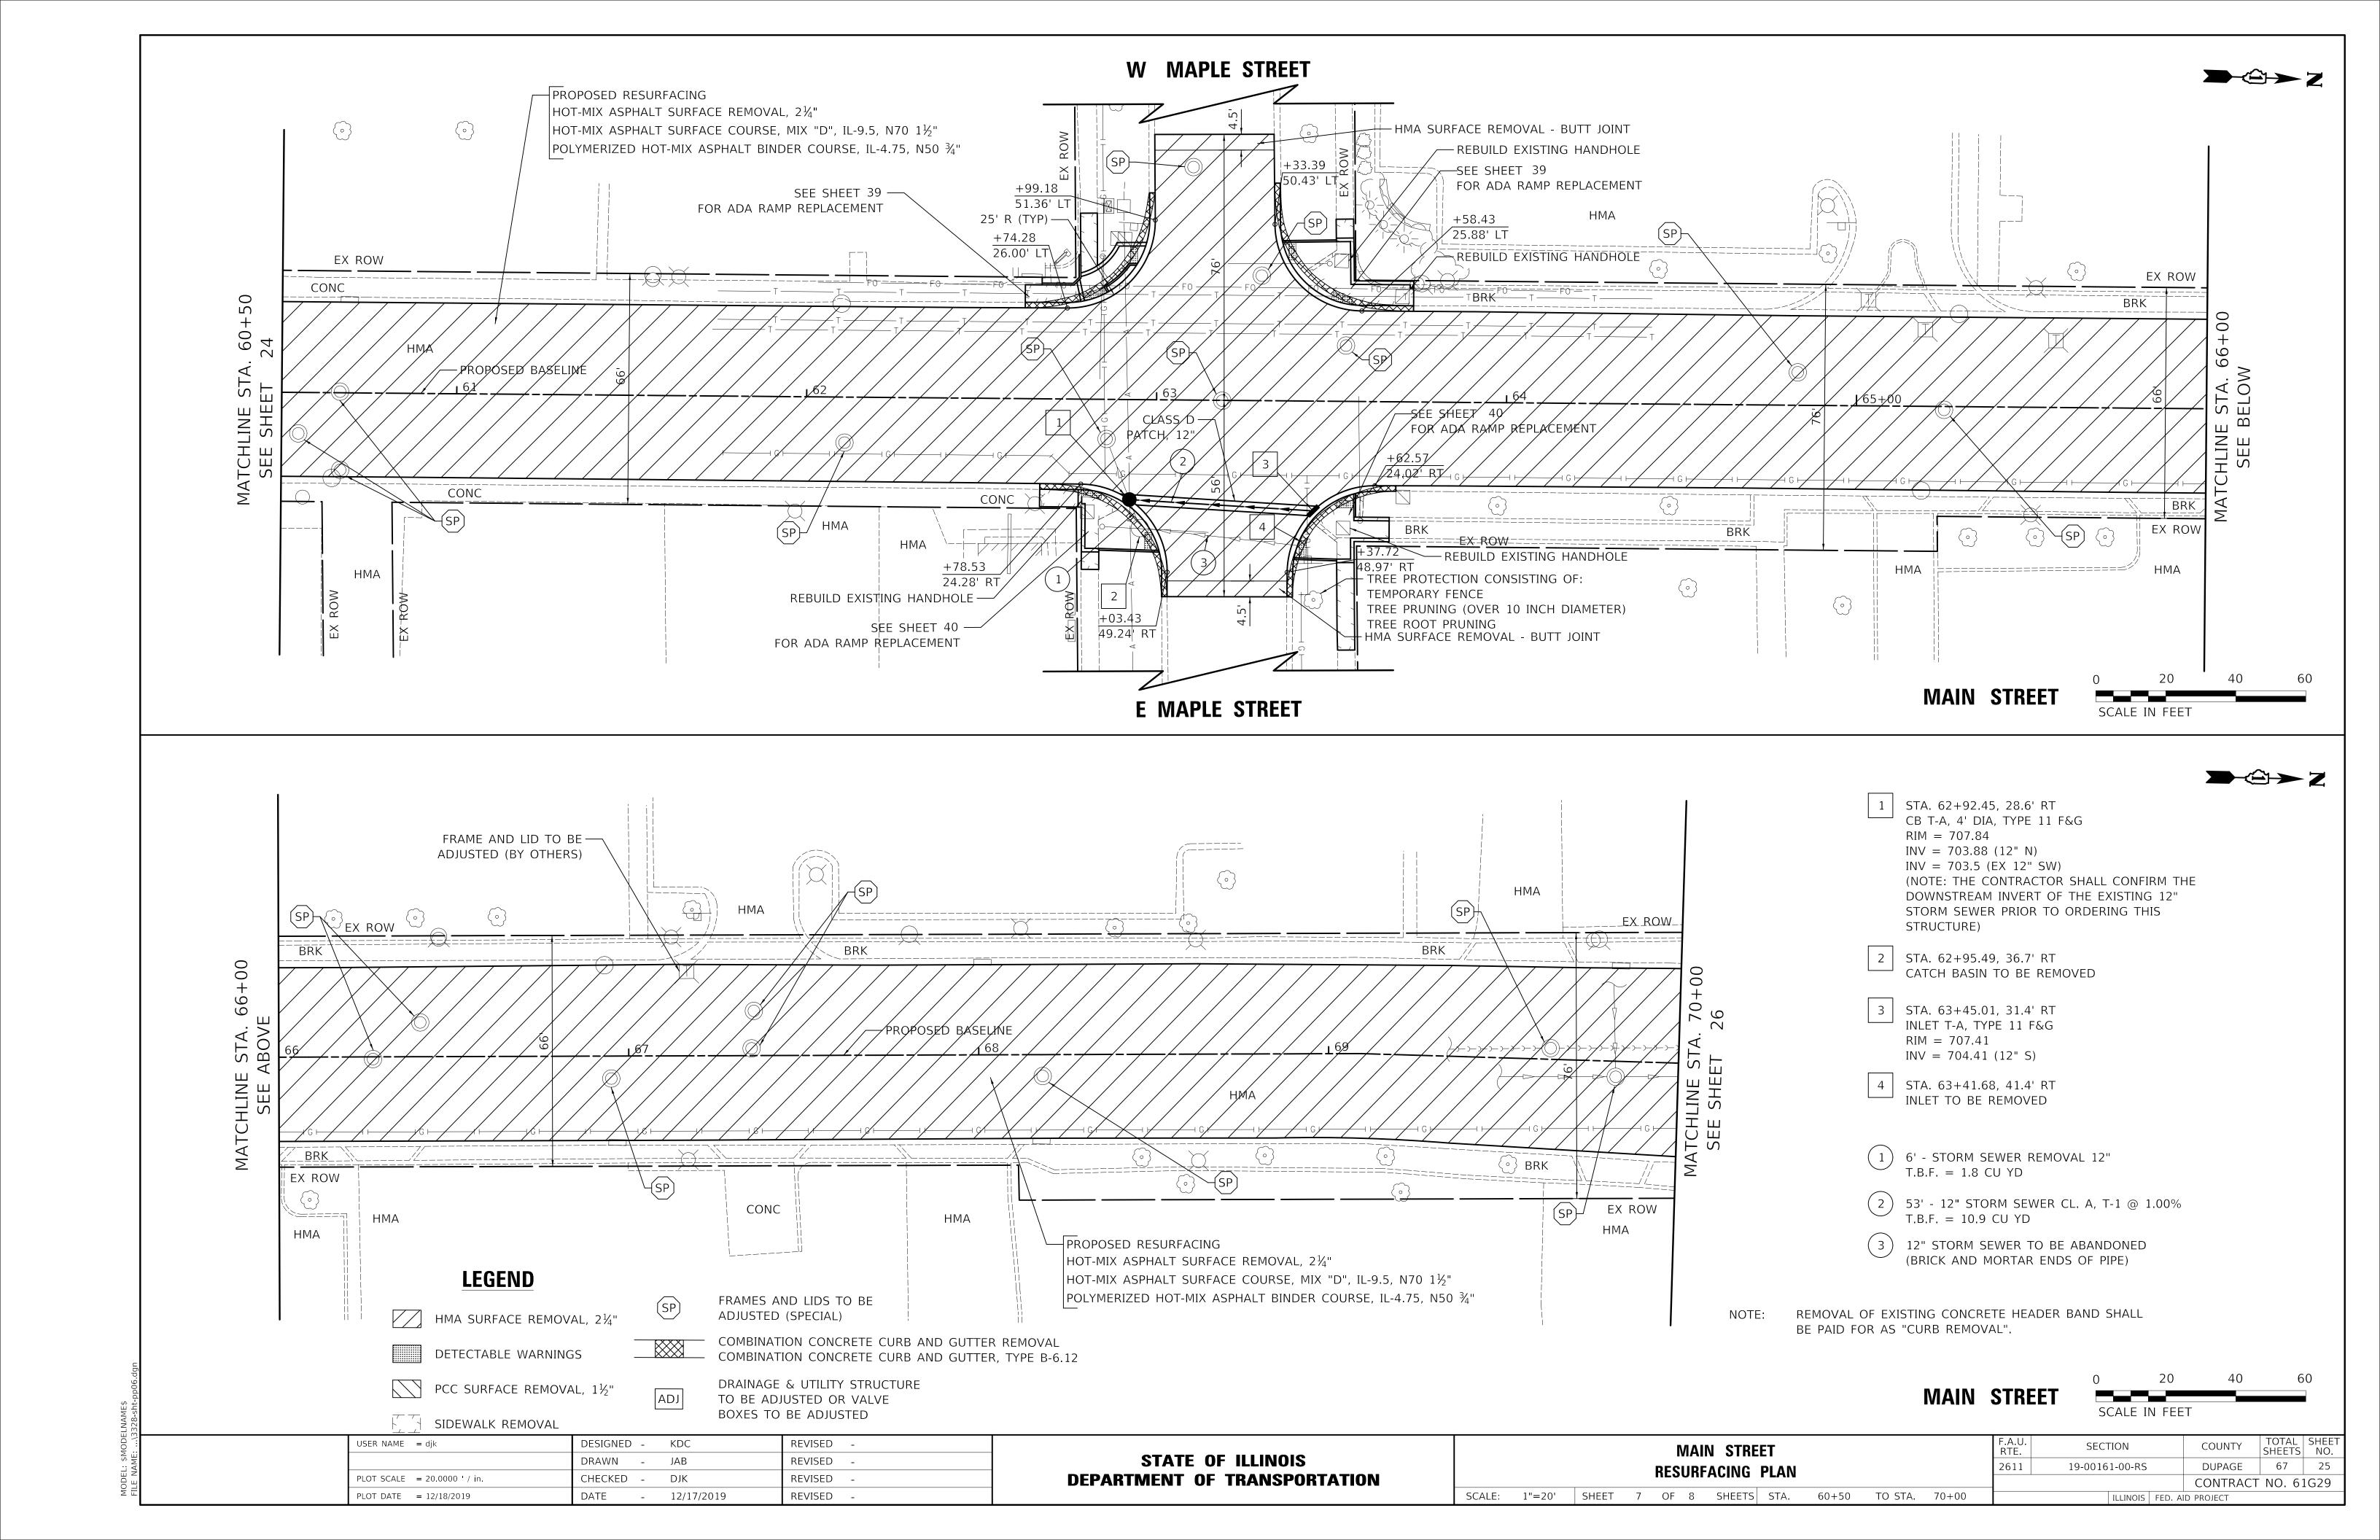

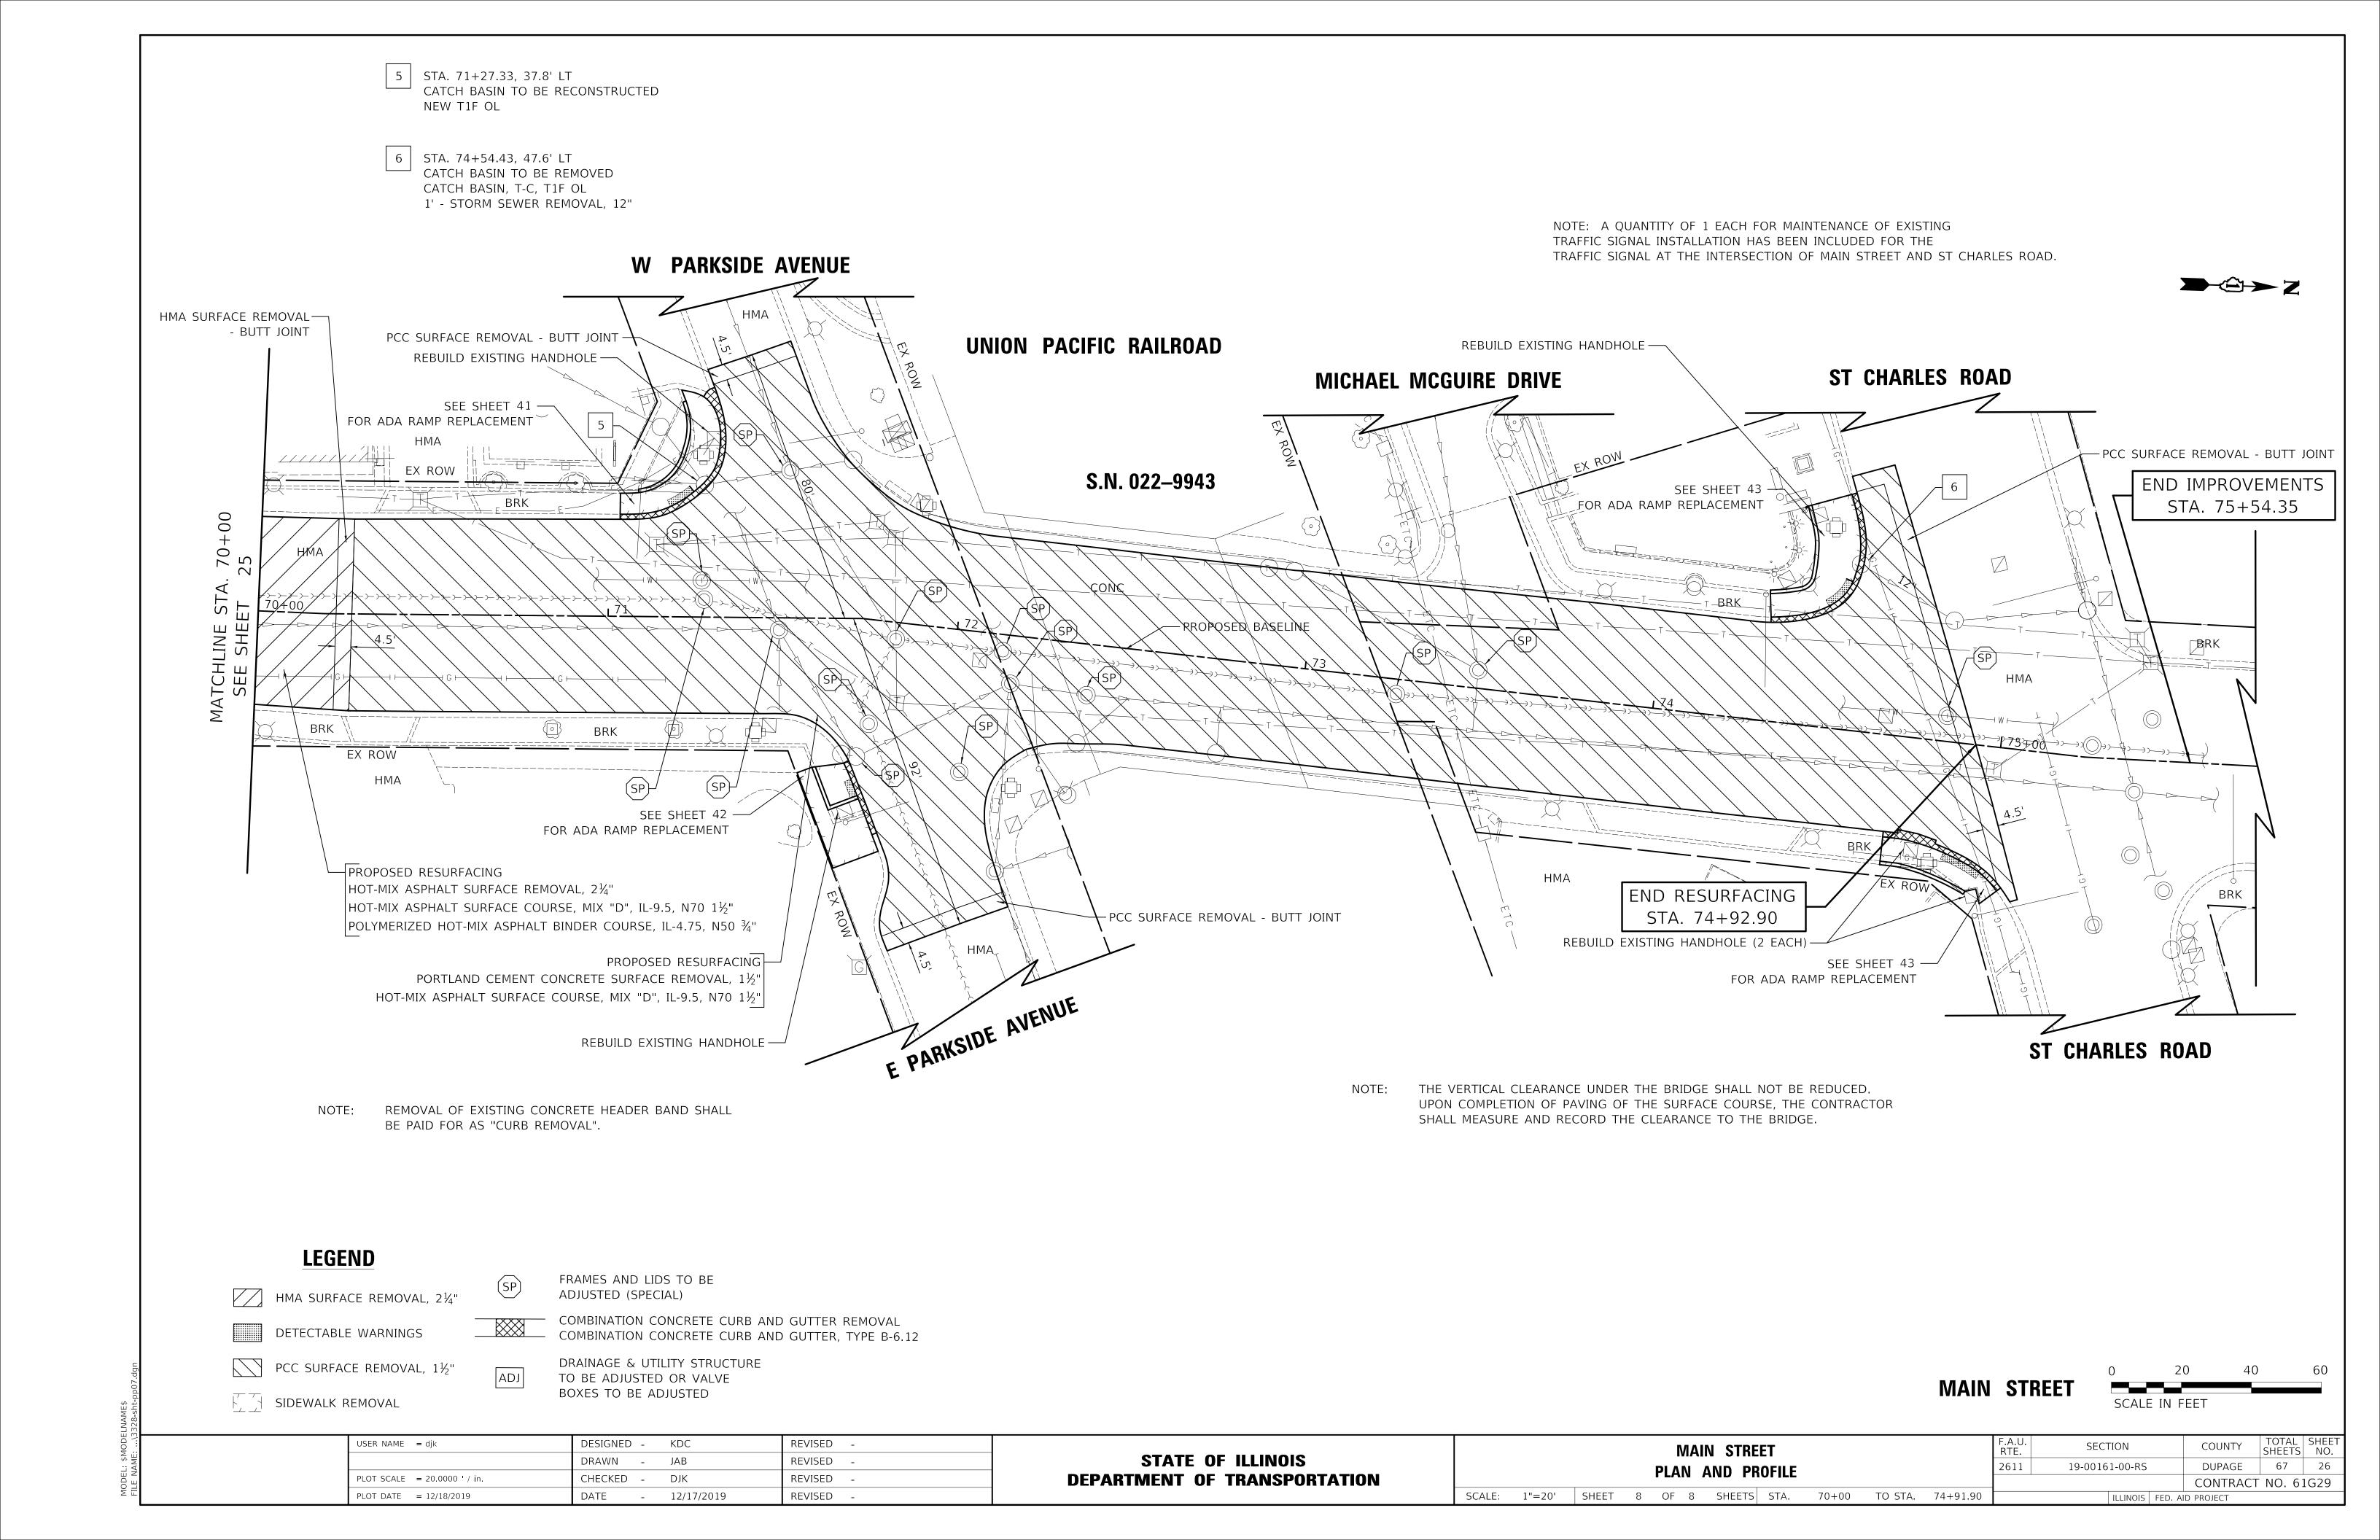

MAINTENANCE OF TRAFFIC GENERAL NOTES

- 1. THE CONTRACTOR SHALL CONTACT THE DISTRICT ONE TRAFFIC CONTROL SUPERVISOR AT (847)-705-4470 A MINIMUM OF 72 HOURS IN ADVANCE OF BEGINNING WORK.
- 2. TRAFFIC CONTROL DEPICTED IN THESE PLANS AND THE APPLICABLE IDOT DETAILS AND STANDARDS ARE THE MINIMUM REQUIREMENTS. OTHER WORK OR SIGNING MAY BE REQUIRED BY THE ENGINEER. TRAFFIC CONTROL AND PROTECTION SHALL BE PERFORMED IN ACCORDANCE WITH THE STANDARD SPECIFICATIONS, DIVISION 700; APPLICABLE GUIDELINES IN THE ILLINOIS MANUAL ON UNIFORM TRAFFIC CONTROL DEVICES FOR STREETS AND HIGHWAYS: AND APPLICABLE HIGHWAY STANDARDS FOR TRAFFIC CONTROL. UNLESS HEREIN REVISED.
- 3. THE EXACT NUMBER, LOCATION AND SPACING OF ALL SIGNS AND TRAFFIC CONTROL DEVICES SHALL FIT FIELD CONDITIONS AS DIRECTED BY THE ENGINEER.
- 4. ALL CONSTRUCTION WARNING SIGNS SHALL HAVE FLUORESCENT ORANGE BACKGROUNDS.
- 5. ALL SIGNS SHALL BE MOUNTED ON METAL POSTS, 7 FEET ABOVE THE EXISTING GROUND AND DRIVEN A MINIMUM OF 3 FEET INTO THE GROUND, UNLESS OTHERWISE NOTED. A J.U.L.I.E. LOCATE SHALL BE PERFORMED PRIOR TO THE INSTALLATION OF THE POSTS
- DRUMS WILL BE REQUIRED ADJACENT TO PAVEMENT EDGES WHERE WIDENING, CURB AND GUTTER OR OVERLAYING WORK IS BEING DONE, AS SPECIFIED IN SECTION 701 OF THE STANDARD SPECIFICATIONS, EXCEPT THAT THE BARRICADES SHALL BE NON-METALLIC DRUMS SPACING SHALL BE AS SHOWN ON THE HIGHWAY STANDARDS UNLESS OTHERWISE DIRECTED BY THE ENGINEER. BARRICADES THAT MUST BE PLACED IN EXCAVATED AREAS SHALL HAVE LEG EXTENSIONS INSTALLED SUCH THAT THE TOPS OF THE BARRICADES ARE IN COMPLIANCE WITH THE HEIGHT REQUIREMENTS OF STANDARD 701901.
- 7. DRUMS WILL BE REQUIRED AT ALL OPEN TRENCHES, EXCAVATIONS, OPEN OR EXPOSED SEWER STRUCTURES, AND AT ANY OTHER LOCATIONS DESIGNATED BY THE ENGINEER OR LAW ENFORCEMENT AGENCIES. BARRICADES SHALL BE PLACED AT 50' CENTERS ALONG TANGENTS, 20' CENTERS ALONG TAPERS, AND 10' CENTERS IN CURVES AND RADII.
- DRUMS AND BARRICADES SHALL MEET THE REQUIREMENTS OF THE NATIONAL COOPERATIVE HIGHWAY RESEARCH PROGRAM (NCHRP) REPORT 350 AND THE STANDARD SPECIFICATIONS.
- 9. TYPE III BARRICADES ARE TO BE PLACED IN ACCORDANCE WITH STANDARD 701901 UNLESS AUTHORIZED BY THE ENGINEER TO USE AN ALTERNATE ARRANGEMENT.
- 10. THE CONTRACTOR SHALL INFORM THE ENGINEER OF ANY STAGE CHANGE AT LEAST TWO WEEKS IN ADVANCE OF THE CHANGE.
- 11. EXISTING TRAFFIC CONTROL SIGNS AND DEVICES SHALL BE REMOVED OR RELOCATED BY THE CONTRACTOR AFTER THE TRAFFIC CONTROL REQUIREMENTS ARE MET OR AS AUTHORIZED BY THE ENGINEER; ANY SIGNS OR DEVICES LEFT IN PLACE ARE TO BE PROTECTED FROM DAMAGE AND MAINTAINED. ANY DAMAGE CAUSED BY THIS WORK SHALL BE REPAIRED TO THE SATISFACTION OF THE ENGINEER AND AT THE EXPENSE OF THE CONTRACTOR
- 12. THE FIRST TWO WARNING SIGNS IN EACH DIRECTION OF TRAVEL SHALL BE EQUIPPED WITH MONO-DIRECTIONAL AMBER FLASHING LIGHTS DURING HOURS OF DARKNESS. FLAGS ARE OPTIONAL
- 13. EXISTING TRAFFIC CONTROL DEVICES ARE TO BE PROTECTED FROM DAMAGE BY THE CONTRACTOR. ANY DAMAGE CAUSED BY HIS/HER WORK SHALL BE REPAIRED TO THE SATISFACTION OF THE ENGINEER AT THE EXPENSE OF THE CONTRACTOR
- 14. ALL ROADS SHALL BE KEPT OPEN TO TRAFFIC DURING THE ENTIRE CONSTRUCTION PERIOD. THE CONTRACTOR MAY CLOSE ONE LANE OF TRAFFIC (DUE TO CONSTRUCTION) ONLY BETWEEN THE HOURS OF 7:00 AM AND 6:00 PM. MONDAY THRU FRIDAY AND 7:00 AM TO 4:00 PM ON SATURDAY. ALL LANES OF TRAFFIC SHALL BE OPEN OUTSIDE OF THESE HOURS.
- 15. W21-1(O) "WORKERS" SIGNS SHALL ONLY BE ERECTED WHEN WORKERS ARE PRESENT. SIGN MUST BE COVERED OR REMOVED WHEN NO WORKERS ARE PRESENT.
- 16. "FRESH OIL" SIGNS (W21-2(O)-4848) WITH DATE SIGNS SHALL BE ERECTED 48 HOURS PRIOR TO PRIMING. THE COST OF THESE SIGNS SHALL BE INCLUDED IN THE TRAFFIC CONTROL AND PROTECTION PAY ITEM BEING USED AT THE TIME THE SIGNS ARE REQUIRED.
- 17. FLASHING ARROW BOARDS WILL BE REQUIRED WHEN IMPLEMENTING ALL LANE CLOSURES, AND SHALL BE INCLUDED IN THE TRAFFIC CONTROL AND PROTECTION PAY ITEM BEING USED AT THE TIME THE SIGNS ARE REOUIRED.
- 18. THE COST OF SUPPLYING, ERECTING, AND MAINTAINING BARRICADES, DRUMS, WARNING LIGHTS, AND SIGNS SHALL BE INCLUDED IN THE COST OF THE VARIOUS TRAFFIC CONTROL AND PROTECTION PAY ITEMS.
- 19. A QUANTITY FOR "TEMPORARY PAVEMENT (VARIABLE DEPTH)" HAS BEEN INCLUDED FOR USE WHEN DIRECTED BY THE ENGINEER TO PROVIDE A TRANSITION AT THE DEPRESSED CURB AND GUTTER AT SIDE STREETS.

USER NAME = djk

SIDEWALK MAINTENANCE NOTE

- 1. THE SIDEWALK ON ONE SIDE OF THE STREET MUST REMAIN OPEN AND ACCESSIBLE AT ALL TIMES. CONSTRUCTION STAGING SHALL BE COORDINATED WITH THE ENGINEER AND CONTRACTOR TO ENSURE ONE SIDEWALK REMAINS OPEN. SIGNING DIRECTING PEDESTRIANS TO THE OPEN SIDEWALK SHALL BE IN ACCORDANCE WITH IDOT HIGHWAY STANDARD 701801. THE WORK REQUIRED TO COMPLY WITH THESE REQUIREMENTS SHALL BE INCLUDED IN THE COST OF "TRAFFIC CONTROL AND PROTECTION, STANDARD 701801".
- 2. AT EACH INTERSECTION, REPLACEMENT OF THE CURB AND GUTTER, ADA RAMP, AND SIDEWALK SHALL ONLY BE ALLOWED AT ONE CORNER AT A TIME, UNLESS OTHERWISE APPROVED BY THE ENGINEER.
- WHEN DIRECTED BY THE ENGINEER, THE PAY ITEM HOT-MIX ASPHALT BINDER COURSE, IL-9.5, N70 SHALL BE USED TO FILL IN THE GAP BETWEEN THE REPLACED CURB AND GUTTER AND THE EXISTING PAVEMENT PRIOR TO MILLING OF THE EXISTING SURFACE.
- 4. DURING CONSTRUCTION OF THE MEDIAN AT THE ILLINOIS PRAIRIE PATH CROSSING, THE EXISTING CROSSWALK SHALL BE CLOSED. PEDESTRIANS SHALL BE DIRECTED TO THE SOUTH, TO THE EXISTING CROSSWALK AT HICKORY STREET. NO SIDEWALK OR ADA CONSTRUCTION SHALL BE ALLOWED ALONG THIS ROUTE DURING THE TIME THAT THE PRAIRIE PATH CROSSING IS CLOSED. ALL BARRICADES AND SIGNS REQUIRED SHALL BE INCLUDED IN THE COST OF "TRAFFIC CONTROL AND PROTECTION, STANDARD 701801". THE MAXIMUM CLOSURE LENGTH FOR THE PRAIRIE PATH CROSSING SHALL BE 14 DAYS.

CONSTRUCTION REQUIREMENTS


- ALL WORK SHALL BE IN ACCORDANCE WITH IDOT'S SAFETY ENGINEERING POLICY MEMORANDUM, SAFETY 4-15, INCLUDING THE REQUIREMENT FOR USE OF TEMPORARY OR MILLED SLOPE EDGES (MIN OF 1:3). THIS MAY REQUIRE ADDITIONAL PASSES OF THE MILLING MACHINE OR THE USE OF A SECONDARY, SMALLER MILLING MACHINE TO CREATE THE REQUIRED EDGE. THE COST TO COMPLY WITH THESE REQUIREMENTS SHALL BE INCLUDED IN THE COST OF "HOT-MIX ASPHALT SURFACE REMOVAL" OF THE THICKNESS SPECIFIED OR "PORTLAND CEMENT CONCRETE SURFACE REMOVAL" OF THE THICKNESS SPECIFIED.
- "UNEVEN LANE" SIGNS (W8-1(O)-4848) SHALL BE PLACED AT THE INTERVALS REQUIRED BY THE ENGINEER WHEN TRAFFIC IS ADJACENT TO THE MILLED SURFACE. THE COST OF THESE SIGNS SHALL BE INCLUDED IN THE TRAFFIC CONTROL AND PROTECTION PAY ITEM BEING USED AT THE TIME THE SIGNS ARE REQUIRED.

CONSTRUCTION SEQUENCE

THIS CONSTRUCTION SEQUENCE WAS DEVELOPED TO MINIMIZE IMPACTS TO PROPERTY OWNERS AND TO PROVIDE AN ADEQUATE METHOD OF INSPECTING THE CONDITION OF THE PAVEMENT BASE AND CURB AND GUTTER. THIS CONSTRUCTION SEQUENCE SHALL BE FOLLOWED UNLESS AN ALTERNATE SEQUENCE IS APPROVED BY THE ENGINEER.

- 1. SET UP APPLICABLE TRAFFIC CONTROL MEASURES USING IDOT HIGHWAY STANDARDS AND DISTRICT ONE DETAILS PROVIDED IN THE PLANS. DAILY LANE CLOSURES SHALL BE USED FOR ALL WORK DEPICTED IN THESE PLANS. PERMANENT LANE CLOSURES SHALL NOT BE ALLOWED UNLESS SHOWN ON THE PLANS OR OTHERWISE APPROVED BY THE ENGINEER.
- 2. SET UP EROSION AND SEDIMENT CONTROL MEASURES / TREE PRUNING.
- REMOVE AND REPLACE CURB AND GUTTER, INSTALL PROPOSED DRAINAGE STRUCTURE. AND ADJUST DRAINAGE STRUCTURES AS DETERMINED BY THE ENGINEER.
- 4. INSTALL SIDEWALK AND DETECTABLE WARNINGS.
- 5. INSTALL PEDESTRIAN PUSH-BUTTONS.
- LANDSCAPE RESTORATION.
- 7. REMOVE HMA AND PCC PAVEMENT SURFACE.
- THE ENGINEER SHALL INSPECT THE CONDITION OF THE PAVEMENT AND MARK THE AREAS REQUIRING PAVEMENT PATCHING. UNDER NO CONDITION SHALL THE CONTRACTOR PROCEED WITH THIS WORK WITHOUT PRIOR CONSENT FROM THE ENGINEER. PERFORM PAVEMENT PATCHING.
- 9. INSTALL BINDER AND HMA SURFACE.
- 10. INSTALL PERMANENT PAVEMENT MARKINGS AND SIGNING.
- 11. REMOVE EROSION CONTROL AND TRAFFIC CONTROL.

CONSTRUCTION SIGNS

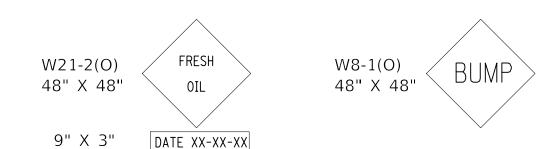

THESE SIGNS SHALL BE PLACED AS DIRECTED BY THE ENGINEER W21-2(O) SHALL BE PLACED 48 HOURS PRIOR TO PRIMING. THE COST OF THESE SIGNS SHALL BE INCLUDED IN THE COST OF THE VARIOUS TRAFFIC CONTROL AND PROTECTION PAY ITEMS.

TOTAL SHEET SHEET NO.

67 27


COUNTY


| ILLINOIS | FED. AID PROJECT


DUPAGE

CONTRACT NO. 61G29

SHEET 1 OF 1 SHEETS

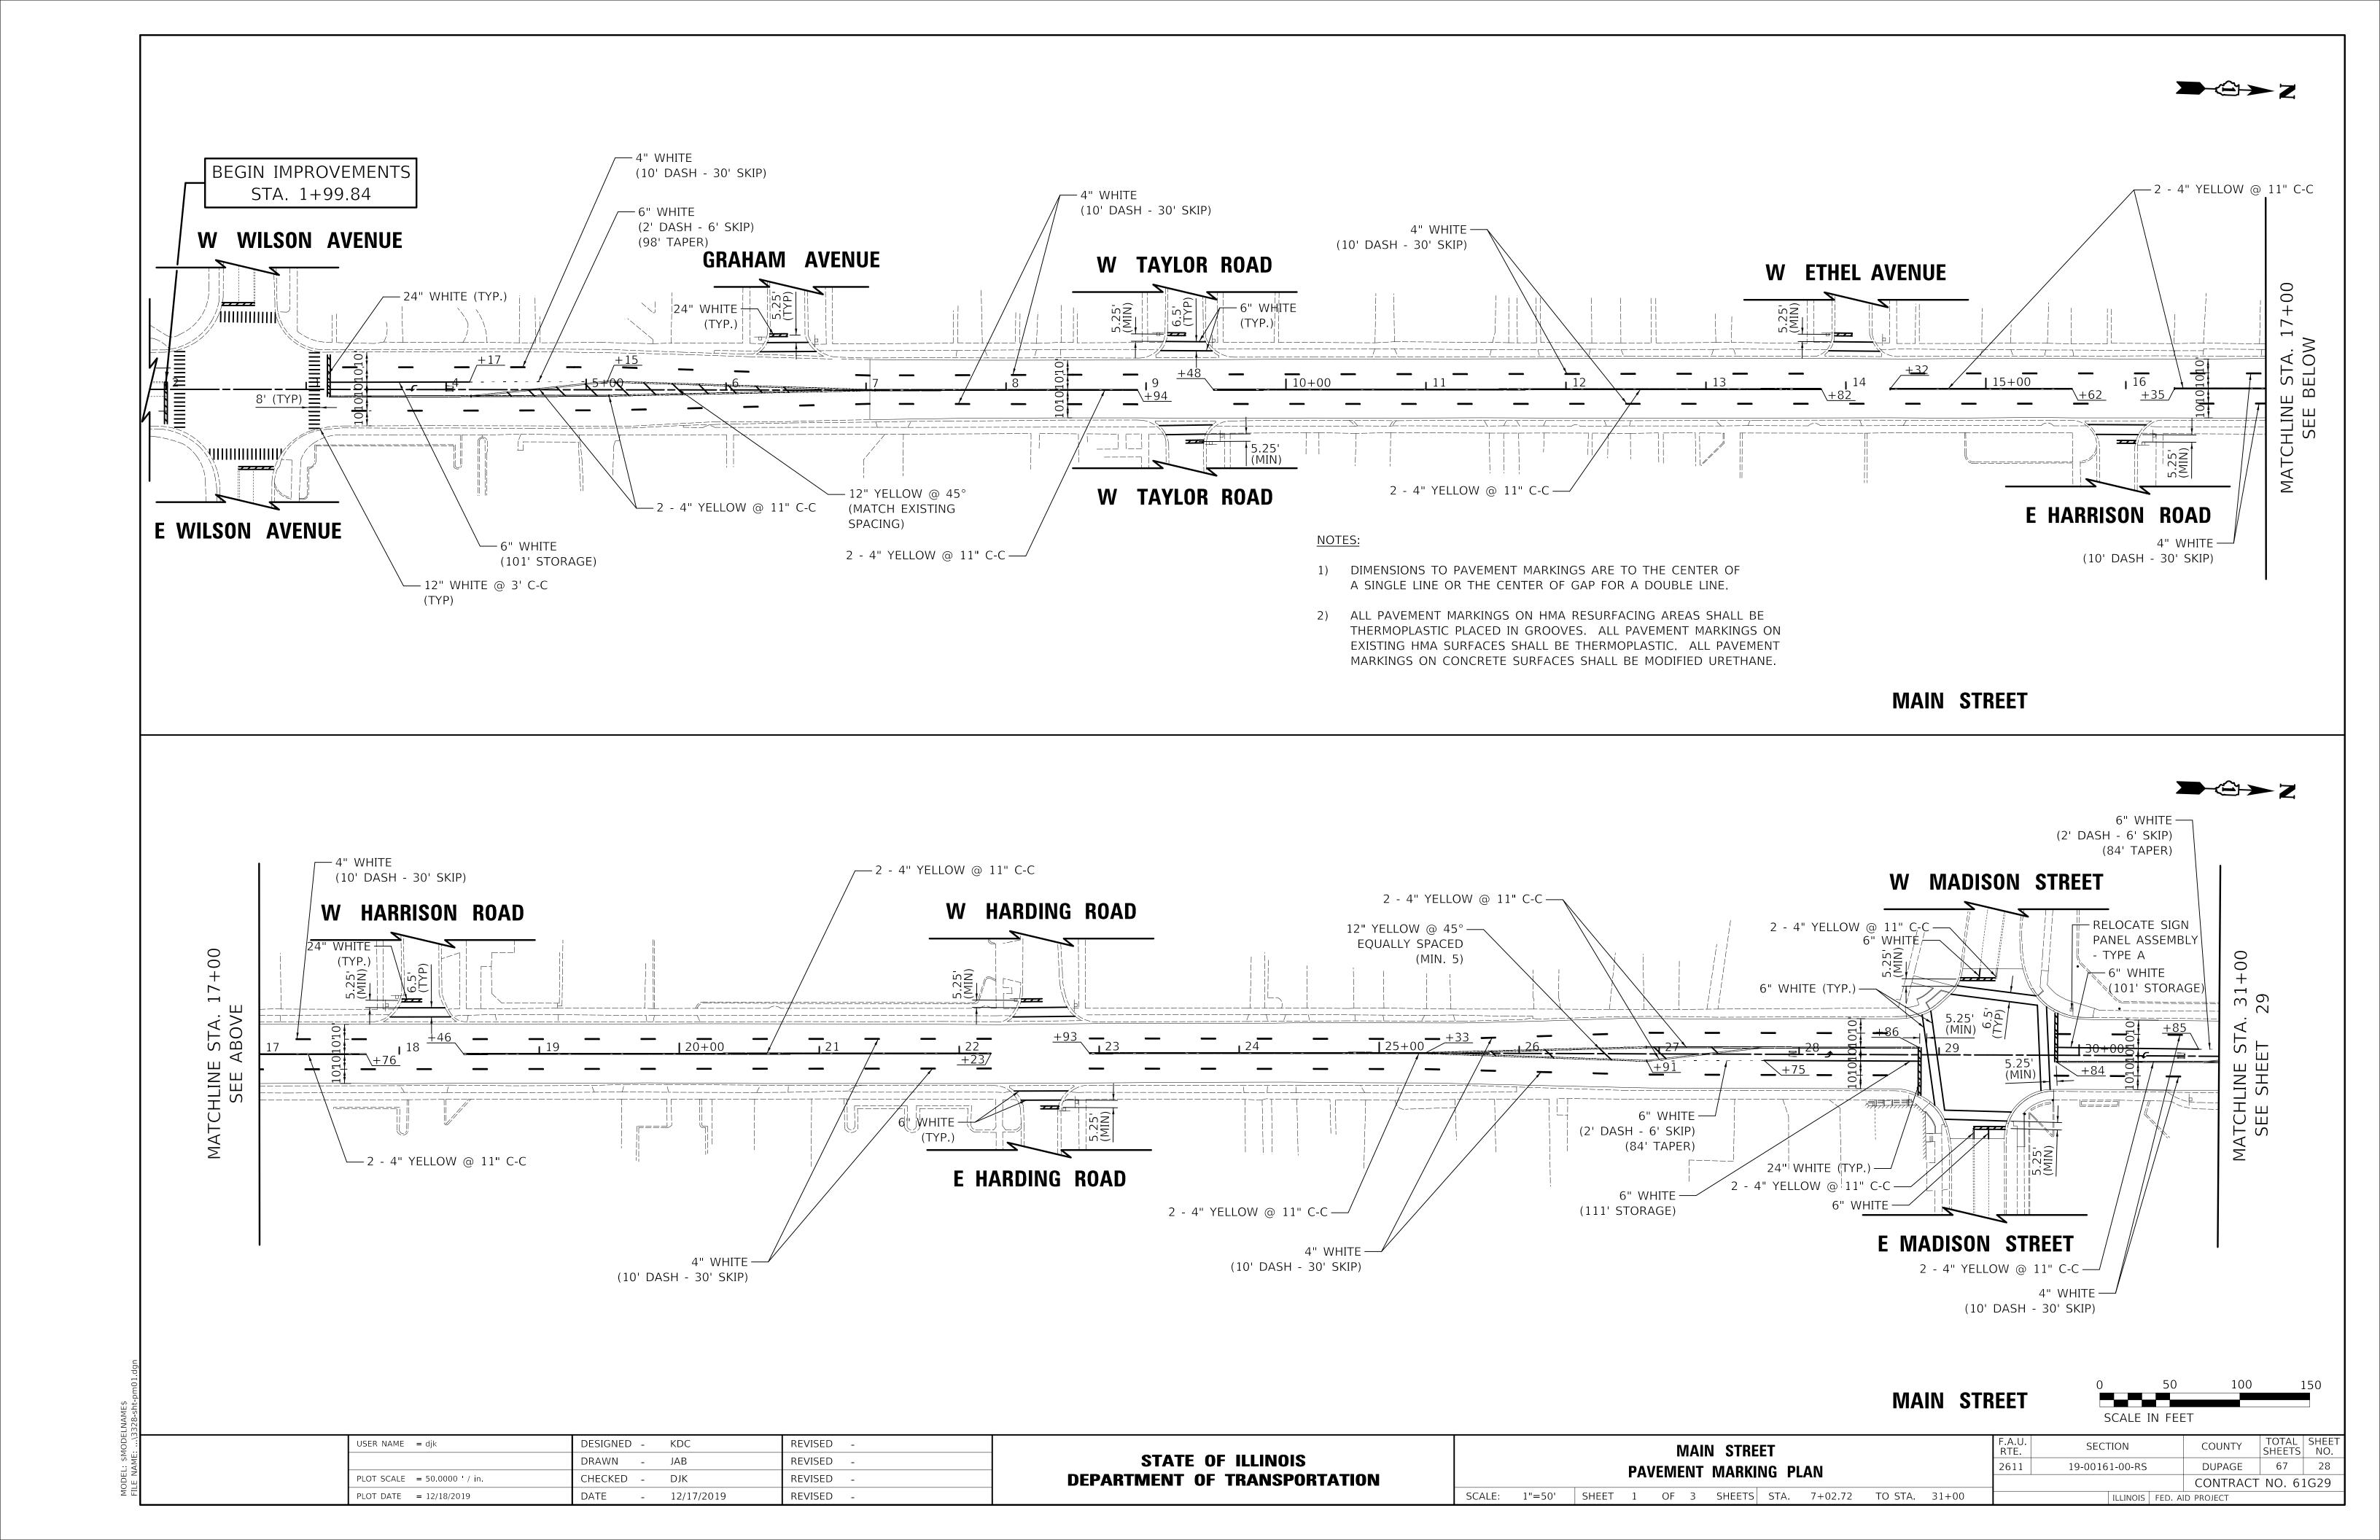

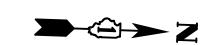

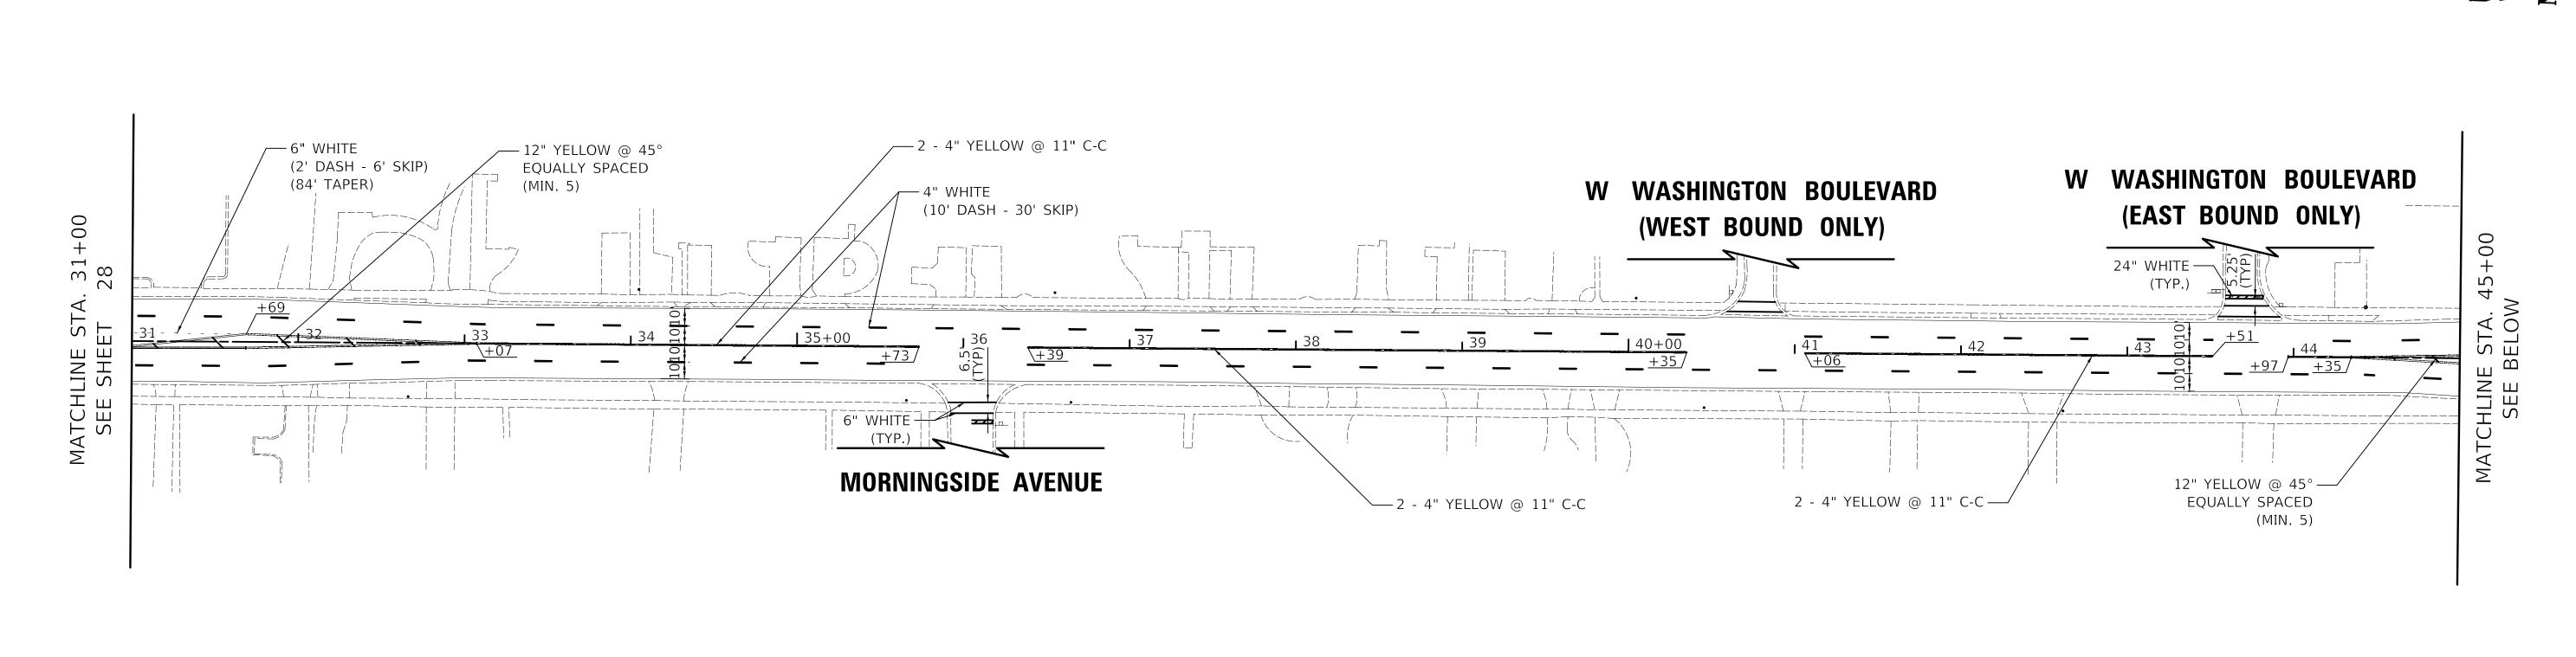

MAIN STREET

MAIN STREET

TO STA. 59+00

MAIN STREET

PAVEMENT MARKING PLAN

SCALE: 1"=50' SHEET 2 OF 3 SHEETS STA. 31+00

SCALE IN FEET

ILLINOIS FED. AID PROJECT

SECTION


19-00161-00-RS

TOTAL SHEET SHEETS NO.

DUPAGE 67 29

CONTRACT NO. 61G29

COUNTY

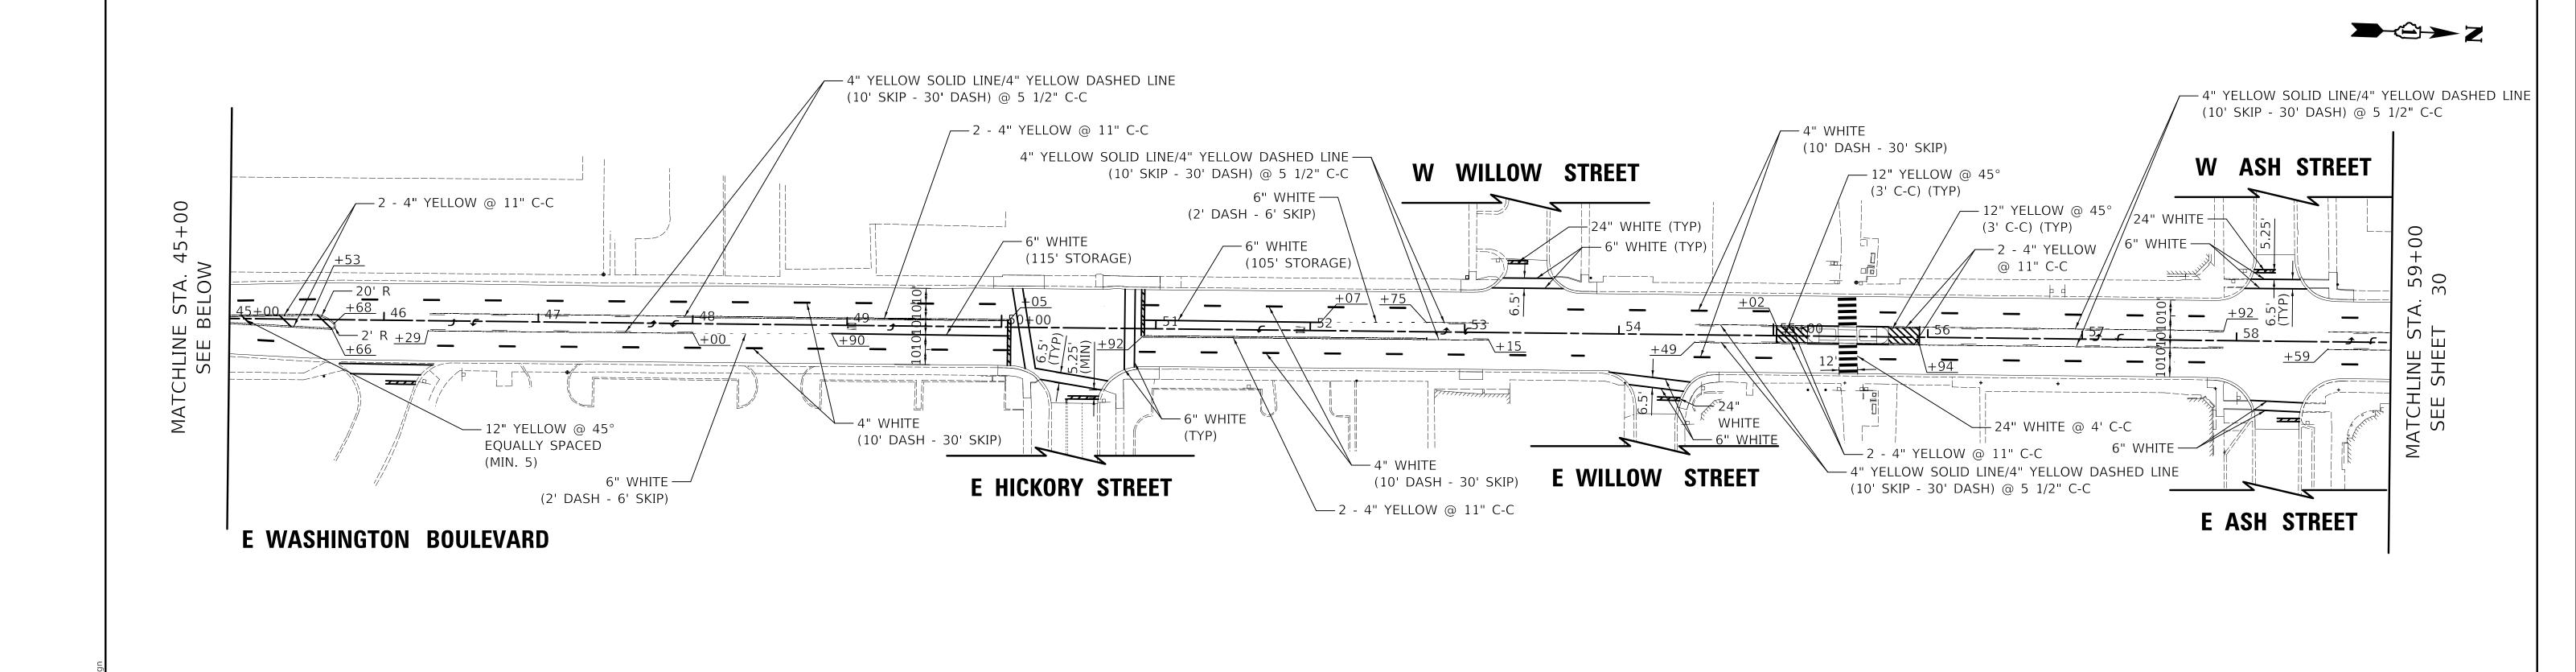

STATE OF ILLINOIS

DEPARTMENT OF TRANSPORTATION

USER NAME = djk

PLOT SCALE = 50.0000 ' / in.

PLOT DATE = 12/18/2019

DESIGNED -

CHECKED -

DRAWN

DATE

KDC

JAB

DJK

- 12/17/2019


REVISED

REVISED

REVISED


REVISED -



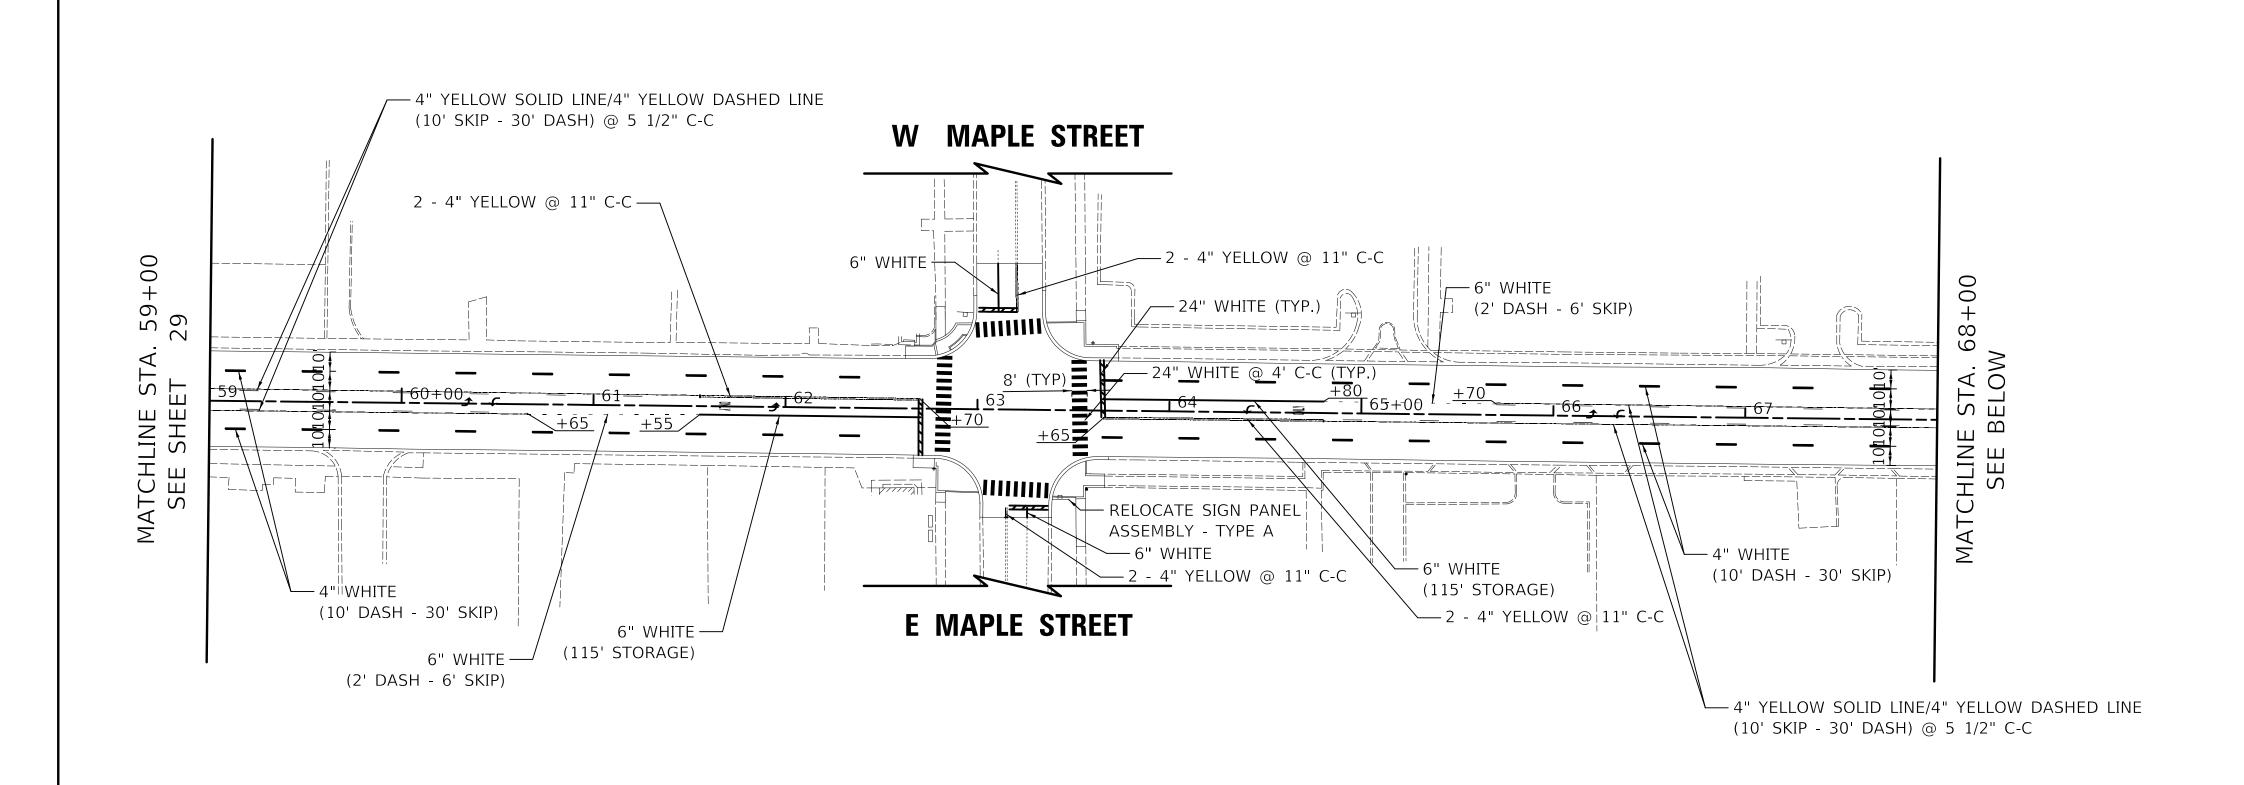

MAIN STREET




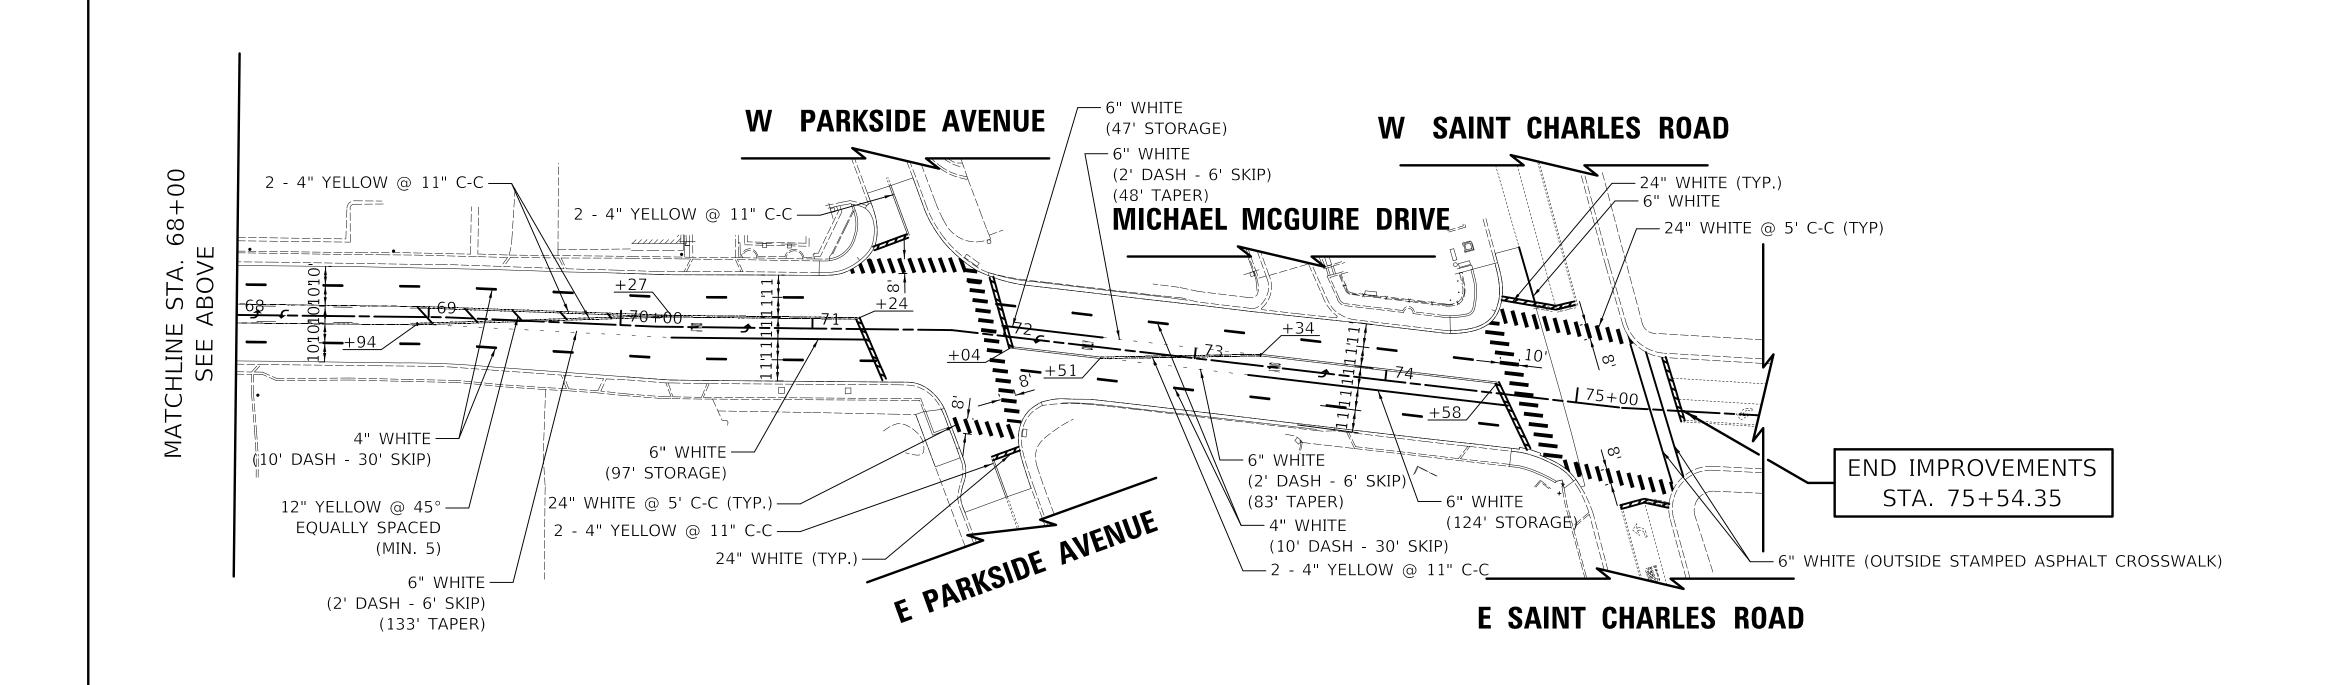

		U
ΔIN	STREET	
/ \ 11 \ \	O I II L I	SCALE

0	50	100	150
SCA	LE IN FEET		

									0 07 122 111 1 2		
	USER NAME = djk	DESIGNED -	KDC	REVISED -			MAIN STREET	F.A.U.	SECTION	COUNTY TOTAL SHEETS	SHEET
		DRAWN -	JAB	REVISED -	STATE OF ILLINOIS DEPARTMENT OF TRANSPORTATION	PAVEMENT MARKING PLAN			19-00161-00-RS	DUPAGE 67	30
	PLOT SCALE = 50.0000 ' / in.	CHECKED -	DJK	REVISED -						CONTRACT NO. 61G29	
	PLOT DATE = $12/18/2019$	DATE -	12/17/2019	REVISED -		SCALE: 1"=50'	SHEET 3 OF 3 SHEETS STA. 59+00 TO STA. 74+41.90		ILLINOIS FED. A	AID PROJECT	

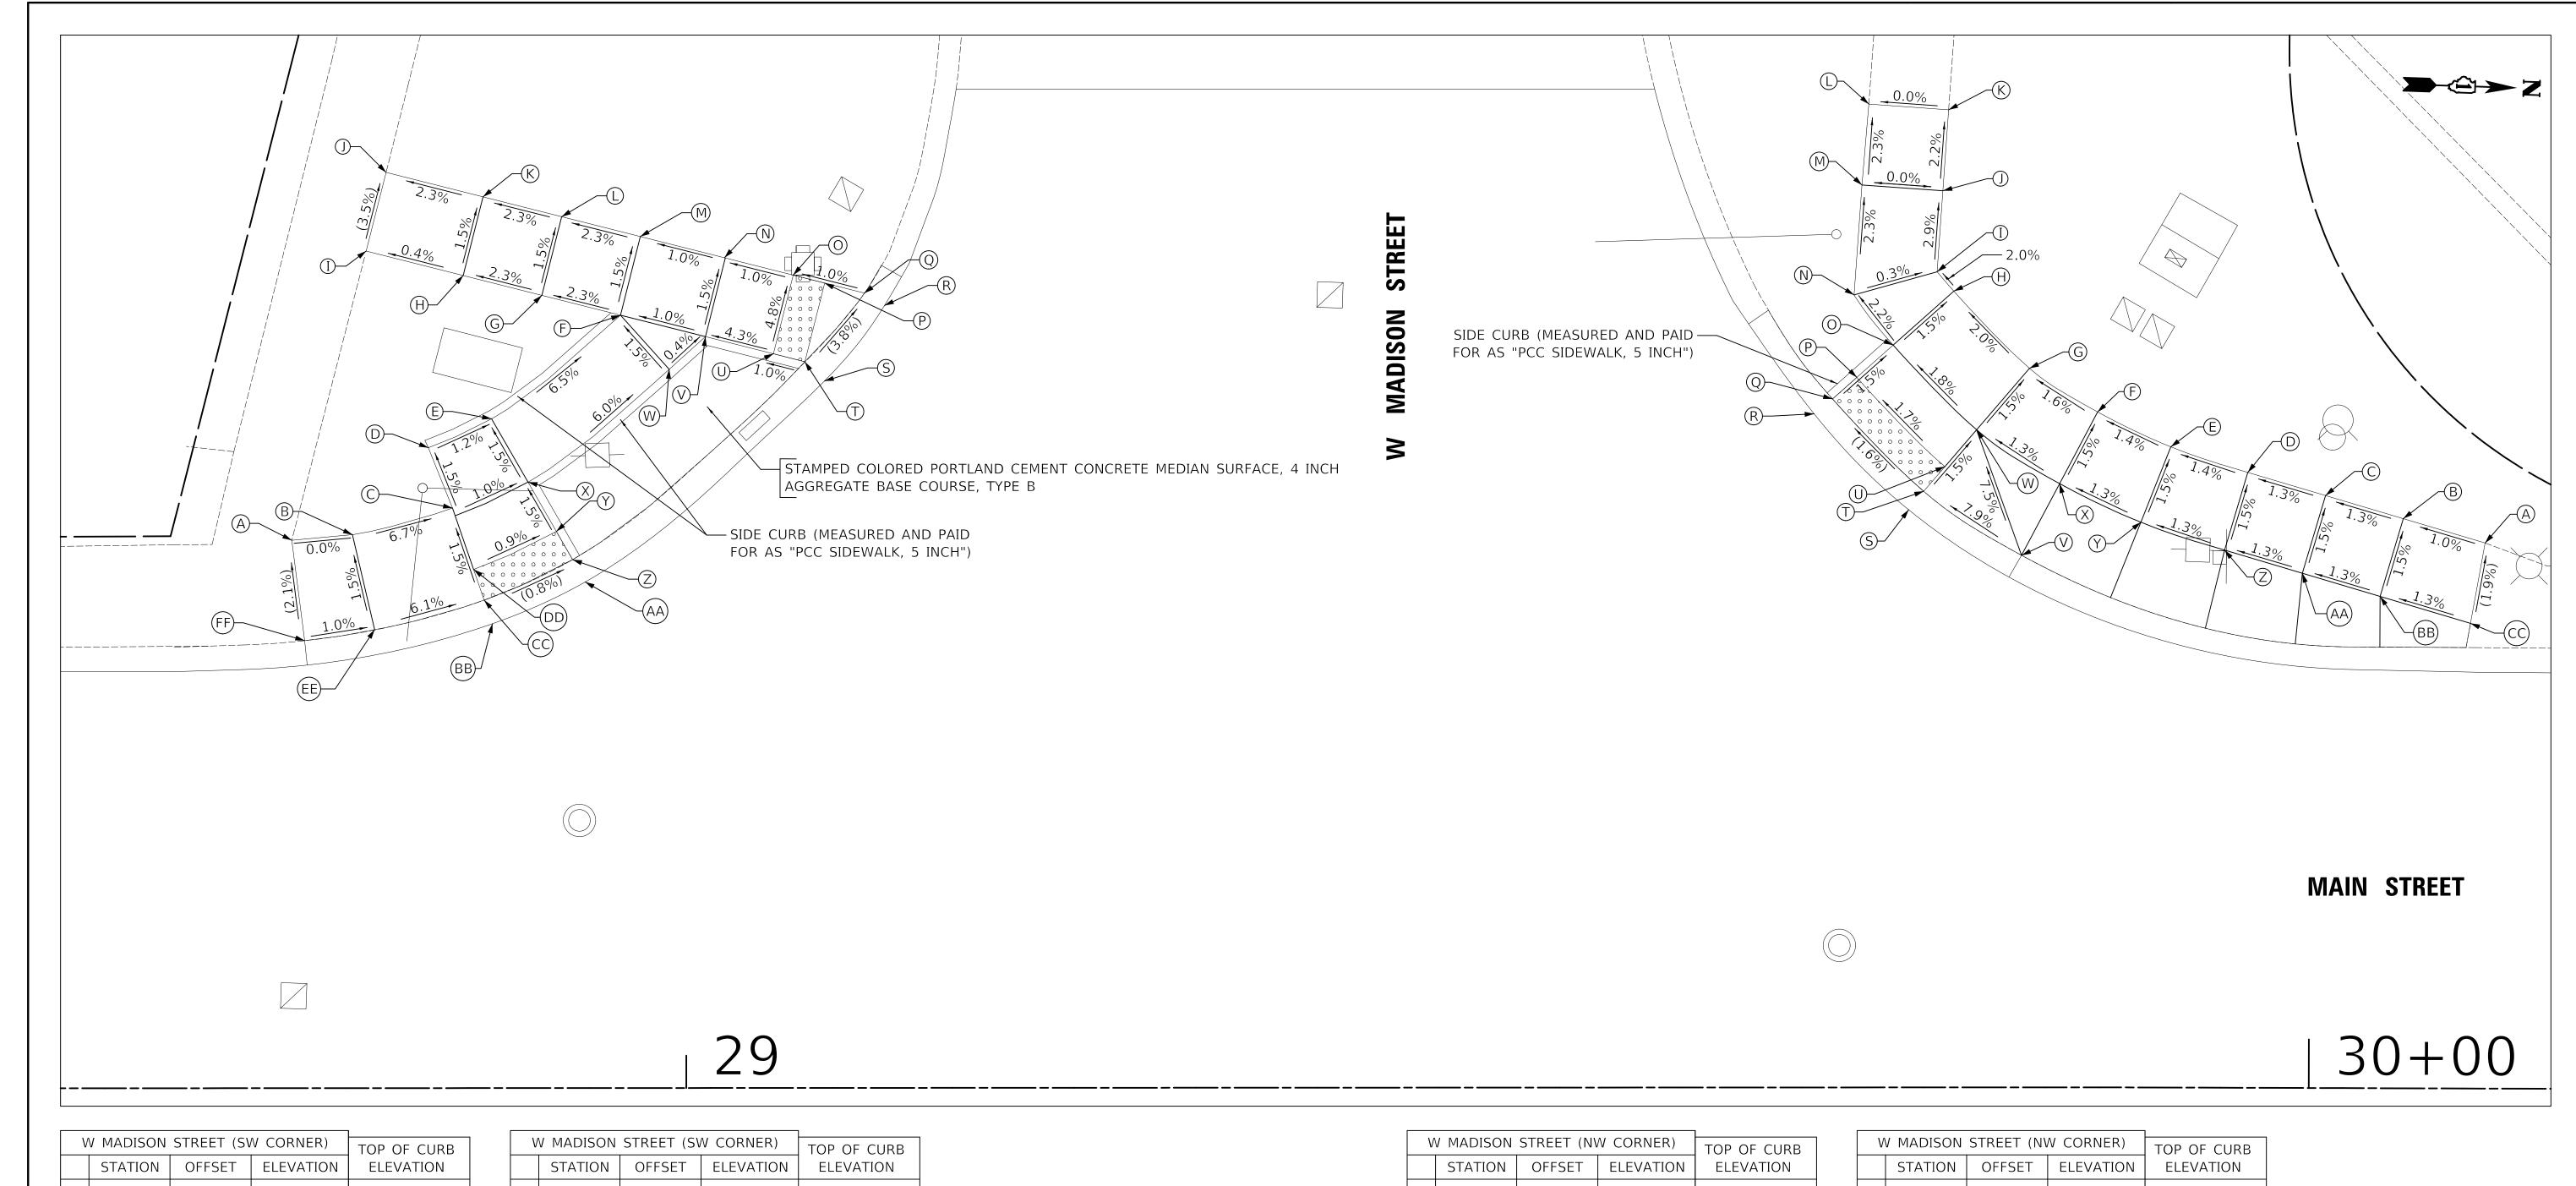

V	V MADISON	STREET (SW CORNER)		TOP OF CURB
	STATION	OFFSET	ELEVATION	ELEVATION
А	28+75.70	33.77' LT	(736.76)	
В	28+79.44	34.11' LT	736.76	
С	28+85.61	35.75' LT	736.33	
D	28+84.12	39.46' LT	736.27	736.77
Е	28+88.02	41.24' LT	736.22	736.72
F	28+95.97	47.62' LT	735.56	735.54
G	28+91.12	48.85' LT	735.44	
Н	28+86.27	50.07' LT	735.33	
I	28+80.30	51.58' LT	(735.29)	
J	28+81.53	56.43' LT	(735.12)	
K	28+87.50	54.92' LT	735.26	
L	28+92.35	53.70' LT	735.37	
М	28+97.19	52.47' LT	735.48	
N	29+02.38	51.16' LT	735.54	
0	29+06.62	50.09' LT	735.58	
Р	29+08.56	49.60' LT	735.60	

V	W MADISON STREET (SW CORNER) TOP OF CURB								
	STATION OF		ELEVATION	ELEVATION					
Q	29+11.01	48.98' LT	735.63						
R	29+12.24	48.21' LT	(735.64)						
S	29+08.54	43.56' LT	(735.85)						
Т	29+07.33	44.75' LT	735.84	736.37					
U	29+05.39	45.24' LT	735.82	736.32					
\	29+01.15	46.31' LT	735.61	736.11					
W	28+98.97	44.29' LT	735.63	736.12					
X	28+90.26	37.34' LT	736.29	736.78					
Υ	28+92.01	34.30' LT	736.34	736.84					
Ζ	28+93.01	32.56' LT	736.37	736.81					
АА	28+93.79	31.19' LT	(736.38)						
ВВ	28+88.07	28.62' LT	(736.43)						
CC	28+87.55	30.07' LT	736.42						
DD	28+86.91	31.96' LT	736.39						
EE	28+80.80	28.25' LT	736.85						
FF	28+76.49	27.58' LT	(736.89)						

V	V MADISON	STREET (N	V CORNER)	TOP OF CURB
	STATION	OFFSET	ELEVATION	ELEVATION
Α	30+10.76	33.62' LT	(735.31)	
В	30+05.72	35.10' LT	735.26	
С	30+00.92	36.51' LT	735.19	
D	29+96.12	37.92' LT	735.13	
Е	29+91.37	39.48' LT	735.06	
F	29+87.01	41.62' LT	734.99	
G	29+82.81	44.31' LT	734.91	
Н	29+78.15	49.07' LT	734.78	
I	29+77.12	50.26' LT	734.75	
J	29+77.48	55.25' LT	734.60	
Κ	29+77.84	60.24' LT	(734.65)	
L	29+72.92	60.59' LT	(734.49)	
М	29+72.49	55.61' LT	734.60	
N	29+72.00	48.84' LT	734.77	
0	29+74.41	45.75' LT	734.85	734.84

V	/ MADISON	STREET (NV	W CORNER)	TOP OF CURE
	STATION	OFFSET	ELEVATION	ELEVATION
Р	29+72.17	43.76' LT	734.90	735.40
Q	29+70.67	42.43' LT	734.93	735.37
R	29+69.54	41.51' LT	(734.94)	
S	29+75.36	35.60' LT	(735.06)	
Т	29+76.29	36.73' LT	735.05	
U	29+77.59	38.25' LT	735.03	
V	29+82.32	32.78' LT	735.60	
W	29+79.55	40.52' LT	734.98	
Χ	29+84.66	37.20' LT	735.06	
Υ	29+89.54	34.83' LT	735.13	
Z	29+94.71	33.13' LT	735.20	
АА	29+99.51	31.72' LT	735.27	
ВВ	30+04.31	30.31' LT	735.33	
CC	30+09.88	28.67' LT	(735.41)	


		,	,	I TOP OF CURB
	STATION	OFFSET	ELEVATION	ELEVATION
Р	29+72.17	43.76' LT	734.90	735.40
Q	29+70.67	42.43' LT	734.93	735.37
R	29+69.54	41.51' LT	(734.94)	
S	29+75.36	35.60' LT	(735.06)	
Т	29+76.29	36.73' LT	735.05	
U	29+77.59	38.25' LT	735.03	
V	29+82.32	32.78' LT	735.60	
V	29+79.55	40.52' LT	734.98	
Χ	29+84.66	37.20' LT	735.06	
Υ	29+89.54	34.83' LT	735.13	
Ζ	29+94.71	33.13' LT	735.20	
λA	29+99.51	31.72' LT	735.27	
ЗВ	30+04.31	30.31' LT	735.33	
CC	30+09.88	28.67' LT	(735.41)	


LEGEND

DETECTABLE WARNINGS

SCALE IN FEET


DESIGNED -REVISED F.A.U. RTE. USER NAME = djk KDC SECTION MAIN STREET STATE OF ILLINOIS DRAWN -JAB REVISED DUPAGE 67 31 19-00161-00-RS ADA GRADING PLAN **DEPARTMENT OF TRANSPORTATION** CHECKED -REVISED -PLOT SCALE = 5.0000 ' / in. DJK CONTRACT NO. 61G29 SCALE: 1"=5' SHEET 1 OF 13 SHEETS DATE - 12/17/2019 PLOT DATE = 12/18/2019REVISED -ILLINOIS FED. AID PROJECT

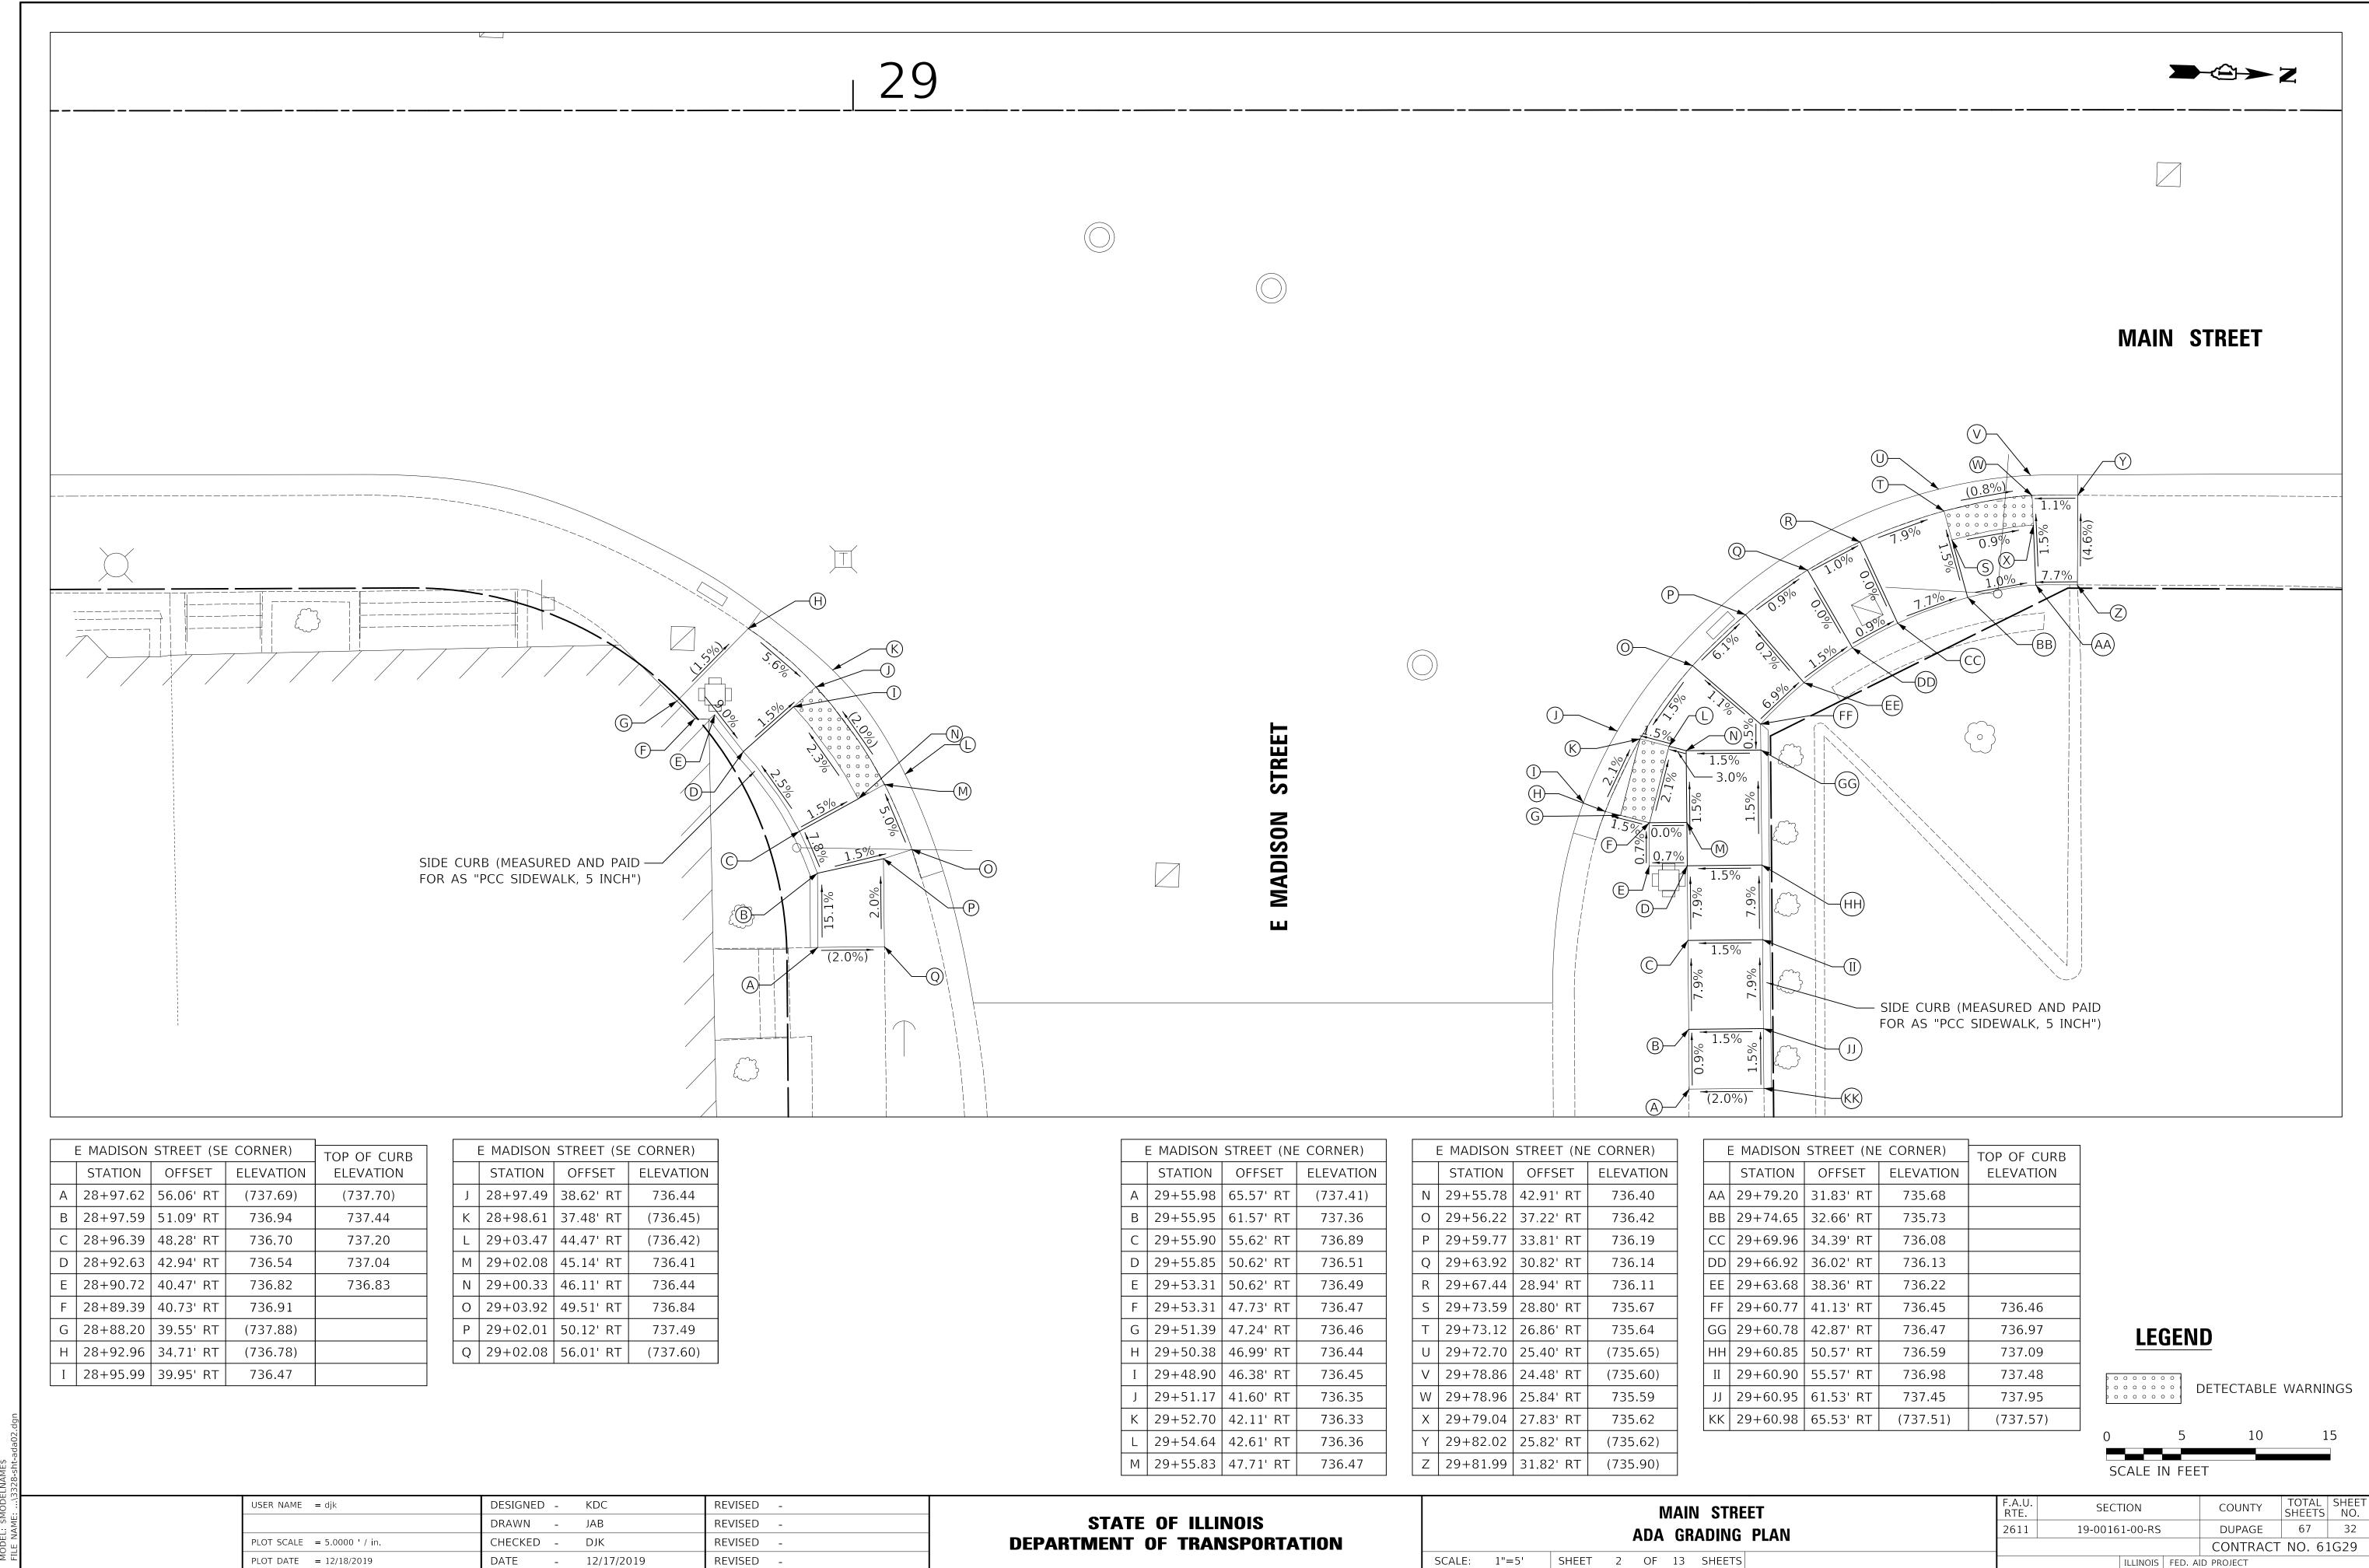


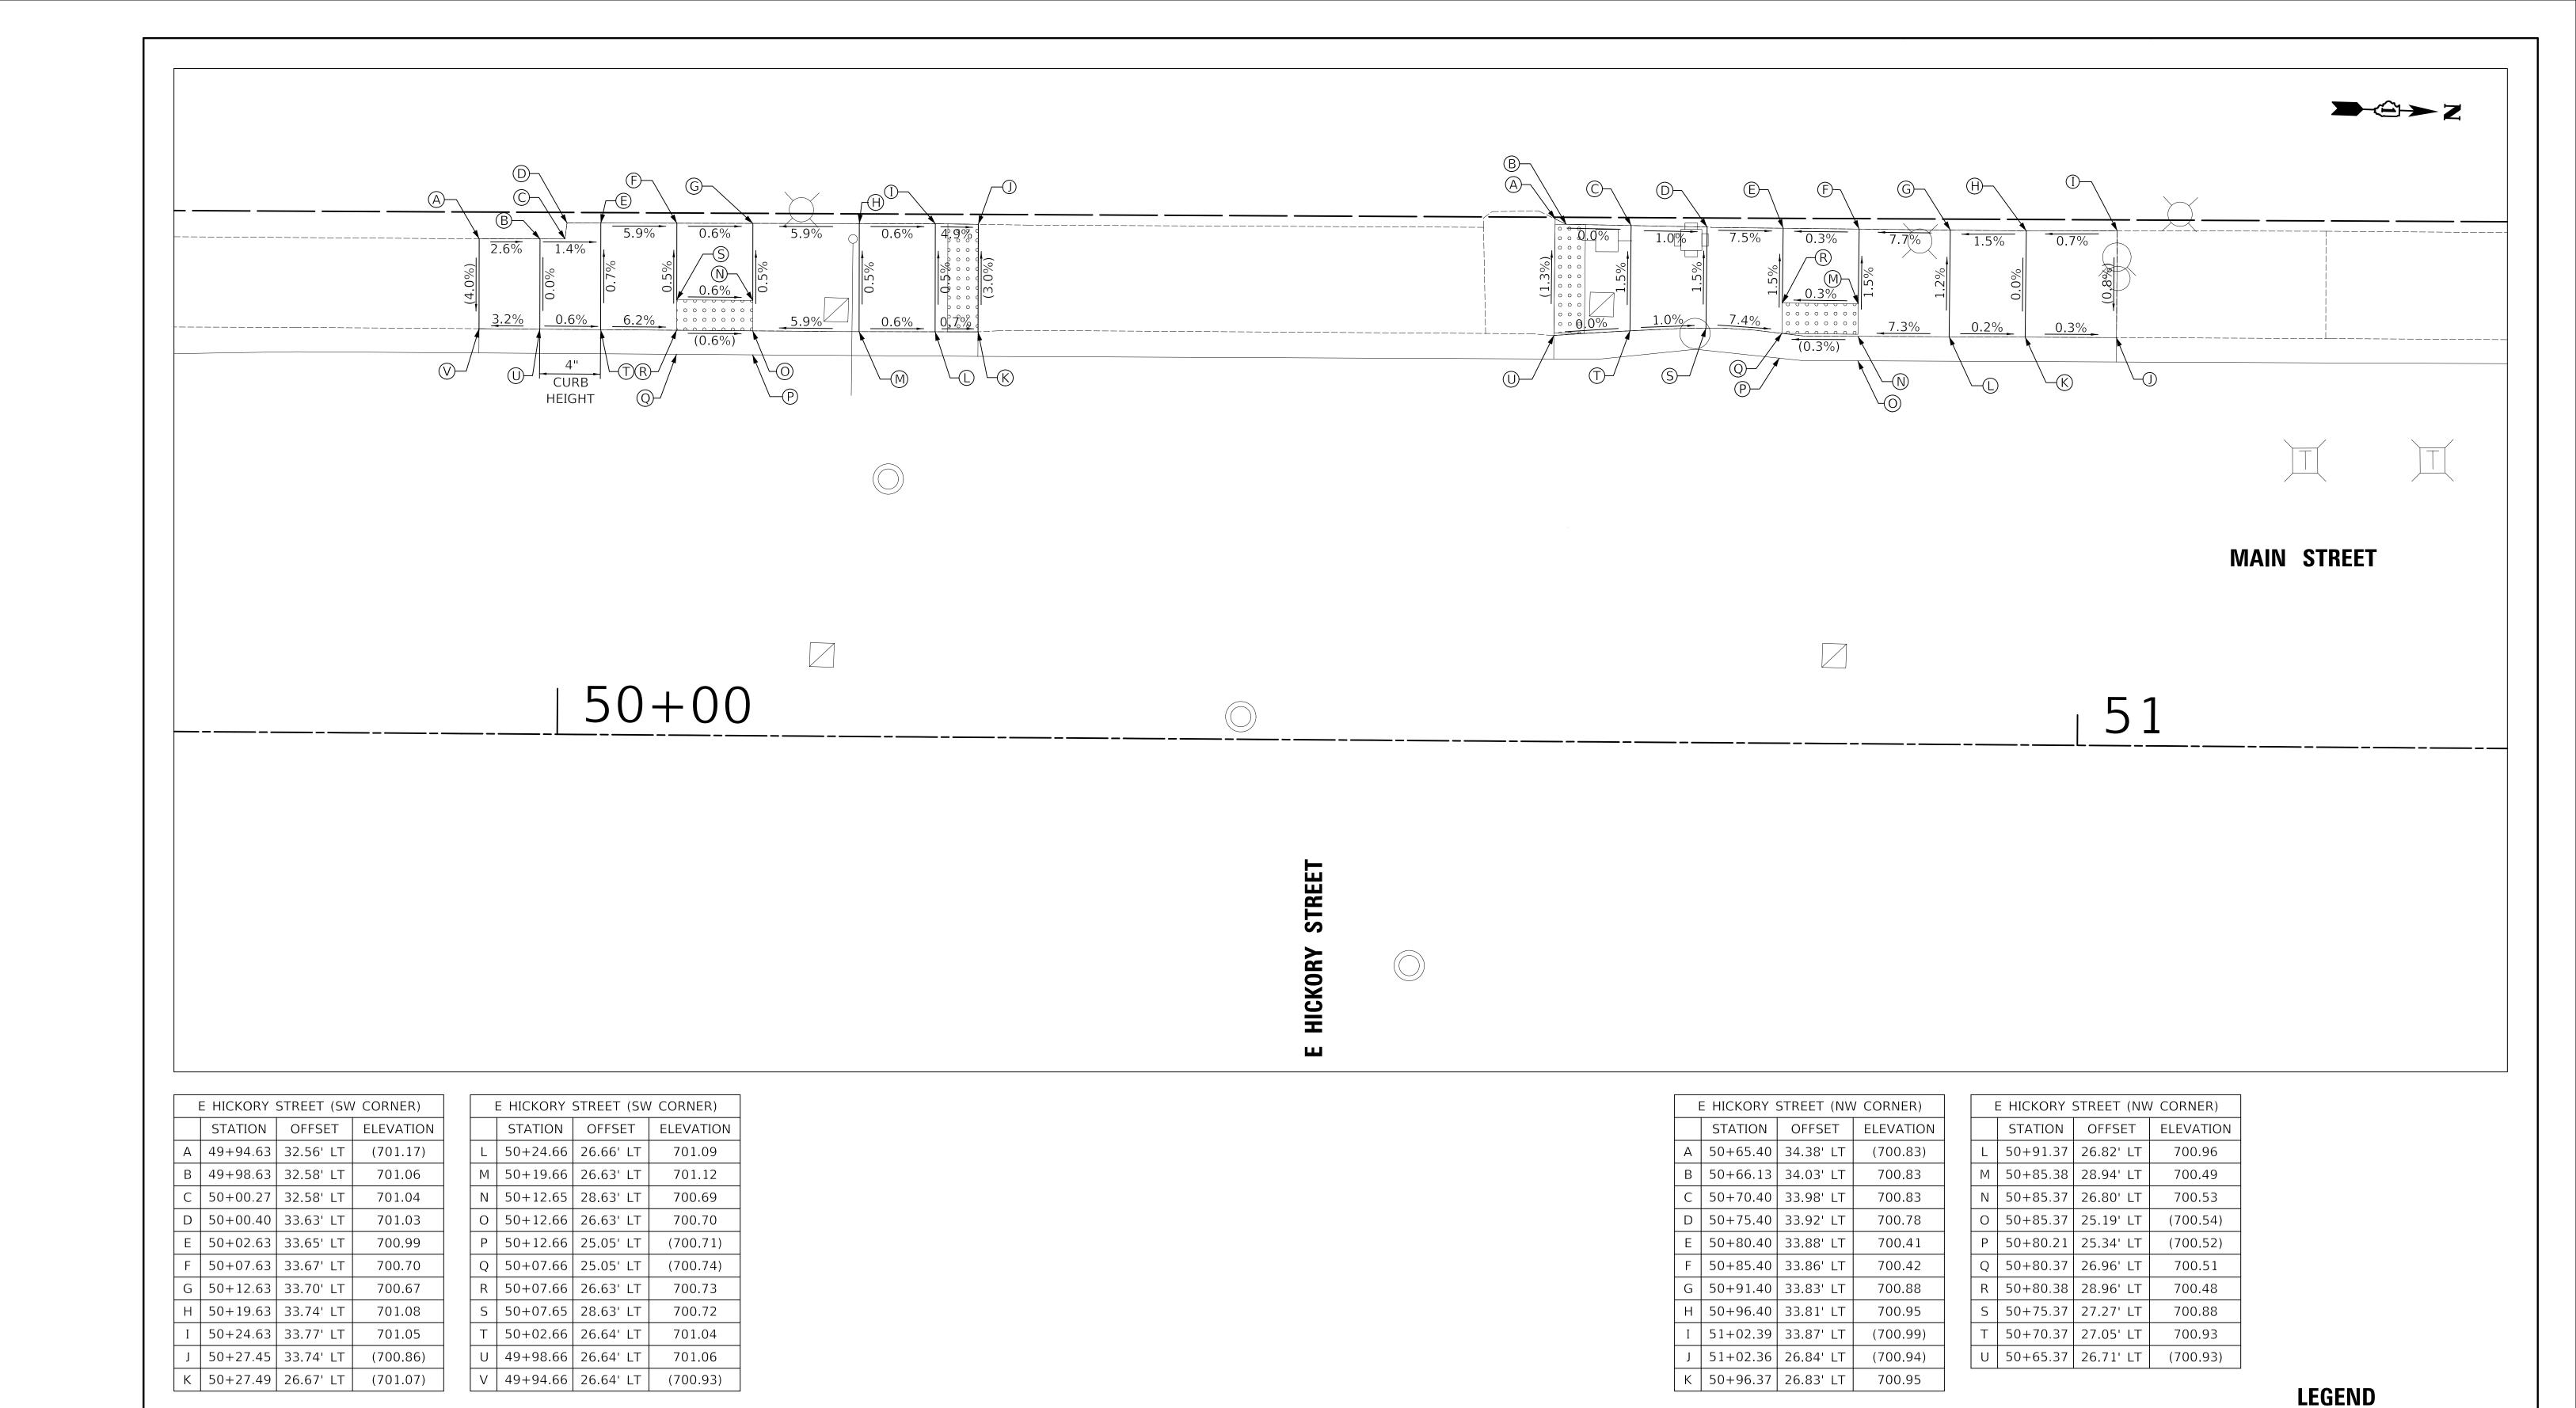

DESIGNED - KDC REVISED
MAIN STREET SECTION COUNTY SHEETS NO.

USER NAME = djk**MAIN STREET STATE OF ILLINOIS** REVISED DRAWN JAB 19-00161-00-RS DUPAGE 67 33 **ADA GRADING PLAN DEPARTMENT OF TRANSPORTATION** CHECKED -DJK REVISED PLOT SCALE = 5.0000 ' / in. CONTRACT NO. 61G29 DATE REVISED SCALE: 1"=5' SHEET 3 OF 13 SHEETS PLOT DATE = 12/18/2019- 12/17/2019 ILLINOIS FED. AID PROJECT

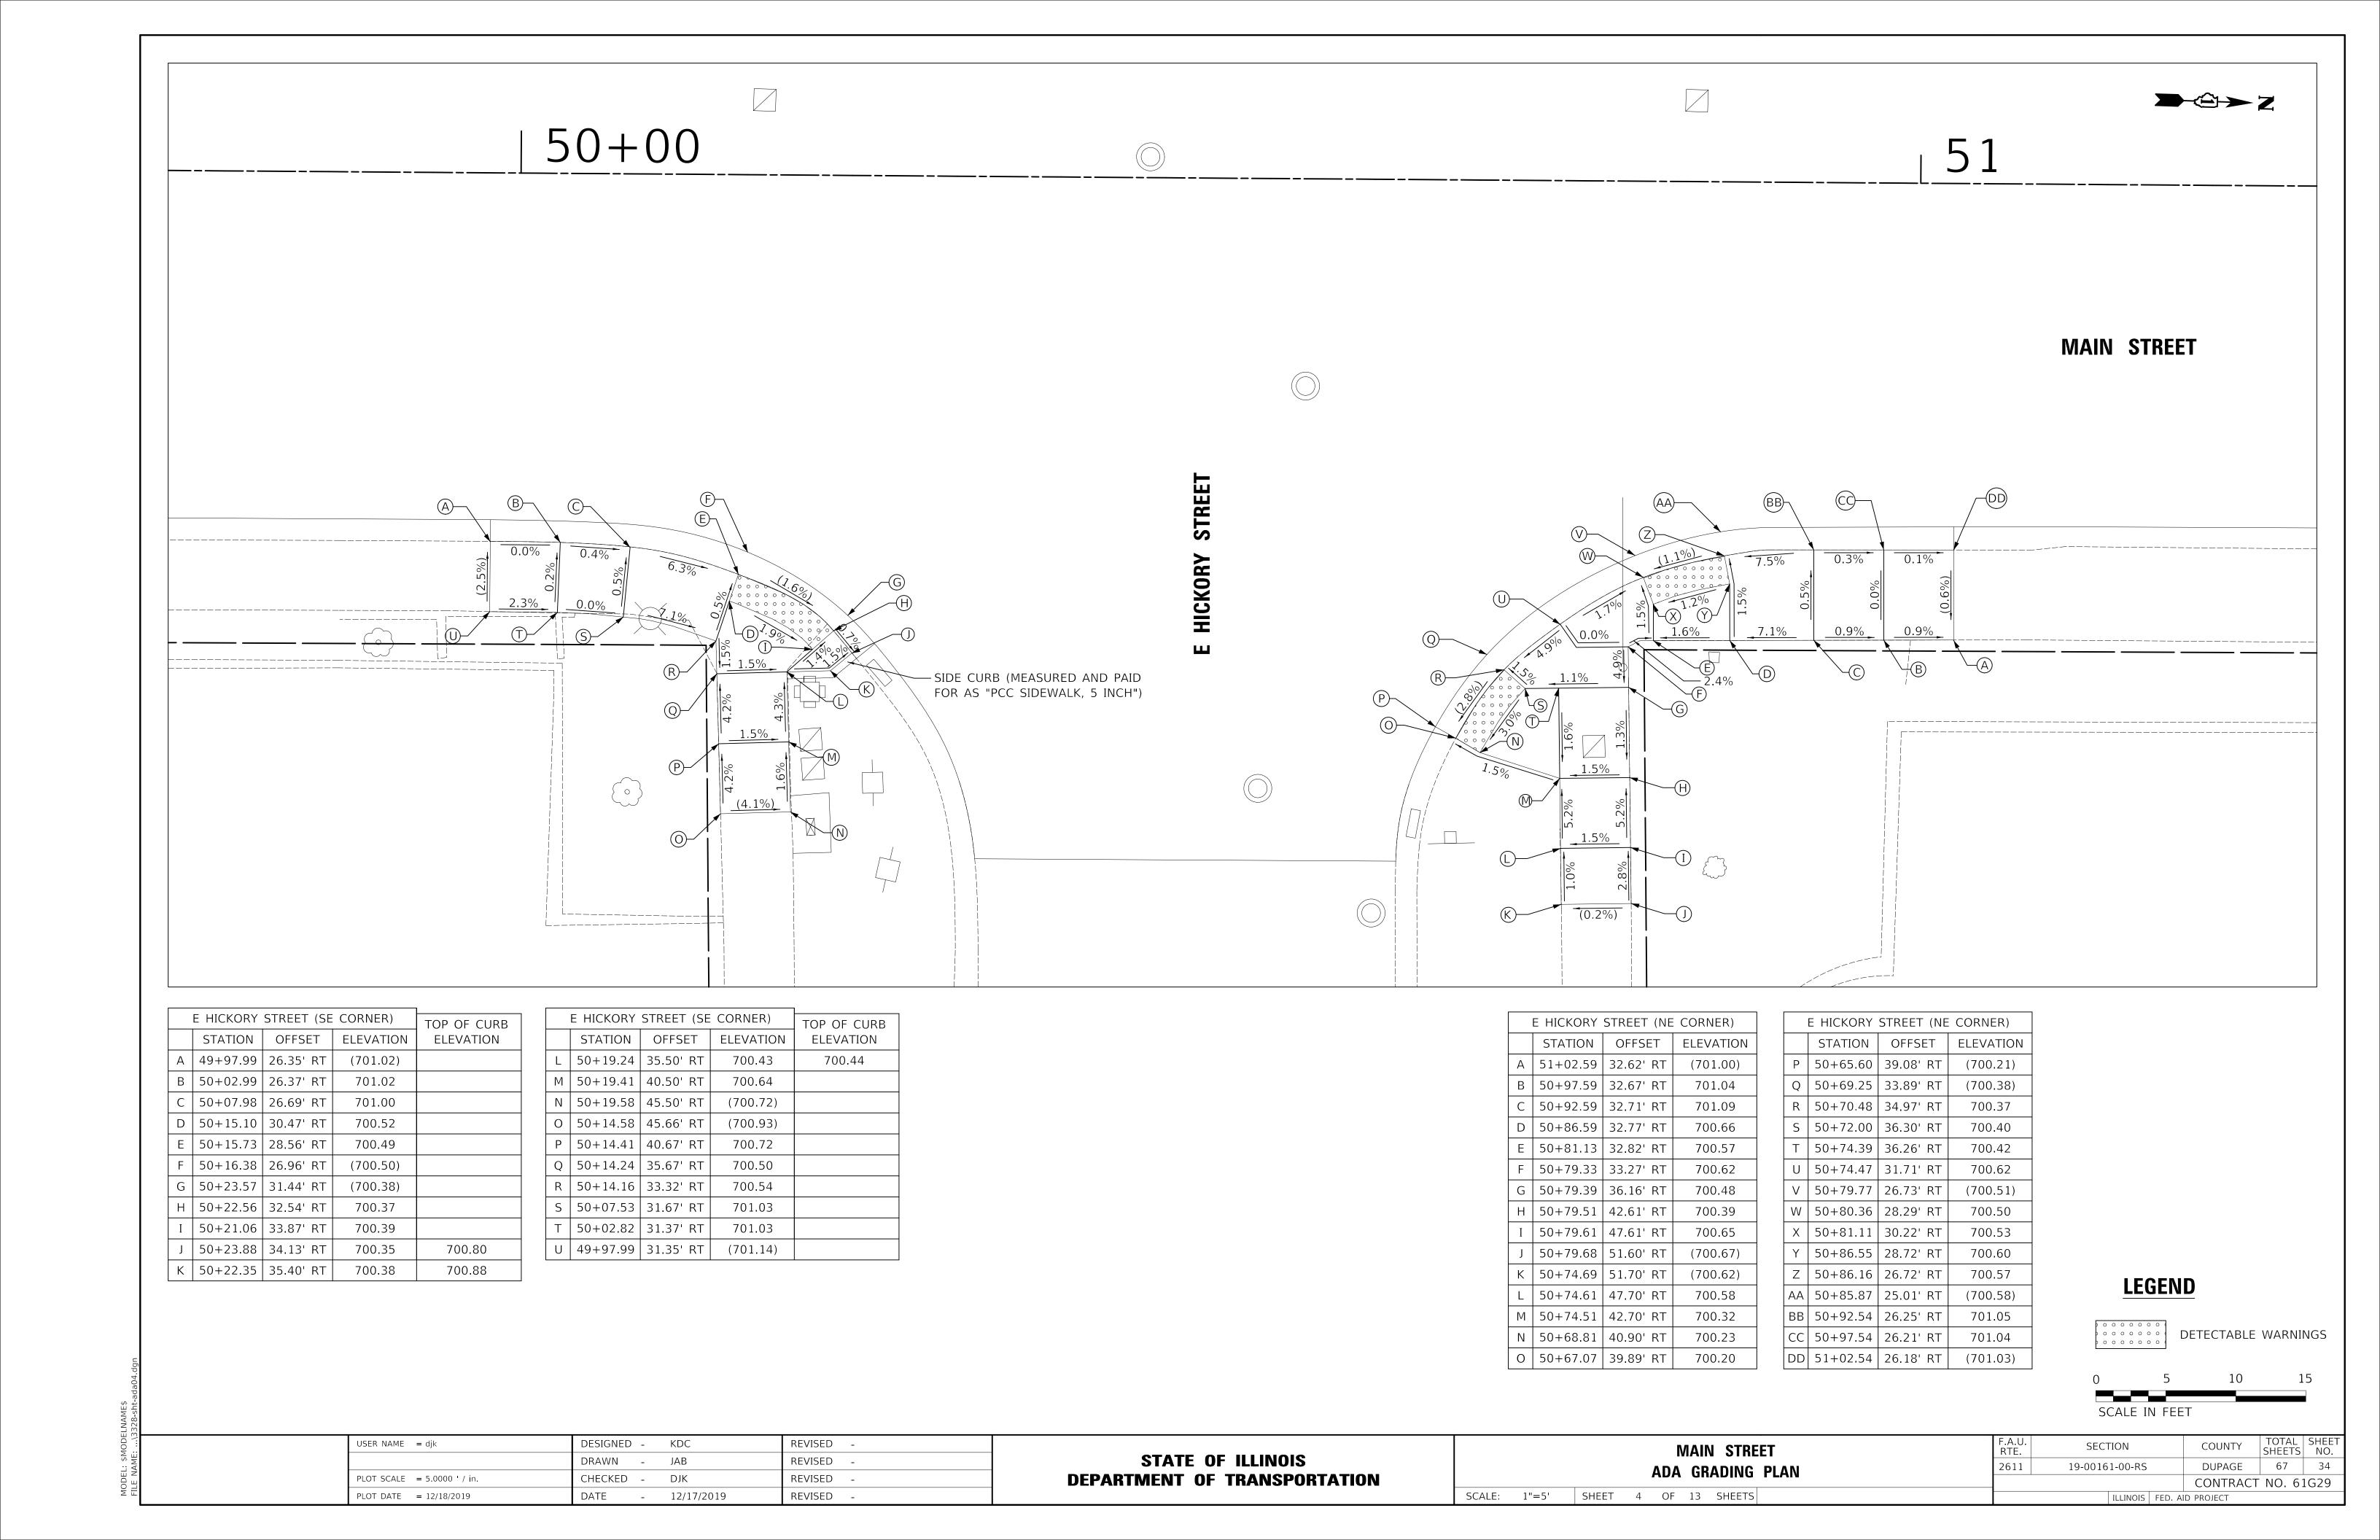

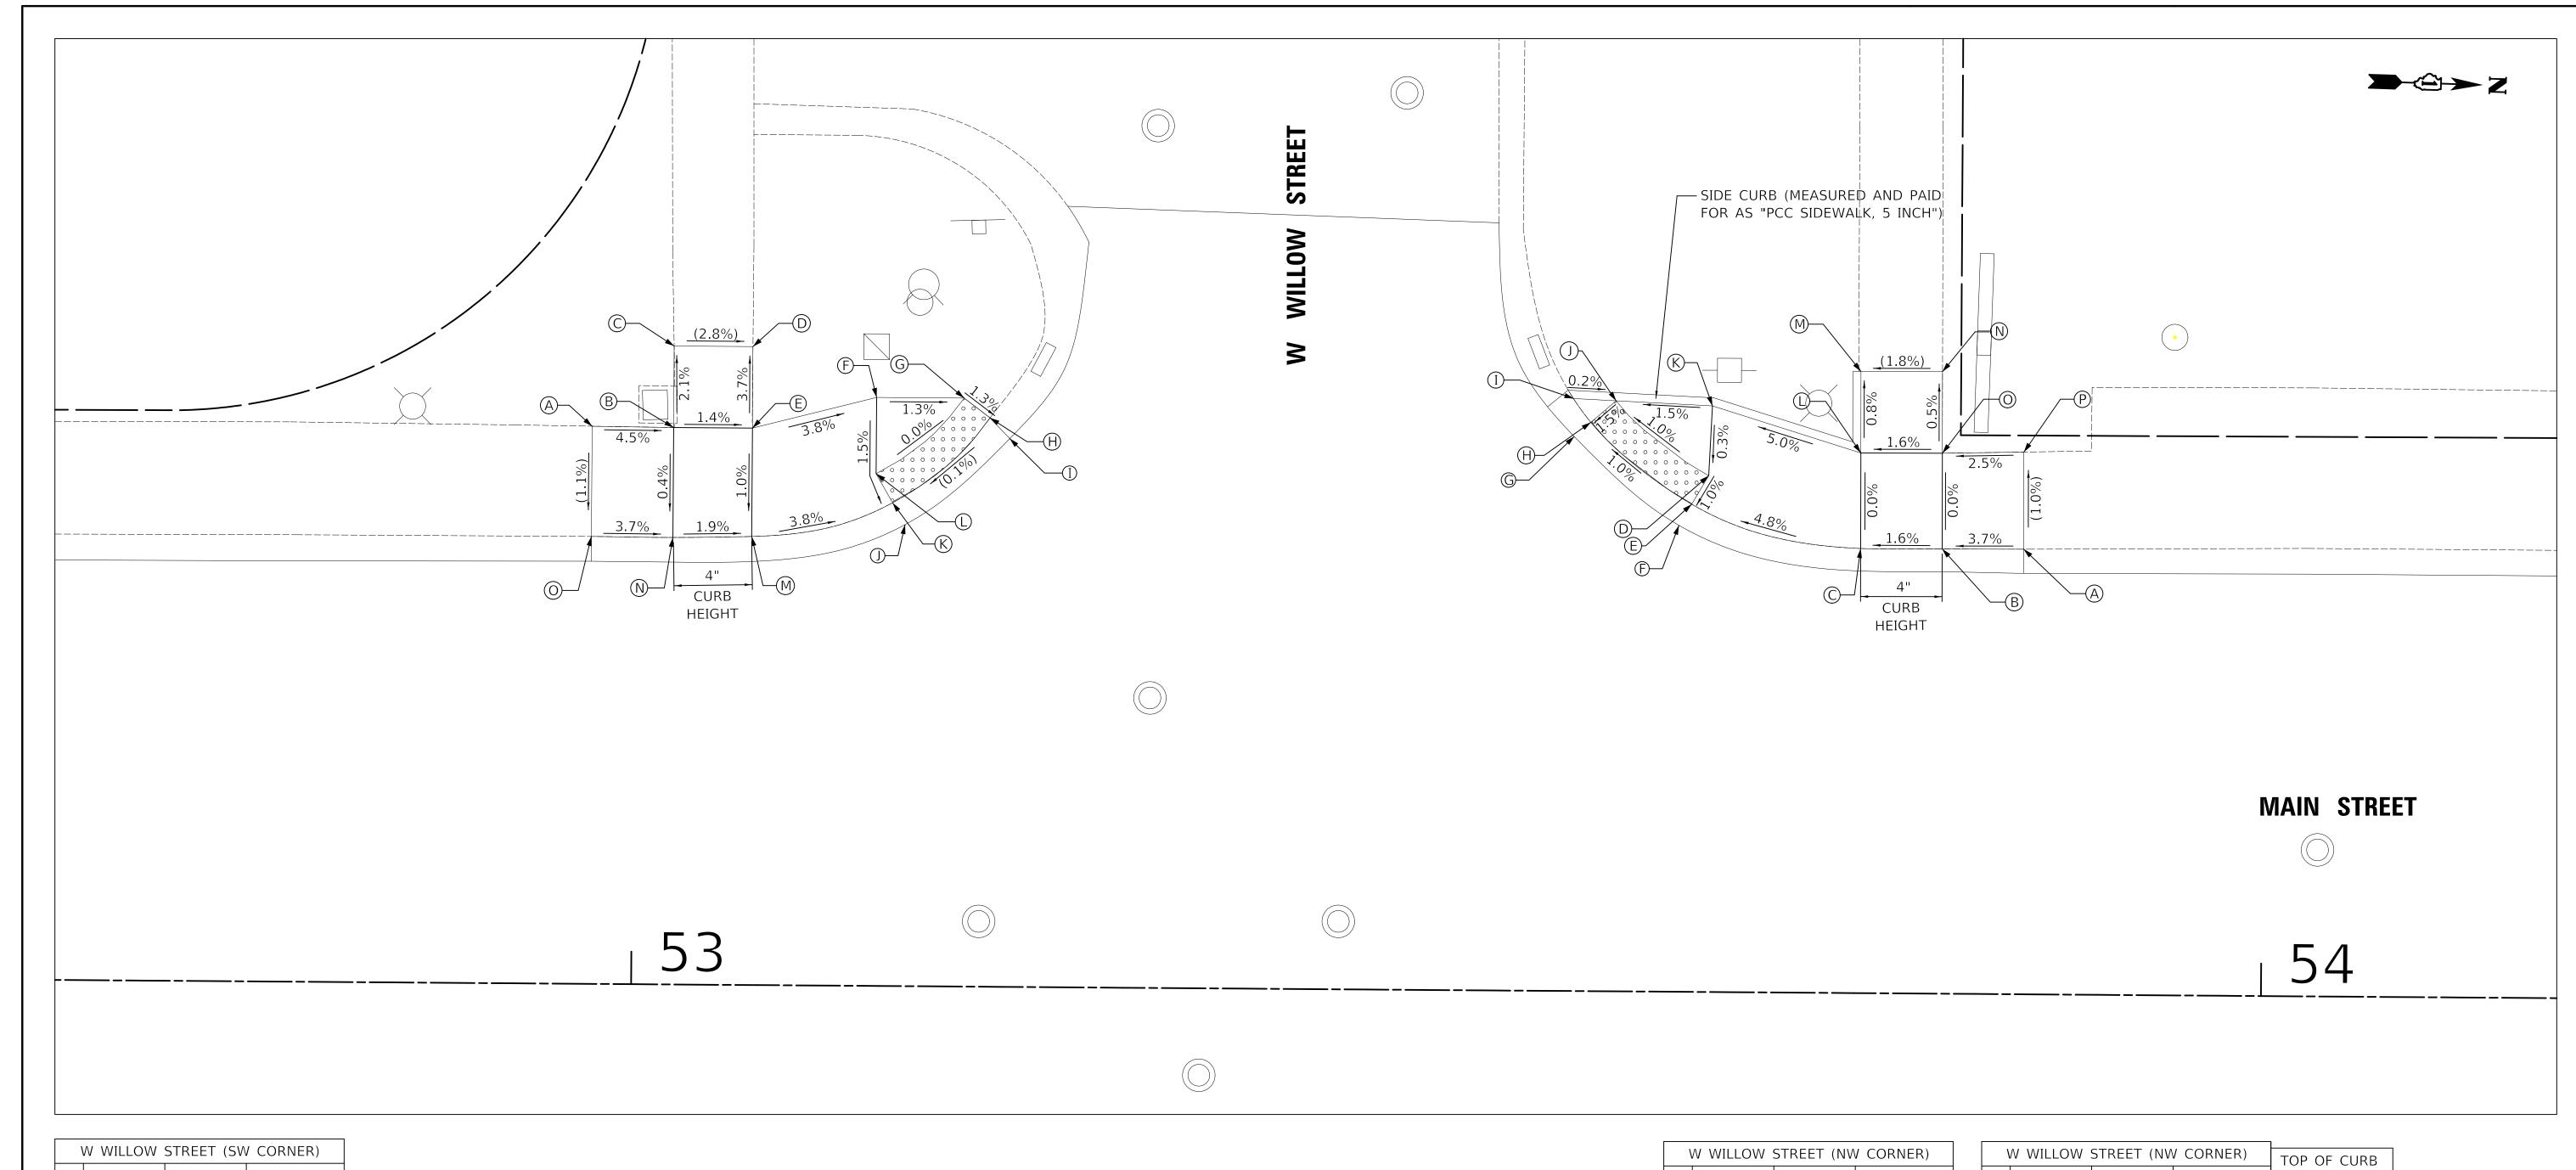

	VV WILLOW STREET (SW CORNER)							
	STATION	OFFSET	ELEVATION					
А	52+97.36	34.21' LT	(700.39)					
В	53+02.36	34.17' LT	700.16					
С	53+02.36	39.17' LT	(700.06)					
D	53+07.19	39.17' LT	(699.91)					
Е	53+07.20	34.17' LT	700.09					
F	53+14.80	36.10' LT	699.80					
G	53+20.17	36.10' LT	699.73					
Н	53+21.76	34.89' LT	699.71					
I	53+22.98	33.65' LT	(699.72)					
J	53+16.60	28.31' LT	(699.71)					
K	53+15.83	29.65' LT	699.70					
L	53+14.80	31.43' LT	699.73					
М	53+07.20	27.52' LT	700.04					
N	53+02.36	27.42' LT	700.13					
0	52+97.36	27.45' LT	(700.32)					

W WILLOW STREET (NW CORNER)								
	STATION	OFFSET	ELEVATION					
Α	53+85.24	27.31' LT	(700.44)					
В	53+80.24	27.29' LT	700.26					
С	53+75.24	27.26' LT	700.18					
D	53+65.89	31.67' LT	699.68					
Е	53+64.85	29.92' LT	699.66					
F	53+64.09	28.62' LT	(699.67)					
G	53+57.62	34.02' LT	(699.59)					
Н	53+58.63	34.90' LT	699.58					


\	WILLOW !	TOP OF CURB							
	STATION	OFFSET	ELEVATION	ELEVATION					
I	53+57.57	36.35' LT	699.62	(699.93)					
J	53+60.17	36.23' LT	699.61	(699.98)					
K	53+66.08	35.96' LT	699.70	(700.06)					
L	53+75.21	33.13' LT	700.18	(700.20)					
М	53+75.18	38.13' LT	(700.14)						
N	53+80.18	38.16' LT	(700.23)						
0	53+80.21	33.16' LT	700.26						
Р	53+85.21	33.27' LT	(700.38)						


LEGEND

DETECTABLE WARNINGS


		5	10
ALE	IN	FEET	

USER NAME = djk	DESIGNED -	KDC	REVISED -		MAIN STREET	F.A.U. RTF	SECTION	COUNTY TOTAL SHEET NO
	DRAWN -	JAB	REVISED -	STATE OF ILLINOIS		2611	19-00161-00-RS	DUPAGE 67 35
PLOT SCALE = 5.0000 ' / in.	CHECKED -	DJK	REVISED -	DEPARTMENT OF TRANSPORTATION	ADA GRADING PLAN			CONTRACT NO. 61G29
PLOT DATE = 12/18/2019	DATE -	12/17/2019	REVISED -		SCALE: 1"=5' SHEET 5 OF 13 SHEETS		ILLINOIS FED. A	AID PROJECT

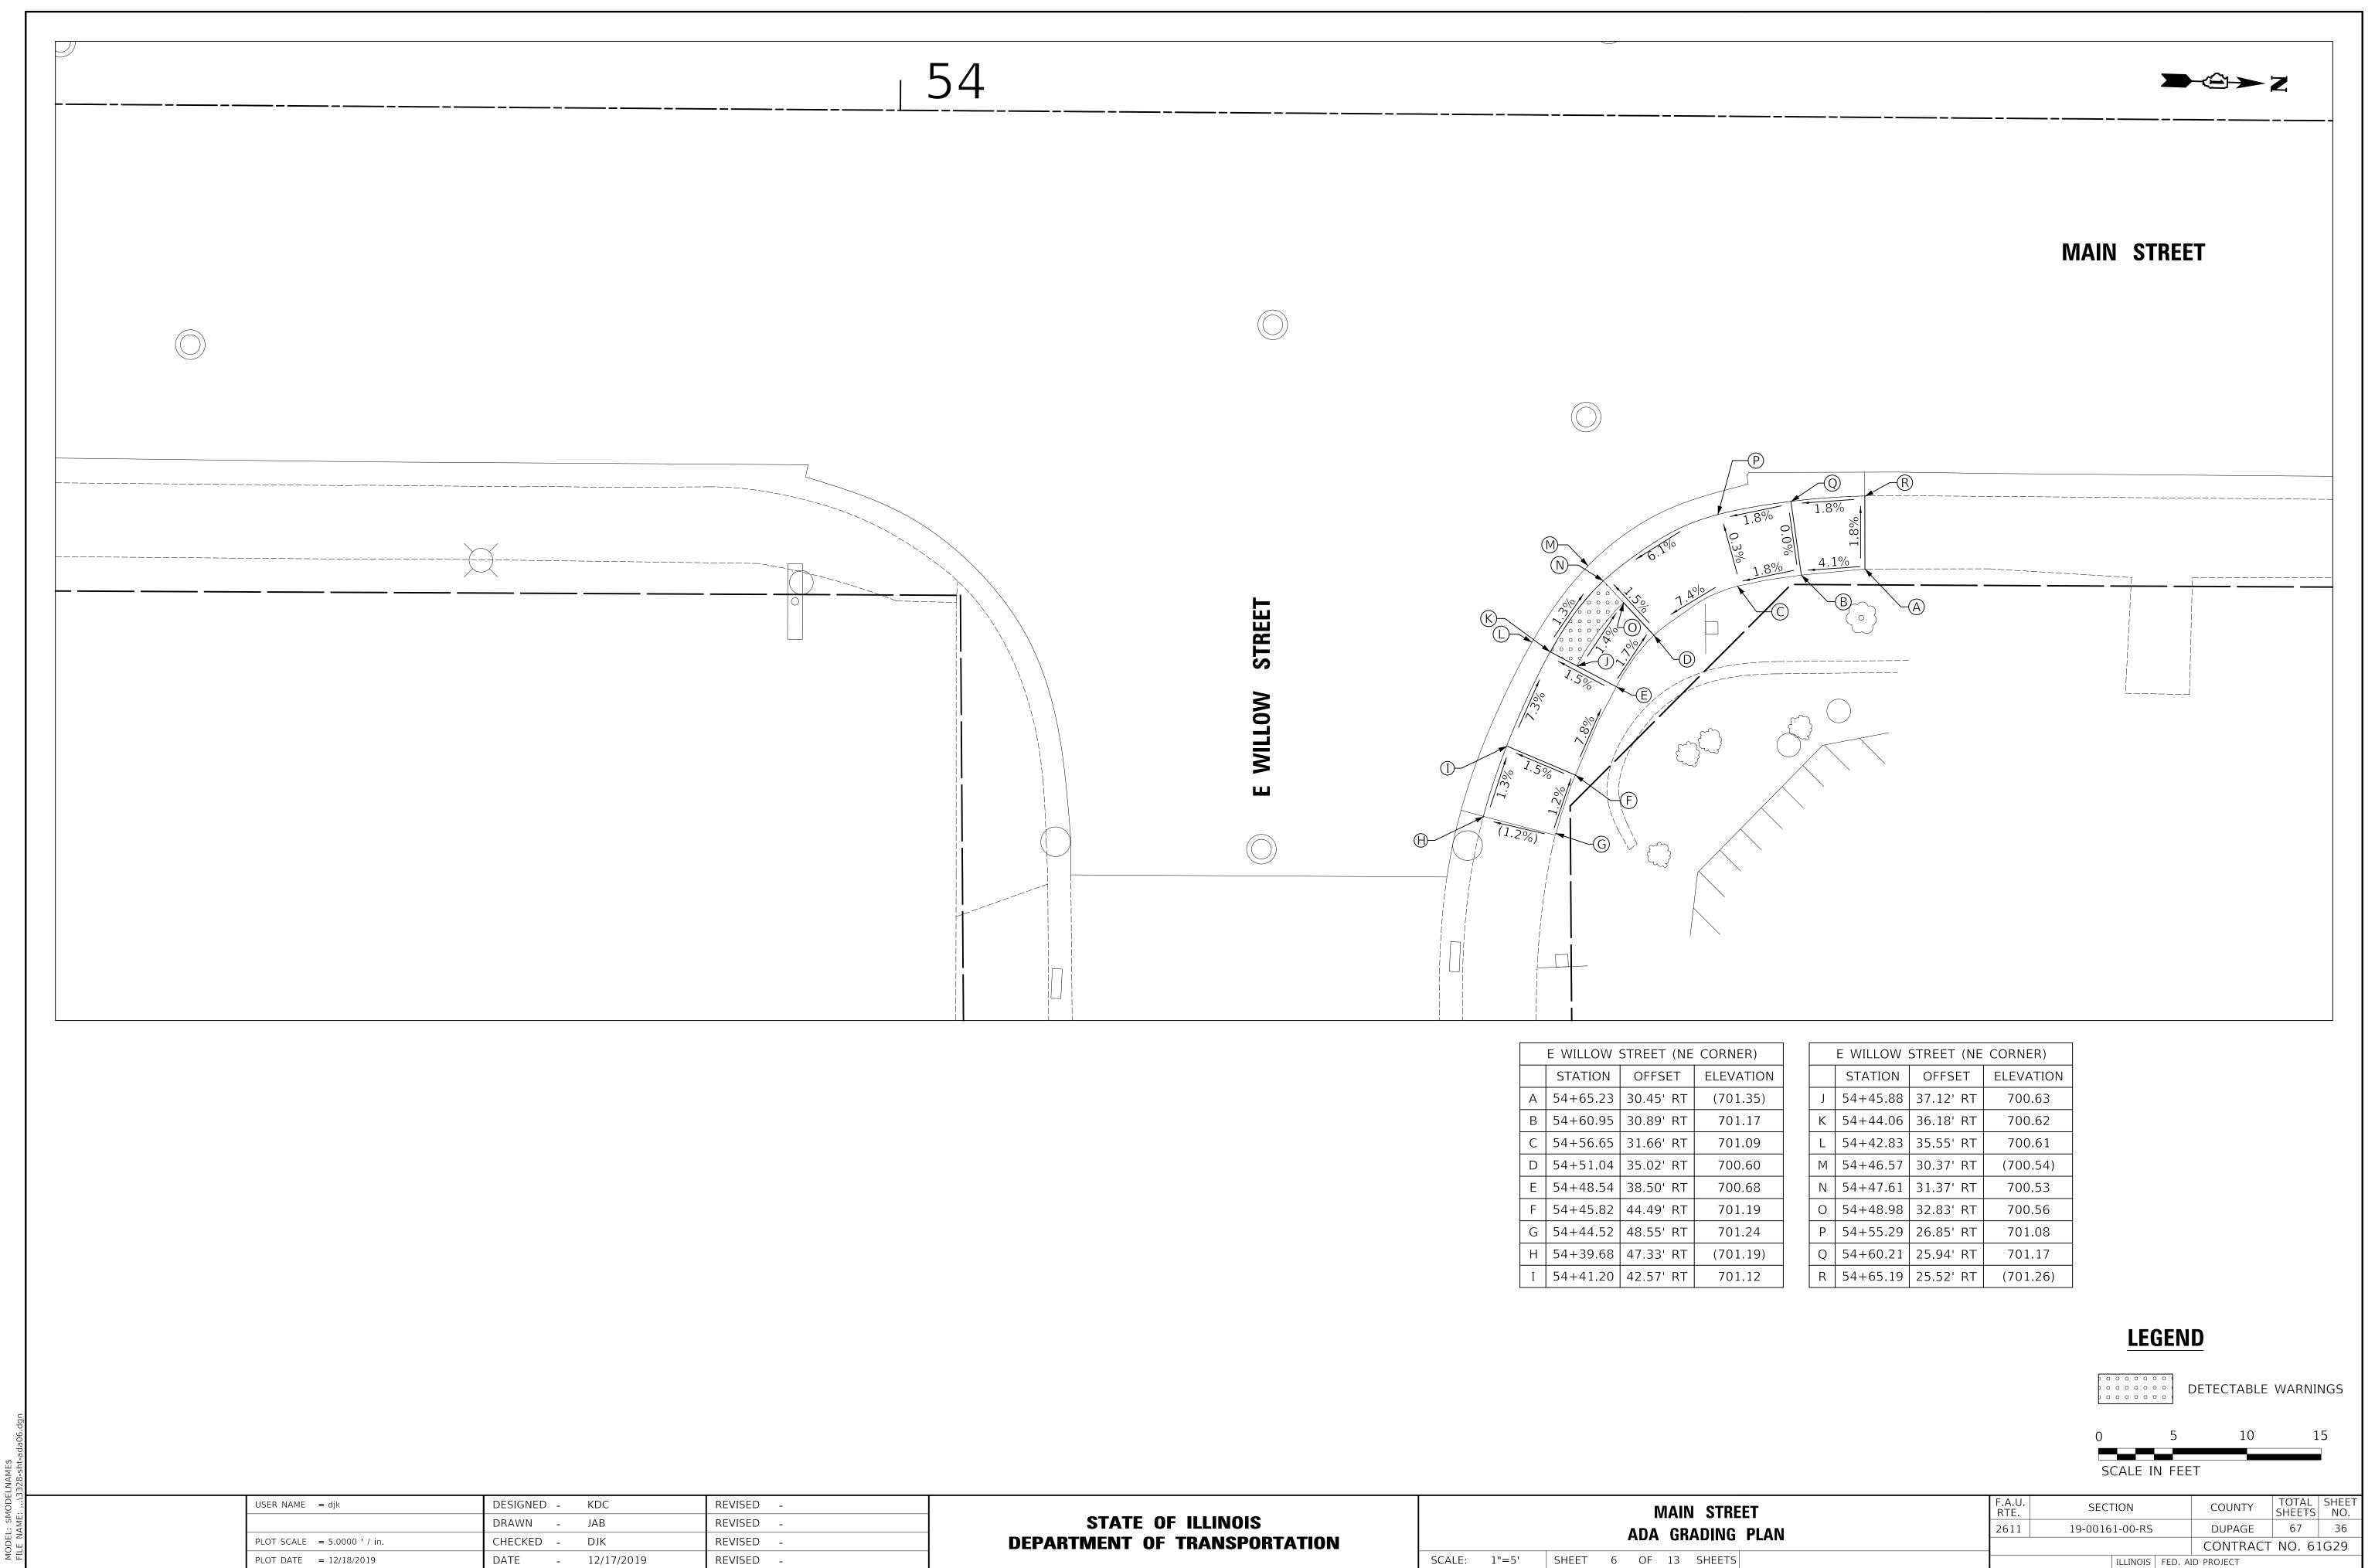

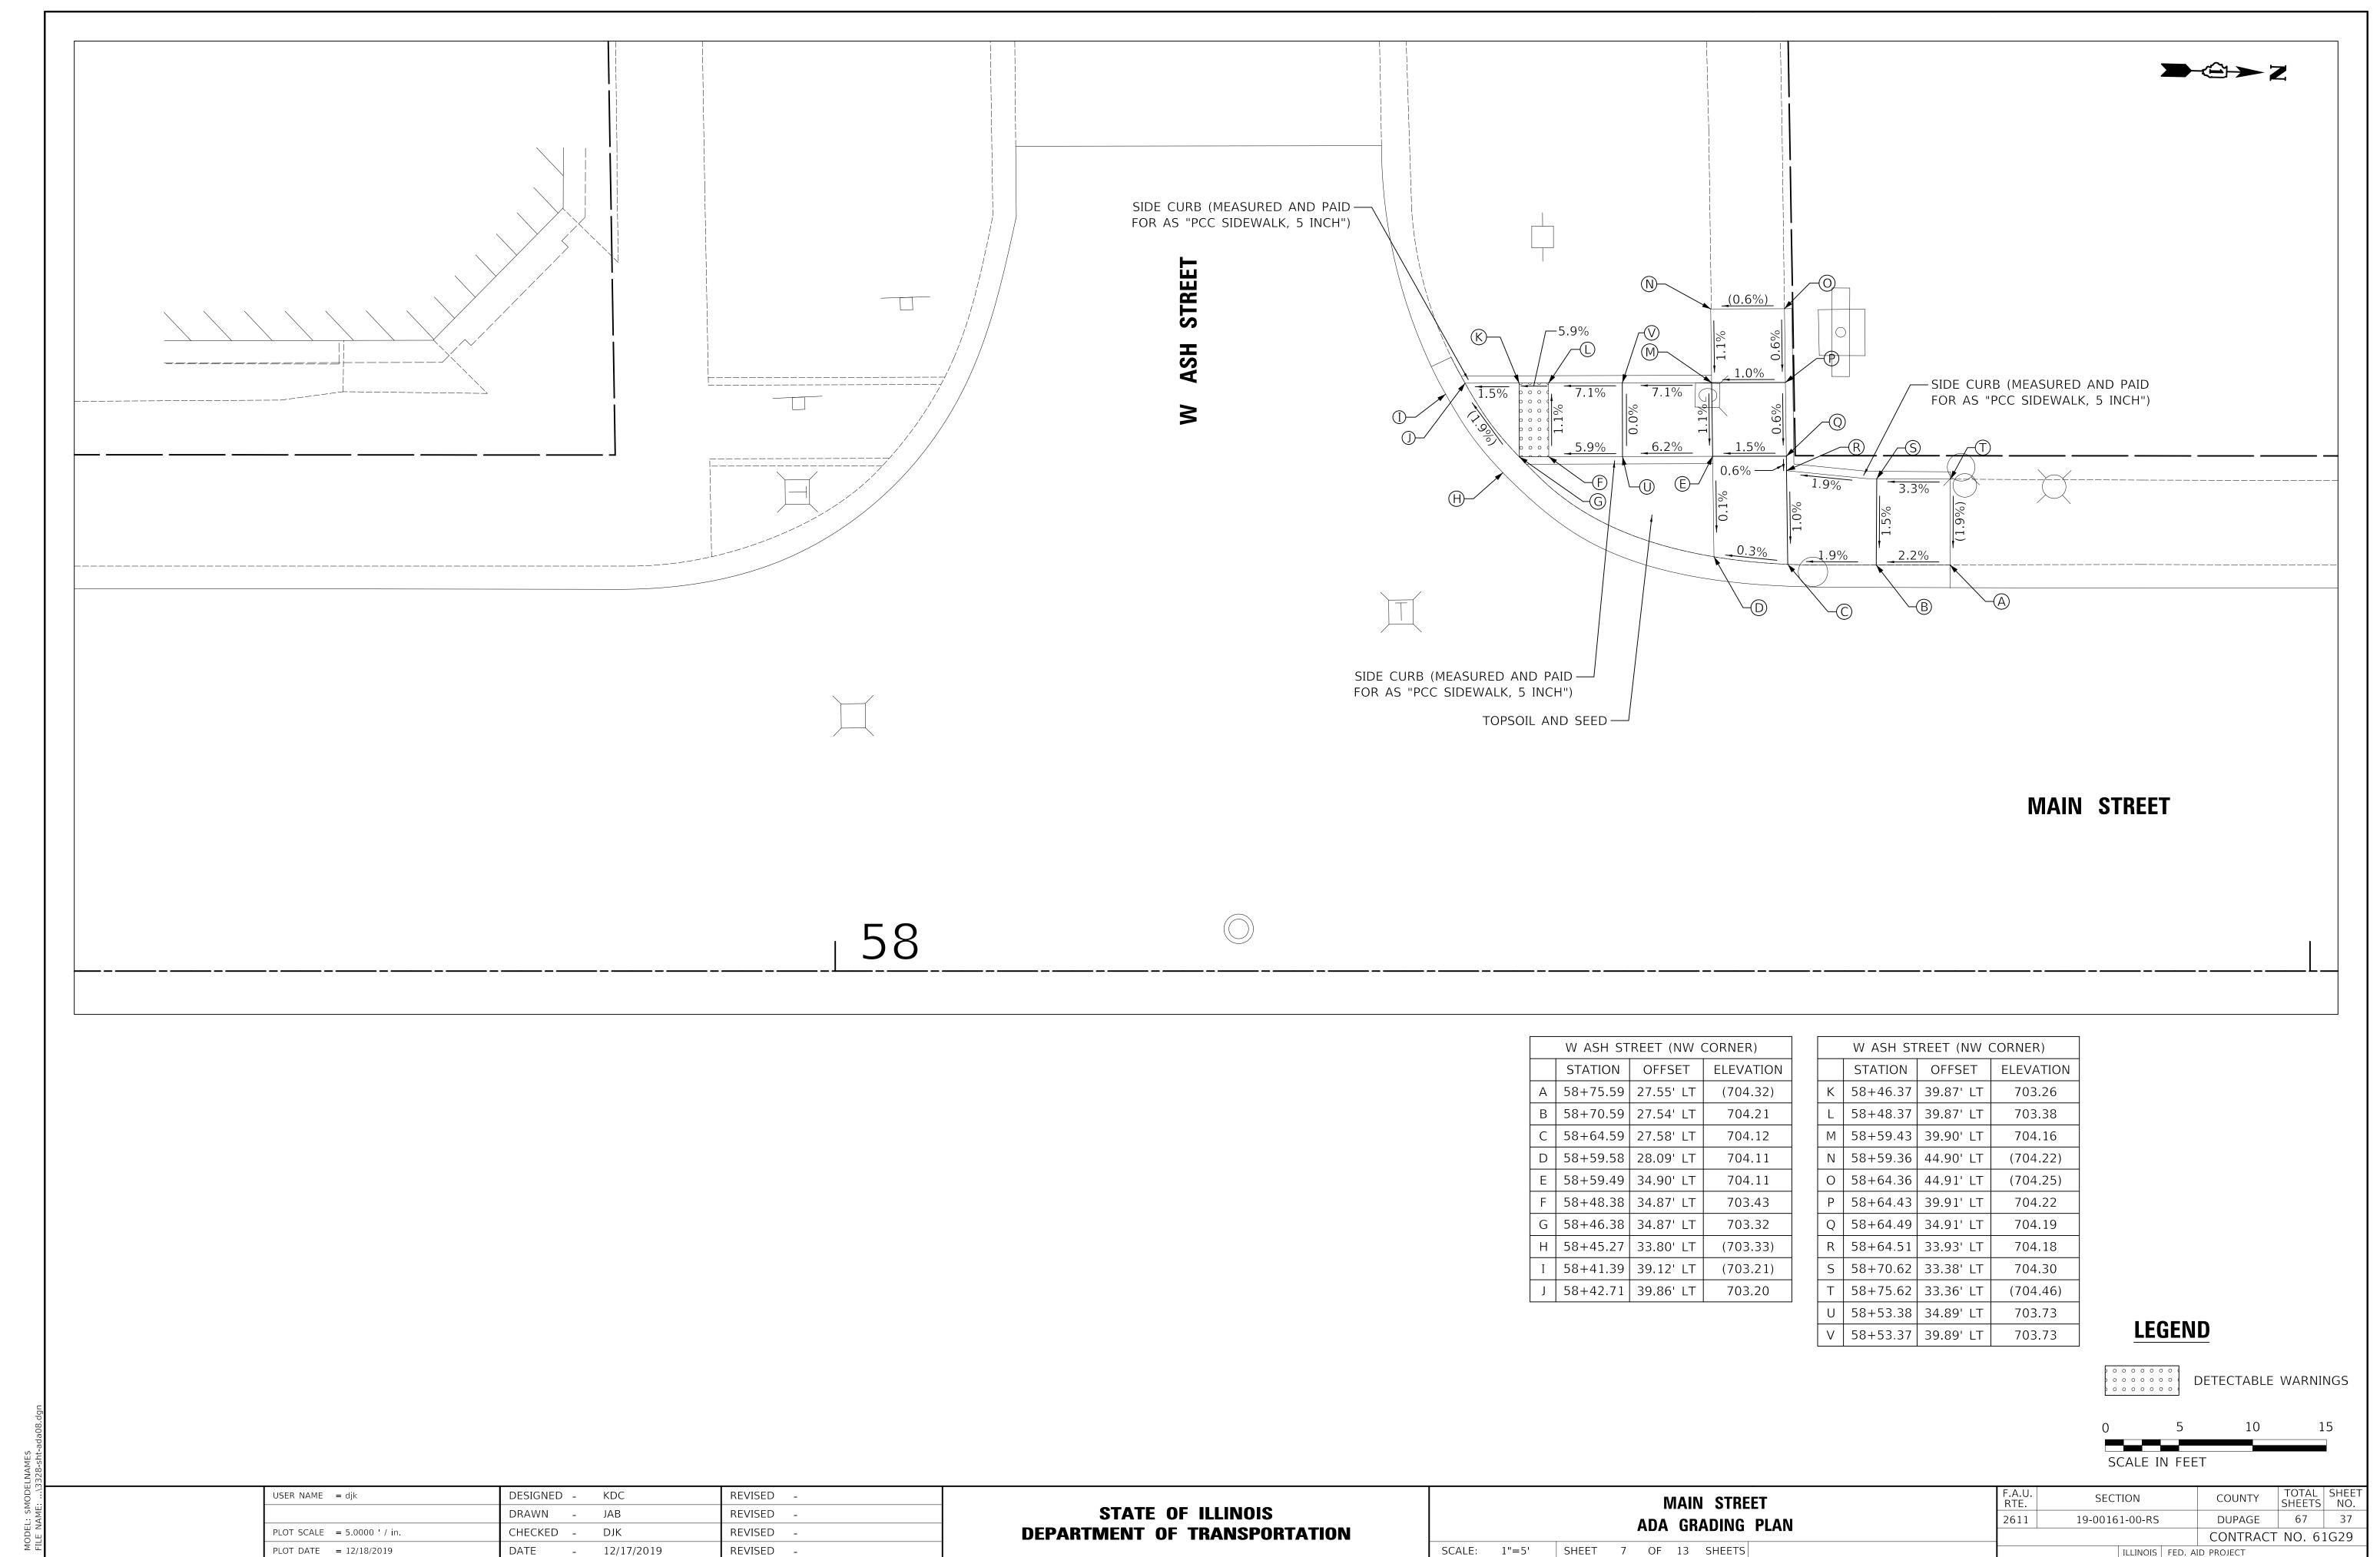


ILLINOIS FED. AID PROJECT

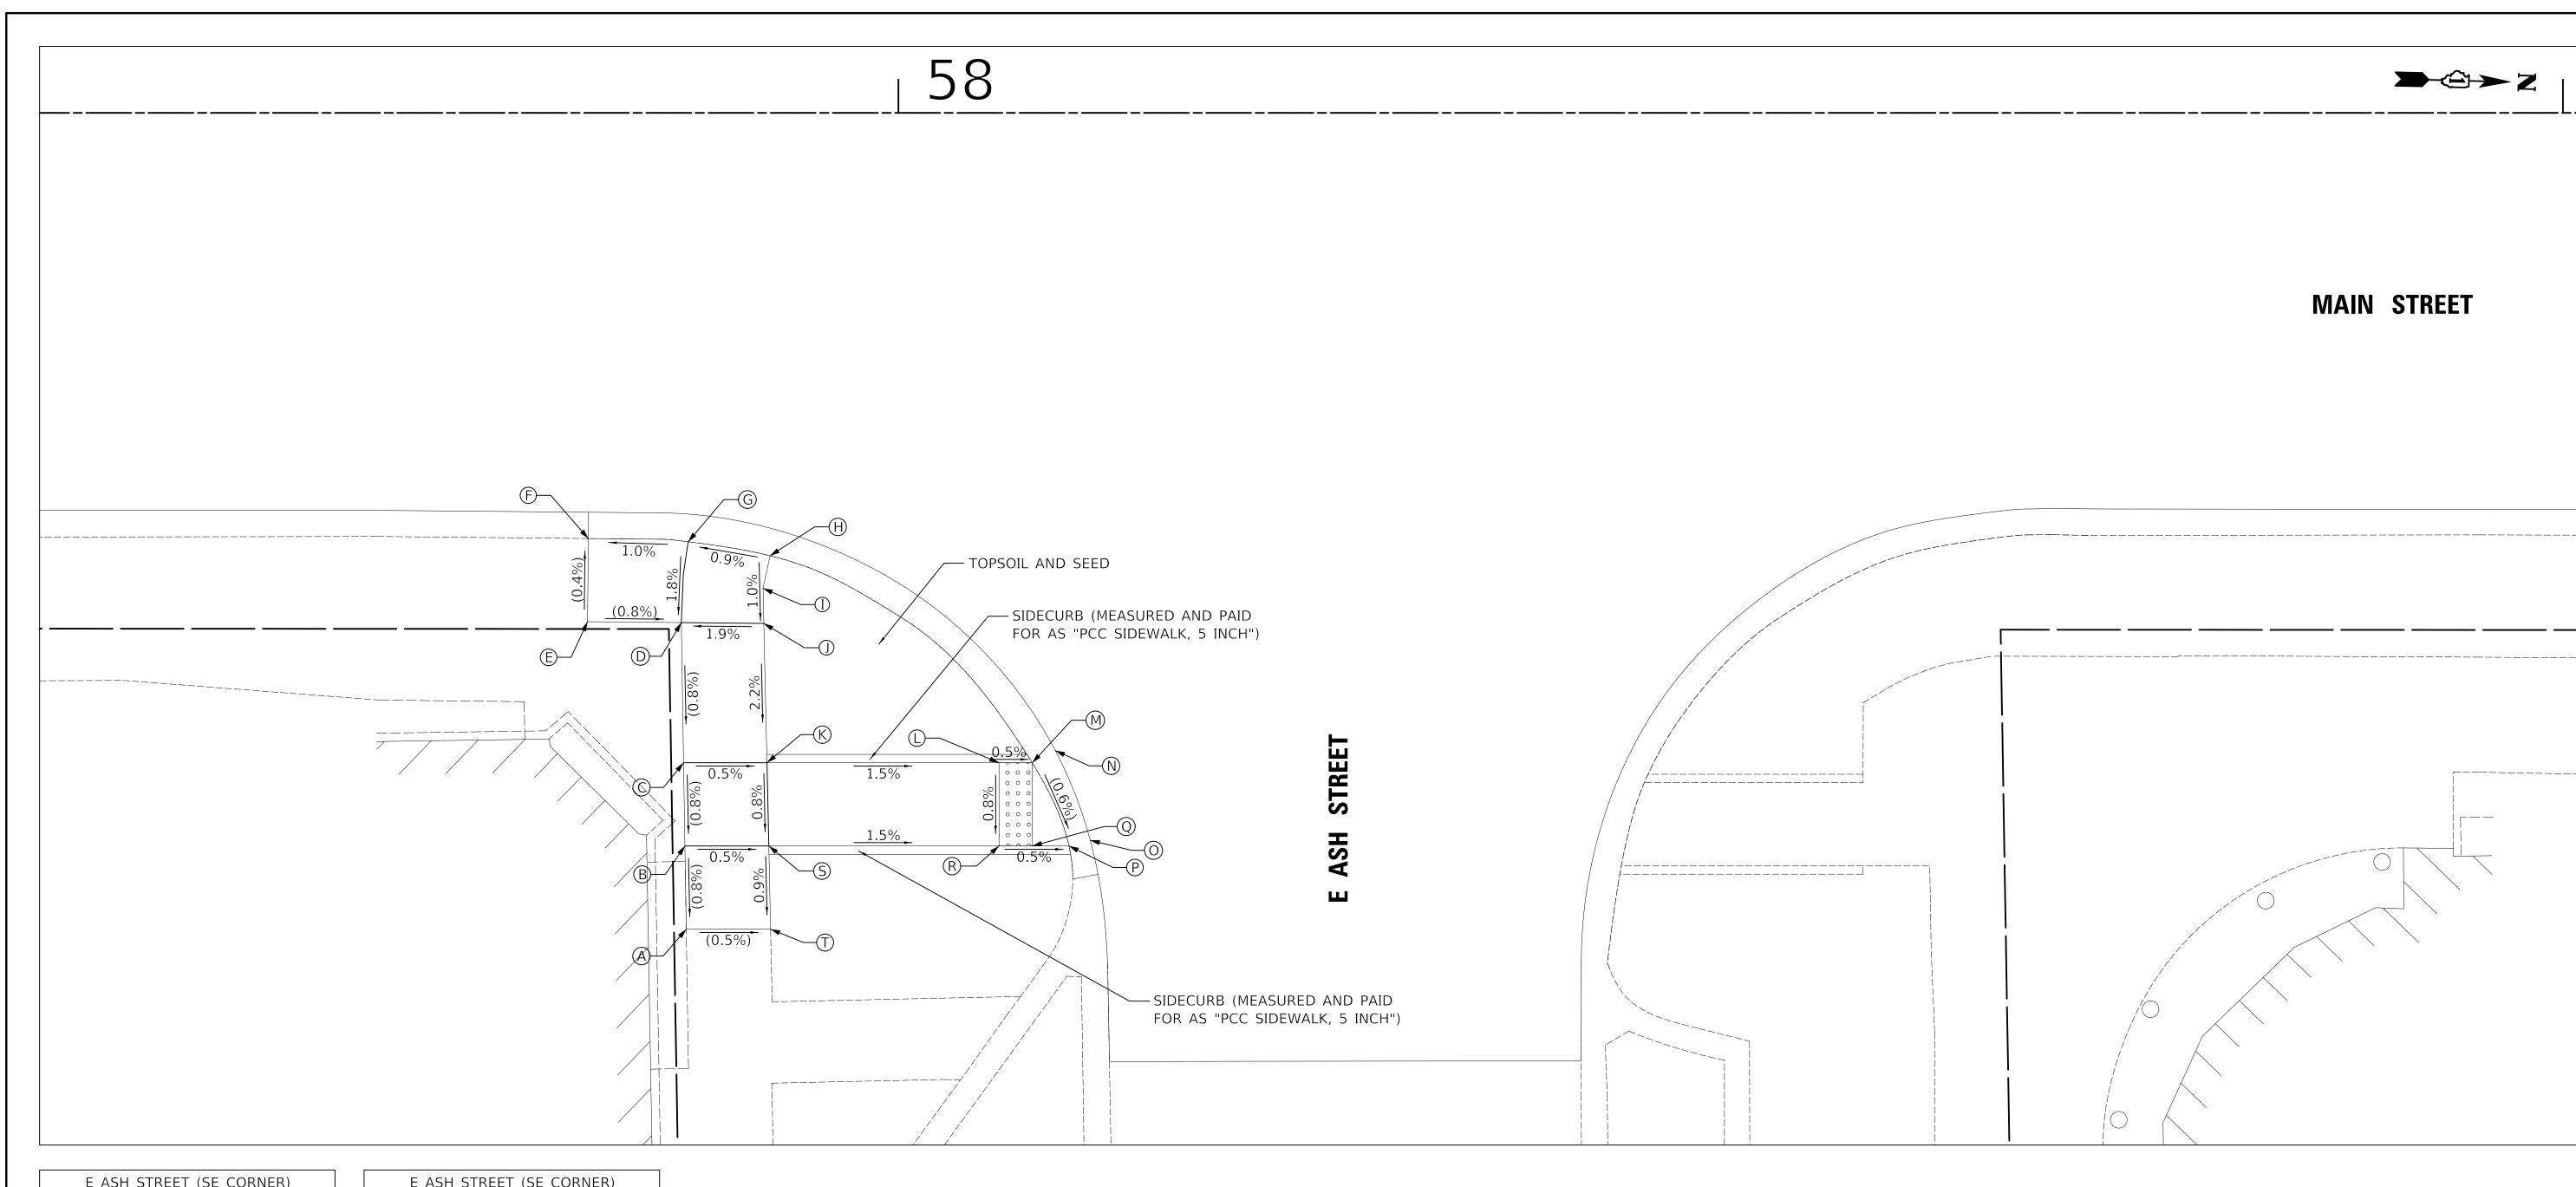


E ASH STREET (SE CORNER)						
	STATION OFFSET		ELEVATION			
А	57+87.25	49.04' RT	(703.24)			
В	57+87.17	44.04' RT	(703.28)			
С	57+87.09	39.04' RT	(703.32)			
D	57+86.96	30.62' RT	(703.38)			
Е	57+81.32	30.57' RT	(703.43)			
F	57+81.37	25.57' RT	(703.41)			
G	57+87.36	25.76' RT	703.47			
Н	57+92.29	26.61' RT	703.51			
I	57+91.87	28.56' RT	703.49			
J	57+91.91	30.67' RT	703.47			

	E ASH STREET (SE CORNER)							
	STATION OFFSET		ELEVATION					
K	57+92.10	39.04' RT	703.29					
L	58+06.04	39.04' RT	703.08					
M	58+08.04	39.04' RT	703.05					
N	58+09.43	38.31' RT	(703.06)					
0	58+11.52	43.70' RT	(703.03)					
Р	58+10.25	44.04' RT	703.02					
Q	58+08.04	44.04' RT	703.03					
R	58+06.04	44.04' RT	703.04					
S	57+92.21	44.04' RT	703.25					
Т	57+92.32	49.04' RT	(703.21)					

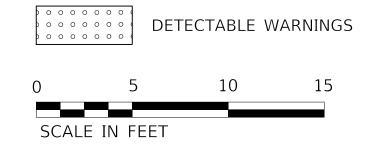

USER NAME = djk	DESIGNED - KDC	REVISED -		MAIN STREET	F.A.U.	SECTION	COUNTY TOTAL SHEET
	DRAWN - JAB	REVISED -	STATE OF ILLINOIS	ADA GRADING PLAN	2611	19-00161-00-RS	DUPAGE 67 38
PLOT SCALE = 5.0000 ' / in.	CHECKED - DJK	REVISED -	DEPARTMENT OF TRANSPORTATION	ADA GRADING PLAN			CONTRACT NO. 61G29
PLOT DATE = 12/18/2019	DATE - 12/17/2019	REVISED -		SCALE: 1"=5' SHEET 8 OF 13 SHEETS	<u> </u>	ILLINOIS FED.	AID PROJECT

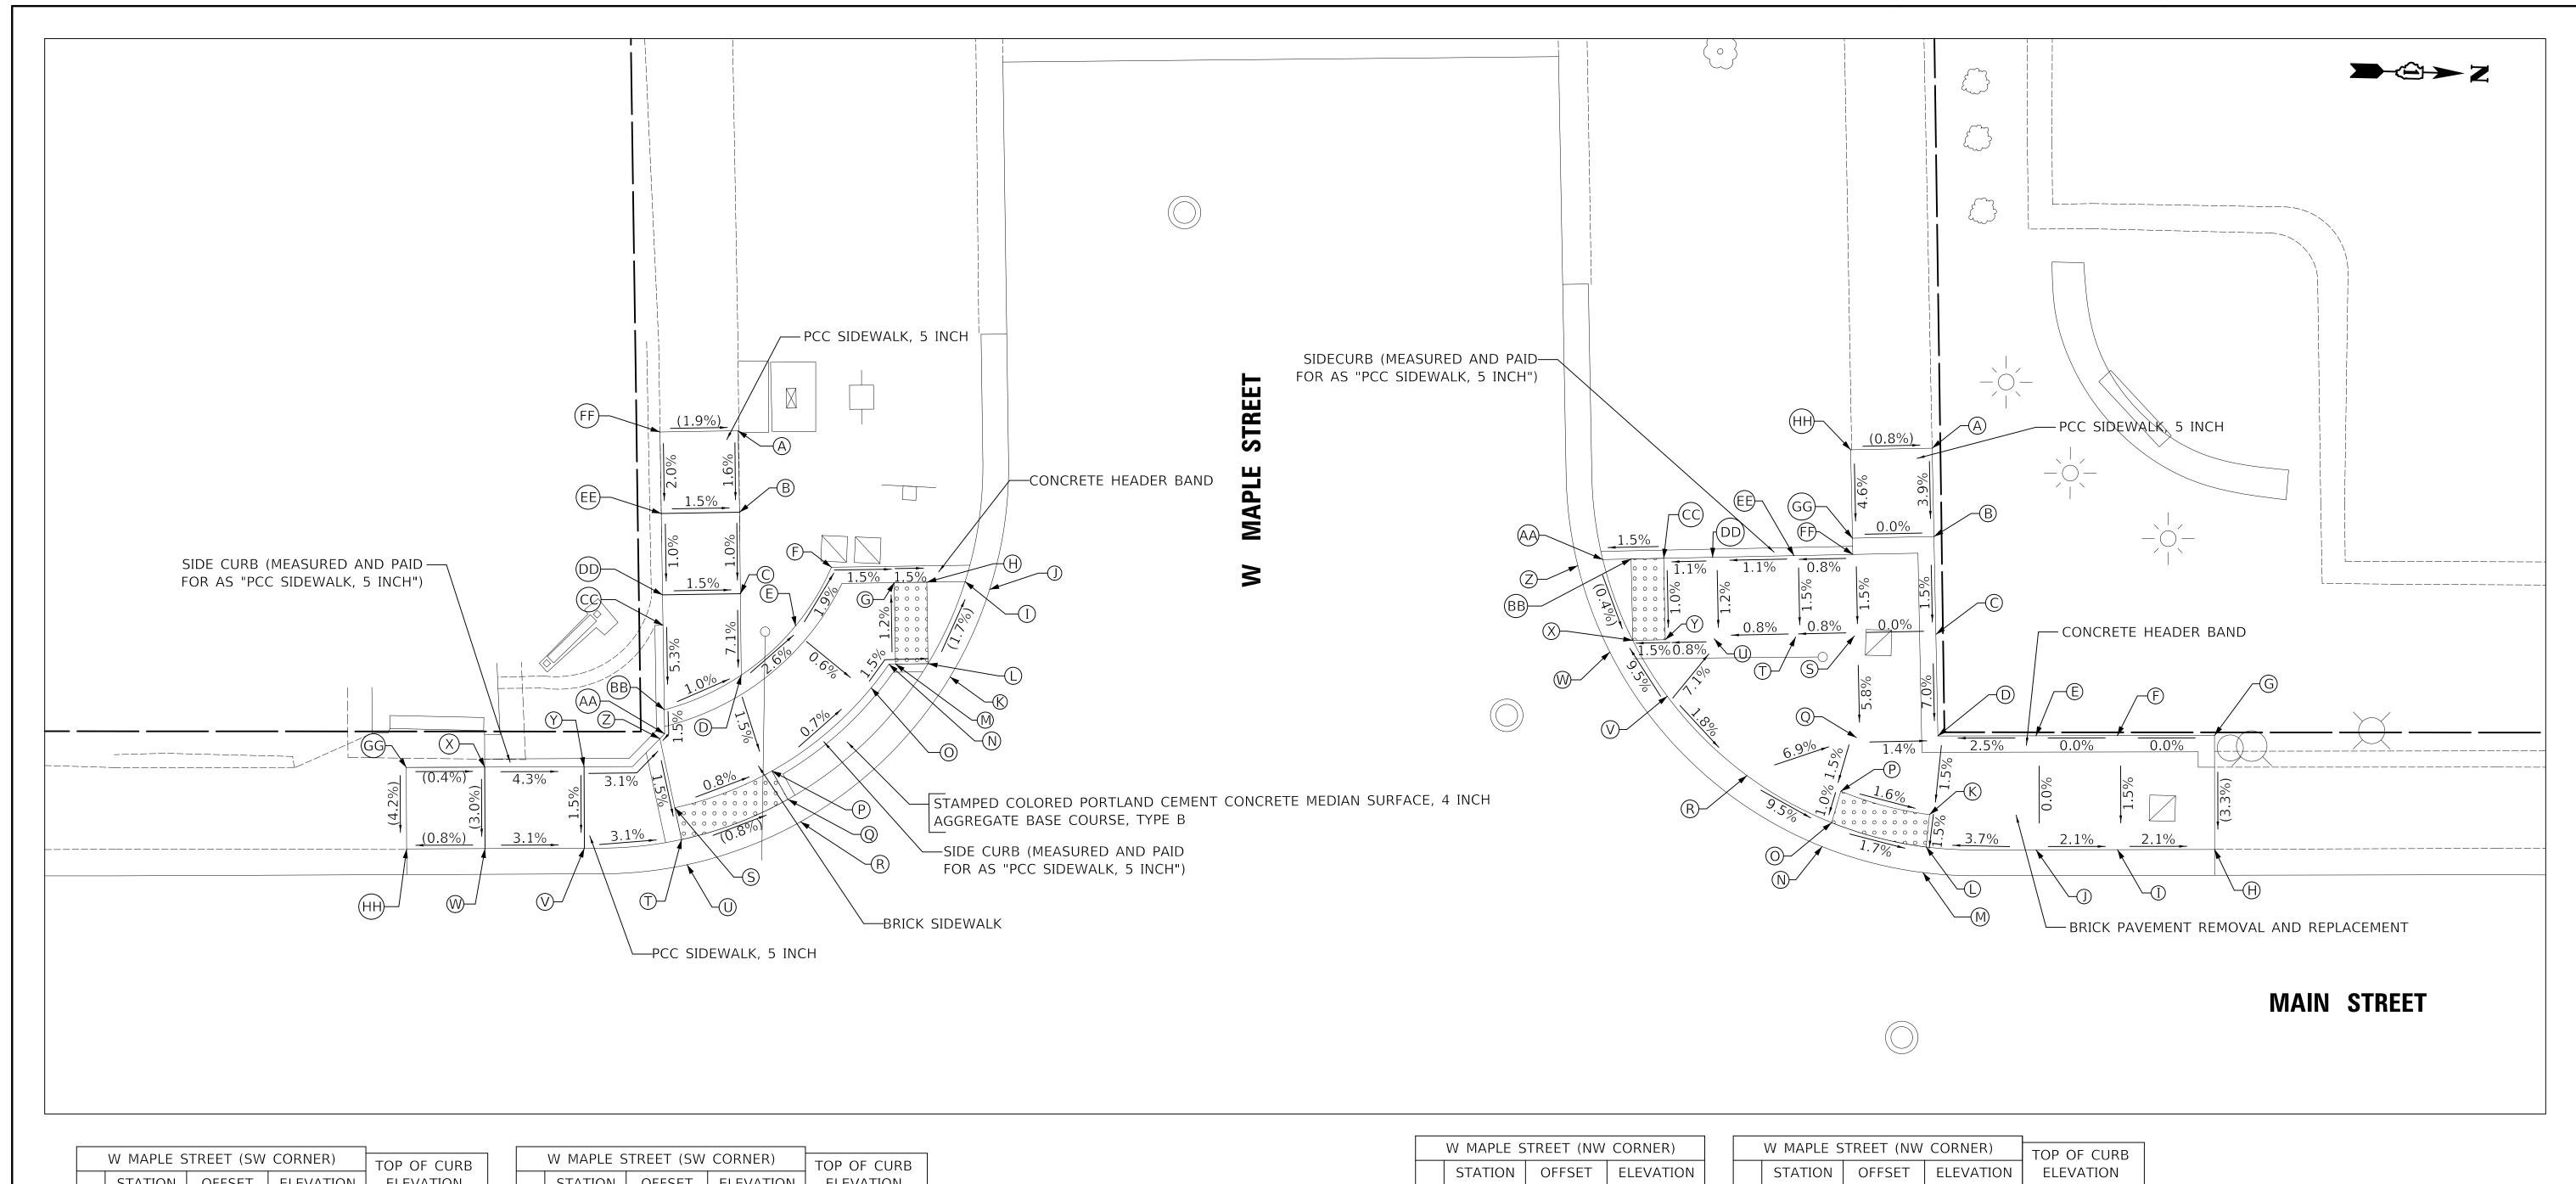


	W MAPLE S	TOP OF CURB		
	STATION	OFFSET	ELEVATION	ELEVATION
Α	62+82.56	53.19' LT	(708.40)	
В	62+82.67	48.19' LT	708.32	
С	62+82.72	43.19' LT	708.27	
D	62+82.77	38.19' LT	707.91	
Е	62+86.10	41.22' LT	707.79	
F	62+88.30	44.81' LT	707.71	
G	62+92.16	43.87' LT	707.67	
Н	62+94.16	43.90' LT	707.64	
I	62+96.51	43.93' LT	707.60	
J	62+98.01	43.46' LT	(707.71)	
K	62+95.58	38.08' LT	(707.71)	
L	62+94.23	38.90' LT	707.70	708.20
М	62+92.23	38.87' LT	707.73	708.23
N	62+91.83	38.86' LT	707.73	708.23
0	62+90.74	37.41' LT	707.76	708.26
Р	62+84.65	32.31' LT	707.82	708.32
Q	62+85.63	30.57' LT	707.79	708.23

	W MAPLE S	STREET (SW	CORNER)	TOP OF CURB		
	STATION	OFFSET	ELEVATION	ELEVATION		
R	62+86.40	29.19' LT	(707.80)			
S	62+78.69	30.06' LT	707.87			
Т	62+79.11	28.10' LT	707.84			
U	62+79.44	26.56' LT	(707.85)			
V	62+73.14	27.57' LT	708.02			
W	62+67.05	27.55' LT	708.21			
X	62+67.03	32.55' LT	708.36	(708.38)		
Υ	62+73.12	32.57' LT	708.10	(708.14)		
Z	62+77.77	34.29' LT	707.94	(708.09)		
АА	62+78.07	34.59' LT	707.94	(708.10)		
ВВ	62+78.04	36.07' LT	707.96	(708.18)		
СС	62+77.97	41.25' LT	708.24	(708.39)		
DD	62+77.94	43.12' LT	708.34			
EE	62+77.86	48.12' LT	708.39			
FF	62+77.78	53.12' LT	(708.49)			
GG	62+62.21	32.53' LT	(708.38)			
НН	62+62.23	27.53' LT	(708.17)			

W MAPLE STREET (NW CORNER)					
	STATION	OFFSET	ELEVATION		
А	63+55.86	52.12' LT	(707.13)		
В	63+55.97	46.70' LT	706.92		
С	63+56.09	40.70' LT	706.83		
D	63+56.21	34.46' LT	706.40		
Е	63+62.22	34.47' LT	706.55		
F	63+67.22	34.48' LT	706.55		
G	63+73.18	34.49' LT	(706.55)		
Н	63+73.19	27.49' LT	(706.31)		
I	63+67.23	27.48' LT	706.44		
J	63+62.23	27.47' LT	706.55		
K	63+55.70	29.63' LT	706.32		
L	63+55.49	27.64' LT	706.29		
M	63+55.29	26.08' LT	706.30		
N	63+49.10	27.67' LT	(706.40)		
Ο	63+49.69	29.14' LT	706.39		
Р	63+50.25	31.07' LT	706.41		
Q	63+51.21	34.36' LT	706.41		


	W MAPLE S	TOP OF CURB		
	STATION	OFFSET	ELEVATION	ELEVATION
R	63+44.49	32.03' LT	706.96	
S	63+51.09	40.60' LT	706.83	
Т	63+47.48	40.53' LT	706.80	
U	63+42.48	40.43' LT	706.76	
<	63+39.60	36.90' LT	707.08	
W	63+36.07	39.61' LT	(706.72)	
Χ	63+37.48	40.32' LT	706.71	
Υ	63+39.48	40.37' LT	706.74	
Ζ	63+34.11	44.91' LT	(706.74)	
АА	63+35.64	45.29' LT	706.73	707.18
ВВ	63+37.38	45.32' LT	706.76	707.26
CC	63+39.38	45.36' LT	706.79	707.29
DD	63+42.38	45.42' LT	706.82	707.32
EE	63+47.38	45.52' LT	706.88	707.78
FF	63+50.99	45.60' LT	706.92	707.18
GG	63+50.97	46.60' LT	706.92	706.93
НН	63+50.86	52.02' LT	(707.17)	

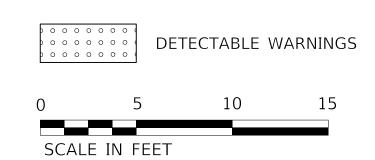


USER NAME = djk	DESIGNED -	KDC	REVISED -
	DRAWN -	JAB	REVISED -
PLOT SCALE = 5.0000 ' / in.	CHECKED -	DJK	REVISED -
PLOT DATE = 12/18/2019	DATE -	12/17/2019	REVISED -

STATE OF ILLINOIS
DEPARTMENT OF TRANSPORTATION

MAIN STREET	F.A.U. RTE.	J. SECTION COUNTY		COUNTY	TOTAL SHEETS	SHEET NO.
ADA GRADING PLAN	2611	19-0016	1-00-RS	DUPAGE	67	39
ADA GIIADING I LAN				CONTRACT	NO. 61	.G29
SCALE: 1"=5' SHEET 9 OF 13 SHEETS			ILLINOIS FED.	AID PROJECT		

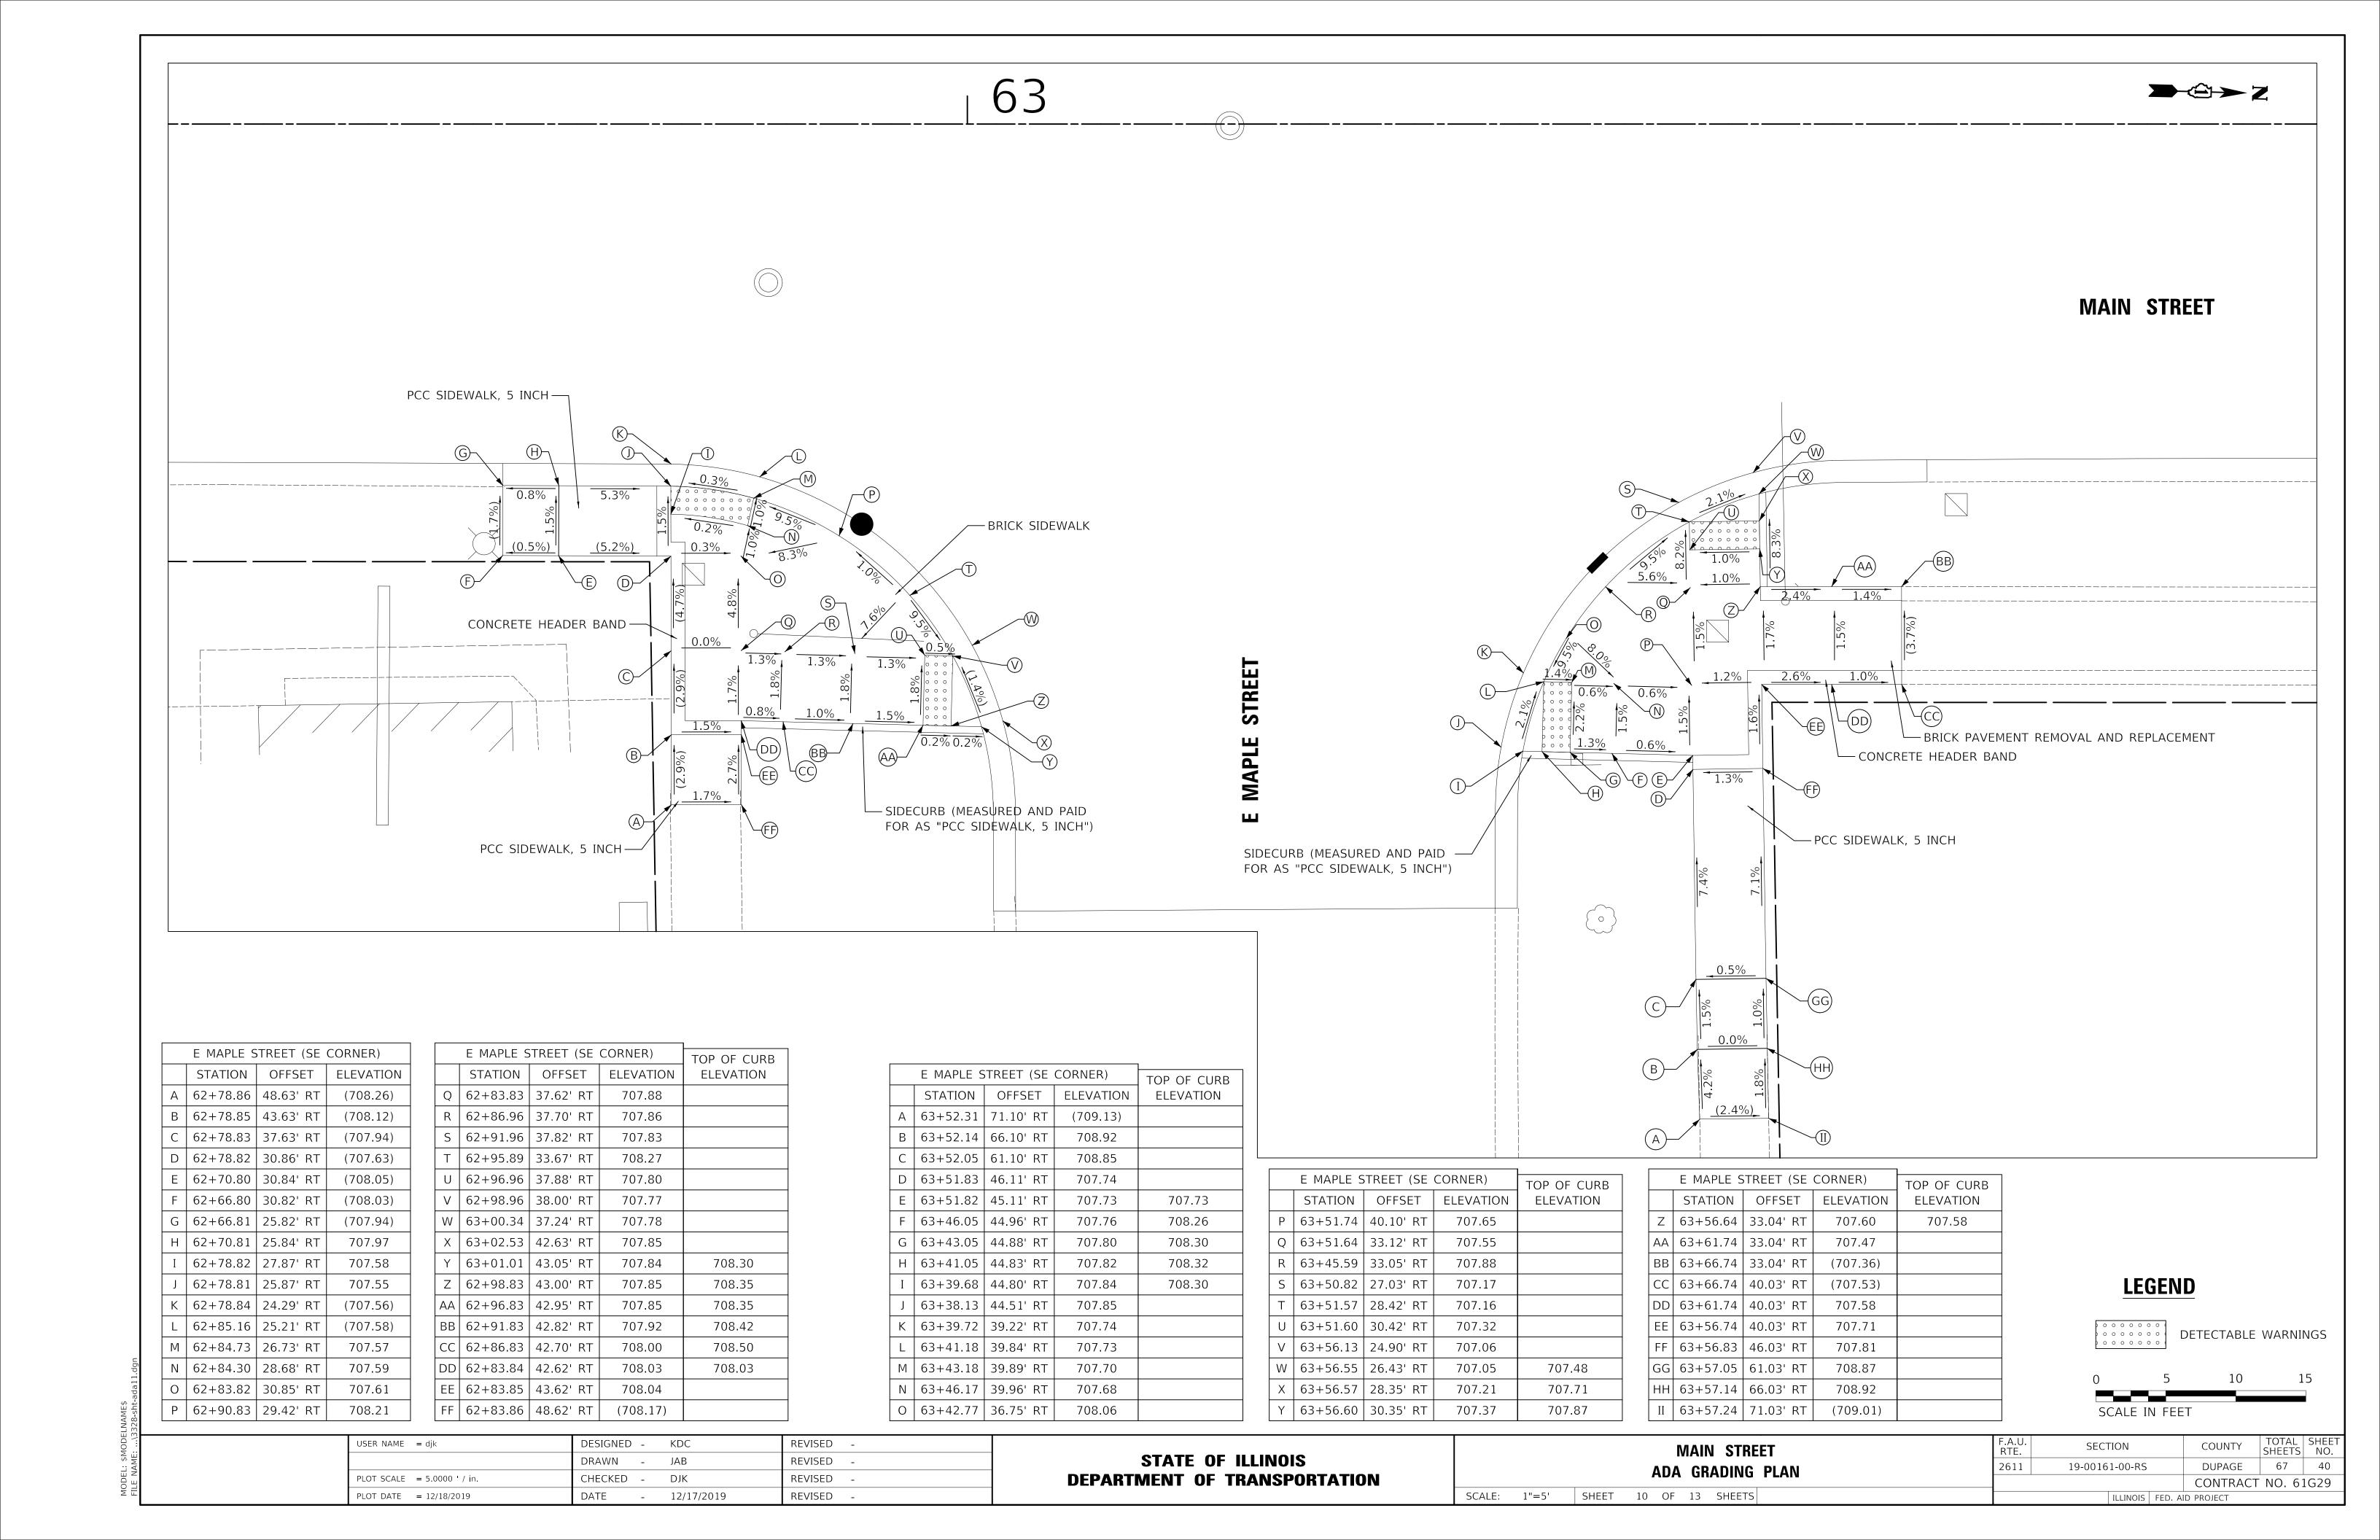

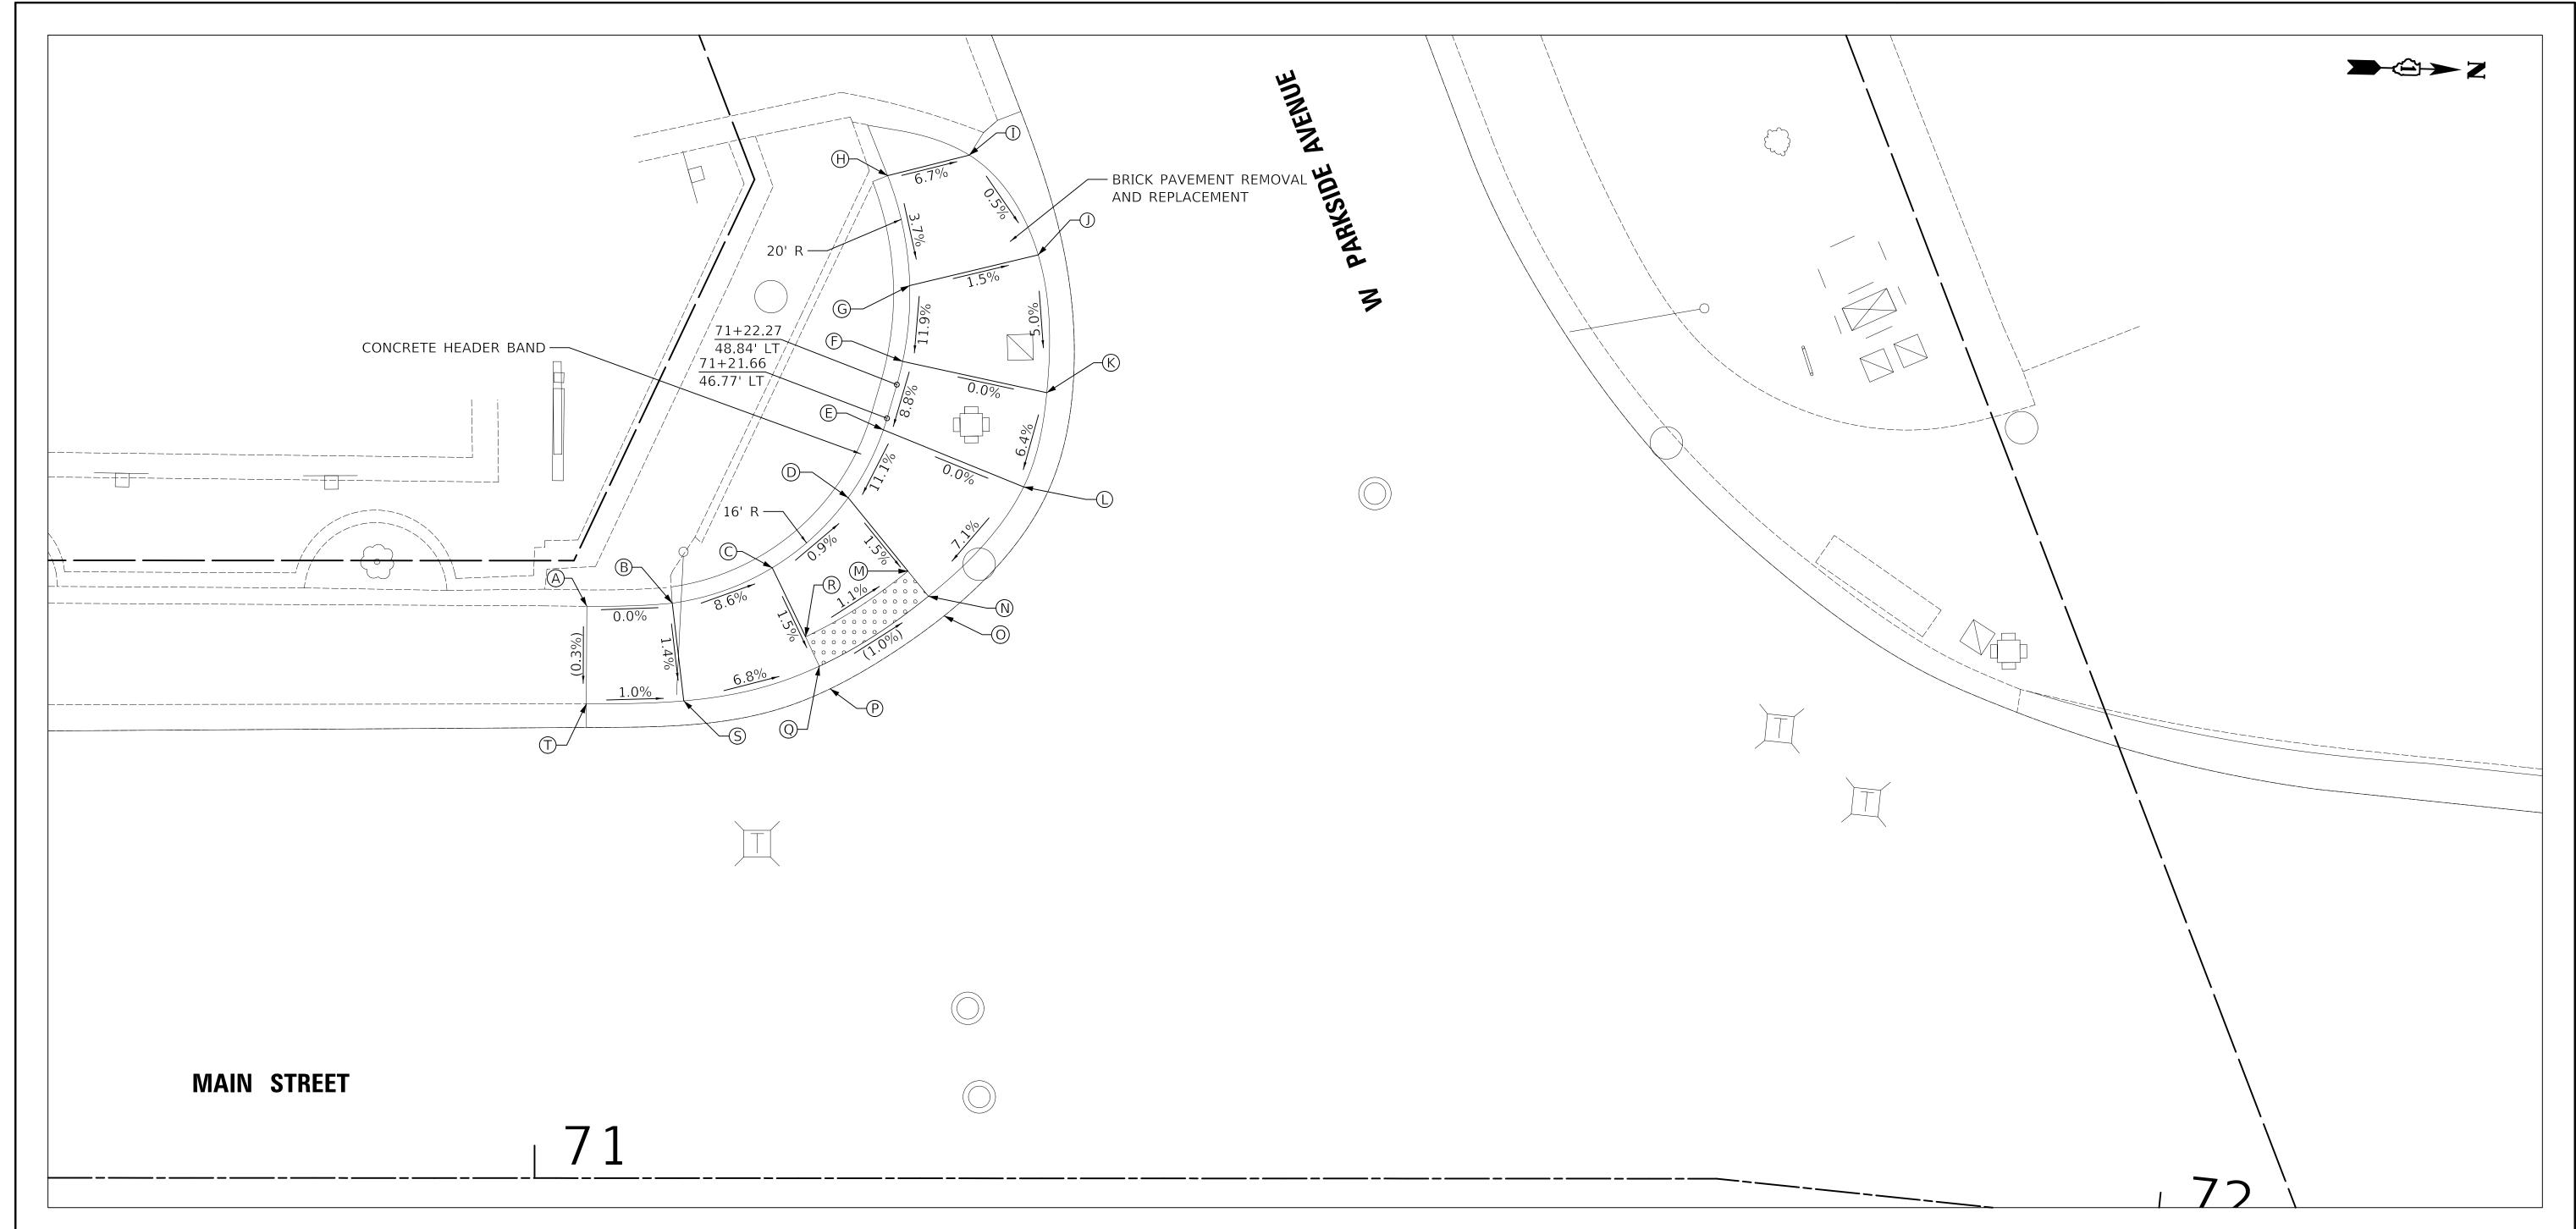

W	/ PARKSIDE	AVENUE (S'	W CORNER)	TOP OF
	STATION	OFFSET	ELEVATION	HEADER BAND
Α	71+03.20	35.19' LT	(698.16)	
В	71+08.46	35.39' LT	698.16	(698.17)
С	71+14.61	37.57' LT	697.60	(698.28)
О	71+19.27	41.88' LT	697.54	(698.46)
Е	71+21.44	46.06' LT	698.06	(698.63)
F	71+22.63	50.27' LT	698.45	(698.81)
G	71+23.06	54.94' LT	699.00	(699.00)
Η	71+21.69	61.71' LT	(699.26)	(699.36)
I	71+26.72	62.97' LT	(698.92)	
J	71+30.96	56.83' LT	698.88	


W	/ PARKSIDE	AVENUE (S'	W CORNER)
	STATION	OFFSET	ELEVATION
Κ	71+31.54	48.90' LT	698.45
L	71+30.07	42.56' LT	698.06
М	71+22.95	37.37' LT	697.45
N	71+24.22	35.82' LT	697.42
0	71+25.19	34.61' LT	(697.43)
Р	71+18.18	30.12' LT	(697.51)
Q	71+17.50	31.51' LT	697.50
R	71+16.66	33.33' LT	697.53
S	71+09.16	29.38' LT	698.08
Т	71+03.17	29.18' LT	(698.14)

DETECTABLE WARNINGS

0 5 10 11

SCALE IN FEET

USER NAME = djk	DESIGNED - KDC	REVISED -		MAIN STREET	RTF	SECTION	COUNTY	SHEETS	SHEET
	DRAWN - JAB	REVISED -	STATE OF ILLINOIS		2611	19-00161-00-RS	DUPAGE	67	41
PLOT SCALE = 5.0000 ' / in.	CHECKED - DJK	REVISED -	DEPARTMENT OF TRANSPORTATION	ADA GRADING PLAN		13 00101 00 1.0	CONTRA	CT NO 61	IG29
PLOT DATE = 12/18/2019	DATE - 12/17/2019	REVISED -		SCALE: 1"=5' SHEET 11 OF 13 SHEETS		ILLINOIS	FED. AID PROJECT		

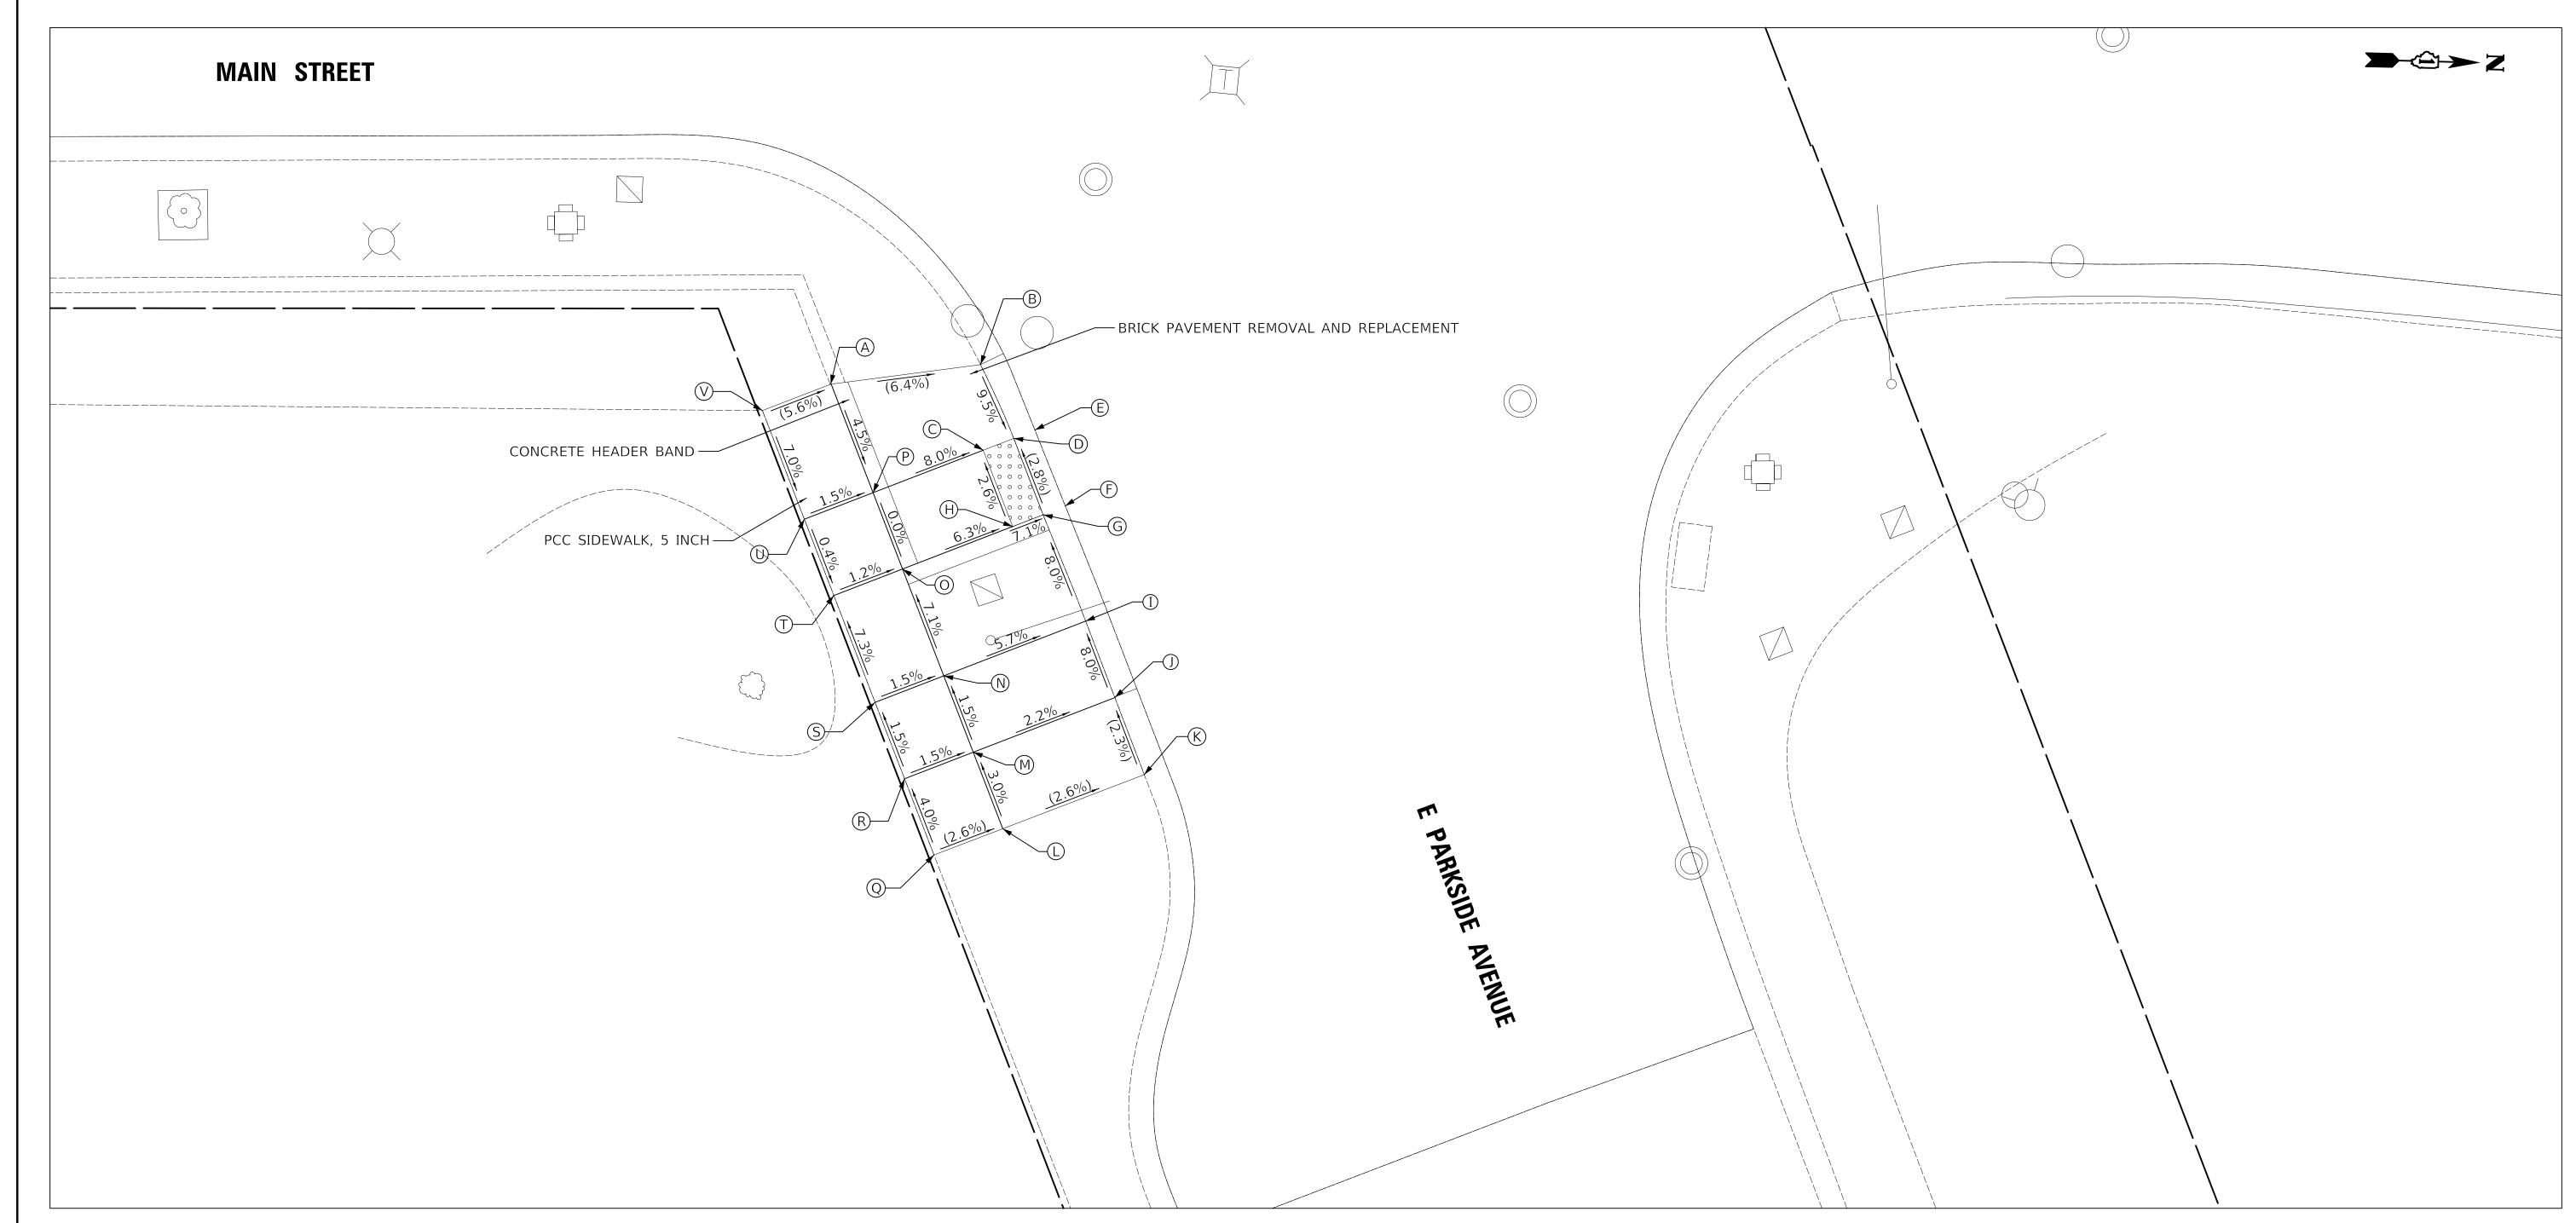


E	PARKSIDE	AVENUE (SI	E CORNER)
	STATION	OFFSET	ELEVATION
А	71+58.57	42.62' RT	(698.31)
В	71+67.73	41.42' RT	697.72
U	71+67.89	46.65' RT	697.41
D	71+69.76	45.93' RT	697.25
Е	71+75.77	45.34' RT	(697.26)
F	71+78.10	49.76' RT	(697.40)
G	71+76.81	50.44' RT	697.39
Η	71+69.69	51.31' RT	697.53
I	71+80.06	56.64' RT	697.95
J	71+82.33	61.10' RT	(698.35)
K	71+84.61	65.60' RT	(698.47)

E	PARKSIDE	AVENUE (S	E CORNER)
	STATION	OFFSET	ELEVATION
L	71+69.10	69.78' RT	(698.71)
М	71+67.29	65.11' RT	698.56
N	71+65.49	60.44' RT	698.48
О	71+62.97	53.91' RT	697.99
Р	71+61.16	49.25' RT	697.99
Q	71+64.90	71.39' RT	(698.82)
R	71+63.10	66.73' RT	698.63
S	71+61.29	62.06' RT	698.55
Т	71+58.77	55.54' RT	698.04
U	71+56.96	50.87' RT	698.06
V	71+54.40	44.23' RT	(698.56)



SCALE IN FEET

USER NAME = djk	DESIGNED - KDC REVISED -		MAIN STREET	F.A.U. SECTION COUNTY TOTAL SHEET NO.
	DRAWN - JAB REVISED -	STATE OF ILLINOIS	ADA GRADING PLAN	2611 19-00161-00-RS DUPAGE 67 42
PLOT SCALE = 5.0000 ' / in.	CHECKED - DJK REVISED -	DEPARTMENT OF TRANSPORTATION	ADA GRADING PLAN	CONTRACT NO. 61G29
PLOT DATE = 12/18/2019	DATE - 12/17/2019 REVISED -		SCALE: 1"=5' SHEET 12 OF 13 SHEETS	ILLINOIS FED. AID PROJECT

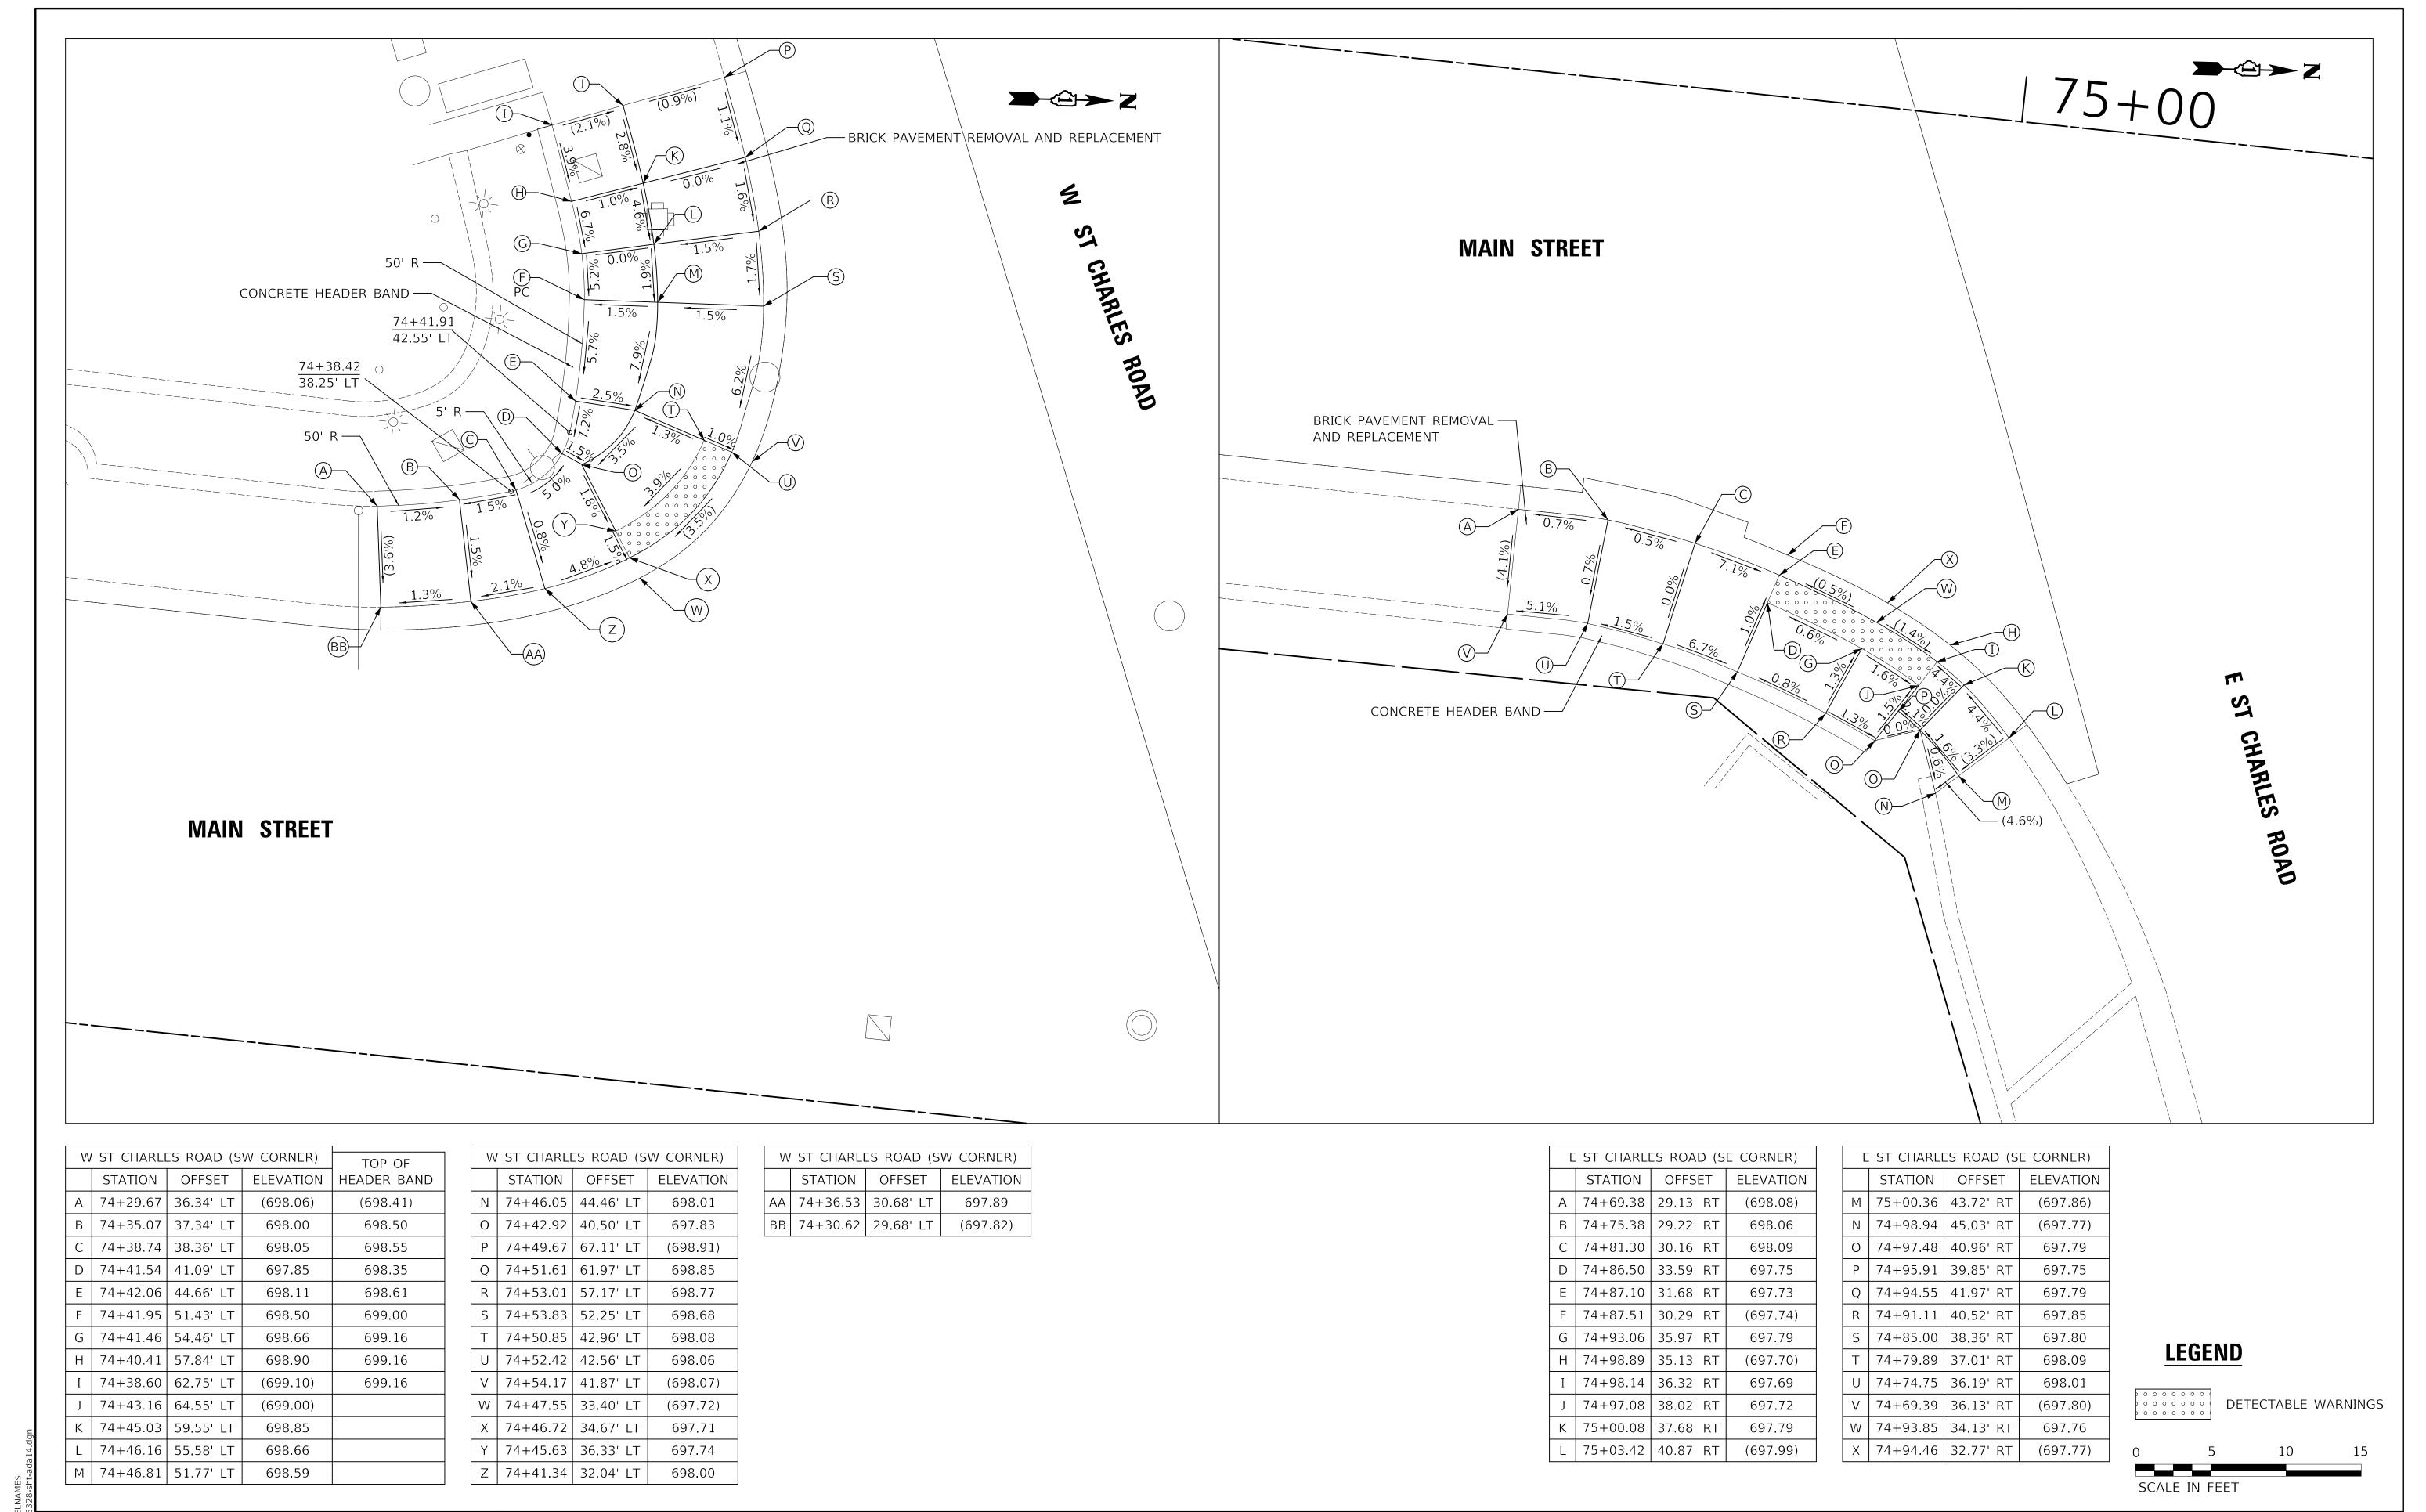

STATE OF ILLINOIS

DEPARTMENT OF TRANSPORTATION

DESIGNED -

CHECKED -

DRAWN

DATE

KDC

JAB

DJK

- 12/17/2019

USER NAME = djk

PLOT SCALE = 5.0000 ' / in.

PLOT DATE = 12/18/2019

REVISED

REVISED


REVISED

REVISED

MAIN STREET ADA GRADING PLAN SCALE: 1"=5' SHEET 13 OF 13 SHEETS

F.A.U. RTE. SECTION 19-00161-00-RS

COUNTY TOTAL SHEET NO. DUPAGE 67 43 CONTRACT NO. 61G29 ILLINOIS FED. AID PROJECT

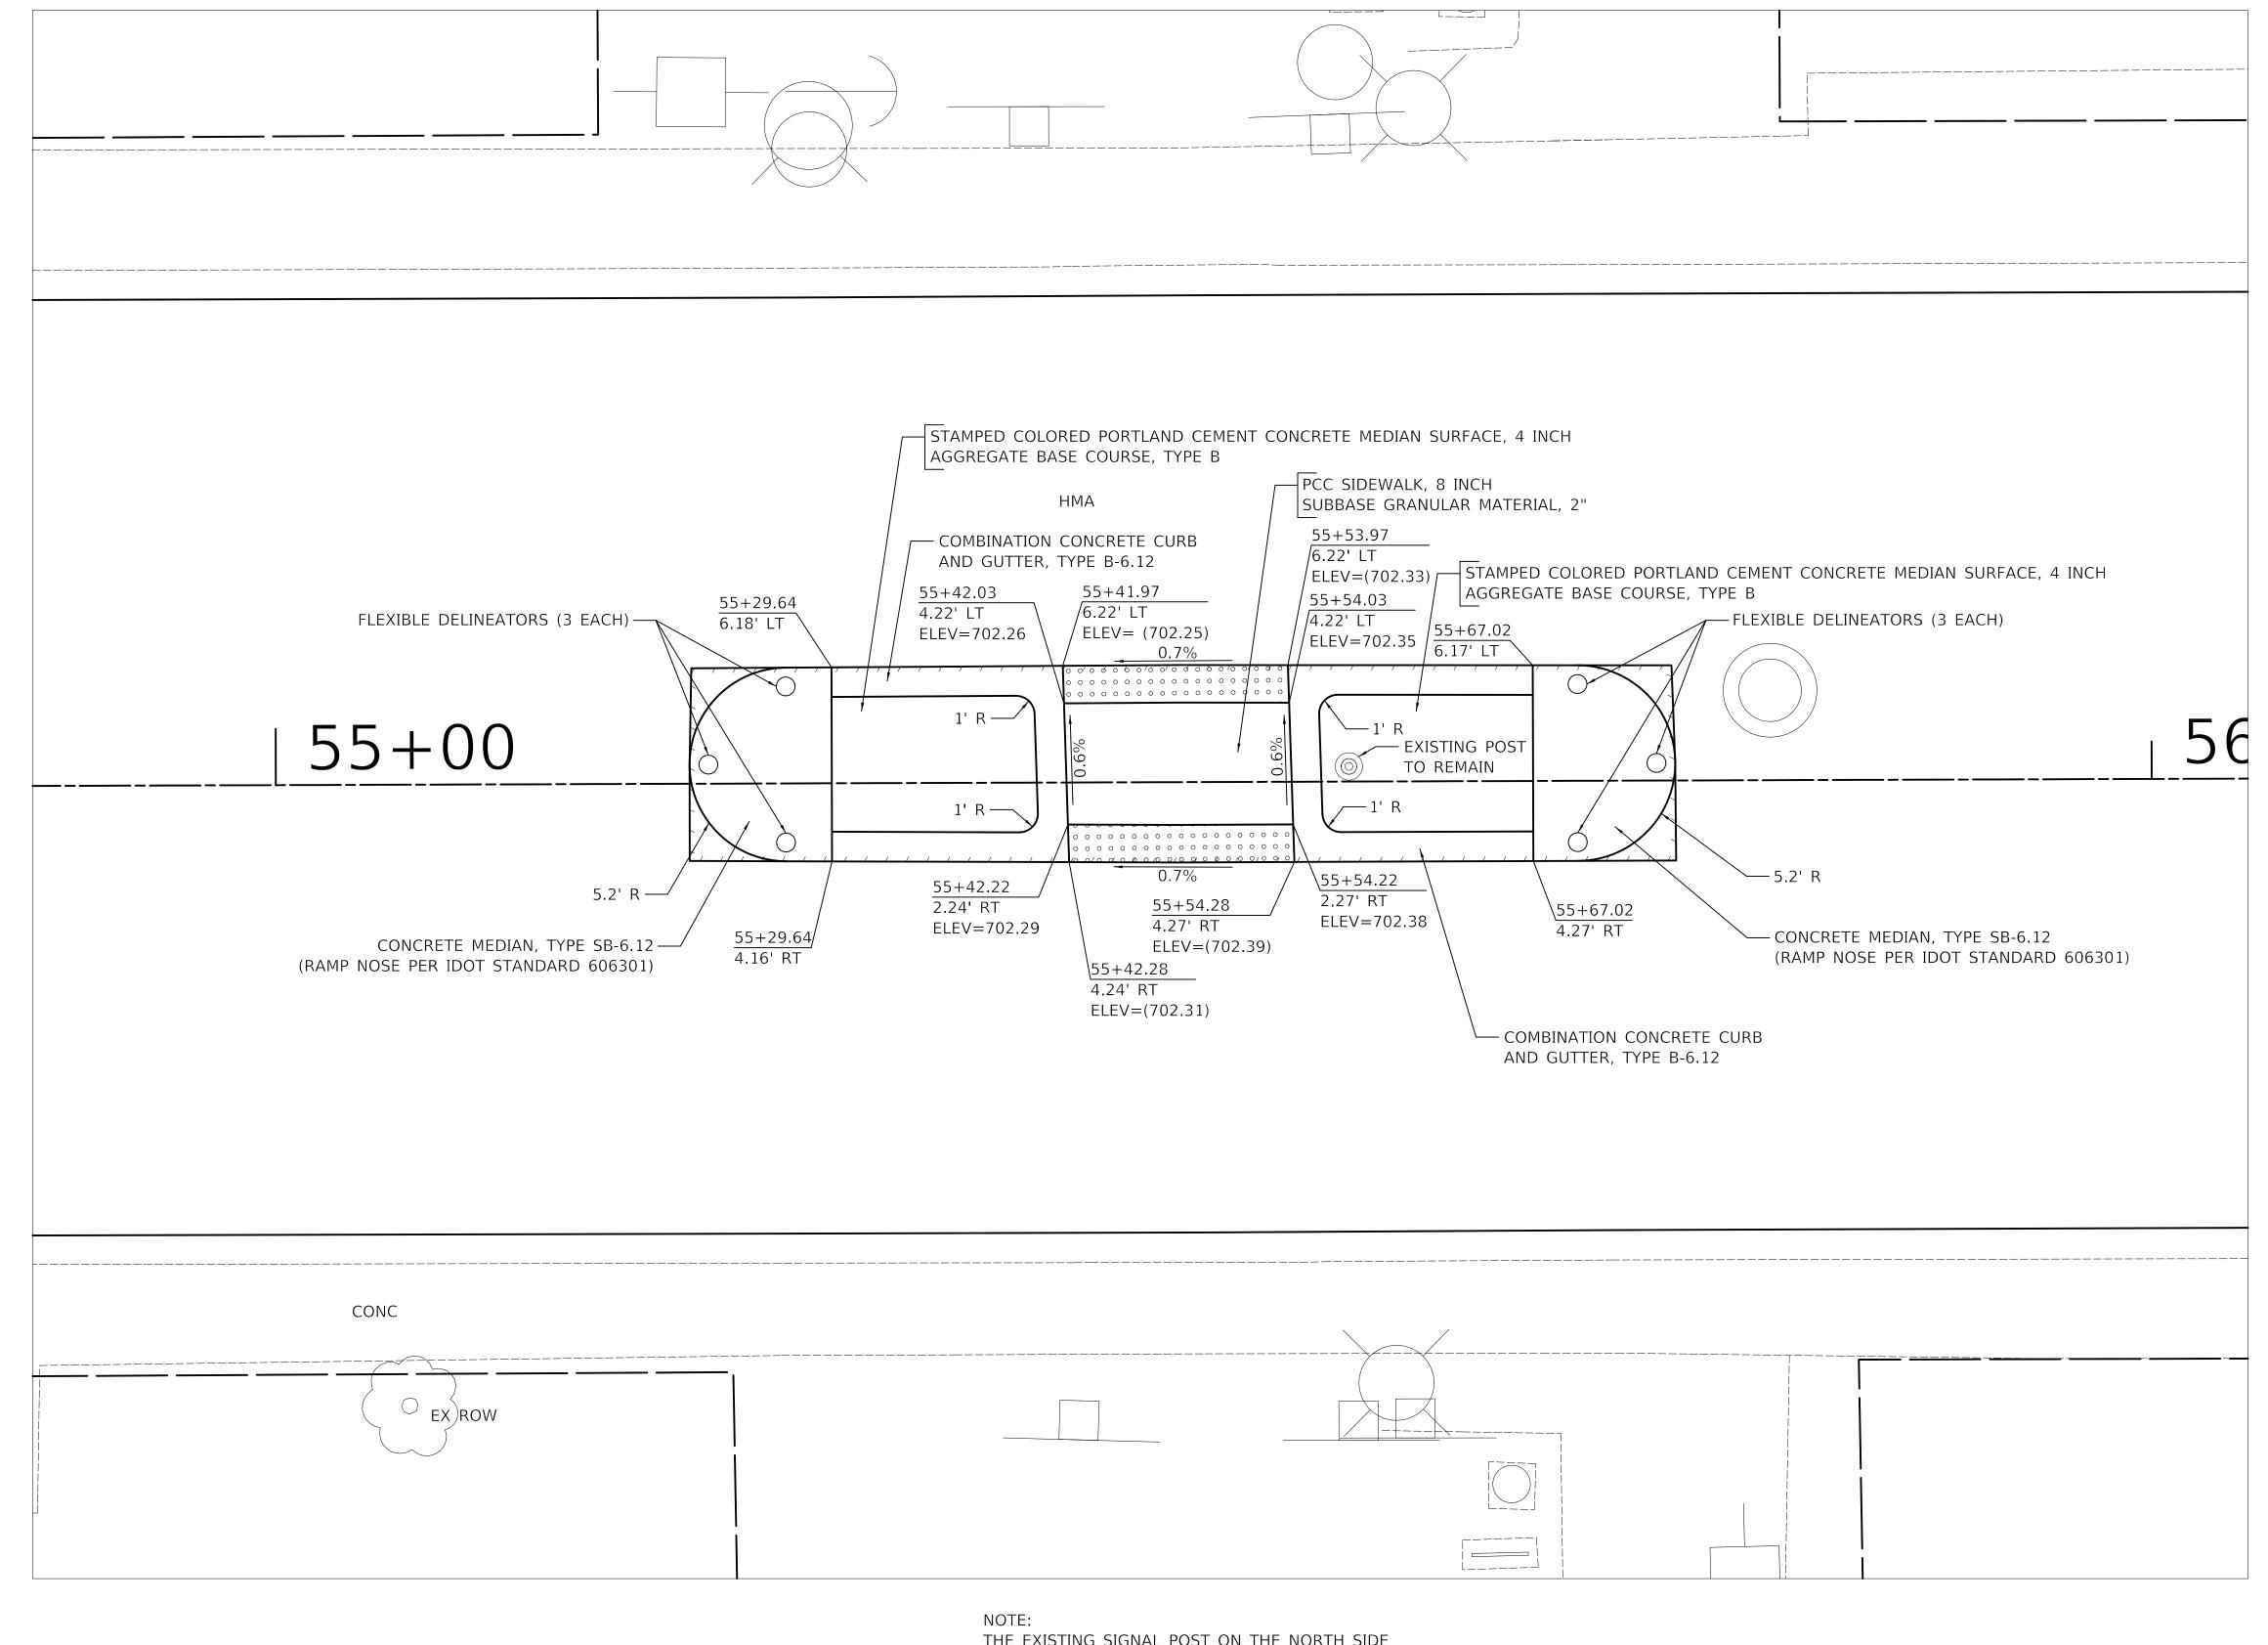

DETECTABLE WARNINGS

NOTE:
THE EXISTING SIGNAL POST ON THE NORTH SIDE
OF THE MEDIAN SHALL REMAIN IN PLACE DURING
CONSTRUCTION. THE CONTRACTOR SHALL PROTECT
THE POST AND FOUNDATION FROM DAMAGE IN A MANNER
MEETING THE APPROVAL OF THE ENGINEER. ALL DAMAGE
TO THE POST AND FOUNDATION CAUSED BY THE
CONTRACTOR SHALL BE REPAIRED BY THE CONTRACTOR
TO THE ENGINEER'S SATISFACTION AT NO COST TO THE
CONTRACT.

0	5	10	15
SCALE	IN FEET		

USER NAME = djk	DESIGNED -	KDC	REVISED -			MAIN STREET		F.A.U.	SECTION	COUNTY	TOTAL SHEET SHEETS NO
	DRAWN -	JAB	REVISED -	STATE OF ILLINOIS				2611	19-00161-00-RS	DUPAGE	67 44
PLOT SCALE = 5.0000 ' / in.	CHECKED -	DJK	REVISED -	DEPARTMENT OF TRANSPORTATION		RAISED MEDIAN DETAIL				CONTRACT	T NO. 61G29
PLOT DATE = 12/18/2019	DATE -	12/17/2019	REVISED -		SCALE: 1" = 5'	SHEET 1 OF 1 SHEETS STA.	TO STA.		ILLINOIS FED.	AID PROJECT	

TRAFFIC SIGNAL LEGEND

(NOT TO SCALE)

<u>ITEM</u>								
<u> </u>	EXISTING	<u>PROPOSED</u>	ITEM	EXISTING	<u>PROPOSED</u>	ITEM	EXISTING	<u>PROPOSED</u>
CONTROLLER CABINET			HANDHOLE -SQUARE			SIGNAL HEAD -(P) PROGRAMMABLE SIGNAL HEAD	R	R R Y
COMMUNICATION CABINET	ECC	СС	-ROUND			-(F) FROGRAMMABLE SIGNAL HEAD		G G
MASTER CONTROLLER	EMC	MC	HEAVY DUTY HANDHOLE -SQUARE -ROUND		⊞ ⊕			G G G 4Y 4G 4G
MASTER MASTER CONTROLLER	ЕММС	ммс	DOUBLE HANDHOLE				P	P
UNINTERRUPTABLE POWER SUPPLY	<u></u>	<u></u>	JUNCTION BOX		<u> </u>	SIGNAL HEAD WITH BACKPLATE -(P) PROGRAMMABLE SIGNAL HEAD	R R Y	R Y G G 4Y 4G R Y G 4Y 4G
SERVICE INSTALLATION	<u>-</u> □-	D	RAILROAD CANTILEVER MAST ARM	X OX X	X eX X	-(RB) RETROREFLECTIVE BACKPLATE		R Y G G 4Y 4G R Y G G 4Y 4G
-(P) POLE MOUNTED	1_1	-	RAILROAD FLASHING SIGNAL	$X \rightarrow X$	X •X		P RB	P RB
SERVICE INSTALLATION -(G) GROUND MOUNTED -(GM) GROUND MOUNTED METERED	$\boxtimes^{G} \boxtimes^{GM}$	⊠ ^G ⊠ ^{GM}	RAILROAD CROSSING GATE	\\\\\\\\\\\\\\\\\\\\\\\\\\\\\\\\\\\\\	X• X	DEDECTRIAN CIONAL HEAD		
TELEPHONE CONNECTION	ET	Т	RAILROAD CROSSBUCK	₹	*	PEDESTRIAN SIGNAL HEAD AT RAILROAD INTERSECTIONS	S	**
STEEL MAST ARM ASSEMBLY AND POLE	<u> </u>	•	RAILROAD CONTROLLER CABINET	₽ 	≯ ∢	PEDESTRIAN SIGNAL HEAD WITH COUNTDOWN TIMER	() C D	₩ C 1 ⁄7 D
ALUMINUM MAST ARM ASSEMBLY AND POLE			UNDERGROUND CONDUIT (UC), GALVANIZED STEEL					
STEEL COMBINATION MAST ARM ASSEMBLY AND POLE WITH LUMINAIRE	0->>	•*	TEMPORARY SPAN WIRE, TETHER WIRE, AND CABLE			ILLUMINATED SIGN ''NO LEFT TURN''/'NO RIGHT TURN''		
SIGNAL POST	0	 ● BM 	SYSTEM ITEM	S	SP	NUMBER OF CONDUCTORS, ELECTRIC CABLE NO. 14, UNLESS NOTED OTHERWISE.		
-(BM) BARREL MOUNTED - TEMPORARY			INTERSECTION ITEM	I	IP	ALL DETECTOR LOOP CABLE TO BE SHIELDED		
OOD POLE	⊗	⊕ ≻	REMOVE ITEM		R	GROUND CABLE IN CONDUIT, NO. 6 SOLID COPPER (GREEN)	- 1 # 6 - -	 (1 * 6)
IGNAL HEAD	→	→	RELOCATE ITEM		RL	ELECTRIC CABLE IN CONDUIT, TRACER NO. 14 1/C		
IGNAL HEAD WITH BACKPLATE	+1>	+►	ABANDON ITEM CONTROLLER CABINET AND		Α	COAXIAL CABLE	— <u>c</u>	<u> </u>
IGNAL HEAD OPTICALLY PROGRAMMED	>P +->P	→ P + P	FOUNDATION TO BE REMOVED		RCF		- /	
LASHER INSTALLATION	F FS	F FS FS	MAST ARM POLE AND FOUNDATION TO BE REMOVED		RMF	VENDOR CABLE		
(FS) SOLAR POWERED	F FS	FF FS	SIGNAL POST AND FOUNDATION TO BE REMOVED		RPF	COPPER INTERCONNECT CABLE, NO. 18, 3 PAIR TWISTED, SHIELDED	6# 18	
PEDESTRIAN SIGNAL HEAD	-0	-1	DETECTOR LOOP, TYPE I			FIBER OPTIC CABLE -NO. 62.5/125, MM12F		——————————————————————————————————————
PEDESTRIAN PUSH BUTTON (APS) ACCESSIBLE PEDESTRIAN PUSH BUTTON	<pre></pre>		PREFORMED DETECTOR LOOP		P P	-NO. 62.5/125, MM12F SM12F -NO. 62.5/125, MM12F SM24F		24F
RADAR DETECTION SENSOR	R	R	SAMPLING (SYSTEM) DETECTOR	$\begin{bmatrix} \overline{s} \\ \overline{s} \end{bmatrix} (\overline{s})$	<u>s</u> s			—(36F)—
/IDEO DETECTION CAMERA		V	INTERSECTION AND SAMPLING		IS (S)			
RADAR/VIDEO DETECTION ZONE			(SYSTEM) DETECTOR QUEUE AND SAMPLING			GROUND ROD -(C) CONTROLLER	<u>=</u> C <u>=</u> M <u>=</u> P <u>=</u> S	<u>.</u> C <u>.</u> M <u>.</u> P <u>.</u> S
			(SYSTEM) DETECTOR	(QS)	as (as)	-(M) MAST ARM -(P) POST	8 8 8	1 1 1
AN, TILT, ZOOM (PTZ) CAMERA	PTZ]	PTZ	WIRELESS DETECTOR SENSOR		®	-(S) SERVICE		
MERGENCY VEHICLE LIGHT DETECTOR		•4	WIRELESS ACCESS POINT					
CONFIMATION BEACON	o - ()	•••						
	~ IIII	•·+ -						
IRELESS INTERCONNECT	○+ ERR	RR						

DATE - 9/29/2016

PLOT DATE = 9/29/2016

REVISED -


STANDARD TRAFFIC SIGNAL DESIGN DETAILS SHEET 1 OF 7 SHEETS STA. SCALE: NONE TO STA.

CONTRACT NO. 61G29 TS-05 ILLINOIS FED. AID PROJECT


LOOP DETECTOR NOTES

- 1. EACH PAIR OF LOOP WIRES SHALL BE PLACED IN A SEPARATE EMPTY COILABLE NONMETALLIC CONDUIT FROM THE EDGE OF PAVEMENT TO THE HANDHOLE. SPACING BETWEEN THE HOLES DRILLED IN THE PAVEMENT SHALL NOT BE LESS THAN 6" (150 mm). EMPTY COILABLE NONMETALLIC CONDUIT SHALL BE INCLUDED IN THE COST OF THE LOOP WIRE.
- 2. THE NUMBER OF LOOP TURNS SHALL BE AS RECOMMENDED BY THE AMPLIFIER MANUFACTURER.
 ALL ADJACENT SIDES OF THE LOOPS SHALL BE INSTALLED IN SUCH A WAY THAT THE CURRENT FLOW IS IN THE SAME DIRECTION TO REINFORCE ITS MAGNETIC FIELDS FOR SMALL VEHICLE DETECTION.
- 3. EACH LOOP LEAD-IN SHALL BE IDENTIFIED AND PERMANENTLY TAGGED IN THE HANDHOLE. EACH LEAD-IN CABLE TAG SHALL INDICATE THE LOCATION OF THE LOOP, LOOP ROTATION (CLOCKWISE/COUNTERCLOCKWISE), LOOP LEAD-IN DIRECTION (IN OR OUT), LOOP CABLE NUMBER AND LOCATION IN CABINET, AND NUMBER OF TURNS IN THE DETECTOR LOOPS IN WATER PROOF INK AS INDICATED ON THE DISTRICT 1 STANDARD TRAFFIC SIGNAL DESIGN DETAIL. THE CONTRACTOR SHALL MARK LOOP LOCATIONS ON RECORD DRAWINGS AND PRESENT TO THE ENGINEER AFTER FINAL INSPECTION. LOOPS SHALL BE MARKED BY LANE AND LOOP NUMBER. SEE DETAIL BELOW.
- 4. ALL LOOP CABLE SHALL BE FASTENED WITH PLASTIC TIE WRAP TO THE HANDHOLE HOOKS.
- 5. IN ASPHALT PAVEMENT, LOOPS SHOULD BE PLACED IN THE BINDER AND DIVEHOLES MARKED AT THE CURB WITH A SAW-CUT. THE SAW-CUT SHALL BE CUT IN ACCORDANCE WITH LOCAL AND E.P.A. DUST CONTROL REQUIREMENTS. DETECTOR LOOP(S) SHALL NOT BE INSTALLED IN WET CONDITIONS AND THE SAW-CUTS MUST BE FREE OF DEBRIS AND RESIDUE SUCH AS DUST AND WATER WHICH IS TO BE ACHIEVED BY THE USE OF COMPRESSED AIR, WIRE BRUSHING AND HEAT DRYING ACCORDING TO SEALANT MANUFACTURER REQUIREMENTS. THE DETECTOR WIRE SHALL BE HELD IN PLACE BY THE USE OF FORM WEDGES. WEDGES SHALL BE SPACED NO MORE THAN 18" (450 mm) APART.
- 6. LOOP SPLICES SHALL BE SOLDERED USING A SOLDERING IRON. BLOW TORCHES OR OTHER DEVICES WHICH OXIDIZE COPPER CABLE SHALL NOT BE ALLOWED FOR SOLDERING OPERATIONS. SEE DETAIL BELOW RIGHT.
- 7. PREFORMED DETECTOR LOOPS SHALL BE USED, AS SHOWN ON THE PLANS, WHERE NEW CONCRETE PAVEMENT IS PROPOSED. THE INSTALLATION OF PREFORMED LOOPS SHALL BE IN ACCORDANCE WITH THE DISTRICT 1 SPECIFICATIONS OR AS DIRECTED BY THE ENGINEER.

LOOP LEAD-IN CABLE TAG

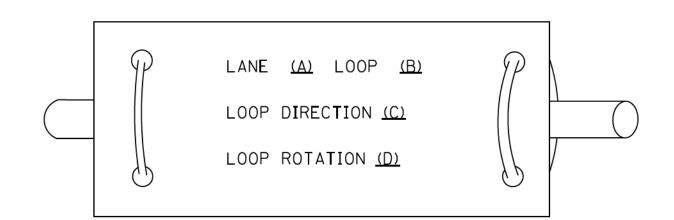



- A. LANE 1 IS THE LANE CLOSEST TO THE CENTERLINE OF THE ROADWAY
- B. LOOP *1 IS THE LOOP IN THE LANE CLOSEST TO THE INTERSECTION.
- C. LABEL LOOP CABLE "IN" OR LOOP CABLE "OUT".
- D. LABEL LOOP CABLE CLOCKWISE OR LOOP CABLE COUNTERCLOCKWISE.

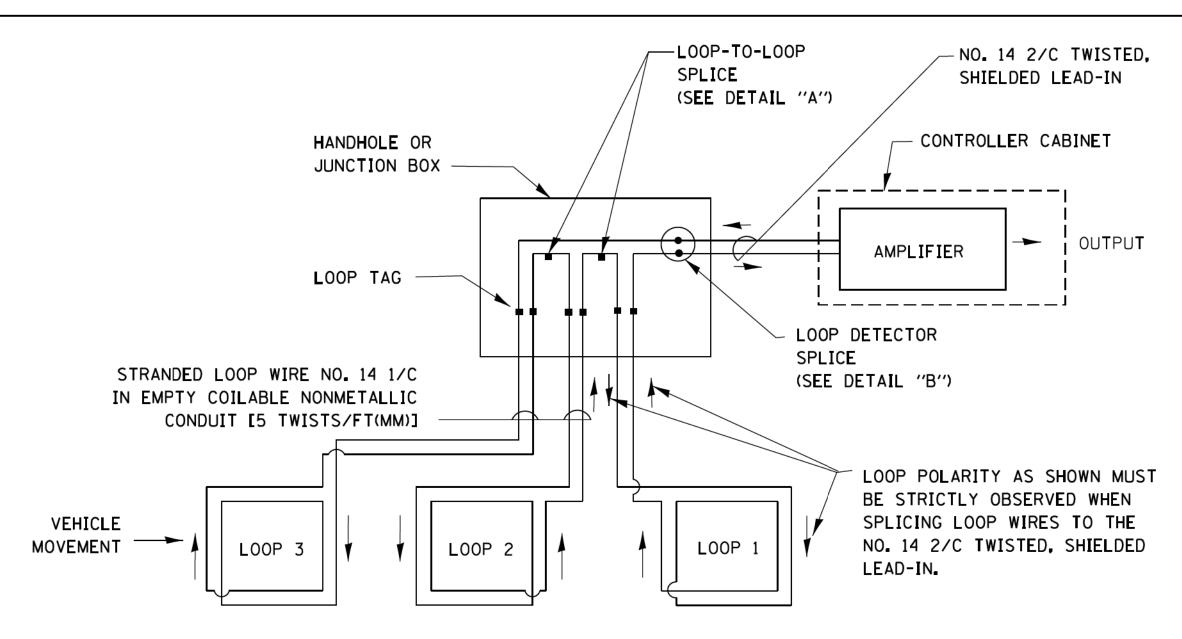

DETECTOR LOOP WIRING SCHEMATIC

- LOOPS SHALL BE SPLICED IN SERIES.
- SAW-CUTS SHALL BE A MINIMUM WIDTH OF 5/16" (8 mm).
- SAW-CUT DEPTHS SHALL BE 3" (75 mm). IF IN CONCRETE, THE SAW-CUT DEPTH SHALL BE TO THE TOP OF THE REINFORCEMENT.
- LOOP CORNERS SHALL BE DRILLED WITH A 2" (50 mm) DIAMETER CORE.

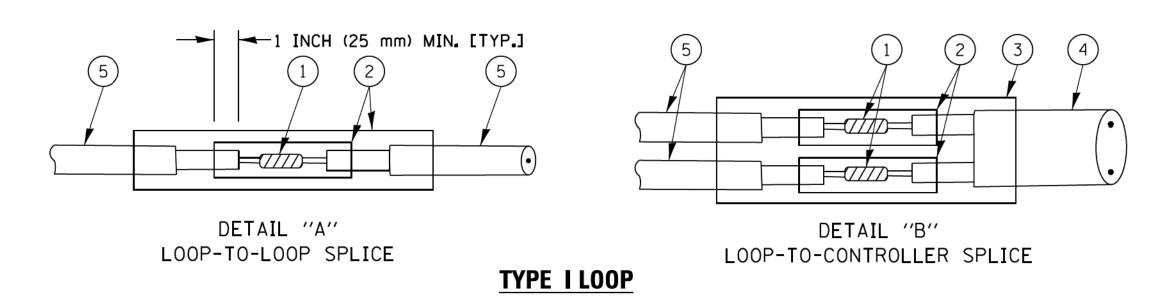

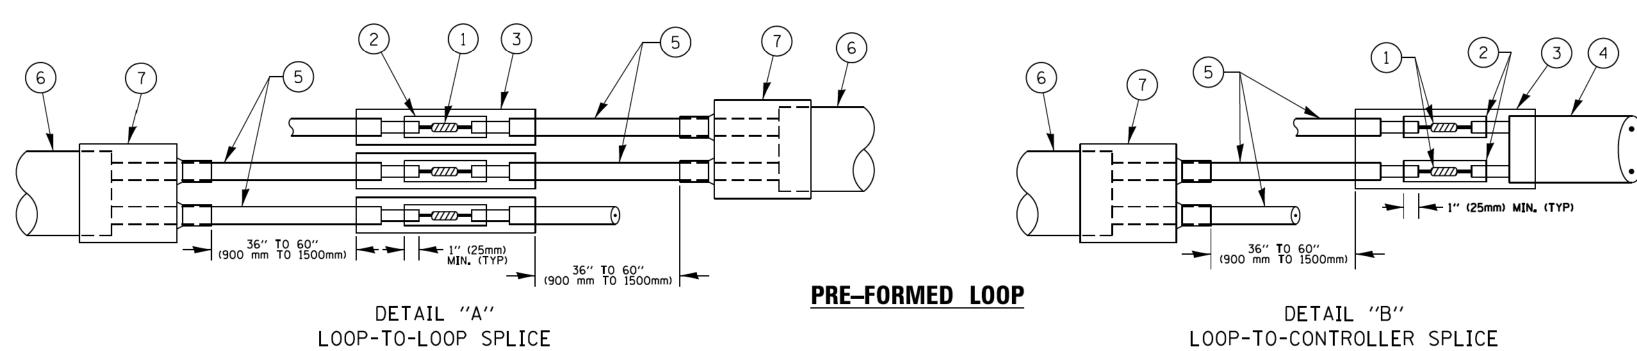

LOOP DETECTOR SPLICE

- 1 WESTERN UNION SPLICE SOLDERED WITH ROSIN CORE FLUX. ALL EXPOSED SURFACES OF THE SOLDER SHALL BE SMOOTH. THE WESTERN UNION SPLICES SHALL BE STAGGERED.
- (2) WCSMW 30/100 HEAT SHRINK TUBE, MINIMUM LENGTH 3" (75 mm), UNDERWATER GRADE.
- (3) WCS 200/750 HEAT SHRINK TUBE, MINIMUM LENGHT 6" (150 mm), UNDERWATER GRADE.

SCALE: NONE


(4) NO. 14 2/C TWISTED, SHIELDED CABLE.

- (5) LOOP CONDUCTOR WITH FLEXIBLE PLASTIC TUBE.
- 6 PRE-FORMED LOOP
- 7 XL POLYOLEFIN 2 CONDUCTOR
 BREAKOUT SEALS. TYCO CBR-2 OR APPROVED EQUAL

FILE NAME =	USER NAME = footemj	DESIGNED -	DAD	REVISED - DAG 1-1-14
c:\pw_work\pwidot\footemj\d0108315\ts05.	dgn	DRAWN -	BCK	REVISED -
	PLOT SCALE = 50.0000 '/ in.	CHECKED -	DAD	REVISED -
	PLOT DATE = 1/13/2014	DA TE -	10-28-09	REVISED -


STATE OF ILLINOIS
DEPARTMENT OF TRANSPORTATION

TRAFFIC SIGNAL MAST ARM AND SIGNAL POST MAST ARM MOUNTED SIGNALS IN EXISTING, PROPOSED OR FUTURE SIDEWALK/BICYCLE PATH AREA. INTERSECTION SHOWN WITH PEDESTRIAN SIGNALS AND PEDESTRIAN PUSHBUTTON DETECTORS.

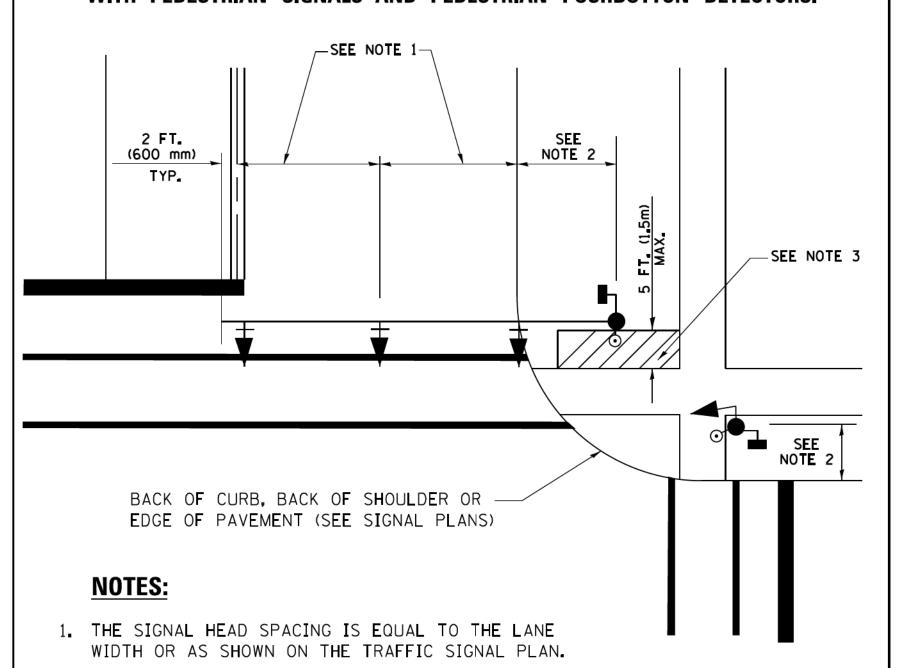


- 2. REFER TO THE TRAFFIC SIGNAL EQUIPMENT OFFSET TABLE.
- 3. PROVIDE A LEVEL ALL-WEATHER SURFACE (CONCRETE SIDEWALK, ASPHALT BICYCLE PATH SURFACE OR MATCHING MATERIAL TO THE ADJACENT SURFACE) UP TO THE MAST ARM SHAFT OR THE SIGNAL POST.
- 4. THE FACE OF THE PEDESTRIAN PUSHBUTTON SHALL BE PARALLEL TO THE CROSSWALK TO BE USED.
- 5. THE LOCATIONS AND INSTALLATION OF PEDESTRIAN SIGNAL HEADS AND PEDESTRIAN PUSHBUTTONS SHALL MEET THE REQUIREMENTS OF THE MUTCD AND INFORMATION FOUND IN THE "AMERICANS WITH DISABILITIES ACT ACCESSIBILITY GUIDELINES FOR BUILDINGS AND FACILITIES."

PEDESTRIAN SIGNAL POST AND PEDESTRIAN PUSH BUTTON POST

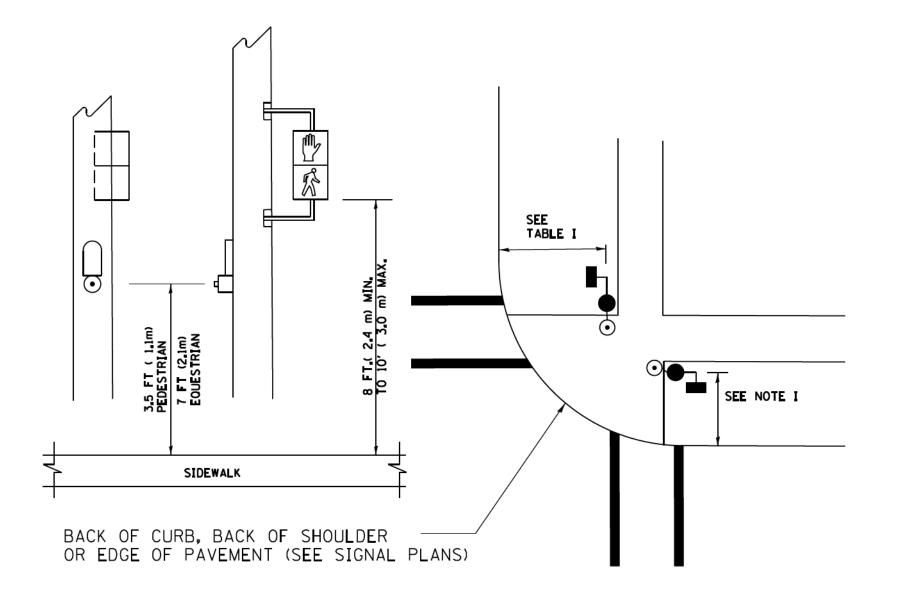

NOTES:

- 1. REFER TO THE TRAFFIC SIGNAL EQUIPMENT OFFSET TABLE.
- 2. PROVIDE A LEVEL ALL-WEATHER SURFACE (CONCRETE SIDEWALK, ASPHALT BICYCLE PATH SURFACE OR MATCHING MATERIAL TO THE ADJACENT SURFACE) UP TO THE PEDESTRIAN SIGNAL POST OR THE PEDESTRIAN PUSH BUTTON POST.
- 3. THE FACE OF THE PEDESTRIAN PUSHBUTTON SHALL BE PARALLEL TO THE CROSSWALK TO BE USED.
- 4. THE LOCATIONS AND INSTALLATION OF PEDESTRIAN SIGNAL HEADS AND PEDESTRIAN PUSHBUTTONS SHALL MEET THE REQUIREMENTS OF THE MUTCD AND INFORMATION FOUND IN THE "AMERICANS WITH DISABILITIES ACT ACCESSIBILITY GUIDELINES FOR BUILDINGS AND FACILITIES."

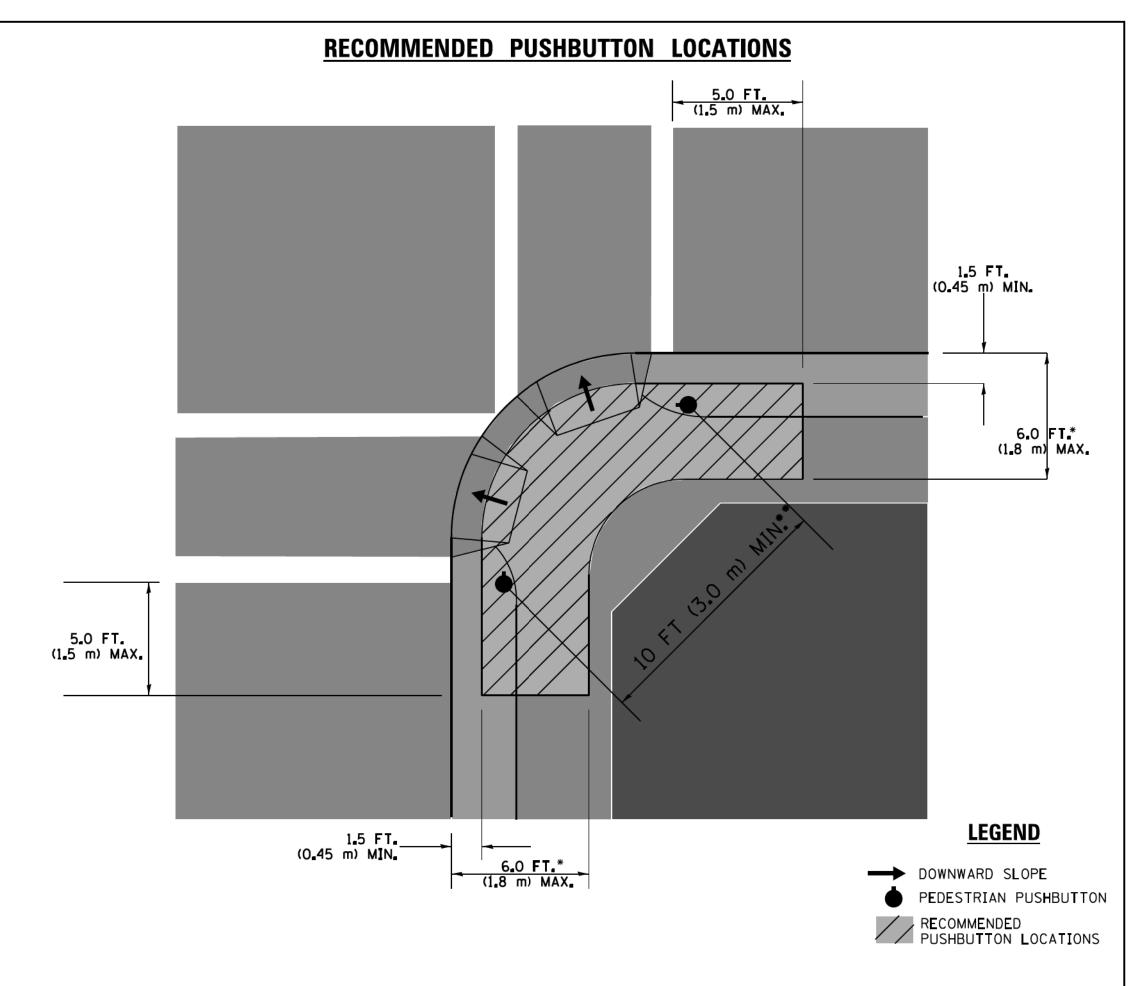

- * WHERE THERE ARE CONSTRAINTS THAT MAKE IT IMPRACTICAL TO PLACE THE PEDESTRIAN PUSHBUTTON BETWEEN 1.5 FT (0.45 m) AND 6 FT (1.8 m) FROM THE EDGE OF THE CURB, SHOULDER, OR PAVEMENT, IT SHOULD NOT BE FURTHER THAN 10 FT (3 m) FROM THE EDGE OF CURB, SHOULDER, OR PAVEMENT.
- ** WHERE THERE ARE CONSTRAINTS ON A PARTICULAR CORNER THAT MAKE IT IMPRACTICAL TO PROVIDE THE 10 FT (3 m) SEPERATION BETWEEN THE TWO PEDESTRIAN PUSHBUTTONS, THE PUSHBUTTONS MAY BE PLACED CLOSER TOGETHER OR ON THE SAME POLE.

NOTES:

- 1. PEDESTRIAN SIGNAL HEADS SHALL BE MOUNTED WITH THE BOTTOM OF THE SIGNAL HOUSING INCLUDING BRACKETS NOT LESS THAN 8 FT (2.4 m) OR MORE THAN 10 FT (3 m) ABOVE SIDEWALK LEVEL, AND SHALL BE POSITIONED AND ADJUSTED TO PROVIDE MAXIMUM VISIBILITY AT THE BEGINNING OF THE CONTROLLED CROSSWALK.
- 2. THE BOTTOM OF THE SIGNAL HOUSING (INCLUDING BRACKETS) OF A VEHICULAR SIGNAL FACE THAT IS NOT LOCATED OVER A HIGHWAY SHALL BE AT LEAST 8 FT (2.4 m) BUT NOT MORE THAN 19 FT (5.8 m) ABOVE THE SIDEWALK OR, IF THERE IS NO SIDEWALK, ABOVE THE PAVEMENT GRADE AT THE CENTER OF THE ROADWAY.
- 3. THE BOTTOM OF THE SIGNAL HOUSING AND ANY RELATED ATTACHMENTS TO A SIGNAL FACE LOCATED OVER ANY PORTION OF A HIGHWAY SHALL BE ACCORDING TO CURRENT STATE STANDARDS 877001, 877002, 877006, 877011 AND 877012 WITH A MINIMUM OF 16 FT (5.0 m) AND A MAXIMUM OF 18 FT. (5.5 m) FROM THE HIGHEST POINT OF PAVEMENT.
- 4. THE BOTTOM OF THE TEMPORARY SPAN WIRE MOUNTED SIGNAL HOUSING AND ANY RELATED ATTACHMENTS TO A SIGNAL FACE LOCATED OVER ANY PORTION OF A HIGHWAY SHALL BE ACCORDING TO CURRENT STATE STANDARD 880001 WITH A MINIMUM OF 17 FT (5.18 m) FROM THE HIGHEST POINT OF PAVEMENT.
- 5. THE TOP OF THE SIGNAL HOUSING OF A SIGNAL FACE LOCATED OVER ANY PORTION OF A HIGHWAY SHALL NOT BE MORE THAN 25.6 FT (7.8 m) ABOVE THE PAVEMENT.


TRAFFIC SIGNAL EQUIPMENT OFFSET


	TRAITIC STORAL EGGI WERT OF	
TRAFFIC SIGNAL EQUIPMENT	COMBINATION CONCRETE CURB AND GUTTER (MINIMUM DISTANCE FROM BACK OF CURB TO CENTERLINE OF FOUNDATION)	SHOULDER/NON-CURBED AREA (MINIMUM DISTANCE FROM EDGE OF PAVEMENT TO CENTERLINE OF FOUNDATION)
TRAFFIC SIGNAL MAST ARM POLE	6 FT (1.8m)	SHOULDER WIDTH + 2 FT (0.6m), MINIMUM 10 FT (3.0m)
TRAFFIC SIGNAL POST	4 FT (1.2m)	SHOULDER WIDTH + 2 FT (0.6m), MINIMUM 10 FT (3.0m)
PEDESTRIAN SIGNAL POST	4 FT (1.2m)	SHOULDER WIDTH + 2 FT (0.6m), MINIMUM 10 FT (3.0m)
PEDESTRIAN PUSHBUTTON POST	4 FT (1.2m)	SHOULDER WIDTH + 2 FT (0.6m), MINIMUM 10 FT (3.0m)
TEMPORARY WOOD POLE	6 FT (1.8m)	SHOULDER WIDTH + 2 FT (0.6m), MINIMUM 10 FT (3.0m)
CONTROLLER CABINET	6 FT (1.8m) MINIMUM DISTANCE SEE NOTE 2	SHOULDER WIDTH + 6 FT (1.8m), MINIMUM 16 FT (4.9m) SEE NOTE 3.
SERVICE INSTALLATION, GROUND MOUNT	6 FT (1.8m) MINIMUM DISTANCE SEE NOTE 2	SHOULDER WIDTH + 6 FT (1.8m), MINIMUM 16 FT (4.9m) SEE NOTE 3.


NOTES:

- 1. CONTACT THE "AREA TRAFFIC SIGNAL MAINTENANCE AND OPERATIONS ENGINEER" FOR ASSISTANCE IN LOCATING THE TRAFFIC SIGNAL EQUIPMENT WHEN THERE ARE CONFLICTS WITH DITCHES OR THE MINIMUM OFFSET DISTANCES CANNOT BE MET.
- 2. MINIMUM DISTANCE FROM THE BACK OF CURB TO THE ROADWAY SIDE OF THE FOUNDATION.
- 3. MINIMUM DISTANCE FROM THE EDGE OF PAVEMENT TOTHE ROADWAY SIDE OF THE FOUNDATION.
- 4. ANY CHANGES TO THE OFFSETS OF THE FOUNDATIONS, FROM THE MINIMUM DISTANCES LISTED IN THE "TRAFFIC SIGNAL EQUIPMENT OFFSET" CHART AND THE TRAFFIC SIGNAL INSTALLATION PLAN, COULD EFFECT THE PLACEMENT OF THE SIGNAL HEADS, PEDESTRIAN SIGNAL HEADS AND THE PEDESTRIAN PUSHBUTTONS. THE SIGNAL HEAD PLACEMENT ON THE MAST ARMS SHALL REMAIN AS PER THE TRAFFIC SIGNAL INSTALLATION PLAN AND THE "TRAFFIC SIGNAL MAST ARM AND SIGNAL POST" DETAIL ABOVE. THE PROPOSED MAST ARM LENGTHS MAY NEED TO BE REVISED TO MEET THE ABOVE REQUIREMENTS. THE PEDESTRIAN SIGNAL HEADS AND PEDESTRIAN PUSHBUTTONS MUST MEET THE REQUIREMENTS UNDER THE DETAILS ON THIS SHEET.

FILE NAME =	USER NAME = footemj	DESIGNED - DAD	REVISED - DAG 1-1-14			DISTRICT ONE	F.A.U.	SECTION	COUNTY	CHEETS	SHEET
c:\pw_work\pwidot\footemj\d0108315\ts05.	dgn	DRAWN - BCK	REVISED -	STATE OF ILLINOIS			2611	19-00161-00-RS	DUPAGE	67	47
	PLOT SCALE = 50.0000 ' / 10.	CHECKED - DAD	REVISED -	DEPARTMENT OF TRANSPORTATION		STANDARD TRAFFIC SIGNAL DESIGN DETAILS		TS-05	CONTRACT	NO.	61G29
	PLOT DATE = 1/13/2014	DATE - 10-28-09	REVISED -		SCALE: NONE	SHEET NO. 3 OF 7 SHEETS STA. TO STA.	EED BOA	O DIST NO 1 HILINOIS FED AT	O PROJECT		

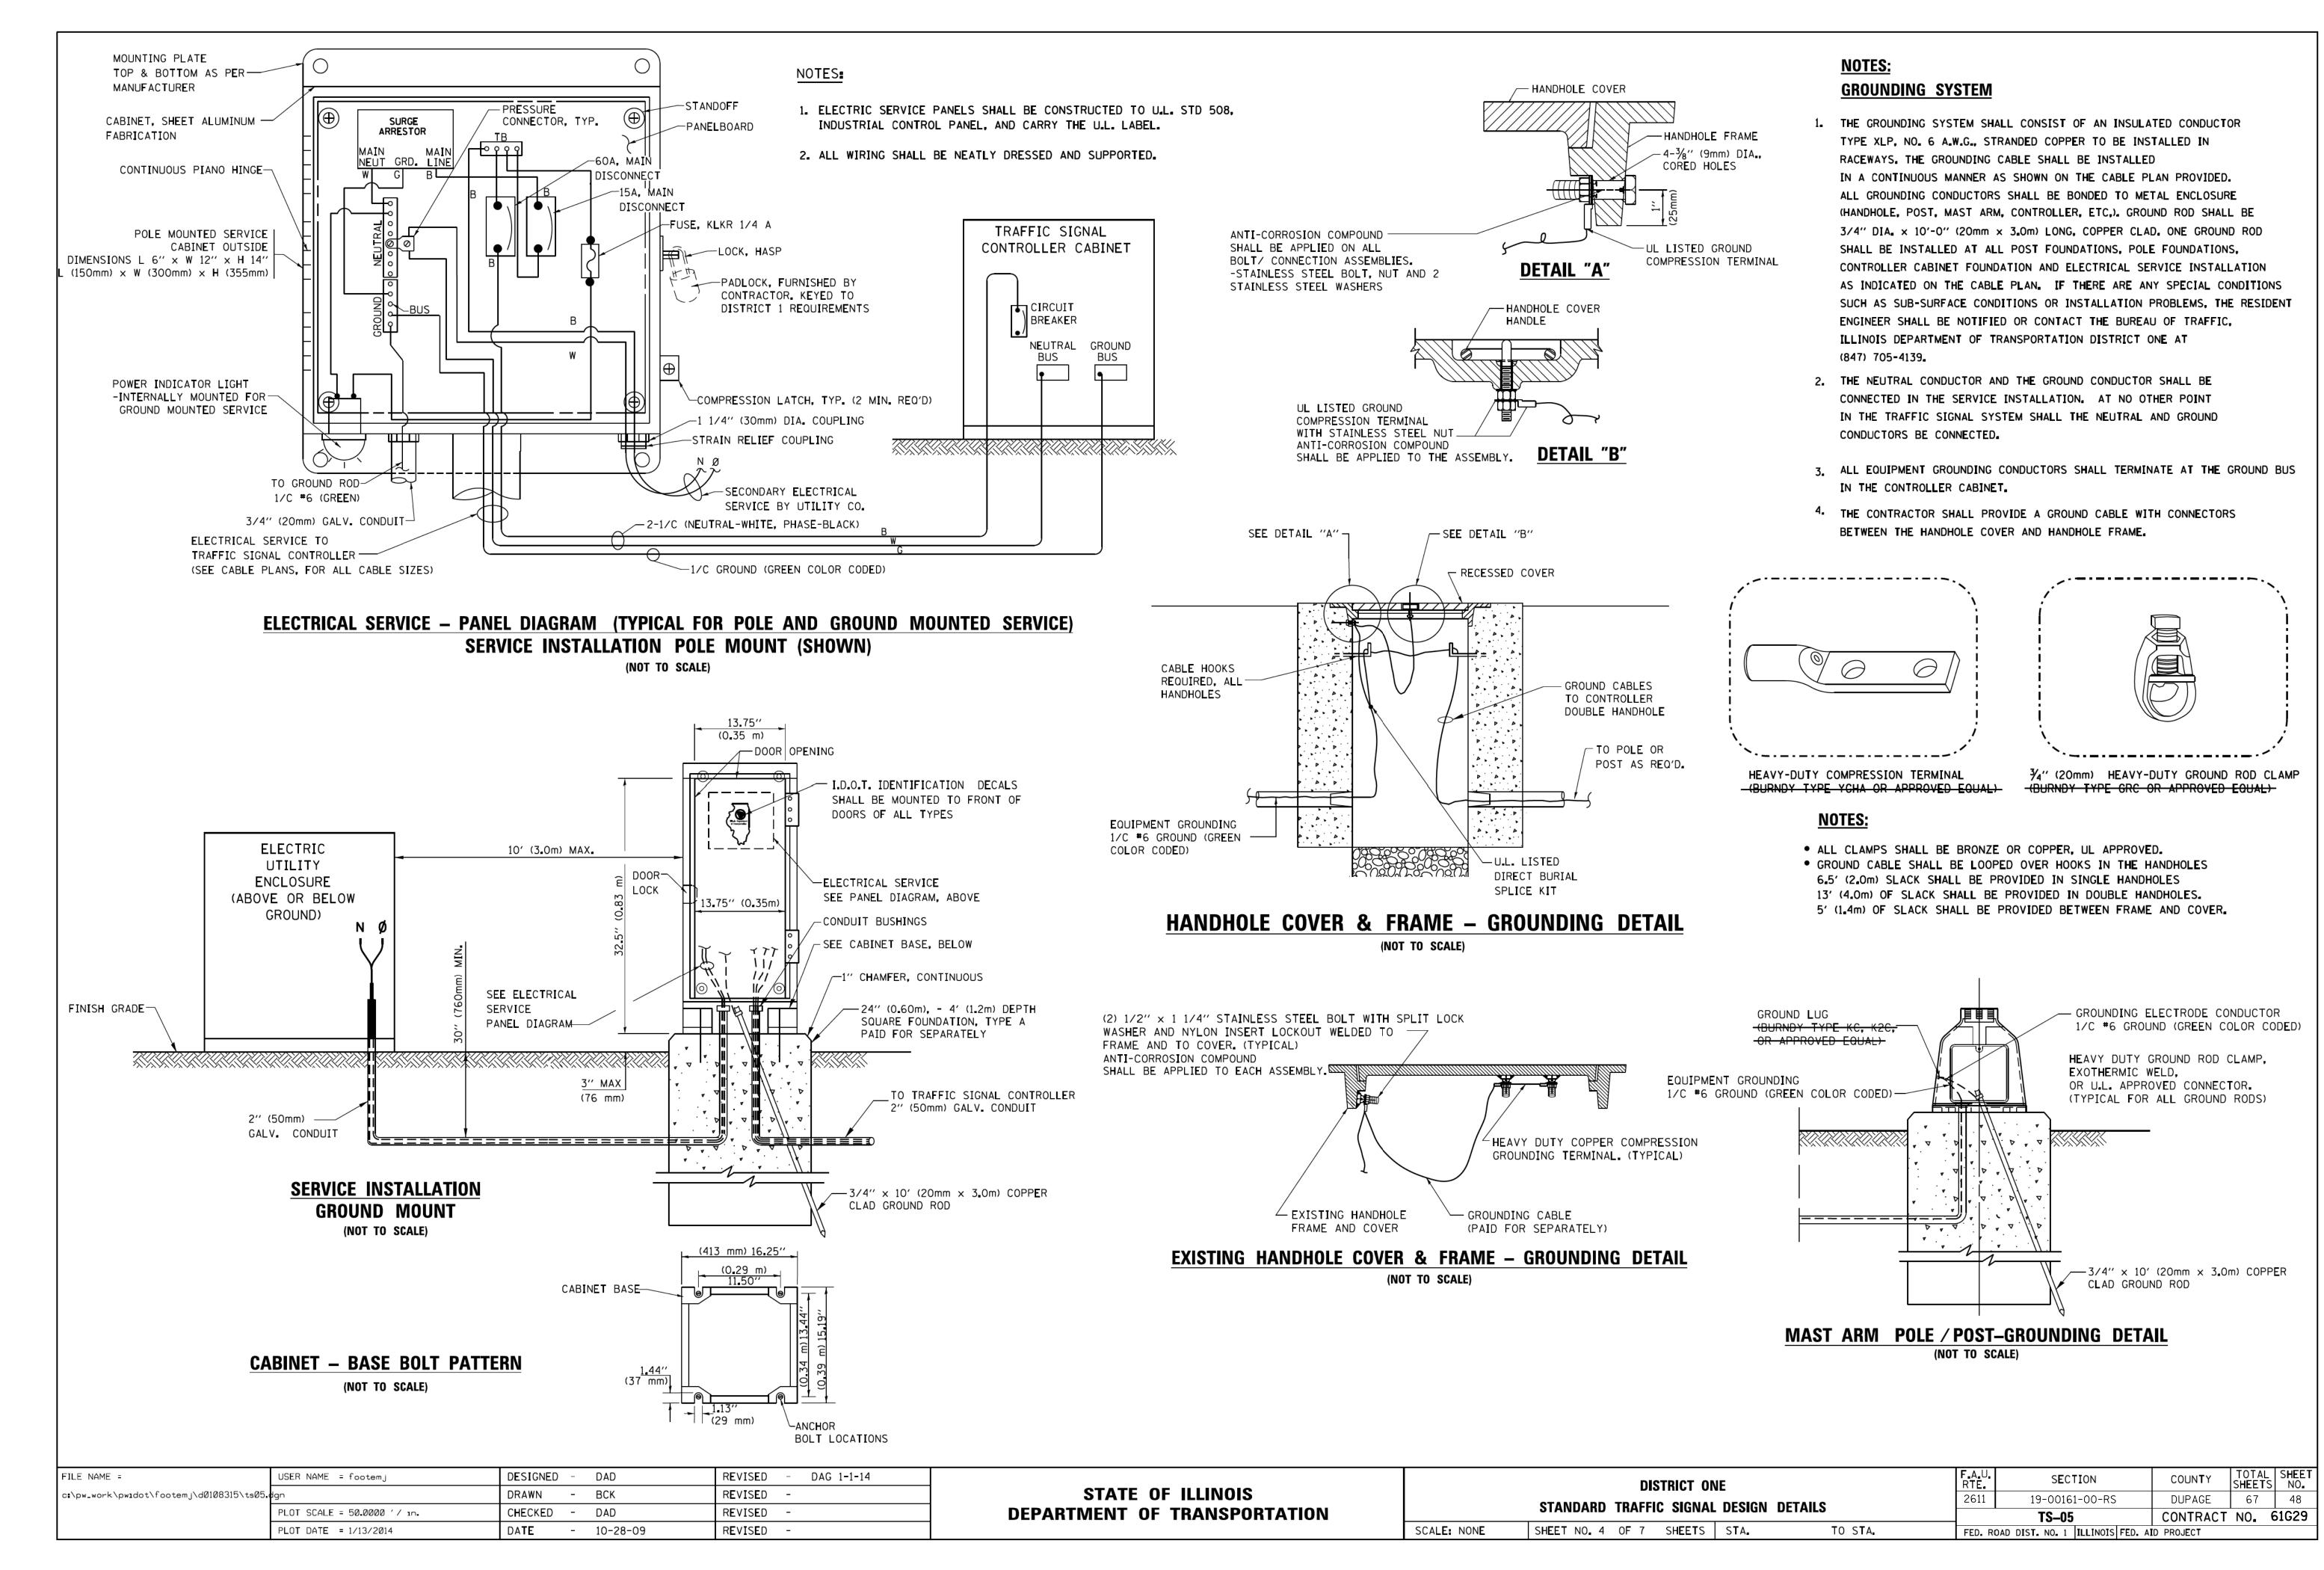

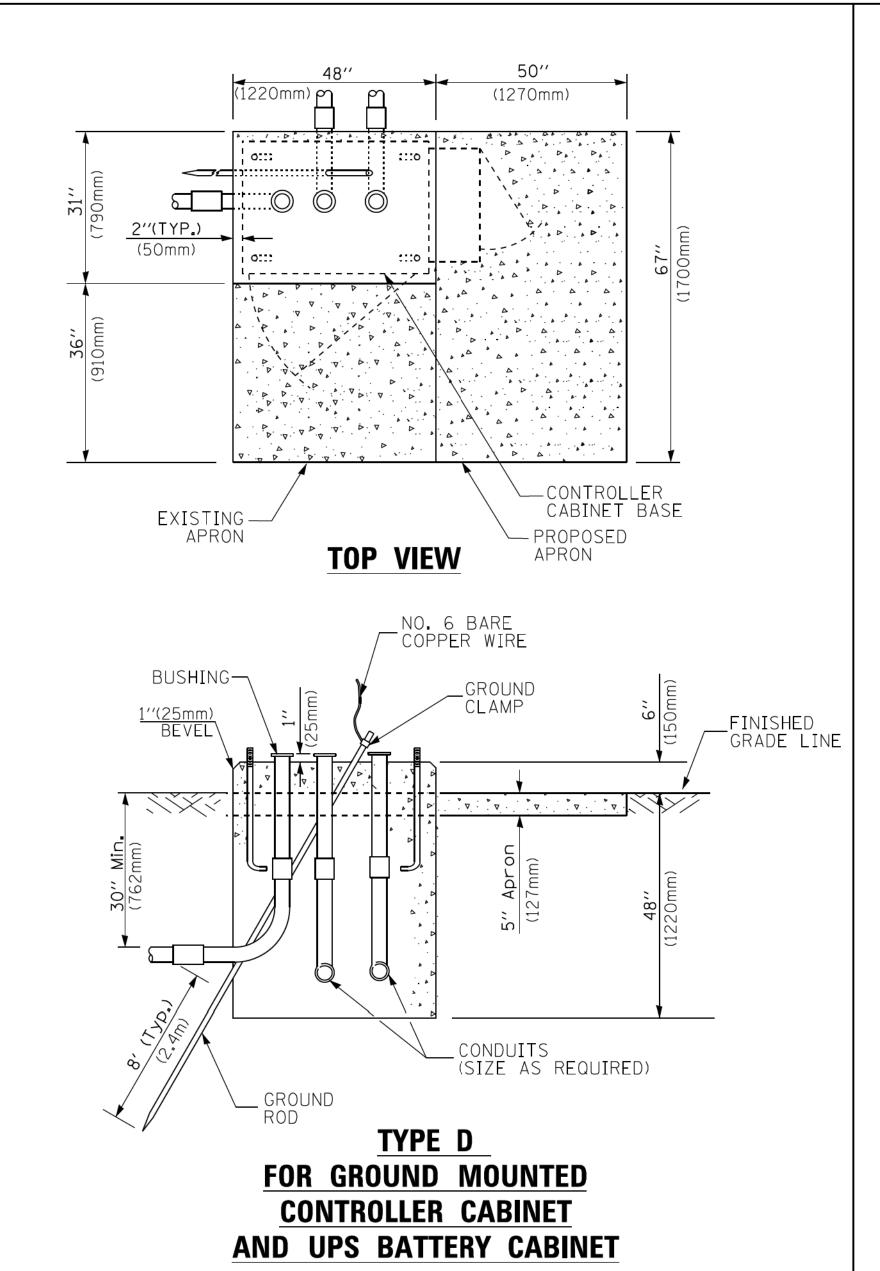

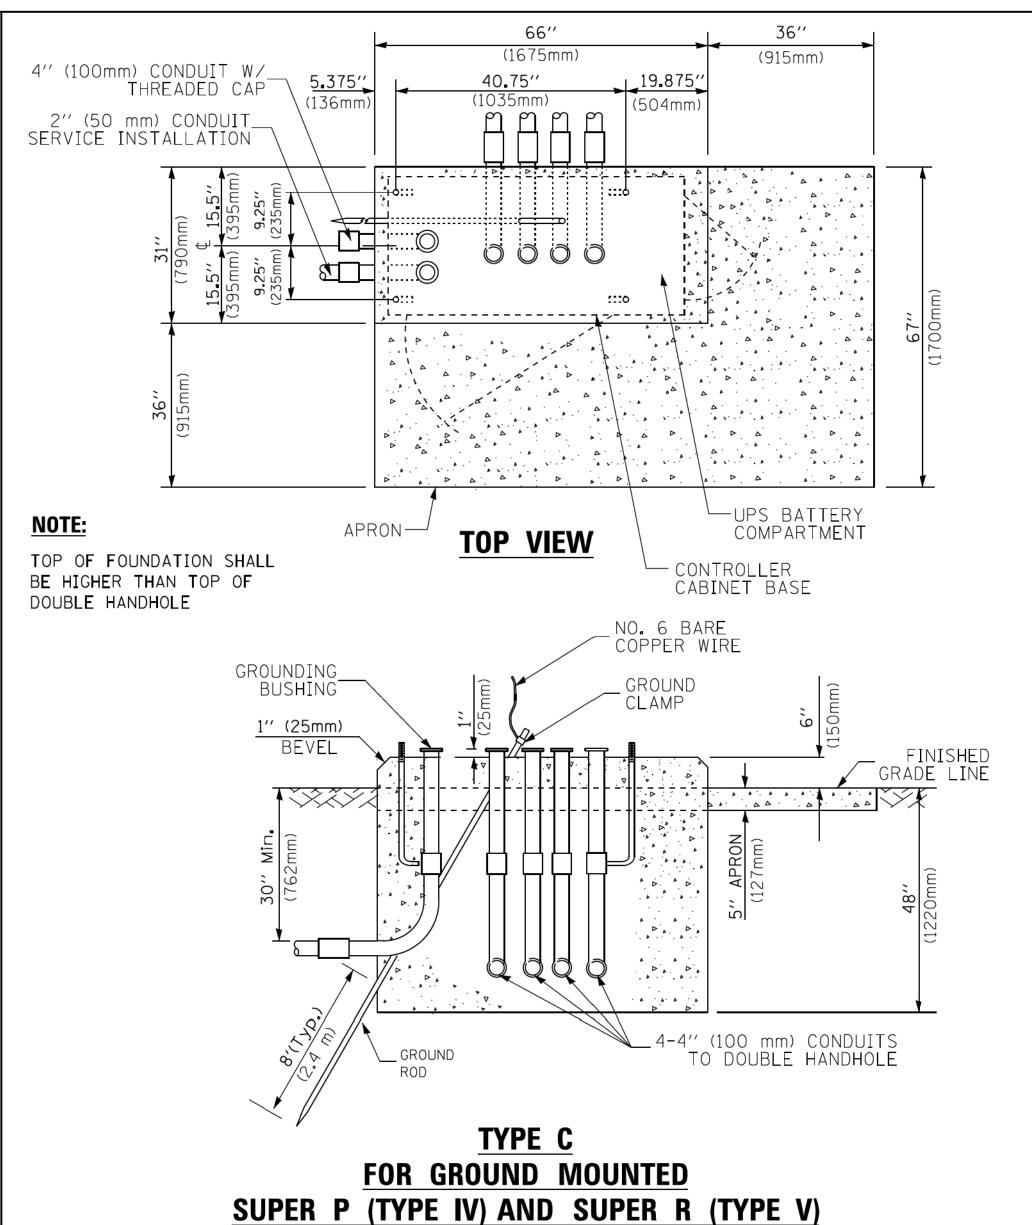

CONTROLLER CABINETS

SEE NOTE 5- $2'' \times 6''$ (51mm × 152mm) WOOD FRAMING (TYP.) TRAFFIC SIGNAL --CONTROLLER CABINET CABINET 3/4" (19mm) TREATED PHYWOOD DECK TREATED WOOD POSTS 1. BASED ON CONTROLLER CABINET TYPE IV WITH BASE DIMENSIONS OF 26" x 44" (660mm x 1118mm). ADJUST PLATFORM SIZE TO FIT CABINET BASE DIMENSIONS BEING SUPPLIED

- 2. BASED ON UNINTERRUPTIBLE POWER SUPPLY CABINET WITH BASE DIMENSIONS OF $16'' \times 25''$ (406mm \times 635mm). ADJUST PLATFORM SIZE TO FIT CABINET BASE DIMENSIONS BEING SUPPLIED.
- 3. PLATFORM SIZE FOR CONTROLLER CABINET TYPE IV.
- 4. PLATFORM SIZE FOR CONTROLLER CABINET TYPE IV AND UNINTERRUPTIBLE POWER SUPPLY CABINET.
- 5. DRILLED HOLES THROUGH THE PLATFORM BASE TO MATCH THE CONTROLLER CABINET BOLT TEMPLATE. FASTEN THE CONTROLLER CABINET TO THE PLATFORM WITH CARRIAGE BOLTS, WASHERS AND NUTS.
- 6. FASTEN ALL SUPPORT WOOD FRAMING TO THE WOOD POSTS WITH 2 LAG SCREWS FOR EACH CONNECTION...

TEMPORARY SIGNAL CONTROLLER **WOOD SUPPORT PLATFORM**

	1	
CABLE SLACK LENGTH	FEET	METER
HANDHOLE	6.5	2.0
DOUBLE HANDHOLE	13.0	4.0
SIGNAL POST	2.0	0.6
MAST ARM	2.0	0.6
CONTROLLER CABINET	1.5	0.5
FIBER OPTIC AT CABINET	13.0	4.0
ELECTRIC SERVICE AT (CABINET OR SERVICE LOCATION)	1.5	0.5
GROUND CABLE (SIGNAL POST, MAST ARM, CABINET)	1.5	0.5
GROUND CABLE (BETWEEN FRAME AND COVER)	5.0	1.6

VERTICAL CABLE LENGTH	FEET	METER
MAST ARM POLE (MAST ARM MOUNTED SIGNAL HEAD)		
(L = MAST ARM LENGTH - DISTANCE TO SIGNAL HEAD FROM END OF ARM)	20 . 0+L	6.0+L
BRACKET MOUNTED (MAST ARM POLE OR SIGNAL POLE)	13.0	4.0
PEDESTRIAN PUSH BUTTON	6.0	2.0
SERVICE INSTALLATION POLE MOUNT TO SERVICE DROP	13.5	4.1
SERVICE INSTALLATION POLE MOUNT TO GROUND	13.5	4.1
SERVICE INSTALLATION GROUND MOUNT	6.0	2.0
FOUNDATION (SIGNAL POST, MAST ARM POLE, CONTROLLER CABINET, SERVICE-GROUND MOUNT)	3.0	1 . O

VERTICAL CABLE LENGTH

CABLE SLACK

METER	FOUNDATION
	TYPE A - Signal Post
6 . 0+L	TYPE C - CONTROLLER W/ UPS
4.0	TYPE D - CONTROLLER
2.0	SERVICE INSTALLATION,
4.1	GROUND MOUNT,
4.1	TYPE A - SQUARE
2.0	
1 0	

DEPTH OF FOUNDATION

Mast Arm Length	① Foundation Depth	Foundation Diameter	Spiral Diameter	Quantity of Rebars	Size of Rebars
Less than 30′ (9.1 m)	10'-0" (3 . 0 m)	30'' (750mm)	24" (600mm)	8	6(19)
Greater than or equal to	13′-6′′ (4∎1 m)	30'' (750mm)	24" (600mm)	8	6(19)
30' (9.1 m) and less than 40' (12.2 m)	11'-0'' (3₌4 m)	36" (900mm)	30'' (750mm)	12	7(22)
Greater than or equal to 40' (12.2 m) and less than 50' (15.2 m)	13'-0" (4.0 m)	36'' (900mm)	30" (750mm)	12	7(22)
Greater than or equal to 50' (15.2 m) and up to 55' (16.8 m)	15'-0'' (4 . 6 m)	36'' (900mm)	30'' (750mm)	12	7(22)
Greater than or equal to 56' (16.8 m) and less than 65' (19.8 m)	21'-0'' (6.4 m)	42'' (1060mm)	36" (900mm)	16	8(25)
Greater than or equal to 65' (19.8 m) and up to 75' (22.9 m)	25'-0" (7 . 6 m)	42'' (1060mm)	36" (900mm)	16	8(25)

DEPTH


4'-0" (1.2m)

4'-0" (1₂m) 4'-0" (1.2m) 4'-0" (1₂m)

- 1. These foundation depths are for sites which have cohesive soils (clayey silt, sandy clay, etc.) along the length of the shaft, with an average Unconfined Compressive Strength (Qu) > 1.0 tsf (100 kpa). This strength shall be verified by boring data prior to construction or with testing by the Engineer during foundation drilling. The Bureau of Bridges & structures should be contacted for a revised design if other conditions are encountered.
- 2. Combination mast arm assemblies under 55 feet (16.8 m) shall use 36" (900 mm) diameter foundations.
- 3. Combination mast arm assemblies under 56 feet (16.8 m) through 75 feet (22.9 m) shall use 42" (1060 mm)
- 4. For mast arm assemblies with dual arms refer to state standard 878001...

DEPTH OF MAST ARM FOUNDATIONS, TYPE E


FILE NAME =	USER NAME = footemj	DESIGNED - DAG	REVISED - DAG 1-1-14	·		DISTRICT ONE	F.A.U. RTE.	SECTION	COUNTY TOTAL SHEET SHEETS NO.
c:\pw_work\pw1dot\footemj\d0108315\ts05	dgn	DRAWN - BCK	REVISED -	STATE OF ILLINOIS			2611	19-00161-00-RS	DUPAGE 67 49
	PLOT SCALE = 50.0000 ' / in.	CHECKED - DAD	REVISED -	DEPARTMENT OF TRANSPORTATION		STANDARD TRAFFIC SIGNAL DESIGN DETAILS		TS-05	CONTRACT NO. 61G29
	PLOT DATE = 1/13/2014	DA TE - 10-28-09	REVISED -		SCALE: NONE	SHEET NO. 5 OF 7 SHEETS STA. TO STA.	FED. ROAD	DIST. NO. 1 ILLINOIS FED. A	ID PROJECT

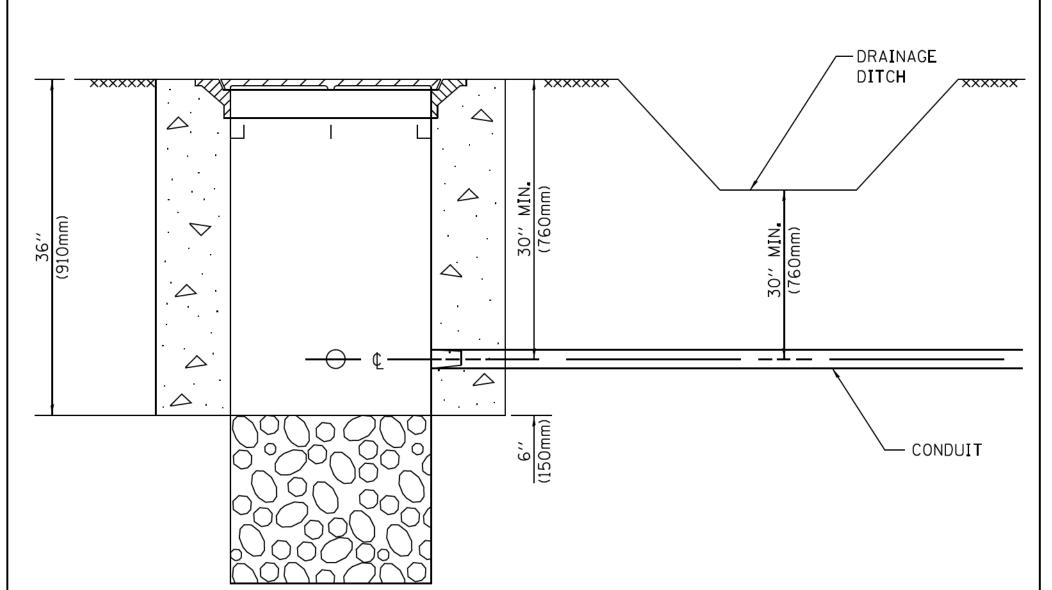



NOTES:

- 1. CONDUIT DEPTH SHALL BE A MINIMUM OF 30" (760mm) BELOW THE BOTTOM OF THE DRAINAGE DITCH OR ANY SLOPING GROUND
- 2. THE MINIMUM CONDUIT DEPTH APPLIES TO ALL CONDUIT PLACED UNDER ROADWAY PAVEMENT, MULTI-USE PATHS, SIDEWALKS AND SOIL SURFACES.
- 3. THE MINIMUM CONDUIT DEPTH APPLIES TO ALL HANDHOLES, HEAVY DUTY HANDHOLES AND DOUBLE HANDHOLES.

HANDHOLE WITH MINIMUM CONDUIT DEPTH (NOT TO SCALE)

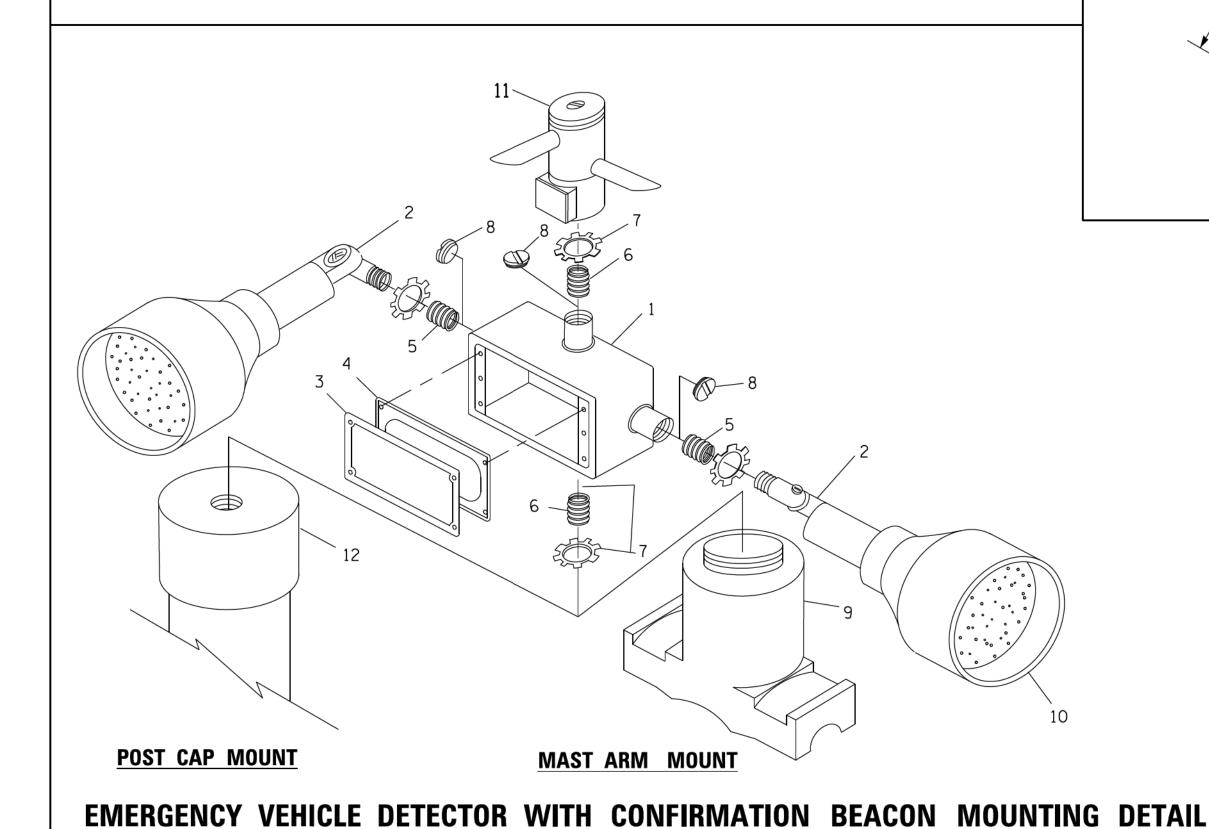

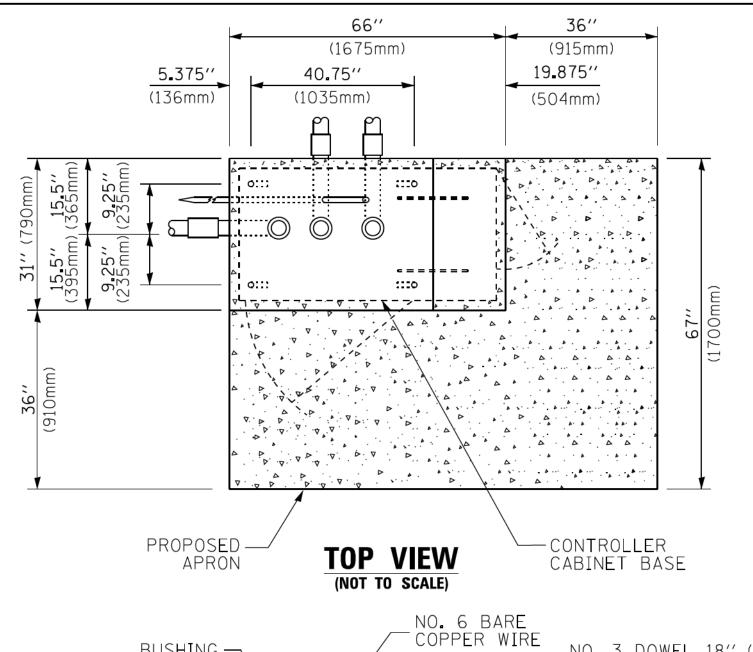

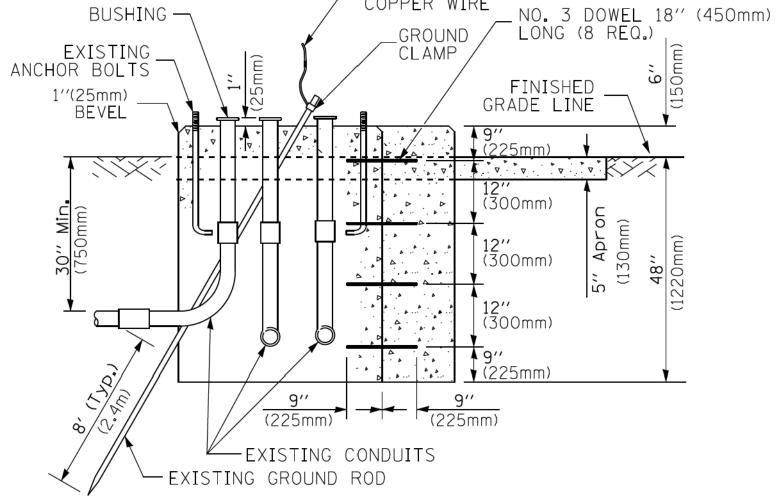

MODIFY EXISTING TYPE "D" FOUNDATION TO TYPE "C" FOUNDATION


(NOT TO SCALE)

ITEM	NO. IDENTIFICATION
1	OUTLET BOX- GALV. 21 CU.IN. (0.000344 CU-M)
2	LAMP HOLDER AND COVER
3	OUTLET BOX COVER
4	RUBBER COVER GASKET
5	REDUCING BUSHING
6	¾''(19 mm) CLOSE NIPPLE
7	³ ∕ ₄ ′′(19 mm) LOCKNUT
8	3/4''(19 mm) HOLE PLUG
9	SADDLE BRACKET - GALV.
10	6 WATT PAR 38 LED FLOOD LAMP
11	DETECTOR UNIT
12	POST CAP [18 FT. (5.4 m) POST MIN.]

NOTES:

- 1. ALL ELECTRICAL ITEMS, EXCEPT ITEMS #2 AND #11 SHALL BE ALUMINUM OR GALVANIZED
- 2. ITEM #1- OZ/GEDNEY FSX-1-50 OR EQUIVALENT

 ITEM #2- MULBERRY CON-O-SHADE LAMP SHIELD OR EQUIVALENT
- 3. WHEN POST MOUNTING IS SPECIFIED, ITEM *9 SHALL NOT BE REQUIRED. THE DETECTION UNIT SHALL BE MOUNTED DIRECTLY ON TOP OF THE CAP BY DRILLING AND TAPPING A 3/4 "(19 mm) HOLE WITH PIPE THREADS. THE POST CAP SHALL EITHER BE SCREWED TO THE TOP OF THE POST OR A MINIMUM OF 3 TIGHTENING SCREWS SHALL BE REQUIRED ON EACH CAP.

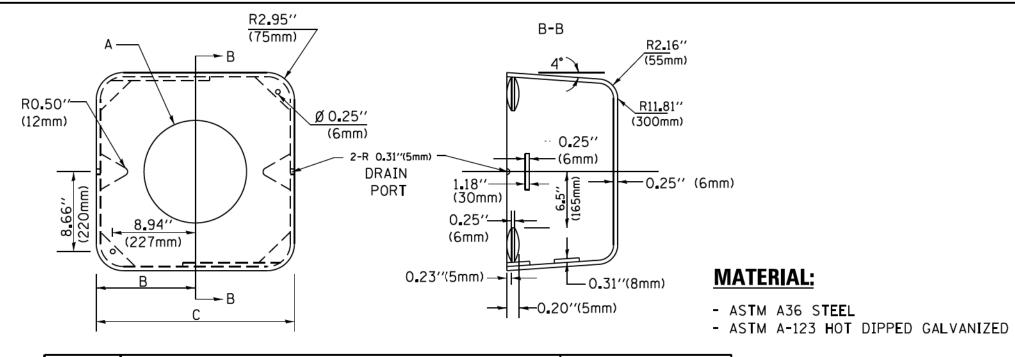


А	В	С	HEIGHT	WEIGHT
VARIES	9 . 5′′(241mm)	19''(483mm)	7" (178mm) - 12" (300mm)	53 lbs (24kg)
VARIES	10.75′′(273mm)	21.5"(546mm)	7" (178mm) - 12" (300mm)	68 lbs (31 kg)
VARIES	13 . 0''(330mm)	26''(660mm)	7" (178mm) - 12" (300mm)	81 lbs (37 kg)
VARIES	18 . 5′′(470mm)	37''(940mm)	7" (178mm) - 12" (300mm)	126 lbs (57 kg)

SHROUD

NOTES:

- 1. DIMENSION "A" IS EQUAL TO THE DIAMETER OF THE MAST ARM POLE AT THE TOP OF THE SHROUD. THE SHROUD SHALL BE TIGHT TO THE MAST ARM POLE.
- 2. THE SUPPLIER SHALL VERIFIED THE ABOVE DIMENSIONS BASED ON MAST ARM REQUIREMENTS.
- 3. THE HEIGHT OF THE SHROUD SHALL COVER THE ANCHOR BOLTS, NUTS AND MAST ARM POLE BASE.

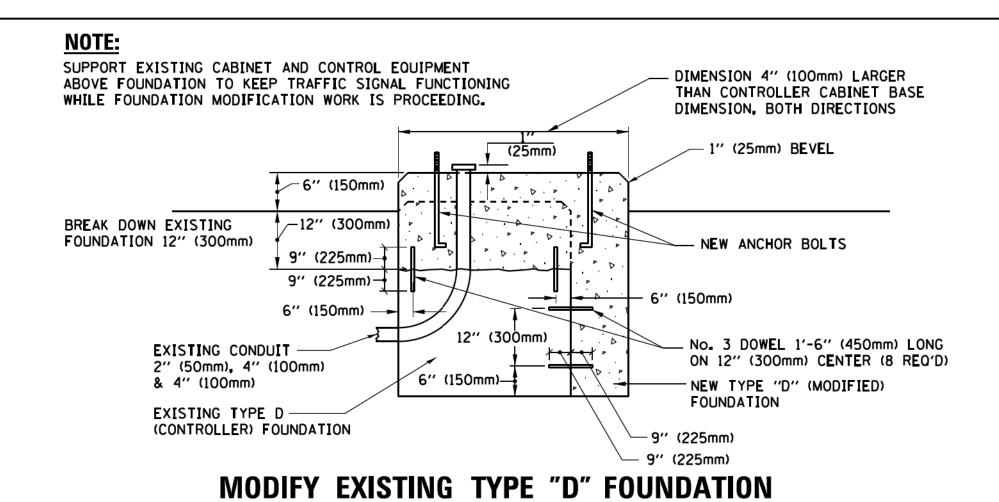

CALVANIZED STEEL HOOKS 21 1/2" MIN. (545mm) CONDUIT BUSHING EXISTING CONDUIT TO BE REMOVED CONDUIT TO REMAIN EXISTING CONDUIT TO REMAIN PLAN ELEVATION

NOTES:


SCALE: NONE


- 1. HANDHOLE CONSTRUCTED PER STATE STANDARD 814001.
- 2. REMOVAL OF THE EXISTING CONDUIT FROM THE HANDHOLE AND THE INSTALLATION OF THE CONDUIT BUSHINGS SHALL BE INCLUDED WITH THE COST OF THE HANDHOLE.

HANDHOLE TO INTERCEPT EXISTING CONDUIT

FILE NAME =	USER NAME = footemj	DESIGNED	-	DAD	REVISED	- DAG 1-1-14	Γ
c:\pw_work\pwidot\footemj\d0108315\ts05.	dgn	DRAWN	-	BCK	REVISED	-	
	PLOT SCALE = 50.0000 '/ in.	CHECKED	-	DAD	REVISED	-]
	PLOT DATE = 1/13/2014	DATE	-	10-28-09	REVISED	-	1

STATE OF ILLINOIS
DEPARTMENT OF TRANSPORTATION

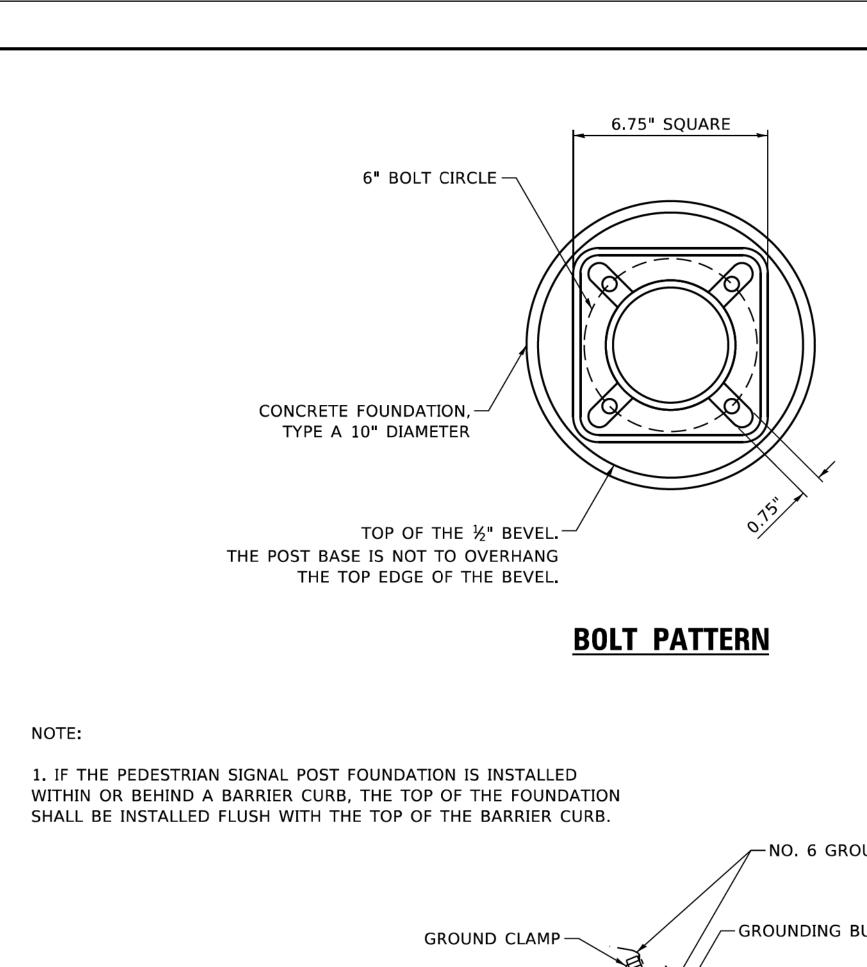

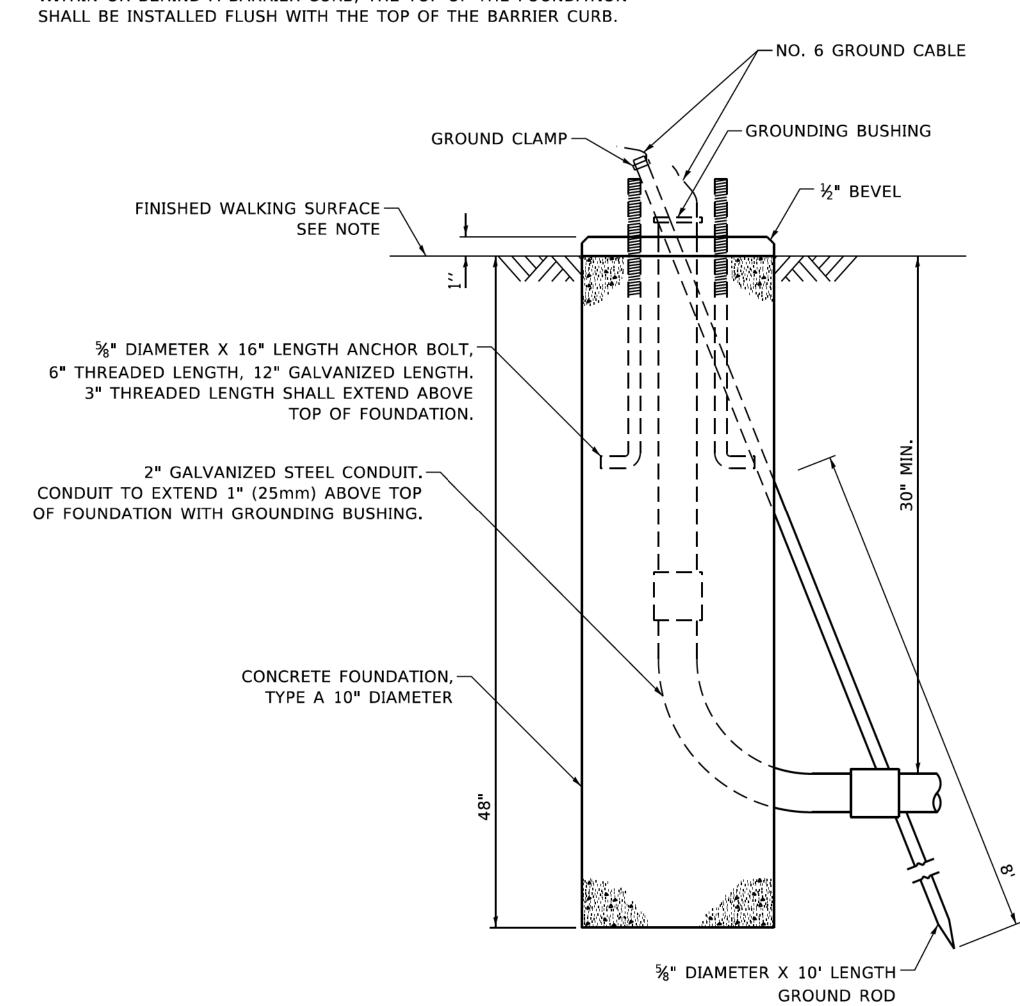



AS

OJT

JJE

12/17/2019

DESIGNED -

CHECKED -

DRAWN

USER NAME = plascenciai

PLOT SCALE = 100.0000 ' / in.

PEDESTRIAN PUSH-BUTTON POST, SPECIAL

— PEDESTRIAN SIGNAL HEAD

- COUNTDOWN PEDESTRIAN SIGNAL HEADS ARE NOT TO BE USED AT RAILROAD INTERSECTIONS

ALUMINUM OR-

ALUMINUM-

STATION

PEDESTRIAN PUSH-BUTTON

GALVANIZED STEEL POST, 4.5" OUTSIDE DIAMETER

CAST IRON GALVANIZED BASE CENTERED ON FOUNDATION

-FINISHED WALKING SURFACE-

DRILLED AND TAPPED GROUNDING HOLE

GALVANIZED STEEL POST CAP

SIGN (SEE SIGN TABLE) -


STATE OF ILLINOIS DEPARTMENT OF TRANSPORTATION	
	SCALE: NTS


PEDESTRIAN POST DETAILS SHEET NO. 1 OF 1 SHEETS STA.

TO STA.

SECTION 19-00161-00-RS DUPAGE 67 CONTRACT NO. 61G29 ILLINOIS FED. AID PROJECT

PUSH BUTTON TO CROSS

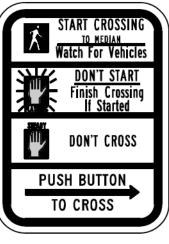

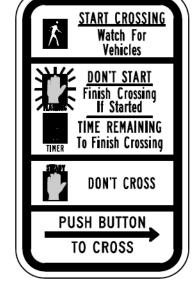

R10-3e

R10-3b

R10-3d

SIGN TABLE

SIGN	DIMENSIONS
R10-3b (RAILROAD ONLY)	9" X 12"
R10-3d (RAILROAD ONLY)	9" X 12"
R10-3e	9" X 15"

NOTES:

- 1. THE SIGN PANELS SHALL BE TYPE AP SHEETING.
- 2. THE ARROW ON SIGNS FOR PUSH-BUTTONS SERVING TWO DIRECTIONS ON THE SAME PHASE SHALL BE BI-DIRECTIONAL.
- 3. THE SIGN FOR DUAL-CALL PUSH-BUTTONS SHALL HAVE NO ARROW.




REVISED -


REVISED

REVISED

REVISED

PEDESTRIAN SIGNAL POST, 10 FT.

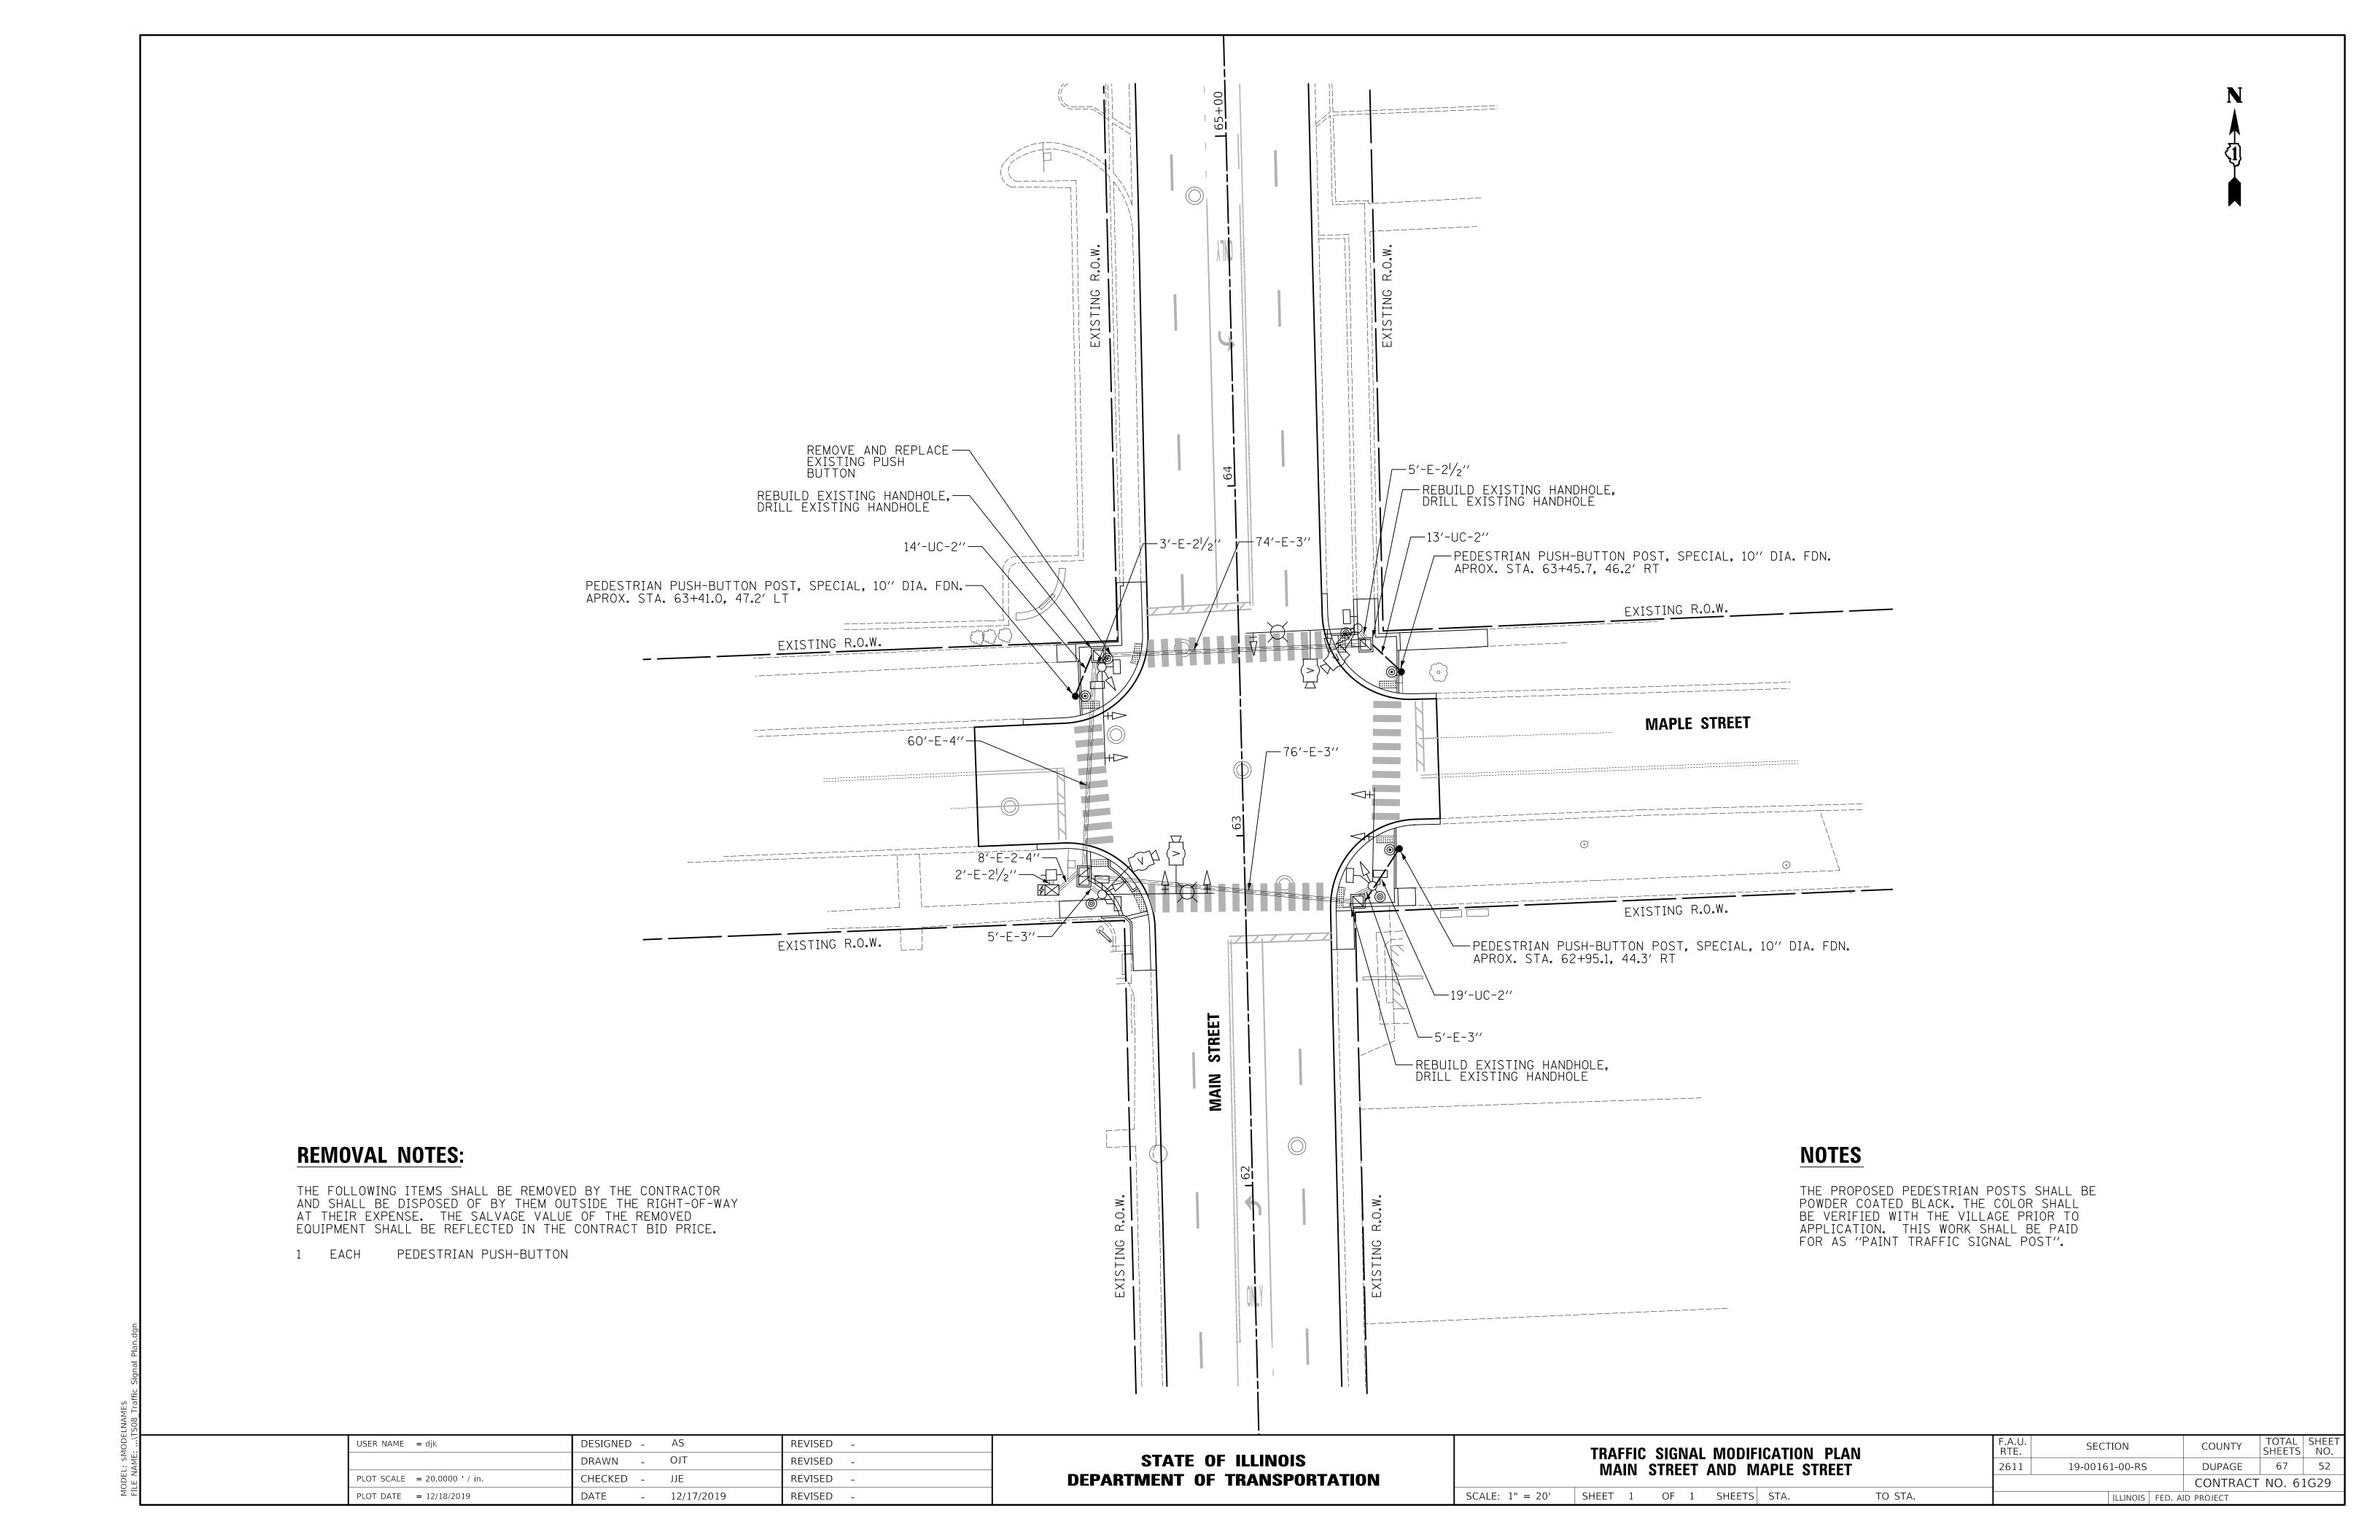


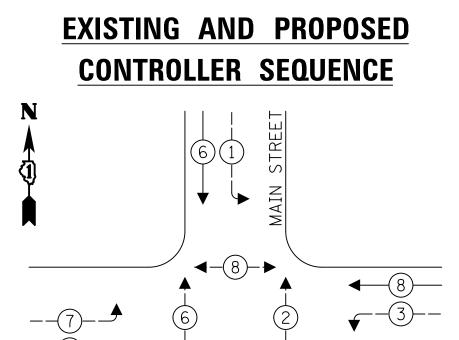

- **◆ * PROTECTED PHASE**
- ←───
 PROTECTED/PERMITTED PHASE
- **◄**—*****→ PEDESTRIAN PHASE
- OL OVERLAP

EXISTING AND PROPOSED EMERGENCY VEHICLE PREEMPTION SEQUENCE

52

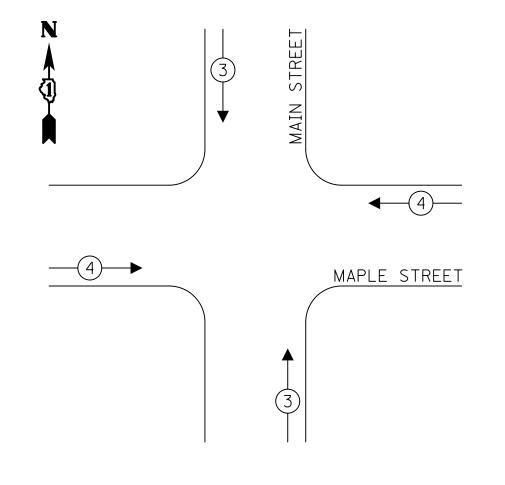

TRAFFIC SIGNAL ELECTRICAL SERVICE REQUIREMENTS

	NO. OF	LED	%	TOTAL
TYPE	LAMPS	WATTAGE	OPERATION	WATTAGE
SIGNAL (RED)	12	17	50	102
(YELLOW)	12	25	5	15
(GREEN)	12	15	45	81
PERMISSIVE ARROW	16	12	10	19.2
PED. SIGNAL	8	25	100	200
CONTROLLER	1	100	100	100.0
UPS	1	25	100	25
VIDEO SYSTEM	1	150	100	150
BLANK-OUT SIGN	_	25	5	_
FLASHER	_	_	50	_
STREET NAME SIGN	_	120	50	_
LUMINAIRE	-	_	-	-
			TOTAL =	692.2

ENERGY COSTS TO:

VILLAGE OF LOMBARD
1051 HAMMERSCHMIDT AVE


LOMBARD, IL 60148

ENERGY SUPPLY: CONTACT: NEW BUSINESS

PHONE: (866) 639-3532 COMPANY: COMED

COMPANY: COMED

ACCOUNT NUMBER: ---

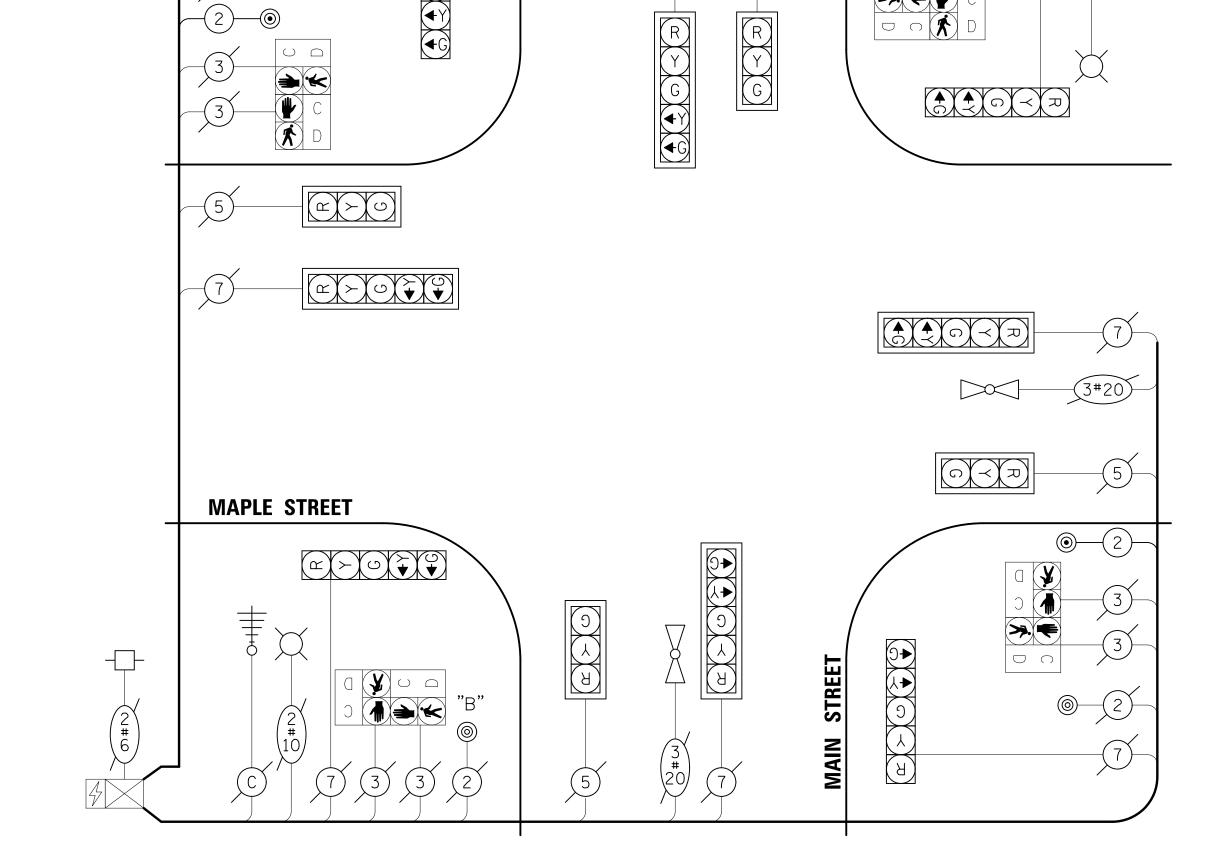

NOTES

1. THE MODIFICATIONS TO THE EXISTING CONTROLLER TO ACCOMMODATE THE CHANGE FROM THE EXISTING NON-LATCHING PUSH-BUTTONS TO THE PROPOSED LATCHING PUSH-BUTTONS ON THE NORTHEAST, NORTHWEST, AND SOUTHEAST CORNERS SHALL BE PAID AS "MODIFY EXISTING CONTROLLER".

CABLE PLAN (NOT TO SCALE)

NOTES

PUSH-BUTTON "B" SHALL PLACE A CALL TO PHASES 4 & 6


SCHEDULE OF QUANTITIES

PAY ITEM	UNIT	QNTY.
UNDERGROUND CONDUIT, GALVANIZED STEEL, 2" DIA.	FOOT	46
MAINTENANCE OF EXISTING TRAFFIC SIGNAL INSTALLATION	EACH	1
PAINT NEW TRAFFIC SIGNAL POST	EACH	3
ELECTRIC CABLE IN CONDUIT, SIGNAL NO. 14 2C	FOOT	452
ELECTRIC CABLE IN CONDUIT, EQUIPMENT GROUNDING CONDUCTOR, NO. 6 1C	FOOT	64
DRILL EXISTING HANDHOLE	EACH	3
PEDESTRIAN PUSH-BUTTON	EACH	4
MODIFY EXISTING CONTROLLER	EACH	1
REMOVE EXISTING TRAFFIC SIGNAL EQUIPMENT	EACH	1
CONCRETE FOUNDATION, TYPE A 10-INCH DIAMETER	FOOT	12
PEDESTRIAN PUSH-BUTTON POST, SPECIAL	EACH	3

USER NAME = djk	DESIGNED - AS	REVISED -		CABLE PLAN, PHASE DESIGNATION DIAGRAM, EMERGENCY VEHICLE	F.A.U. RTE.	SECTION	COUNTY	TOTAL SHEETS	SHEET NO.
	DRAWN - OJT	REVISED -	STATE OF ILLINOIS	PREEMPTION SEQUENCE, AND SCHEDULE OF QUANTITIES	2611	19-00161-00-RS	DUPAGE	67	53
PLOT SCALE = 20.0000 ' / in.	CHECKED - JJE	REVISED -	DEPARTMENT OF TRANSPORTATION	MAIN STREET AND MAPLE STREET			CONTRAC	T NO. 61	.G29
PLOT DATE = $12/18/2019$	DATE - 12/17/2019	REVISED -		SCALE: NONE SHEET 1 OF 1 SHEETS STA. TO STA.		ILLINOIS	FED. AID PROJECT		

NOTES

- 1. INSTALL 3" GALVANIZED STEEL CONDUIT UNDER PARKSIDE AVENUE. INSTALL UNIT DUCT, 600V, 4-1/C NO. 6 (XLP-TYPE USE), $1\frac{1}{4}$ " DIA. POLYETHELENE (BLACK, RED, WHITE, GREEN) FROM EXISTING LIGHT POLE ON SOUTHEAST QUADRANT TO NORTHERNMOST EXISTING HANDHOLE ON THE NORTHEAST QUADRANT. CONTRACTOR SHALL PROVIDE SUFFICIENT SLACK IN THE HANDHOLE TO MAKE THE CONNECTION TO THE PROPOSED COMBINATION MAST ARM ASSEMBLY AND POLE AS SHOWN ON THE TRAFFIC SIGNAL MODIFICATION PLAN.
- 2. DISCONNECT LIGHTING CABLES FROM THE EXISTING COMBINATON MAST ARM ASSEMBLY AND POLE ON THE NOTHEAST QUADRANT. PULL LIGHTING CABLES TO NORTHERNMOST EXISTING HANDHOLE ON NORTHEAST QUADRANT.
- 3. SPLICE LIGHTING CABLES IN NORTHERNMOST HANDHOLE TO MAINTAIN LIGHTING SYSTEM ALONG PARKSIDE AVENUE (RED = RED, ORANGE, BLUE; BLACK = BROWN, BLACK).
- 4. INSTALL TEMPORARY TRAFFIC SIGNAL. CONNECT NORTHEAST WOOD POLE TO NORTHERNMOST EXISTING HANDHOLE ON NORTHEAST QUADRANT AND NORTHWEST WOOD POLE TO EXISTING DOUBLE HANDHOLE ON NORTHWEST QUADRANT. COILABLE NONMETALLIC CONDUIT AND DRILL EXISTING HANDHOLE SHALL BE INCLUDED IN THE COST OF "TEMPORARY TRAFFIC SIGNAL INSTALLATION (SPECIAL).
- TEMPORARY LUMINAIRE ON NORTHEAST WOOD POLE SHALL BE 200 WATT. SPLICE LIGHTING CABLES FOR TEMPORARY LUMINAIRE TO LIGHTING CABLES IN EXISTING HANDHOLE. THIS WORK SHALL BE INCLUDED IN THE COST OF "TEMPORARY TRAFFIC SIGNAL INSTALLATION (SPECIAL)".
- 6. WATERPROOF SPLICE KIT SHALL BE USED FOR TEMPORARY SPLICING OF EXISTING AND PROPOSED CONDUCTORS IN THE HANDHOLE.
- 7. THE EXISTING VIDEO VEHICLE DETECTORS ON THE EXISTING COMBINATION MAST ARM ASSEMBLY AND POLE SHALL BE REMOVED AND RELOCATED TO THE NORTHEAST WOOD POLE FOR USE WITH THE TEMPORARY TRAFFIC SIGNAL.
- 8. THE TEMPORARY SPAN MOUNTED TRAFFIC SIGNAL HEADS, TEMPORARY PEDESTRIAN SIGNAL ON THE NORTHEAST WOOD POLE, AND RELOCATED VIDEO VEHICLE DETECTORS SHALL BE CONNECTED TO THE EXISTING TRAFFIC SIGNAL CONTROLLER THROUGH THE CONNECTION FROM NORTHWEST WOOD POLE TO THE EXISTING DOUBLE HANDHOLE. ALL OTHER EQUIPMENT AT THE INTERSECTION WILL CONTINUE TO FUNCTION NORMALLY THROUGH EXISTING CABLES AND CONDUITS.

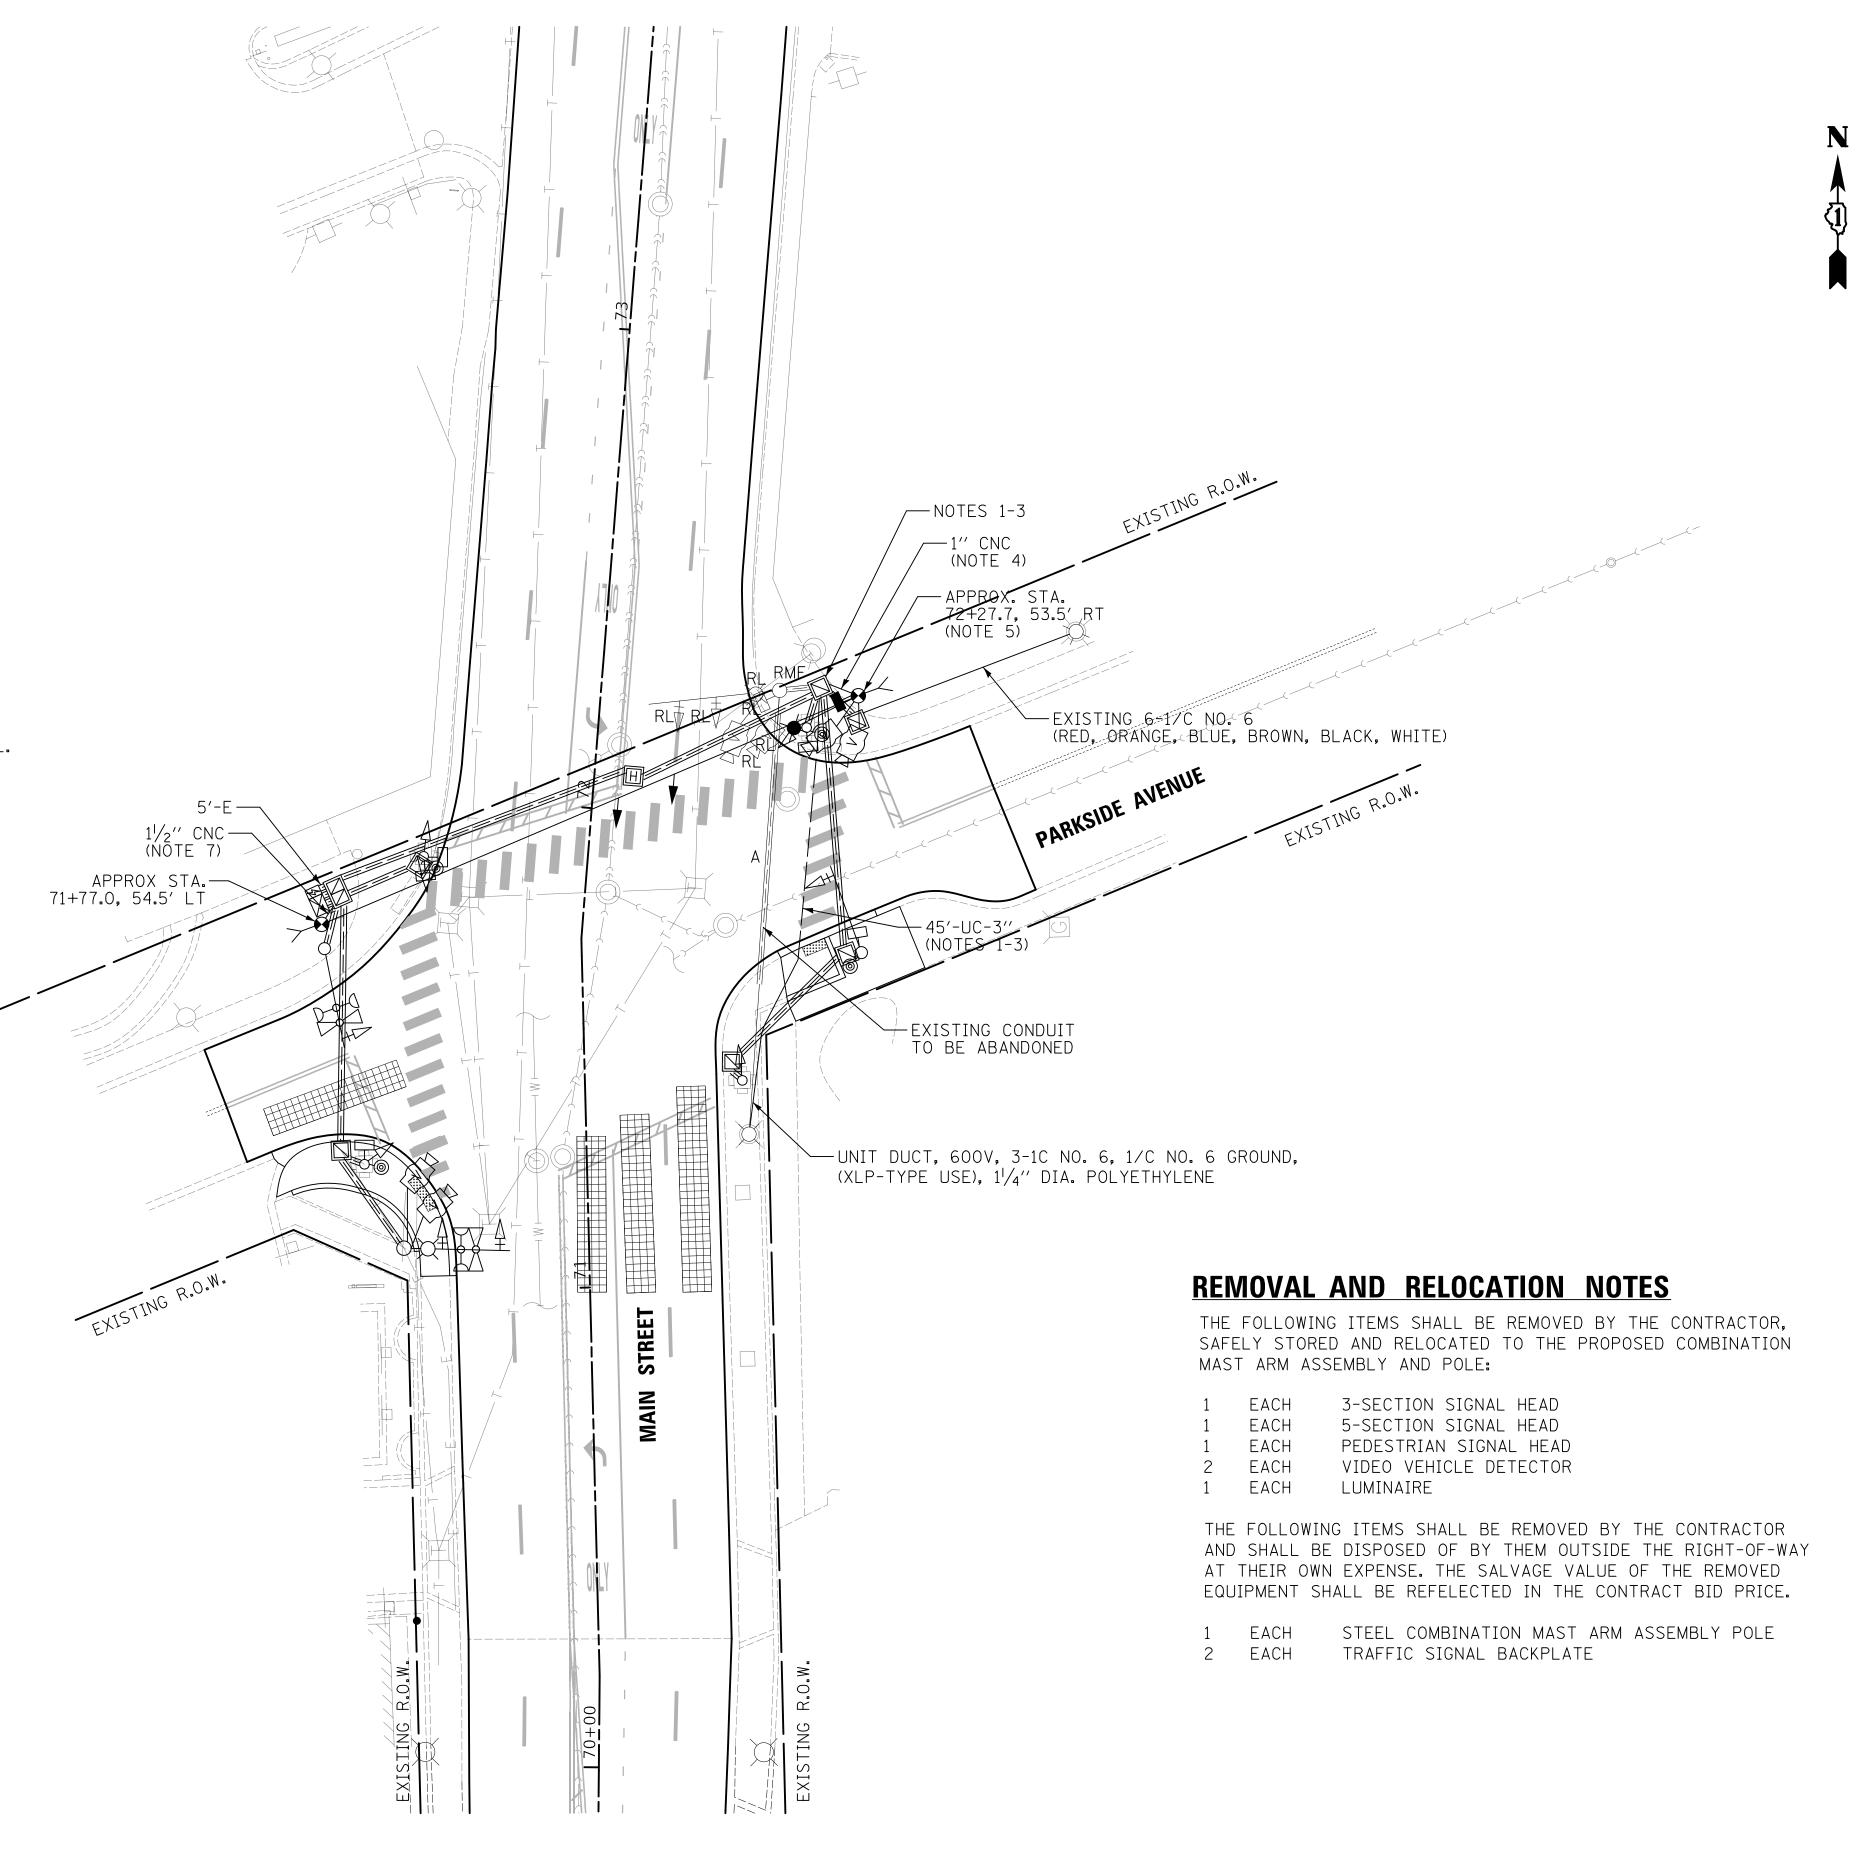


USER NAME = djk	DESIGNED -	AS	REVISED -
	DRAWN -	OJT	REVISED -
PLOT SCALE = 20.0000 ' / in.	CHECKED -	JJE	REVISED -
PLOT DATE = 12/18/2019	DATE -	12/17/2019	REVISED -

STATE OF ILLINOIS DEPARTMENT OF TRANSPORTATION

TEMPORARY TRAFFC SIGNAL INS	F.A.U. RTE.	SECTION	COUNTY	TOTAL SHEETS	SHEET NO.		
AND REMOVE EXISTING TRAFFIC SIG	2611	19-00161-00-RS	DUPAGE	67	54		
MAIN STREET AND PARKS	<u>IDE AVENUE</u>				CONTRACT	NO. 6	1G29
SCALE: NONE SHEET 1 OF 1 SHEE	TS STA.	TO STA.		ILLINOIS FED.	AID PROJECT		

EXISTING AND PROPOSED CONTROLLER SEQUENCE

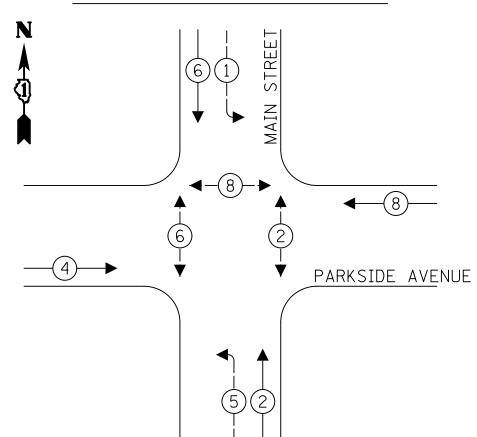

LEGEND:


◆ * PROTECTED PHASE

◆-(*)-- PROTECTED/PERMITTED PHASE

◄—*****→ PEDESTRIAN PHASE

OVERLAP OVERLAP

EXISTING AND PROPOSED EMERGENCY VEHICLE PREEMPTION SEQUENCE

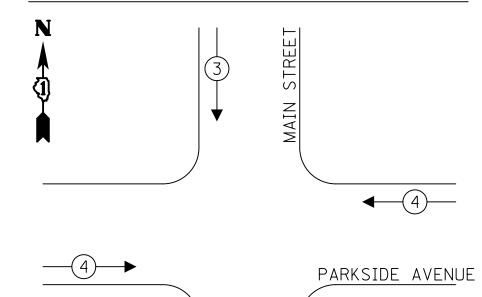

TRAFFIC SIGNAL ELECTRICAL SERVICE REQUIREMENTS

	NO. OF	LED	",	TOTAL
TYPE	LAMPS	WATTAGE	OPERATION	WATTAGE
SIGNAL (RED)	11	17	50	93.5
(YELLOW)	11	25	5	13.75
(GREEN)	11	15	45	74.25
PERMISSIVE ARROW	8	12	10	9.60
PED. SIGNAL	6	25	100	150.0
CONTROLLER	1	100	100	100.0
UPS	1	25	100	25.0
VIDEO SYSTEM	1	150	100	150.0
BLANK-OUT SIGN	_	25	5	_
FLASHER	_	_	50	_
STREET NAME SIGN	_	120	50	_
LUMINAIRE	_	_	_	_
			TOTAL =	616.1

ENERGY COSTS TO:

VILLAGE OF LOMBARD
1051 HAMMERSCHMIDT AVE

LOMBARD, IL 60148

ENERGY SUPPLY: CONTACT: NEW BUSINESS

PHONE: (866) 639-3532

PLOT SCALE = 20.0000 ' / in.

PLOT DATE = 12/18/2019

COMPANY: COMED ACCOUNT NUMBER: ---

USER NAME = djk DESIGNED - AS REVISED DRAWN - OJT REVISED -

CHECKED -

DATE

JJE

- 12/17/2019

REVISED

REVISED -

STATE OF ILLINOIS DEPARTMENT OF TRANSPORTATION

TEMPORARY CABLE PLAN, PHASE DESIGNATION DIAGRAM, EMERGENCY VEHICLE PREEMPTION SEQUENCE, AND SCHEDULE OF QUANTITIES


MAIN STREET AND PARKSIDE AVENUE

SCALE: NONE SHEET 1 OF 1 SHEETS STA. TO STA.

F.A.U. RTE. SECTION COUNTY TOTAL SHEET NO.

2611 19-00161-00-RS DUPAGE 67 55

CONTRACT NO. 61G29

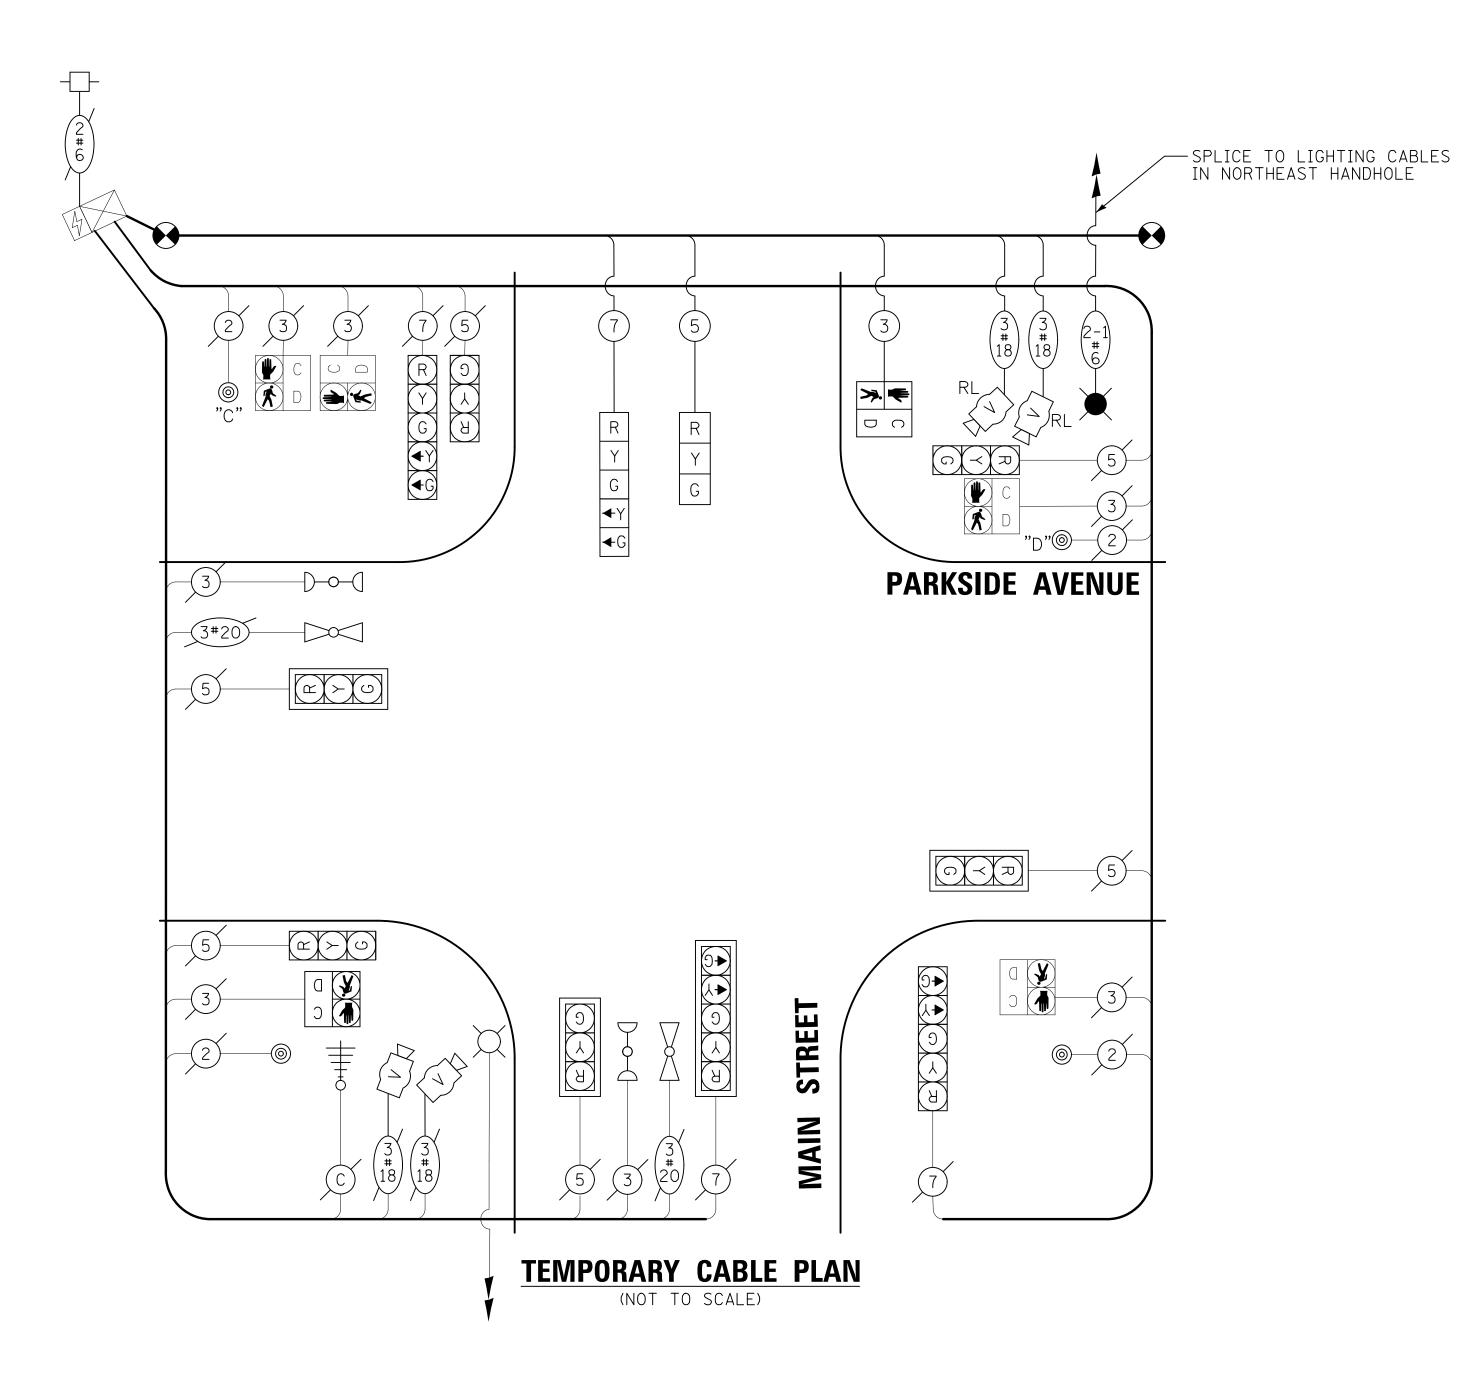


NOTES

PUSHBUTTON C SHALL PLACE A CALL TO PHASES 6 & 8 PUSHBUTTON D SHALL PLACE A CALL TO PHASES 2 & 8

NOTES

- 1. INSTALL 3" GALVANIZED STEEL CONDUIT UNDER PARKSIDE AVENUE. INSTALL UNIT DUCT, 600V, 4-1/C NO. 6 (XLP-TYPE USE), 1/4" DIA. POLYETHELENE (BLACK, RED, WHITE, GREEN) FROM EXISTING LIGHT POLE ON SOUTHEAST QUADRANT TO NORTHERNMOST EXISTING HANDHOLE ON THE NORTHEAST QUADRANT. CONTRACTOR SHALL PROVIDE A SUFFICIENT LENGTH OF SLACK IN THE HANDHOLE TO MAKE THE CONNECTION TO THE PROPOSED COMBINATION MAST ARM ASSEMBLY AND POLE. THIS WORK IS TO BE COMPLETED CONCURRENTLY WITH THE INSTALLATION OF THE TEMPORARY TRAFFIC SIGNAL SO THAT EXISTING LIGHTING IS MAINTAINED THROUGHOUT CONSTRUCTION.
- 2. SPLICE LIGHTING CABLES TO MAINTAIN LIGHTING SYSTEM ALONG PARKSIDE AVENUE (RED = RED, ORANGE, BLUE; BLACK = BROWN, BLACK). FOR THE TEMPORARY CONDITION, THE CABLES SHALL BE SPLICED IN THE HANDHOLE USING A WATERPROOF SPLICE KIT. SEE THE TEMPORARY TRAFFIC SIGNAL INSTALLATION PLAN FOR ADDITIONAL INFORMATION.
- 3. UPON INSTALLATION OF THE PROPOSED COMBINATION MAST ARM ASSEMBLY AND POLE AND REMOVAL OF THE TEMPORARY TRAFFIC SIGNAL, THE LIGHTING CABLES SHALL BE PULLED INTO THE PROPOSED POLE AND SPLICED WITH THE WIRES FOR THE RELOCATED LUMINAIRE IN THE POLE HANDHOLE.
- 4. RELOCATE THE EXISTING VIDEO VEHICLE DETECTORS FROM THE TEMPORARY WOOD POLE TO THE PROPOSED COMBINATION MAST ARM ASSEMBLY AND POLE.
- 5. THE PROPOSED COMBINATION MAST ARM ASSEMBLY AND POLE SHALL BE POWDER COATED BLACK. THE COLOR SHALL BE VERIFIED WITH THE VILLAGE PRIOR TO APPLICATION.

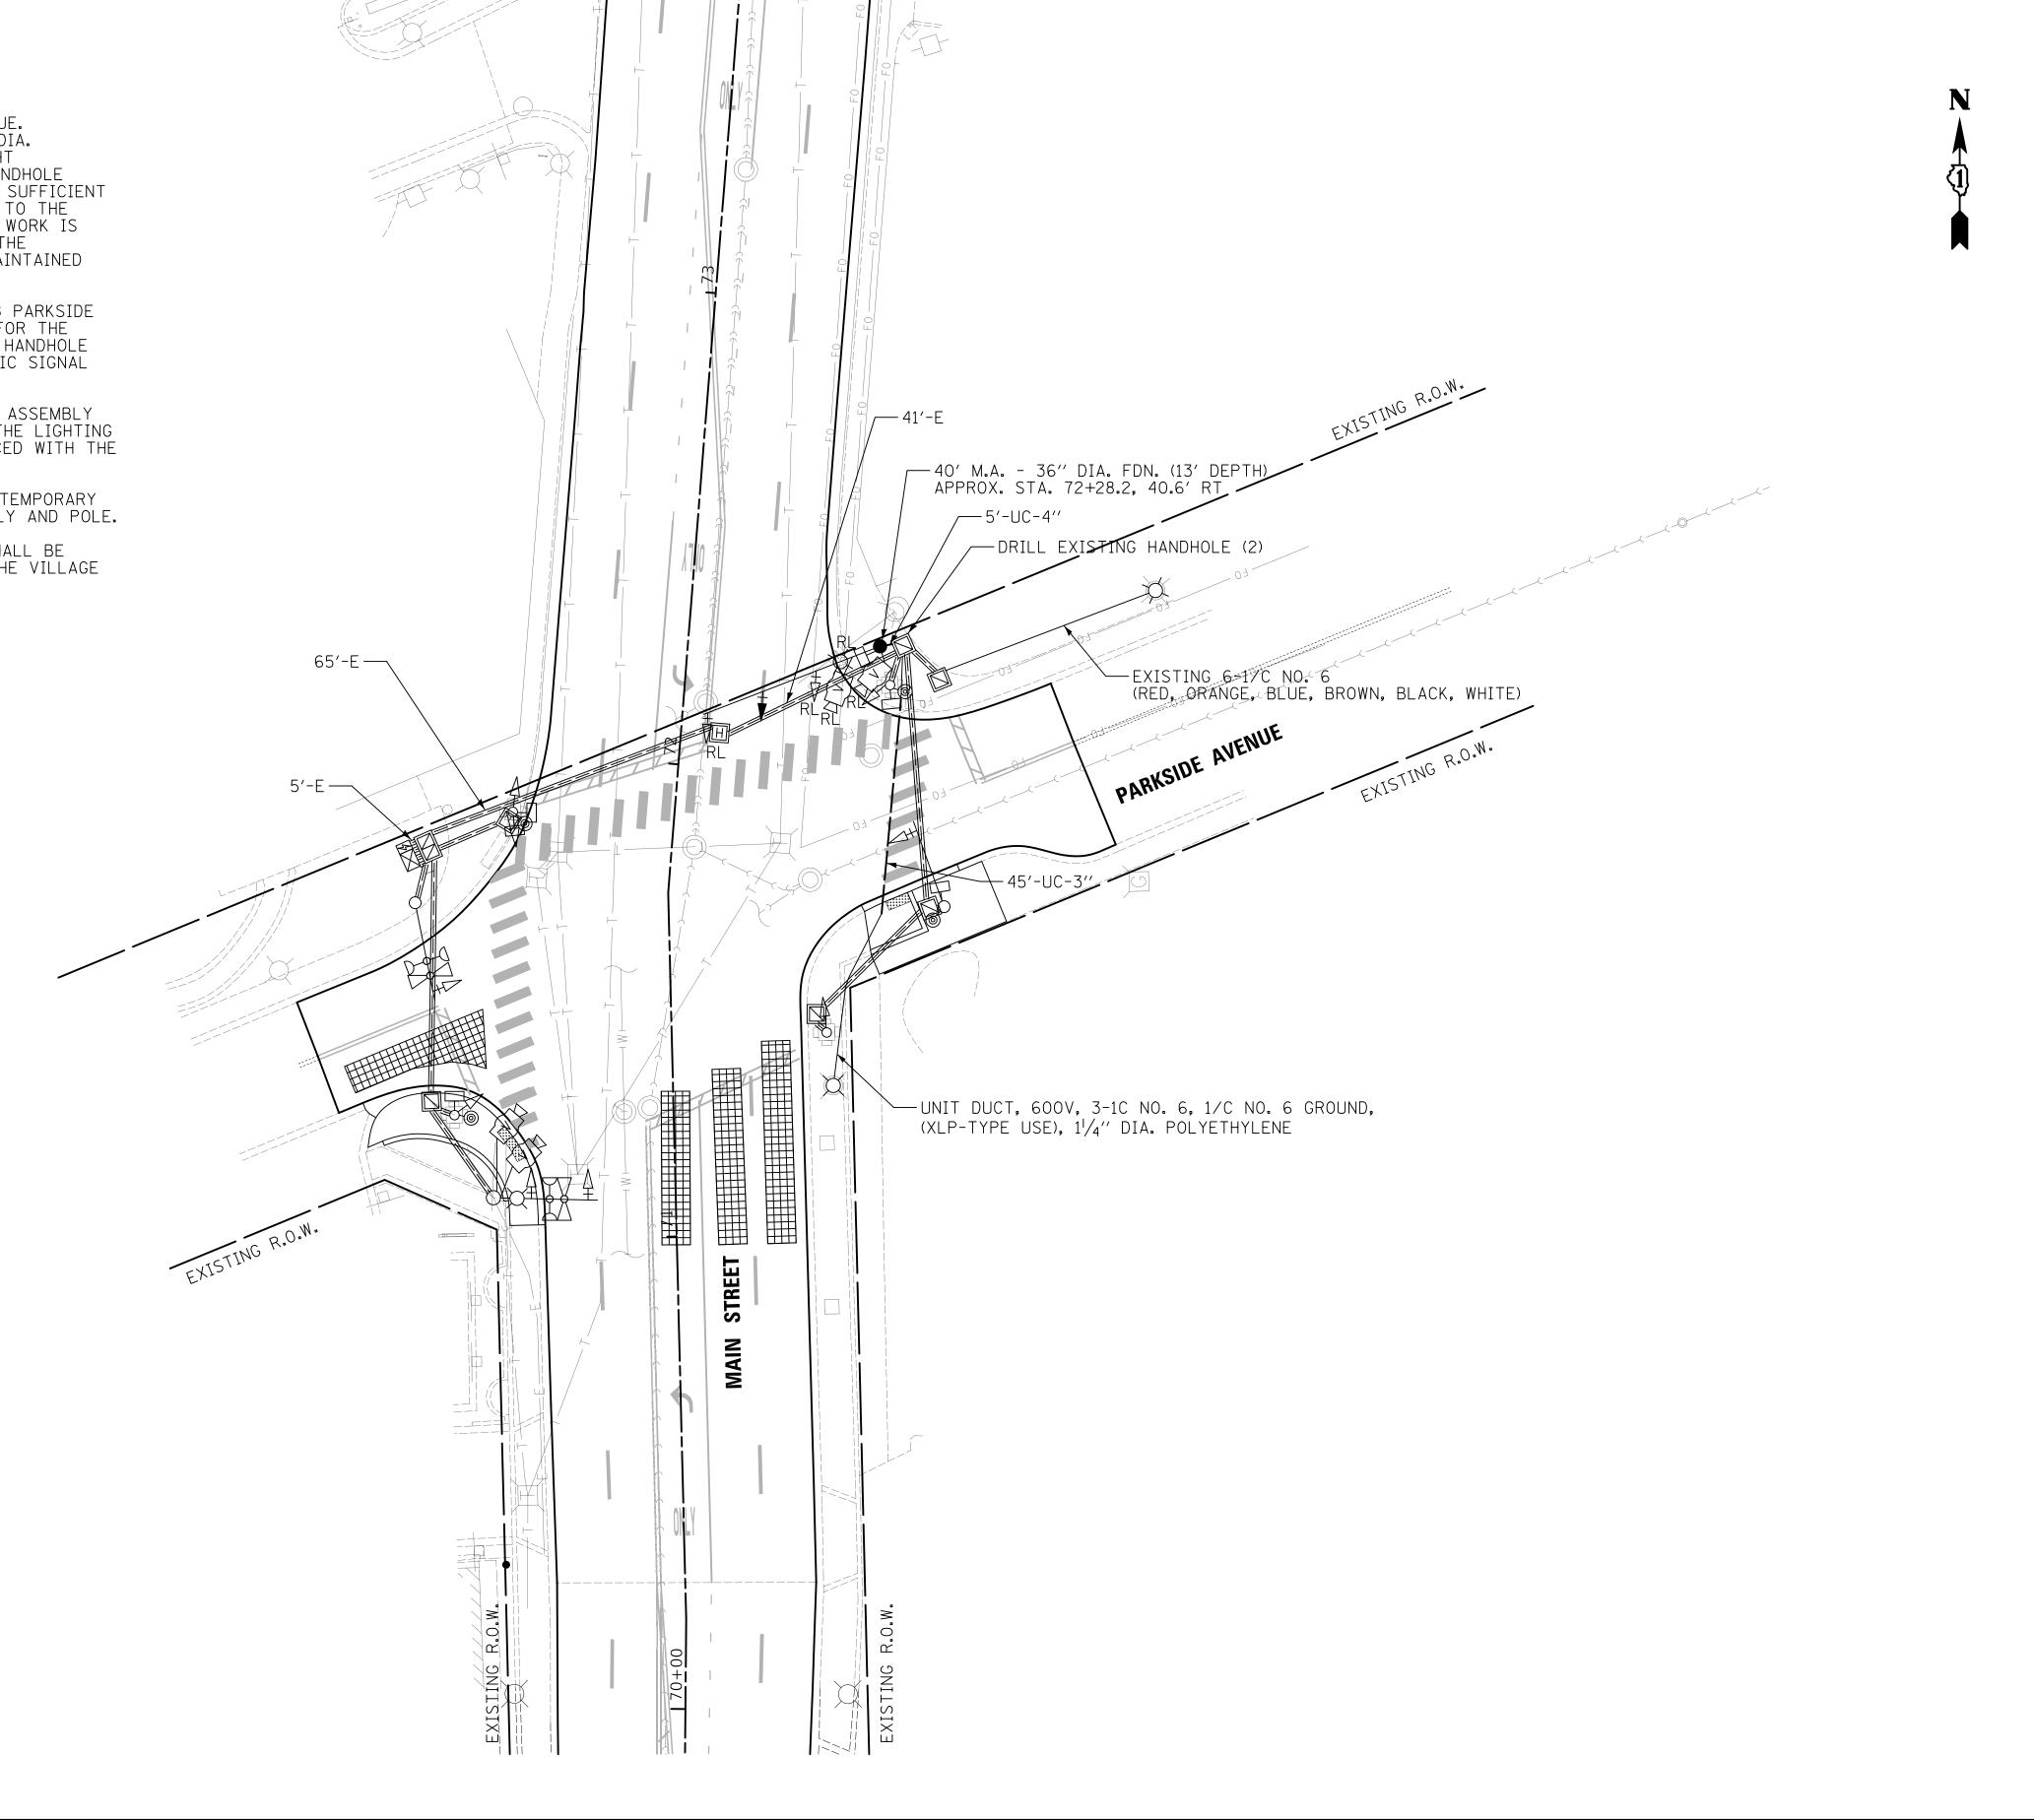

SCALE: NONE

USER NAME = djkDESIGNED -REVISED AS REVISED DRAWN OJT REVISED CHECKED -JJE PLOT SCALE = 20.0000 ' / in. DATE - 12/17/2019 REVISED PLOT DATE = 12/18/2019


STATE OF ILLINOIS DEPARTMENT OF TRANSPORTATION

F.A.U. RTE. SECTION TRAFFIC SIGNAL MODIFICATION PLAN MAIN STREET AND PARKSIDE AVENUE 19-00161-00-RS DUPAGE CONTRACT NO. 61G29 SHEET 1 OF 1 SHEETS STA. TO STA. ILLINOIS FED. AID PROJECT

TOTAL SHEET NO.

67 56

EXISTING AND PROPOSED CONTROLLER SEQUENCE

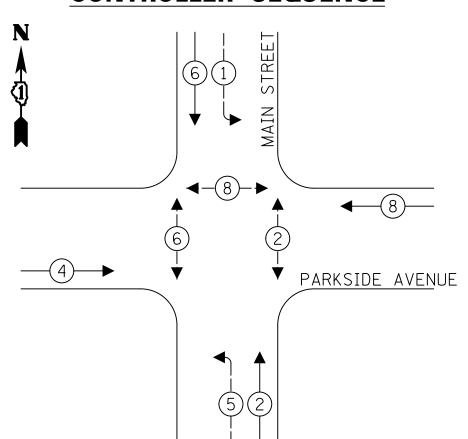

LEGEND:

- **◆ * PROTECTED PHASE**
- ←───
 PROTECTED/PERMITTED PHASE
- ◆─


 PEDESTRIAN PHASE

 A

 PEDESTRIAN PHASE

 PEDESTRIAN PHASE
- OVERLAP OVERLAP

EXISTING AND PROPOSED EMERGENCY VEHICLE PREEMPTION SEQUENCE

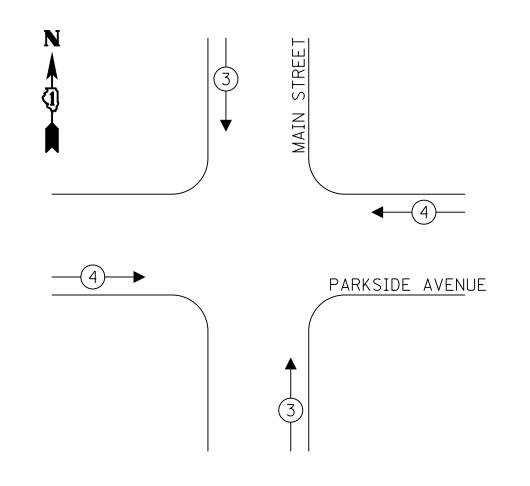

TRAFFIC SIGNAL **ELECTRICAL SERVICE REQUIREMENTS**

	NO. OF	LED	%	TOTAL	
TYPE	LAMPS	WATTAGE	OPERATION	WATTAGE	
SIGNAL (RED)	12	17	50	102.0	
(YELLOW)	12	25	5	15.0	
(GREEN)	12	15	45	81.0	
PERMISSIVE ARROW	8	12	10	9.6	
PED. SIGNAL	6	25	100	150.0	
CONTROLLER	1	100	100	100.0	
UPS	1	25	100	25.0	
VIDEO SYSTEM	1	150	100	150.0	
BLANK-OUT SIGN	_	25	5	_	
FLASHER	_	_	50	_	
STREET NAME SIGN	_	120	50	_	
LUMINAIRE	-	_	-	-	
			TOTAL =	632.6	

ENERGY COSTS TO:

VILLAGE OF LOMBARD 1051 HAMMERSCHMIDT AVE

LOMBARD, IL 60148

ENERGY SUPPLY: CONTACT: NEW BUSINESS

ACCOUNT NUMBER: ---

PHONE: (866) 639-3532 COMPANY: COMED

USER NAME = djk REVISED DESIGNED -AS REVISED DRAWN - OJT CHECKED -JJE REVISED PLOT SCALE = 20.0000 ' / in. PLOT DATE = 12/18/2019DATE - 12/17/2019 REVISED -


STATE OF ILLINOIS **DEPARTMENT OF TRANSPORTATION**

CABLE PLAN, PHASE DESIGNATION DIAGRAM, EMERGENCY VEHICLE PREEMPTION SEQUENCE, AND SCHEDULE OF QUANTITIES MAIN STREET AND PARKSIDE AVENUE SCALE: NONE SHEET 1 OF 1 SHEETS STA. TO STA.

F.A.U. RTE. TOTAL SHEET NO. SECTION COUNTY 19-00161-00-RS ILLINOIS FED. AID PROJECT

SCHEDULE OF QUANTITIES


PAY ITEM	UNIT	QNTY.
UNDERGROUND CONDUIT, GALVANIZED STEEL, 3" DIA.	FOOT	45
UNDERGROUND CONDUIT, GALVANIZED STEEL, 4" DIA.	FOOT	5
UNIT DUCT, 600V, 3-1C NO.6, 1/C NO.6 GROUND (XLP-TYPE USE), 1 1/4" DIA. POLYETHELENE	FOOT	93
ELECTRIC CABLE IN CONDUIT, 600V (XLP-TYPE USE) 1/C NO. 6	FOOT	153
MAINTENANCE OF EXISTING TRAFFIC SIGNAL INSTALLATION	EACH	1
PAINT NEW COMBINATION MAST ARM AND POLE, UNDER 40 FOOT	EACH	1
ELECTRIC CABLE IN CONDUIT, SIGNAL NO. 14 5C	FOOT	196
ELECTRIC CABLE IN CONDUIT, SIGNAL NO. 14 7C	FOOT	208
STEEL COMBINATION MAST ARM ASSEMBLY AND POLE 40 FT.	EACH	1
CONCRETE FOUNDATION, TYPE E 36-INCH DIAMETER	FOOT	13
DRILL EXISTING HANDHOLE	EACH	2
SIGNAL HEAD, LED, 1-FACE, 3-SECTION, MAST-ARM MOUNTED	EACH	1
TRAFFIC SIGNAL BACKPLATE, LOUVERED, FORMED PLASTIC	EACH	3
RELOCATE EXISTING SIGNAL HEAD	EACH	2
RELOCATE EXISTING PEDESTRIAN SIGNAL HEAD	EACH	1
MODIFY EXISTING CONTROLLER	EACH	1
REMOVE ELECTRIC CABLE FROM CONDUIT	FOOT	630
REMOVE AND REINSTALL ELECTRIC CABLE FROM CONDUIT	FOOT	114
REMOVE EXISTING TRAFFIC SIGNAL EQUIPMENT	EACH	1
REMOVE EXISTING CONCRETE FOUDATION	EACH	1
RELOCATE EXISTING VIDEO VEHICLE DETECTOR	EACH	4
RELOCATE EXISTING LUMINAIRE	EACH	1
TEMPORARY TRAFFIC SIGNAL INSTALLATON (SPECIAL)	EACH	1
MAINTENANCE OF LIGHTING SYSTEM	CAL MO	6
TEMPORARY TRAFFIC SIGNAL TIMING	EACH	1

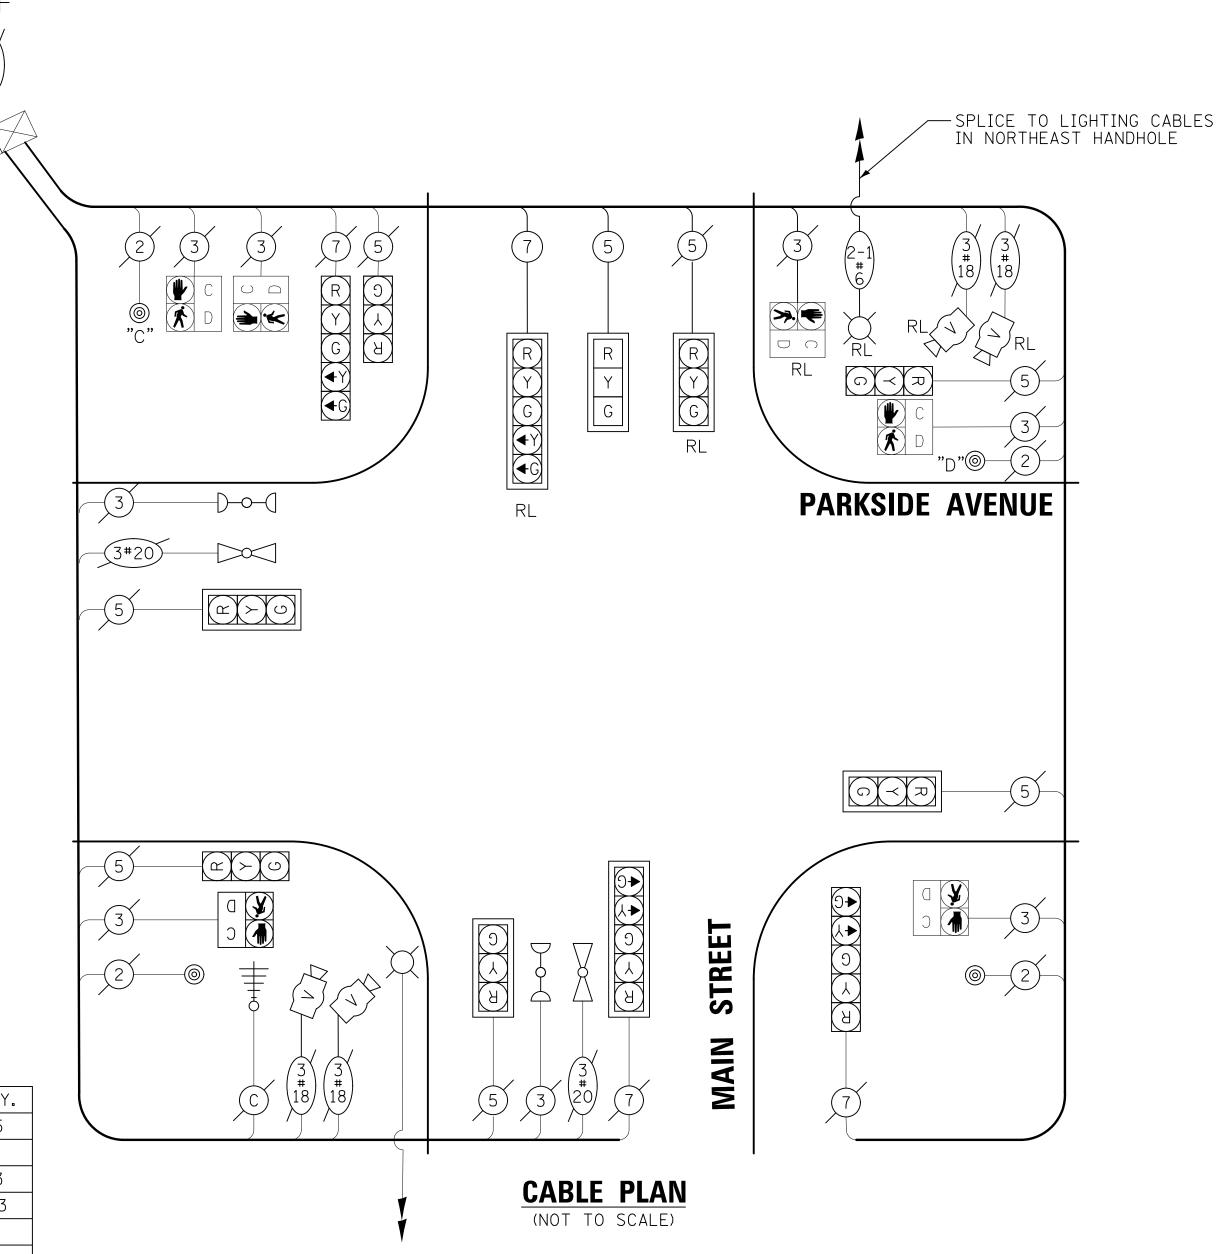

NOTES

PUSHBUTTON C SHALL PLACE A CALL TO PHASES 6 & 8 PUSHBUTTON D SHALL PLACE A CALL TO PHASES 2 & 8

DUPAGE 67 57 CONTRACT NO. 61G29

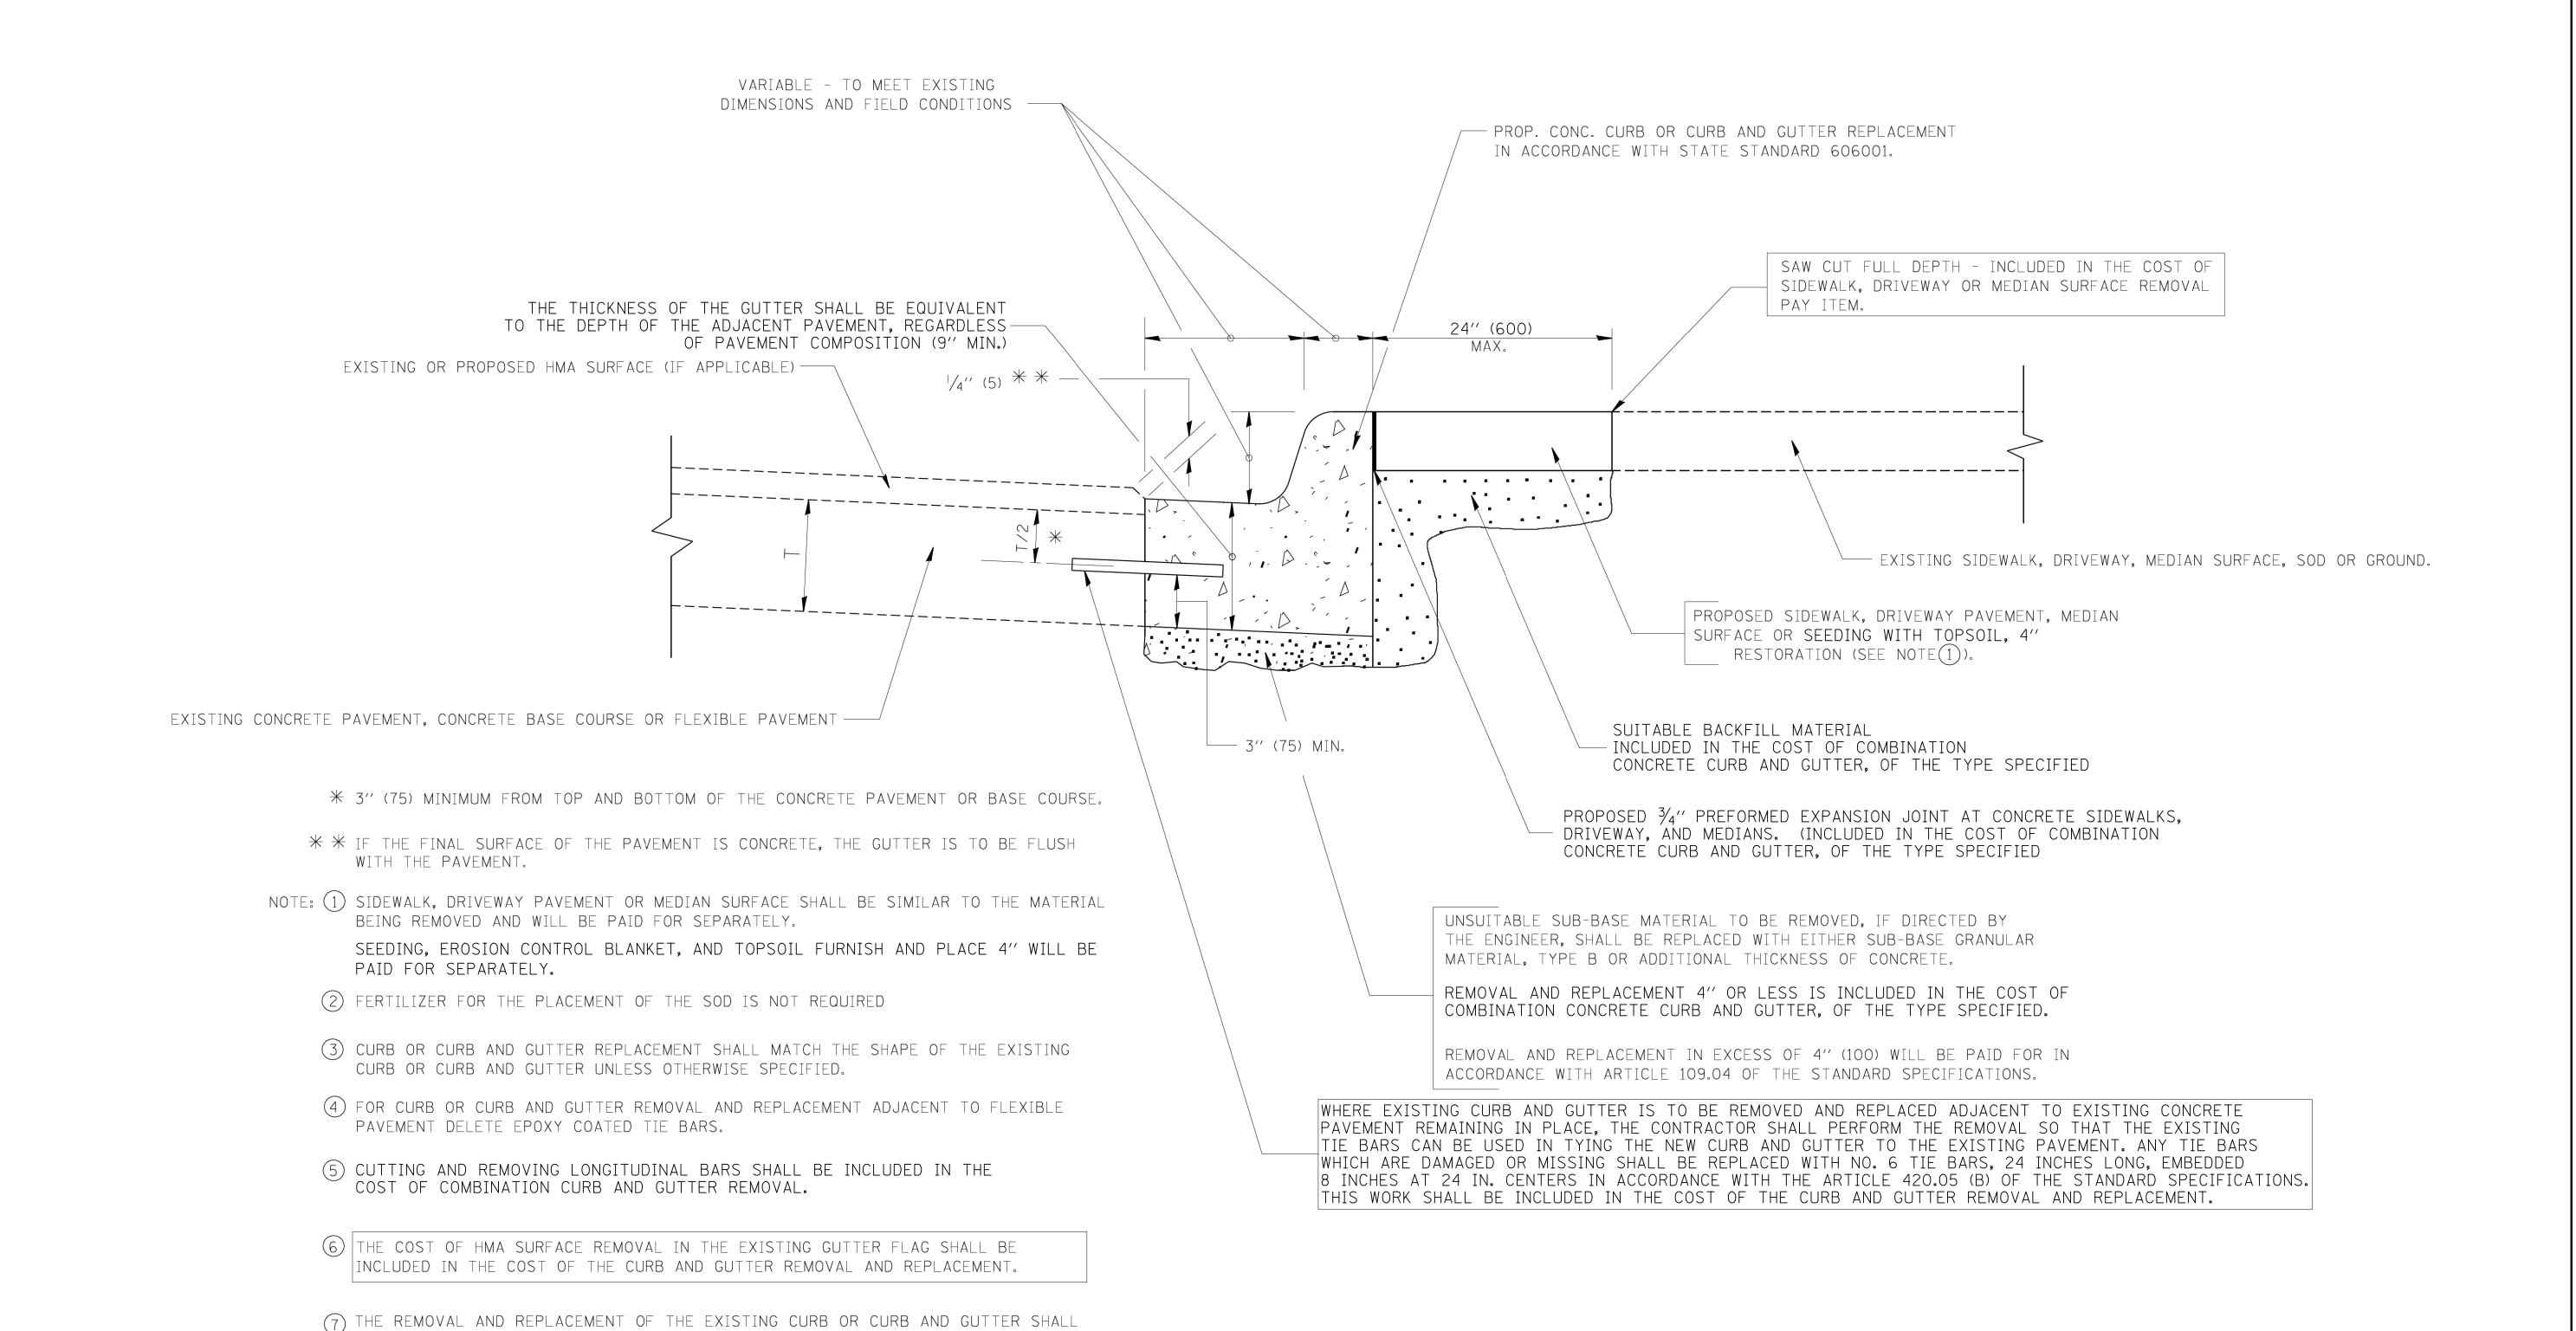

CURB AND GUTTER REMOVAL AND REPLACEMENT DETAIL


BE DONE IN ACCORDANCE WITH THE APPLICABLE PORTIONS OF SECTION 440 AND 606


(8) THE LOCATIONS OF REMOVAL AND REPLACEMENT OF EXISTING CURB OR CURB AND GUTTER SHALL BE DETERMINED BY THE RESIDENT ENGINEER AT THE TIME OF CONSTRUCTION.

OF THE STANDARD SPECIFICATIONS.

ALL DIMENSIONS ARE IN INCHES (MILLIMETERS) UNLESS OTHERWISE SHOWN.

USER NAME = djk	DESIGNED -	KDC	REVISED -			MAIN STREET		F.A.U.	SECTION	COUNTY	TOTAL SHEET
	DRAWN -	JAB	REVISED -	STATE OF ILLINOIS		CONSTRUCTION DETAILS		2611	19-00161-00-RS	DUPAGE	67 58
PLOT SCALE = 1.0000 ' / in.	CHECKED -	DJK	REVISED -	DEPARTMENT OF TRANSPORTATION		CONSTRUCTION DETAILS				CONTRACT	T NO. 61G29
PLOT DATE = $12/18/2019$	DATE -	12/17/2019	REVISED -		SCALE: NTS	SHEET 1 OF 2 SHEETS STA.	TO STA.		ILLINOIS FED.	AID PROJECT	

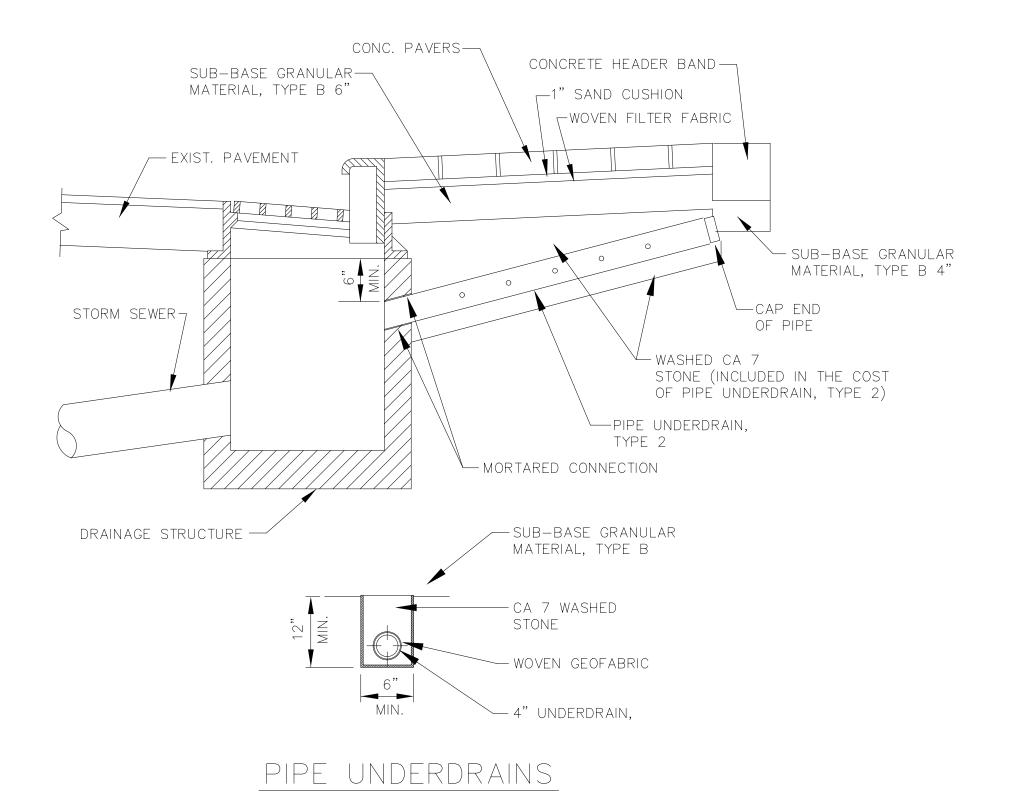


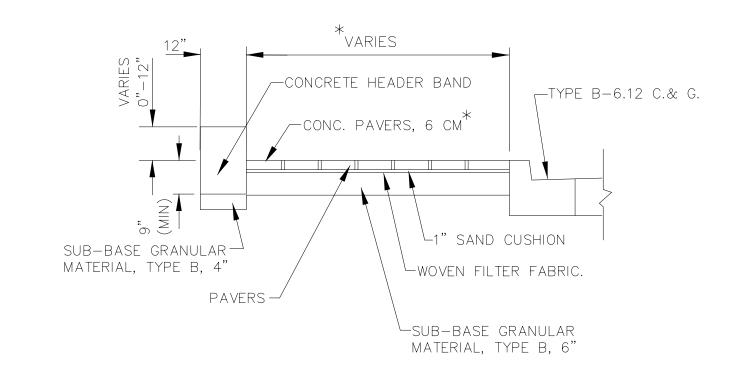


*THE WIDTHS OF PAVERS SHALL BE ADJUSTED IN THE FIELD, AS DIRECTED BY THE ENGINEER, SO THAT LATERAL CUTTING OF PAVER BRICKS IS MINIMIZED.

PAVER SIDEWALK DETAIL

F.A.U. RTE. TOTAL SHEET NO. DESIGNED -REVISED USER NAME = djkKDC SECTION COUNTY MAIN STREET STATE OF ILLINOIS REVISED DRAWN JAB DUPAGE 67 59 19-00161-00-RS CONSTRUCTION DETAILS **DEPARTMENT OF TRANSPORTATION** CHECKED -DJK REVISED -PLOT SCALE = 1.0000 ' / in. CONTRACT NO. 61G29 SHEET 2 OF 2 SHEETS STA. TO STA. PLOT DATE = 12/18/2019DATE - 12/17/2019 REVISED -SCALE: NTS ILLINOIS FED. AID PROJECT

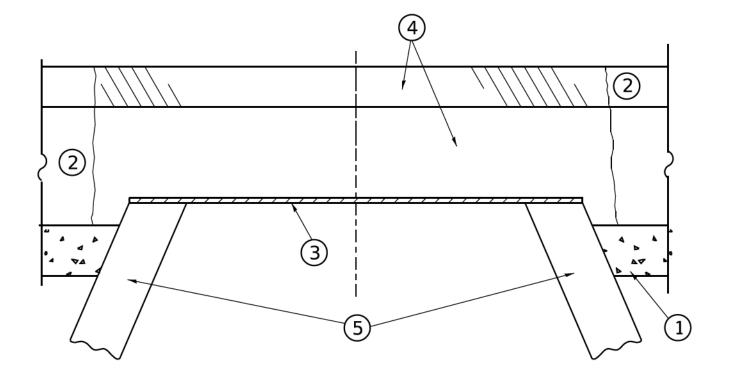

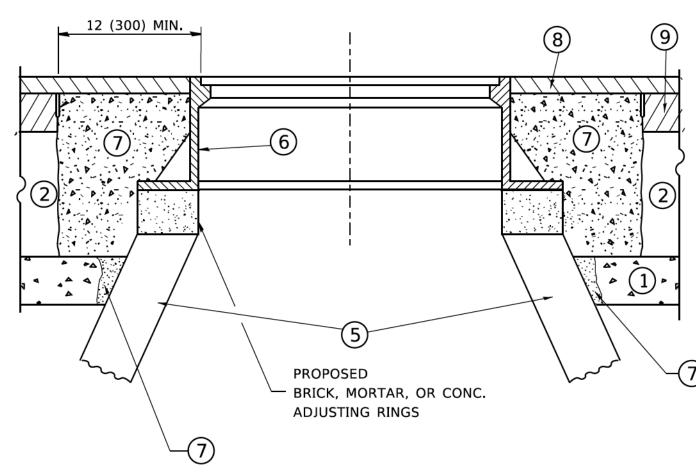

NOTES

EXISTING BROKEN FRAMES AND LIDS SHALL BE REMOVED AND DISPOSED OF BY THE CONTRACTOR AND SHALL BE REPLACED AS DIRECTED BY THE ENGINEER. REPLACEMENT FRAMES AND LIDS WILL BE PAID FOR IN ACCORDANCE WITH ARTICLE 109.04 OF THE STANDARD SPECIFICATIONS UNLESS A SEPARATE PAY ITEM HAS BEEN PROVIDED.

IF THE EXISTING LIDS ARE OPEN, THE FRAME WILL BE ADJUSTED TO THE ELEVATION OF THE MILLED PAVEMENT SURFACE PRIOR TO THE MILLING OPERATION. THE FRAME WILL NOT BE REMOVED AND COVERED BY THE METAL PLATE.

CITY OF CHICAGO CASTINGS ARE THE PROPERTY OF THE CITY AND THE CONTRACTOR SHALL NOTIFY THE CITY FOR REMOVAL AND DISPOSITION OF THE CASTINGS.

THE METAL PLATE USED TO COVER THE STRUCTURE SHALL REMAIN THE PROPERTY OF THE CONTRACTOR.

WHEN STRUCTURES ARE TO BE ADJUSTED OR RECONSTRUCTED, THE LOWERING AND RAISING OF THE FRAMES AND LIDS WILL NOT BE PAID FOR SEPARATELY BUT WILL BE INCLUDED IN THE COST OF THE CORRESPONDING PAY ITEM.

SCALE: NONE

CONSTRUCTION PROCEDURES

STAGE 1 (BEFORE PAVEMENT MILLING)

- A) REMOVE A MINIMUM OF 12 (300) OF THE PAVEMENT FROM AROUND THE STRUCTURE.
- B) REMOVE THE EXISTING FRAME AND LID FROM THE STRUCTURE.
- C) COVER THE STRUCTURE OPENING WITH A 36 (900) DIAMETER
- D) BACKFILL WITH CRUSHED STONE AND A MINIMUM 1½ (40)
 THICK HMA SURFACE MIX APPROVED BY THE ENGINEER.

STAGE 2 (AFTER PAVEMENT MILLING)

- A) REMOVE THE HMA SURFACE MIX AND CRUSHED STONE.
- B) INSTALL THE FRAME AND LID; ADJUST THE FRAME TO ITS FINAL SURFACE ELEVATION.
- C) THE SURROUNDING SPACE SHALL BE FILLED WITH CLASS PP-1 *
 CONCRETE TO THE ELEVATION OF THE SURFACE OF THE EXISTING
 BASE COURSE OR THE BINDER COURSE.
- * UNLESS OTHERWISE SPECIFIED IN THE PLANS.

THE PROCEDURE EXPLAINED ABOVE SHALL CONFORM TO THE APPLICABLE PORTIONS OF SECTIONS 353, 406, 602, AND 603 OF THE STANDARD SPECIFICATIONS EXCEPT THAT "THE CONTRACTOR SHALL ADJUST THE STRUCTURES TO THE FINISHED PAVEMENT ELEVATION NO MORE THAN 5 CALENDAR DAYS PRIOR TO PLACEMENT OF THE FINAL LIFT OF SURFACE UNLESS APPROVED BY THE ENGINEER."

LEGEND

- SUB-BASE GRANULAR MATERIAL
- 6 FRAME AND LID (SEE NOTES)
- 2 EXISTING PAVEMENT
- 7 CLASS PP-1 *CONCRETE
- 3 36 (900) DIAMETER METAL PLATE
- 8 PROPOSED HMA SURFACE COURSE
- PROPOSED CRUSHED STONE AND HMA SURFACE MIX

 (5) EXISTING STRUCTURE
- 9 PROPOSED HMA BINDER COURSE

LOCATION OF STRUCTURES

THE CONTRACTOR WILL BE REQUIRED TO KEEP A RECORD OF THE LOCATIONS OF THE BURIED STRUCTURES ACCORDING TO THE STATION AND DISTANCE LEFT OR RIGHT OF THE CENTERLINE OF PAVEMENT. UPON COMPLETION OF THE WORK, THE CONTRACTOR WILL DELIVER THE RECORD TO THE ENGINEER.

BASIS OF PAYMENT

TO STA.

REMOVING FRAMES AND LIDS ON DRAINAGE AND UTILITY STRUCTURES IN THE PAVEMENT PRIOR TO MILLING, AND ADJUSTING TO FINAL GRADE PRIOR TO PLACING THE SURFACE COURSE, WILL BE PAID FOR AT THE CONTRACT UNIT PRICE EACH FOR "FRAMES AND LIDS TO BE ADJUSTED (SPECIAL)."

THIS WORK WILL NOT BE PAID FOR WHEN DRAINAGE AND UTILITY STRUCTURES ARE SPECIFIED FOR PAYMENT AS STRUCTURE RECONSTRUCTION.

NEW FRAMES AND LIDS, WHEN SPECIFIED, WILL BE PAID FOR SEPARATELY.

DETAILS FOR FRAMES AND LIDS ADJUSTMENT WITH MILLING

ALL DIMENSIONS ARE IN INCHES (MILLIMETERS) UNLESS OTHERWISE SHOWN

 USER NAME
 = footemj
 DESIGNED - R. SHAH
 REVISED - R. WEDEMAN 05-14-04

 DRAWN REVISED - R. BORO 01-01-07

 PLOT SCALE = 50.0000 ' / in.
 CHECKED - R. BORO 03-09-11

 PLOT DATE = 3/27/2019
 DATE - 10-25-94
 REVISED - R. BORO 12-06-11

STATE OF ILLINOIS
DEPARTMENT OF TRANSPORTATION

DETAILS FOR
FRAMES AND LIDS ADJUSTMENT WITH MILLING


SHEET 1 OF 1 SHEETS STA.

F.A.U SECTION COUNTY TOTAL SHEETS NO.

2611 19-00161-00-RS DUPAGE 67 60


BD600-03 (BD-8) CONTRACT NO. 61G29

ILLINOIS FED. AID PROJECT

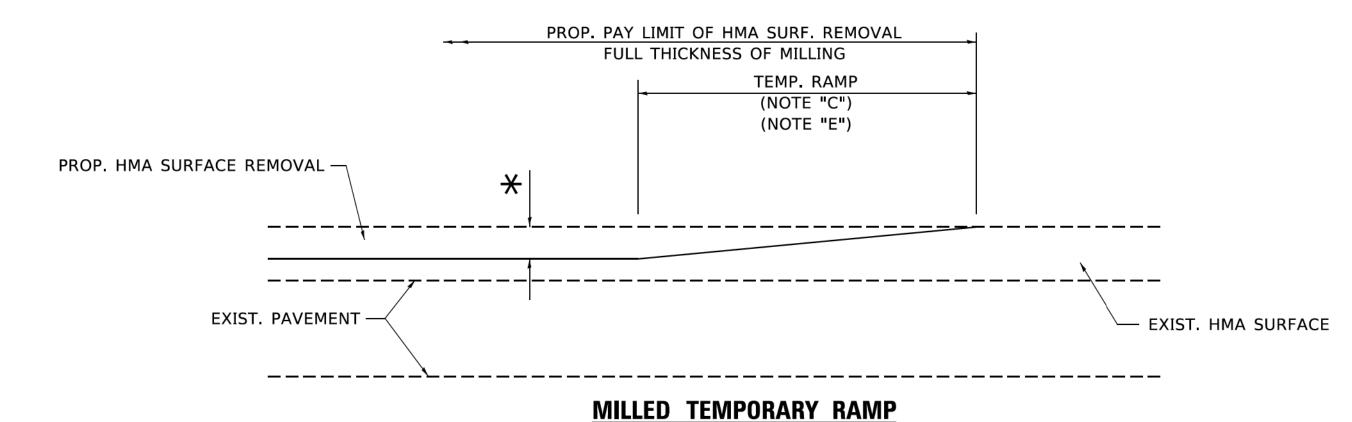

(FOR BUTT JOINT AND HMA TAPER SEE DETAIL BELOW)

OPTION 1

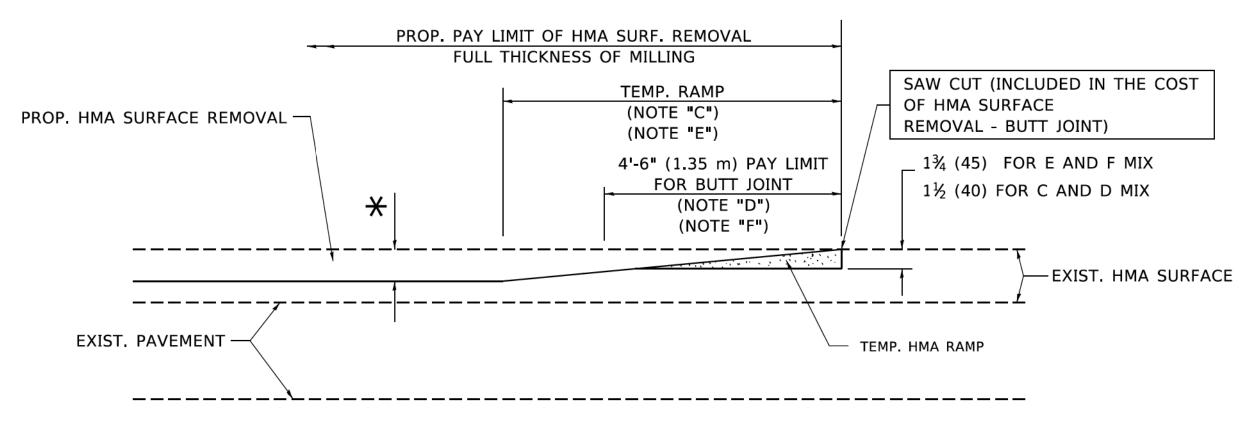


HMA CONSTRUCTED TEMPORARY RAMP


(FOR BUTT JOINT AND HMA TAPER SEE DETAIL BELOW)

OPTION 2

TYPICAL TEMPORARY RAMP

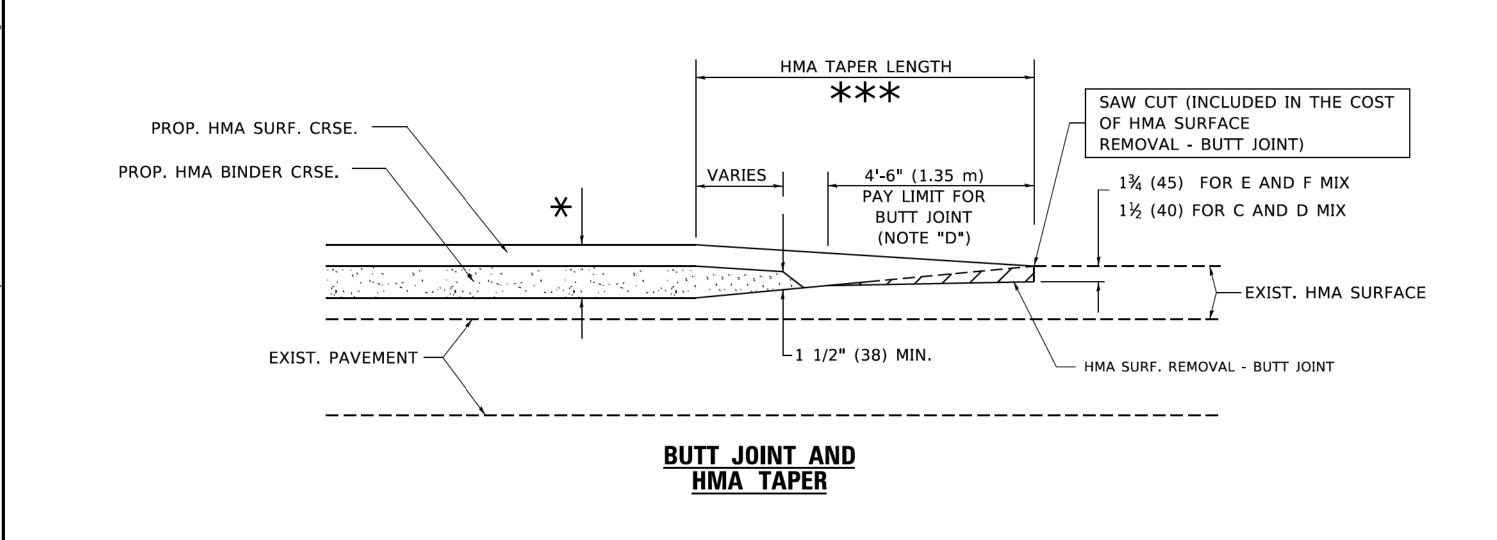



TYPICAL BUTT JOINT AND HMA TAPER FOR MILLING AND RESURFACING

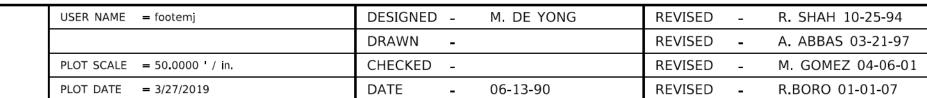

STATE OF ILLINOIS DEPARTMENT OF TRANSPORTATION

TOTAL SHEET NO. SECTION COUNTY **BUTT JOINT AND** 19-00161-00-RS DUPAGE 67 **HMA TAPER DETAILS** BD400-05 BD32 CONTRACT NO. 61G29 OF 1 SHEETS STA. SHEET 1 TO STA. ILLINOIS FED. AID PROJECT

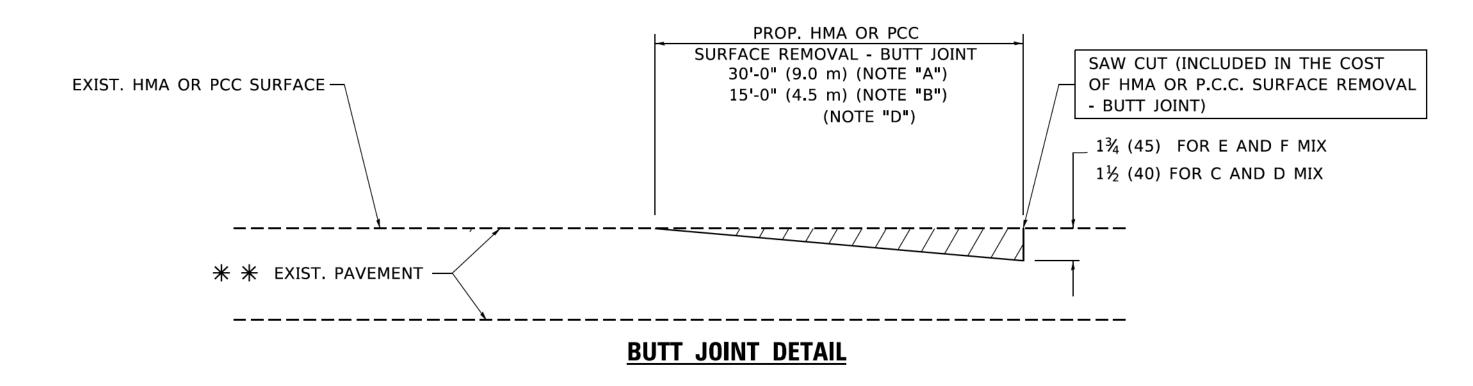

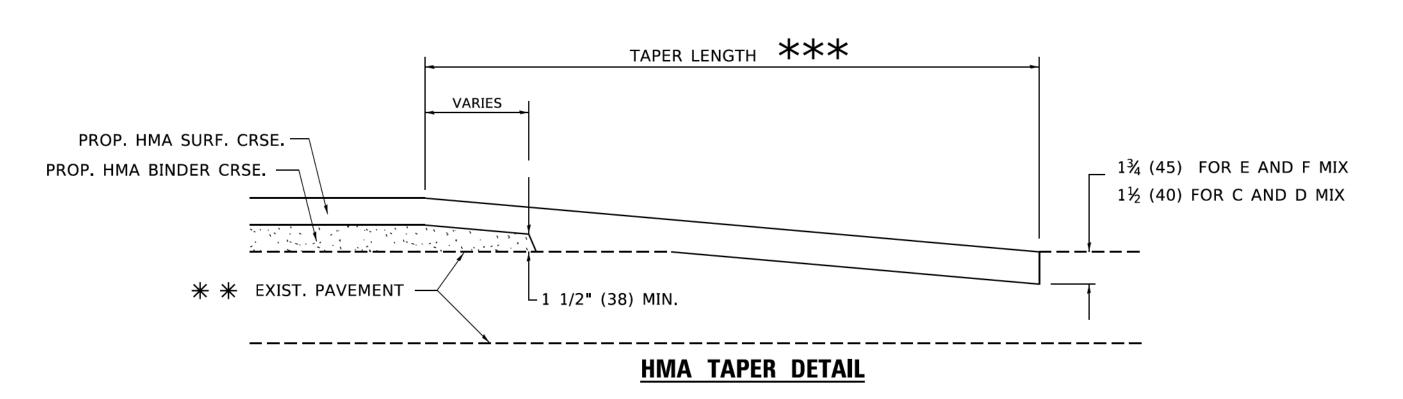

TYPICAL BUTT JOINT AND HMA TAPER FOR RESURFACING ONLY

PC CONCRETE, HMA OR HMA RESURFACED PAVEMENT.

NOTES


- A. MAINLINE ROADWAYS AND MAJOR SIDE ROADS.
- B. MINOR SIDE ROADS.
- C. THE TEMP. RAMP SHALL BE CONSTRUCTED IMMEDIATELY UPON REMOVAL OF THE EXISTING HMA SURFACE.
- D. THE BUTT JOINT SHALL BE CONSTRUCTED IMMEDIATELY PRIOR TO PLACING THE PROPOSED HMA COURSES.
- E. TAPER THE TEMP. RAMP AT A RATE OF 3'-0" (900 mm) PER 1 INCH (25 mm) OF MILLING THICKNESS.
- F. INSTALLATION AND REMOVAL OF THE 4'-6" (1.35 m) TEMP. RAMP IS INCLUDED IN COST OF HMA SURFACE REMOVAL - BUTT JOINT. * SEE TYPICAL SECTIONS FOR MILLING THICKNESS.
- G. SEE ARTICLE 406.08 AND 406.14 OF THE STANDARD SPECIFICATIONS FOR "HMA AND/OR PCC SURFACE REMOVAL, BUTT JOINT".
- ** 20'-0" (6.1 m) PER 1 (25) RESURFACING (NOTE "A") 10'-0" (3.0 m) PER 1 (25) RESURFACING (NOTE "B")

BASIS OF PAYMENT

THE BUTT JOINT WILL BE PAID FOR AT THE CONTRACT UNIT PRICE PER SQUARE YARD (SQUARE METER) FOR "HOT-MIX ASPHALT SURFACE REMOVAL - BUTT JOINT" OR FOR "PORTLAND CEMENT CONCRETE SURFACE REMOVAL- BUTT JOINT".

SCALE: NONE

ALL DIMENSIONS ARE IN INCHES (MILLIMETERS) UNLESS OTHERWISE SHOWN.

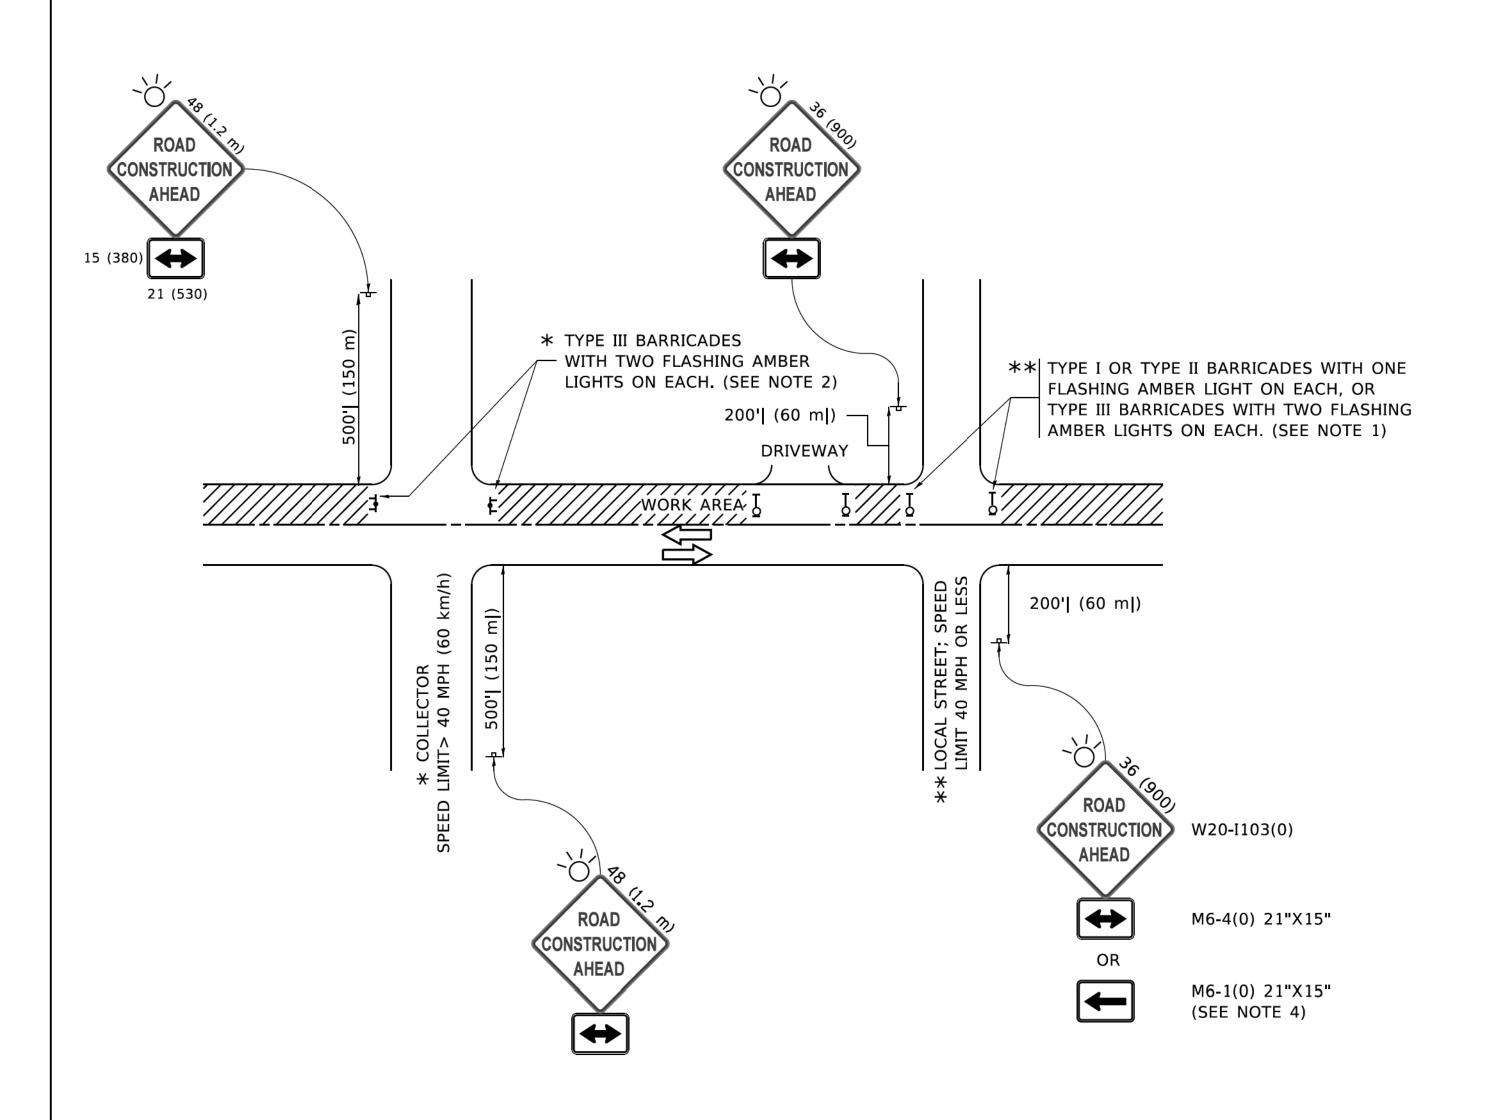

NOTES:

- 1. SIDE ROAD WITH A SPEED LIMIT OF 40 MPH (60 km/h) OR LESS AS SHOWN ON THE DRAWING AND AS DIRECTED BY THE ENGINEER:
- a) ONE "ROAD CONSTRUCTION AHEAD" SIGN 36 x 36 (900x900) WITH A FLASHER MOUNTED ON IT APPROXIMATELY 200' (60 m) IN ADVANCE OF THE MAIN ROUTE.
- b) THE CLOSED PORTION OF THE MAIN ROUTE SHALL BE PROTECTED BY BLOCKING WITH TYPE I, TYPE II OR TYPE III BARRICADES, 1/3 OF THE CROSS SECTION OF THE CLOSED PORTION.
- 2. SIDE ROAD WITH A SPEED LIMIT GREATER THAN 40 MPH (60 km/h) AS SHOWN ON THE DRAWING AND AS DIRECTED BY THE ENGINEER:
- a) ONE "ROAD CONSTRUCTION AHEAD" SIGN 48 x 48 (1.2 m x 1.2 m) WITH A FLASHER MOUNTED ON IT APPROXIMATELY 500' (150 m) IN ADVANCE OF THE MAIN ROUTE.
- THE CLOSED PORTION OF THE MAIN ROUTE SHALL BE PROTECTED BY
 b) BLOCKING WITH TYPE III BARRICADES, 1/2 OF THE CROSS SECTION
 OF THE CLOSED PORTION.
- 3. CONES MAY BE SUBSTITUTED FOR BARRICADES OR DRUMS AT HALF THE SPACING DURING DAY OPERATIONS. CONES SHALL BE A MINIMUM OF 28 (710) IN HEIGHT.
- WHEN THE SIDE ROAD LIES BETWEEN THE BEGINNING OF THE MAINLINE
 4. SIGNING AND THE WORK ZONE, A SINGLE HEADED ARROW (M6-1) SHALL
 BE USED IN LIEU OF THE DOUBLE HEADED ARROW (M6-4).

SCALE: NONE

- 5. WHEN WORK IS BEING PERFORMED ON A SIDE ROAD OR DRIVEWAY, FOLLOW THE APPLICABLE STANDARD(S). THE DIRECTIONAL ARROW (M6-1 OR M6-4) SHALL BE COVERED OR REMOVED WHEN NO LONGER CONSISTENT WITH THE TRAFFIC CONTROL SET-UP.
- 6. ADVANCE WARNING SIGNS ARE TO BE OMITTED ON DRIVEWAYS UNLESS OTHERWISE SPECIFIED IN THE PLANS OR BY THE ENGINEER.
- 7. THE TRAFFIC CONTROL AND PROTECTION FOR SIDE ROADS, INTERSECTIONS, AND DRIVEWAYS SHALL BE INCLUDED IN THE COST OF SPECIFIED TRAFFIC CONTROL STANDARDS OR ITEMS.

All dimensions are in inches (millimeters) unless otherwise shown.

 USER NAME
 = footemj
 DESIGNED
 L.H.A.
 REVISED
 A. HOUSEH 10-15-96

 DRAWN
 REVISED
 T. RAMMACHER 01-06-00

 PLOT SCALE
 = 50.0000 ' / in.
 CHECKED
 REVISED
 A. SCHUETZE 07-01-13

 PLOT DATE
 = 3/4/2019
 DATE
 06-89
 REVISED
 A. SCHUETZE 09-15-16

STATE OF ILLINOIS
DEPARTMENT OF TRANSPORTATION

TRAFFIC CONTROL AND PROTECTION FOR SIDE ROADS, INTERSECTIONS, AND DRIVEWAYS


TO STA.

SHEET 1 OF 1 SHEETS STA.

F.A.U SECTION COUNTY TOTAL SHEETS NO.

2611 19-00161-00-RS DUPAGE 67 62

TC-10 CONTRACT NO. 61G29

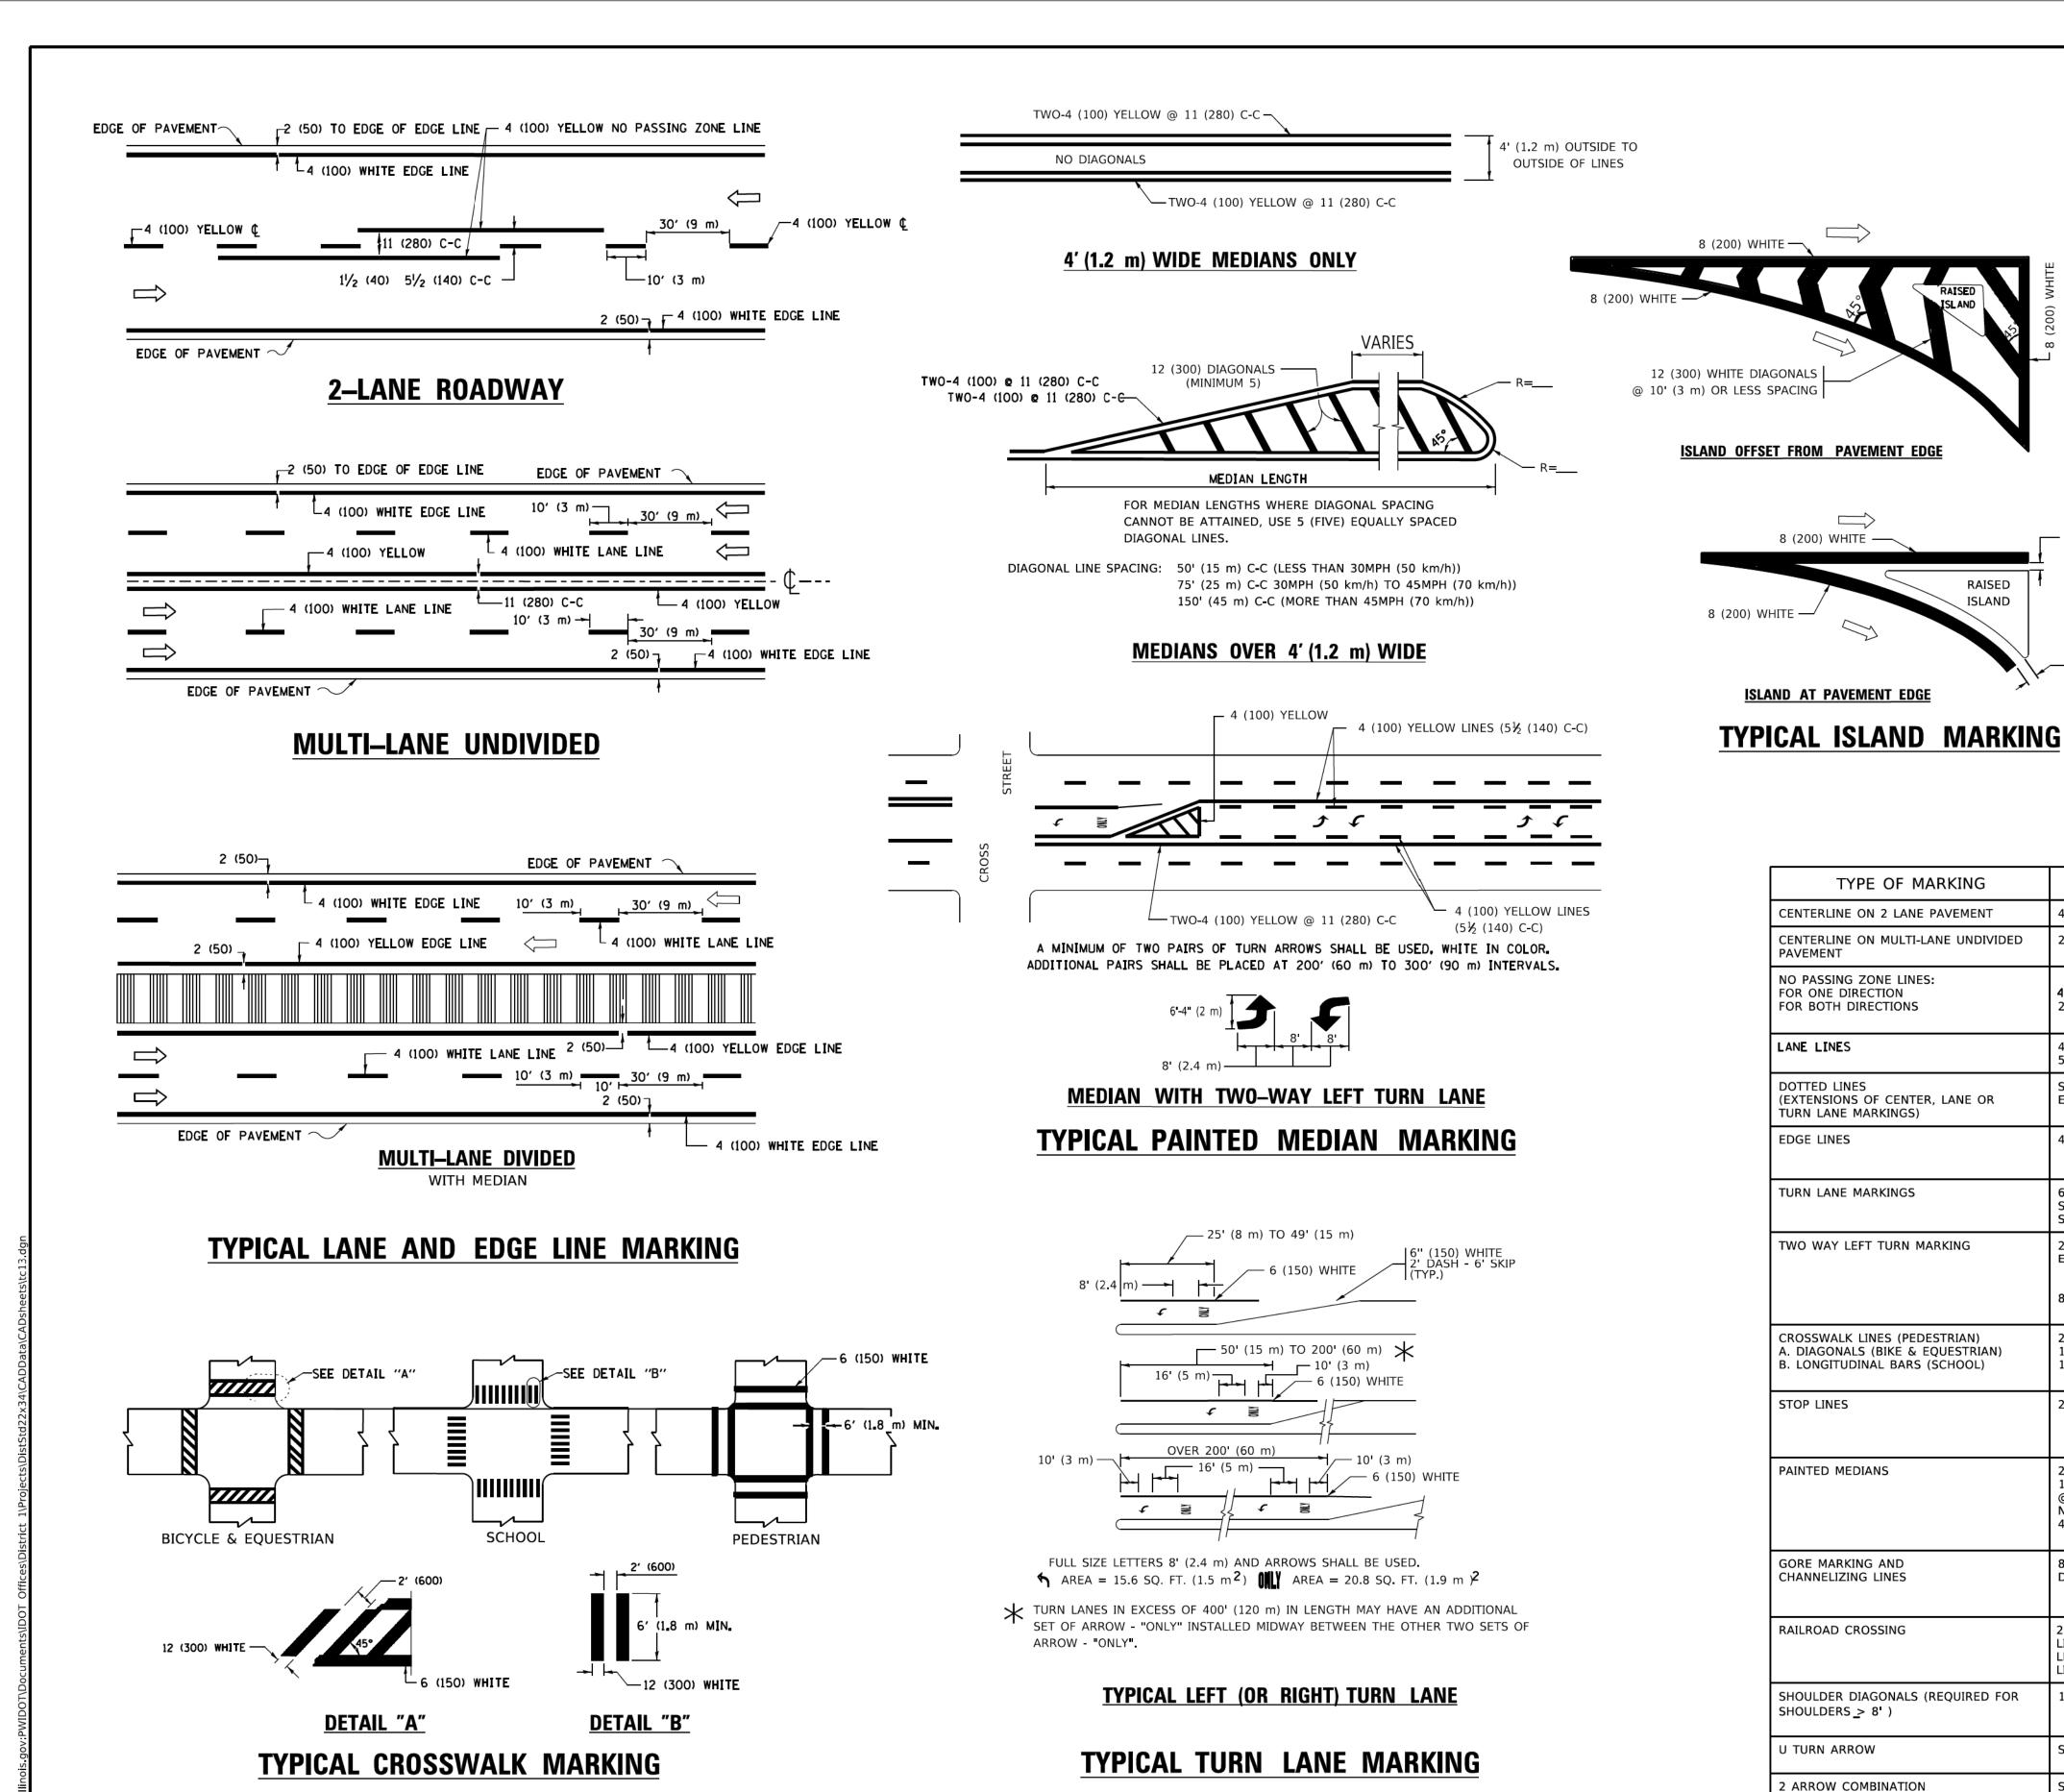

COMBINATION LEFT AND U-TURN √ 32 R (810) LANE REDUCTION TRANSITION * LANE REDUCTION ARROWS REQUIRED AT SPEEDS OF 45 MPH OR U-TURN GREATER OR WHEN SPECIFIED IN PLANS. WIDTH OF LINE PATTERN COLOR SPACING / REMARKS SKIP-DASH YELLOW 10' (3 m) LINE WITH 30' (9 m) SPACE SOLID YELLOW 2 @ 4 (100) 11 (280) C-C 4 (100) 2 @ 4 (100) SOLID SOLID YELLOW YELLOW 5½ (140) C-C FROM SKIP-DASH CENTERLINE OMIT SKIP-DASH CENTERLINE BETWEEN SKIP-DASH WHITE 10' (3 m) LINE WITH 30' (9 m) SPACE SKIP-DASH WHITE 5 (125) ON FREEWAYS SAME AS LINE BEING SKIP-DASH SAME AS LINE BEING 2' (600) LINE WITH 6' (1.8 m) SPACE EXTENDED EXTENDED 4 (100) SOLID YELLOW-LEFT OUTLINE MEDIANS IN YELLOW WHITE-RIGHT 6 (150) LINE; FULL SOLID WHITE SEE TYPICAL TURN LANE MARKING DETAIL SIZE LÉTTERS & SYMBOLS (8' (2.4m)) SKIP-DASH YELLOW 10' (3 m) LINE WITH 30' (9 m) SPACE FOR 2 @ 4 (100) EACH DIRECTION AND SOLID SKIP-DASH; 5½ (140) C-C BETWEEN SOLID IN PAIRS LINE AND SKIP-DASH LINE SEE TYPICAL TWO-WAY LEFT TURN 8' (2.4m) LEFT ARROW WHITE MARKING DETAIL SOLID 2 @ 6 (150) WHITE NOT LESS THAN 6' (1.8 m) APART 12 (300) @ 45° 12 (300) @ 90° 2' (600) APART SOLID WHITE SOLID WHITE 2' (600) APART SEE TYPICAL CROSSWALK MARKING DETAILS. PLACE 4' (1.2 m) IN ADVANCE OF AND 24 (600) SOLID WHITE PARALLEL TO CROSSWALK, IF PRESENT. OTHERWISE, PLACE AT DESIRED STOPPING POINT. PARALLEL TO CROSSROAD CENTERLINE, WHERE SOLID 2 @ 4 (100) WITH YELLOW: 11 (280) C-C FOR THE DOUBLE LINE 12 (300) DIAGONALS TWO WAY TRAFFIC SEE TYPICAL PAINTED MEDIAN MARKING. WHITE: NO DIAGONALS USED FOR ONE WAY TRAFFIC 4' (1.2 m) WIDE MEDIANS

(1020)

(910)

D(FT)

425

500

580

665

750

SPEED LIMIT

35

40

45

50

55

REVISED - C. JUCIUS 09-09-09

REVISED - C. JUCIUS 07-01-13

- C. JUCIUS 12-21-15

REVISED - C. JUCIUS 04-12-16

REVISED

STATE OF ILLINOIS
DEPARTMENT OF TRANSPORTATION

DIAGONALS:

AREA OF:

16.3 SF

30.4 SF

15' (4.5 m) C-C (LESS THAN 30MPH (50 km/h))

50' (15 m) C-C (LESS THAN 30MPH (50 km/h))

150' (45 m) C-C (OVER 45MPH (70 km/h))

unless otherwise shown.

30' (9 m) C-C (OVER 45MPH (70 km/h))

SEE STATE STANDARD 780001

"X"=54.0 SQ. FT. (5.0 m)²

"R"=3.6 SQ. FT. (0.33 m) EACH

20' (6 m) C-C 30MPH (50 km/h) TO 45MPH (70 km/h))

75' (25 m) C-C (30 MPH (50 km/h) TO 45MPH (70 km/h))

All dimensions are in inches (millimeters)

SOLID

SOLID

SOLID

SOLID

SOLID

WHITE

WHITE

WHITE

WHITE

WHITE - RIGHT

YELLOW - LEFT

8 (200) WITH 12 (300)

24 (600) TRANSVERSE

LETTERS; 16 (400)

LINE FOR "X"

SEE DETAIL

SEE DETAIL

LEFT AND U TURN

SCALE: NONE

FOR FURTHER DETAILS ON PAVEMENT MARKING REFER TO

STANDARD SPECIFICATIONS FOR ROAD AND BRIDGE

CONSTRUCTION AND STATE STANDARD 780001.

12 (300) @ 45°

LINES; "RR" IS 6' (1.8 m)

DIAGONALS @ 45°

PLOT DATE = 3/4/2019

* MARKINGS SHALL BE INSTALLED PARALLEL TO THE CENTERLINE OF

DESIGNED

CHECKED -

DRAWN

DATE


EVERS

- 03-19-90

THE ROAD WHICH IT CROSSES

USER NAME = footemj


PLOT SCALE = 50.0000' / in

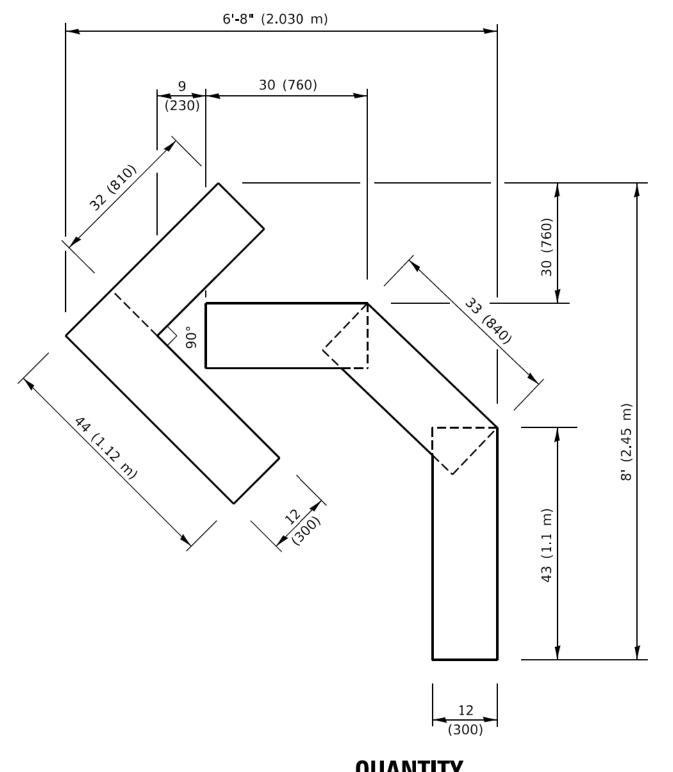

QUANTITY

4 (100) LINE = 45.5 ft. (13.9 m)15.2 sq. ft. (1.41 sq. m)

6' (2 m)

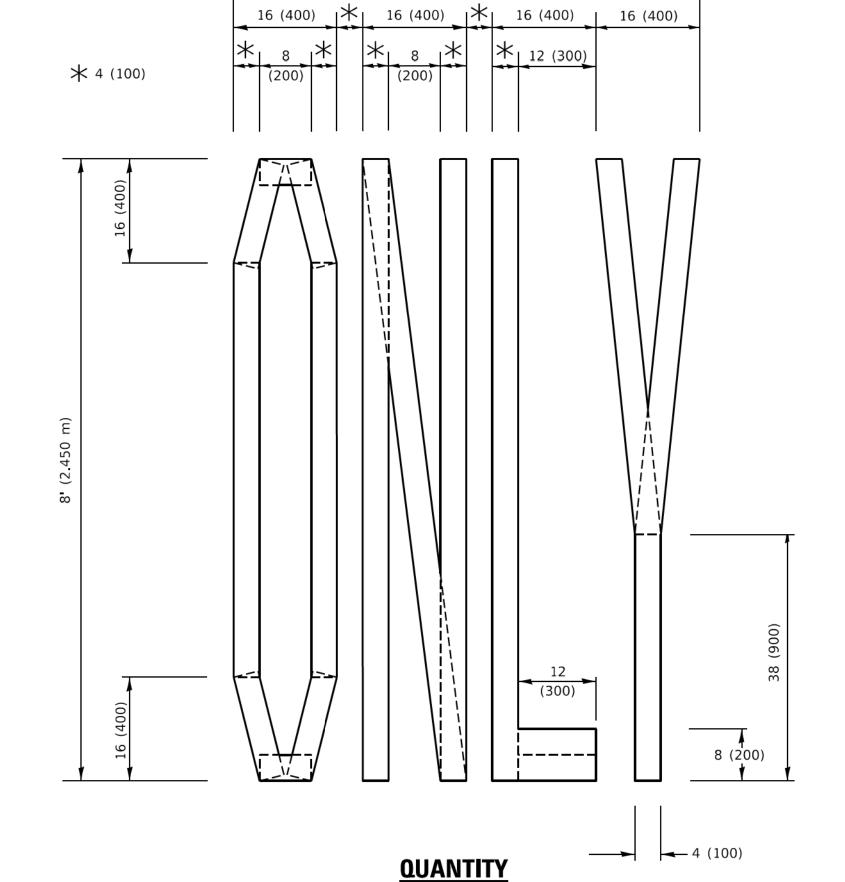

4 (100) LINE = 64.1 ft. (19.5 m)21.4 sq. ft. (1.99 sq. m)

DESIGNED -

CHECKED -


DATE - 09-18-94

DRAWN

USER NAME = footemj

PLOT DATE = 3/4/2019

PLOT SCALE = 50.0068 ' / in.

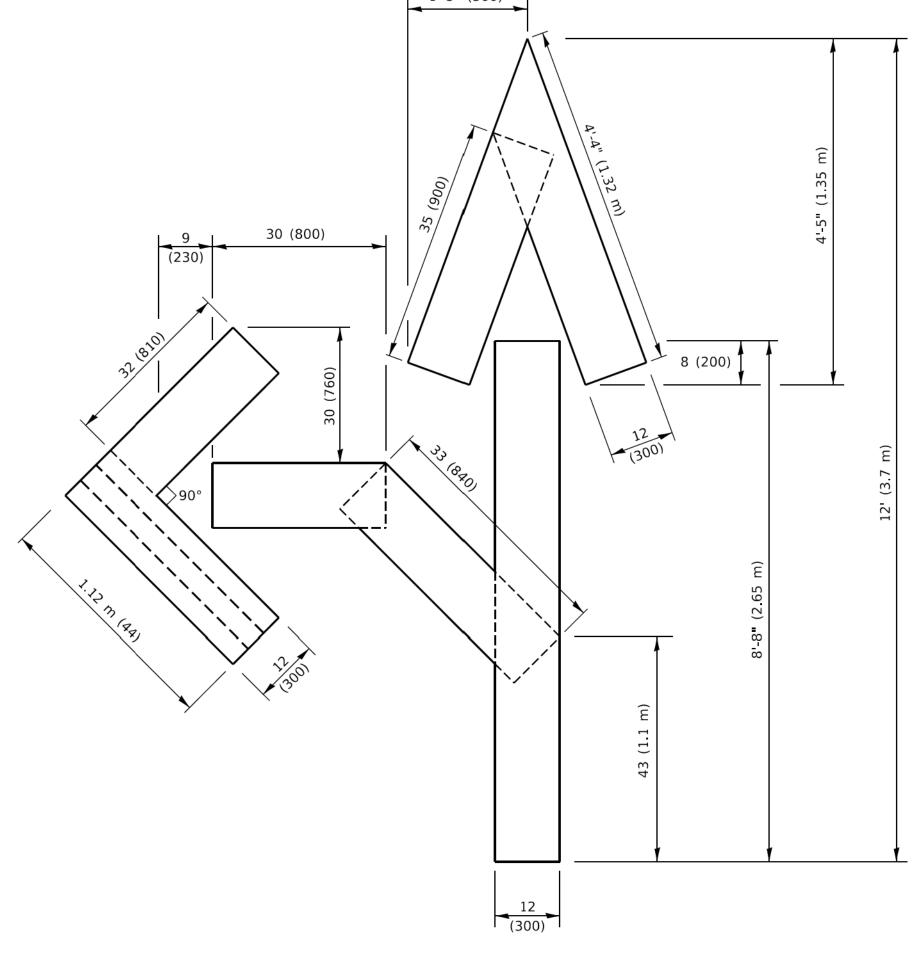


QUANTITY

4 (100) LINE = 82.5 ft. (25.1 m) 27.5 sq. ft. (2.53 sq. m)

NOTE:

ALL QUANTITIES OF PLACEMENT ARE REPRESENTED IN LINEAR FEET OF 4" LINES TO MATCH THE 4" TEMPORARY TAPE PAY ITEM AND REPRESENTS THE TOTAL QUANTITY OF 4" TAPE REQUIRED.

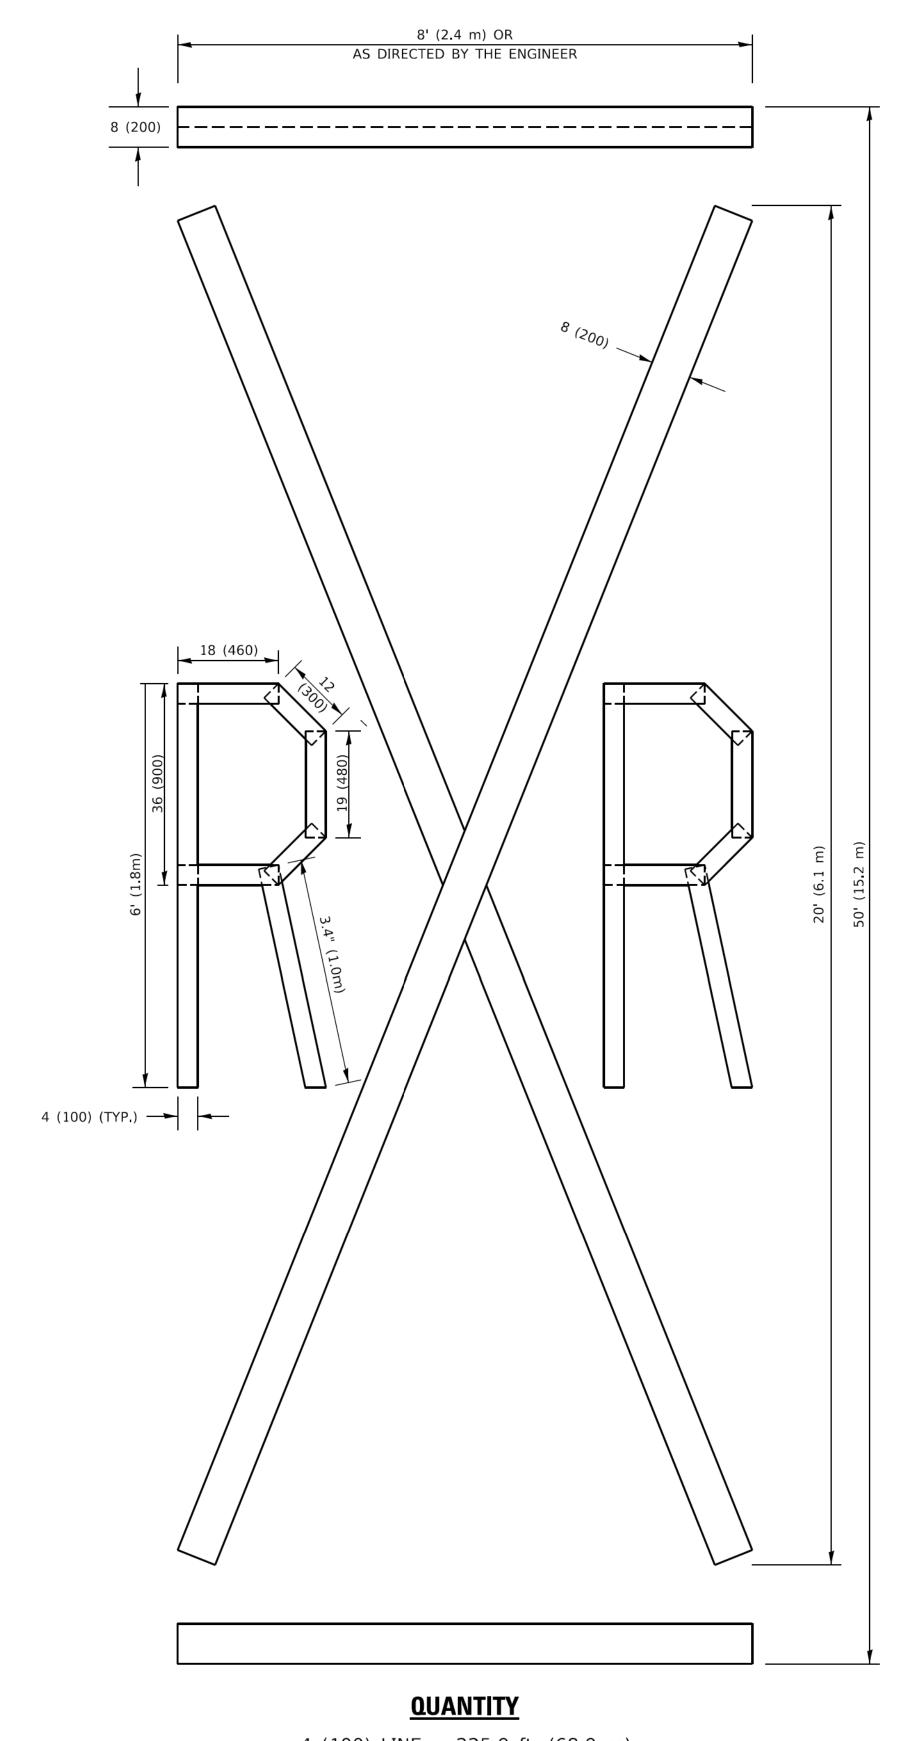

4 (100) LINE = 225.9 ft. (68.9 m) 75.3 sq. ft. (6.99 sq. m)


> All dimensions are in inches (millimeters) unless otherwise shown.

REVISED - T. RAMMACHER 03-02-98 REVISED - E. GOMEZ 08-28-00 REVISED - E. GOMEZ 08-28-00

REVISED - A. SCHUETZE 09-15-16

STATE OF ILLINOIS DEPARTMENT OF TRANSPORTATION

TOTAL SHEET NO. SECTION SHORT TERM PAVEMENT MARKING LETTERS AND SYMBOLS 67 64 19-00161-00-RS DUPAGE TC-16 CONTRACT NO. 61G29 SHEET 1 OF 1 SHEETS STA. SCALE: NONE TO STA. ILLINOIS FED. AID PROJECT

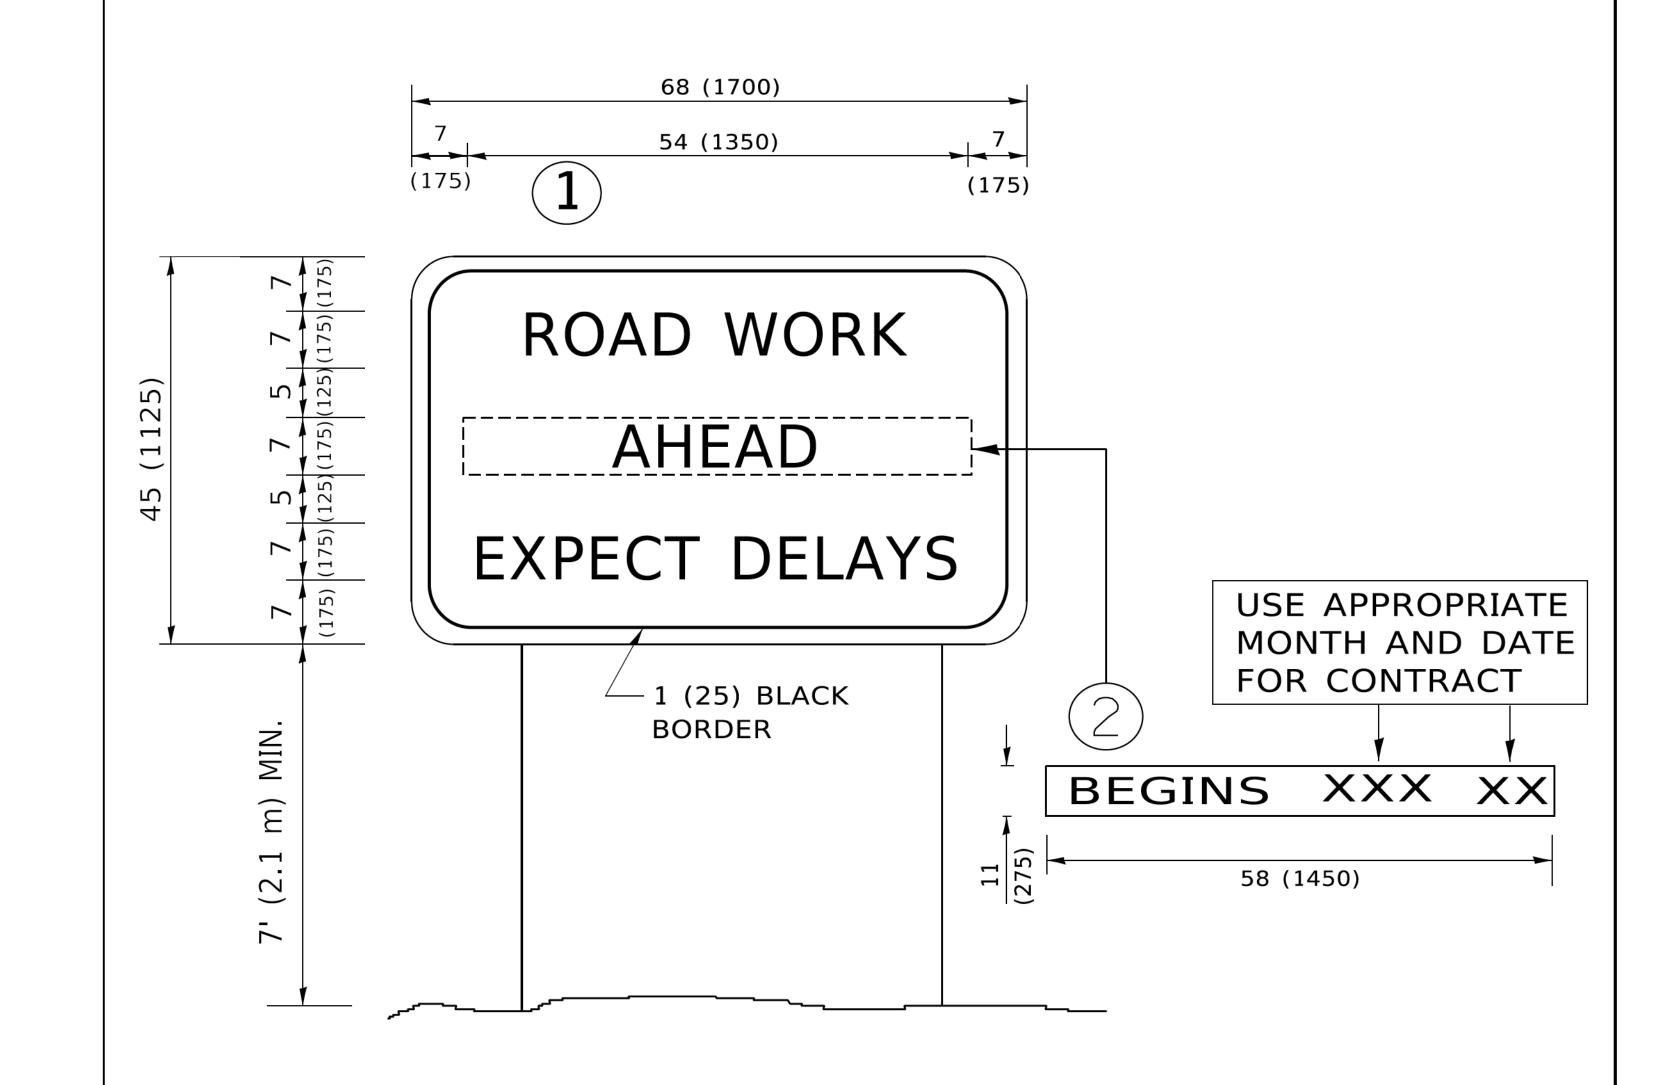

NOTES:

- 1. USE BLACK LETTERING ON ORANGE BACKGROUND.
- 2. ERECT SIGNS IN ADVANCE OF THE LOCATION FOR THE "ROAD CONSTRUCTION AHEAD" SIGN AT LOCATIONS AS DIRECTED BY THE ENGINEER.
- 3. ERECT SIGN 1 WITH INSTALLED PANEL 2 ONE WEEK PRIOR TO THE START OF CONSTRUCTION.
- 4. REMOVE PANEL 2 SOON AFTER THE START OF CONSTRUCTION.
- 5. SEE SPECIAL PROVISION FOR "TEMPORARY INFORMATION SIGNING" FOR ADDITIONAL INFORMATION.
- 6. ONE SIGN ASSEMBLY EQUALS 25.70 SQ. FT. (2.3 SQ. M.)
- 7. SHALL BE PAID FOR AS TEMPORARY INFORMATION SIGNING.

ALL DIMENSIONS ARE IN INCHES (MILLIMETERS)
UNLESS OTHERWISE SHOWN.

USER NAME = footemj	DESIGNED -	REVISED - R. MIRS 09-15-97			ARTERIAL ROAD		F.A.∪ RTE.	SECTION	COUNTY	SHEETS	NO.
	DRAWN -	REVISED - R. MIRS 12-11-97	STATE OF ILLINOIS				2611	19-00161-00-RS	DUPAGE	67	65
PLOT SCALE = 50.0000 ' / in.	CHECKED -	REVISED -T. RAMMACHER 02-02-99	DEL AITTIMENT OF THAIROF ON TATION			TC-22		CONTRACT NO. 610		29	
PLOT DATE = 3/4/2019	DATE -	REVISED - C. JUCIUS 01-31-07		SCALE: NONE	SHEET 1 OF 1 SHEETS STA.	TO STA.		ILLINOIS FED. AI	D PROJECT		

TURN BAY ENTRANCE AT START OF LANE CLOSURE TAPER


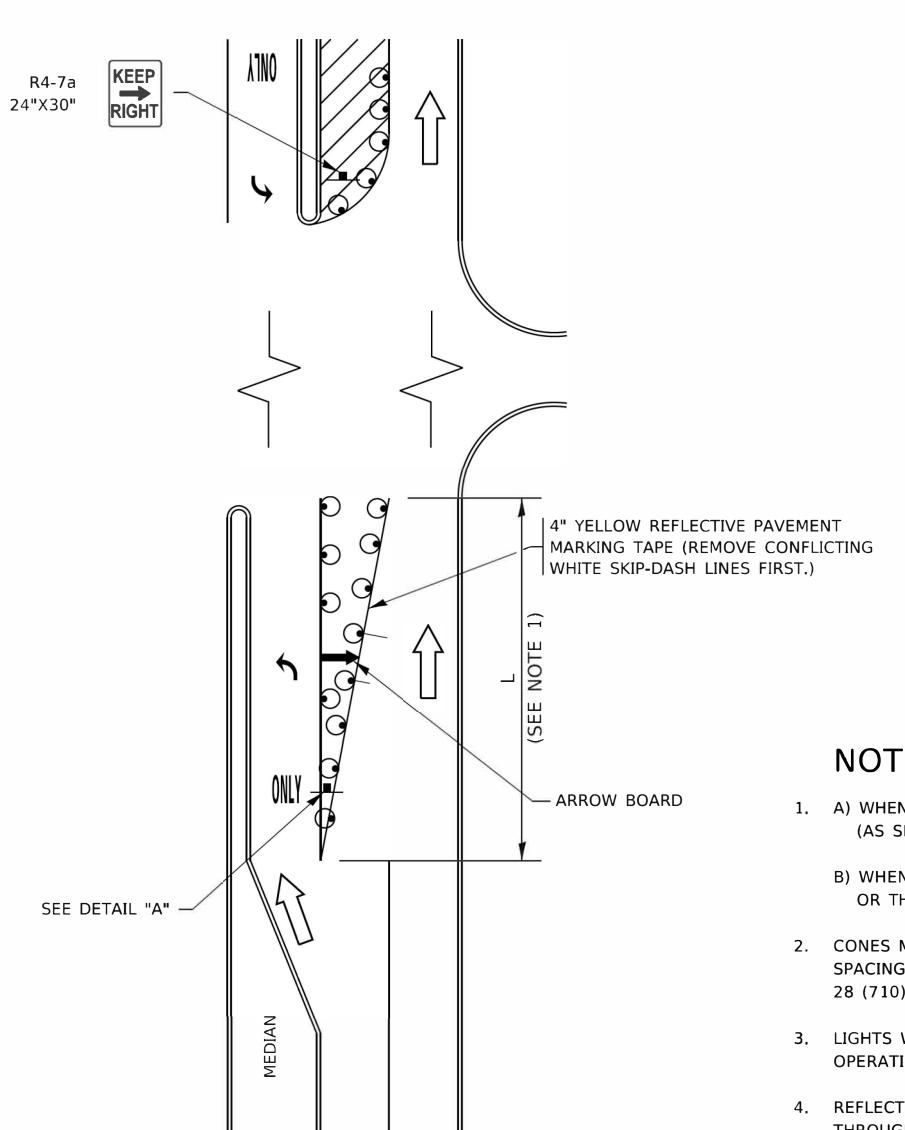



FIGURE 1

TURN BAY ENTRANCE WITHIN A LANE CLOSURE

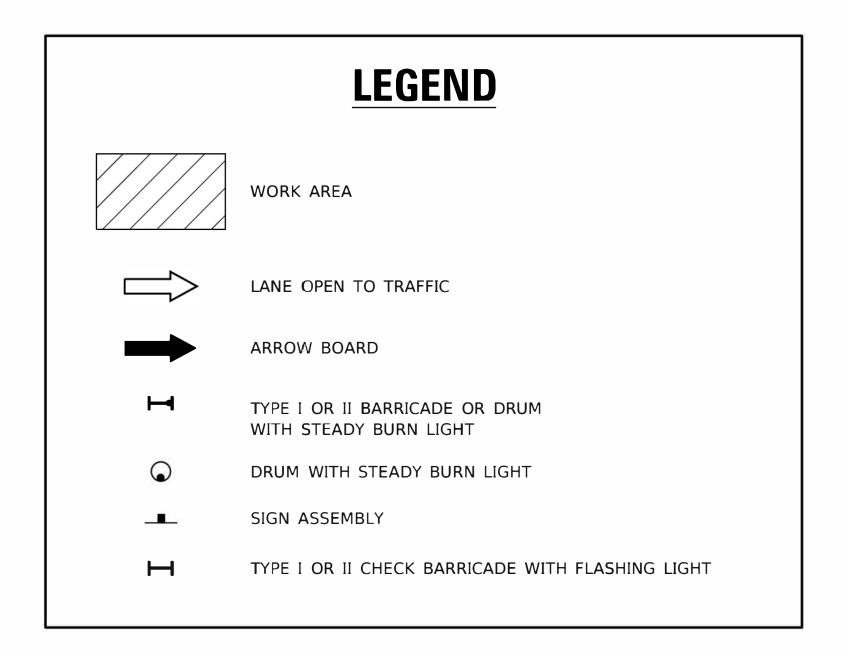

NOTES:

- 1. A) WHEN "L" IS ≤ THE STORAGE LENGTH OF THE TURN LANE (AS SHOWN IN FIG. 1), USE FIGURE 1.
 - B) WHEN "L" IS > THE STORAGE LENGTH OF THE TURN LANE OR THE TURN LANE IS WITHIN THE LANE CLOSURE, USE FIGURE 2.
- 2. CONES MAY BE SUBSTITUTED FOR BARRICADES OR DRUMS AT HALF THE SPACING DURING DAY OPERATIONS. CONES SHALL BE A MINIMUM OF 28 (710) IN HEIGHT.
- 3. LIGHTS WILL NOT BE REQUIRED ON BARRICADES OR DRUMS FOR DAY OPERATIONS. ALL LIGHTS SHALL BE MONODIRECTIONAL.
- 4. REFLECTIVE TEMPORARY PAVEMENT MARKINGS SHALL BE PLACED THROUGHOUT THE BARRICADED AREAS OF EACH TURN BAY AS SHOWN WHERE THE CLOSURE TIME IS GREATER THAN FOURTEEN (14) DAYS.
- 5. THIS APPLICATION ALSO APPLIES WHEN WORK IS BEING PERFORMED IN THE RIGHT LANE(S) AND THE RIGHT TURN BAY IS TO REMAIN OPEN. UNDER THIS CONDITION, "RIGHT TURN LANE" R3-I100R 24 x 24 (600 x 600) AND M6-2R 21 x 15 (530 x 380) SHALL BE USED.
- 6. THESE CONTROLS SHALL SUPPLEMENT MAINLINE TRAFFIC CONTROL FOR LANE CLOSURES.
- 7. THE SIGNS SHALL BE MOUNTED ABOVE THE BARRICADES/DRUMS ON SEPARATE SIGN SUPPORTS THAT MEET NCHRP 350 OR MASH PREQUIREMENTS.
- 8. TRAFFIC CONTROL AND PROTECTION AT TURN BAYS (TO REMAIN OPEN TO TRAFFIC) SHALL BE INCLUDED IN THE COST OF SPECIFIED TRAFFIC CONTROL STANDARDS OR ITEMS.

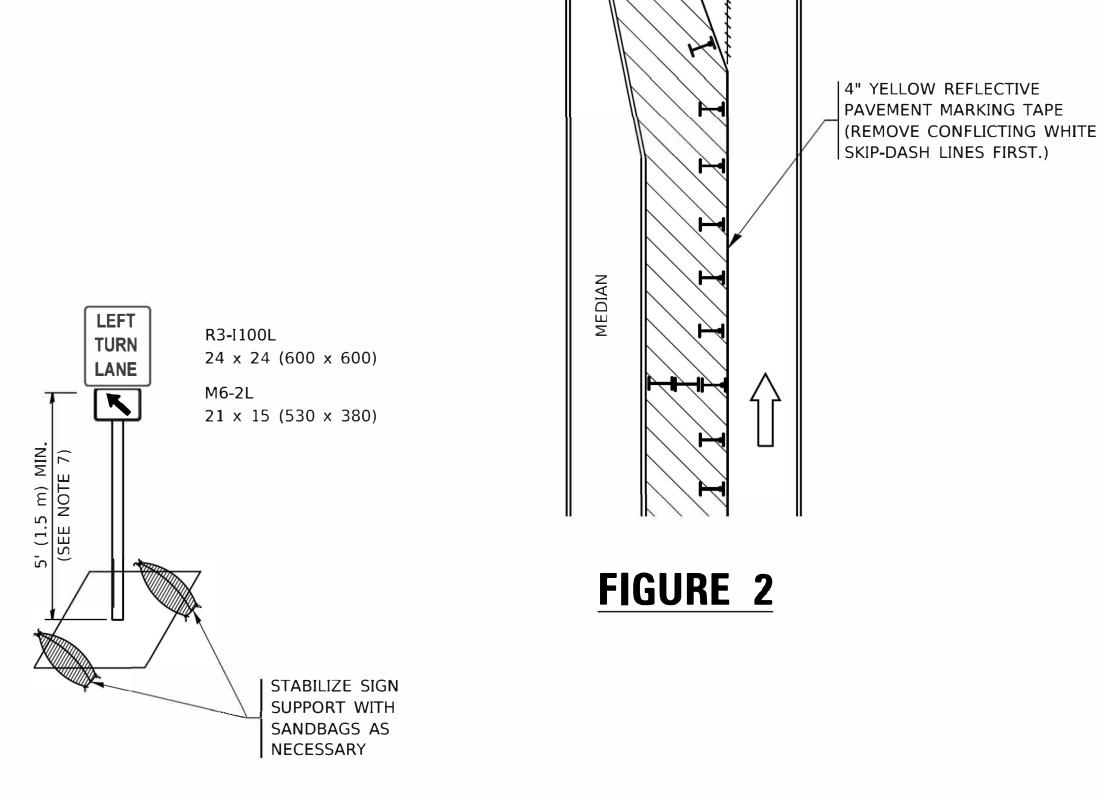

CONFLICTING |

REMOVAL (TYP.)

PAVEMENT MARKING

DETAIL A

SCALE: NONE

All dimensions are in inches (millimeters) unless otherwise shown.

TOTAL SHEET SHEETS NO.

67 66

— SEE DETAIL "A"


6" WHITE REFLECTIVE

PAVEMENT MARKING TAPE

USER NAME = footemj	DESIGNED	- I.	RAMMACHER 09-08-94	REVISED	-	R. BORO 09-14-09
	DRAWN	12 	A. HOUSEH 11-07-95	REVISED	- A	SCHUETZE 07-01-13
PLOT SCALE = 50.0000 ' / in.	CHECKED	*	A. HOUSEH 10-12-96	REVISED	- A	SCHUETZE 09-15-16
PLOT DATE $= 3/4/2019$	DATE	- T.	RAMMACHER 01-06-00	REVISED	-	

STATE OF ILLINOIS DEPARTMENT OF TRANSPORTATION

SECTION COUNTY TRAFFIC CONTROL AND PROTECTION AT TURN BAYS 19-00161-00-RS DUPAGE (TO REMAIN OPEN TO TRAFFIC) TC-24 CONTRACT NO. 61G29 SHEET 1 OF 1 SHEETS STA. TO STA. ILLINOIS FED. AID PROJECT

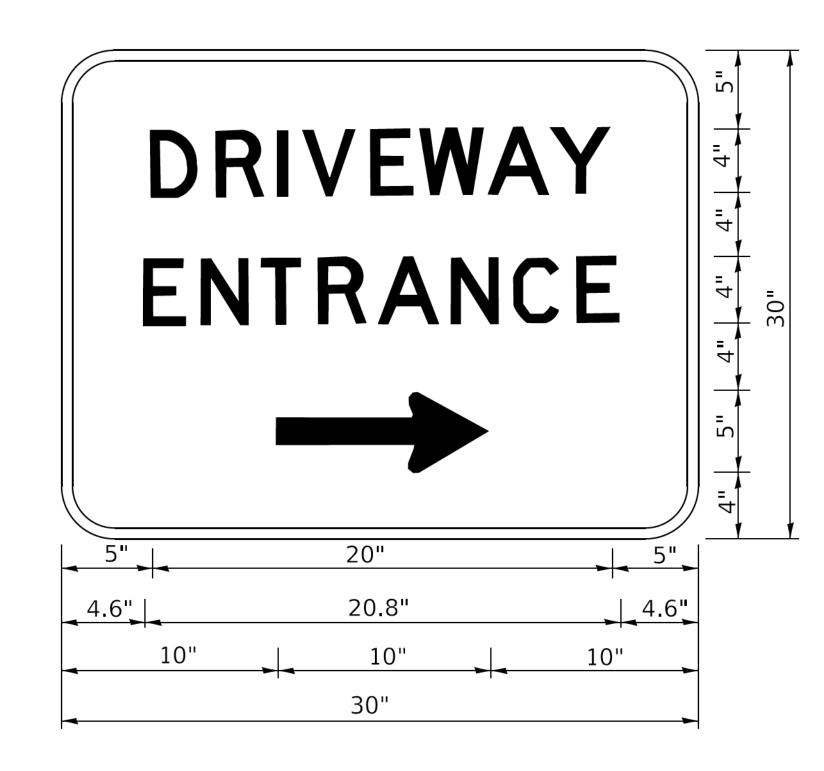

3.0" RADIUS, 0.5" BORDER, WHITE ON GREEN; REFLECTORIZED "DRIVEWAY" D; "ENTRANCE" D; STANDARD ARROW CUSTOM 12.0" x 5.0"

NOTES:

- 1. HALF OF THE SIGNS WILL REQUIRE A LEFT HAND FACING ARROW.
- 2. TWO SIGNS SHALL BE USED AT EACH COMMERCIAL ENTRANCE PLACED BACK-TO-BACK: ONE WITH A RIGHT HAND ARROW (SHOWN) SHALL BE PLACED ON THE NEAR RIGHT SIDE THE DRIVEWAY AND ONE WITH A LEFT HAND ARROW SHALL BE PLACED ON THE FAR LEFT SIDE OF THE DRIVEWAY.
- 3. SIGNS TO BE PAID FOR AS ITEM "TEMPORARY INFORMATION SIGNING".

USER NAME = footemj	DESIGNED -	REVISED -	C. JUCIUS 02-15-07
	DRAWN -	REVISED -	
PLOT SCALE = 50.0000 ' / in.	CHECKED -	REVISED -	
PLOT DATE = 3/4/2019	DATE -	REVISED -	

STATE OF ILLINOIS
DEPARTMENT OF TRANSPORTATION

SCALE: NONE

	DRIVEWAY ENTRANCE SIGNING							SEC	TION		COUNTY TOTAL SHEETS		SHEET NO.
DRIVEWAY ENTRANCE SIGNING				2611	19-0016	DUPAGE	67	67					
					TC-26			CONTRACT	NO. 61	G29			
SHEET	1	OF	2	SHEETS	STA.	TO STA.		ILLIN			D PROJECT		