CONSTRUCTION PLANS - ISSUED JANUARY 10, 2020


RECONSTRUCT BITUMINOUS T-HANGAR TAXILANE PAVEMENTS NEAR SOUTHEAST AREA OF MAIN RAMP

ST. LOUIS REGIONAL AIRPORT AUTHORITY **ST. LOUIS REGIONAL AIRPORT (ALN)** EAST ALTON, MADISON COUNTY, ILLINOIS

IDA PROJECT NO. : ALN-4348 SBG PROJECT NO.: 3-17-SBGP-144/TBD

SCOPE OF WORK:

THIS PROJECT CONSISTS OF RECONSTRUCTING THE BITUMINOUS T-HANGAR TAXILANE PAVEMENTS NEAR THE SOUTHEAST AREA OF THE MAIN RAMP. THIS PROJECT WILL INCLUDE EARTHWORK, PAVEMENT MILLING, PAVEMENT REMOVAL AND PLACEMENT, DRAINAGE AND PAVEMENT MARKING.

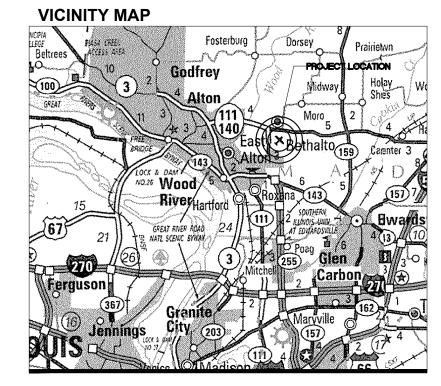

NOTICE TO CONTRACTORS AND BIDDERS

THESE CONSTRUCTION PLANS RELY UPON THE SPECIAL PROVISIONS AND THE SPECIFICATIONS TO PROVIDE FOR A COMPLETE DESCRIPTION OF THE WORK AND CONSTRUCTION REQUIREMENTS. THE PLANS SHALL ONLY BE USED IN COMBINATION WITH ALL CONTRACT DOCUMENTS

No.	Issue/Description	Sheets Changed	Date	Ву


Jon John	062.069664
aycen R. Herndon, P.E.	Da
Project Engineer	

MULTINGESSION EXP.

Date



SR093 **TOTAL SHEETS = 17**

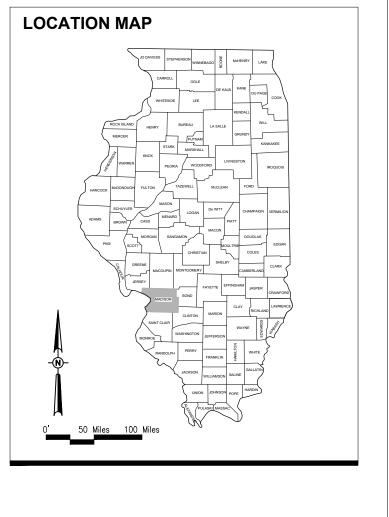



ITEM NO.	DESCRIPTION	UNIT	TOTAL	AS-BUILT
AR150510	ENGINEER'S FIELD OFFICE	L.S.	QUANTITY 1	QUANTITY
AR150520	MOBILIZATION	L.S.	1	
AR150540	HAUL ROUTE	L.S.	1	
AR152410	UNCLASSIFIED EXCAVATION	C.Y.	611	
AR156500	TEMPORARY EROSION CONTROL	L.S.	1	
AR156530	TEMPORARY SEEDING	ACRE	0.24	
AR156531	EROSION CONTROL BLANKET	S.Y.	1,172	
AR208540	OVERSIZE AGGREGATE	TON	1,041	
AR209510	CRUSHED AGGREGATE BASE COURSE	TON	1,047	
AR401613	BIT. SURF. CSEMETHOD I, SUPERPAVE	TON	1,975	
AR401900	REMOVE BITUMINOUS PAVEMENT	S.Y.	2,887	
AR401901	REMOVE BITUMINOUS SURFACE COURSE	S.Y.	5,613	
AR602510	BITUMINOUS PRIME COAT	GAL.	1,041	
AR603510	BITUMINOUS TACK COAT	GAL.	1,288	
AR620520	PAVEMENT MARKING-WATERBORNE	S.F.	799	
AR620525	PAVEMENT MARKING-BLACK BORDER	S.F.	843	
AR701900	REMOVE PIPE	L.F.	98	
AR705548	8" NON PERFORATED UNDERDRAIN	L.F.	20	
AR751411	INLET-TYPE A	EA.	1	
AR751900	REMOVE INLET	EA.	2	
AR751940	ADJUST INLET	EA.	1	
AR901510	SEEDING	ACRE	0.24	
	SUMMARY OF QUANTITIES - ADD	ITIVE ALTERN	ATE BID	
ITEM NO.	DESCRIPTION	UNIT	TOTAL QUANTITY	AS-BUILT QUANTITY
AS152410	UNCLASSIFIED EXCAVATION	C.Y.	988	
AS156530	TEMPORARY SEEDING	ACRE	0.03	
AS156531	EROSION CONTROL BLANKET	S.Y.	146	
AS208540	OVERSIZE AGGREGATE	TON	751	
AS209510	CRUSHED AGGREGATE BASE COURSE	TON	748	
AS401900	REMOVE BITUMINOUS PAVEMENT	S.Y.	2,033	
AS501507	7" PCC PAVEMENT	S.Y.	2,122	
AS501530	PCC TEST BATCH	EA.	1	
	SEEDING		0.03	

	INDEX TO SHEETS
SHEET NUMBER	SHEET TITLE
1	COVER SHEET
2	SUMMARY OF QUANTITIES AND INDEX TO SHE
3	SCOPE OF WORK
4	PROPOSED SAFETY AND PHASING PLAN - PHA
5	PROPOSED SAFETY AND PHASING PLAN - PHA
6	CONSTRUCTION SAFETY AND PHASING DETAI
7	TYPICAL SECTIONS
8	PROPOSED DEMOLITION PLAN
9	PROPOSED CONSTRUCTION PLAN
10	PROPOSED STAKING PLAN
11	PROPOSED STAKING PLAN (WEST)
12	PROPOSED STAKING PLAN (EAST)
13	PROPOSED JOINTING PLAN (ADD. ALT. BID)
14	PROPOSED JOINTING DETAILS AND NOTES (AI
15	PROPOSED MARKING PLAN
16	STORM WATER POLLUTION PREVENTION PLAY
17	STORM WATER POLLUTION PREVENTION DET

EARTHWORK QUANTITY SUMMARY					
WORK AREA	CUT (CY)	FILL (CY)	FILL + 20% (CY)	NET (CY)	
BASE BID	611**	24	29	582 (EXCESS)	
ADD. ALT. BID	988**	144	173	815 (EXCESS)	

** USED TO CALCULATE AR152410 AND AS152410 PAY ITEM QUANTITIES

EARTHWORK NOTES:

- EARTHWORK QUANTITIES (CUT/FILL VOLUMES) SHOWN ABOVE WERE 1. CALCULATED UTILIZING AUTODESK CIVIL3D 2018 SOFTWARE THROUGH AUTOCAD. THE CALCULATION METHOD WAS BY A COMPARISON OF SURFACE MODELS CREATED WITH EXISTING SURVEY DATA AND PROPOSED DESIGN GRADES. THE VOLUMES WERE CALCULATED IN TWO PARTS: THE CUT/FILL VOLUME REQUIRED TO CORE OUT AND FILL FOR THE PROPOSED PAVEMENT SECTION AS COMPARED TO THE EXISTING SUBGRADE DATUM, AND THE CUT/FILL VOLUMES REQUIRED FOR PROPOSED GRADING WORK OUTSIDE OF THE PROPOSED PAVEMENT LIMITS AS COMPARED TO THE EXISTING GROUND SURFACE. THE NUMBERS IN THE SUMMARY TABLES ABOVE REPRESENT A TOTAL OF THESE TWO PARTS ADDED TOGETHER FOR CLARITY.
- FOLLOWING THE PROJECT AWARD, THE ENGINEER CAN PROVIDE THE 2. RELEVANT AUTOCAD AND CIVIL 3D SURFACE MODEL FILES TO THE AWARDED CONTRACTOR UPON REQUEST TO ASSIST WITH CONSTRUCTION LAYOUT.

GENERAL NOTES:

QUANTITIES PAYMENT WILL BE MADE UNDER THE ITEM NUMBERS, DESCRIPTIONS AND UNITS NOTED IN THE ABOVE TABLE IN ACCORDANCE WITH THE BASIS OF PAYMENT FOR EACH RESPECTIVE WORK ITEM COMPLETED AND ACCEPTED BY THE ENGINEER

CERITIFIED PAYROLLS

THE RESIDENT ENGINEER/TECHNICIAN CANNOT FORWARD CONSTRUCTION REPORTS TO THE ILLINOIS DIVISION OF AERONAUTICS FOR PROCESSING UNTIL ALL CERTIFIED PAYROLLS FOR THE PERIOD HAVE BEEN RECEIVED.

MATERIAL CERTIFICATIONS MATERIALS TO BE INCORPORATED INTO THE PROJECT CANNOT BE USED WITHOUT PRIOR APPROVAL. ALL MATERIALS TO BE USED IN THE PROJECT MUST BE SUBMITTED TO THE RESIDENT ENGINEER/TECHNICIAN FOR APPROVAL. USE OF MATERIALS WITHOUT PRIOR APPROVAL AND ULTIMATELY DETERMINED TO BE UNACCEPTABLE BY THE ILLINOIS DIVISION OF AERONAUTICS ARE SUBJECT TO REMOVAL AND/OR NON-PAYMENT.

EETS
ASE 1
ASE 2
ILS AND NOTES
DD. ALT. BID)
N
AILS



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Illinois Licensed Professional Service Corporation #184-001084



ST. LOUIS REGIONAL AIRPORT AUTHORITY

ST. LOUIS REGIONAL AIRPORT 8 TERMINAL DRIVE EAST ALTON, ILLINOIS 62024



RECONSTRUCT BITUMINOUS T-HANGAR TAXILANE PAVEMENTS NEAR SOUTHEAST AREA OF MAIN RAMP

IDA No: ALN-4348

Contract No. SR093

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NO.	DATE	DES	CRIPT	ION
NO.	DATE	DES	DWN	REV
ISSUE:	ISSUE: JANUARY 10, 2020			
PROJECT NO: 19A0092				
CAD FIL	CAD FILE: G-002-FLP.DWG			

DESIGN BY: JRH 10/01/2019 DRAWN BY: JRH 10/01/2019 REVIEWED BY: BSS 01/08/2020

SHEET TITLE

SUMMARY OF QUANTITIES AND INDEX TO SHEETS

<u>UTILITY NOTE</u>

THE LOCATION, SIZE, AND TYPE OF MATERIAL OF EXISTING UNDERGROUND AND/OR ABOVEGROUND UTILITIES INDICATED ON THE PLANS ARE NOT REPRESENTED AS BEING ACCURATE, SUFFICIENT OR COMPLETE. NEITHER THE OWNER NOR THE ENGINEER ASSUMES ANY RESPONSIBILITY WHATSOEVER IN RESPECT TO THE ACCURACY, COMPLETENESS, OR SUFFICIENCY OF THE INFORMATION. THERE IS NO GUARANTEE, EITHER EXPRESSED OR IMPLIED, THAT THE LOCATIONS, SIZE AND TYPE OF MATERIAL OF EXISTING UNDERGROUND UTILITIES INDICATED ARE REPRESENTATIVE OF THOSE TO BE ENCOUNTERED IN THE CONSTRUCTION. IT SHALL BE THE CONTRACTOR'S RESPONSIBILITY TO DETERMINE THE ACTUAL LOCATION OF ALL SUCH. FACILITIES. INCLUDING SERVICE CONNECTIONS TO UNDERGROUND UTILITIES.

PRIOR TO CONSTRUCTION, THE CONTRACTOR SHALL NOTIFY THE UTILITY COMPANIES OF ITS OPERATIONAL PLANS AND SHALL OBTAIN FROM THE RESPECTIVE UTILITY COMPANIES DETAILED INFORMATION AND ASSISTANCE RELATIVE TO THE LOCATION OF THEIR FACILITIES AND THE WORKING SCHEDULE OF THE COMPANIES FOR REMOVAL OR ADJUSTMENT WHERE REQUIRED. IN THE EVENT AN UNEXPECTED UTILITY INTERFERENCE IS ENCOUNTERED DURING CONSTRUCTION, THE CONTRACTOR SHALL IMMEDIATELY NOTIFY THE UTILITY COMPANY OF JURISDICTION. THE OWNER'S REPRESENTATIVE AND THE RESIDENT ENGINEER/TECHNICIAN SHALL ALSO BE IMMEDIATELY NOTIFIED. ANY DAMAGE TO SUCH MAINS AND SERVICES SHALL BE RESTORED TO SERVICE AT ONCE AND PAID FOR BY THE CONTRACTOR AT NO ADDITIONAL COST TO THE CONTRACT. ALL UTILITY CABLES AND LINES SHALL BE LOCATED BY THE RESPECTIVE UTILITY. CONTACT JULIE (JOINT UTILITY LOCATION INFORMATION FOR EXCAVATORS) FOR UTILITY INFORMATION, PHONE: 1-800-892-0123. CONTACT THE FAA (FEDERAL AVIATION ADMINISTRATION) FOR ASSISTANCE IN LOCATING FAA CABLES AND UTILITIES. LOCATION OF FAA POWER, CONTROL, AND COMMUNICATION CABLES SHALL BE COORDINATED WITH AND LOCATED BY THE FAA. ALSO CONTACT AIRPORT MANAGER AND AIRPORT PERSONNEL FOR ASSISTANCE IN LOCATING UNDERGROUND AIRPORT CABLES AND UTILITIES. ALSO COORDINATE WORK WITH ALL ABOVEGROUND UTILITIES.

J.U.L.I.E. INFORMATION

COUNTY MADISON RETHAL TO TOWNSHIP ALTON - WOODRIVER SECTION NO. __13 & 18 ADDRESS _ST. LOUIS REGIONAL AIRPORT 8 TERMINAL DRIVE


EAST ALTON, ILLINOIS 62024 Simply Call 811 CONTROL POINT DATA

Call Before You Dig

N0.	DESCRIPTION	ELEV.
A	1"X2" CUT SQUARE ON LIGHT STANDARD ON NE SIDE	539.471
В	CUT-CROSS ON RIM ON GRATE INLET ON EAST SIDE OF RIM	539.154
C	CUT-CROSS ON RIM OF GRATE INLET ON NE SIDE OF RIM	539.162
1. AL	V <mark>EY NOTES</mark> LL COORDINATE VALUES SHOWN IN TABLE ARE BASED ON ILLINOIS FATE PLANE – WEST ZONE NAD-83 (2011).	

REFER TO IDOT STANDARD SPECIFICATIONS 50-06, CONSTRUCTION LAYOUT STAKES, FOR ADDITIONAL INFORMATION.



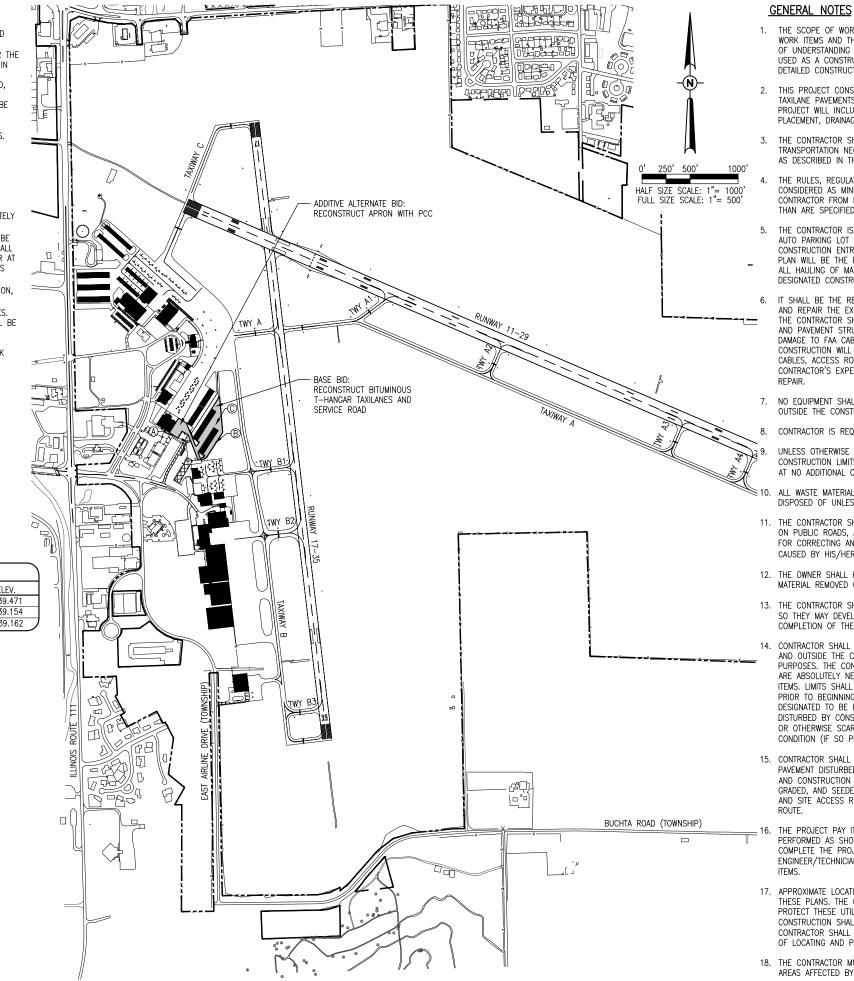

THE SCOPE OF WORK SHEET IS INTENDED ONLY AS A GENERAL DESCRIPTION OF WORK ITEMS AND THEIR APPROXIMATE LOCATIONS AND LIMITS, FOR THE PURPOSE OF UNDERSTANDING THE SCOPE OF THE PROJECT. THIS SHEET SHALL NOT BE USED AS A CONSTRUCTION PLAN. REFER TO THE FOLLOWING PLAN SHEETS FOR DETAILED CONSTRUCTION REQUIREMENTS, LOCATIONS, AND ITEMS OF WORK.

THIS PROJECT CONSISTS OF RECONSTRUCTING THE BITUMINOUS T-HANGAR TAXILANE PAVEMENTS NEAR THE SOUTHEAST AREA OF THE MAIN RAMP. THIS PROJECT WILL INCLUDE EARTHWORK, PAVEMENT MILLING, PAVEMENT REMOVAL AND PLACEMENT, DRAINAGE AND PAVEMENT MARKING.

THE CONTRACTOR SHALL FURNISH ALL LABOR, MATERIAL, EQUIPMENT, AND TRANSPORTATION NECESSARY TO CONSTRUCT ALL ELEMENTS OF THE PROJECT AS DESCRIBED IN THE CONSTRUCTION PLANS AND SPECIFICATIONS.

THE RULES, REGULATIONS, AND SPECIFICATIONS ENUMERATED HEREIN SHALL BE CONSIDERED AS MINIMUM REQUIREMENTS. THEY SHALL NOT PROHIBIT THE CONTRACTOR FROM FURNISHING AND INSTALLING HIGHER GRADES OF MATERIAL THAN ARE SPECIFIED HEREIN.

THE CONTRACTOR IS NOT PERMITTED TO USE THE AIRPORT ENTRANCE DRIVE AND AUTO PARKING LOT FOR MATERIAL AND EQUIPMENT HAULING OR STORAGE. THE CONSTRUCTION ENTRANCE AS SHOWN ON THE PROPOSED SAFETY AND PHASING PLAN WILL BE THE PRIMARY ACCESS TO THE PROPOSED CONSTRUCTION SITE. ALL HAULING OF MATERIALS AND EQUIPMENT SHALL BE RESTRICTED TO THE DESIGNATED CONSTRUCTION ENTRANCE.

IT SHALL BE THE RESPONSIBILITY OF THE CONTRACTOR TO PROTECT, PRESERVE AND REPAIR THE EXISTING AIRFIELD AND ROADWAY PAVEMENTS AT ALL TIMES. THE CONTRACTOR SHALL REPAIR ANY DAMAGE TO EXISTING ELECTRICAL, DRAINAGE AND PAVEMENT STRUCTURES AT NO ADDITIONAL COST TO THE CONTRACT, ANY DAMAGE TO FAA CABLES, ACCESS ROADS OR TO FAA FACILITIES DURING CONSTRUCTION WILL REQUIRE THE CONTRACTOR TO REPLACE THE DAMAGED CABLES, ACCESS ROAD OR FAA FACILITIES TO FAA REQUIREMENTS AT THE CONTRACTOR'S EXPENSE. SPLICING OF CABLES IS NOT AN ACCEPTABLE FORM OF

7. NO EQUIPMENT SHALL BE PERMITTED TO CROSS OR USE ANY EXISTING PAVEMENT OUTSIDE THE CONSTRUCTION LIMITS, GENERAL PROJECT AREA OR HAUL ROUTE.

CONTRACTOR IS REQUIRED TO PROVIDE THEIR OWN RESTROOM FACILITIES.

UNLESS OTHERWISE NOTED, ALL DISTURBED AREAS OUTSIDE OF THE PROPOSED CONSTRUCTION LIMITS SHALL BE GRADED, SEEDED AND/OR HYDROMULCH SEEDED AT NO ADDITIONAL COST TO THE CONTRACT

ALL WASTE MATERIAL SHALL BE HAULED FROM THE AIRPORT AND PROPERLY DISPOSED OF UNLESS OTHERWISE SPECIFIED HEREIN.

11. THE CONTRACTOR SHALL BE RESPONSIBLE FOR OBTAINING PERMITS FOR HAULING ON PUBLIC ROADS, AS APPLICABLE. THE CONTRACTOR SHALL BE RESPONSIBLE FOR CORRECTING ANY DAMAGES TO ANY PAVEMENTS (PUBLIC OR PRIVATE) CAUSED BY HIS/HER CONSTRUCTION EQUIPMENT OR PERSONNEL.

12. THE OWNER SHALL HAVE THE RIGHT OF FIRST REFUSAL FOR ALL SALVAGEABLE MATERIAL REMOVED ON THE PROJECT.

13. THE CONTRACTOR SHALL COORDINATE WITH THE RESIDENT ENGINEER/TECHNICIAN SO THEY MAY DEVELOP ONE SET OF REDLINED AS-BUILT DRAWINGS AT THE COMPLETION OF THE PROJECT.

14. CONTRACTOR SHALL NOTE THAT ALL AREAS WITHIN THE AIRPORT PROPERTY LINE AND OUTSIDE THE CONSTRUCTION LIMITS MAY BE USED FOR AGRICULTURAL PURPOSES. THE CONSTRUCTION LIMITS SHALL BE RESTRICTED TO AREAS THAT ARE ABSOLUTELY NECESSARY TO DISTURB TO COMPLETE THE REQUIRED WORK ITEMS. LIMITS SHALL BE COORDINATED WITH THE RESIDENT ENGINEER/TECHNICIAN PRIOR TO BEGINNING ANY WORK. ALL AREAS WHICH HAVE BEEN FARMED AND OR DESIGNATED TO BE FARMED AFTER THE PROJECT COMPLETION, AND HAVE BEEN DISTURBED BY CONSTRUCTION ACTIVITY, SHALL BE CHISEL PLOWED (36" MAX.) OR OTHERWISE SCARIFIED TO RETURN THE AREA TO A REASONABLE TILLABLE CONDITION (IF SO PERMITTED BY THE AIRPORT MANAGER.)

15. CONTRACTOR SHALL RESTORE TO ORIGINAL CONDITION ALL GRASS, STONE, OR PAVEMENT DISTURBED BY CONTRACTOR'S CONSTRUCTION OPERATIONS, STAGING, AND CONSTRUCTION ACCESS ROUTES, DISTURBED AREAS TO BE REPAIRED. GRADED, AND SEEDED AND MULCHED UNLESS OTHERWISE NOTED, STAGING AREA AND SITE ACCESS RESTORATION SHALL BE INCLUDED IN THE COST OF THE HAUL

THE PROJECT PAY ITEMS ARE INTENDED TO BE INCLUSIVE OF ALL WORK TO BE PERFORMED AS SHOWN IN THESE PLANS. ALL INCIDENTAL WORK REQUIRED TO COMPLETE THE PROJECT TO THE SATISFACTION OF THE RESIDENT ENGINEER/TECHNICIAN IS TO BE INCLUDED IN THE COSTS OF PERFORMING THESE

17. APPROXIMATE LOCATIONS OF UNDERGROUND UTILITIES ARE SHOWN THROUGHOUT THESE PLANS. THE CONTRACTOR SHALL DETERMINE EXACT LOCATIONS AND PROTECT THESE UTILITIES DURING CONSTRUCTION. ANY UTILITIES DAMAGED DURING CONSTRUCTION SHALL BE REPAIRED AT THE CONTRACTOR'S EXPENSE. CONTRACTOR SHALL COORDINATE WITH THE PROPER PERSONS FOR THE PURPOSE OF LOCATING AND PROTECTING EXISTING UNDERGROUND UTILITIES

18. THE CONTRACTOR MUST AT ALL TIMES MAINTAIN PROPER DRAINAGE FOR ALL AREAS AFFECTED BY HIS WORK.



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ST. LOUIS REGIONAL AIRPORT AUTHORITY

ST. LOUIS REGIONAL AIRPORT 8 TERMINAL DRIVE EAST ALTON, ILLINOIS 62024



RECONSTRUCT BITUMINOUS T-HANGAR TAXILANE PAVEMENTS NEAR SOUTHEAST AREA OF MAIN RAMP

IDA No: ALN-4348


Contract No. SR093

NO.	DATE	DESCRIPTIO		ION
110.	DATE	DES	DWN	REV
ISSUE: JANUARY 10, 2020				

PROJECT NO: 19A0092 CAD FILE: G-003-SOW.DWG DESIGN BY: JRH 10/01/2019 DRAWN BY: JRH 10/01/2019 REVIEWED BY: BSS 01/08/2020

SHEET TITLE

SCOPE OF WORK

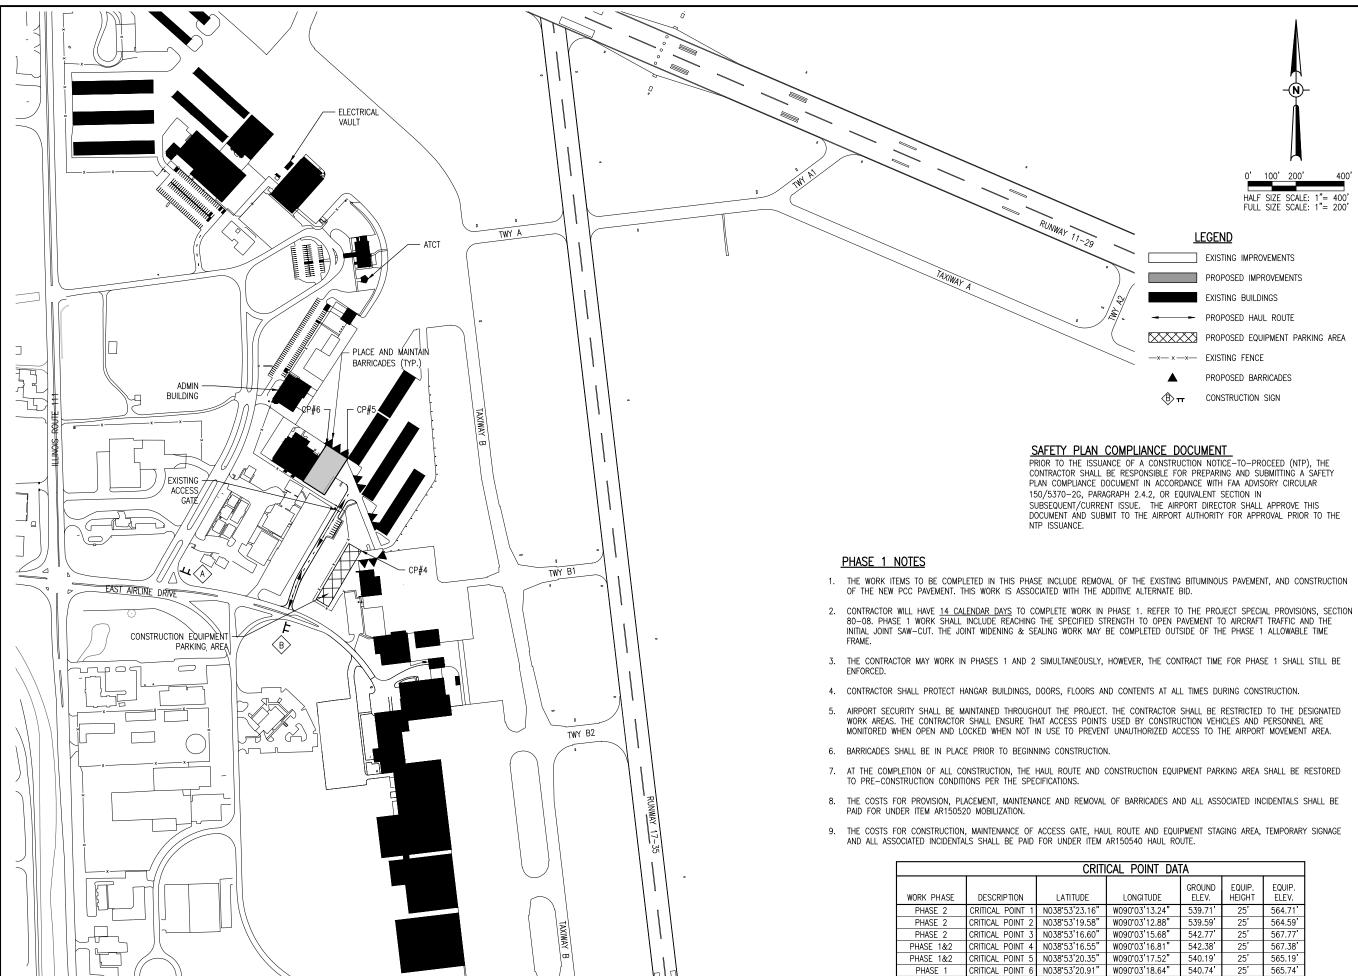

POINT DATA					
ONGITUDE	GROUND ELEV.	EQUIP. HEIGHT	EQUIP. ELEV.		
0°03'13.24"	539.71'	25'	564.71'		
0°03'12.88"	539.59'	25'	564.59'		
0°03'15.68"	542.77'	25'	567.77'		
0°03'16.81"	542.38'	25'	567.38'		
0°03'17.52"	540.19'	25'	565.19'		
0°03'18.64"	540.74'	25'	565.74'		





8 TERMINAL DRIVE EAST ALTON, ILLINOIS 62024

RECONSTRUCT BITUMINOUS T-HANGAR TAXILANE PAVEMENTS NEAR SOUTHEAST AREA OF MAIN RAMP

IDA No: ALN-4348


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NO	DATE	NO. DATE	DESCRIPTION		
NO.	DATE	DES	DWN	REV	
ISSUE:	JANUAF	RY 10,	2020		
PROJECT NO: 19A0092					

CAD FILE: G-004-SFY.DWG DESIGN BY: JRH 10/01/2019 DRAWN BY: JRH 10/01/2019 REVIEWED BY: BSS 01/08/2020

SHEET TITLE

PROPOSED SAFETY AND PHASING PLAN -PHASE 1

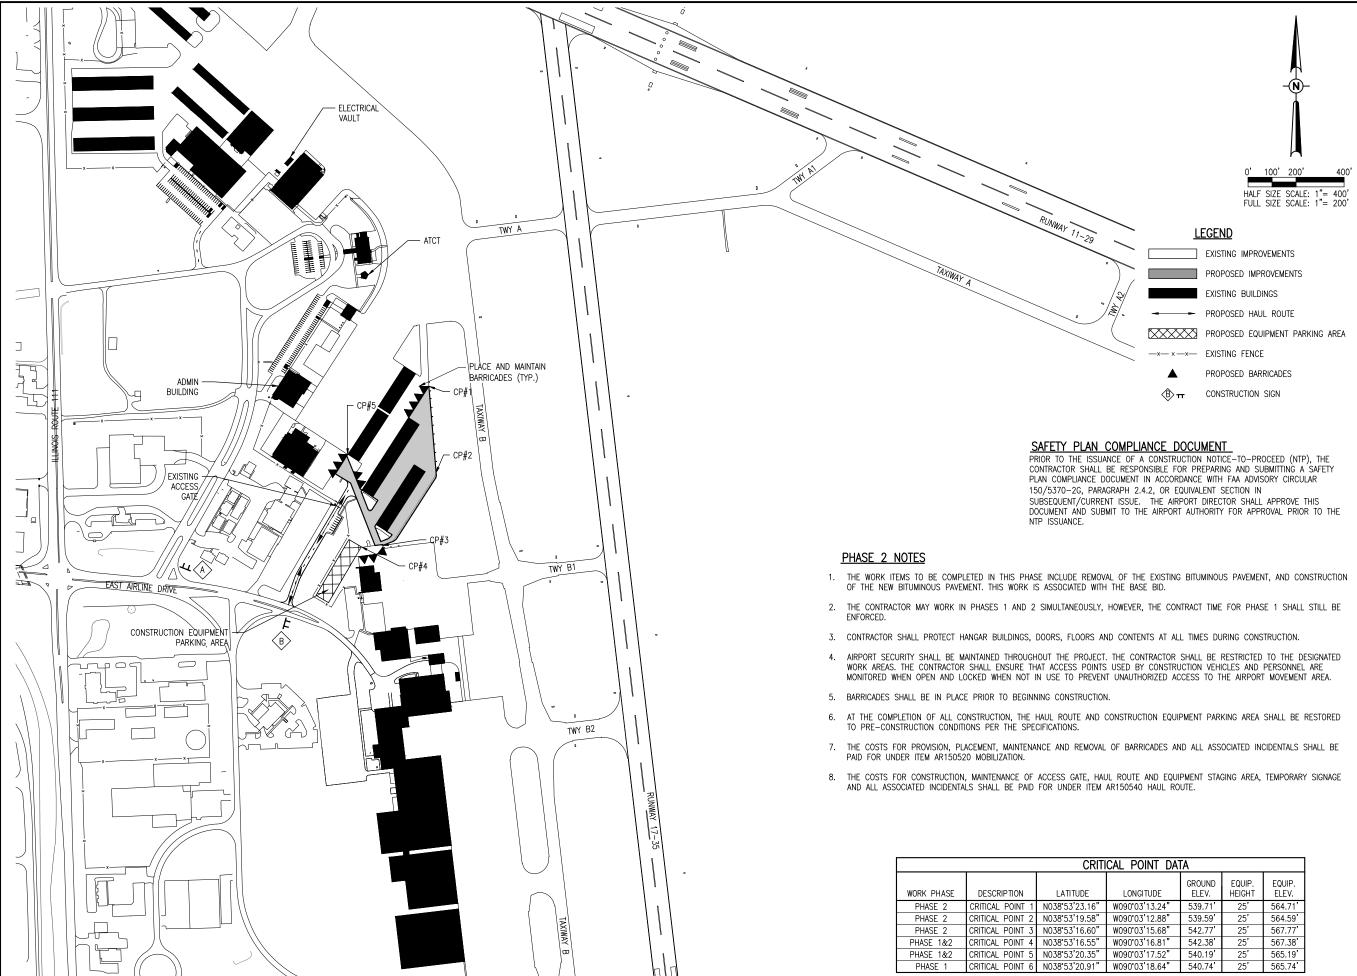

POINT DATA						
ONGITUDE	GROUND ELEV.	EQUIP. HEIGHT	EQUIP. ELEV.			
90°03'13.24"	539.71'	25'	564.71'			
90°03'12.88"	539.59'	25'	564.59'			
90°03'15.68"	542.77'	25'	567.77'			
90°03'16.81"	542.38'	25'	567.38'			
90°03'17.52"	540.19'	25'	565.19'			
90°03'18.64"	540.74'	25'	565.74'			



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ST. LOUIS REGIONAL AIRPORT AUTHORITY ST. LOUIS REGIONAL AIRPORT

8 TERMINAL DRIVE EAST ALTON, ILLINOIS 62024



RECONSTRUCT BITUMINOUS T-HANGAR TAXILANE PAVEMENTS NEAR SOUTHEAST AREA OF MAIN RAMP

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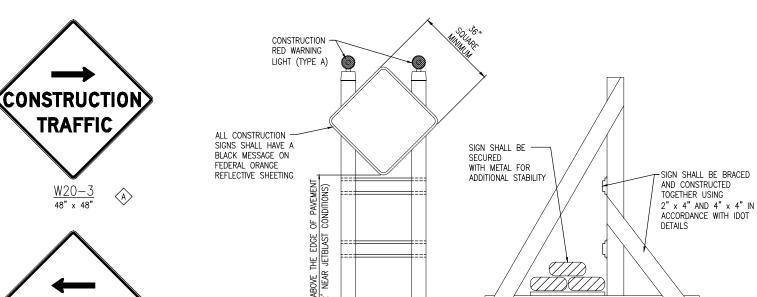
Contract No. SR093

NO.	DATE	DES	CRIPT	ION	
NO. DATE	DES	DWN	REV		
ISSUE: JANUARY 10, 2020					
PROJEC	CT NO: 1	9A009	2		

CAD FILE: G-004-SFY.DWG DESIGN BY: JRH 10/01/2019 DRAWN BY: JRH 10/01/2019 REVIEWED BY: BSS 01/08/2020

SHEET TITLE

PROPOSED SAFETY AND PHASING PLAN -PHASE 2




FRONT VIEW

SIGNAGE NOTES

ALL CONSTRUCTION SIGNS AND TRAFFIC CONTROL DEVICES SHALL CONFORM TO THE MANUAL ON UNIFORM TRAFFIC CONTROL DEVICES INCLUDING THE ILLINOIS SUPPLEMENT (LATEST EDITION) AND THE FAA ADVISORY CIRCULARS (LATEST EDITION) UNLESS NOTED OTHERWISE. THE FAA OR MORE STRINGENT SPECIFICATIONS SHALL GOVERN

SIDE VIEW

- UNLESS OTHERWISE SPECIFIED. CONSTRUCTION SIGNS SHALL BE MOUNTED ON PORTABLE OR 2. NON-PORTABLE SUPPORTS. A PORTABLE SUPPORT IS DEFINED AS A TYPICAL SIGN STANDARD AS SHOWN ON THIS SHEET, OR A SMALL LIGHT WEIGHT TRAILER. A NON-PORTABLE SUPPORT IS DEFINED AS DRIVEN METAL OR WOOD POST. ALL SIGNS, REGARDLESS OF THE TYPE OF SUPPORTS USED, SHALL BE MOUNTED SUCH THAT THE MESSAGE ON THE SIGN IS LEVEL IN THE HORIZONTAL PLANE AFTER PLACEMENT. THE COST OF CONSTRUCTION WARNING LIGHTS SHALL BE INCLUDED IN THE COST OF THE CONSTRUCTION SIGNS.
- CONSTRUCTION RED WARNING LIGHT: THESE ARE PORTABLE, LENS DIRECTED, ENCLOSED LIGHTS. THE 3. COLOR OF THE LIGHT EMITTED SHALL BE RED. THEY ARE TO BE USED IN A LOW INTENSITY FLASHING MODE (TYPE A)
- 4. THE LIGHTING SHALL BE MAINTAINED IN OPERATION DURING THE HOURS OF DARKNESS BETWEEN 1/2 HOUR AFTER SUNSET AND 1/2 HOUR BEFORE SUNRISE AND WHEN CONDITIONS EXIST WHICH TEND TO OBSCURE VISION
- COST FOR PROVIDING, PLACING, MAINTAINING, AND REMOVING SIGNS SHALL BE INCLUDED IN ITEM AR150540 HAUL ROUTE.

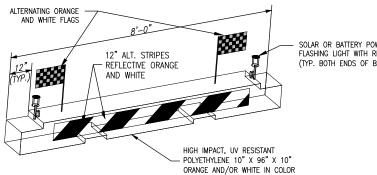

LOW-PROFILE BARRICADE DETAIL TO SCALE

DETAIL ABOVE REPRESENTS ONE OPTION FOR LOW-PROFILE BARRICADES. OTHER OPTIONS MAY BE UTILIZED AS LONG AS THEY MEET THE REQUIREMENTS OF THE PROJECT. INCLUDING BARRICADE NOTE 1.

SAFETY NOTES

- PROJECT. ADDITIONAL REQUIREMENTS ARE SHOWN ON THE CONSTRUCTION SAFETY AND PHASING PLAN SHEET AND THIS SHEET.
- 2. ALL PROVISIONS OF THE LATEST EDITION OF FAA ADVISORY CIRCULAR AC 150/5370-2 (CURRENT EDITION), "OPERATIONAL SAFETY ON AIRPORTS DURING CONSTRUCTION", APPLY TO THIS CONTRACT, EXCEPT AS MODIFIED BY THIS SAFETY PLAN, OR AS MODIFIED BY THE OWNER THROUGH THE RESIDENT ENGINEER/TECHNICIAN AT THE PRECONSTRUCTION CONFERENCE, OR DURING THE COURSE OF THE CONTRACT
- 3. THE CONTRACTORS SHALL MINIMIZE DISRUPTION OF STANDARD OPERATING PROCEDURES FOR AERONAUTICAL ACTIVITY BY REMAINING WITHIN THE PRESCRIBED STAGING, CONSTRUCTION, AND PHASING AREAS PRESENTED ON THE CONSTRUCTION SAFETY AND PHASING PLAN SHEETS
- 4. NO UNAUTHORIZED PERSONNEL SHALL ENTER ANY AREA OF THE AIRPORT THAT COULD POTENTIALLY BE HAZARDOUS. THE AIRPORT MANAGER RESERVES THE RIGHT TO SUSPEND OPERATIONS IN ORDER TO MAINTAIN SAFETY AT THE AIRPORT.
- CONTRACTOR EQUIPMENT, VEHICLES, AND PROJECT MATERIALS SHALL BE STORED IN THE EQUIPMENT PARKING/STAGING AREA SHOWN ON THE PLAN VIEW, EXCEPT AS OTHERWISE PROVIDED FOR AT THE PRECONSTRUCTION CONFERENCE.
- 6. ALL CONSTRUCTION EQUIPMENT OPERATING IN THE PRESCRIBED CONSTRUCTION AREA IS REQUIRED TO DISPLAY A MARKING, AND LIGHTING OF VEHICLES USED ON AN AIRPORT" LATEST EDITION.
- 7. NO CONSTRUCTION MATERIAL STOCKPILES SHALL BE LOCATED WITHIN 250' OF ANY ACTIVE RUNWAY, WITHIN 93' OF ANY OTHER ACTIVE AIRPORT OPERATIONS AREA, OR PENETRATE A PART 77 IMAGINARY SURFACE (PROVIDED BY THE RESIDENT ENGINEER/TECHNICIAN) EXTENDING OUT AND UPWARDS FROM ALL SIDES OF AN ACTIVE RUNWAY
- 8. CLOSED AIRFIELD PHASING AREAS, OPEN TRENCHES, AND STOCKPILED MATERIALS AT THE CONSTRUCTION SITE SHALL BE PROMINENTLY MARKED WITH LIGHTED BARRICADES WITH STEADY BURNING OR FLASHING RED LIGHTS AS SPECIFIED IN 150/5370-2, "OPERATIONAL SAFETY ON AIRPORT DURING CONSTRUCTION, LATEST EDITION, LIGHTED BARRICADES MUST BE NO TALLER THAN 18" (EXCLUSIVE OF SUPPLEMENTARY LIGHTS AND FLAGS) ON THE TAXIWAYS AND COMPLY WITH ADVISORY CIRCULAR 150/5370-2, LATEST EDITION, CONTRACTOR SHALL NIGHT CHECK BARRICADES DAILY FOR PROPER OPERATION.
- 9 NO OPEN TRENCHES WITHIN 250' OF AN ACTIVE RUNWAY CENTERLINE OR WITHIN 93' OF ANY AIRPORT OPERATIONS AREA WILL BE PERMITTED UNLESS PROPERLY MARKED. OTHER TRENCHES SHALL BE MAINTAINED SAFE, I.E., BARRICADED OR COVERED WITH STEEL PLATES IN ALL OTHER AREAS.
- 10. OPEN TRENCHES, EXCAVATIONS, AND STOCKPILED MATERIALS AT THE CONSTRUCTION SITE SHOULD BE PROMINENTLY DARKNESS
- TALLER THAN 25' MAY BE PERMITTED WITH THE APPROVAL OF THE AIRPORT MANAGER AND AIRSPACE APPROVAL BY THE
- ARE PROVIDED AND HAVE BEEN APPROVED BY THE AIRPORT MANAGER NO FLARE POTS ARE ALLOWED ON THE PROJECT.
- 13. SOIL, DEBRIS, AND LOOSE MATERIAL DROPPED OR TRUCKED ONTO AIRPORT ROADS, TAXIWAYS, AND SOD SURFACES, OR CLOSED CONTAINERS. ANY DAMAGE TO AIRPORT PROPERTY SHALL BE REPAIRED IMMEDIATELY AT NO COST TO THE OWNER.
- 14. EACH CONTRACTOR SHALL BE RESPONSIBLE FOR LOCATING AND MAINTAINING AIRPORT LIGHTING AND NAVIGATIONAL ELECTRICAL SYSTEMS DURING CONSTRUCTION. A CONTACT PERSON AND TELEPHONE NUMBER FOR 24 HOUR EMERGENCY IMMEDIATE REPAIR SHALL BE SUBMITTED TO THE AIRPORT MANAGER AND RESIDENT ENGINEER/TECHNICIAN HAUL ROUTES. CROSSING PAVEMENT, DRAINAGE, MISCELLANEOUS. STRUCTURES AND/OR AIRFIELD CABLES SHALL BE PROTECTED FROM DAMAGE
- 15. ALL AIRCRAFT AND AIRPORT OPERATIONS HAVE THE RIGHT-OF-WAY. CONTRACTOR TO YIELD TO VEHICLES AND REMAIN CLEAR AT ALL TIMES.
- 16. CONTRACTOR SHALL PLACE, SECURE, AND MAINTAIN LIGHTED BARRICADES AND CLOSURE CROSSES WHEN A RUNWAY/TAXIWAY/APRON IS CLOSED OR AS REQUIRED BY THE PLANS AND DESIGNATED BY THE RESIDENT ENGINEER / TECHNICIAN.
- 17. CONTRACTOR SHALL MARK HAZARDOUS AREA WITH STEADY-BURNING OR FLASHING RED LIGHTS DURING PERIODS OF LOW VISIBILITY AS REQUIRED.
- 18. THE CONTRACTOR SHALL PERIODICALLY PERFORM ONSITE INSPECTIONS THROUGHOUT THE DURATION OF THE PROJECT WITH THE IMMEDIATE REMEDY OF ANY DIFFERENCES, WHETHER CAUSED BY NEGLIGENCE, OVERSIGHT, OR PROJECT SCOPE CHANGE.
- 19. CONTRACTOR SHALL MOVE MAINTENANCE OF TRAFFIC COMPONENTS AT THE WRITTEN DIRECTION OF THE RESIDENT ENGINEER/TECHNICIAN AT NO ADDITIONAL COST.
- 20. CONTRACTOR SHALL NOT REMOVE THE BARRICADES WITHOUT THE APPROVAL BY THE RESIDENT ENGINEER/TECHNICIAN.
- 21. CONTRACTOR SHALL MAINTAIN FLASHERS, SIGNS AND/OR BARRICADES AS REQUIRED BY THE PLANS, CITY OR COUNTY REGULATIONS OR CONTRACTOR ACTIVITIES. CONTRACTOR SHALL OBTAIN ANY AND ALL REQUIRED LOCAL PERMITS UNLESS SPECIFIED OTHERWISE.
- 22. THE CONTRACTOR SHALL UTILIZE WATER AND/OR CHEMICALS APPROVED BY THE RESIDENT ENGINEER/TECHNICIAN AS NECESSARY TO CONTROL DUST
- 23. NO CONSTRUCTION VEHICLES SHALL BE DRIVEN ACROSS ANY ACTIVE RUNWAY, INCLUDING TURF RUNWAYS. CONSTRUCTION EQUIPMENT OR CONSTRUCTION ACTIVITY WILL NOT BE PERMITTED WITHIN 250' OF ANY ACTIVE RUNWAY CENTERLINE OR WITHIN 93' OF ANY OTHER ACTIVE AIRPORT TAXIWAY OR APRON. HOWEVER, CONSTRUCTION MAY BE PERMITTED IN THESE AREAS IF THE CONTRACTOR HAS GAINED APPROVAL FROM THE AIRPORT MANAGER AT LEAST 7 DAYS IN ADVANCE OF THE BY THE AIRPORT MANAGER TO THE APPROPRIATE FLIGHT SERVICE STATION.
- 24. UNLESS SPECIFIED OTHERWISE, COST FOR THE ABOVE IS TO BE CONSIDERED INCIDENTAL TO THE PROJECT, SEPARATE PAYMENT SHALL NOT BE MADE.



CONSTRUCTION SIGNS

NOT TO SCALE

BARRICADE NOTES

- 1. ALL CONSTRUCTION SIGNS AND TRAFFIC CONTROL DEVICES SHALL CONFORM TO THE MANUAL ON UNIFORM TRAFFIC CONTROL DEVICES INCLUDING THE ILLINOIS SUPPLEMENT (LATEST EDITION) AND THE FAA ADVISORY CIRCULARS (LATEST EDITION) UNLESS NOTED OTHERWISE. THE FAA OR MORE STRINGENT SPECIFICATIONS SHALL GOVERN.
- 2. BARRICADES SHALL BE "LOW-PROFILE" WITH A MAXIMUM HEIGHT OF 18" ABOVE GROUND, EXCLUSIVE OF ASSOCIATED WARNING LIGHTS AND FLAGS.
- BARRICADES SHALL BE SPACED END TO END THE WIDTH OF THE PAVEMENT, WITH GAPS BETWEEN BARRICADES NOT TO EXCEED 4' WIDE. BARRICADES ARE TO BE SET BACK 66' FROM THE ACTIVE TAXIWAY CENTERLINE OR AS SHOWN ON THE PLANS
- 4. CONSTRUCTION RED WARNING LIGHT: THESE ARE PORTABLE, LENS DIRECTED, ENCLOSED LIGHTS. THE COLOR OF THE LIGHT EMITTED SHALL BE RED. THEY MAY BE USED IN EITHER A STEADY BURN (TYPE C) OR LOW INTENSITY FLASHING MODE (TYPE A) UNLESS NOTED OTHERWISE
- 5. THE LIGHTING SHALL BE MAINTAINED IN OPERATION DURING THE HOURS OF DARKNESS BETWEEN 1/2 HOUR BEFORE SUNSET AND 1/2 HOUR AFTER SUNRISE AND WHEN CONDITIONS EXIST WHICH TEND TO OBSCURE VISION.
- 6. BARRICADES SHALL BE SECURED TO THE GROUND BY APPROVED METHODS TO PREVENT MOVEMENT BY PROP WASH. JET BLAST OR OTHER WIND CURRENTS.
- THE ONLY COLOR COMBINATION ON BARRICADES IS ORANGE AND WHITE. THE ORANGE STRIPES SHALL BE ENCAPSULATED LENS REFLECTIVE SHEETING. THE WHITE STRIPES SHALL BE EITHER ENCAPSULATED OR ENCLOSED LENS REFLECTIVE SHEETING AND MUST BE IN ACCEPTABLE CONDITION.
- COST FOR PROVIDING, PLACING, MAINTAINING, AND REMOVING BARRICADES SHALL BE INCLUDED IN THE COST OF THE OTHER CONTRACT ITEMS.

- SOLAR OR BATTERY POWERED
 - FLASHING LIGHT WITH RED LENS (TYP, BOTH ENDS OF BARRICADE).

FOLLOWING ARE THE CONSTRUCTION SAFETY PROCEDURES THAT THE CONTRACTOR SHALL FOLLOW THROUGHOUT THIS

CHECKERBOARD FLAG PROPERLY LOCATED OR A ROTATING BEACON (STROBE) AS SPECIFIED IN AC 150/5210-5, "PAINTING,

MARKED WITH ORANGE FLAGS AND LIGHTED WITH FLASHING RED LIGHTS DURING HOURS OF RESTRICTED VISIBILITY AND/OR

11. NO CONSTRUCTION EQUIPMENT GREATER THAN 25' TALL WILL BE PERMITTED ON THE AIRPORT. HOWEVER OTHER EQUIPMENT

12. NO OPEN FLAME WELDING OR TORCH CUTTING OPERATION IS PERMITTED UNLESS ADEQUATE FIRE AND SAFETY PRECAUTIONS

WHICH CAN BE BLOWN ONTO SUCH SURFACES, SHALL BE IMMEDIATELY SWEPT, PICKED UP AND REMOVED, OR PLACED INTO

SCHEDULED CONSTRUCTION PERIOD AND THE OPERATIONAL AREA IS CLOSED TO TRAFFIC AND PROPER NOTAMS ARE ISSUED



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ST. LOUIS REGIONAL AIRPORT AUTHORITY

ST. LOUIS REGIONAL AIRPORT **8 TERMINAL DRIVE** EAST ALTON, ILLINOIS 62024



RECONSTRUCT BITUMINOUS T-HANGAR TAXILANE PAVEMENTS NEAR SOUTHEAST AREA OF MAIN RAMP

IDA No: ALN-4348


Contract No. SR093

NO.	DATE	DESCRIPTION				
NO.	DAIL	DES DWN REV				
ISSUE: JANUARY 10, 2020						
PROJECT NO: 19A0092						
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DESIGN BY: JRH 10/01/2019 DRAWN BY: JRH 10/01/2019 REVIEWED BY: BSS 01/08/2020


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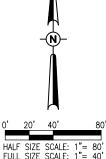
CONSTRUCTION SAFETY AND PHASING DETAILS AND NOTES



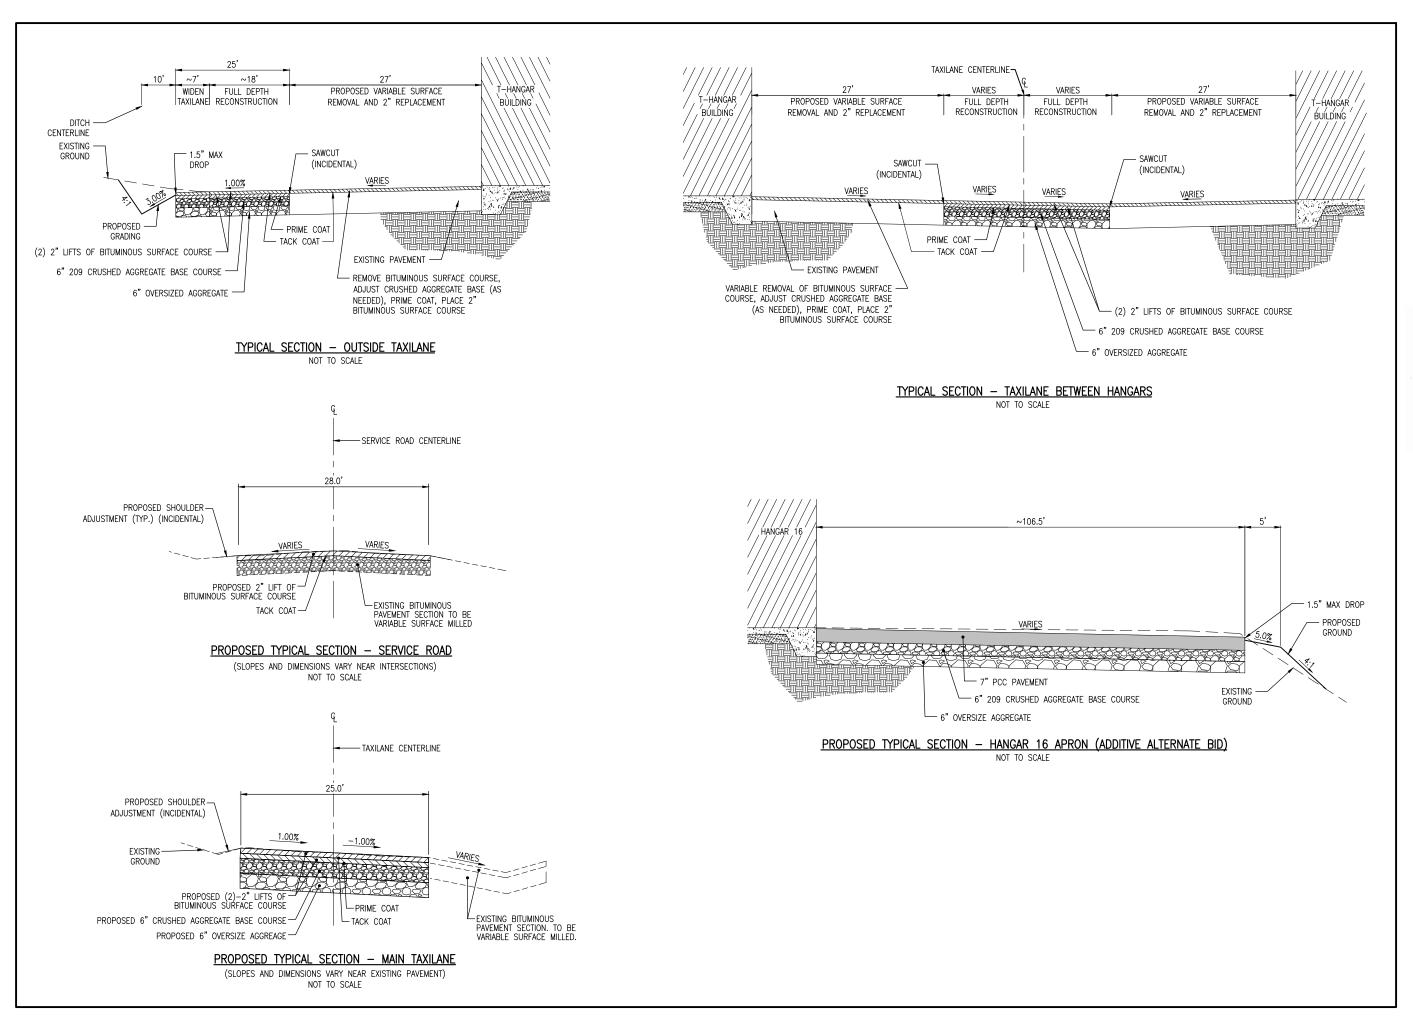

TYPICAL SECTIONS



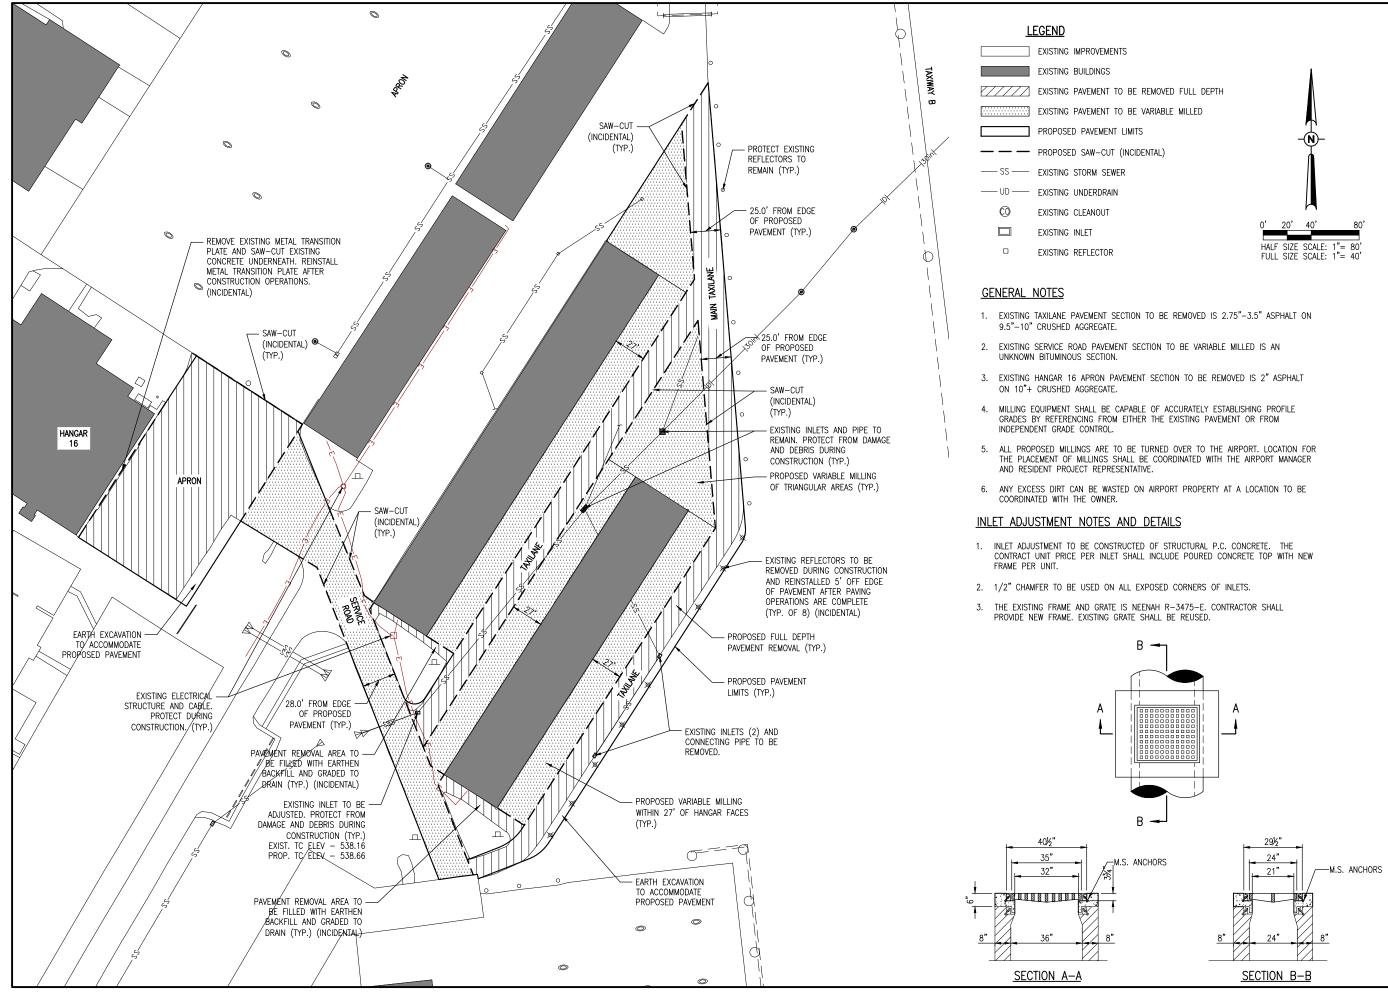



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ST. LOUIS REGIONAL AIRPORT AUTHORITY ST. LOUIS REGIONAL AIRPORT

8 TERMINAL DRIVE EAST ALTON, ILLINOIS 62024



RECONSTRUCT BITUMINOUS **T-HANGAR TAXILANE** PAVEMENTS NEAR SOUTHEAST AREA OF MAIN RAMP

IDA No: ALN-4348


Contract No. SR093


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PROJECT NO: 19A0092					
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DESIGN BY: JRH 10/01/2019					

DRAWN BY: JRH 10/01/2019 REVIEWED BY: BSS 01/08/2020


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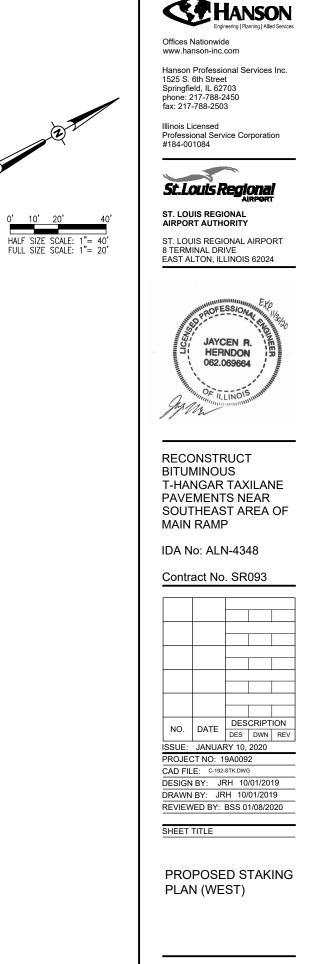
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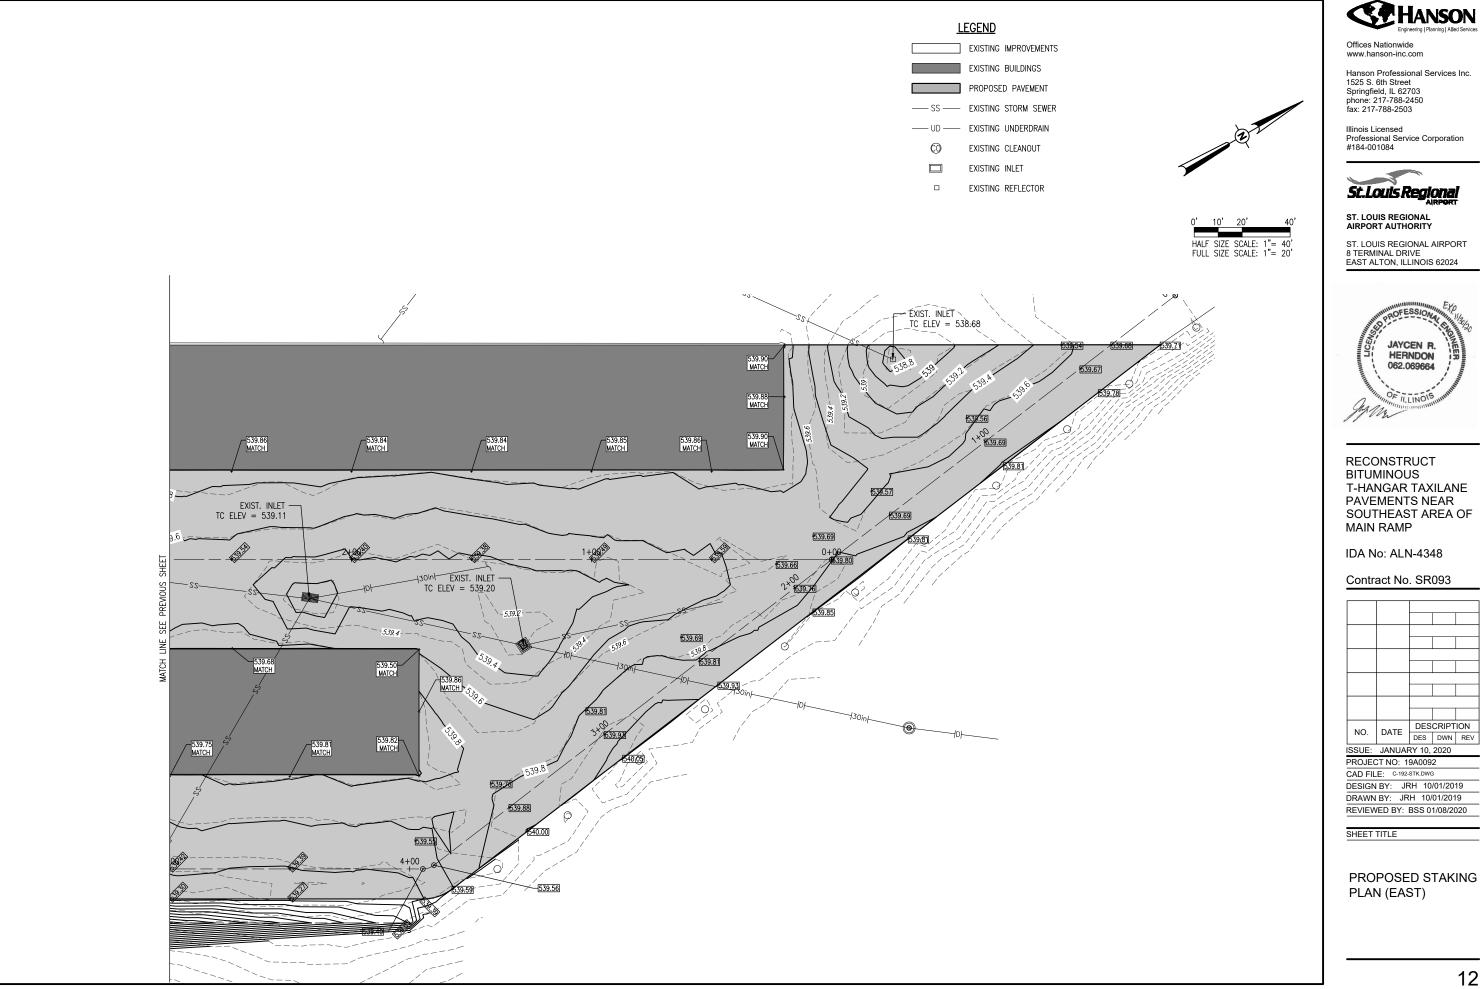


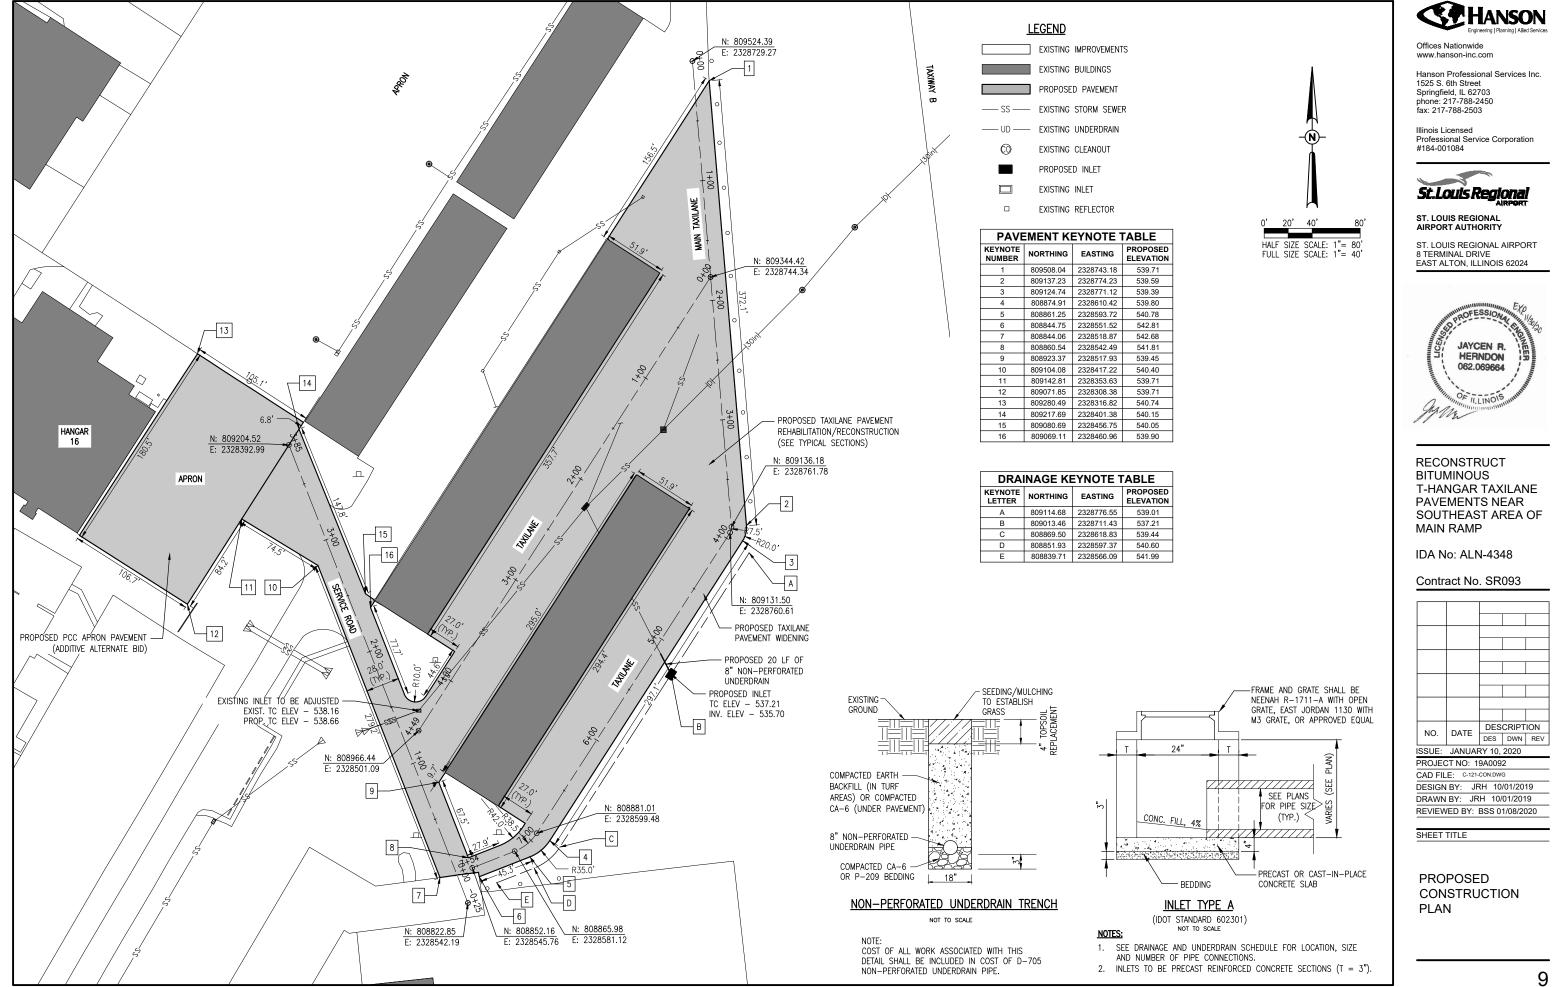

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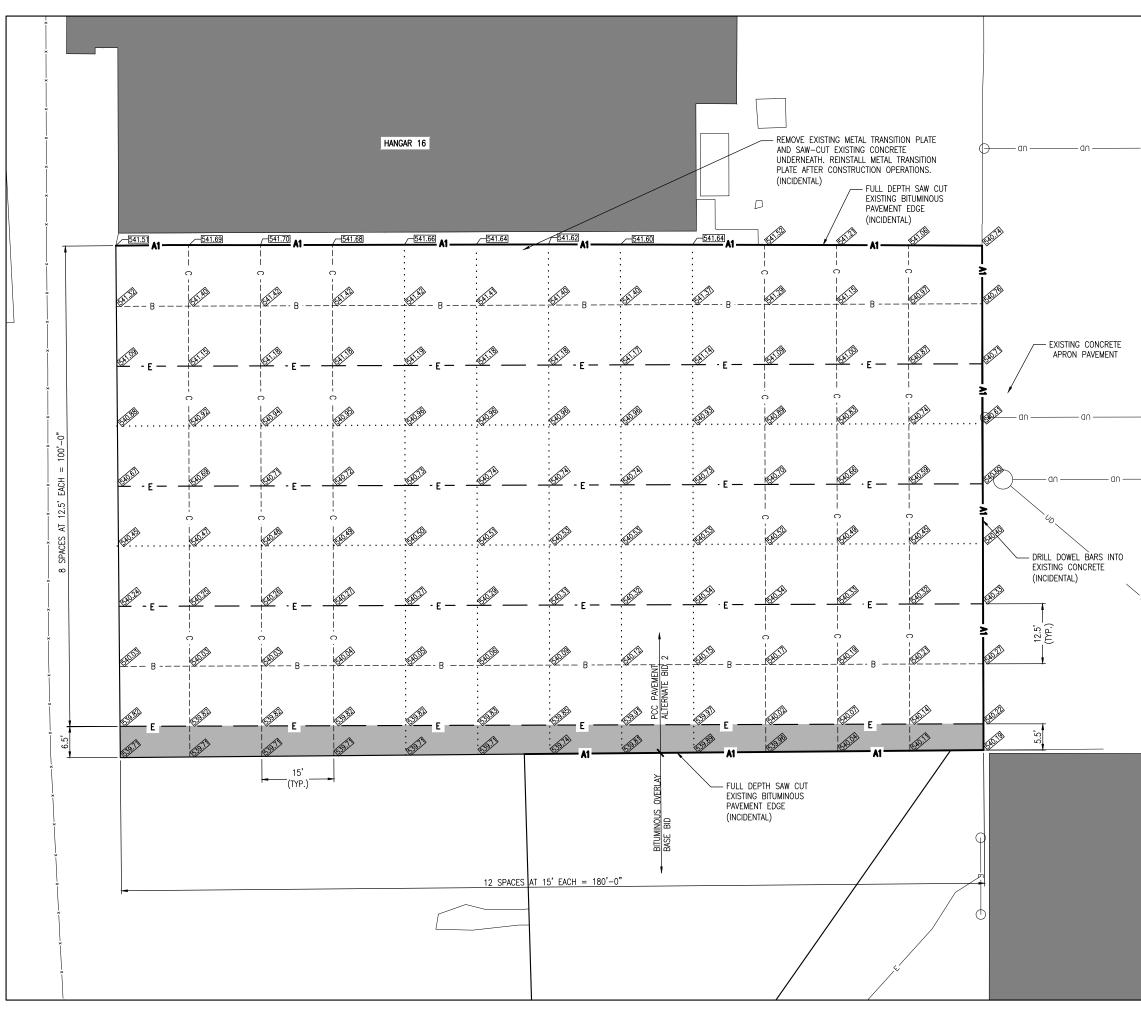


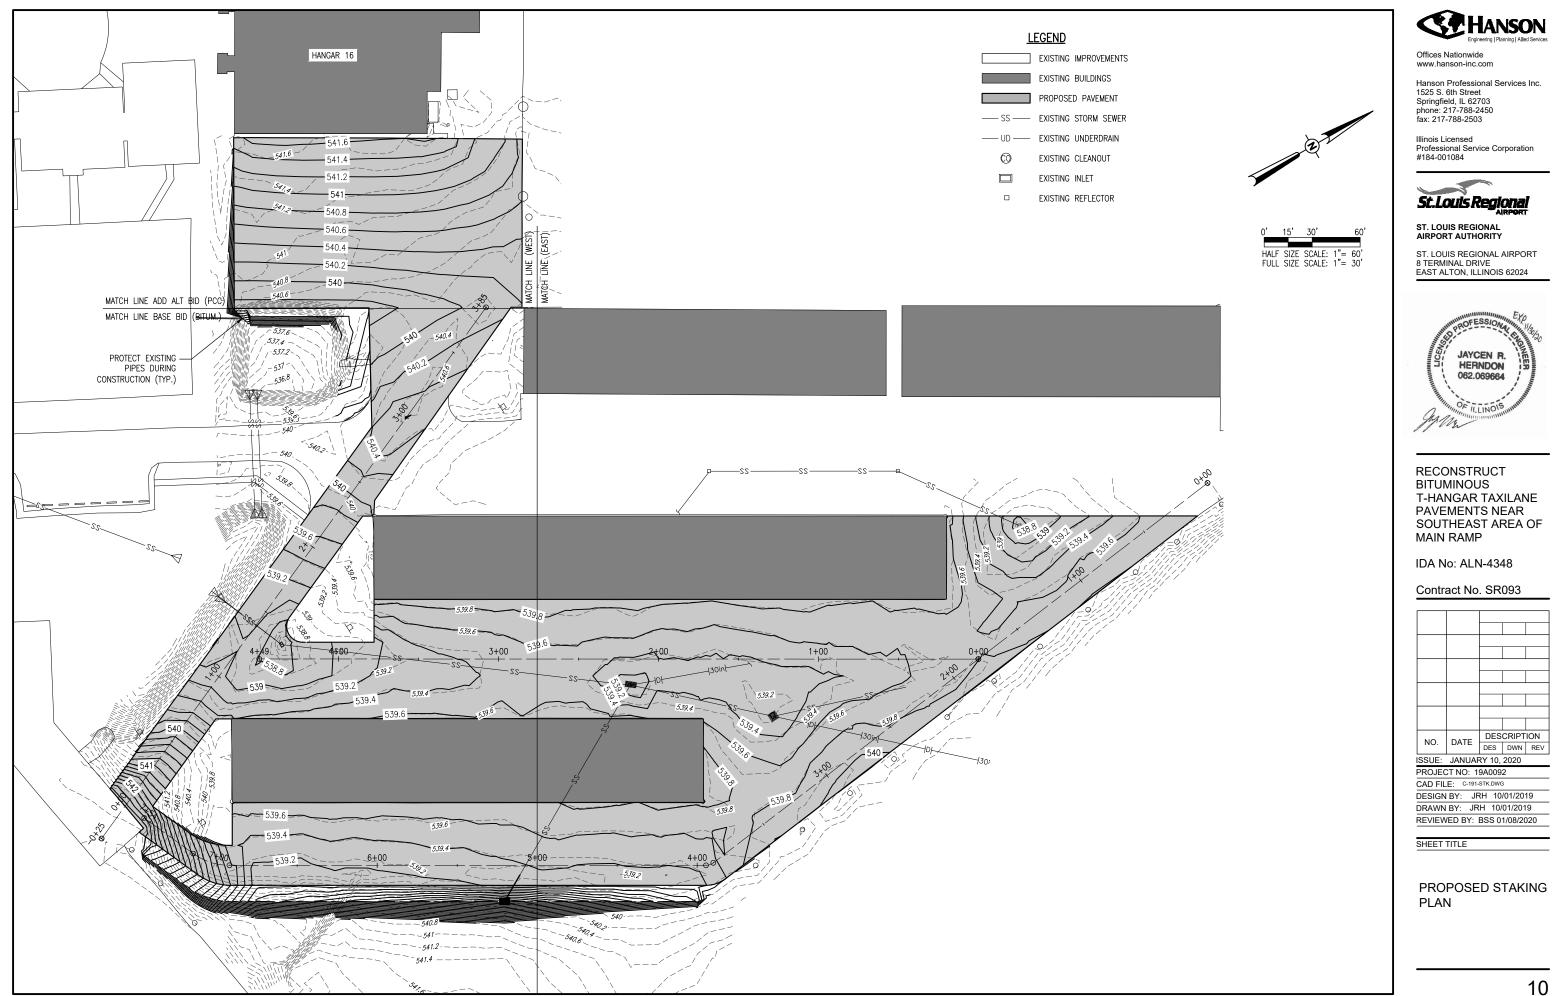

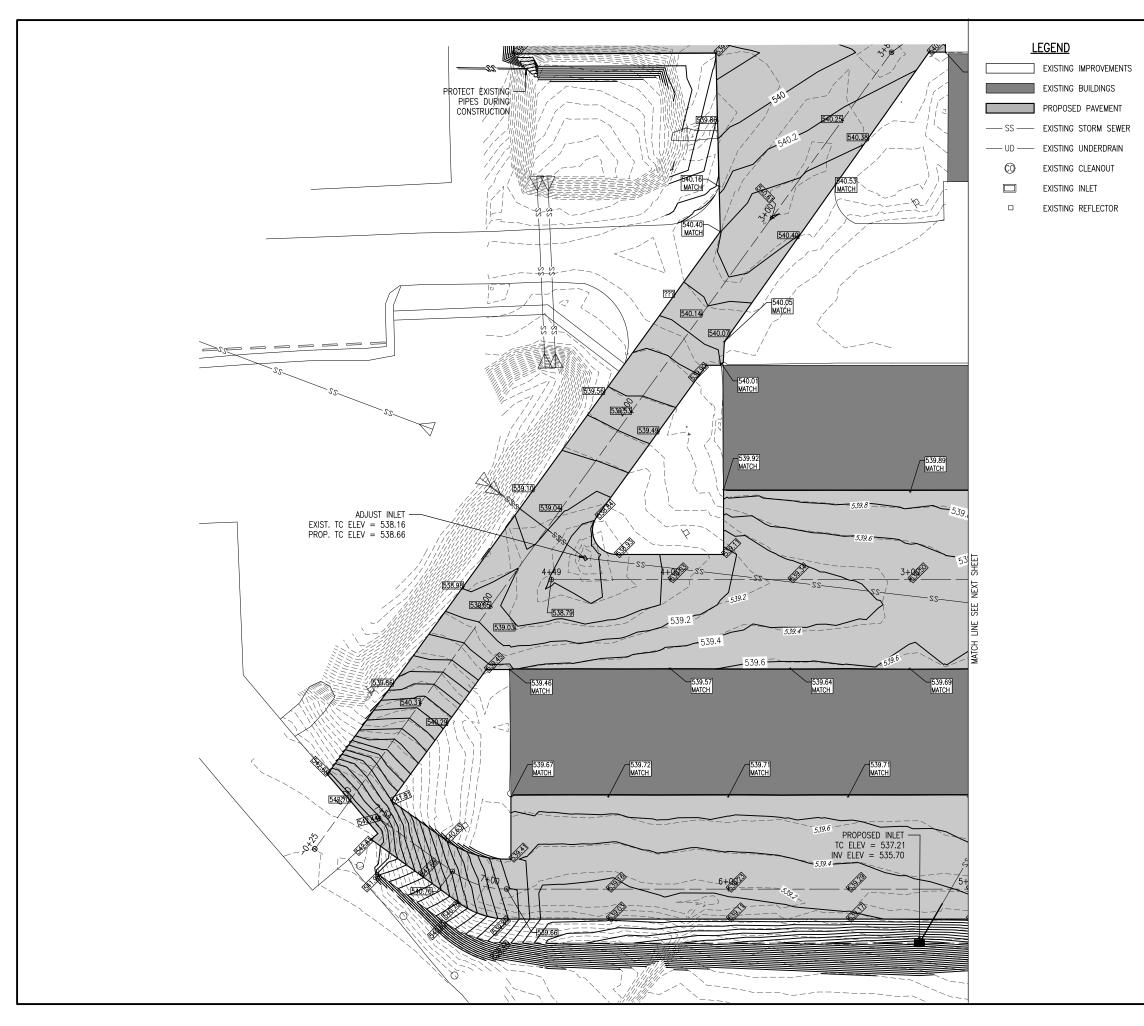

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DRAWN BY: JRH 10/01/2019				
REVIEWED BY: BSS 01/08/2020				



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- an	E
	0' 5' 10' 20' HALF SIZE SCALE: 1"= 20' FULL SIZE SCALE: 1"= 10'
	LEGEND
	EXISTING IMPROVEMENTS
	EXISTING BUILDINGS
	X EXISTING FENCE
	PROPOSED REINFORCED PANEL
	TYPE A, ISOLATION JOINT
- ON	B TYPE B, HINGED JOINT
	C· TYPE C, CONTRACTION JOINT
	- · · · · · · · · · TYPE D, CONTRACTION JOINT
	E TYPE E, CONSTRUCTION JOINT
	541.0 PROPOSED SPOT ELEVATION

NOTES:

- 1. CONTRACTOR MAY PROPOSE ALTERNATIVE PAVING/JOINTING PLAN FOR REVIEW AND APPROVAL FOLLOWING AWARD.
- 2. CONTRACTOR SHALL VERIFY EXISTING ELEVATIONS AT "MATCH" LOCATIONS PRIOR TO CONSTRUCTION. ANY DISCREPANCIES SHALL BE BROUGHT TO THE ATTENTION OF THE RESIDENT ENGINEER/TECHNICIAN IMMEDIATELY TO DETERMINE IF ADJUSTMENTS ARE NECESSARY TO PROPOSED GRADES.



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ST. LOUIS REGIONAL AIRPORT AUTHORITY ST. LOUIS REGIONAL AIRPORT

8 TERMINAL DRIVE EAST ALTON, ILLINOIS 62024



RECONSTRUCT BITUMINOUS T-HANGAR TAXILANE PAVEMENTS NEAR SOUTHEAST AREA OF MAIN RAMP

IDA No: ALN-4348

Contract No. SR093

NO.	DATE	DES	CRIPT	ION
NO.	DATE	DES	DWN	REV
ISSUE: JANUARY 10, 2020				
PROJEC	T NO: 1	9A009	2	

 PROJECT NO:
 19A0092

 CAD FILE:
 C-161-JNT.DWG


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 JRH
 10/01/2019

 DRAWN BY:
 JRH
 10/01/2019


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 BSS 01/08/2020


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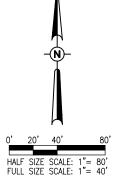
PROPOSED JOINTING PLAN (ADD. ALT. BID)



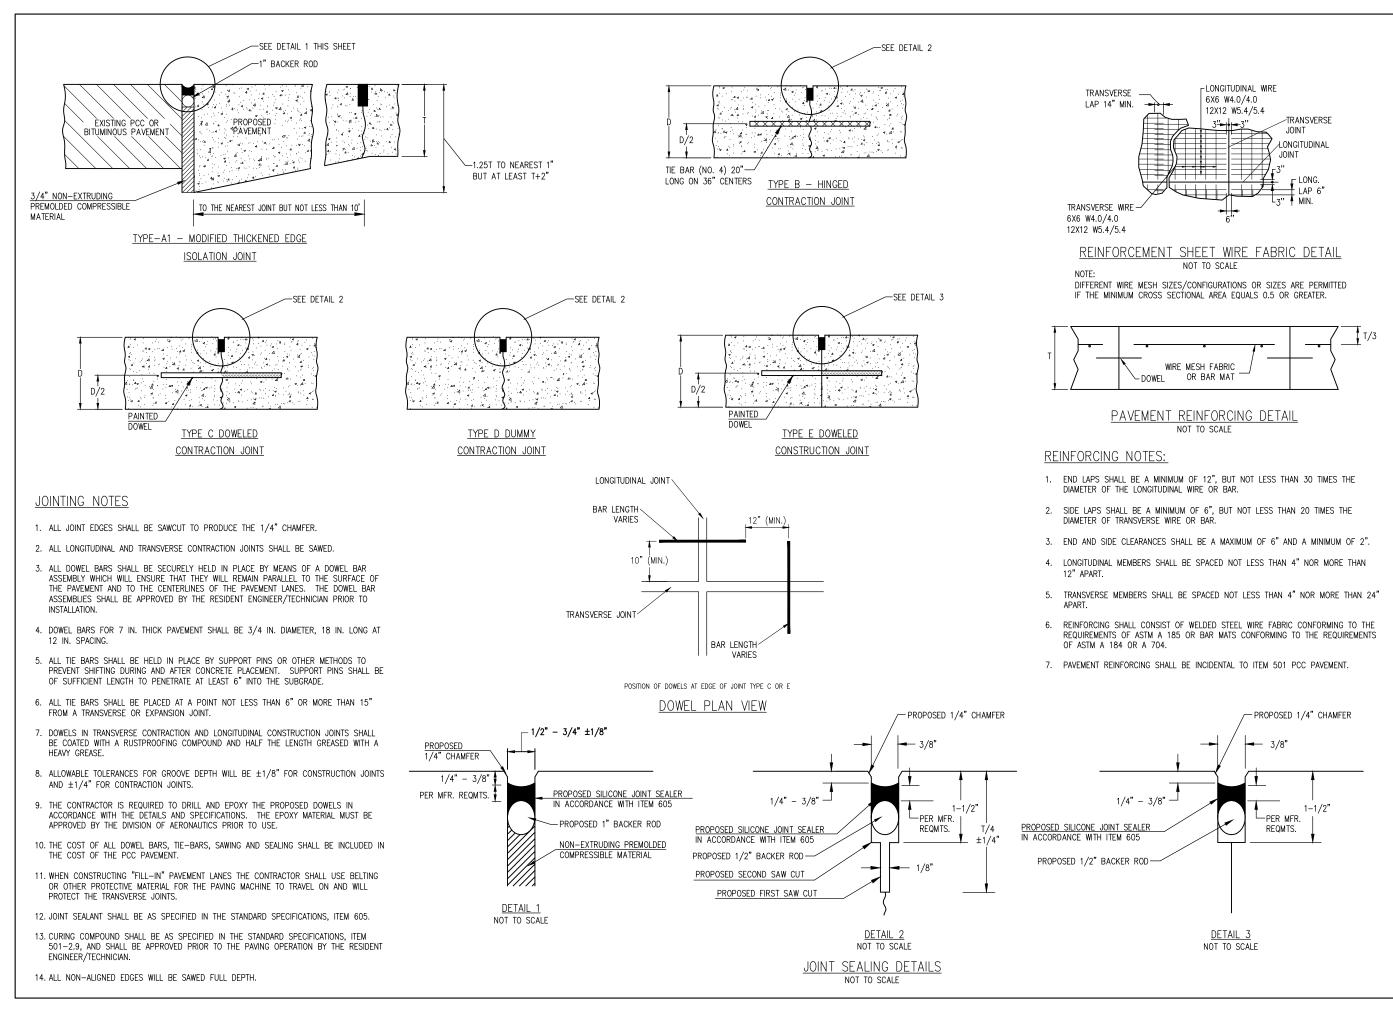



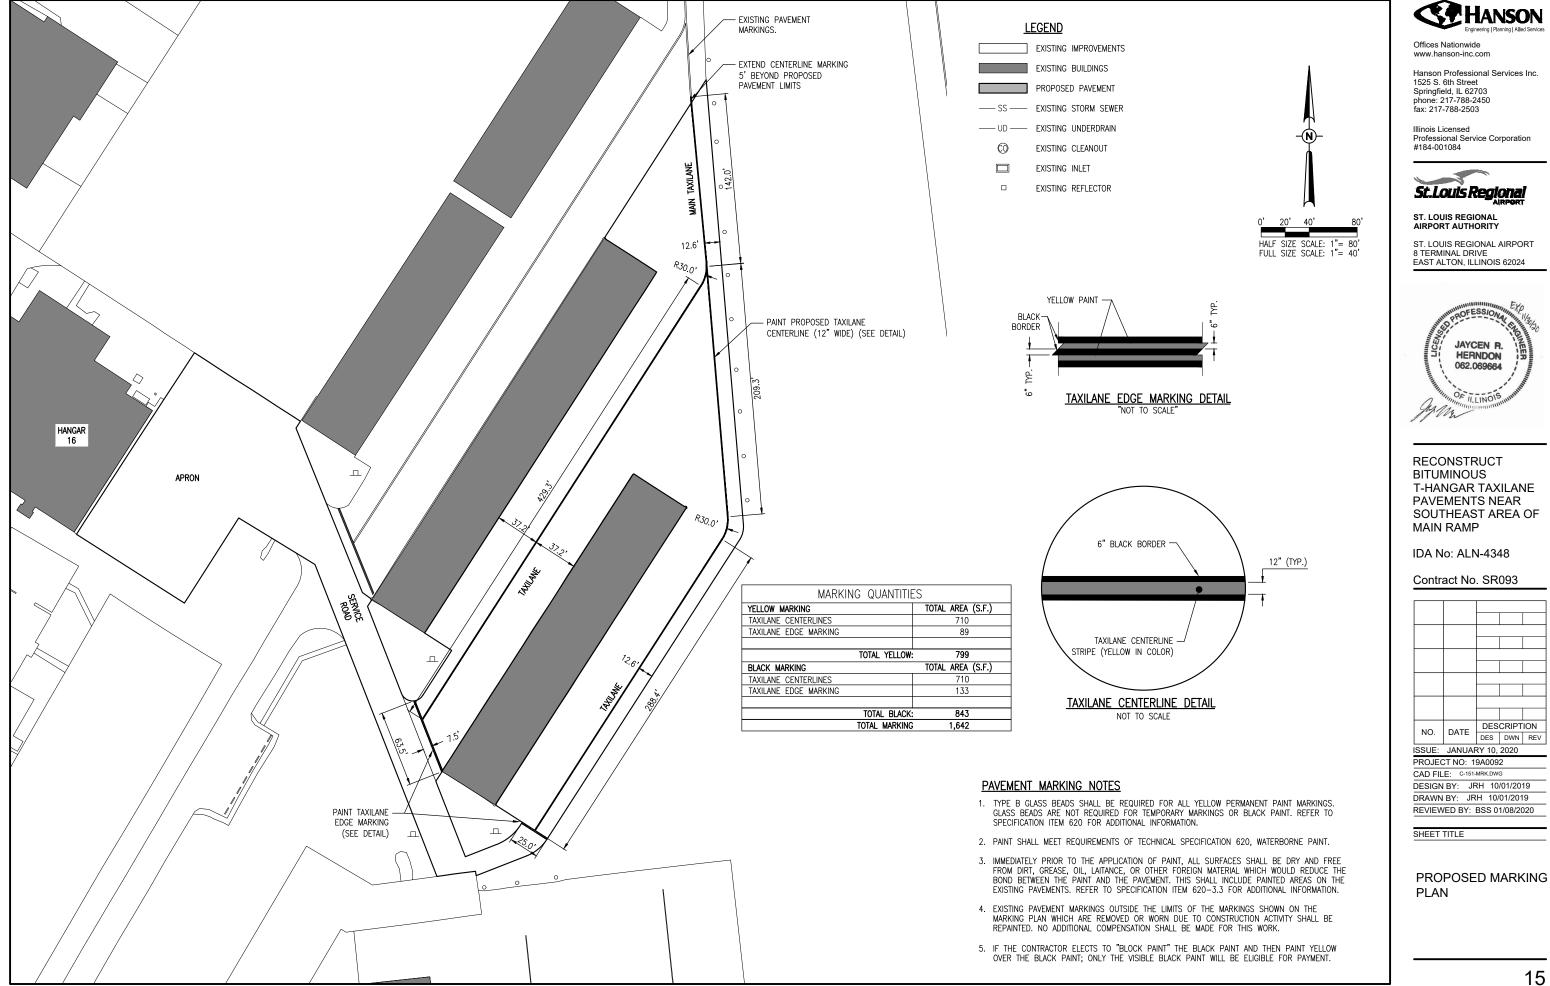

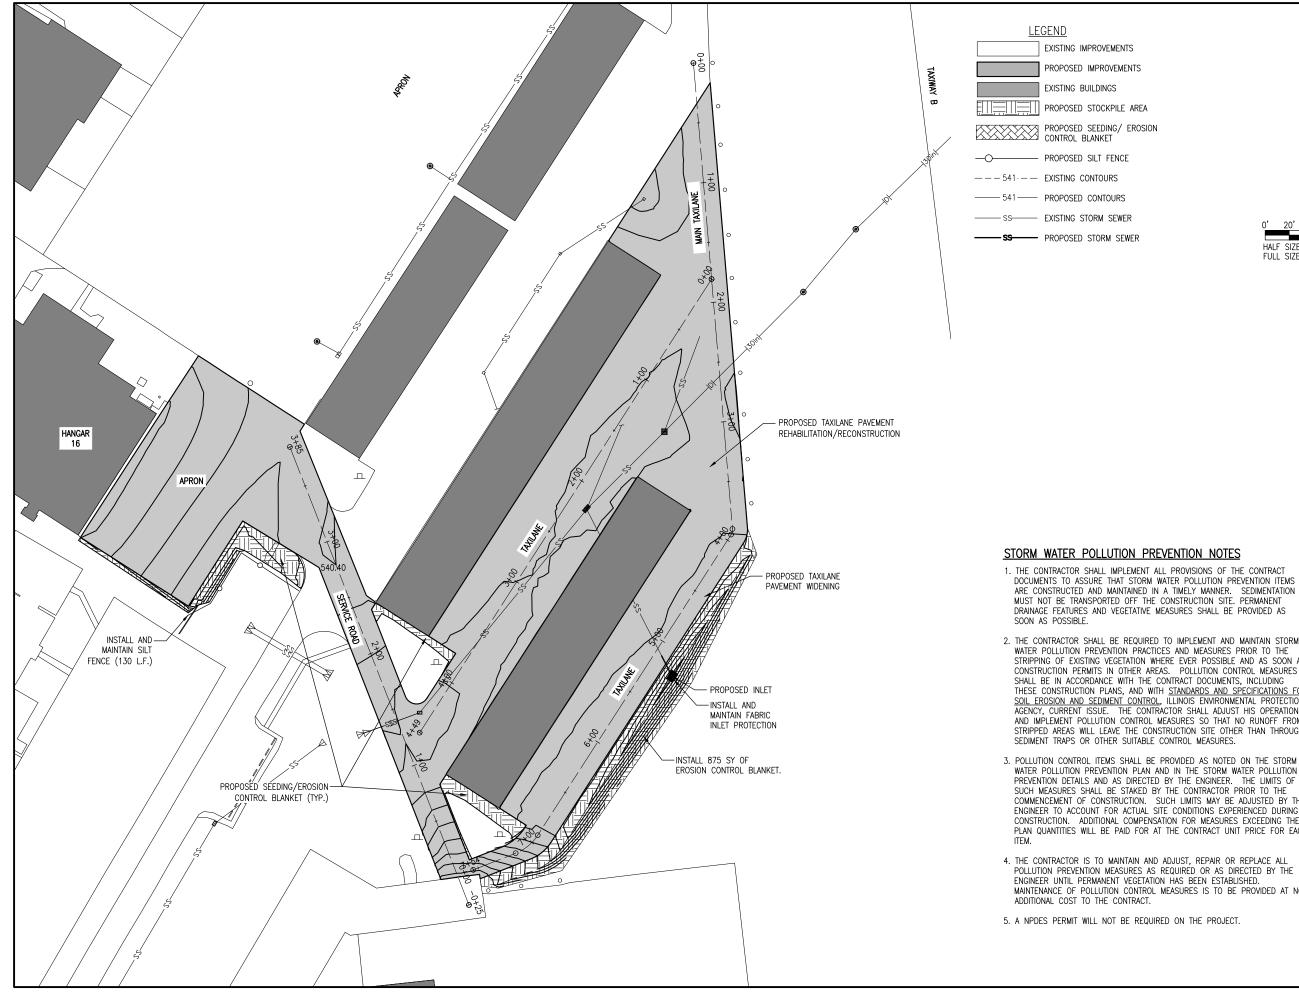

ARE CONSTRUCTED AND MAINTAINED IN A TIMELY MANNER. SEDIMENTATION MUST NOT BE TRANSPORTED OFF THE CONSTRUCTION SITE. PERMANENT DRAINAGE FEATURES AND VEGETATIVE MEASURES SHALL BE PROVIDED AS

2. THE CONTRACTOR SHALL BE REQUIRED TO IMPLEMENT AND MAINTAIN STORM WATER POLLUTION PREVENTION PRACTICES AND MEASURES PRIOR TO THE STRIPPING OF EXISTING VEGETATION WHERE EVER POSSIBLE AND AS SOON AS CONSTRUCTION PERMITS IN OTHER AREAS. POLLUTION CONTROL MEASURES SHALL BE IN ACCORDANCE WITH THE CONTRACT DOCUMENTS, INCLUDING THESE CONSTRUCTION PLANS, AND WITH <u>STANDARDS AND SPECIFICATIONS FOR</u> <u>SOIL EROSION AND SEDIMENT CONTROL</u>, ILLINOIS ENVIRONMENTAL PROTECTION AGENCY, CURRENT ISSUE. THE CONTRACTOR SHALL ADJUST HIS OPERATIONS AND IMPLEMENT POLLUTION CONTROL MEASURES SO THAT NO RUNOFF FROM STRIPPED AREAS WILL LEAVE THE CONSTRUCTION SITE OTHER THAN THROUGH

PREVENTION DETAILS AND AS DIRECTED BY THE ENGINEER. THE LIMITS OF SUCH MEASURES SHALL BE STAKED BY THE CONTRACTOR PRIOR TO THE COMMENCEMENT OF CONSTRUCTION. SUCH LIMITS MAY BE ADJUSTED BY THE CONSTRUCTION. ADDITIONAL COMPENSATION FOR MEASURES EXCEEDING THE PLAN QUANTITIES WILL BE PAID FOR AT THE CONTRACT UNIT PRICE FOR EACH

POLLUTION PREVENTION MEASURES AS REQUIRED OR AS DIRECTED BY THE ENGINEER UNTIL PERMANENT VEGETATION HAS BEEN ESTABLISHED. MAINTENANCE OF POLLUTION CONTROL MEASURES IS TO BE PROVIDED AT NO



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ST. LOUIS REGIONAL AIRPORT AUTHORITY

ST. LOUIS REGIONAL AIRPORT 8 TERMINAL DRIVE EAST ALTON, ILLINOIS 62024



RECONSTRUCT BITUMINOUS T-HANGAR TAXILANE PAVEMENTS NEAR SOUTHEAST AREA OF MAIN RAMP


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Contract No. SR093

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PROJEC	CT NO: 1	9A009	2		
CAD FIL	E: C-181-	SWP.DW	G		
DESIGN	BY: JF	RH 10	/01/20	19	
DRAWN BY: JRH 10/01/2019					
REVIEW	REVIEWED BY: BSS 01/08/2020				

SHEET TITLE

STORM WATER POLLUTION PREVENTION PLAN



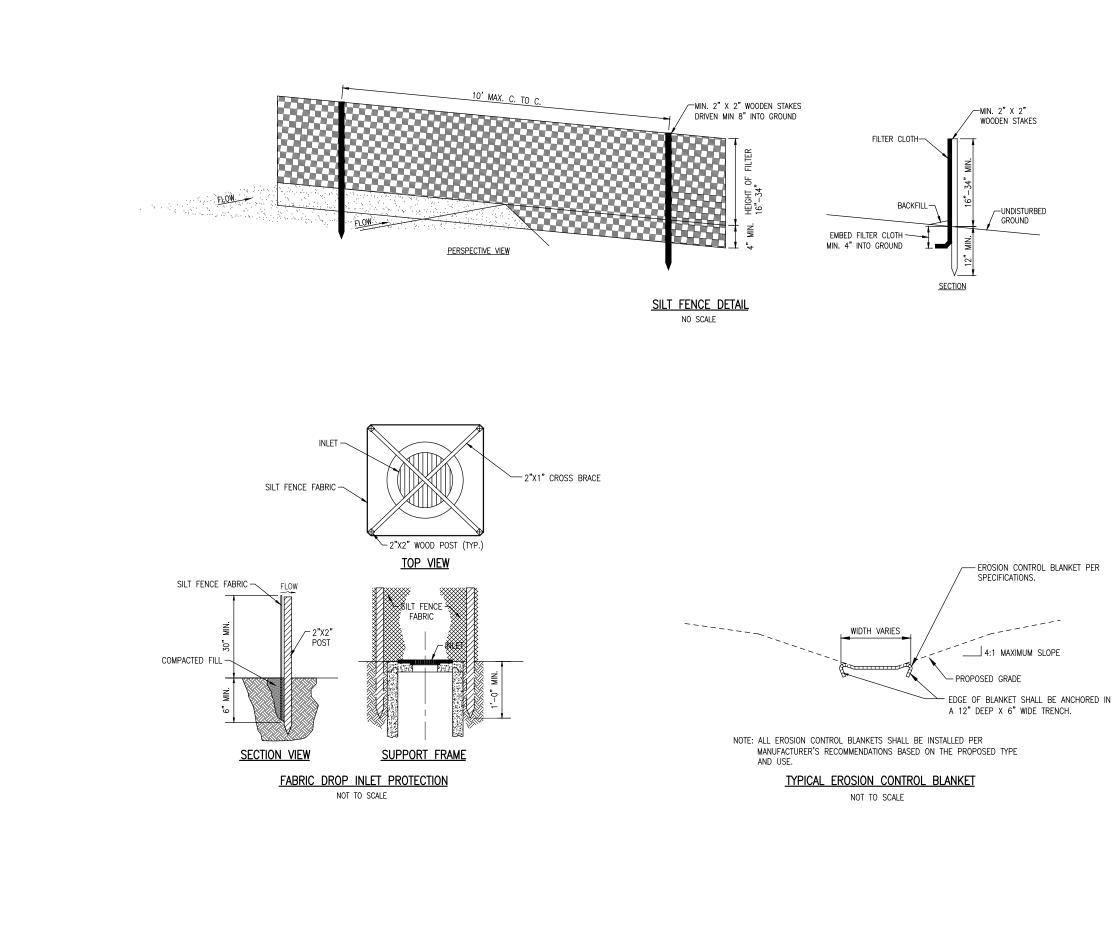

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ST. LOUIS REGIONAL AIRPORT AUTHORITY

ST. LOUIS REGIONAL AIRPORT 8 TERMINAL DRIVE EAST ALTON, ILLINOIS 62024



RECONSTRUCT BITUMINOUS T-HANGAR TAXILANE PAVEMENTS NEAR SOUTHEAST AREA OF MAIN RAMP

IDA No: ALN-4348

Contract No. SR093

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		REVIEWED BY: BSS 01/08/2020				

SHEET TITLE

STORM WATER POLLUTION PREVENTION DETAILS