STATE OF ILLINOIS

DEPARTMENT OF TRANSPORTATION

DIVISION OF HIGHWAYS

FOR INDEX OF SHEETS, SEE SHEET NO. 2 FOR STATE STANDARDS, SEE SHEET NO. 2

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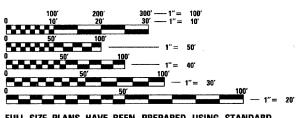
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PROPOSED HIGHWAY PLANS

FAP ROUTE 17 (IL 64) SECTION 101T PROJECT ACF-0017 (122) OGLE COUNTY C-92-121-07

BROOKVILLE TOWNSHIP SECTION 23, 26




FULL SIZE PLANS HAVE BEEN PREPARED USING STANDARD ENGINEERING SCALES. REDUCED SIZED PLANS WILL NOT CONFORM TO STANDARD SCALES. IN MAKING MEASUREMENTS ON REDUCED PLANS, THE ABOVE SCALES MAY BE USED.

J.U.L.I.E.
JOINT UTILITY LOCATION INFORMATION FOR EXCAVATION
1-800-892-0123
OR 811

PROJECT ENGINEER: BOB WAGNER
SQUAD TECHNICIAN: LANCE NICKLAUS (815) 284-5920

CONTRACT NO. 64C36

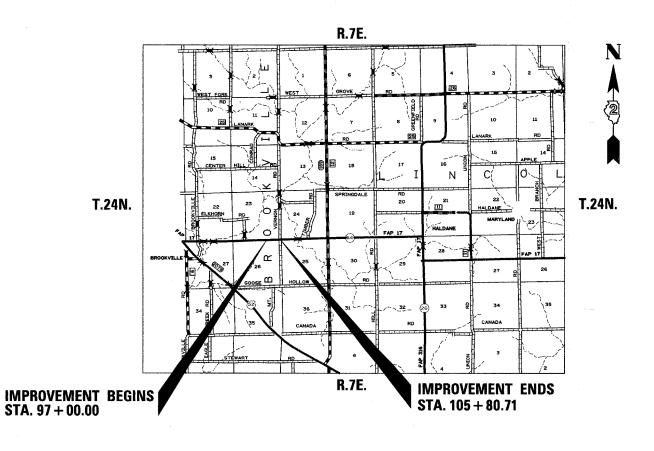


 F.A.P. RTE.
 SECTION
 COUNTY SHEETS NO.
 TOTAL SHEETS NO.
 SHEET NO.

 17
 101T
 OGLE
 39
 1

 FED. ROAD DIST. NO.
 ILLINOIS
 CONTRACT
 NO.
 64C36

D-92-079-06



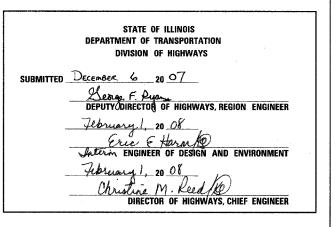

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OF THE STATE OF ILLINOIS

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<u>STANDARDS</u>

000001-05 STANDARD SYMBOLS, ABBRECIATIONS AND PATTERNS

280001-04 TEMPORARY EROSION CONTROL SYSTEMS

442201-03 CLASS C AND D PATCHES

515001-02 NAME PLATE FOR BRIDGES

542306-01 PRECAST REINFORCED CONCRETE ELLIPTICAL FLARED END SECTION

542401 METAL END SECTION FOR PIPE CULVERTS

635001 DELINEATORS

635011-01 REFLECTOR MARKER AND MOUNTING DETAILS

666001 RIGHT-OF-WAY MARKERS

667101 PERMANENT SURVEY MARKERS

701006-02 OFF-ROAD OPERATIONS, 2L, 2W, 4.5M (15') TO 600MM (24") FROM PAVEMENT EDGE

701011-01 OFF-ROAD MOVING OPERATIONS, 2L, 2W, DAY ONLY

701201-02 LANE CLOSURE, 2L, 2W, DAY ONLY, FOR SPEEDS > 45 MPH

701301-02 LANE CLOSURE, 2L, 2W, SHORT TIME OPERATIONS

701311-02 LANE CLOSURE, 2L, 2W, MOVING OPERATIONS DAY ONLY

701901 TRAFFIC CONTROL DEVICES

720011 METAL POSTS FOR SIGNS, MARKERS & DELINEATORS

728001 TELESCOPING STEEL SIGN SUPPORT

729001 APPLICATIONS OF TYPES A AND B METAL POST (FOR SIGNS & MARKERS)

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DEPARTMENT	OF 1	FRANSPOF	RTATION

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SUMMARY OF QUANTITIES 80% FED / 20% STATE **Y007** CODE NO. UNIT TOTAL QTY 20100110 TREE REMOVAL (6 TO 15 UNITS DIAMETER) UNIT 20100500 TREE REMOVAL, ACRES ACRE 0.25 20200100 EARTH EXCAVATION CU YD 6383 21301052 EXPLORATION TRENCH 52" DEPTH FOOT 100 25000210 SEEDING, CLASS 2A ACRE 0.7 * 25000310 SEEDING, CLASS 4 ACRE 0.8 25000750 MOWING ACRE 25100115 MULCH, METHOD 2 ACRE 25100630 EROSION CONTROL BLANKET SQ YD 481 28000250 TEMPORARY EROSION CONTROL SEEDING POUND 450 28000300 TEMPORARY DITCH CHECKS EACH 36 28000400 PERIMETER EROSION BARRIER FOOT 129 28000500 INLET AND PIPE PROTECTION EACH 28100107 STONE RIPRAP, CLASS A4 SQ YD 13 28200200 FILTER FABRIC SQ YD 13 35101400 AGGREGATE BASE COURSE, TYPE B TON 257 40600990 TEMPORARY RAMP SQ YD 58 40603315 HOT-MIX ASPHALT SURFACE COURSE, MIX "C", N70 TON 47 44201383 CLASS C PATCHES, TYPE IV, 12 INCH SQ YD 160 48100100 AGGREGATE SHOULDERS, TYPE A TON 608

■ NP 100% STATE

* Specialty Item

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SUMMARY OF QUANTITIES

80% FED / 20% STATE

Y007

			7001
CODE NO.	ITEM	UNIT	TOTAL QTY
50100300	REMOVAL OF EXISTING STRUCTURES NO. 1	EACH	1
50105200	REMOVE EXISTING CULVERTS	EACH	2
54207165	PIPE CULVERTS, TYPE 1, REINFORCED CONCRETE-ELLIPTICAL, EQUIVALENT ROUND-SIZE 30"	FOOT	58
542D0220	PIPE CULVERTS, CLASS D, TYPE 1 15"	FOOT	120
54213450	END SECTION 15"	EACH	2
54214725	PRECAST REINFORCED CONCRETE FLARED END SECTIONS-ELLIPTICAL, EQUIVALENT ROUND-SIZE 30"	EACH	2
61100605	MISCELLANEOUS CONCRETE	CU YD	1
61101009	STORM SEWERS PROTECTED, CLASS A, 8"	FOOT	50
61133100	FIELD TILE JUNCTION VAULTS, 2' DIA.	EACH	2
63200310	GUARDRAIL REMOVAL	FOOT	202
63500105	DELINEATORS	EACH	2
66600105	FURNISHING AND ERECTING RIGHT-OF-WAY MARKERS	EACH	11
66700095	PERMANENT SURVEY MARKERS	EACH	2
67100100	MOBILIZATION	L SUM	1
70100450	TRAFFIC CONTROL AND PROTECTION, STANDARD 701201	L SUM	1
78001110	PAINT PAVEMENT MARKING - LINE 4"	FOOT	5828
A2006514	TREE, QUERCUS BICOLOR (SWAMP WHITE OAK), 1-3/4" CALIPER, BALLED AND BURLAPPED	EACH	45
C2001748	SHRUB, CORNUS SERICEA CARDINAL (CARDINAL REDOSIER DOGWOOD), 4' HEIGHT, BALLED AND BURLAPPED	EACH	20
XX001135	PAVEMENT PATCHING SPECIAL	SQ YD	160
Z0013798	CONSTRUCTION LAYOUT	L SUM	1
Z0020900	ESTABLISHING AND REFERENCING LAND SECTION MARKERS	EACH	1
Z0023600	FILLING EXISTING CULVERTS	EACH	1

* Specialty Item

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GENERAL NOTES

ROUTE NO.	SEC.	COUNTY	TOTAL	SHEET NO.
FAP 17 (IL 64)	101T	Ogle	20	_
FED ROAD DIST. NO.	ILLINOIS	PROJECT	+ 39 -	T 5 -

The final top 100 mm (four inches) of soil in any right-of-way area disturbed by the Contractor must be capable of supporting vegetation. The soil must be from the A horizon (zero to 2' deep) of soil profiles of local soils.

All Borrow/Waste/Use sites must be approved by the Department prior to removing any material from the project or initiating any earthmoving activities, including temporary stockpiling outside the limits of construction.

The Contractor shall seed all disturbed areas within the project limits. Seeding Class 4 or 2A shall be used, except in front of properties where the grass will be mowed, then use Seeding, Class 1. Class 2A shall be used on front slopes and ditch bottoms. Class 4 shall be used behind Type A gutter, on all backslopes and areas behind the backslope, and beyond the toe of front slope on fill sections without ditches.

Fertilizer Nutrients shall be applied at the rate specified in Sections 250 and 252 of the Standard Specifications. This shall be included in the cost of the SEEDING or SODDING.

Previously pugmilled stockpiles of "Type A" older than 1 month will not be approved for use until a moisture check is run to verify moisture content. Material shipped to projects without being tested will not be accepted.

Tree Layout shall be performed by the District Landscape Architect.

The mulch around new trees shall be hardwood wood chips, 5 foot diameter, 4 inches thick with weed barrier fabric,

Placement and compaction of the backfill for proposed across road culverts and existing across road culverts that are removed shall conform to Section 502.10 of the Standard Specifications, except that the material shall conform to Article 208.02 of the Standard Specifications, and shall be compacted to a minimum of 95% of the standard laboratory density. Any material conforming to the requirements of Article 1003.04 or 1004.05 which has been excavated from the trenches shall be used for backfilling the trenches. The entire excavation, within 2 feet outside of each shoulder, shall be backfilled with trench backfill material to the bottom of the proposed subgrade. This trench backfill material will not be measured for payment, but shall be included in the contract unit price for the class of concrete involved or other unit price item of the work for which it is required.

Except for the top 75 mm (3"), all aggregate bases and subbases 300 mm (12") in thickness shall be constructed of aggregate gradation CA-2. If the specified thickness exceeds 300 mm (12"), the bases or subbases shall be constructed of topsize 150 mm (6") breaker-run crushed stone with 70% to 90% by weight, passing the 4" sieve and 15% to 40% by weight, passing the 50 mm (2") size sieve, except for the top 75 mm (3"). The breaker-run crushed stone shall be reasonably uniformly graded from coarse to fine and be taken from a quarry ledge capable of producing Class "D" quality aggregate. The top 75 mm (3") shall be gradation CA-6 or CA-10 regardless of thickness. The water necessary to achieve compaction in all but the top 75 mm (3") layer may be added after the subbase or base course is placed on the grade.

The following Mixture Requirements are applicable for this project:

Mixture Uses(s):	Surface Course	
PG:	PG 64-22	
Design Air Voids	4.0 @ N70	
Mixture Composition (Gradation Mixture)	IL 9.5 or 12.5	
Friction Aggregate	С	
20 Year ESAL	N/A	

Bituminous and Aggregate prime coat shall be placed in accordance with Section 406 of the Standard Specifications. The cost of the prime coats shall be included in the contract unit price per metric ton (ton) for HOT-MIX ASPHALT SURFACE COURSE, MIX C, N70.

The new number for this structure will be 071-1162.

Culvert flows must be maintained throughout the project. Normal flow shall be allowed to pass at the rate it enters the jobsite. High flows shall be allowed to pass without causing damage to upstream properties.

The Contractor shall remove all entrance culverts in condition for reuse which are not to be left in place. They shall be cleaned and stored along the right of way as directed. In no case shall they be roughly handled or shoved by heavy machinery. Unusable material shall be disposed of by the Contractor at his expense. Cost of the work to be included in the contract unit price for EARTH EXCAVATION.

The proposed pipes for entrances and side roads shall be placed in line with the existing or proposed ditch line.

Where field tile is encountered, storm sewer or pipe drain will be used in accordance with Section 611. The minimum size for replacement will be 150 mm (6") for Pipe Drains and 200 mm (8") for Storm Sewer, but the size must be at least 50 mm (2") larger than the adjoining tile. A Field Tile Junction Vault will be constructed at the right of way to connect the tile and storm sewer. See the Summary of Quantities for the estimated quantities.

Delineators shall be installed as shown in Standard 635001, except that the post shall be rotated 180° and only metal-backed delineators shall be permitted.

Delineators shall be placed at the ends of approach guardrail terminal sections, and at each headwall or end section of AR Culverts. This work will be paid for at the contract unit price each for DELINEATORS.

Pavement Marking shall be done according to Standard 780001, except as follows:

- 1. All words, such as ONLY, shall be 2.4 m (8 feet) high.
- 2. All non-freeway arrows shall be the large size.
- 3. The distance between yellow no-passing lines shall be 200 mm (8"), not 180 mm (7") as shown in the detail of Typical Lane and Edge Lines.

PERMANENT SURVEY MARKERS, TYPE II, shall be set at intervals of 1.6 Km (1 mile) or as directed by the Engineer. Bridge or culvert projects shall have one survey marker placed near the structure. Estimated: 2 Each.

Permanent Survey Markers, Type II shall be cast-in-place as shown on Highway Standard 667101.

The Contractor shall submit to the Engineer a description of location, elevation, and coordinates for each permanent survey marker. The Engineer shall submit this information to the Survey Crew.

Right-of-way markers will be erected with the back face of the marker on the right-of-way line unless the new right-of-way line has been surveyed and pinned, in which instance the right-of-way markers will be erected 300 mm (12 inches) inside the new right-of-way line.

Work on this project will be in progress at the same time as work on the US 52 Brookville project. Work on these projects shall be scheduled to keep interference between all the projects to a minimum. The contractors shall inform each other of progress of the projects and give fair warning to the other contractors when a problem might be encountered.

The Contractor shall be responsible for protecting utility property during construction operations as outlined in Article 107.31 of the Standard Specifications. A minimum of 48 hours advance notice is required for non-emergency work. The JULIE number is 800-892-0123. The following listed utilities located within the project limits or immediately adjacent to the project construction limits are members of JULIE:

Commonwealth Edison Co. Frontier/Citizens

Verizon

Program (Arch. Sh...) Enlarge 200% Enlarge 107%

GENERAL NOTES

ROUTE NO.	SEC.	COUNTY	TOTAL	SHEET NO.
FAP 17 (IL 64)	101T	Ogle	39-	6_
FED ROAD DIST. NO.	ILLINOIS	PROJECT	7 39	


The applicable portions of Article 105.07 of the Standard Specification shall apply except for the following: The Contractor shall be responsible to locate the vertical depths of the underground utilities which may interfere with construction operations. This work will not be measured or paid for separately, but shall be considered as included in the unit bid price for the item of construction involved.

Per SB 699 (90 day utility relocation law), once right-of-way is clear to award the project, a notice will be sent to the utility companies instructing them to have their facilities relocated within 90 days. Estimated date relocation complete = Letting Date + 135 days.

CADD data will be available to Contractors and Consultants working on this project. This information will be provided upon request as MicroStation CADD files and Geopak coordinate geometry files <u>ONLY</u>. If data is required in other formats it will be your responsibility to make these conversions. If any discrepancy or inconsistency arises between the electronic data and the information on the hard copy, the information on the hard copy should be used. Contact the District's Project Engineer to request these files.

Program #5 (Arch. Size) Enlarge 200% Enlarge 107%

TYPICAL SECTIONS

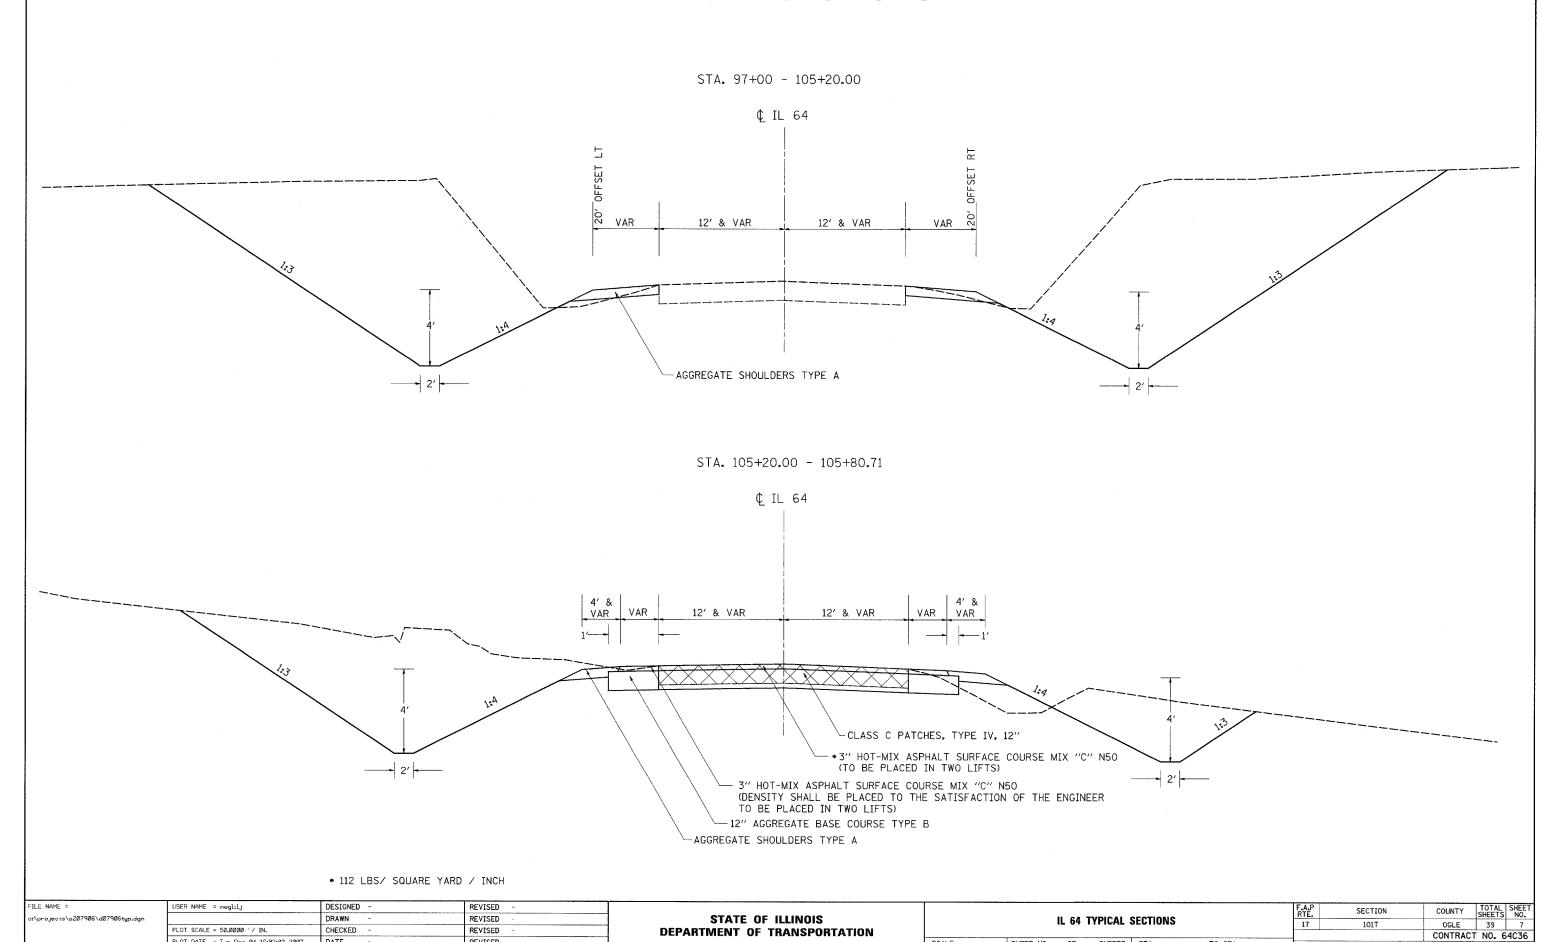

DEPARTMENT OF TRANSPORTATION

SCALE:

SHEET NO. OF SHEETS STA.

PLOT SCALE = 50.00000 '/ IN.

PLOT DATE = Tue Dec 04 16:02:03 2007

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SCHEDILLE OF OLIANTITIES

				20UEDOFE	UF			5	
20100110	TREE REMOVAL (6 TO 1	5 UNITS DIAMETER)				25100115	MULCH, METHOD 2		
	UNIT	LOCATION <i>IL 65</i>	OFFSET				ACRE	LOCATION <i>IL 64</i>	
	11	LT	100+66 52				1.5	LT&RT	97+00 - 105+80
	12	LT	100+99 52			TOTAL	1.5	_ / 5	
	14	LT	100 +9 9 52						
	7	LT	100+99 40						
TOTAL	44					25100630	EROSION CONTROL	BLANKET	
							SQ YD	LOCATION	
20100500	TREE REMOVAL ACRES							IL 64	
							424	LT	98+97 - 105+33
	ACRE	LOCATION					57	RT	101+75 - 102+50
		IL 64				TOTAL	481		
	0.25	RT	97+00 - 105+59						
TOTAL	0.25								
						28000250	TEMPORARY EROSI	ON CONTROL SEEDING (THREE APPLICATIONS)
21301052	EXPLORATION TRENCH 5	52" DEPTH					POUND	LOCATION	
								<u>IL 64</u>	
	FOOT	LOCATION					450	LT&RT	97+00 - 105+80
		IL 64				TOTAL	450		
	50	LT	101+49 FIELD TILE LOCATION						
	50	LT	104+95 FIELD TILE LOCATION						
TOTAL	100								
25000210	SEEDING, CLASS 2A								
	ACRE	LOCATION							
		IL 64							
	0.7	LT&RT	97+00 - 105+80						
TOTAL	0.7								
25000310	SEEDING, CLASS 4								
	ACRE	LOCATION							
	ACRE	IL 64							
	8.0	LT&RT	97+00 - 105+80						
TOTAL	0.8	LIGITI							
TOTAL	0.0								
25000750	MOWING								
	ACRE	LOCATION							
		<u>IL 64</u>	97+00 - 105+80						
			9 (+00 = 105+X0						

97+00 - 105+80

LT&RT

TOTAL

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SCHEDULE OF QUANTITIES

28000300	TEMPORARY DITCH	CHECKS		28000500	INLET AND PIPE PRO	TECTION				
	EACH	LOCATION			EACH	LOCATION				
		<u>IL 64</u>				IL 64				
	1	LT	97+11		1	LT	97+74			
	1	LT	97+22		1	RT	103+27			
	1	LT	97+58		1	LT	105+27			
	1	LT	99+17	TOTAL	3					
	1	LT	99+66							
	1	LT	100+14							
	1	LT	100+64	28100107	STONE RIPRAP, CLAS	S_A4				
	1	LT	101+13							
	1	LT	101+61		SQ YD	LOCATION				
	1	LT	102+04			<u>IL 64</u>				
	1	LT	102+46		13	RT	105+30	(8' X 15')		
	1	LT	102+85	TOTAL						
	1	LT	103+23							
	1	LT	103+60							
	1	LT	103+97	28200200	FILTER FABRIC					
	1	LT	104+33							
	1	LT	104+69		SQ YD	LOCATION				
	1	LT	105+03			<u>IL 64</u>				
	1	RT	97+15		13	RT	105+30	(8' X 15')		
	1	RT	97+36	TOTAL						
	1	RT	97+65							
	1	RT	97+95							
	1	RT	98+42	35101400	AGGREGATE BASE COL	JRSE TYPE B				
	1	RT	98+91							
	1	RT	99+41		TON	LOCATION				
	1	RT	99+91			<u>IL 64</u>				
	1	RT	100+40		65	LT	98+00		FE	(8" DEPTH)
	1	RT	100+88		63	LT	98+64		FE	(8" DEPTH)
	1	RT	101+37		61	RT	103+50		FE	(8" DEPTH)
	1	RT	101+77		68	LT&RT	105+30 - 1	.05+80 S	IDEROAD RETURNS	(12" DEPTH)
	1	RT	101+91	TOTAL	257	21000				
	1	RT	103+14	101712	201					
	1	RT	104+13							
	1	RT	104+49	40600990	TEMPORARY RAMP					
	1	RT	104+84							
	1	RT	105+12		SQ YD	LOCATION				
TOTAL	36				<u> </u>	IL 64				
					29	LT&RT	105+20 - 10)5+3 <u>0</u>		
					29	LT&RT	105+65 - 10			
28000400	PERIMETER EROSIO	N BARRIER		TOTAL	58	LIWIT				
				TOTAL	30					
	FOOT	LOCATION								
		IL 64								
	129	RT	102+00 - 103+00							
TOTAL	129									

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SCHEDULE OF QUANTITIES

			(0), N30	3011	LDOLL OI		MILLO		
40603315	HOI-MIX ASPHALIS	SURFACE COURSE, MIX '	'C'' N/O			542D0220	PIPE CULVERTS, CLA	ASS D. TYPE 1, 15"	
	ION	LOCATION					E00T	LOCATION	
		IL 64						<u>IL 64</u>	
	10	LT	105+30 - 105+80	SIDEROAD RETURN	(PLACED IN 2 LIFTS)		120	LT	98+35
	6	RT	105+30 - 105+80	SIDEROAD RETURN	(PLACED IN 2 LIFTS)	TOTAL	120		
	31	LT&RT	105+20 - 105+75	PATCH AREA	(PLACED IN 2 LIFTS)				
TOTAL	47								
						54213450	END SECTION, 15"		
44201383	CLASS C PATCHES.	TYPE IV. 12"					EACH	LOCATION	
								<u>IL 64</u>	
	SQ YD	LOCATION					2	LT	98+35
		<u>IL 64</u>				TOTAL	2		
	160	LT&RT	105+20 - 105+75						
TOTAL	160								
						54214725	PRECAST REINFORCE	D CONCRETE FLARED	END SECTIONS - ELLIPTICAL EQUIVALENT ROUND - SIZE 30"
48100100	AGGREGATE SHOULD	ERS TYPE A					EACH	LOCATION	
								<u>IL 64</u>	
	ION	LOCATION					2	LT&RT	105+30
		<u>IL 64</u>				TOTAL	2		
	287	LT	97+00 - 105+80	(6" DEPTH)					
	321	RT	97+01 - 105+81	(6" DEPTH)					
TOTAL	608					61100605	MISCELLANEOUS CON	CRETE	
							CU YD	LOCATION	
50100300	REMOVAL OF EXIST	ING STRUCTURES NO. 1						<u>IL 64</u>	
							1	AT FIELD TILE O	UTLET LOCATIONS (APPROXIMATE LOCATIONS 101+/-50 & 105+/-00)
	EACH	LOCATION				TOTAL	1		
		<u>IL 64</u>							
	1	LT&RT	105+66						
TOTAL	. 1					61101009	STORM SEWERS PROT	FECTED CLASS A 8"	
							FOOT	LOCATION	
50105200	REMOVE EXISTING O	CULVERTS						<u>IL 64</u>	
							50		UTLET LOCATIONS (APPROXIMATE LOCATIONS 101+/-50 & 105+/-00)
	EACH	LOCATION				TOTAL	50		
		<u>IL 64</u>							
	1	LT	105+19						
	1	RT	105+51			61133100	FIELD TILE JUNCTIO	N VAULTS. 2' DIAMET	
TOTAL	2								
							EACH	LOCATION	
								<u>IL 64</u>	
54207165	PIPE CULVERTS, TY	PE 1, REINFORCED CONC	RETE - ELLIPTICAL EQUIV	ALENT ROUND - SIZE 30"			2		UTLET LOCATIONS (APPROXIMATE LOCATIONS 101+/-50 & 105+/-00)
						TOTAL	2		
	FOOT	LOCATION							
		<u>IL 64</u>							
	58	LT&RT	105+30						
TOTAL	58								

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SCHEDULE OF QUANTITIES

				SUILDUL	L UI	UUA		J			
63200310	GUARDRAIL REMOVAL					A2006514	TREE, QUERCUS B	ICOLOR (SWAMP WHITE	OAK), 1-3/4" CALIF	ER BALLED AND BUF	LAPPED
	FOOT	LOCATION					EACH	LOCATION			
		IL 64	404.00 400	104				IL 64			
	101	LT	101+00 - 102-				45	LAYOUT BY DIS	TRICT LANDSCAPE A	RCHITECT	
	101	RT	101+43 - 102-	+44		TOTAL	45				
TOTAL	202										
						C2001748	SHRUB, CORNUS S	ERICEA CARDINAL (CAR	RDINAL REDOSIER DO	GWOOD), 4' HEIGHT.	BALLED AND BURLAPPED
63500105	DELINEATORS										
							EACH	LOCATION			
	EACH	LOCATION		REMARKS				<u>IL 64</u>			
		<u>IL 64</u>	105+30	AT THE END OF THE CULVERT			20	LAYOUT BY DIS	TRICT LANDSCAPE A	RCHITECT	
	2	LT&RT	103 / 30	AT THE END OF THE COLVENT		TOTAL	20				
TOTAL	2										
							B. 1151 151 15 15 15 15 15 15 15 15 15 15				
55500105	ELIDNICUINO AND EDECT	TING DIGHT OF WAY	V MADIZEDO			XX001135	PAVEMENT PATCH	ING. SPECIAL			
66600105	FURNISHING AND ERECT	IING KIGHI-OF-WA	Y. MARKERS				60 VP	1.0047701			
	EACH	LOCATION		OFFSET			SQ YD	LOCATION			
	EACH	IL 64		OFFSET			100	<u>IL 64</u>	105+20 - 10)5+75	
	1	1 <u>1. 64</u> LT	98+32.31	40		TOTAL	160	LT&RT			
	1	LT	98+75	65		IUIAL	160				
	1	LT	99+50	75							
	1	LT	103+50	80		Z0020900	ESTABLISHING AND	REFERENCING LAND S	ECTION MADVEDS		
	1	LT	105+58.26	75		20020300	ESTABLISHING AND	T REFERENCING LAND 3	ECTION WARKERS		
	1	RT	97+00	40			EACH	LOCATION		OFFSET	
	1	RT	97+50	55				IL 64		VIVI	
	1	RT	99+25	80			1	LT	105+91.37	1.22' LEFT	
	1	RT	102+75	80		TOTAL	1				
	1	RT	103+50	60							
	1	RT	105+59.39	60							
TOTAL	11					Z0023600	FILLING EXISTING	CULVERTS			
							EACH	LOCATION			
66700095	PERMANENT SURVEY MA	ARKERS						IL 64			
							1	LT&RT	101+72		
	EACH	LOCATION				TOTAL	1				
		IL 64									
	2	LOCATION AS DIF	RECTED BY THE ENGI	NEER							
TOTAL	2										
70001110	DAINT DAVENENT MADE	TAIO I TAIE 477 / THE	(O ADDI TOATIOIO)								
78001110	PAINT PAVEMENT MARK	ING - LINE 4" (IW	O AFFLICATIONS								
	FOOT	LOCATION									
	lVML.	IL 64									
	1816	17 D4	97+00 - 1	05+80 WHITE EDGE LINE							
	1812	RT		05+80 WHITE EDGE LINE							
	1760	RT		05+80 YELLOW NO PASSING							
	440	LT	97+00 - 1	05+80 YELLOW SKIP DASH							
TOTAL	5828										
101/12	5525										


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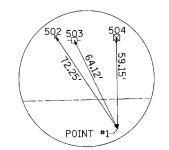
				EARTH WORK	K SCHEDULE	-	
				20200100	EARTH		EARTH WORK
				EARTH	EXC ADJ		BALANCE
LOG	CATIO	N		EXC	SHRINK	EMBANK	WASTE (+)
				(CUT)	25%	(FILL)	SHORTAGE (-)
				CU YD	CU YD	CU YD	CU YD
97 + 00		100 + 00		2338	1753	68	1685
100 + 00	_	105 +	80	4045	3034	418	2616
					-		
TOTAL				6383	4787	486	4301

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	PLOT DATE = Tue Dec 04 15:44:45 2007	DATE -	REVISED -		SCALE: SHEET NO. OF SHEETS STA. TO STA.	FED. ROAD DIST. NO. ILLINOIS FED. AI	ID PROJECT


HORIZONTAL VERTICAL CONTROL





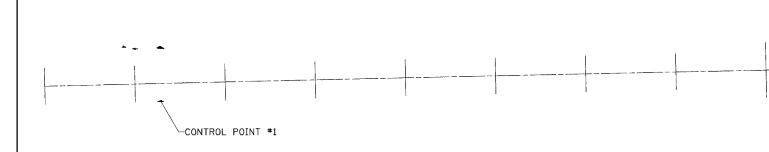

HORIZONTAL CONTROL POINT #1

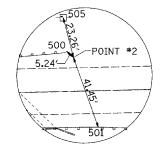

HORIZONTAL CONTROL POINT #2

Chain IL64 contains: G0261260 CUR 200 CUR 210 220

Beginning chain IL64 description

Point G0261260 N 1,962,533.3202 E 2,427,842.9914 Sta 5+52.6233

Course from G0261260 to PC 200 88° 03′ 57.3801″ Dist 6,249.8235′

Curve Data

Curve 200
P.I. Station 76+30.6429 N 1,962,772.1986 E 2,434,916,9788
Delta = 0° 39′ 47.3182″ (RT)
Degree = 0° 02′ 24.1292″
Tangent = 828.1960′
Length = 1,656.3736′
Radius = 143,111.0348′
External = 2.3964′
Long Chord = 1,656.3643′
Mid. Ord. = 2.3964′
P.C. Station 68+02.4468 N 1,962,744.2475 E 2,434,089.2546
P.T. Station 84+58.8204 N 1,962,790.5678 E 2,435,744.9711
C.C. N 1,819,714.7389 E 2,438,919.1552

Course from PT 200 to PC 210 88° 43′ 44.6983″ Dist 10,179.0097′

Curve Data

*-----Curve 210

P.I. Station 188+90.9552 N 1,963,021.9512 E 2,446,174.5396

Delta = 0° 37′ 18.3331″ (RT)

Degree = 0° 07′ 22.1439″

Tangent = 253.1252′

Length = 506.2454′

Radius = 46,651.0557′

External = 0.6867′

Long Chord = 506.2429′

Mid. Ord. = 0.6867′

P.C. Station 186+37.8300 N 1,963,016.3370 E 2,445,921.4767

P.T. Station 191+44.0754 C.C. N 1,916,376.7576 E 2,446,956.1910

Course from PT 210 to 220 89° 21' 03.0314" Dist 7,387.9239'

Point 220 N 1,963,108.5220 E 2,453,815.0982 Sta 265+31.9993

Ending chain IL64 description

				HORIZONTAL	CONTROL	POINTS	
POINT	NORTH	EAST	ELEVATION	CHAIN	STATION	OFFSET	DESCRIPTION
1	1962790.5890	2436614.4020	860.1600	IL64	93+28.0379	19.2627' RT	PIN
2	1962848.1290	2437490.8820	841.1810	IL64	102+05.5785	18.8229' LT	PIN
65722926	1947200.3330	2445080.8679	918.8367	IL64	174+46.6311	15793.4686' RT	NGS MONUMENT
65722925	1948558.9644	2442895.4309	904.3167	IL64	152+91.8660	14386.6987' RT	NGS MONUMENT

-CONTROL POINT #2

				BEN	CH MARKS		
POINT	NORTH	EAST	ELEVATION	CHAIN	STATION	OFFSET	DESCRIPTION
401	1962849.0935	2436614.6498	863.4652	IL64	93+29.5832	39 . 2219′ LT	R.O.W. MARKER


		R	EFERENCE	TIES
POINT	CHAIN	STATION	OFFSET	DESCRIPTION
500	IL64	102+01.8072	22.4585′ LT	GUARDRAIL STEEL PLATE BEAM, END
501	IL64	102+18.6413	20.5115' RT	GUARDRAIL STEEL PLATE BEAM, END
502	IL64	92+88.8313	41.4268' LT	FENCE CORNER, SHINER
503	IL64	93+00.9372	38.8517' LT	POWER POLE, SHINER
504	IL64	93+28.5300	39.8889' LT	R.O.W. MARKER, FACE
505	IL64	102+00,3417	41.4806′ LT	POWER POLE, SHINER


	CURVE POIN	NUN TI	1BERS		
CHAIN	CURVE	PI	cc	PC	PT
IL64	200	200	201	202	203
IL64	210	210	211	212	213

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	PLOT DATE = Wed Dec 05 07:48:36 2007	DATE -	REVISED -

STATE OF ILLINOIS
DEPARTMENT OF TRANSPORTATION


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		_			CONTRACT	NO. 6	64C36
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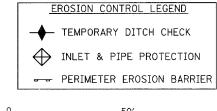


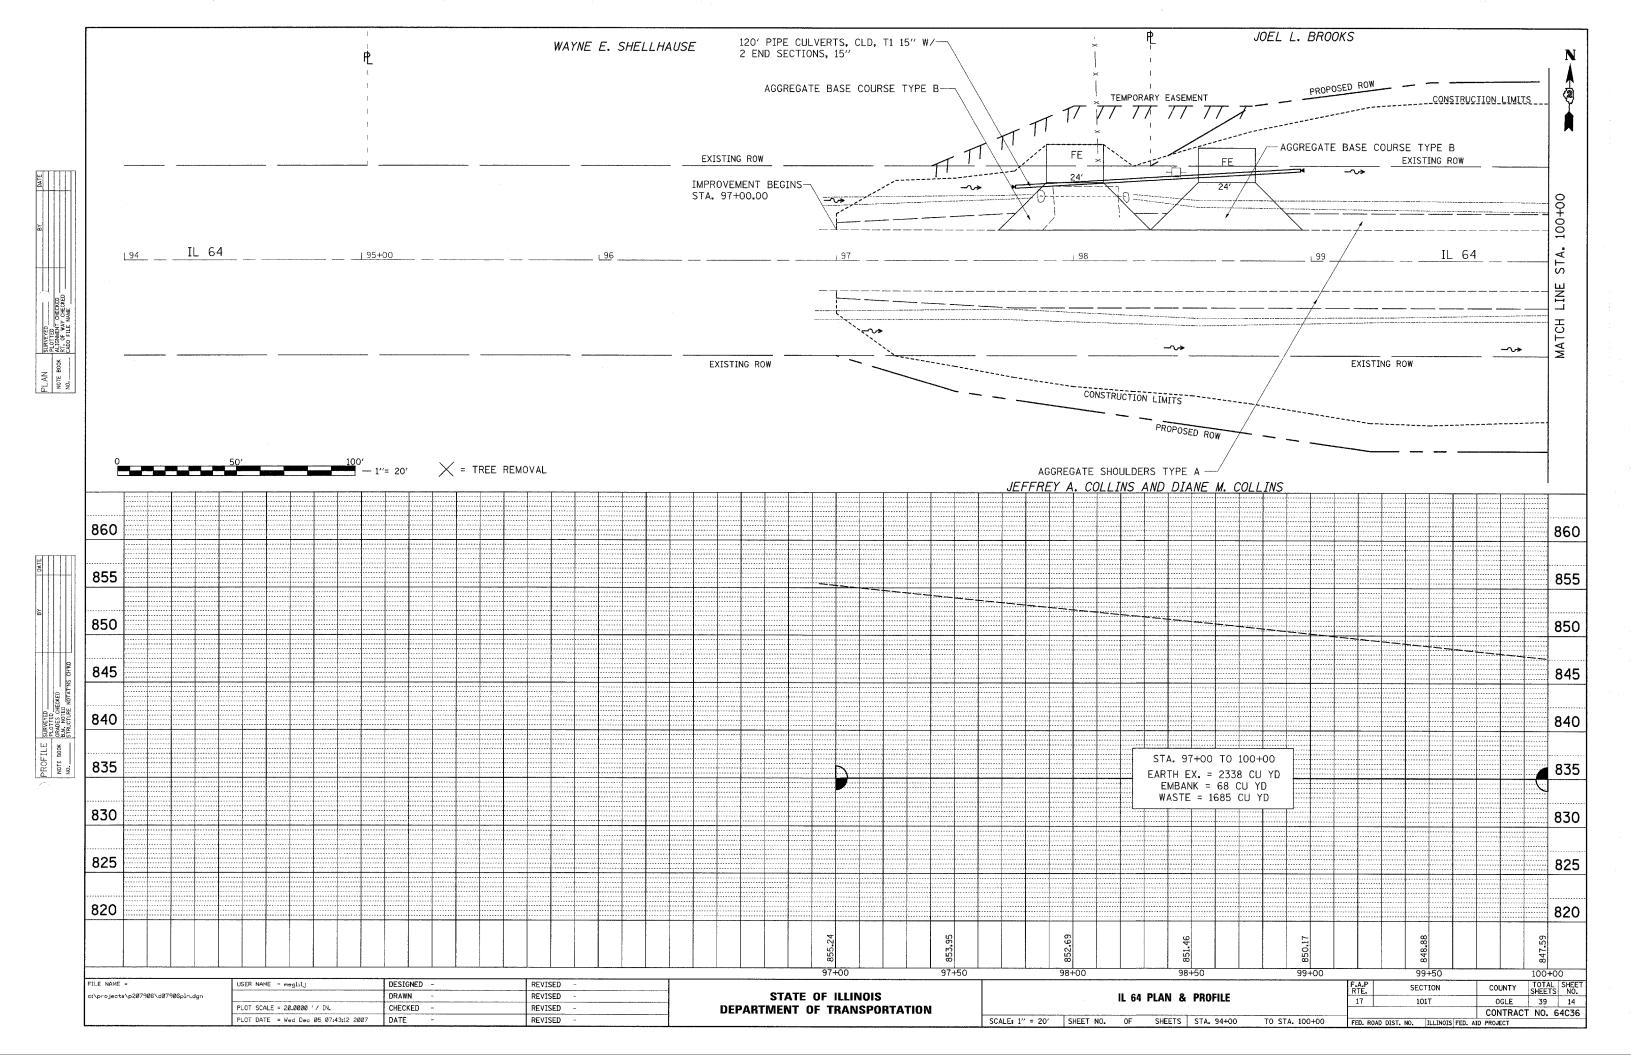

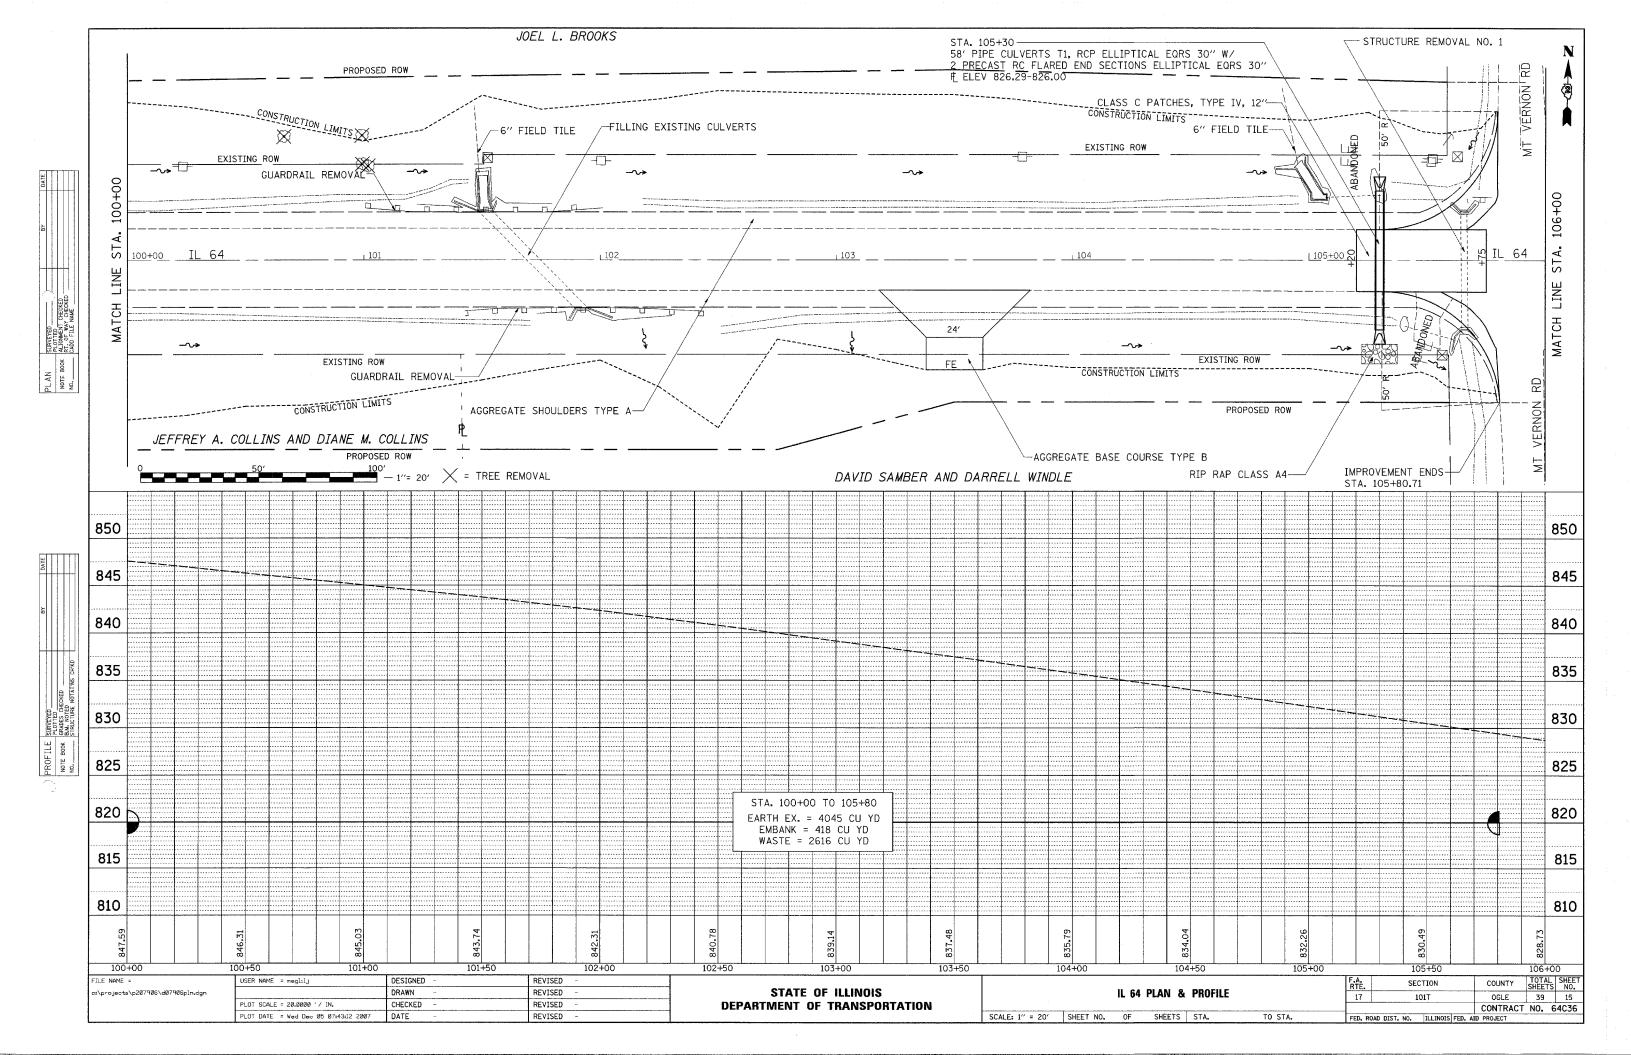EROSION CONTROL AND ROW DETAILS





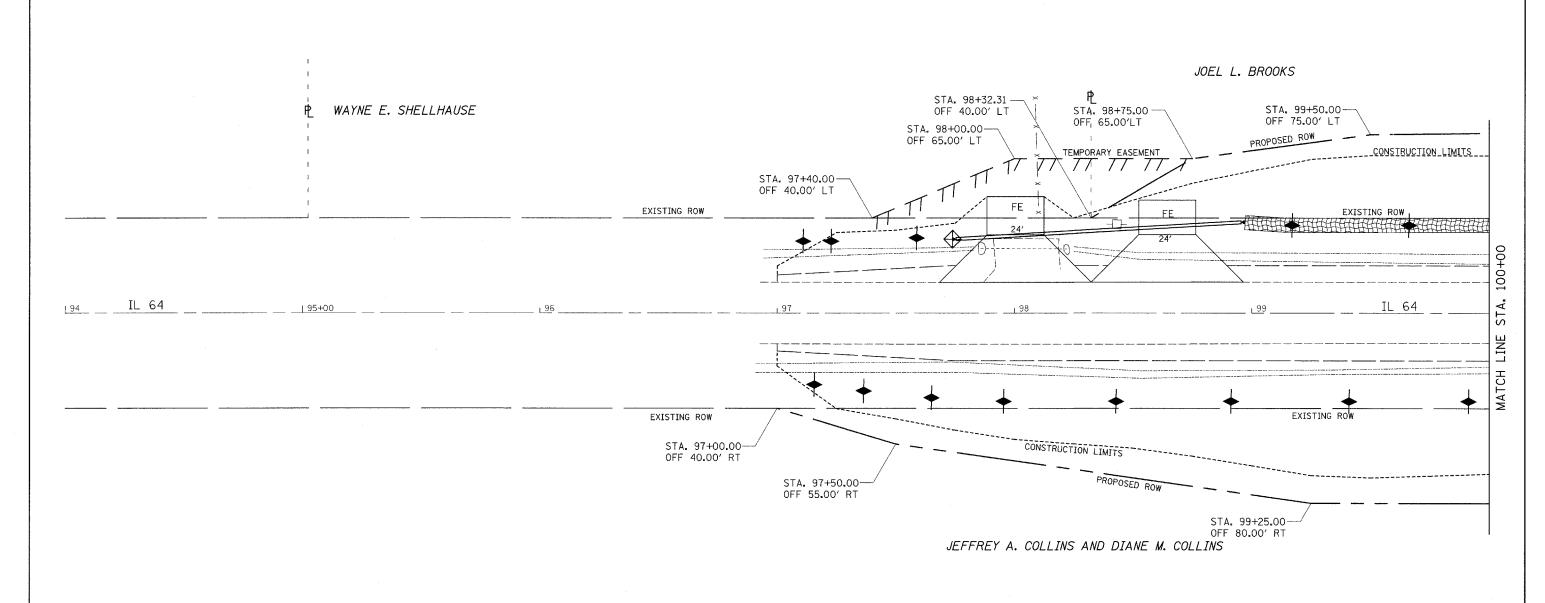


30	100						
	1// 20/						
	1 - 20						


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EROSION CONTROL AND ROW DETAILS



JOEL L. BROOKS




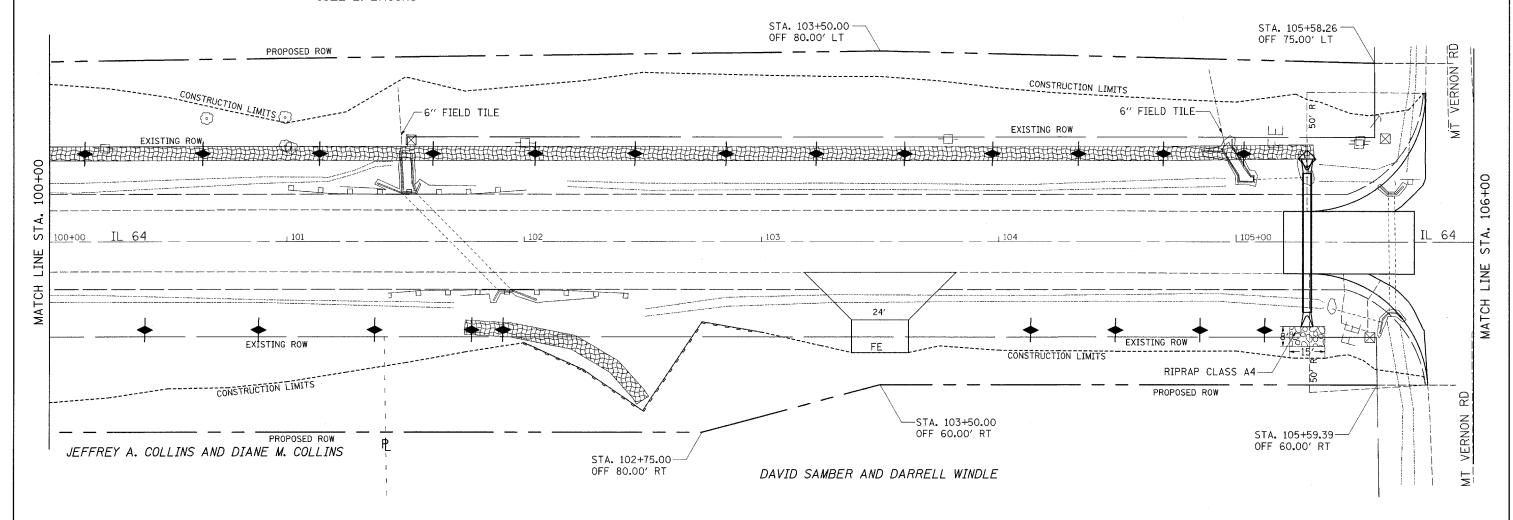

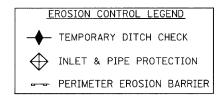0	50′	<u>10</u> 0′
		— 1''= 20'

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SLOPE WALL FOR FIELD TILE OUTLETS

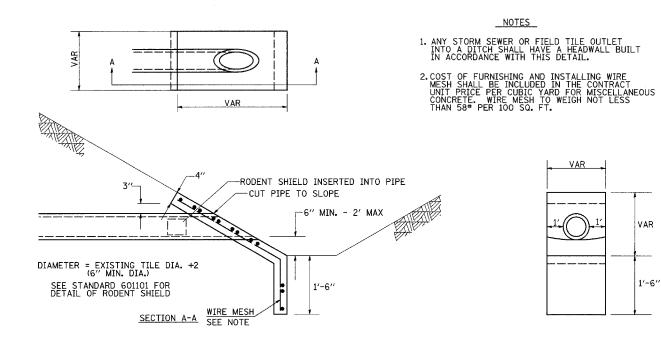


REVISED - 1-24-07

SLOPE WALL FOR FIELD TILE OUTLETS


28.4

DELINEATOR AND POST ORIENTATION

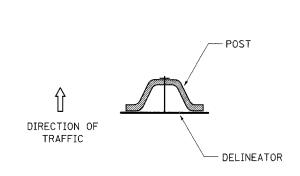

DELINEATORS SHALL BE INSTALLED ACCORDING TO STANDARD 635001 EXCEPT THAT THE POST SHALL BE ROTATED 180°. THE POST WILL HAVE THE WIDE SIDE FACING TRAFFIC AND THE DELINEATOR ATTACHECD AS SHOWN ABOVE.

ALL DIMENSIONS ARE IN MILLIMETERS (INCHES) UNLESS OTHERWISE NOTED.

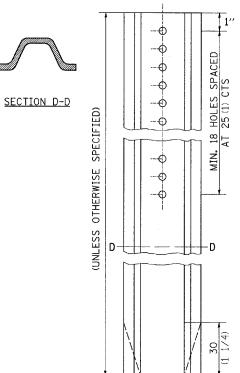

REVISED - 11-01-07

DELINEATOR AND POST ORIENTATION

LETTERING FOR NAME PLATE

STATION BUILT 200 BY STATE OF ILLINOIS RTE. SEC. FA PROJECT LOADING HS 20 STR. NO.

SEE STD. 515001


STATION	STRUCTURE NO.
	
	_1

ALL DIMENSIONS ARE IN MILLIMETERS (INCHES) UNLESS OTHERWISE NOTED.

REVISED - 11-01-07 REVISED REGION 2 / DISTRICT 2 STANDARD REVISED SCALE: 50.0000 // IN SHEET NO. OF SHEETS STA. REVISED

SECTION OGLE 39 18 CONTRACT NO. 64C36

TYPICAL BENCHING ON EXISTING EMBANKMENT

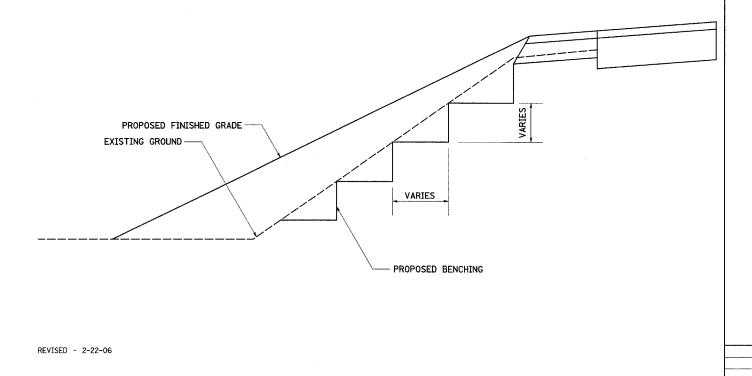

TYPICAL BENCHING ON EXISTING EMBANKMENT

50.4

LETTERING FOR NAME PLATE

37.4

TREE REPLACEMENT SCHEDULE


CODE NUMBER	SCIENTIFIC NAME	COMMON NAME	SIZE	UNIT	QUANTITY
A2006514	QUERCUS BICOLOR	SWAMP WHITE OAK	1 3/4" B&B	EACH	45
C2001748	CORNUS SERICA CARDINAL	CARDINAL REDOSIER DOGWOOD	4' HEIGHT B&B	EACH	20
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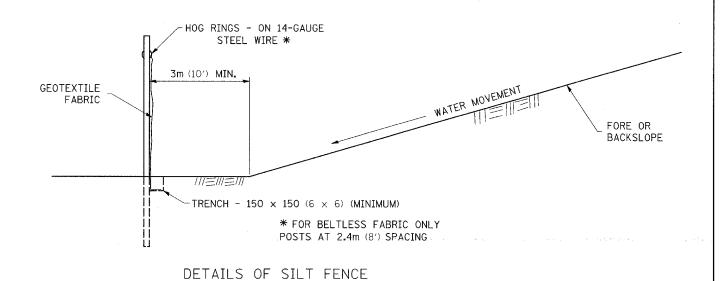
ALL DIMENSIONS ARE IN MILLIMETERS (INCHES) UNLESS OTHERWISE NOTED.

REVISED - 8-10-05

TREE REPLACEMENT SCHEDULE 90.4

EROSION CONTROL DETAILS FOR SILT FENCE




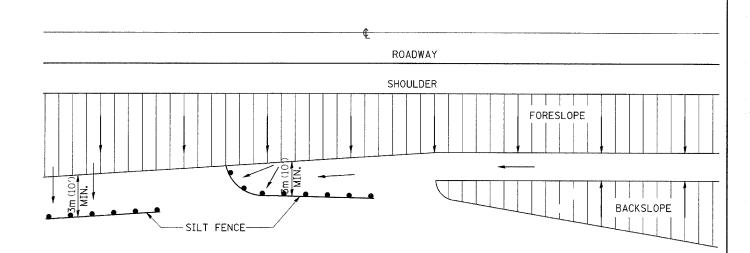


ALL DIMENSIONS ARE IN MILLIMETERS (INCHES) UNLESS OTHERWISE NOTED.

REVISED - 10-22-01						F.A.P RTE.	SECTION	COUNTY	TOTAL	SHEET NO.
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	ļ			·				CONTRAC	T NO. 6	4C36
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FIELD TILE JUNCTION VAULTS 600 (24) AND 900 (36) DIA.



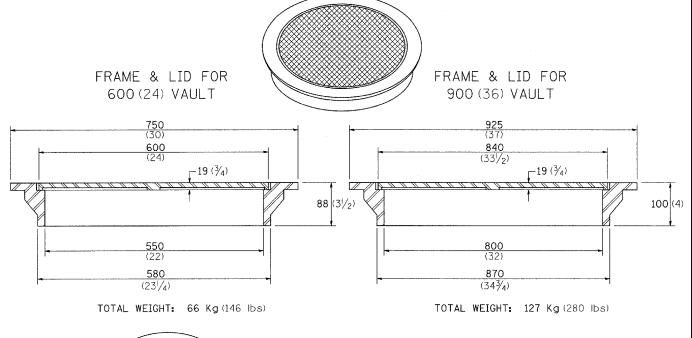

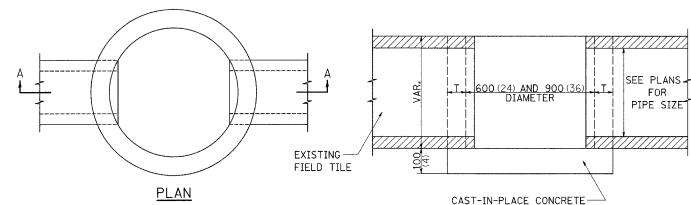
ALTERNATE MATERIALS FOR WALLS	T
BRICK MASONRY	200 (8)
CAST-IN-PLACE CONCRETE	150 (6)
CONCRETE MASONRY UNIT	125 (5)
PRECAST REINFORCED CONCRETE SECTION	75 (3)

NOTE: THE FRAME AND LID IS REQUIRED ON ALL JUNCTION VAULTS.


SECTION A-A

ALL DIMENSIONS ARE IN MILLIMETERS (INCHES) UNLESS OTHERWISE NOTED.


REVISED - 5-03-94

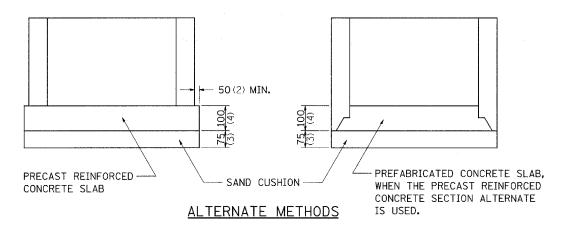

WITNESS MARKER FOR PERMANENT **SURVEY MARKERS, TYPE II**

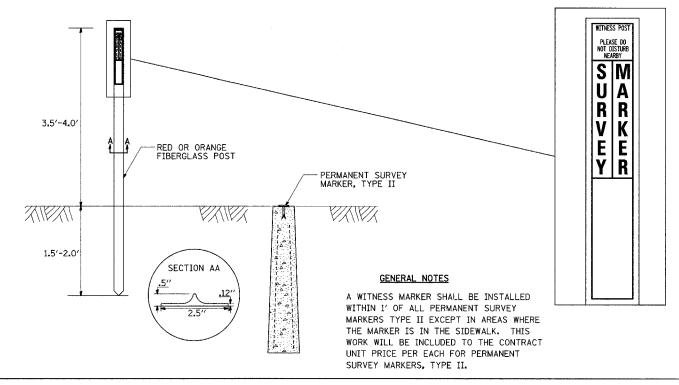

PERMANENT SURVEY MARKERS, TYPE II

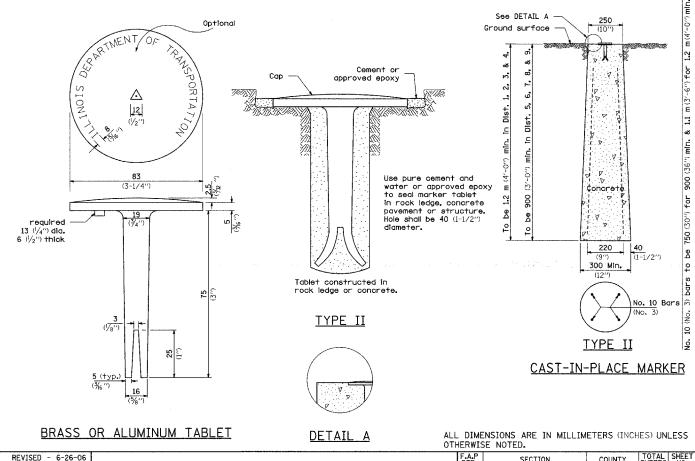

COUNTY REGION 2 / DISTRICT 2 STANDARD REVISED -0GLE 39 20 REVISED CONTRACT NO. 64C36 SCALE: 50.0000 '/ IN SHEET NO. OF SHEETS STA. REVISED 30.2 PLOT DATE = Tue Dec 04 15:44:42 2007

STORM WATER POLLUTION PREVENTION PLAN EROSION CONTROL PLAN

THE FOLLOWING PLAN WAS ESTABLISHED AND INCLUDED IN THESE PLANS TO DIRECT THE CONTRACTOR IN THE PLACEMENT OF TEMPORARY EROSION CONTROL SYSTEMS AND TO PROVIDE A STORM WATER POLLUTION PREVENTION PLAN FOR COMPLIANCE UNDER NPDES.

THE PURPOSE OF THIS PLAN IS TO MINIMIZE SILTATION WITHIN THE CONSTRUCTION ZONE AND TO ELIMINATE SEDIMENTS FROM ENTERING AND LEAVING THE CONSTRUCTION ZONE BY UTILIZING PROPER TEMPORARY EROSION CONTROL SYSTEMS AND PROVIDING GROUND COVER WITHIN A REASONABLE AMOUNT OF TIME.

CERTAIN ITEMS, AS SHOWN IN THIS PLAN AND REFERENCED BY THE LEGEND, SHALL BE PLACED BY THE CONTRACTOR AT THE BEGINNING OF CONSTRUCTION. OTHER ITEMS SHALL BE PLACED BY THE CONTRACTOR AS DIRECTED BY THE ENGINEER ON A CASE BY CASE SITUATION RESULTING FROM THE CONTRACTOR'S SEQUENCE OF ACTIVITIES, TIME OF YEAR, AND EXPECTED WEATHER CONDITIONS.

THE CONTRACTOR SHALL PLACE PERMANENT EROSION CONTROL SYSTEMS AND SEEDING WITHIN A REASONABLE AMOUNT OF TIME: THEREFORE, REDUCING THE AMOUNT OF AREA BEING OPEN TO THE POSSIBILITY OF EROSION AND REDUCING THE AMOUNT OF TEMPORARY SEEDING. THE RESIDENT ENGINEER WILL DETERMINE IF TEMPORARY EROSION CONTROL SYSTEMS SHOWN IN THE PLAN CAN BE DELETED, THE SIZE OF THE PROPOSED DITCH CHECKS, THE PROPER METHOD OF INSTALLATION, AND IF ANY ADDITIONAL TEMPORARY EROSION CONTROL SYSTEMS SHALL BE ADDED WHICH ARE NOT INCLUDED IN THE PLANS. THE CONTRACTOR SHALL PERFORM ALL WORK AS DIRECTED BY THE ENGINEER AND AS SHOWN IN STANDARD 280001 OF THE PLANS.

SITE DESCRIPTION

DESCRIPTION OF CONSTRUCTION ACTIVITY:

THIS PROJECT CONSISTS OF REMOVAL AND REPLACEMENT OF A CULVERT (SN 071-1139) CARRYING IL 64 OVER A DRAINAGE DITCH LOCATED 0.1 MILES WEST OF MT VERNON RD

DESCRIPTION OF INTENDED SEQUENCE OF ACTIVITIES:

THE SEQUENCE OF EVENTS ARE AS FOLLOW: CLEARING, EMBANKMENT, EXCAVATION, GRADING AND PAVING. THIS PROJECT WILL BE CONSTRUCTED IN SEGMENTS AS SHOWN IN THE "STAGING PLANS".

TOTAL CONSTRUCTION SITE (CONSTRUCTION LIMIT TO CONSTRUCTION LIMIT) 2.25 ACRES PROPOSED R.O.W (TOTAL PARCEL AREA) 1.14 ACRES

DISTURBED BY EXCAVATION (E.O.P TO CONSTRUCTION LIMIT) 1.71 ACRES

SUPPORTING REPORTS AND PLANS

THE FOLLOWING ASSISTED IN DEVELOPING THE EROSION CONTROL PLAN AS REFERENCED DOCUMENTS:

SOIL PROFILE SHEETS, SOILS REPORTS, BORING LOGS USGS DRAINAGE MAPS, PROJECT PLAN DOCUMENTS

DRAINAGE TRIBUTARIES RECEIVING WATER FROM CONSTRUCTION SITE

EROSION CONTROLS AND SEDIMENT CONTROL PROCEDURES

STABILIZATION PRACTICES AT THE BEGINNING OF CONSTRUCTION:

PERIMETER EROSION CONTROL SHALL BE PLACED PRIOR TO BEGINNING EARTHWORK.


STABILIZATION PRACTICES DURING CONSTRUCTION:

AS EARTH EXCAVATION AND EMBANKMENT ARE BEING COMPLETED THE CONTRACTOR SHALL PLACE DITCH CHECKS, INLET AND PIPE PROTECTION, EROSION CONTROL BLANKET, AND SEEDING AS STAGES OF THE PROJECT ARE COMPLETED. PERIMETER EROSION BARRIER WILL BE INSTALLED AT ADDITIONAL LOCATIONS AS THE PROJECT PROGRESSES. SEEDING SHALL BE COMPLETED AS SPECIFIED IN THE EROSION CONTROL/SEEDING MOBILIZATION AND TEMPORARY SEEDING SPECIAL PROVISION.

MAINTENANCE AFTER FINAL GRADING

TEMPORARY EROSION CONTROL SYSTEMS SHALL BE LEFT IN PLACE WITH PROPER MAINTENANCE UNTIL PERMANENT EROSION CONTROL IS IN PLACE AND WORKING PROPERLY AND ALL PROPOSED TURF AREAS SEEDED AND ESTABLISHED WITH THE PROPER STAND. ONCE PERMANENT EROSION CONTROL SYSTEMS AS PROPOSED IN THE PLANS ARE FUNCTIONAL AND ESTABLISHED, TEMPORARY ITEMS SHALL BE REMOVED, CLEANED UP AND DISTURBED TURF RESEEDED.

FILE NAME =	USER NAME = meglilj	DESIGNED -	REVISED - 5-12-04					F.A.P	SECTION	COUNTY	TOTAL SHEET
c:\projects\p207906\d07906cvr.dgn		DRAWN	REVISED -	STATE OF ILLINOIS	REGION 2 / DISTRICT 2 STANDARD				101T	0015	30 21
	PLOT SCALE = 50.0000 '/ IN.	CHECKED	REVISED -	DEPARTMENT OF TRANSPORTATION				1011	CONTRAC	T NO 64036	
	PLOT DATE = Tue Dec 04 15:44:42 2007	DATE -	REVISED -		SCALE:	SHEET NO. OF SHEETS STA.	TO STA.	FED. ROAD	DIST, NO. ILLINOIS F	FED. AID PROJECT	21 NO. 04036

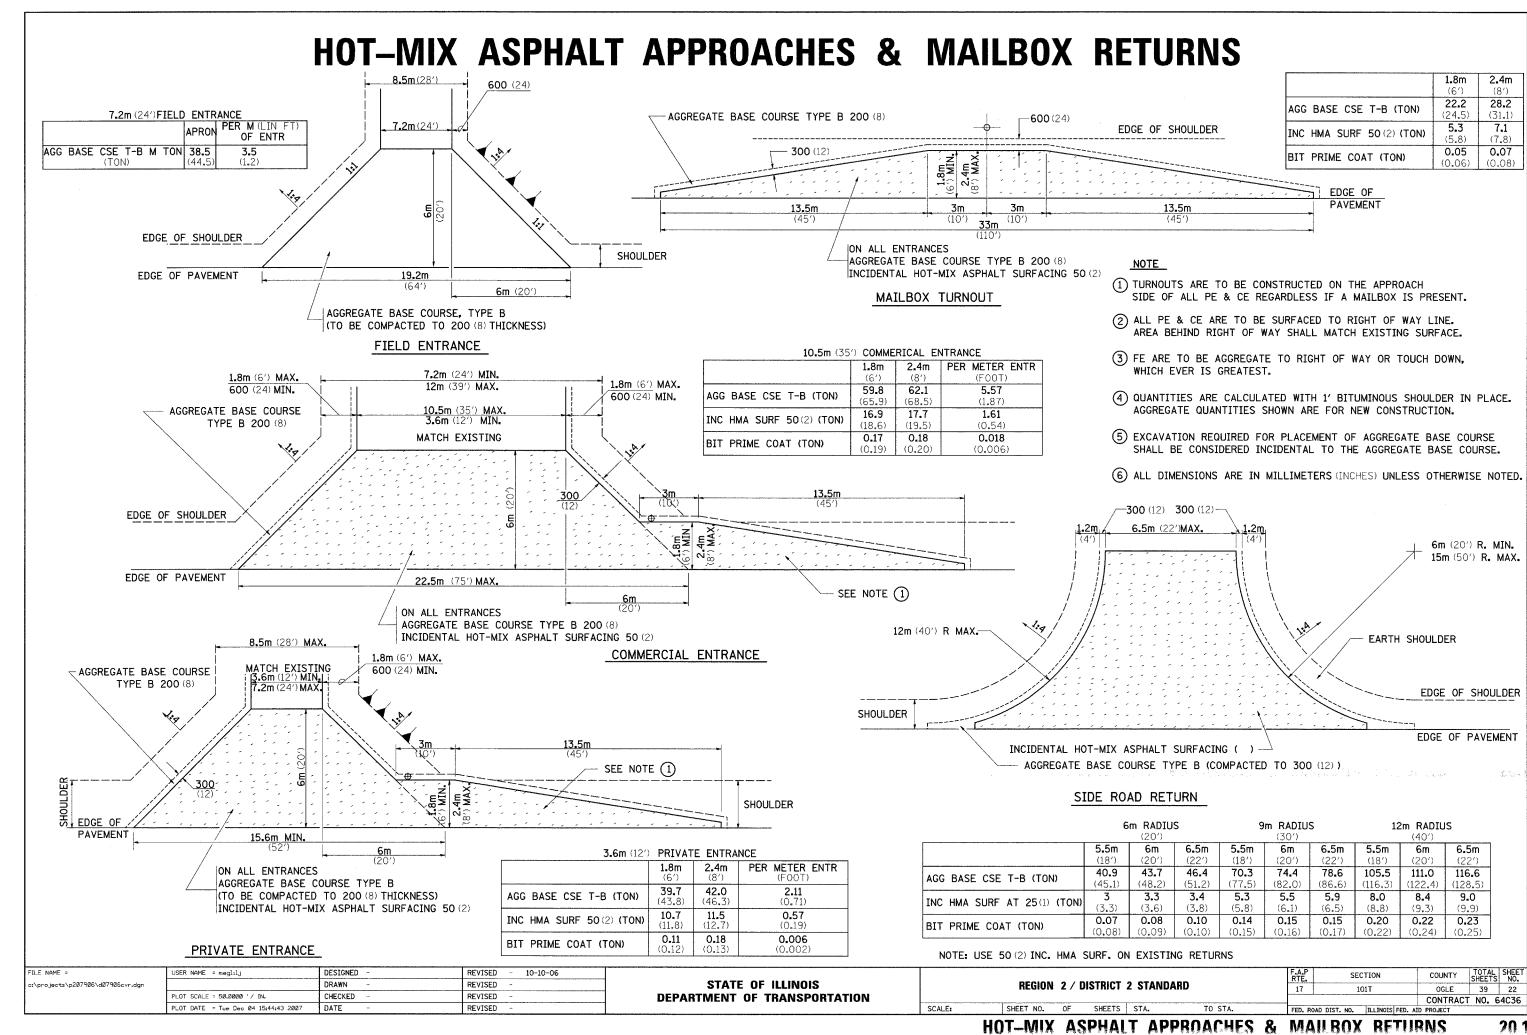


TYPICAL PAVEMENT MARKINGS

MEDIAN PAVEMENT MARKING


100 (4) YELLOW

** ALL DIMENSIONS ARE IN MILLIMETERS (INCHES) UNLESS OTHERWISE NOTED.

TYPICAL PAVEMENT MARKING FOR FLUSH MEDIAN AT LEFT TURN LANE

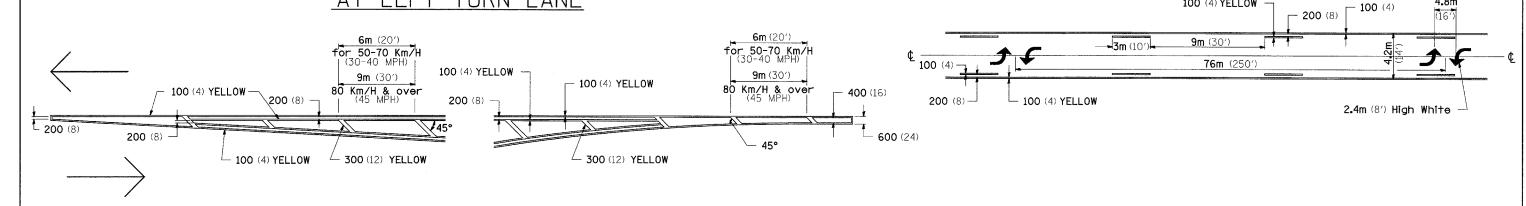

TYPICAL ISLAND OFFSET SHOULDER WIDTH

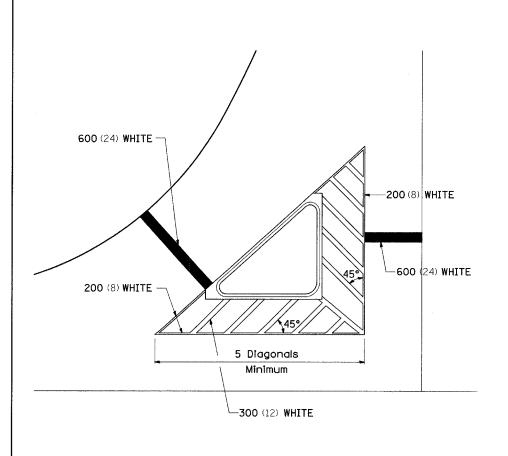

USER NAME = meglilj

PLOT SCALE = 50.0000 '/ IN.

PLOT DATE = Tue Dec 04 15:44:43 2007

DESIGNED

CHECKED

DRAWN

DATE

FILE NAME =

:\projects\p207906\d07906cvr.dg

TYPICAL PARKING SPACING

Face of Curb

STATE OF ILLINOIS

DEPARTMENT OF TRANSPORTATION

6m (20') Min. -

SCALE:

-6m (20') Min.


No Parking Zone

REVISED - 7-20-06

REVISED

REVISED

REVISED

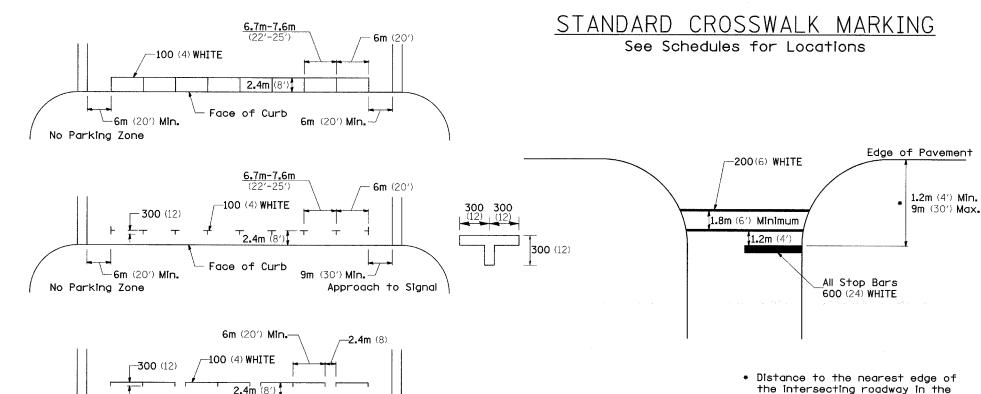


F.A.P RTE. OGLE 39 23 CONTRACT NO. 64C36 SHEETS STA. TO STA. 41.1

absence of a marked crosswalk.


SECTION

COUNTY

REGION 2 / DISTRICT 2 STANDARD

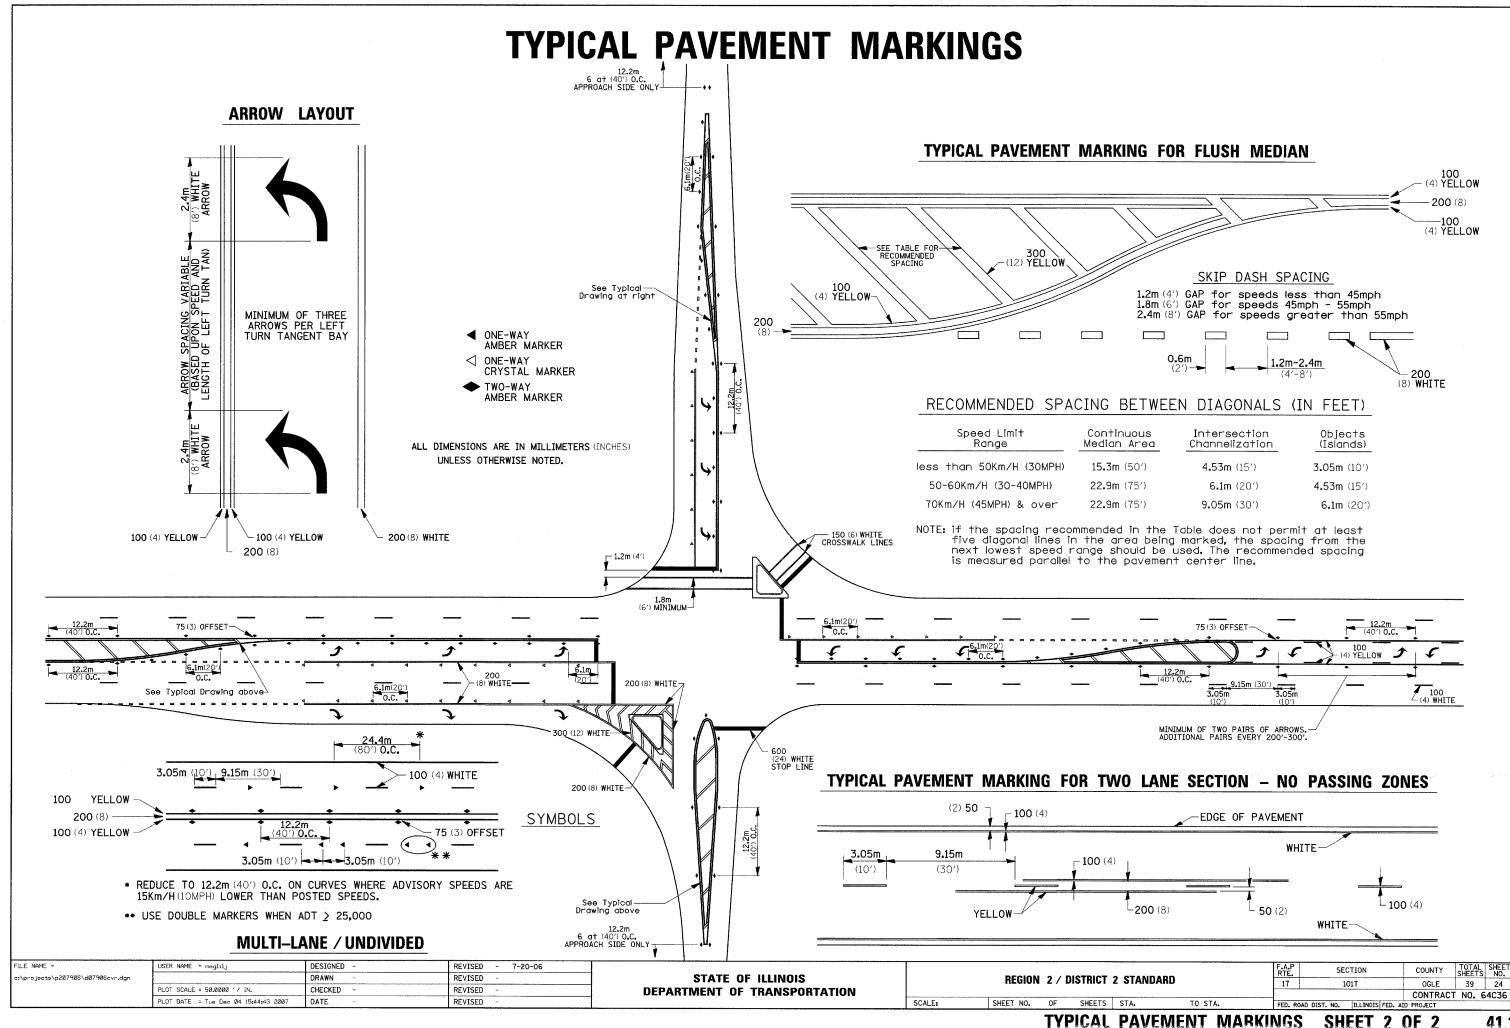


DETAILS OF PLANTING AND BRACING TREES

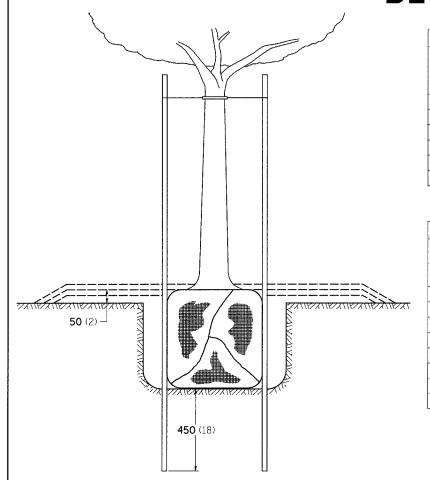



SMALL	A	В	С	D	E	F
TREE SIZE	DIAMETER OF BALL OR ROOT SYS.	DEPTH OF HOLE EXCAVATION	WIDTH OF HOLE EXCAVATION	THICKNESS OF MULCH COVER	DEPTH OF BALL OR ROOT SYS.	VOLUME OF MULCH COVER m ³ (CU. YDS.)
1.5-1.8m (5'-6')	400 (16)	250 (10)	750 (30)	100 (4)	300 (12)	0.41 (0.54)
1.5-1.8m (5'-6') BB	400 (16)	250 (10)	750 (30)	100 (4)	300 (12)	0.41 (0.54)
1.8-2.0m (6'-7') BB	450 (18)	300 (12)	750 (30)	100 (4)	350 (14)	0.41 (0.54)
2.0-2.4m (7'-8') BB	500 (20)	275 (11)	750 (30)	100 (4)	325 (13)	0.41 (0.54)
2.4-3.0m (8'-10') BB	600 (24)	350 (14)	900 (36)	100 (4)	400 (16)	0.47 (0.61)
3.0-3.6m (10'-12') BB	650 (26)	375 (15)	900 (36)	100 (4)	425 (17)	0.47 (0.61)


LARGE	Α	В	С	D	Е	F
TREE SIZE	DIAMETER OF BALL OR ROOT SYS.	DEPTH OF HOLE EXCAVATION	WIDTH OF HOLE EXCAVATION	THICKNESS OF MULCH COVER	DEPTH OF BALL OR ROOT SYS.	VOLUME OF MULCH COVER m³ (CU. YDS.)
0-50 (0-2)	500 (20)	275 (11)	900 (36)	100 (4)	325 (13)	0.47 (0.61)
50-65 (2-21/2) BB	600 (24)	350 (14)	1200 (48)	100 (4)	400 (16)	0.60 (0.78)
65-75 (21/2-3) BB	700 (28)	425 (17)	1200 (48)	100 (4)	475 (19)	0.60 (0.78)
75-90 (3-31/ ₂) BB	800 (32)	425 (17)	1500 (60)	100 (4)	475 (19)	0.73 (0.96)
90-100 (3 ¹ / ₂ -4) BB	900 (36)	500 (20)	1500 (60)	100 (4)	550 (22)	0.73 (0.96)
100-115 (4-4 ¹ / ₂) BB	1000 (40)	550 (22)	1800 (72)	100 (4)	600 (24)	0.89 (1.16)
115-125 (41/2-5) BB	1100 (44)	600 (24)	1800 (72)	100 (4)	650 (26)	0.89 (1.16)
125-140 (5-51/ ₂) BB	1200 (48)	675 (27)	2100 (84)	100 (4)	725 (29)	1.06 (1.38)

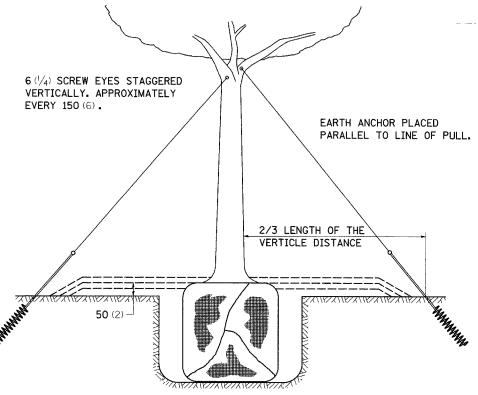

TREES OVER 115 $(4\frac{1}{2})$ IN DIAMETER

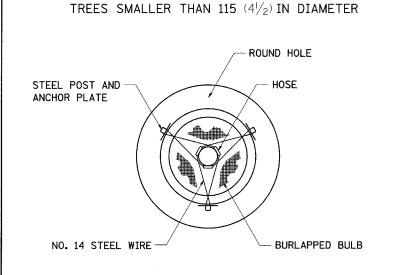

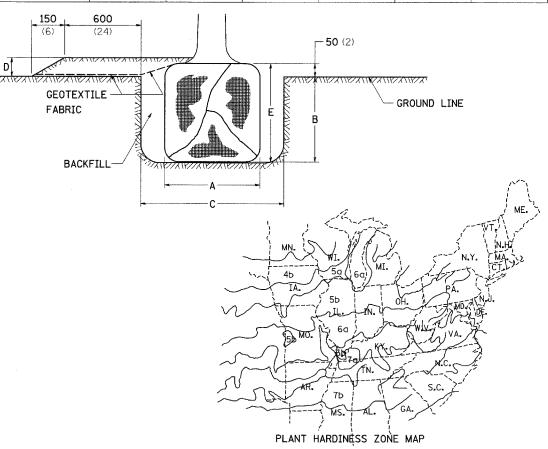

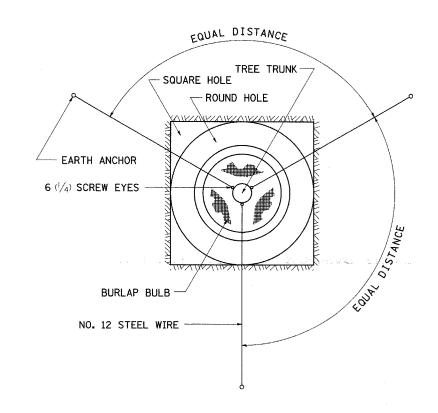

ALL DIMENSIONS ARE IN MILLIMETERS (INCHES) UNLESS OTHERWISE NOTED.

FILE NAME = c:\projects\p207906\d07906cvr.dgn

STATE OF ILLINOIS
DEPARTMENT OF TRANSPORTATION

U.S. DEPARTMENT OF AGRICULTURE

AGRICULTURAL RESEARCH SERVICE

PUBLICATION NO. 814

REGION 2 / DISTRICT 2 STANDARD

SHEET NO. OF SHEETS STA. TO

