


F.A.S. RTE.	SECTION	COUNTY	TOTAL SHEETS	SHEET NO.
1832	5BR-2	WASHINGTON	97	65
STA. _____		TO STA. _____		
FED. ROAD DIST. NO. _____		ILLINOIS FED. AID PROJECT		

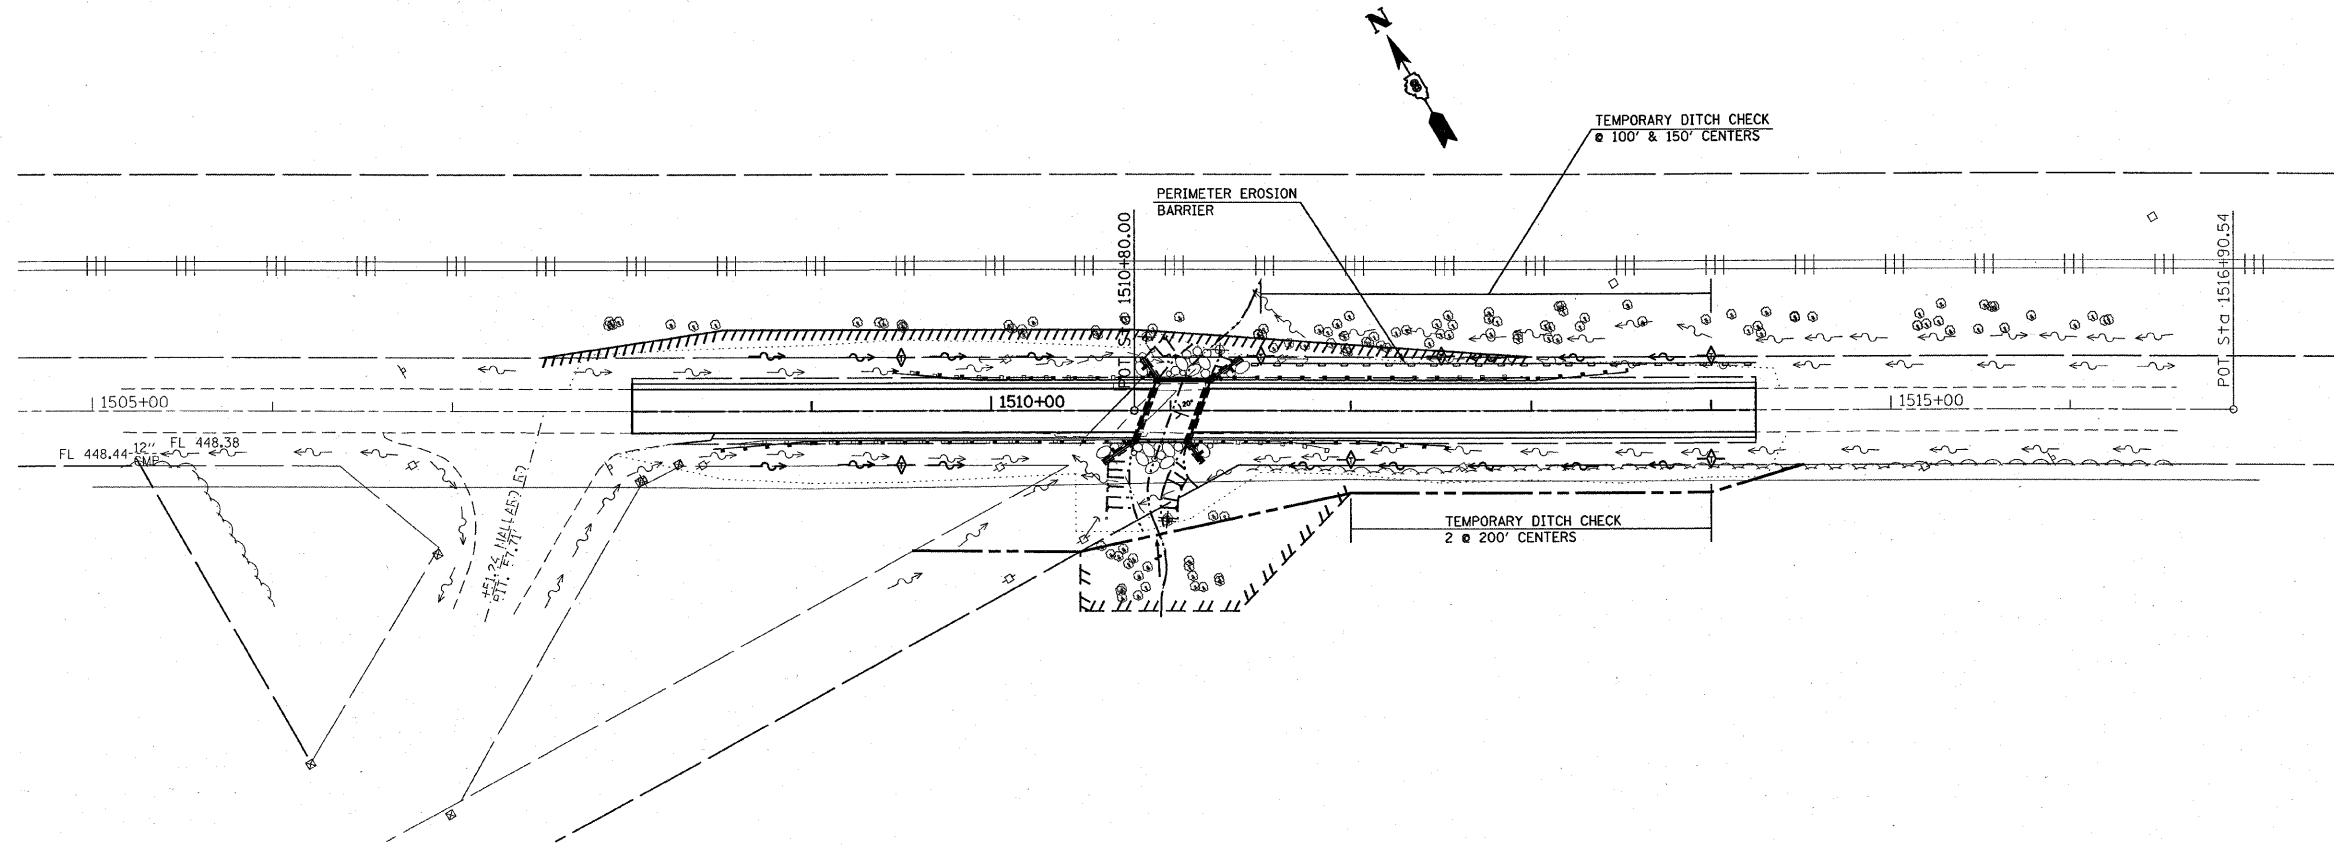


LEGEND

- ◆ INLET AND PIPE PROTECTION - STRAW BALES, FILTER FABRIC, AGGREGATES, TREE REMOVAL
- ◆ TEMPORARY DITCH CHECK - ROLLED EXCELSIOR, SILT WEDGES/PANELS
- PERIMETER EROSION BARRIER- SILT FILTER FENCE OR OTHER AS APPROVED BY THE ENGINEER

TEMPORARY EROSION CONTROL SCHEDULE

LOCATION	RT/LT	TEMP EROSION CONTROL SEEDING (POUND)	MULCH METHOD 1 (ACRE)	PERIMETER EROSION BARRIER (FOOT)	TEMP DITCH CHECK (EACH)
1507+75.00 TO 1514+25.00	LT	18.90	0.21		
1507+75.00 TO 1514+25.00	RT	32.40	0.36		
1509+50.00	RT/LT				2
1511+45.00 TO 1514+25.00	LT			280	
1511+50.00 TO 1514+00.00	LT				3
1512+00.00 TO 1514+00.00	RT				2
TOTAL		51.30	0.57	280	7

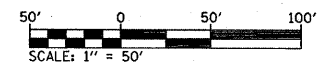

S.N. 095-0078

REVISIONS	
NAME	DATE

ILLINOIS DEPARTMENT OF TRANSPORTATION

EROSION CONTROL PLAN

FAS ROUTE 1832
SECTION 5BR-2
WASHINGTON COUNTY

SCALE: VERT. HORIZ. DATE

DRAWN BY CHECKED BY

PLOT DATE = 12/7/2007
FILE NAME = c:\p\proj\erose\erose.dgn
SCALE = 1" = 50'
REFERENCE = 89254