03-08-2024 LETTING ITEM 010


FOR INDEX OF SHEETS, HIGHWAY STANDARDS, AND LEGEND SEE SHEET NO. 2

POLICY STATEMENT:
PLANS DESIGNED IN ACCORDANCE WITH THE
BUREAU OF LOCAL ROADS AND STREETS MANUAL

STATE OF ILLINOIS DEPARTMENT OF TRANSPORTATION

PLANS FOR PROPOSED FEDERAL-AID HIGHWAY

JOHN SHIELDS ELEMENTARY SCHOOL
SIDEWALK IMPROVEMENTS
SECTION 20-00031-00-SW
PROJECT NUMBER: YPYX (798)
VILLAGE OF SUGAR GROVE
KANE COUNTY
JOB NO. C-91-116-23

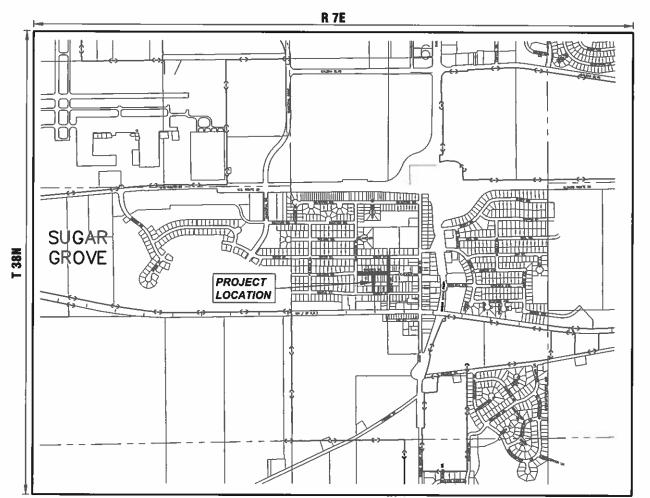

LOCATION MAP (SCALE 1"=1000')
SECTION 2 & 11, T38N, R7E, SUGAR GROVE TOWNSHIP
GROSS LENGTH OF PROJECT = 1,800 FEET (0.34 MILES)
NET LENGTH OF PROJECT = 1,800 FEET (0.34 MILES)

100' 200' 300'— 1"= 100'
10' 20' 30' — 1"= 10'

50' 100'

1"= 50'

100' — 1"= 40'


100' — 1"= 30'

FULL SIZE PLANS HAVE BEEN PREPARED USING STANDARD ENGINEERING SCALES. REDUCED SIZED PLANS WILL NOT

FULL SIZE PLANS HAVE BEEN PREPARED USING STANDARD ENGINEERING SCALES. REDUCED SIZED PLANS WILL NOT CONFORM TO STANDARD SCALES. IN MAKING MEASUREMENTS ON REDUCED PLANS, THE ABOVE SCALES MAY BE USED.



CONTRACT NO. 61K27

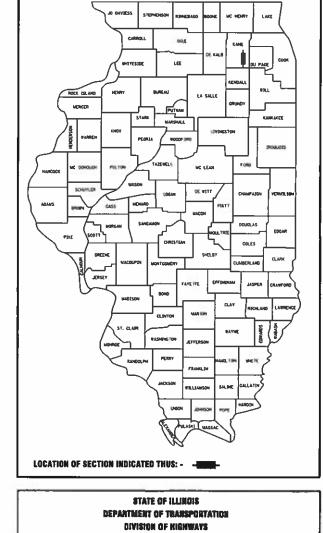



SECTION

20-00031-00-SW

KANE

CONTRACT NO. 61K27

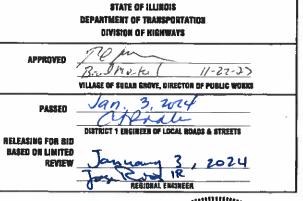

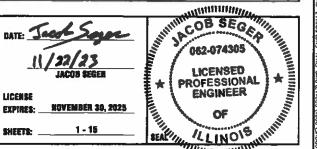



Engineering Enterprises, Inc. CONSULTING ENGINEERS 52 Wheeler Road Sugar Grove, Illinois 60554 Phone: (630) 466-6700

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GENERAL NOTES

SPECIFICATIONS, STANDARDS, AND SPECIAL PROVISIONS

ALL CONSTRUCTION SHALL BE DONE IN ACCORDANCE WITH THE "STANDARD SPECIFICATIONS FOR ROAD AND BRIDGE CONSTRUCTION,"ADOPTED JANUARY 1, 2022 (HEREINAFTER REFERRED TO AS THE STANDARD SPECIFICATIONS), THE "SUPPLEMENTAL SPECIFICATIONS AND RECURRING SPECIAL PROVISIONS," ADOPTED JANUARY 1, 2024. THE LATEST EDITION OF THE ILLINOIS MANUAL ON UNIFORM TRAFFIC CONTROL DEVICES FOR STREETS AND HIGHWAYS", THE "STANDARD SPECIFICATIONS FOR WATER & SEWER MAIN CONSTRUCTION IN ILLINOIS", SEVENTH EDITION, THE CODES AND ORDINANCES OF THE VILLAGE OF SUGAR GROVE, ILLINOIS, THE DETAILS IN THE PLANS AND THE SPECIAL PROVISIONS INCLUDED IN THE CONTRACT DOCUMENTS.

NO SUBSTITUTIONS OR VARIANCES WILL BE PERMITTED TO ANY STANDARD NOTES OR ORDINANCES UNLESS APPROVED OTHERWISE IN WRITING PRIOR TO COMMENCING CONSTRUCTION ACTIVITY.

ALL TRAFFIC CONTROL AND OTHER ADVISORY SIGNS NEEDED FOR CONSTRUCTION ARE TO BE FURNISHED BY THE CONTRACTOR IN ACCORDANCE WITH ARTICLE 107.14 OF THE STANDARD SPECIFICATIONS.

THE CONTRACTOR SHALL AT ALL TIMES PROVIDE PROTECTION FOR TRAFFIC AS CALLED FOR IN THE APPLICATION OF TRAFFIC CONTROL DEVICES, THE STANDARD SPECIFICATIONS, THE SPECIAL PROVISIONS AND THE PLANS

THE CONTRACTOR SHALL COOPERATE WITH THE OWNER IF ANY UTILITY IMPROVEMENTS ARE REQUIRED WITHIN THE DURATION OF THE CONTRACT.

THE CONTRACTOR SHALL BE RESPONSIBLE FOR CONTACTING THE OWNERS OF ALL UTILITIES PRIOR TO CONSTRUCTION TO DETERMINE THE LOCATION OF ALL EXISTING AND PROPOSED UTILITY EQUIPMENT. THE CONTRACTOR SHALL COOPERATE WITH ALL UTILITY OWNERS AS PROVIDED FOR IN THE STANDARD SPECIFICATIONS IF UTILITY RELOCATION, ADJUSTMENT, OR PROTECTION IS NECESSARY.

THE LOCATION OF EXISTING DRAINAGE STRUCTURES, STORM SEWERS, WATER MAINS, SANITARY SEWERS, FIELD TILES AND ANY OTHER PUBLIC OR PRIVATE UTILITIES AS SHOWN ON THE PLANS IS APPROXIMATE AND NOT NECESSARY COMPLETE: THEIR EXACT LOCATION IS TO BE DETERMINED IN THE FIELD BY THE CONTRACTOR.

IF EXISTING UTILITY LINES OF ANY NATURE ARE ENCOUNTERED WHICH CONFLICT IN LOCATION WITH NEW CONSTRUCTION. THE CONTRACTOR SHALL NOTIFY THE ENGINEER SO THAT THE CONFLICT MAY BE RESOLVED.

UNDER NO CIRCUMSTANCES SHALL THE CONTRACTOR OPERATE ANY VALVES OR HYDRANTS.

THE CONTRACTOR SHALL PROTECT AND CAREFULLY PRESERVE ALL SECTION OR SUBSECTION MONUMENTS. PROPERTY CORNERS, AND REFERENCE MARKERS UNTIL THE OWNER, THE OWNER'S AGENT, OR AN AUTHORIZED SURVEYOR HAS WITNESSED OR OTHERWISE REFERENCED THEIR LOCATIONS.

ALL OFFSET LOCATIONS GIVEN ON THE DETAILED PLANS ARE FROM THE CENTERLINE AS SHOWN ON THE PLANS.

THE THICKNESS OF ASPHALT MIXTURES SHOWN IN THE PLANS ARE NOMINAL. DEVIATIONS MAY OCCUR DUE TO IRREGULARITIES IN THE SURFACES OR BASES ON WHICH THE ASPHALT MIXTURES ARE TO BE PLACED.

IT IS THE CONTRACTOR'S RESPONSIBILITY TO ASCERTAIN EXISTING FIELD CONDITIONS BEFORE BIDDING ON THIS CONTRACT. WHERE NEW WORK MEETS EXISTING FEATURES TO REMAIN, THE CONTRACTOR SHALL FIELD CHECK ALL DIMENSIONS AND

ELEVATIONS BEFORE PROCEEDING WITH CONSTRUCTION. IMMEDIATELY NOTIFY THE ENGINEER OF ANY DISCREPANCIES. THE CONTRACTOR WILL BE REQUIRED TO COMPLY WITH ALL STATE REGULATIONS REGARDING AIR, WATER AND NOISE POLLUTION. THE CONTRACTOR IS PROHIBITED FROM BURNING ANY MATERIAL WITHIN OR ADJACENT TO THE IMPROVEMENT.

THE ENGINEER IS NOT RESPONSIBLE FOR THE CONSTRUCTION MEANS, METHODS, TECHNIQUES, SEQUENCES OR PROCEDURES, TIME OF PERFORMANCE, PROGRAMS OR FOR ANY SAFETY PRECAUTIONS USED BY THE CONTRACTOR. THE CONTRACTOR IS SOLELY RESPONSIBLE FOR EXECUTION OF THEIR WORK IN ACCORDANCE WITH THE CONTRACT DOCUMENTS AND

THE CONTRACTOR SHALL MAINTAIN EXISTING SIDE STREET AND DRIVEWAY ACCESS TO EACH ABUTTING PROPERTY AT ALL TIMES DURING CONSTRUCTION OF THE PROJECT UNLESS OTHERWISE NOTED ON THE PLANS OR DIRECTED BY THE ENGINEER.

THE CONTRACTOR SHALL DISPOSE OF AND REMOVE FROM THE SITE EACH DAY ALL CURB AND GUTTER, PAVEMENT AND ALL OTHER EXCAVATED MATERIAL NOT FOR SALVAGE.

THE STORAGE OF EQUIPMENT AND/OR MATERIALS WITHIN THE RIGHT-OF-WAY OF ANY STREET AND/OR PARK PROPERTY SHALL REQUIRE PRIOR APPROVAL OF THE ENGINEER.

SIDEWALK REMOVAL AND REPLACEMENT AND COMBINATION CONCRETE CURB AND GUTTER REMOVAL AND REPLACEMENT QUANTITIES AND LOCATIONS WILL BE VERIFIED IN THE FIELD BY THE ENGINEER PRIOR TO CONSTRUCTION.

ALL EXISTING SIGNS (INCLUDING THOSE LOCATED ON UTILITY/LIGHT POLES) THAT DO NOT CONFLICT WITH THE IMPROVEMENTS SHALL REMAIN IN PLACE UNLESS DIRECTED BY THE ENGINEER.

CONTRACTOR SHALL TAKE PRECAUTION BY PRESERVING EXISTING TREES WITHIN THE RIGHT OF WAY. IF ANY DAMAGE OCCURS, TREES SHALL BE REPLACED IN KIND PER ARTICLE 201.07 REPAIR OR REPLACEMENT OF EXISTING PLANT MATERIAL

PAY LIMITS FOR EARTH EXCAVATION SHALL EXTEND TO THE FULL WIDTH OF THE PROPOSED AGGREGATE BASE. ANY EXCAVATION BEYOND THESE LIMITS SHALL BE INCLUDED IN THE COST OF THE CONTRACT.

"RESTORATION" CALLOUT IN THE PLANS CONSISTS OF THE FOLLOWING PAY ITEMS: TOPSOIL FURNISHING AND PLACEMENT 4" FERTILIZER NUTRIENTS (NITROGEN, PHOSPHORUS AND POTASSIUM); AND SODDING, SALT TOLERANT.

THE PAY LIMITS FOR PAY ITEMS ASSOCIATED WITH RESTORATION SHALL EXTEND A MAXIMUM WIDTH OF 2 FEET FROM THE EDGE OF PROPOSED SIDEWALK. ANY DISTURBANCE BEYOND THESE LIMITS SHALL BE RESTORED AT THE CONTRACTOR'S

INDEX OF SHEETS COVER SHEET

- 2. GENERAL NOTES, HIGHWAY STANDARDS, SUPPLEMENTAL LEGEND AND INDEX OF SHEETS
- 3.—4. SUMMARY OF QUANTITIES
- 5.-7. TYPICAL SECTIONS


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- 8.-9. CALKINS DRIVE PLAN AND PROFILE
- 10. WEST STREET PLAN AND PROFILE 11.-12. GROVE STREET PLAN AND PROFILE
- 13. VILLAGE DETAILS
- 14.-15. IDOT DISTRICT 1 DETAILS

SHEET. NO. **IDOT DISTRICT ONE STD. DETAILS**

- 14. (TC-13) TYPICAL PAVEMENT MARKINGS
- 15

(BD-24) CURB OR CURB AND GUTTER REMOVAL AND REPLACEMENT

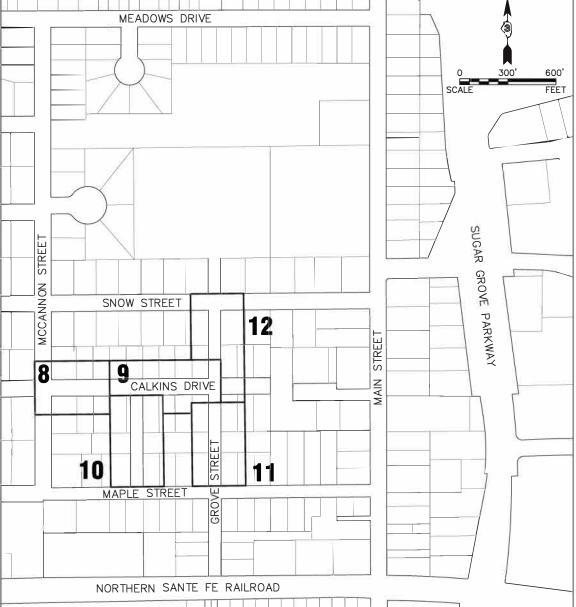

LOCATION MAP

SCALE: N.T.S.

000001-08	STANDARD SYMBOLS, ABBREVIATIONS, AND PATTERNS
280001-07	TEMPORARY EROSION CONTROL SYSTEMS
424001-11	PERPENDICULAR CURB RAMPS FOR SIDEWALKS
424006-05	DIAGONAL CURB RAMPS FOR SIDEWALKS
424021-06	DEPRESSED CORNER FOR SIDEWALKS
442201-03	CLASS C AND D PATCHES
542401-04	METAL FLARE END SECTION FOR PIPE CULVERTS
606001-08	CONCRETE CURB TYPE B AND COMBINATION CONCRETE CURB AND GUTTER
701006-05	OFF-RD OPERATIONS, 2L, 2W, 15'(4.5M) TO 24" (600MM) FROM PAVEMENT EDGE
701011-04	OFF-RD MOVING OPERATIONS, 2L, 2W, DAY ONLY
701301-04	LANE CLOSURE, 2L, 2W, SHORT TIME OPERATIONS
701311-03	LANE CLOSURE, 2L, 2W, MOVING OPERATIONS - DAY ONLY
701501-06	URBAN LANE CLOSURE 2L, 2W, UNDIVIDED
701801-06	SIDEWALK, CORNER OR CROSSWALK CLOSURE
701901-09	TRAFFIC CONTROL DEVICES
720006-04	SIGN PANEL ERECTION DETAILS
780001-05	TYPICAL PAVEMENT MARKINGS

IDOT HIGHWAY STANDARDS

USER NAME = Mike Agote	DESIGNED -	REVISED
	DRAWN -	REVISED -
PLOT SCALE =	CHECKED -	REVISED -
PLOT DATE = November 21, 2023 @ 2:21 PM	DATE =	REVISED -

GENERAL NOTES, HIGHWAY STANDARDS,	F.A.U. RTE.	SECTION	Ī
UPPLEMENTAL LEGEND AND INDEX OF SHEETS		20-0003I-00-SW	
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	CODE NUMBER	ITEM DESCRIPTION	TINU	SIDEWALK 80% STATE 20% LOCAL
2	20101200	TREE ROOT PRUNING	EACH	11
Δ	20101350	TREE PRUNING (OVER 10 INCH DIAMETER)	EACH	6
	20200100	EARTH EXCAVATION	CUYD	342
_	21101615	TOPSOIL FURNISH AND PLACE, 4"	SQYD	1,285
- -	21400100	GRADING AND SHAPING DITCHES	FOOT	50
-	25000400	NITROGEN FERTILIZER NUTRIENT	POUND	16
_	25000500	PHOSPHOROUS FERTILIZER NUTRIENT	POUND	16
	25000600	POTASSIUM FERTILIZER NUTRIENT	POUND	16
-	25200110	SODDING, SALT TOLERANT	SQ YD	1,285
+	25200200	SUPPLEMENTAL WATERING	UNIT	20
-	35101400	AGGREGATE BASE COURSE TYPE B	TON	233
+	42400200	PORTLAND CEMENT CONCRETE SIDEWALK 5 INCH	SQFT	7,630
	42400300	PORTLAND CEMENT CONCRETE SIDEWALK 6 INCH	SQFT	1,735
- -	42400800	DETECTABLE WARNINGS	SQFT	276
- -	44000100	PAVEMENT REMOVAL	SQ YD	7
	44000600	SIDEWALK REMOVAL	SQFT	1,118
	44201670	CLASS D PATCHES, TYPE I, 2 INCH	SQ YD	31
-	44201672	CLASS D PATCHES, TYPE II, 2 INCH	SQ YD	24

A INDICATES SPECIALTY ITEM

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FLOT DATE - December 27

STATE OF ILLINOIS DEPARTMENT OF TRANSPORTATION

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	CODE NUMBER	ITEM DESCRIPTION	UNIT	SIDEWALK 80% STATE 20% LOCAL
	50105220	PIPE CULVERT REMOVAL	FOOT	26
	542C0217	PIPE CULVERTS, CLASS C, TYPE 1, 12"	FOOT	26
	54213447	END SECTIONS 12"	EACH	2
	60266600	VALVE BOXES TO BE ADJUSTED	EACH	1
+	67100100	MOBILIZATION	LSUM	1
- - - -	70102620	TRAFFIC CONTROL AND PROTECTION, STANDARD 701501	LSUM	1
-	70102640	TRAFFIC CONTROL AND PROTECTION, STANDARD 701801	LSUM	1
-	72000100	SIGN PANEL - TYPE 1	SQ FT	44
2	72400310	REMOVE SIGN PANEL - TYPE 1	SQ FT	36
-	72400500	RELOCATE SIGN PANEL ASSEMBLY - TYPE A	EACH	1
١	78000600	THERMOPLASTIC PAVEMENT MARKINGS - LINE 12"	FOOT	577
5	78000650	THERMOPLASTIC PAVEMENT MARKINGS - LINE 24"	FOOT	33
	X4400501	COMBINATION CONCRETE CURB AND GUTTER REMOVAL AND REPLACEMENT LESS THAN OR EQUAL TO 10 FEET	FOOT	20
	X4400503	COMBINATION CONCRETE CURB AND GUTTER REMOVAL AND REPLACEMENT GREATER THAN 10 FEET	FOOT	145
,	Z0004510	HOT-MIX ASPHALT DRIVEWAY PAVEMENT, 3"	\$Q YD	183
_	Z0004544	HOT-MIX ASPHALT DRIVEWAY PAVEMENT REMOVAL	SQ YD	313

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133	52 52 63

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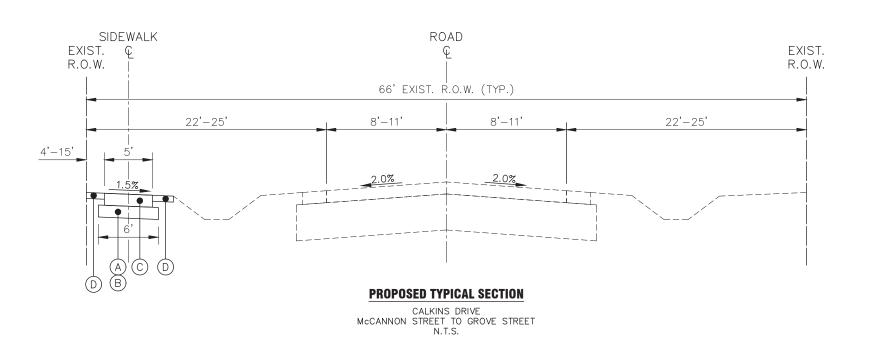
STATE OF ILLINOIS DEPARTMENT OF TRANSPORTATION

						F.A.U. RTE.	SECTION	COUNTY	TOTAL SHEETS	SHEET NO.		
									20-0003I-00-5W	KANE	15	4
						 				CONTRACT I	10. 6KZ	
	SHEET 2	OF 2	2 5	HEETS	STA.	TO STA.				D PROJECT		

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CALKINS DRIVE McCANNON STREET TO GROVE STREET N.T.S.

EXISTING TYPICAL SECTION



EXISTING LEGEND

- 1) EXISTING ASPHALT PAVEMENT
- 2) EXISTING AGGREGATE BASE COURSE
- (3) EXISTING TURF SHOULDER
- (4) EXISTING TURF PARKWAY

PROPOSED LEGEND

- (A) EARTH EXCAVATION
- B AGGREGATE BASE COURSE, TYPE B
- PROPOSED P.C.C. SIDEWALK, 5 INCH (6 INCH AT DRIVEWAYS)
- (D) TOPSOIL, 4", FERTILIZER, AND SODDING, SALT TOLERANT
- GRADING AND SHAPING DITCHES (AS DIRECTED BY ENGINEER)

HOT-MIX ASPHALT MIXTURE REQUIREMENTS

		I			
OPERATION	MIXTURE TYPE	AIR VOIDS NDES	QMP		
CLASS D PATCHES	HOT-MIX ASPHALT SURFACE COURSE, IL-9.5, MIX "D", N50, 2"	4% @ 50 GYR.	LR1030-2		
HOT-MIX ASPHALT DRIVEWAY PAVEMENT, 3"	HOT-MIX ASPHALT SURFACE COURSE, IL-9.5, MIX "D", N50, 3"	4% @ 50 GYR.	LR1030-2		
QMP DESIGNATION: QUALITY CONTROL/QUALITY ASSURANCE (QC/QA) PER LR 1030-2.					

THE UNIT WEIGHT TO CALCULATE ALL HMA SURFACE MIXTURE QUANTITIES IS 112 LBS/SQ YD/IN

THE "AC TYPE" FOR POLYMERIZED HMA MIXES SHALL BE "SBS/SBR PG 76-22" AND FOR NON-POLYMERIZED HMA THE "AC TYPE" SHALL BE "PG 64-22". UNLESS MODIFIED BY RECLAIMED MATERIALS SPECIFICATIONS.


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	DRAWN -	REVISED -
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PLOT DATE = December 27, 2023 @ 10:25 AM	DATE -	REVISED -

STATE OF ILLINOIS DEPARTMENT OF TRANSPORTATION

TYPICAL SECTIONS SECTION COUNTY 20-0003I-00-SW KANE I5 CONTRACT NO. 6IK27 SCALE: N.T.S. SHEET 1 OF 3 SHEETS STA. TO STA.



EXISTING TYPICAL SECTION

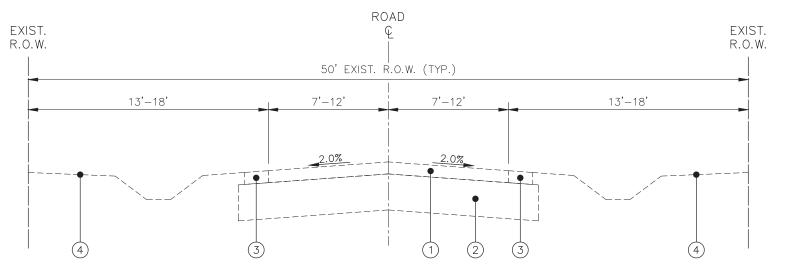WEST STREET MAPLE STREET TO CALKINS DRIVE N.T.S.

EXIST. R.O.W. SIDEWALK C EXIST. R.O.W. 50' EXIST. R.O.W. (TYP.) 13'-18' 7'-12' 7'-12' 13'-18' PROPOSED TYPICAL SECTION WEST STREET TO CALKINS DRIVE N.T.S. N.T.S.

EXISTING LEGEND

- 1) EXISTING ASPHALT PAVEMENT
- 2) EXISTING AGGREGATE BASE COURSE
- (3) EXISTING TURF SHOULDER
- (4) EXISTING TURF PARKWAY

PROPOSED LEGEND

- (A) EARTH EXCAVATION
- B) AGGREGATE BASE COURSE, TYPE B
- PROPOSED P.C.C. SIDEWALK, 5 INCH (6 INCH AT DRIVEWAYS)
- D TOPSOIL, 4", FERTILIZER, AND SODDING, SALT TOLERANT
- © GRADING AND SHAPING DITCHES (AS DIRECTED BY ENGINEER)

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 USER NAME
 = Mike Agate
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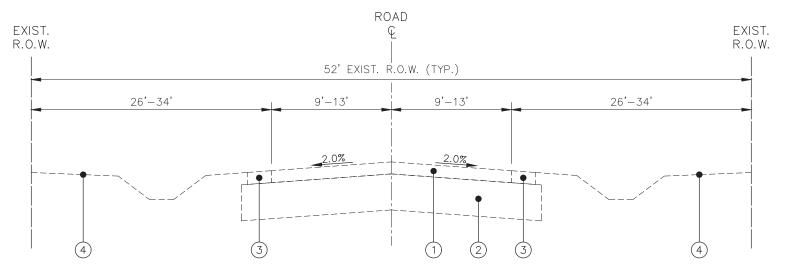
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 PLOT DATE
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STATE OF ILLINOIS
DEPARTMENT OF TRANSPORTATION

 TYPICAL SECTIONS
 F.A.U. SE 20-000

 SCALE: N.T.S. SHEET 2 OF 3 SHEETS STA. TO STA.
 TO STA.



EXISTING TYPICAL SECTION

GROVE STREET
MAPLE STREET TO SNOW STREET
N.T.S.

ROAD SIDEWALK R.O.W. 52' EXIST. R.O.W. (TYP.) 26'-34' 9'-13' 9'-13' 20'-34' PROPOSED TYPICAL SECTION GROVE STREET MAPLE STREET TO SNOW STREET N.T.S.

EXISTING LEGEND

- 1) EXISTING ASPHALT PAVEMENT
- 2) EXISTING AGGREGATE BASE COURSE
- (3) EXISTING TURF SHOULDER
- (4) EXISTING TURF PARKWAY

PROPOSED LEGEND

- (A) EARTH EXCAVATION
- B) AGGREGATE BASE COURSE, TYPE B
- PROPOSED P.C.C. SIDEWALK, 5 INCH (6 INCH AT DRIVEWAYS)
- D TOPSOIL, 4", FERTILIZER, AND SODDING, SALT TOLERANT
- (AS DIRECTED BY ENGINEER)

41

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CONSULTING ENGINEERS
52 Wheeler Road
Sugar Grove, Illinois 60554
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 USER NAME
 = Mike Agate
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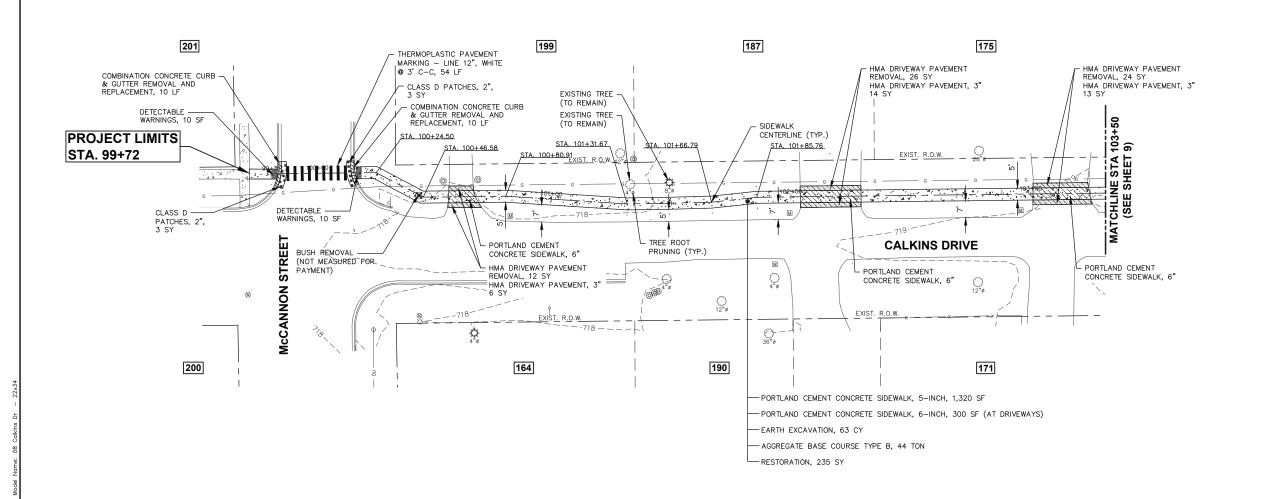
STATE OF ILLINOIS
DEPARTMENT OF TRANSPORTATION


TYPICAL SECTIONS

F.A.U. RTE. SECTION

20-0003I-00-SV

SCALE: N.T.S. SHEET 3 OF 3 SHEETS STA. TO STA. | ILLINOIS



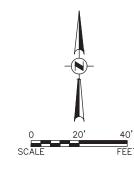

LEGEND

SIDEWALK REMOVAL

HMA DRIVEWAY PAVEMENT REMOVAL

PCC SIDEWALK


HMA DRIVEWAY PAVEMENT, 3"

PAVEMENT REMOVAL

COMBINATION CONCRETE
CURB AND GUTTER REMOVAL
AND REPLACEMENT

**** CLASS D PATCHES, 2"

XXX HOUSE ADDRESS

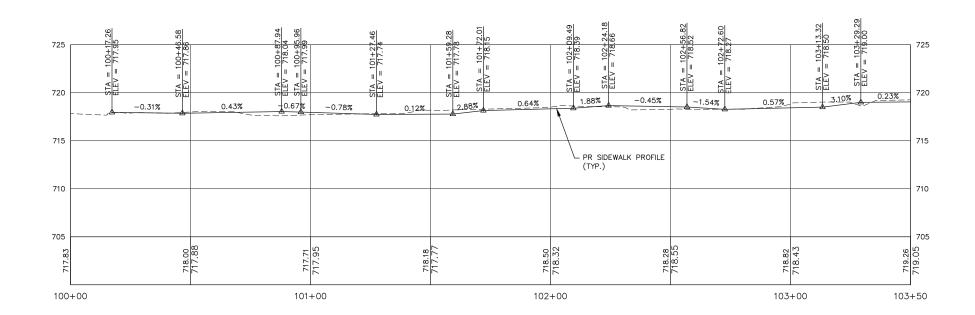

SCALE:
HORIZONTAL 1" = 20'
VERTICAL 1" = 5'

421

Engineering Enterprises, Inc. CONSULTING ENGINEERS 52 Wheeler Road Sugar Grove, Illinois 60554 630.466.6700 / www.eeiweb.com
 USER NAME
 = Kris Pung
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 = December 27, 2023 © 10:11 AM
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STATE OF ILLINOIS
DEPARTMENT OF TRANSPORTATION


CALKINS DRIVE
PLAN AND PROFILE


SCALE: 1"=20' SHEET 1 OF 5 SHEETS STA. 99+72 TO STA. 103+50


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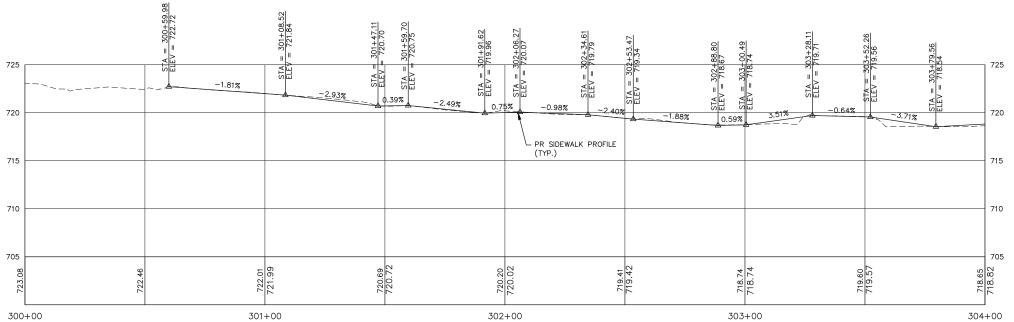
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CONTRACT NO. GIK27






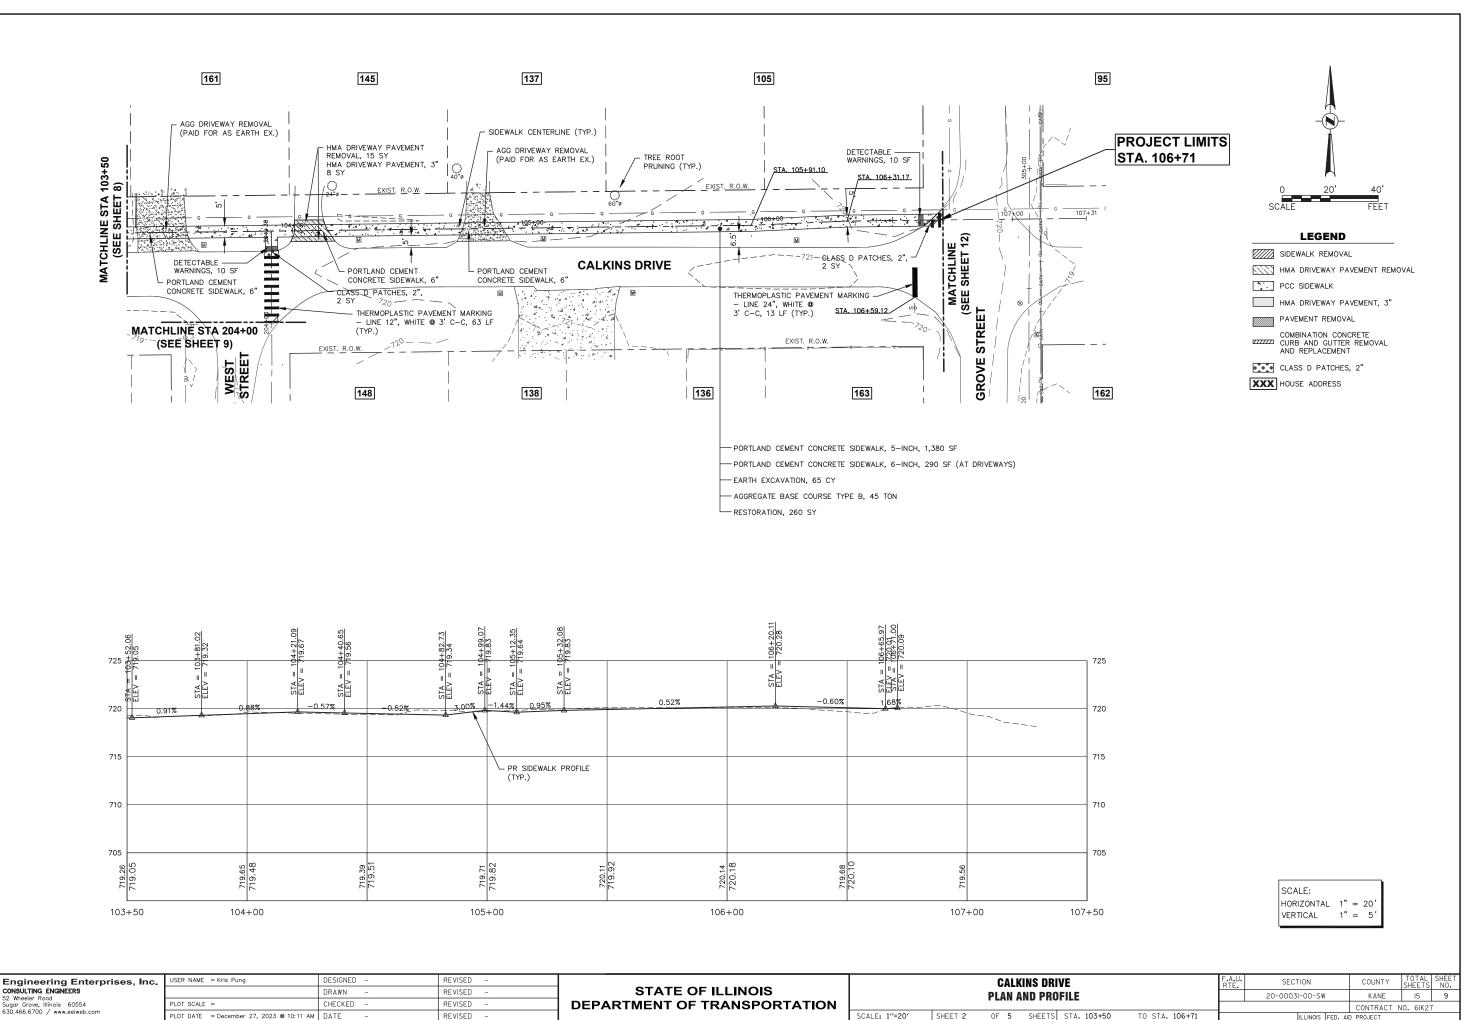


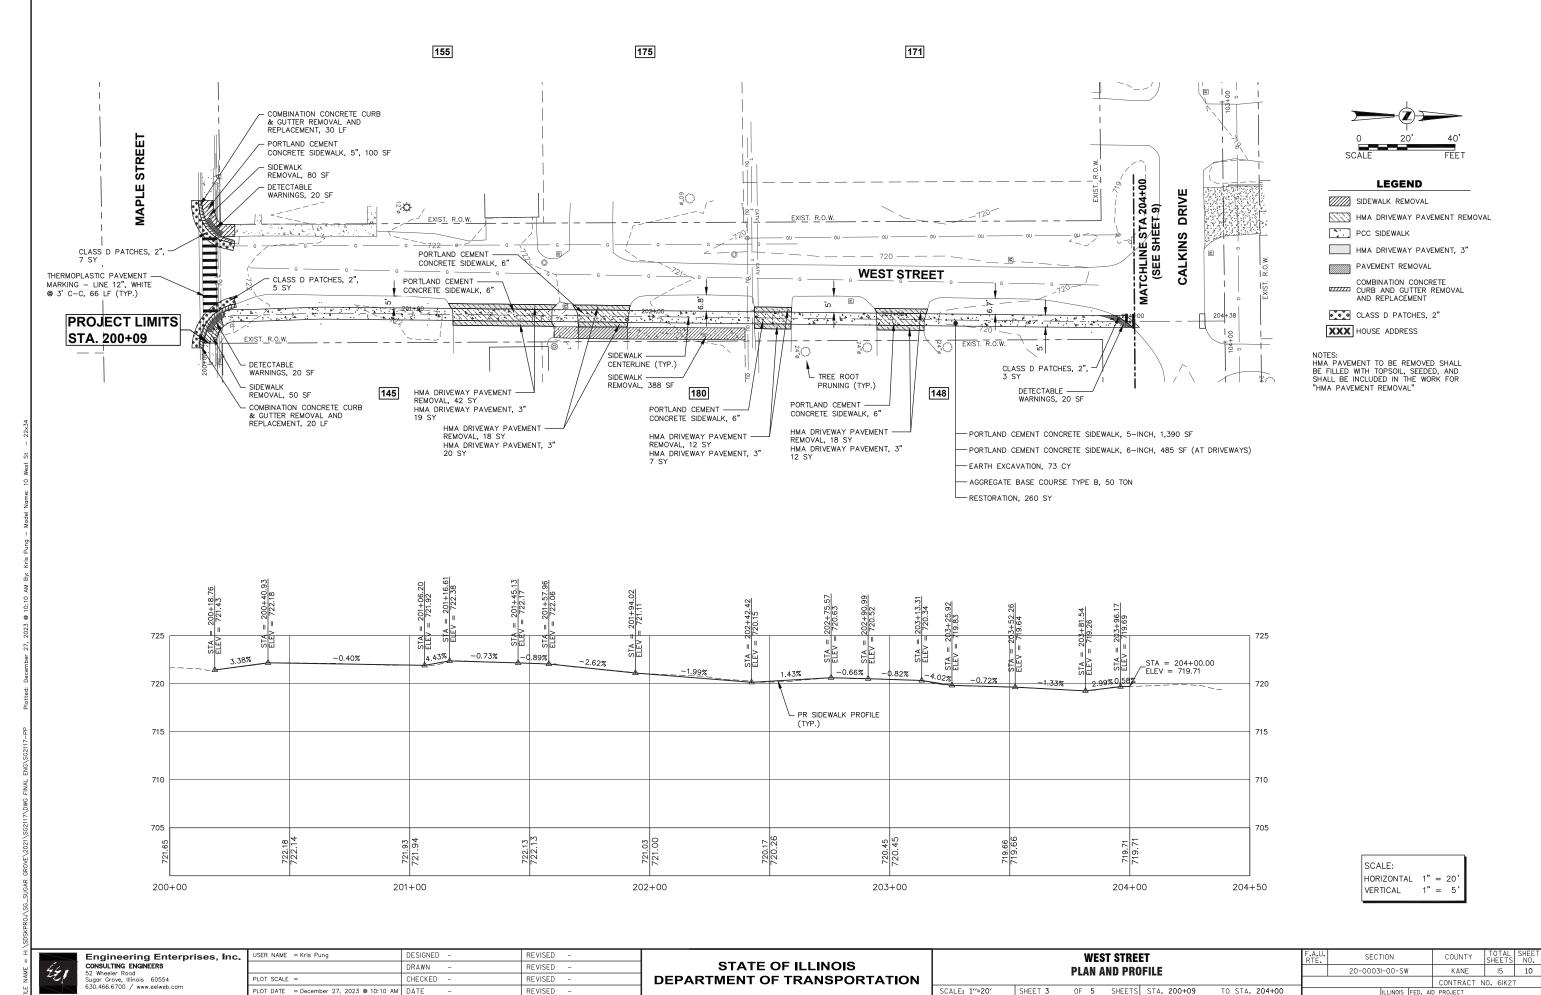

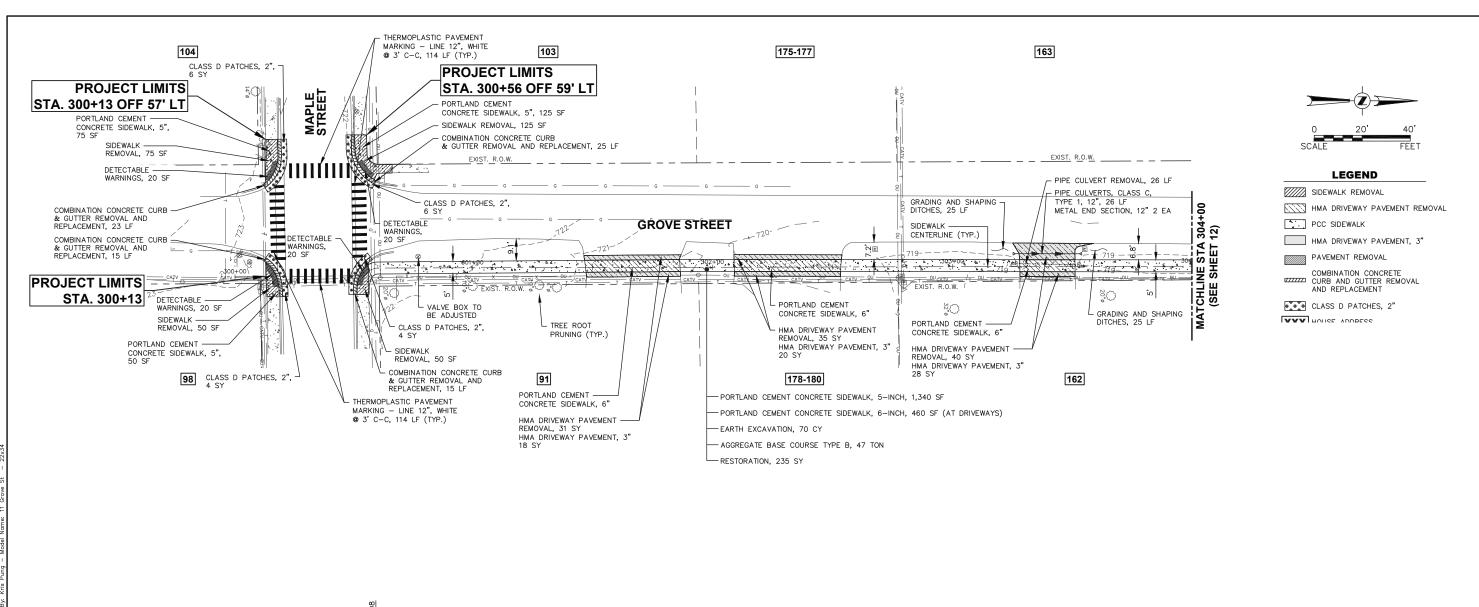SCALE: HORIZONTAL 1" = 20' VERTICAL 1" = 5'

USER NAME = Kris Pung DESIGNED -REVISED Engineering Enterprises, Inc. **GROVE STREET** SECTION COUNTY CONSULTING ENGINEERS
52 Wheeler Road
Sugar Grove, Illinois 60554
630.466.6700 / www.eeiweb.com **STATE OF ILLINOIS** DRAWN REVISED **PLAN AND PROFILE** 20-0003I-00-SW KANE CHECKED REVISED **DEPARTMENT OF TRANSPORTATION** CONTRACT NO. 6IK27 SHEET 4 OF 5 SHEETS STA. 300+13 TO STA, 304+00 SCALE: 1"=20" PLOT DATE = December 27, 2023 @ 10:30 AM DATE

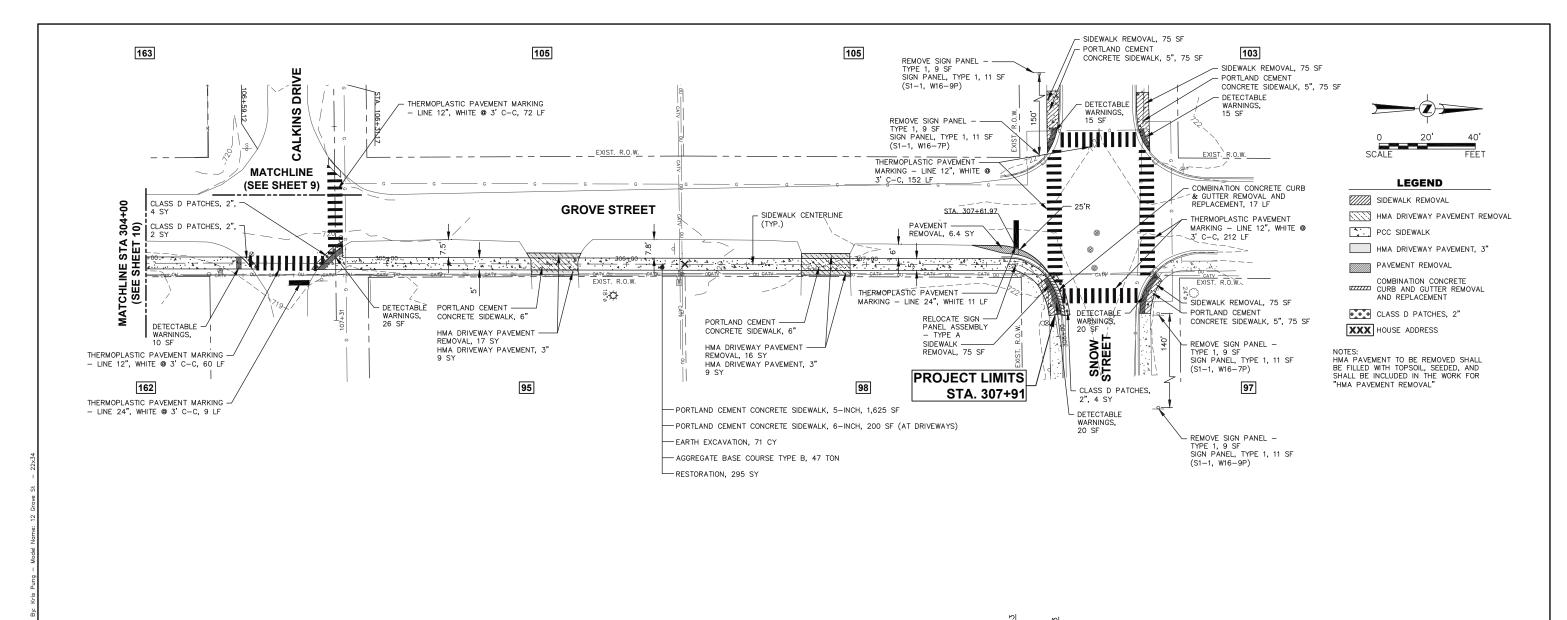

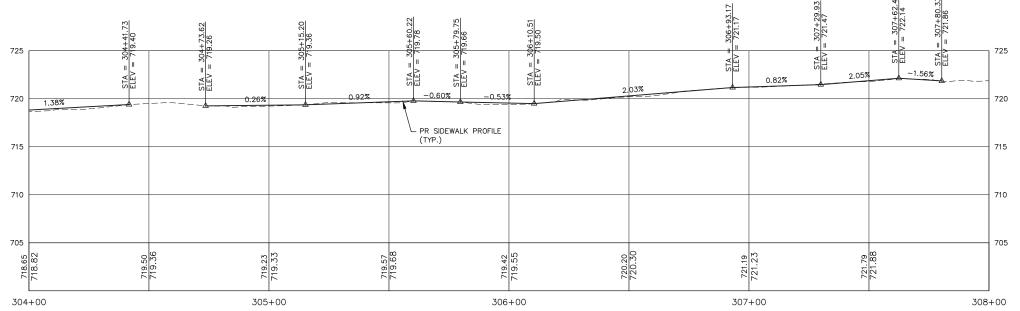

SCALE:

HORIZONTAL 1" = 20' 1" = 5' VERTICAL

CONSULTING ENGINEERS

Engineering Enterprises, Inc.

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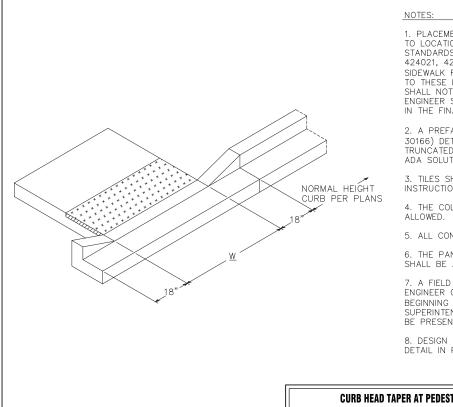
STATE OF ILLINOIS DEPARTMENT OF TRANSPORTATION

GROVE STREET PLAN AND PROFILE OF 5 SHEETS STA. 304+00 SHEET 5

SCALE: 1"=20"

SECTION 20-0003I-00-SW TO STA. 307+91

COUNTY KANE I5 12 CONTRACT NO. 6IK27



- 1. PLACEMENT OF DETECTABLE WARNING TILES SHALL ADHERE TO LOCATIONS AND SETBACKS AS SHOWN IN IDOT HIGHWAY STANDARDS INCLUDING 424001, 424006, 424011, 424016, 424021, 424026, AND 424031 FOR VARIOUS FIELD CONDITIONS. SIDEWALK RAMP WIDTH (W) AND LAYOUT SHALL BE ACCORDING TO THESE IDOT HIGHWAY STANDARDS, EXCEPT A SIDE CURB SHALL NOT BE CONSTRUCTED IN LANDSCAPED AREAS. THE ENGINEER SHALL INCLUDE THE MOST CURRENT IDOT STANDARDS IN THE FINAL ENGINEERING PLANS.
- 2. A PREFABRICATED, BRICK RED (FEDERAL STANDARD COLOR 30166) DETECTABLE WARNING PANEL WITH SQUARE PATTERNED TRUNCATED DOMES, SHALL BE UTILIZED. THE PANEL SHALL BE ADA SOLUTIONS, INC CAST-IN-PLACE TILE.
- 3. TILES SHALL BE INSTALLED PER MANUFACTURER INSTRUCTIONS.
- 4. THE COLORING AND STAMPING OF CONCRETE WILL NOT BE
- 5. ALL CONCRETE SHALL BE POURED IN PLACE.
- 6. THE PANEL SHALL LIE PERPENDICULAR TO THE STREET AND SHALL BE ALIGNED WITH RAMPS ACROSS THE STREET.
- 7. A FIELD MEETING SHALL BE SET UP WITH THE VILLAGE ENGINEER OR STREETS AND PROPERTIES SUPERVISOR PRIOR TO BEGINNING WORK ON ANY RAMP. THE CONTRACTOR'S FIELD SUPERINTENDENT RESPONSIBLE FOR RAMP CONSTRUCTION SHALL BE PRESENT AT MEETING.
- 8. DESIGN ENGINEER SHALL INCLUDE CURRENT IDOT RAMP DETAIL IN PLAN SET.

CURB HEAD TAPER AT PEDESTRIAN RAMPS FOR SIDEWALKS IN LANDSCAPED AREAS DRAWN BY: KKP

	Village of Sugar G
SUGAR GROVE	10 Municipal Drive Sugar Grove, Illinoi Phone: (630) 391-

ois 60554 -7200

SCALE: N.T.S. DATE: 11/30/17

SG-RD

18

REVISED:

SCALE: N.T.S.

HOT-MIX ASPHALT OVERLAY (THICKNESS PER PLAN) COMBINATION CONCRETE CURB AND GUTTER 6"-|-**EXISTING** PAVEMENT CLASS SI CONCRETE (DEPTH TO BOTTOM OF PR CURB AND GUTTER) - CONTRACTOR MUST SAWCUT IN FRONT OF CURB AND GUTTER REMOVAL NOTE:

IF THE CONTRACTOR DAMAGES THE EXISTING PAVEMENT ADJACENT TO NEW CURB AND GUTTER CONSTRUCTION, THE COST OF ALL ITEMS INCLUDING CLASS SI CONCRETE SHALL BE CONSIDERED INCLUDED IN THE COST OF THE COMBINATION CONCRETE CURB AND GUTTER REMOVAL AND REPLACEMENT OR COMBINATION CONCRETE CURB AND GUTTER, SPECIAL. BACKFILLING ADJACENT TO COMB. CONC. CURB AND GUTTER

EE-PV


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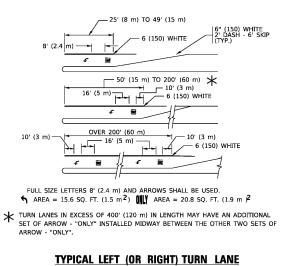
Engineering Enterprises, Inc. CONSULTING ENGINEERS Sugar Grove, Illinois 60554 630.466.6700 / www.eeiweb.com

USER NAME = Kris Pung DESIGNED -REVISED DRAWN REVISED CHECKED REVISED PLOT DATE = November 21, 2023 @ 11:24 AM DATE REVISED

STATE OF ILLINOIS DEPARTMENT OF TRANSPORTATION

SECTION COUNTY **VILLAGE DETAILS** 20-0003I-00-SW KANE CONTRACT NO. 61K27 SHEET 1 OF 1 SHEETS STA. TO STA.



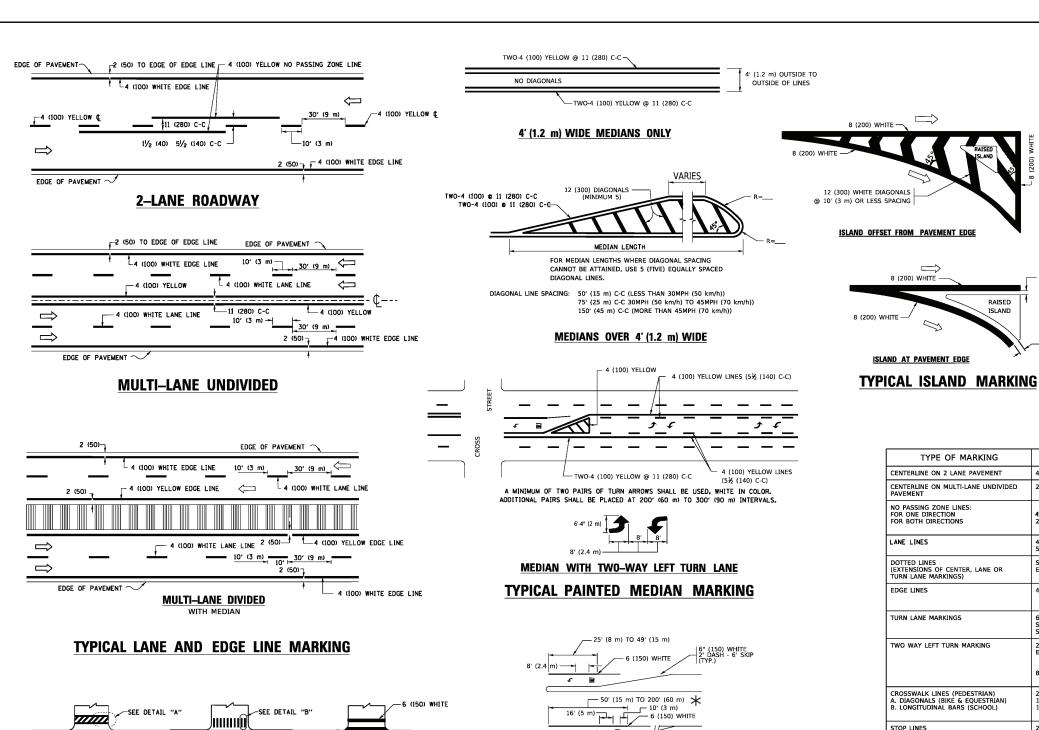

TYPICAL TURN LANE MARKING

6'-4" (1930) D(FT) 425 500 665 **-- 20**¹ 40 (1020) **COMBINATION** LEFT AND U-TURN 5'-4" (1620)

SPEED LIMIT

50

55

* LANE REDUCTION ARROWS REQUIRED AT SPEEDS OF 45 MPH OR GREATER OR WHEN SPECIFIED IN PLANS.

LANE REDUCTION TRANSITION

TYPE OF MARKING	WIDTH OF LINE	PATTERN	COLOR	SPACING / REMARKS		
CENTERLINE ON 2 LANE PAVEMENT	4 (100)	SKIP-DASH	YELLOW	10' (3 m) LINE WITH 30' (9 m) SPACE		
CENTERLINE ON MULTI-LANE UNDIVIDED PAVEMENT	2 @ 4 (100)	SOLID	YELLOW	11 (280) C-C		
NO PASSING ZONE LINES: FOR ONE DIRECTION FOR BOTH DIRECTIONS	4 (100) 2 @ 4 (100)	SOLID SOLID	YELLOW YELLOW	5½ (140) C-C FROM SKIP-DASH CENTERLINE 11 (280) C-C OMIT SKIP-DASH CENTERLINE BETWEEN		
LANE LINES	4 (100) 5 (125) ON FREEWAYS	SKIP-DASH SKIP-DASH	WHITE WHITE	10' (3 m) LINE WITH 30' (9 m) SPACE		
DOTTED LINES (EXTENSIONS OF CENTER, LANE OR TURN LANE MARKINGS)	SAME AS LINE BEING EXTENDED	SKIP-DASH	SAME AS LINE BEING EXTENDED	2' (600) LINE WITH 6' (1.8 m) SPACE		
EDGE LINES	4 (100)	SOLID	YELLOW-LEFT WHITE-RIGHT	OUTLINE MEDIANS IN YELLOW		
TURN LANE MARKINGS	6 (150) LINE; FULL SIZE LETTERS & SYMBOLS (8' (2.4m))	SOLID	WHITE	SEE TYPICAL TURN LANE MARKING DETAIL		
TWO WAY LEFT TURN MARKING	2 @ 4 (100) EACH DIRECTION 8' (2.4m) LEFT ARROW	SKIP-DASH AND SOLID IN PAIRS	YELLOW	10' (3 m) LINE WITH 30' (9 m) SPACE FOR SKIP-DASH; 5½ (140) C-C BETWEEN SOLID LINE AND SKIP-DASH LINE SEE TYPICAL TWO-WAY LEFT TURN MARKING DETAIL		
CROSSWALK LINES (PEDESTRIAN) A. DIAGONALS (BIKE & EQUESTRIAN) B. LONGITUDINAL BARS (SCHOOL)	2 @ 6 (150) 12 (300) @ 45° 12 (300) @ 90°	SOLID SOLID SOLID	WHITE WHITE WHITE	NOT LESS THAN 6' (1.8 m) APART 2' (500) APART 2' (500) APART 5EE TYPICAL CROSSWALK MARKING DETAILS.		
STOP LINES	24 (600)	SOLID	WHITE	PLACE 4' (1.2 m) IN ADVANCE OF AND PARALLEL TO CROSSWALK, IF PRESENT. OTHERWISE, PLACE AT DESIRED STOPPING POINT. PARALLEL TO CROSSROAD CENTERLINE, WHERE POSSIBLE		
PAINTED MEDIANS	2 @ 4 (100) WITH 12 (300) DIAGONALS @ 45° NO DIAGONALS USED FOR 4' (1.2 m) WIDE MEDIANS	SOLID	YELLOW: TWO WAY TRAFFIC WHITE: ONE WAY TRAFFIC	11 (280) C-C FOR THE DOUBLE LINE SEE TYPICAL PAINTED MEDIAN MARKING.		
GORE MARKING AND CHANNELIZING LINES	8 (200) WITH 12 (300) DIAGONALS @ 45°	SOLID	WHITE	DIAGONALS: 15' (4.5 m) C-C (LESS THAN 30MPH (50 km/h)) 20' (6 m) C-C 30MPH (50 km/h) TO 45MPH (70 km/h)) 30' (9 m) C-C (OVER 45MPH (70 km/h))		
RAILROAD CROSSING	24 (600) TRANSVERSE LINES; "RR" IS 6' (1.8 m) LETTERS; 16 (400) LINE FOR "X"	SOLID	WHITE	SEE STATE STANDARD 780001 AREA OF: "R"=3.6 SQ. FT. (0.33 m PEACH "X"=54.0 SQ. FT. (5.0 m P		
SHOULDER DIAGONALS (REQUIRED FOR SHOULDERS > 8')	12 (300) @ 45°	SOLID	WHITE - RIGHT YELLOW - LEFT	50' (15 m) C-C (LESS THAN 30MPH (50 km/h)) 75' (25 m) C-C (30 MPH (50 km/h) TO 45MPH (70 km/h)) 150' (45 m) C-C (OVER 45MPH (70 km/h))		
U TURN ARROW	SEE DETAIL	SOLID	WHITE	16.3 SF		
2 ARROW COMBINATION LEFT AND U TURN	SEE DETAIL	SOLID	WHITE	30.4 SF		

√ 32 R (810)

U-TURN

2 (50)

2 (50)

RAISED

8 (200) WHITE -

FOR FURTHER DETAILS ON PAVEMENT MARKING REFER TO STANDARD SPECIFICATIONS FOR ROAD AND BRIDGE CONSTRUCTION AND STATE STANDARD 780001.

SCALE: NONE

All dimensions are in inches (millimeters) unless otherwise shown.

EVERS REVISED - C. JUCIUS 09-09-09 USER NAME = footemj DESIGNED -Engineering Enterprises, In DRAWN REVISED -C. JUCIUS 07-01-13 CHECKED C. JUCIUS 12-21-15 PLOT DATE = 3/4/2019 DATE REVISED -C. JUCIUS 04-12-16 03-19-90

2' (600)

DETAIL "B"

12 (300) WHITE

PEDESTRIAN

-6 (150) WHITE


TYPICAL CROSSWALK MARKING

DETAIL "A"

BICYCLE & EQUESTRIAN

> STATE OF ILLINOIS **DEPARTMENT OF TRANSPORTATION**

SECTION COUNTY DISTRICT ONE 20-00031-00-SW KANE TYPICAL PAVEMENT MARKINGS TC-13 CONTRACT NO. 61K27 SHEET 1 OF 1 SHEETS STA. TO STA.

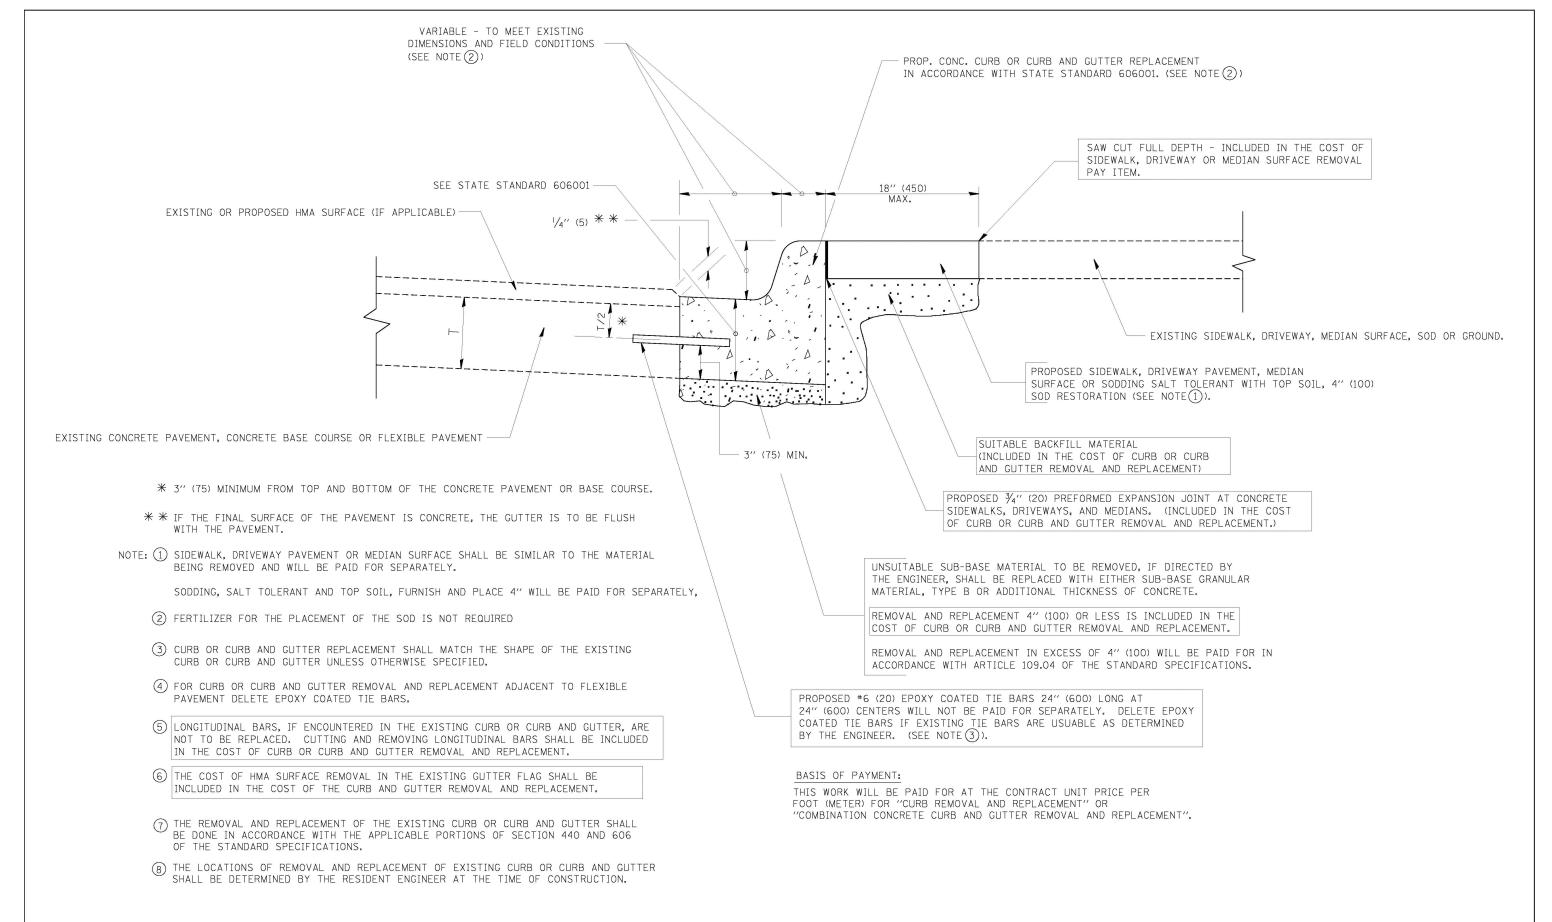

CURB OR CURB AND GUTTER REMOVAL AND REPLACEMENT

SCALE: NONE

SHEET

ALL DIMENSIONS ARE IN INCHES (MILLIMETERS)
UNLESS OTHERWISE SHOWN.

Engineering Enterprises, Inc. CONSULTING ENGINEERS 52 Wheeler Road Suger Grove, Illinois 60554 630.466.6700 / www.eelweb.com	USER NAME = drivakosgm	DESIGNED - A. HOUSEH	REVISED -	R. SHAH 10-03-96	
	CONSULTING ENGINEERS 52 Wheeler Road Sugar Grove, Illinois 60554	24.dgn	DRAWN -	REVISED -	A. ABBAS 03-21-97
		PLOT SCALE = 50,000 '/ IN.	CHECKED -	REVISED -	M. GOMEZ 01-22-01
		PLOT DATE = 12/15/2009	DATE - 03-11-94	REVISED -	R. BORO 12-15-09

STATE OF ILLINOIS
DEPARTMENT OF TRANSPORTATION

CURB OR CURB AND GUTTER REMOVAL AND REPLACEMENT			F.A RTE.	SECTION	COUNTY	TOTAL SHEETS	SHEET NO.	
				20-00031-00-SW	KANE	15	15	
			BD600-06 (BD-24) CONTRACT NO. 61K27			K27		
NO. 1 OF 1	SHEETS	STA.	TO STA.	FED. R	OAD DIST. NO. 1 ILLINOIS FED. A	ID PROJECT		