03-08-2024 LETTING ITEM 053

FOR INDEX OF SHEETS, SEE SHEET NO. 2

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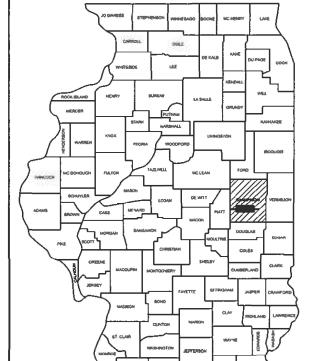
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## **STATE OF ILLINOIS DEPARTMENT OF TRANSPORTATION**

CHAMPAIGN IMP 2024-1 CHAMPAIGN 14 ILLINOIS CONTRACT NO. 70F51

D-95-048-21



## STATE OF ILLINOIS **DEPARTMENT OF TRANSPORTATION** SUBMITTED Decomber 7 20 February 2, 20% February 2, 2024

LOCATION OF SECTION INDICATED THUS: -

PRINTED BY THE AUTHORITY OF THE STATE OF ILLINOIS

DIRECTOR OF HIGHWAYS

# **PROPOSED HIGHWAY PLANS**


### **SECTION CHAMPAIGN IMP 2024-1 PATCHING PARKING IMPROVEMENT CHAMPAIGN COUNTY**

C-95-061-21

**CHAMPAIGN COMPLEX** 

R8E

PROJECT LOCATION
DISTRICT 5 CHAMPAIGN
STORAGE FACILITY 201 EISNER DRIVE CHAMPAIGN, IL 61822

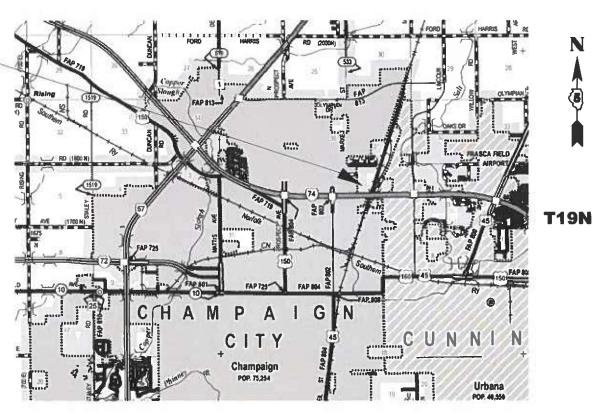

**FULL SIZE PLANS HAVE BEEN PREPARED USING STANDARD** ENGINEERING SCALES. REDUCED SIZED PLANS WILL NOT CONFORM TO STANDARD SCALES. IN MAKING MEASUREMENTS ON REDUCED PLANS, THE ABOVE SCALES MAY BE USED.

JOINT UTILITY LOCATION INFORMATION FOR EXCAVATION 1-800-892-0123 OR 811 CHAMPAIGN CITY TOWNSHIP

**PROJECT ENGINEER: RYAN CARROLL** SQUAD LEADER: CLARE DIETZ DESIGNER: KARY DAWSON PHONE: (217) 465-4181 **CONTRACT NO. 70F51** 

GROSS LENGTH = N/A FT. = N/A MILE NET LENGTH = N/A FT. = N/A MILE

5006

REV. 1/9/24

### **INDEX OF SHEETS**

SHEET NO.	DESCRIPTION
1	COVER SHEET
2	INDEX OF SHEETS & LIST OF HIGHWAY STANDARDS
3	GENERAL NOTES
4-5	SUMMARY OF QUANTITIES
6-7	TYPICAL SECTIONS & MISCELLANEOUS DETAILS
8-9	SCHEDULE OF QUANTITIES
10	CONTROL POINTS & BENCHMARKS
11	REMOVAL PLAN
12	SITE PLAN
13	PUSHWALL DETAIL

DISTRICT 5 DETAIL- DISABLED PARKING

### HIGHWAY STANDARDS

14

<u></u>	
STANDARD NO.	DESCRIPTION
000001-08	STANDARD SYMBOLS, ABBREVIATIONS AND PATTERNS
001001-02	AREAS OF REINFORCEMENT BARS
001006	DECIMAL OF AN INCH AND OF A FOOT
701501-06	URBAN LANE CLOSURE, 2L, 2W, UNDIVIDED
701901-09	TRAFFIC CONTROL DEVICES
780001-05	TYPICAL PAVEMENT MARKINGS

USER NAME = Kary.Dawson	DESIGNED -	REVISED -
	DRAWN -	REVISED -
PLOT SCALE = 0.16666633 ' / in.	CHECKED -	REVISED -
PLOT DATE = 12/7/2023	DATE -	REVISED -

STATE OF ILLINOIS DEPARTMENT OF TRANSPORTATION

SCALE:

	INDEX O			
SHEET	OF	SHEETS	STA.	TO STA.

 
 COUNTY
 TOTAL SHEETS NO.

 CHAMPAIGN
 14
 2

 CONTRACT NO. 70F51
 SECTION CHAMPAIGN IMP 2024-1

### **GENERAL NOTES**

G.N.-100A

ELECTRONIC FILES AND/OR ELECTRONIC SURVEY INFORMATION INCLUDING CADD FILES WILL NOT BE AVAILABLE TO THE CONTRACTOR

G.N.-105.09A

ALL ELEVATIONS SHOWN IN THE PLANS ARE BASED ON NORTH AMERICAN VERTICAL DATUM OF 1988. (NAVD 88)

G.N.-406H

#### MIXTURE REQUIREMENTS

THE FOLLOWING MIXTURE REQUIREMENTS ARE APPLICABLE FOR THIS PROJECT:

LOCATION(S):	CHAMPAIGN STORAGE	CHAMPAIGN STORAGE
MIXTURE USE(S):	SURFACE	BINDER
AC/PG:	SBS PG 70-22	SBS PG 70-22
DESIGN AIR VOIDS	4.0% @ Ndes=50	4.0% @ Ndes=50
MIXTURE COMP		
(GRADATION)	IL 9.5	IL 9.5 FG
FRICTION		
AGGREGATE	Mix C	N.A.
MIXTURE WEIGHT	112	112
QUALITY MANAGE-		_
MENT PROGRAM	QC/QA	QC/QA
SUBLOT SIZE	3000	3000
MATERIAL TRANSFER DEVICE		
(REQUIRED?)	NO	NO

#### NOTE:

- 1. INDIVIDUAL LIFT THICKNESS OF EACH MIX TYPE WILL BE NO LESS THAN 3 TIMES NOMINAL MAXIMUM AGGREGATE SIZE AND NO MORE THAN 6 TIMES NOMINAL MAXIMUM AGGREGATE SIZE, UNLESS OTHERWISE APPROVED BY THE ENGINEER.
- 2. FOR DESIGN PURPOSES MIXTURE WEIGHT FOR ALL MIXES IS DETERMINED TO BE 112.0 LBS/S.Y./IN., UNLESS OTHERWISE NOTED.

#### G.N.-503 SPL

SYNTHETIC FIBERS SHALL BE TYPE III ACCORDING TO ASTM C 1116. THE SYNTHETIC FIBER SHALL BE A MONOFILAMENT OR BUNDLED MONOFILAMENT WITH A MINIMUM LENGTH OF 1.0 INCH (25MM) AND A MAXIMUM LENGTH OF 2.5 INCH (63MM), AND SHALL HAVE A MAXIMUM ASPECT RATION (LENGTH DIVIDED BY THE EQUIVALENT DIAMETER OF THE FIBER) OF 150. THE MINIMUM QUANTITY OF SYNTHETIC FIBER(S) ADDED TO THE CONCRETE MIXTURE SHALL BE ACCORDING TO THE DEPARTMENT'S QUALIFIED PRODUCT LIST OF SYNTHETIC FIBERS. THE SYNTHETIC FIBERS SHALL BE ADDED TO THE CONCRETE AND MIXED PER THE MANUFACTURER'S RECOMMENDATION. THE SYNTHETIC FIBERS SHALL BE INCLUDED IN THE COST OF CONCRETE STRUCTURES.

#### BITUMINOUS MATERIALS RATES

SURFACE TYPE:	RESIDUAL RATE
AGGREGATE BASE COURSE:	0.25 LB /SQ FT
CONCRETE, EX, HMA, AND MILLED HMA:	0.05 LB/SQ FT
NEW HMA AND BRICK:	0.025 LB/SQ FT

### HORIZONTAL CONTROL POINTS

NORTHING	EASTING
1264773.421	1010985.539
1264495.509	1010976.953
1264386.931	1011099.743
1264266.493	1011087.674
	1264773.421 1264495.509 1264386.931

### **COMMITMENTS**

THERE ARE NO COMMITMENTS.

SHEET

USER NAME = Kary.Dawson	DESIGNED -	REVISED -	
	DRAWN -	REVISED -	
PLOT SCALE = 0.16666633 ' / in.	CHECKED -	REVISED -	
PLOT DATE = 12/7/2023	DATE -	REVISED -	

STATE OF ILLINOIS
DEPARTMENT OF TRANSPORTATION

GENE	RAL NO	TES		F.A. RTE.	SECTION		COUNTY	TOTAL SHEETS	SHEET NO.
					CHAMPAIGN IMP 2024-1		CHAMPAIGN	14	3
							CONTRAC	Γ NO. 70F	-51
OF	SHEETS	QTA	TO STA		11.11010	EED AU	D DDO JEOT		

## SUMMARY OF QUANTITIES

LOCATION OF WORK:

CHAMPAIGN STORAGE FACILITY

URBAN

COUNTY: FUNDING BREAKOUT:

CONSTRUCTION TYPE CODE:

SCALE: 1"=50'

CHAMPAIGN 100% STATE 0005

CODE NO.	ITEM	<u>UNIT</u>	TOTAL QUANTITY	STATE QUANTITY
20200100	EARTH EXCAVATION	CU YD	205.00	205.0
35800100	PREPARATION OF BASE	SQ YD	2,582.00	2,582.0
40600275	BITUMINOUS MATERIALS (PRIME COAT)	POUND	4,134.00	4,134.0
40600290	BITUMINOUS MATERIALS (TACK COAT)	POUND	1,754.00	1,754.0
40600982	HOT-MIX ASPHALT SURFACE REMOVAL - BUTT JOINT	SQ YD	973.00	973.0
40603215	POLYMERIZED HOT-MIX ASPHALT BINDER COURSE, IL-9.5FG, N50	TON	290.00	290.0
40604150	POLYMERIZED HOT-MIX ASPHALT SURFACE COURSE, IL-9.5, MIX "C", N50	TON	540.00	540.0
44000100	PAVEMENT REMOVAL	SQ YD	167.00	167.0
48102100	AGGREGATE WEDGE SHOULDER, TYPE B	TON	5.00	5.0
50300225	CONCRETE STRUCTURES	CU YD	36.70	36.7
50800205	REINFORCEMENT BARS, EPOXY COATED	POUND	3,990.00	3,990.0
60300305	FRAMES AND LIDS TO BE ADJUSTED	EACH	9.00	9.(
* 66900200	NON-SPECIAL WASTE DISPOSAL	CU YD	70.00	70.0
* 66900530	SOIL DISPOSAL ANALYSIS	EACH	1.00	1.0
DENOTES SPECIA	TY ITEM			

EL: \$MODELNAME\$

USER NAME = Kary.Dawson	DESIGNED -	REVISED -
	DRAWN -	REVISED -
PLOT SCALE = 0.16666633 ' / in.	CHECKED -	REVISED -
PLOT DATE = 12/7/2023	DATE -	REVISED -

STATE OF ILLINOIS DEPARTMENT OF TRANSPORTATION

SUMMARY OF QUANTITIES	SECTION COUNTY TOTAL SHEET NO.
	CHAMPAIGN IMP 2024-1 CHAMPAIGN 14 4
	CONTRACT NO. 70F51
SHEET 1 OF 2 SHEETS STA. TO STA.	ILLINOIS FED, AID PROJECT

### **SUMMARY OF QUANTITIES**

LOCATION OF WORK: CHAMPAIGN STORAGE FACILITY

URBAN

COUNTY

CHAMPAIGN 100% STATE

FUNDING BREAKOUT: CONSTRUCTION TYPE CODE:

0005

CODE NO.	ITEM	<u>UNIT</u>	TOTAL QUANTITY	
66901001	REGULATED SUBSTANCES PRE-CONSTRUCTION PLAN	L SUM	1.00	1.0
66901003	REGULATED SUBSTANCES FINAL CONSTRUCTION REPORT	L SUM	1.00	1.0
66901006	REGULATED SUBSTANCES MONITORING	CAL DA	2.00	2.0
67100100	MOBILIZATION	L SUM	1.00	1.0
78001100	PAINT PAVEMENT MARKING - LETTERS AND SYMBOLS	SQ FT	7.00	7.0
78001110	PAINT PAVEMENT MARKING - LINE 4"	FOOT	700.00	700.0
X7010216	TRAFFIC CONTROL AND PROTECTION, (SPECIAL)	L SUM	1.00	1.0
XZ177600	REMOVE EXISTING BUMPER BLOCKS	EACH	11.00	11.0
Z0007800	BUMPER BLOCKS	EACH	11.00	11.0
Z0013798	CONSTRUCTION LAYOUT	L SUM	1.00	1.0
Z0075496	CONCRETE RETAINING WALL REMOVAL	FOOT	43.00	43.
DENOTES SPECIAL				

DEL: \$MODELNAME\$
NAME: cur/ildet cur boodes:

STATE OF ILLINOIS
DEPARTMENT OF TRANSPORTATION

 SUMMARY OF QUANTITIES
 SECTION


 CHAMPAIGN IMP 2024-1


 SCALE: 1"=50"
 SHEET 2
 OF 2
 SHEETS
 STA.
 TO STA.
 ILLINOIS

COUNTY TOTAL SHEETS NO.

CHAMPAIGN 14 5

CONTRACT NO. 70F51

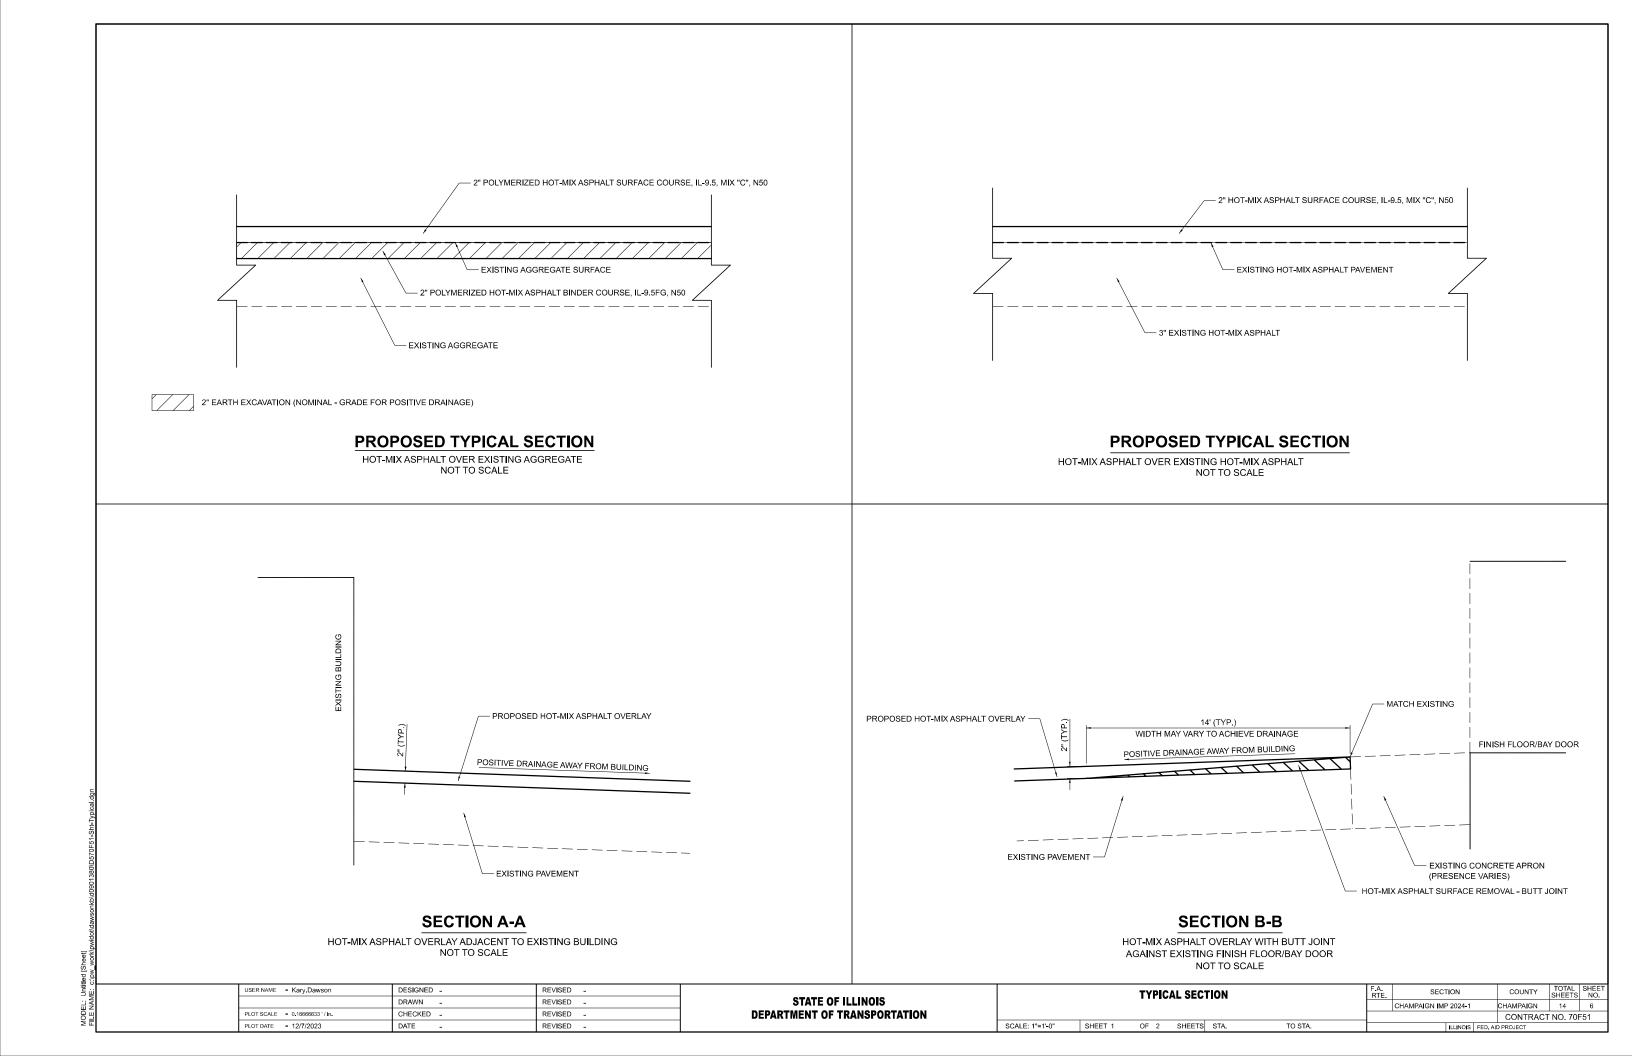

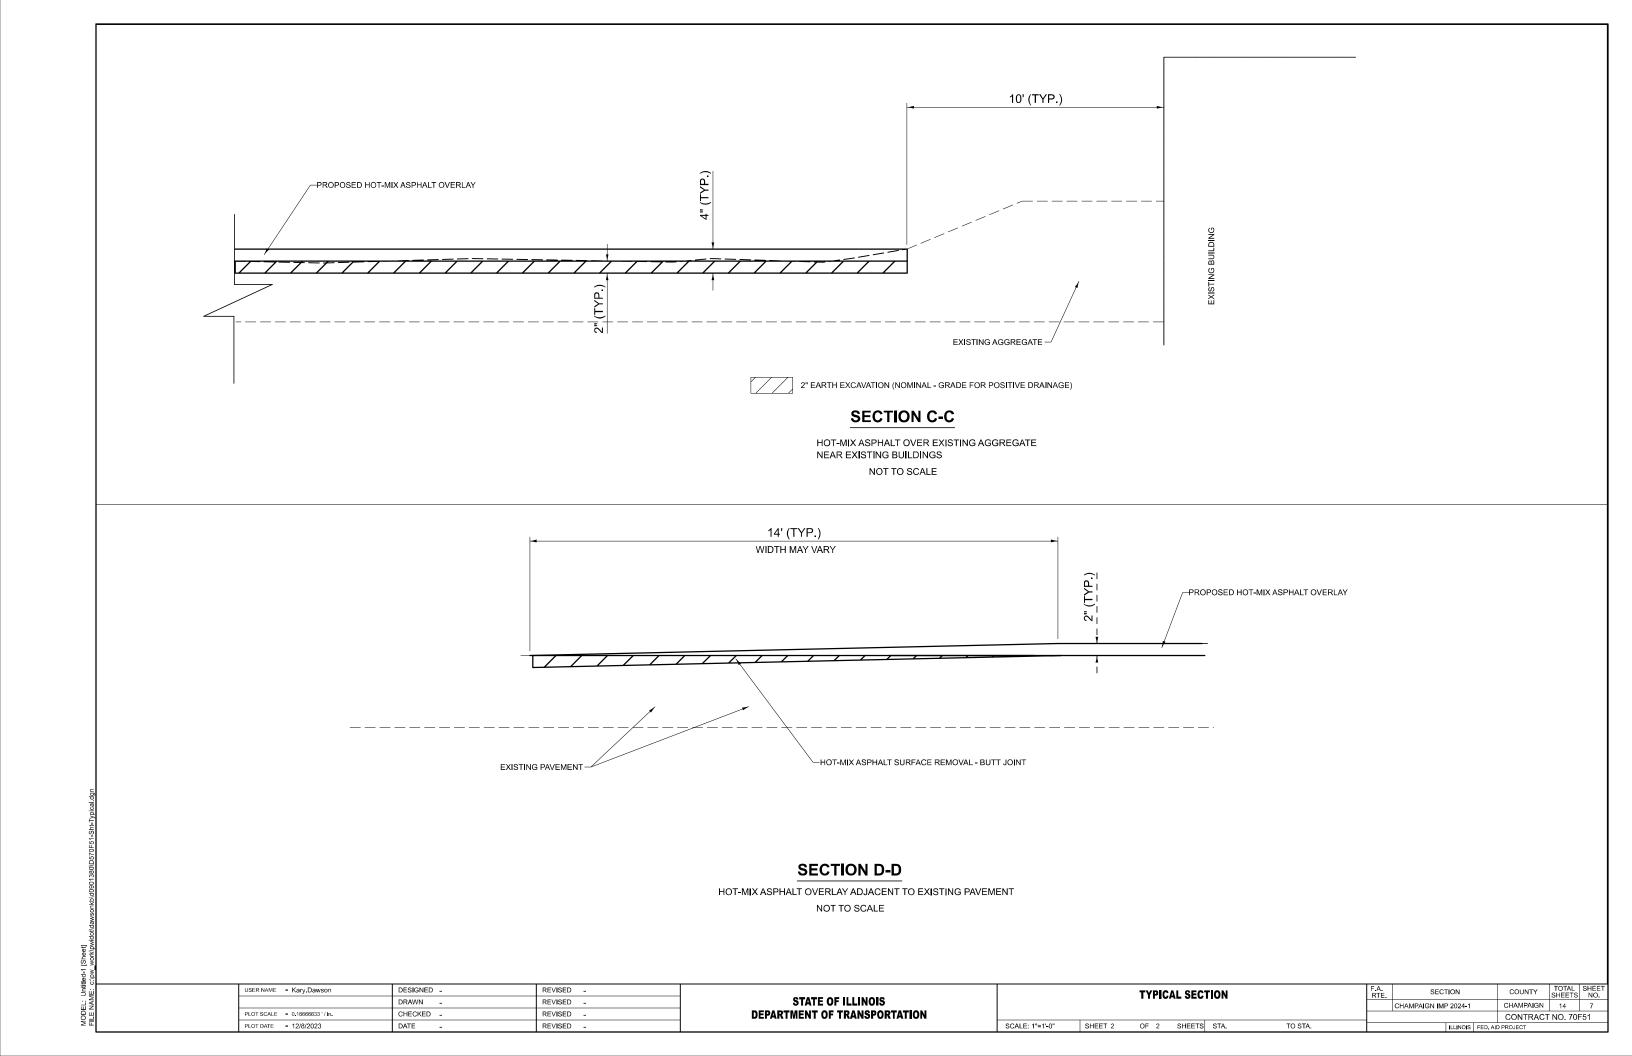

## SCHEDULE OF QUANTITIES

20200100 EARTH EXCAVATION		
LOCATION	CUYD	
EX AGG SURFACE EAST OF SALT DOME		102.30
EX MATERIAL AT PUSH WALL		102.30
SUBTOTAL		204.60
ROUNDED TOTAL		205

35800100 PREPARATION OF BASE		
LOCATION	SQ YD	
EX AGG SURFACE EAST OF SALT DOME		1837.20
EX HMA SURFACE WEST OF SIGN SHOP X 25%		187.20
EX HMA SURFACE NORTH OF SIGN SHOP X 25%		499.40
EX HMA SURFACE EAST OF SALT DOME X 25%		58.00
SUBTOTAL		2581.80
ROUNDED TOTAL		2582

40600275	BITUMINOUS MATERIALS (PRIME COAT)					
LOCATION		LBS				
AREA EAST	AREA EAST OF SALT DOME					
	SUBTOTAL		4133.60			
	ROUNDED TOTAL		4134			

40600290 BITUMINOUS MATERIALS (TACK COAT)	
LOCATION	LBS
EX AGG SURFACE AREA EAST OF SALT DOME (AFTER BINDER)	413.36
EX HMA SURFACE EAST OF SALT DOME (BEFORE SURFACE)	104.35
EX HMA SURFACE AREA WEST OF SIGN SHOP	336.88
EX HMA SURFACE AREA NORTH OF SIGN SHOP	898.96
SUBTOTAL	1753.55
ROUNDED TOTAL	1754

40600982	HOT-MIX ASPHALT SURFACE REMOVAL	- BUTT JOINT	
LOCATION		SQYD	
AREAS SURF	OUNDING UNDERGROUND FUEL TANK AR	EA & CAN	283.50
NORTH SIDE	OF SIGN SHOP		174.70
WEST SIDE C	OF SIGN SHOP		205.80
WEST SIDE C	OF SIGN SHOP AT SOUTH EDGE ADJACENT T	<sup>-</sup> O	81.70
EXIST PCC			
EISNER RD.	WEST ENTRANCE		73.70
EAST OF SAL	T DOME		153.20
	SUBTOTAL		972.60
	ROUNDED TOTAL		973

40603215	POLYMERIZED HOT-MIX ASPHALT BIND	DER COURSE, IL-9.5FG, N50
LOCATION		TON
EX AGG SURI	FACE AREA EAST OF SALT DOME	205.7
EX HMA SUR	FACE AREAS REQUIRING PREPARATION O	F BASE
EX HMA SUR	FACE AREA WEST OF SIGN SHOP X 25%	20.97
EX HMA SUR	FACE AREA NORTH OF SIGN SHOP X 25%	55.93
EX HMA SUR	FACE AREA EAST OF SALT DOME X 25%	6.50
	SUBTOTAL	289.20
	ROUNDED TOTAL	

40604150	POLYMERIZED HOT-MIX ASPHALT SUR	FACE COURSE, IL-9.5, MIX "C", I	<b>\</b> 50
LOCATION		TON	
EX AGG SUR	FACE AREA EAST OF SALT DOME		205.77
EX HMA SUF	RFACE AREA WEST OF SIGN SHOP		83.84
EX HMA SUF	RFACE AREA NORTH OF SIGN SHOP		223.74
EX HMA SUF	RFACE AREA EAST OF SALT DOME		25.97
	SUBTOTAL		539.32
	ROUNDED TOTAL		540

4000100 PAVEMENT REMOVAL				
LOCATION	SQYD			
PORTION OF THE EXIST HMA PAD IN FRONT OF SALT DOME	167.00			
SUBTOTAL	167.00			
ROUNDED TOTAL	167			

USER NAME = Kary.Dawson	DESIGNED -	REVISED -	
	DRAWN -	REVISED -	
PLOT SCALE = 0.16666633 ' / in.	CHECKED -	REVISED -	
PLOT DATE = 12/7/2023	DATE -	REVISED -	

STATE OF ILLINOIS
DEPARTMENT OF TRANSPORTATION

SCHEDULE OF QUANTITIES			SECTION		COUNTY	TOTAL SHEETS	SHEET NO.		
					CHAMPAIGN IMP 2024-1		CHAMPAIGN	14	8
							CONTRAC	T NO. 70F	-51
HEET	OF	SHEETS	STA.	TO STA.	ILLINOIS FED. AID PROJECT				

## SCHEDULE OF QUANTITIES

48102100	AGGREGATE WEDGE SHOULDER, TYPE B	
LOCATION	TON	
81.25' ALONG THE WEST SIDE OF THE PROPOS	SED HMA,	2.05
NORTH OF THE SALT DOME		
101.33' ALONG THE SOUTH SIDE OF PROPOSE EAST OF THE SALT DOME	D HMA,	2.56
SUBTOTAL		4.61
ROUNDED TOTAL		5

50300205	CONCRETE STRUCTURES		
LOCATION	CUYD		
PUSHWALLS, FOOTINGS & PAD IN FRONT OF	SALT DOME	36.7	
(SEE PUSHWALL DETAIL)			
SUBTOTAL		36.7	
ROUNDED TOTAL		37	

50800205	REINFORCEMENT BARS, EPOXY COATED	
LOCATION	POUND	
PUSHWALLS, FOOTINGS & PAD IN FRONT OF	F SALT DOME	3990
(SEE PUSHWALL DETAIL)		
SUBTOTAL		3990
ROUNDED TOTAL		3990

60300305	FRAMES AND LIDS TO BE ADJUSTED
LOCATION	EACH
EX MANHOLE NW OF SIGN SHO	1
EX MANHOLE SW OF SIGN SHOP	1
EX GASOLINE MONITORING WE	L NW OF CANOPY 1
EX GASOLINE MONITORING WE	L SE OF CANOPY 1
EX GASOLINE MONITORING WE	L SW OF CANOPY 1
EX GASOLINE MONITORING WE	LS WEST OF SIGN SHOP 2
EX CATCH BASINS WEST OF TRU	CK WASH 2
SUBTOT	NL 9
ROUND	D TOTAL 9

78001100	PAINT PAVEMENT MARKING - LETTERS AND SYMBOLS	
LOCATION	SQ FT	
2 ACCESSIBLE PARKING SPACES		6.2
SUBTOTA	L	6.2
ROUNDE	O TOTAL	7

78001110	PAINT PAVEMENT MARKING - LINE 4"		
LOCATION	FOOT		
EAST SIDE PARKING (13 SPACES)		280	
NORTH SIDE PARKING (6 SPACES)		140	
WEST SIDE PARKING (5 SPACES)		120	
DIAGONALS NEAR THE ACCESSIBL	E SPOTS	160	
SUBTOTAL	_	700	
ROUNDE	O TOTAL	700	

XZ177600		REMOVE EXISTING BUMPER BLOCKS	
LOCATION		EACH	
EAST SIDE PARKING			11
	SUBTOTAL		11
	ROUNDED TOTAL		11

Z0007800		BUMPER BLOCKS		
LOCATION			EACH	
EAST SIDE PARKING				11
	SUBTOTAL			11
	<b>ROUNDED TOTAL</b>			11

Z0075496	CONCRETE RETAINING WALL REMOVAL	
LOCATION	FOOT	
EXIST RETAINING WALLS & FOOTIN	GS IN FRONT OF SALT DOME	43
(SEE PUSHWALL DETAIL)		
SUBTOTAL		43
ROUNDED	TOTAL	43

SCALE: 1"=50'


STATE OF ILLINOIS DEPARTMENT OF TRANSPORTATION

 SCHEDULE OF QUANTITIES
 SECTION
 COUNTY SHEETS NO.
 TOTAL SHEETS NO.

 CHAMPAIGN IMP 2024-1
 CHAMPAIGN IMP 2024-1
 CHAMPAIGN IMP 2024-1
 CHAMPAIGN IMP 2024-1
 CONTRACT NO. 70F51

 SHEET 2
 OF 2 SHEETS STA.
 TO STA.
 ILLINOIS FED. AID PROJECT

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MODEL: ATB [Sheet]

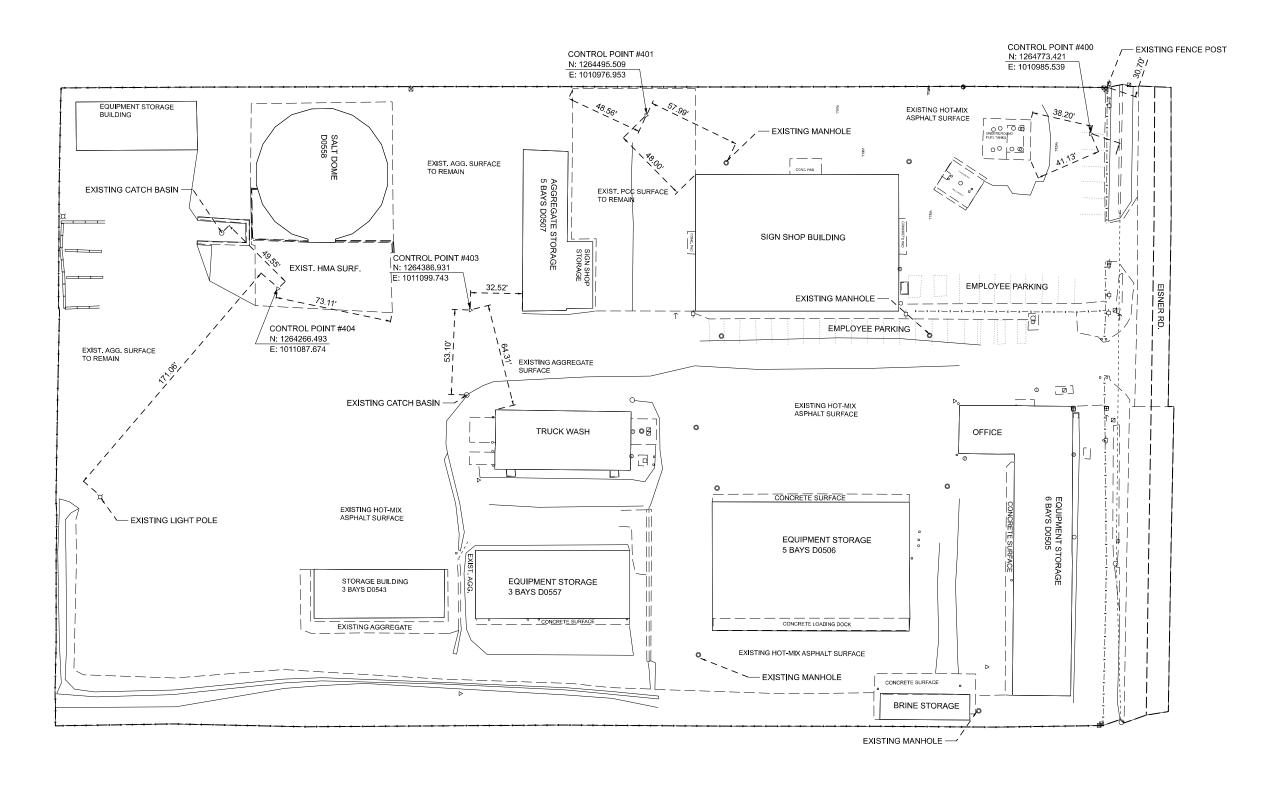 USER NAME
 = Kary, Dawson
 DESIGNED
 REVISED

 DRAWN
 REVISED

 PLOT SCALE
 = 0.19666633\*/in.
 CHECKED
 REVISED

 PLOT DATE
 = 12/7/2023
 DATE
 REVISED

STATE OF ILLINOIS
DEPARTMENT OF TRANSPORTATION

SCALE:

DISTRICT 5 CHAMPAIGN STORAGE FACILITY
CONTROL POINTS & BENCHMARKS


SHEET OF SHEETS STA. TO STA.


A. SECTION COUNTY TOTAL SHEETS NO.

CHAMPAIGN IMP 2024-1 CHAMPAIGN 14 10

CONTRACT NO. 70F51



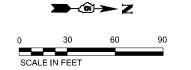

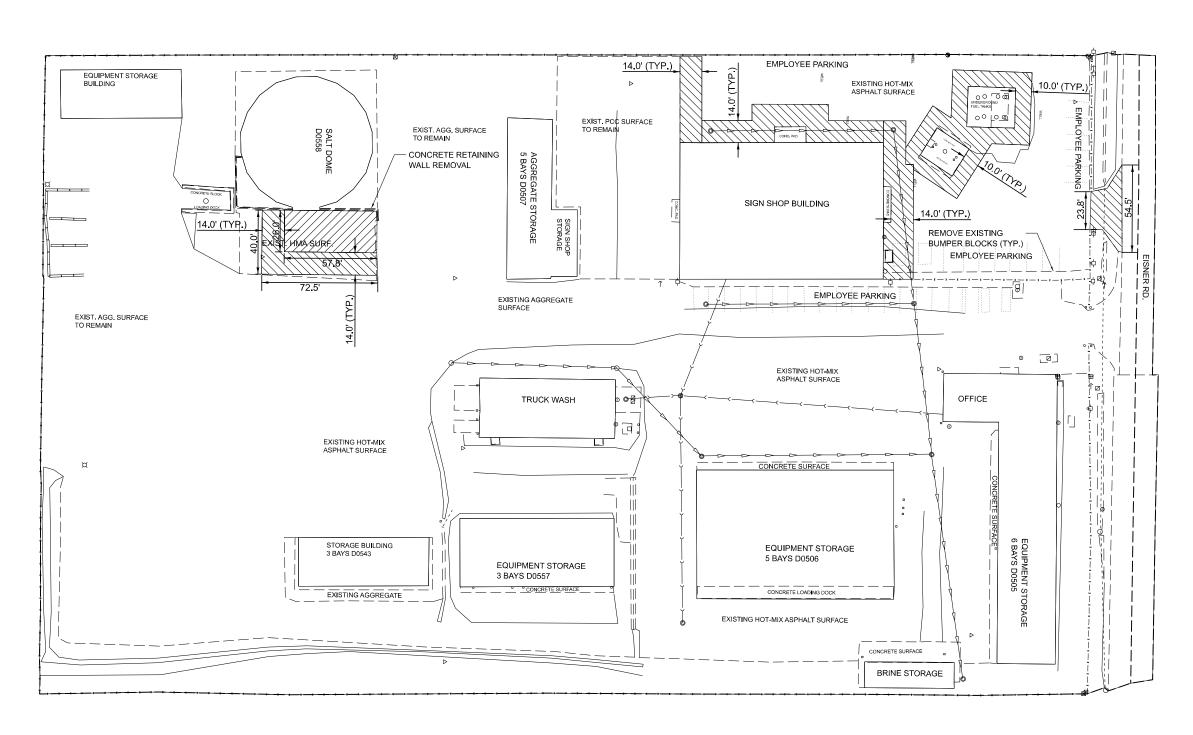

MODEL: Removal [Sheet]

 USER NAME
 = Kary, Dawson
 DESIGNED - REVISED - REV

STATE OF ILLINOIS DEPARTMENT OF TRANSPORTATION

SCALE:

DISTRICT 5 CHAMPAIGN STORAGE FACILITY

REMOVAL PLAN

SHEET OF SHEETS STA. TO STA.

A. TE. SECTION COUNTY TOTAL SHEETS NO.


CHAMPAIGN IMP 2024-1 CHAMPAIGN 14 11


CONTRACT NO. 70F51

LEGEND

EXISTING AGGREGATE SURFACE TO BE PAVED
2" POLYMERIZED HOT-MIX ASPHALT SURFACE COURSE, IL-9.5, MIX "C", N50 & 2" POLYMERIZED HOT-MIX ASPHALT BINDER COURSE, IL-9.5FG, N50 & PREPARATION OF BASE

EXISTING HOT-MIX ASPHALT SURFACE TO BE OVERLAYED
2" POLYMERIZED HOT-MIX ASPHALT SURFACE COURSE, IL-9.5, MIX "C", N50 & PREPARATION OF BASE FOR ESTIMATED 25% OF THE AREA

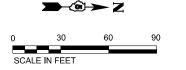

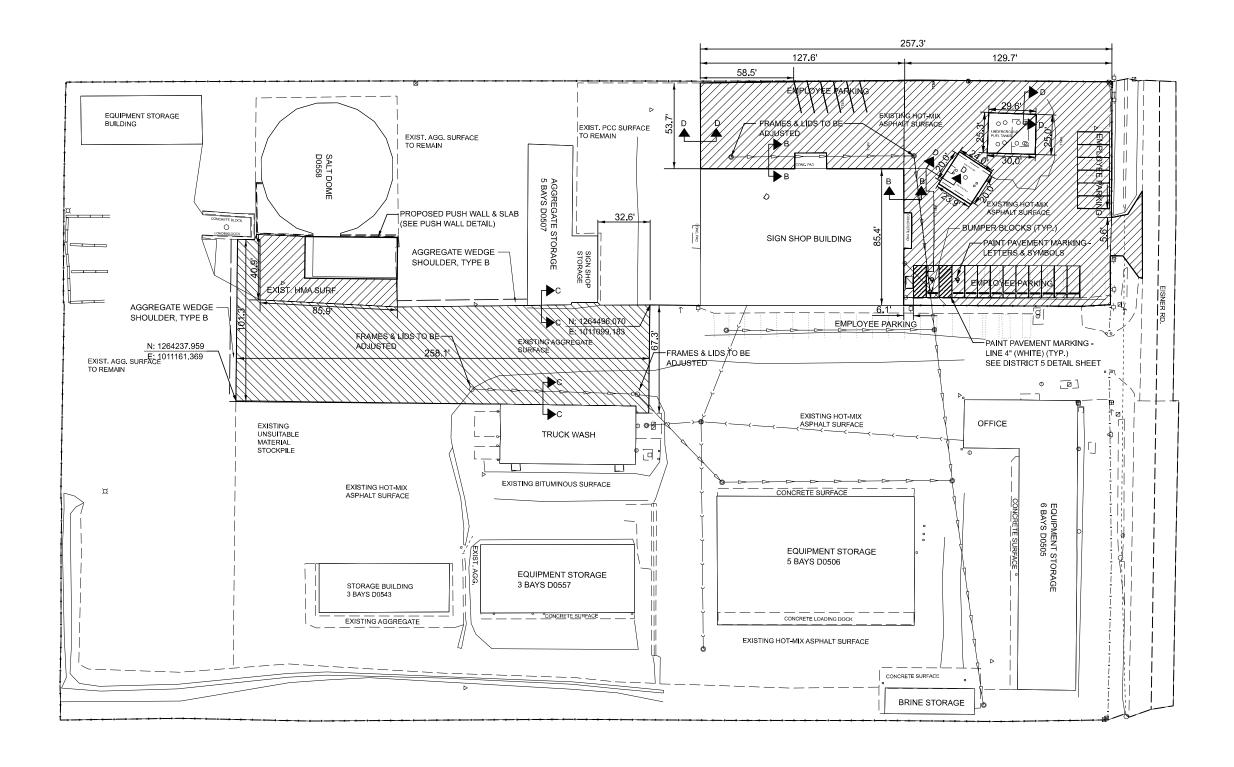

MODEL: Site [Sheet]

STATE OF ILLINOIS
DEPARTMENT OF TRANSPORTATION

SCALE:


DISTRICT 5 CHAMPAIGN STORAGE FACILITY
SITE PLAN

SHEET OF SHEETS STA. TO STA.

F.A. RTE. SECTION COUNTY TOTAL SHEET'S NO.

CHAMPAIGN IMP 2024-1 CHAMPAIGN 14 12

CONTRACT NO. 70F51

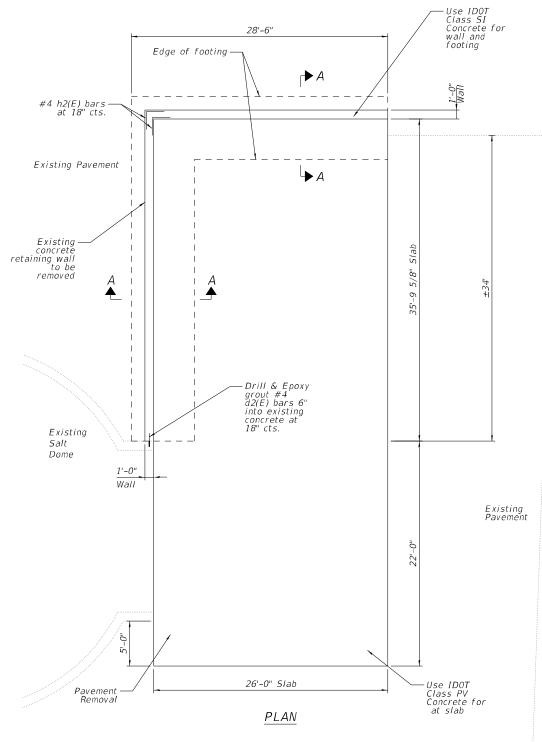

### GENERAL NOTES

Reinforcement bars designated (E) shall be epoxy coated.

The Push wall slab shall receive a light-broom nish, and the walls shall receive a normal nish in accordance with Article 503.15 of the Standard Speci cations.

The Push wall is designed for a 2,000 plf service load at 2' above the concrete slab. Maximum Applied Service Bearing Pressure Qmax, 1,500 psf.

# $\frac{DESIGN\ STRESSES}{FIELD\ UNITS}$ $f'c = 3,500\ psi$

f'c = 3,500 psify = 60,000 psi (Reinforcement)

#4 h1(E) bars or h3(E) at Cost Included with Concrete Structures

Each Face, (Continuous)

#4 h1(E) bars or h3(E) at Cost Included with Concrete Structures

#5 Slab With Fiber Mesh (1.5 Lb/Cu.Yd.) Cost Included with Concrete Structures

#6 Hollow Bulb Type Nonmetallic Water Seal, Cost Included with Concrete Structures

excavation areas. Cost Included with Concrete Structures

CA-06 Compacted
8" Minimum Thickness
Under Slab. Cost Included
with Concrete Structures

Top of Wall-

### BILL OF MATERIAL


Existing salt

dome wall

Bar	No.	Size	Length	Shape
d1(E)	124	#4	5'-0"	
d2(E)	6	#4	2'-0"	
h1(E)	12	#4	26'-8"	
h2(E)	12	#4	4'-0"	
h3(E)	12	#4	36'-5"	
t1(E)	124	#6	6'-8"	
v1(E)	62	#6	9'-9"	
v2(E)	42	#4	9'-5"	
w1(E)	14	#4	28'-2"	
w2(E)	14	#4	38'-0"	
Concre	te Stru	ctures	Cu. Yd.	36.7
	rcement Coated		Pound	3990
Earth Excavation			Cu. Yd.	102.3
Non-Special Waste Disposal			Cu. Yd.	70.0
Paveme	ent Rem	noval	Sq. Yd.	167.0
Concre Wall Re	te Reta emoval	ining	Foot	43.0

### SECTION A-A

7'-0"

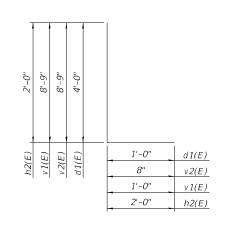

BARS d1(E), v1(E), v2(E), & h2(E)

 DATE:
 DECEMBER 4
 20 23

 EXPIRES:
 NOVEMBER 30
 20 24

RUCTUR

MICHAEL J.

TRELLO NUMBER

081-006334

OF IL

\*Bill of materials only pertain to retaining wall



LO	USER NAME	=		DESIGNED	-	PA	REVISED	-
RS pany				CHECKED	-	MJT	REVISED	-
1001	PLOT SCALE	=		DRAWN	-	KTCE	REVISED	-
516	PLOT DATE	= 12/7/2023	\$TIME\$	CHECKED	-	MJT	REVISED	-

STATE OF ILLINOIS DEPARTMENT OF TRANSPORTATION

PUSH WALL		SECTION
CHAMPAIGN STORAGE FACILITY		CHAMPAIGN IMP 2024-1
CHAMPAIGN STORAGE PACILITY		
CUEFT 1 OF 1 CHEFTS		NUMBER SER

CTION COUNTY TOTAL SHEET NO.
5N IMP 2024-1 CHAMPAIGN 14 13
CONTRACT NO. 70F51

### **SIGN R7-I 101**




COLOR: LEGEND AND BORDER **BACKGROUND** 


GREEN NON-REFLECTORIZED WHITE REFLECTORIZED

SIGN	DIMENSIONS								
SIZE	Α	В	С	C D E F		F	G	Н	
6 x 12	12	6	1.5	4.5	1.15	3.4	4.6	4.0	
(152.4 x 304.8)	(340.8)	(152.4)	(38.1)	(114.3)	(29.2)	(86.4)	(116.8)	(101.6)	

SIGN SIZE	SERIES Lines	Margin	Border	BLK Std
6 x 12 (152.4 x 304.8)	1/3A	0.37 (9.5)	0.37 (9.5)	B5-126

To be used with R7-8 \* \$ = SERIES 3A "S"

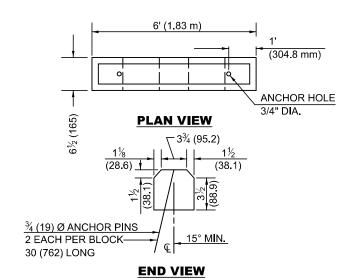

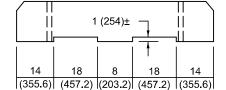


### **ELEVATION VIEW**

NOTE: NOMINAL DIMENSIONS OF BLOCKS MAY VARY CLASS P.C. CONCRETE SHALL BE USED THROUGHOUT.


### **BUMPER BLOCK DETAIL**

### **SIGN R7-8**

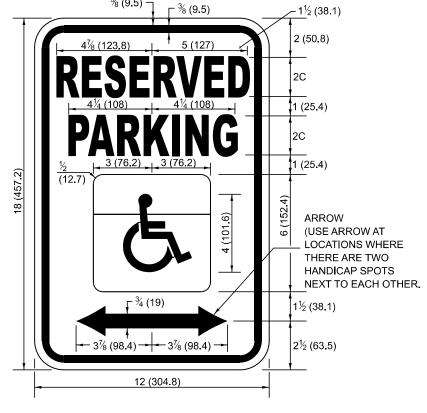

### **COLORS**

LEGEND AND BORDER - GREEN WHITE SYMBOL ON BLUE BACKGROUND BACKGROUND - WHITE

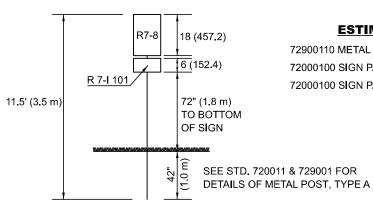


#### **ESTIMATED QUANTITY**

72900110 METAL POST - TYPE A = 11.5' (3.5 m) 72000100 SIGN PANEL R 7-I 101 0.5 SQ.FT. (.046 m<sup>2</sup>) 72000100 SIGN PANEL R 7-8 1.5 SQ.FT. (.139 m<sup>2</sup>)

TOTAL = 2.0 SQ.FT. (.185 m<sup>2</sup>)

SEE STD. 720011 & 729001 FOR

### **SIGN POST DETAILS**

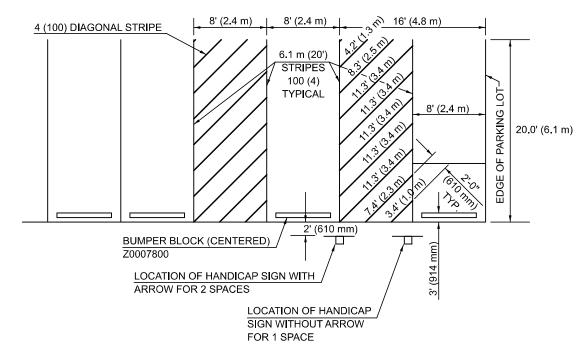

**DETAIL OF PARKING SPACES** 

THIS DRAWING HAS NO SCALE.

ESTIMATED QUANTITY OF PAVEMENT MARKING-LINE 4" (100 mm) (FOR 1 SPACE) TOTAL DIAGONALS = 80' (24.4 m)

SEE DETAIL FOR HANDICAP SIGN.

Note: All dimensions are in INCHES

### (millimeters) unless otherwise shown. DISTRICT 5 DETAIL NO. 72000100

											DIGITAGE S DE IA	AIL 140. 120	00100	ı
USER NAME = Kary.Dawson	DESIGNED -	REVISED - 11/06		DISABLED PARKING					F.A.	SECTION	COUNTY	TOTAL SHEET	1	
	DRAWN -	REVISED - 12/27/17 JWS	STATE OF ILLINOIS						1112	CHAMPAIGN IMP 2024-1	CHAMPAIGN	14 14	1	
PLOT SCALE = 0.16666633 '/in.	CHECKED -	REVISED -	DEPARTMENT OF TRANSPORTATION							CONTRACT NO. 70F			1	
PLOT DATE = 11/16/2023	DATE -	REVISED -		SCALE:	SHEET 1	OF 1	SHEETS	STA.	TO STA.	$\overline{}$	ILLINOIS FEC	. AID PROJECT		1