


PROPOSED\_PROJECT BEGINS

STA. 141 + 59

SN044-7100(P)/SN044-7057(E) Q PROP. CULVERT STA. 141 + 92 FAP ROUTE 885 (IL 146) SECTION 110CR-1 PROJECT HBFP-WYEQ(674) BOX CULVERT REPLACEMENT JOHNSON COUNTY

C-99-055-22

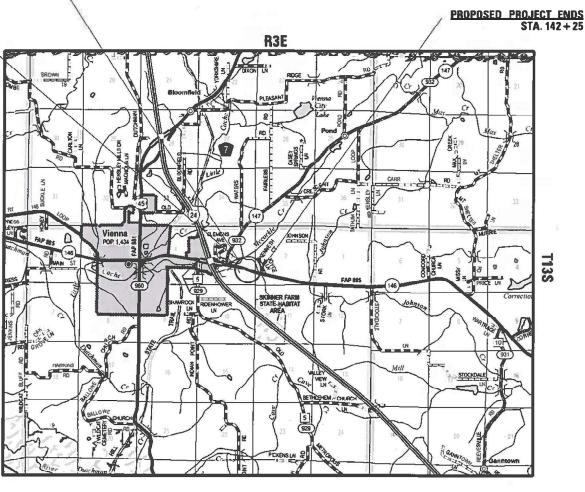

GROSS LENGTH = 66.0 FT. = 0.0125 MILES NET LENGTH = 66.0 FT. = 0.0125 MILES

9'x8' PROP. PRECAST BOX CULVERT WC.I.P. APRON END SECTIONS 35° SKEW, 64'-8" END TO END TOWNSHIP

TRAFFIC\_DATA

2021 ADT = 2700 WITH 4% TRUCKS SPEED LIMIT = 55 MPH

COUNTY\_UNIT\_ROAD

COORDINATE SYSTEM : ILLINOIS CORDINATE SYSTEM, EAST ZONE

**POSTED SPEED : 55 MPH** 

0

 $\bigcirc$ 


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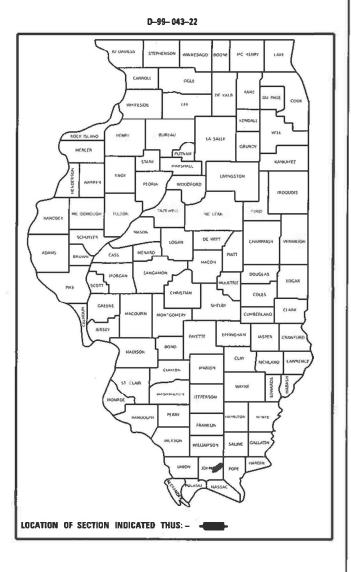
0

J.U.LI.E. JOINT UTILITY LOCATION INFORMATION FOR EXCAVATION 1-800-892-0123 OR 811

## PROJECT ENGINEER: EHREN KIRBY PROJECT DESIGNER: ZACH LOMAX


CONTRACT NO. 78948



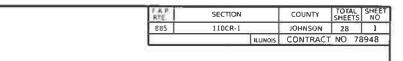

STATE OF ILLINOIS DEPARTMENT OF TRANSPORTATION

SUBMITTED Dec 4 2023 H. Bran **REGION FIVE ENGINEER** February 2, 202 ENGINEER OF DESIGN AND ENVIRONMENT February 2, 2024 DIRECTOR OF HIGHWAYS PROJECT IMPLEMENTATION **PRINTED BY THE AUTHORITY** OF THE STATE OF ILLINOIS

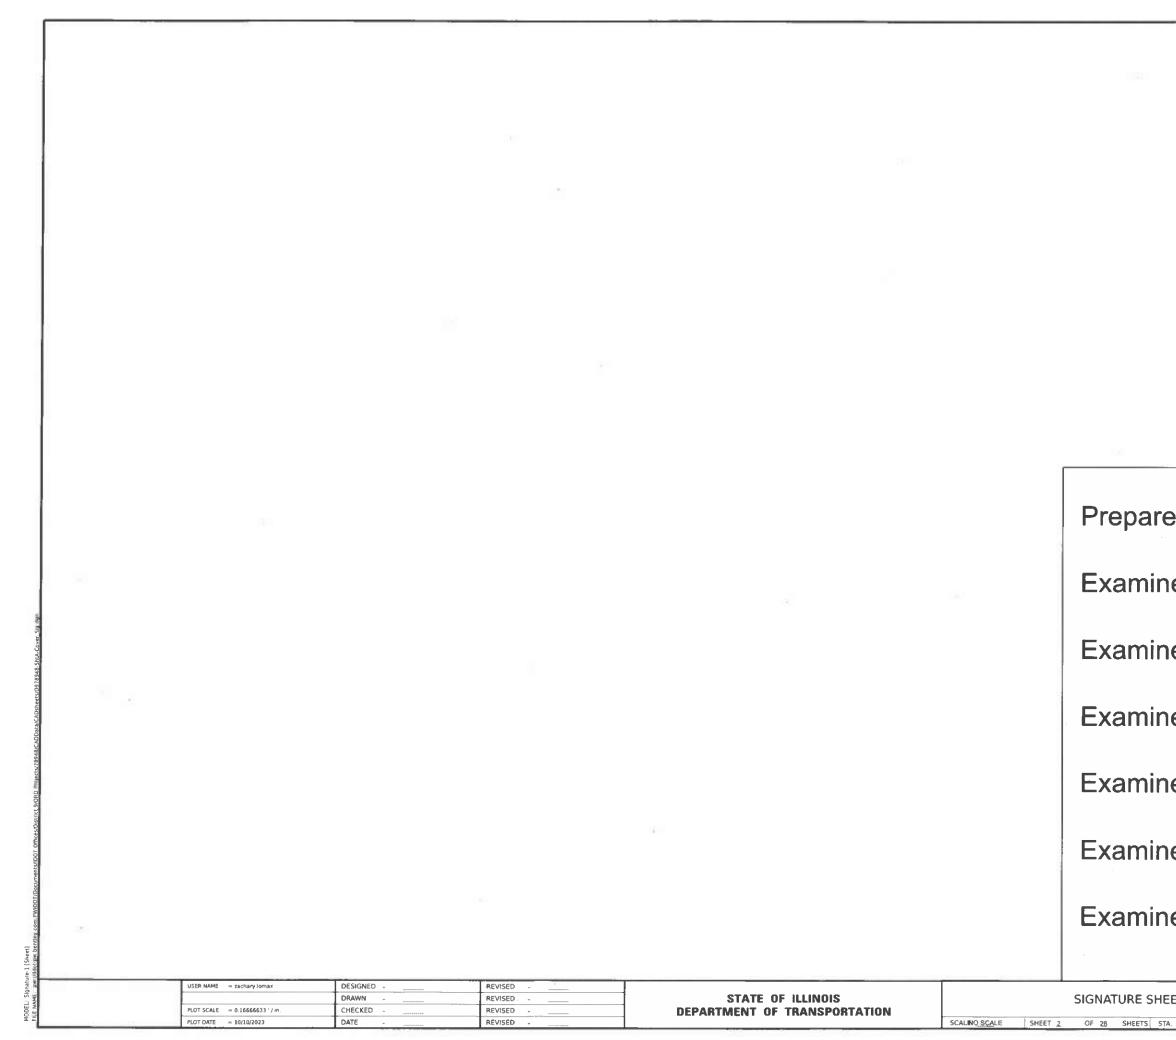

1	
ared By:	Charles Steri DISTRICT STUDIES & PLANS ENGINEER
nined By:	Manay Le DISTRICT LAND ACQUISITION ENGINEER
ningd Dy:	
nined By <del>:</del>	DISTRICT OPERATIONS ENGINEER
nined By:	District PROJECT IMPLEMENTATION ENGINEER
nined By:	Dans 1- 71-0 DISTRICT CONSTRUCTION ENGINEER
	Aan Dang DISTRICT MATERIALS ENGINEER
E SHEET	F.A.P. RTE. SECTION COUNTY TOTAL SHEETS SHEET NO.   885 110CR-1 JOHNSON 28 2   CONTRACT NO. 78948   TA.

# **INDEX OF SHEETS**

# **GENERAL NOTES**

SHEET NO	DESCRIPTION	FACTORS USED FOR ESTIMATING PLAN	QUANTITIES AREA AS FOLLOW
1	COVER SHEET	QUANTITIES.	
2	SIGNATURE SHEET	ALLAGG	2.05 T
3	INDEX OF SHEETS, HIGHWAY STANDARDS, GENERAL NOTES, AND	ALLAGO	2.03 1
5	COMMITMENTS	RIPRAP	1.5 TC
4-7	SUMMARY OF QUANTITIES	NIENAE	1.5 10
8-9	SCHEDULES		
10	ALIGNMENT, TIES, AND BENCHMARKS		
11	PROPOSED ROW PLAN	AT ALL LOCATIONS WHERE THE PROPC	SED CONCRETE PAVEMENT JOI
12	PLAN AND PROFILE	A FULL DEPTH SAWED JOINT SHALL BE	CONSTRUCTED. THE COST OF T
13	GENERAL PLAN	COST OF THE TYPE OF PAVEMENT BEIN	IG CONSTRUCTED.
14	GENERAL PLAN AND ELEVATION		
15	LIMITS OF POROUS GRANULAR EMBANKMENT AND SECTION WITHIN PAVEMENT REMOVAL	COMMITMENTS:	
16	TEMPORARY AND FINAL SECTIONS		
17-18	CIP APRON END SECTION DETAILS	TREES THREE (3) INCHES OR GREATER I	N DIAMETER AT BREAST HEIGH
19	GUARDRAIL DESIGN	THROUGH SEPTEMBER 30TH OF ANY GI	VEN YEAR.
20-21	DISTRICT STANDARDS		
22	DETOUR SIGNING PLAN		

## **HIGHWAY STANDARDS**

PLOT SCALE = 0.16666633 ' / in.

PLOT DATE = 10/20/2023

23-28

CROSS SECTIONS

DRAWN -

DATE

CHECKED -

-	USER NAME = zachary.lomax	DESIGNED -	REVISED	-		INDEX OF SHEETS								
BLR21-9					RURAL LOCAL HIGHWAYS									
862001-01	UNINTERRUPTABLE PO	WER SUPPLY (UF	PS)											
782006-01	GUARDRAIL AND BAR													
780001-05	TYPICAL PAVEMENT N	IARKINGS												
725001-01	OBJECT AND TERMINA	L MARKERS												
701901-09	TRAFFIC CONTROL DE	VICES												
701316-13	LANE CLOSURE, 2L, 2W	, BRIDGE REPAIR	, FOR SPEEDS ≥ 45 MPH											
701201-05	LANE CLOSURE, 2L, 2W	, DAY ONLY, FOF	R SPEEDS ≥ 45 MPH											
701006-05	OFF-ROAD OPERATION	NS, 2L, 2W, 15' (4	.5 m) TO 24" (600 mm	) FROM PAVEMEN	T EDGE									
701001-02	OFF-ROAD OPERATION	NS, 2L, 2W, MORE	ETHAN 15' (4.5 m) AW	/AY										
666001-01	RIGHT OF WAY MARKE	RS												
630201-07	PCC/HMA STABILIZAT	ION AT STEEL PI	LATE BEAM GUARDRA	AIL										
630101-11	STRONG POST GUARDRAIL ATTACHED TO CULVERT													
630301-09	SHOULDER WIDENING FOR TYPE 1 (SPECIAL) GUARDRAIL TERMINALS													
630001-13	STEEL PLATE BEAM GUARDRAIL													
483001-06	PCC SHOULDER													
420701-03	PAVEMENT WELDED WIRE REINFORCEMENT													
420101-07	24' JOINTED PCC PAVEMENT													
420001-10	PAVEMENT JOINTS													
280001-07	TEMPORARY EROSION	TEMPORARY EROSION CONTROL SYSTEMS												
001006	DECIMAL OF AN INCH	DECIMAL OF AN INCH & OF A FOOT												
001001-02	AREAS OF REINFORCEMENT BARS													
000001-08	STANDARD SYMBOLS	ABBREVIATIONS												

REVISED -

REVISED -

REVISED -

LOWS AND SHALL NOT BE USED AS BASIS OF FINAL

2.05 TONS/CU. YD.

..5 TONS/CU. YD.

T JOINS EXISTING CONCRETE PAVEMENT OF THIS JOINT WILL BE INCLUDED IN THE

EIGHT SHALL NOT BE CLEARED FROM APRIL 1ST

HWAY STANDARDS, L NOTES			F.A.P RTE	SECT	ION		COUNTY	TOTAL SHEETS	SHEET NO.		
			885 110CR-1 JOHNSON 28 3						3		
	1012		CONTRACT NO.7894			8					
тs	STA.	+	TO STA.	+	ILLINOIS FED. AID PROJECT						

COUNTY:
ROUTE:
FUNDING:

		г			
	SUMMARY	OF QUANTITIES	Ļ	COUNTY:	JOHNSON CO
	JOHMAN	OI QUANIIILS		ROUTE:	FAP 885
				FUNDING:	80% FEDERAL 20% STATE
			Ī	_OCATION:	RURAL
CODE					ROADWAY
NUMBER		ITEM DESCRIPTION		UNIT	0004
20100110	TREE REMOVAL (6 TO 15 UNI	TS DIAMETER)		UNIT	64
20100210	TREE REMOVAL (OVER 15 UN	ITS DIAMETER)		UNIT	79
20200100	EARTH EXCAVATION			CU YD	495
20200100				COTD	495
20300100	CHANNEL EXCAVATION			CU YD	105
20400800	FURNISHED EXCAVATION			CU YD	845
20700220	POROUS GRANULAR EMBANK	MENT		CU YD	586
25000200	SEEDING, CLASS 2			ACRE	0.29
25000350	SEEDING, CLASS 7			ACRE	0.29
25000400	NITROGEN FERTILIZER NUTRI	ENT		POUND	27
25000500	PHOSPHORUS FERTILIZER NU	TRIENT		POUND	27
25000600	POTASSIUM FERTILIZER NUTR	IENT		POUND	27
25000700	AGRICULTURAL GROUND LIM	ESTONE		TON	0.6
25100620					1 404
25100630	EROSION CONTROL BLANKET			SQ YD	1,404
28000250	TEMPORARY EROSION CONTR	OL SEEDING		POUND	29
SIGNED -	REVISED -		I		
RAWN -	REVISED -	STATE OF ILLINOIS		SUMINARY U	
HECKED -	REVISED -	DEPARTMENT OF TRANSPORTATION	SC/74589/	SHEET 4 OF 28 S	SHEETS STA+ TO STA+

	USER NAME = zachary.lomax	DESIGNED - DRAWN -	REVISED - REVISED -	STATE OF ILLINOIS		SUM	MAR	Y OF	<sup>=</sup> QUA
	PLOT SCALE = 0.16666633 ' / in.	CHECKED -	REVISED -	DEPARTMENT OF TRANSPORTATION					
PLOT DATE = 10/20/2023		DATE -	REVISED -		SCTALEE!	SHEET 4	OF 2	28 SI	HEETS

## COUNTY: SUMMARY OF QUANTITIES - CONT ROUTE: FUNDING: 80% LOCATION: CODE ITEM DESCRIPTION UNIT NUMBER 28000400 FOOT PERIMETER EROSION BARRIER 28100107 SQ YD STONE RIPRAP, CLASS A4

			-
28100109	STONE RIPRAP, CLASS A5	SQ YD	
28200200	FILTER FABRIC	SQ YD	
42000060	WELDED WIRE REINFORCEMENT	SQ YD	-
42000500	PORTLAND CEMENT CONCRETE PAVEMENT 10"	SQ YD	_
44000100	PAVEMENT REMOVAL	SQ YD	
48300300	PORTLAND CEMENT CONCRETE SHOULDERS 8"	SQ YD	-
50100100	REMOVAL OF EXISTING STRUCTURES	EACH	
50200450	REMOVAL AND DISPOSAL OF UNSUITABLE MATERIAL FOR STRUCTURES	CU YD	
			-
50800205	REINFORCEMENT BARS, EPOXY COATED	POUND	
54003000	CONCRETE BOX CULVERTS	CU YD	
54010908	PRECAST CONCRETE BOX CULVERTS 9' X 8'	FOOT	

	USER NAME = zachary.lomax	DESIGNED -	REVISED _	STATE OF ILLINOIS DEPARTMENT OF TRANSPORTATION		SUM					F.A.P.	SECTION	COUNTY	TOTAL	SHEET
		DRAWN -	REVISED -		SUMMARY OF QUANTITIES				885	110CR-1	IOHNSON	28	5		
(	PLOT SCALE = 0.16666633 ' / in.	CHECKED -	REVISED -										CONTRACT	T NO. 78	948
1	PLOT DATE = 10/20/2023	DATE -	REVISED _		SCALINO SCALE	SHEET 5	OF 28	SHEETS	STA.	TO STA.	1	ILLINOIS FED. A	D PROJECT		

SQ YD

59100100

GEOCOMPOSITE WALL DRAIN

JOHNSON CO
FAP 885
FEDERAL 20% STATE
RURAL
ROADWAY
0004
826
020
44
144
196
191
191
191
570
570
1
66
2,870
40.4
40.4
65
89

	CI	IMMADY OF OUANTITIES CONT	COUNTY:	JOHN SON CO
	20	JMMARY OF QUANTITIES - CONT	ROUTE:	FAP 885
			FUNDING:	80% FEDERAL 20% STA
* 63000030 STRONG I * 63100167 TRAFFIC E			LOCATION:	RURAL
		ITEM DESCRIPTION	UNIT	ROADWAY
ŀ	NUMBER		1-465	0004
*	63000001	STEEL PLATE BEAM GUARDRAIL, TYPE A, 6 FOOT POSTS	FOOT	
*	63000030	STRONG POST GUARDRAIL ATTACHED TO CULVERT	FOOT	
*	6310 <mark>01</mark> 67	TRAFFIC BARRIER TERMINAL, TYPE 1 (SPECIAL) TANGENT	EACH	
	63200310	GUARDRAIL REMOVAL	FOOT	
-	66600105	FURNISHING AND ERECTING RIGHT OF WAY MARKERS	EACH	
	67100100	MOBILIZATION	L SUM	
-	70100100	TRAFFIC CONTROL AND PROTECTION, STANDARD 701316	EACH	
	701004 <mark>5</mark> 0	TRAFFIC CONTROL AND PROTECTION, STANDARD 701201	L SUM	
	70103815	TRAFFIC CONTROL SURVEILLANCE	CAL DA	
	70106500	TEMPORARY BRIDGE TRAFFIC SIGNALS	EACH	
	70106700	TEMPORARY RUMBLE STRIPS	EACH	
	70 <mark>1</mark> 070 <mark>25</mark>	CHANGEABLE MESSAGE SIGN	CAL DA	
*	72501000	TERMINAL MARKER - DIRECT APPLIED	EACH	
*	78 <mark>001</mark> 110	PAINT PAVEMENT MARKING - LINE 4"	FOOT	
*	78200005	GUARDRAIL REFLECTORS, TYPE A	EACH	

*	SPECIALTY ITEM	

	- 516			
Ì	USER NAME = david.a.wilson	DESIGNED -	REVISED -	
		DRAWN _	REVISED _	STATE OF
	PLOT SCALE = 0.16666633 ' / in.	CHECKED -	REVISED -	DEPARTMENT OF
j	PLOT DATE = 12/12/2023	DATE -	REVISED -	

DF ILLINOIS DEPARTMENT OF TRANSPORTATION SUMMARY OF

QUANTITIES			F.A.P. RTE.	SECTION			COUNTY	TOTAL SHEETS	SHEET NO.		
		885	110CR-1			JOHNSON	28	6			
							CONTRACT NO. 78948				
гs	STA.	to sta.			FED. AI	AID PROJECT					

CI		COUNTY:	JOHNSON CO
50	JMMARY OF QUANTITIES - CONT	ROUTE:	FAP 885
		FUNDING:	80% FEDERAL 20% STATE
		LOCATION:	RURAL
CODE	ITEM DESCRIPTION	UNIT	ROADWAY
NUMBER		UNIT	0004
86200300	UNINTERRUPTABLE POWER SUPPLY, EXTENDED	EACH	1
X5810103	MEMBRANE WATERPROOFING SYSTEM FOR BURIED STRUCTURES	SQ YD	89
X7011800	TRAFFIC CONTROL AND PROTECTION, STANDARD BLR 21	L SUM	1
Z0016702	DETOUR SIGNING	L SUM	1
Z0054406	ROCK FILL - FOUNDATION	CU YD	140

\* SPECIALTY ITEM

	USER NAME = zachary.lomax	DESIGNED -	REVISED _			SUMMARY OF QUANTITIES	F.A.P. BTE	SECTION	COUNTY TOTAL SHEET
		DRAWN -	REVISED -	STATE OF ILLINOIS		Somman of QOANTIES	885	110CR-1	JOHNSON 28 7
	PLOT SCALE = 0.16666633 ' / in.	CHECKED -	REVISED -	DEPARTMENT OF TRANSPORTATION			i i		CONTRACT NO. 78948
	PLOT DATE = 10/20/2023	DATE _	REVISED _		SCALENO SCALE	SHEET 7 OF 28 SHEETS STA. TO STA.	di.	ILLINOIS FED.	

TREE REMOVAL SCHEDULE									
LOCATION	TREE REMOVAL (6 TO 15 UNITS DIAMETER)	TREE REMOVAL (OVER 15 UNITS DIAMETER)							
	UNIT	UNIT							
IL 146 - SN 044-7057 (E) / SN 044-7100 (P)									
NORTH END OF STRUCTURE									
1 - 8" DIAMETER TREE	8								
3 - 10" DIAMETER TREE	30								
2 - 13" DIAMETER TREES	26								
1- 16" DIAMETER TREE		16							
1 - 17" DIAMETER TREE		17							
1- 19" DIAMETER TREE		19							
1- 27" DIAMETER TREE		27							
PROJECT TOTALS	64	79							

# PAVEMENT MARKING SCHEDULE

			PAINT P	AVEMEN	IT MARK	KING
START	END STATION	NOTES	LINE- 4" WHITE			
STATION		NOTES	SOLID	SOL I D L T	SK I P - DASH	SOL I D R T
			FT	FΤ	FΤ	FΤ
IL 1	46 - SN 044	4-7057 (E) / SN 044-7100 (P)				
141+59.30	142+24.92	CENTERLINE		66	66	
140+24.35	143+61.07	LEFT EDGELINE	337			
140+38.68	143+62.09	RIGHT EDGELINE	323			
	1	PROJECT TOTALS		792		

# EARTHWORK SCHEDULE

LOCATION				AVERAGE	EARTH		EARTHWORK BALANCE					
		DN	EARTH EXCAVATION	CHANNEL			EMBANKMENT	EXCAVATION REQUIRED TO COMPLETE	EXCESS	FURNISHED EXCAVATION	REMARKS	
STA.	TO	STA.	CU YD	CU YD	%	CU YD	CU YD	CU YD	CU YD	CU YD		
IL 146-SN 044-	7057(E)	/SN 044-7100(P)										
141+52.80	ТО	142+30.60	420.0	105							EARTH EXCAVATION FOR BOX & P.G.E	
140+40.00	ТО	144+10.00	75.0		21.0%	60.0	905	845.0	0	845.0		
PRC	PROJECT TOTALS			105						845.0		
EADTH EVENIATION (		CALCULATED FOR THE	EMOVAL OF THE EVIC	THE BOY BOE OU		A DE NOT HEED IN	THE BALLANGTHE OF	THE TOTAL EASTING	OBV DUE TO THE HIM			

\* EARTH EXCAVATION QUANTITIES CALCULATED FOR THE FEMOVAL OF THE EXISTING BOX, P.G.E, CHANNEL EXCAVATION ARE NOT USED IN THE BALANCING OF THE TOTAL EARTHWORK DUE TO THE UNCERTAINTY OF SUITABLE MATERIAL.

# PAVEMENT SCHEDULE

LOCATION STATION TO STATION	LENGTH ROADWAY WIDTH AREA		PAVEMENT REMOVAL	PORTLAND CEMENT CONCRETE PAVEMENT	WELDED WIRE REINFORCEMENT	REMARKS	
	FOR INFORM. PURPOSES ONLY				10"		
	FT	FT	SQ FT	SQ YD	SQ YD	SQ YD	
IL 146 - SN 044-7057(E)/ SN 044-7100(P)							
STA 141+59.00 TO STA 142+25.00	66	26	1716.0	191	191	191	
PROJECT TOTALS				191	191	191	

USER NAME = zachary.lomax	DESIGNED -	REVISED -				SCHED		
	DRAWN -	REVISED -	STATE OF ILLINOIS		•	JUILD	ULLJ	
PLOT SCALE = 0.16666633 / in.	CHECKED -	REVISED -	DEPARTMENT OF TRANSPORTATION					
PLOT DATE = 10/20/2023	DATE -	REVISED -		SCALENO SCALE	SHEET 8	OF 28	SHEETS	STA

;			F.A.P. RTE	SECT	TION		COUNTY	TOTAL SHEETS	SHEET NO.
			885	1100	CR-1		JOHNSON	28	8
_	1						CONTRACT	NO. 789	948
S	STA.	TO STA.			ILLINOIS	FED. A	D PROJECT		

# SHOULDER SCHEDULE

		<u> </u>		
LOCATION	LENGTH	PROPOSED SHOULDER WIDTH	PCC SHOULDERS	REMARKS
	FOR INFORMATIONAL PURPOSES ONLY		(8")	
	FΤ	FT	SQ YD	
IL 146 - SN 044-7057(E) / SN 044-7100 (P)				
STA 140+24.00 LT TO STA 143+61.00 LT	337.0	7.75	291	
STA 140+38.00 RT TO STA 143+62.00 RT	324.0	7.75	279	
PROJECT TOTALS			570	

# GUARDRAIL SCHEDULE


LOCATION (IL 146)	STEEL PLATE BEAM GUARDRAIL TYPE A, 6 FOOT POSTS	STRONG POST GUARDRAIL ATTACHED TO CULVERT	TRAFFIC BARRIER TERMINAL, TYPE 1 (SPECIAL) TANGENT	GUARDRA I L REMOVAL	TERMINAL MARKER - DIRECT APPLIED	GUARDRAIL REFLECTORS, TYPE A
	FOOT	FOOT	EACH	FOOT	EACH	EACH
SN 044-7057(E)/SN 044-7100(P)						
STA 140+44 LT TO STA 143+44 LT (S)	185.4	14.6	2	282	2	4
STA 140+54 RT TO STA 143+4.5 RT (N)	172.0	15.5	2	257	2	4
PROJECT TOTALS	358	31	4	539	4	8

SEE GUARDRAIL DETAIL SHEETS FOR ADDITIONAL INFORMATION.

# SEEDING SCHEDULE

LOCATION (IL 34)	CLASS 2 SEEDING		PHOSPHORUS FERTILIZER	POTASSIUM FERTILIZER	AG GROUND LIMESTONE	EROSION CONTROL BLANKET	CLASS 7 SEEDING	TEMP EROSION CONTROL SEEDING	PER IMETER EROS I ON CONTROL BARR I ER
	ACRE	POUND	POUND	POUND	TON	SQ YD	ACRE	POUND	FOOT
SN 044-7057(E)/SN 044-7100(P)									
North/Downstream End	0.13	12	12	12	0.3	629.5	0.13	13	399
South/Upstream End	0.16	15	15	15	0.3	774.5	0.16	16	427
PROJECT TOTALS	0.29	27	27	27	0.6	1404	0.29	29	826

USER NAME = zachary.lomax	DESIGNED -	REVISED -				SCHEDU	II ES			F.A.P. BTE	SECTION	COUNTY TOTAL SHEET
	DRAWN -	REVISED -	STATE OF ILLINOIS			SCHEDE				885	110CR-1	JOHNSON 28 9
PLOT SCALE = 0.16666633 / in.	CHECKED -	REVISED -	DEPARTMENT OF TRANSPORTATION									CONTRACT NO. 78948
PLOT DATE = 10/20/2023	DATE -	REVISED -		SCALENO SCALE	SHEET 9	OF 28	SHEETS	STA.	TO STA.		ILLINOIS	ED. AID PROJECT

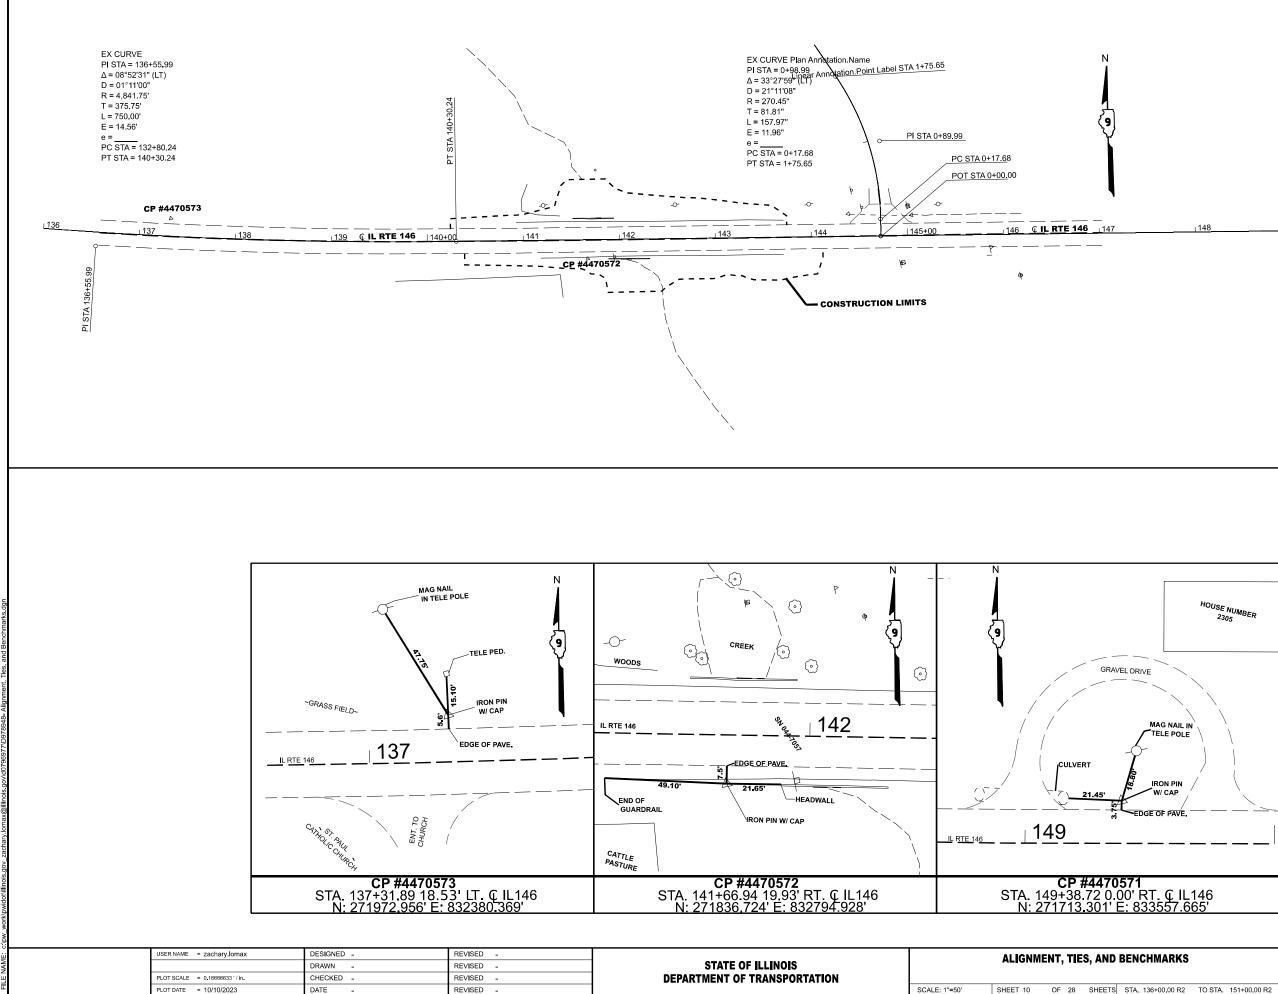


SHEET 10 OF 28 SHEET




149


150+00

ID BENCHMARKS		F.A.P. RTE	SECTION			COUNTY	TOTAL SHEETS	SHEET NO.		
				885	110CR-1			JOHNSON	28	10
								CONTRACT	NO. 789	948
TS	STA. 136+00.00 R2	TO STA.	151+00.00 R2			ILLINOIS	FED, AI	D PROJECT		

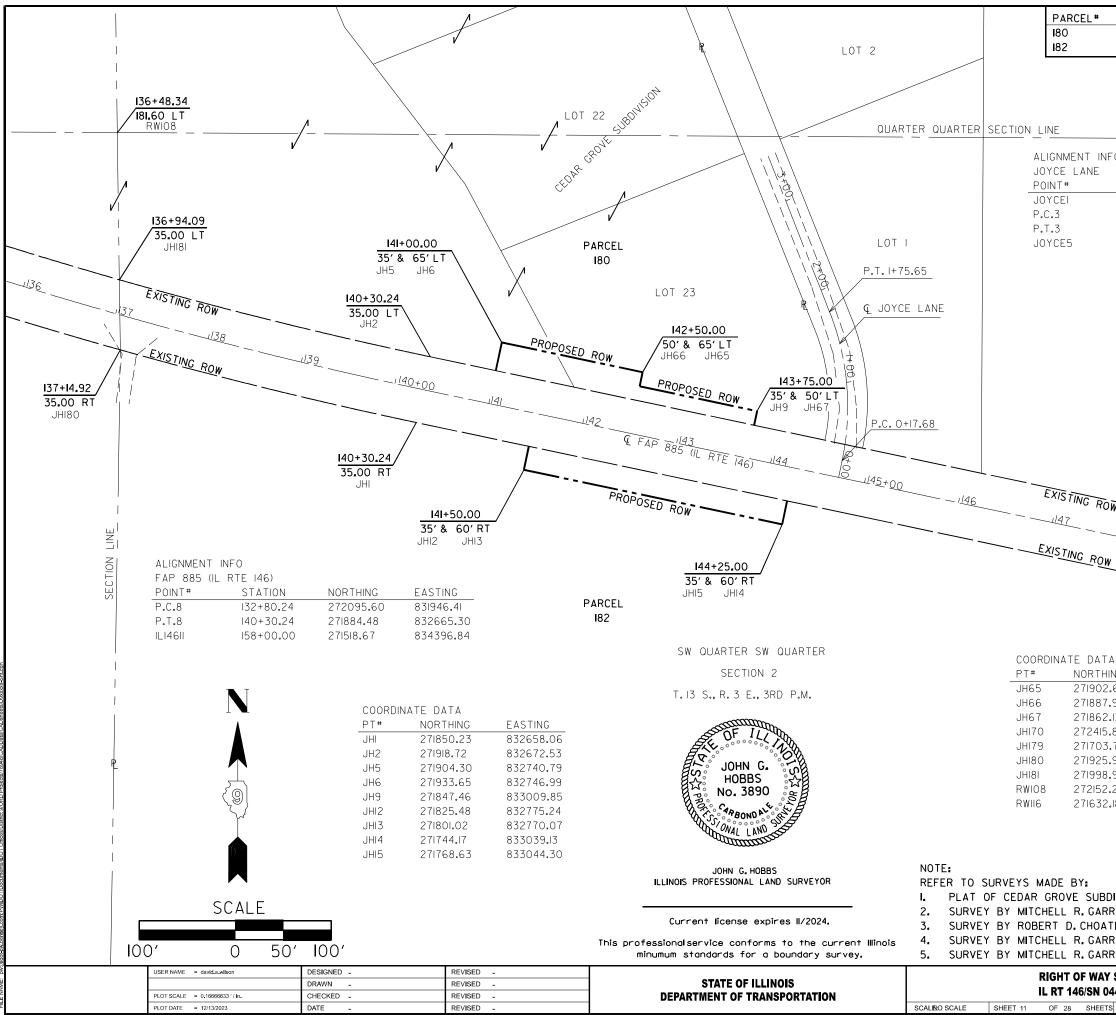

	TY OWNER		PURPOSE	ACREAGE
—	FROVILLION A.& ASHLEY M	JACKSON	R.O.W. R.O.W.	0 <b>.</b> 146 AC: 0 <b>.</b> 158 AC:
				149+81.13 466.77 LT JH70
IFO			/	
STATION 0+00.00 0+17.68 1+75.65 3+50.00	NORTHING 271793.09 271810.39 271965.57 272127.75	EASTING 833097.86 833101.52 833088.47 833024.47		
ŌW			QUARTER QUARTER SECTION LINE	150+70.18
				35.00 LT JHI79
W			±00	11 <u>51</u>
7.97 8328   2.13 8330   5.88 8306   3.76 8336   5.95 8323   8.98 8323	TING 93.75 990.65 012.95 528.07 590.01 549.68 548.67 546.56	150+8 35.0 RW	ORT	
BDIVISION, SHAW RETT, 05/04/ ATE, 01/13/95, F RETT, 02/12/9 RETT, 08/09/ <b>Y SHEET</b>	NEE SURVEYING 95, FOR MORGAN FOR CEDAR OAKS 96, FOR EAVES 96, FOR LOHSTR	FARMS PARTNERSHIP OH	TION C	OUNTY TOTAL SHEETS SHEETS NO. HINSON 28 11
044-7057	TO STA		CC	NTRACT NO. 78948
IS STA.	TO STA.		ILLINOIS FED. AID PROJ	ECT

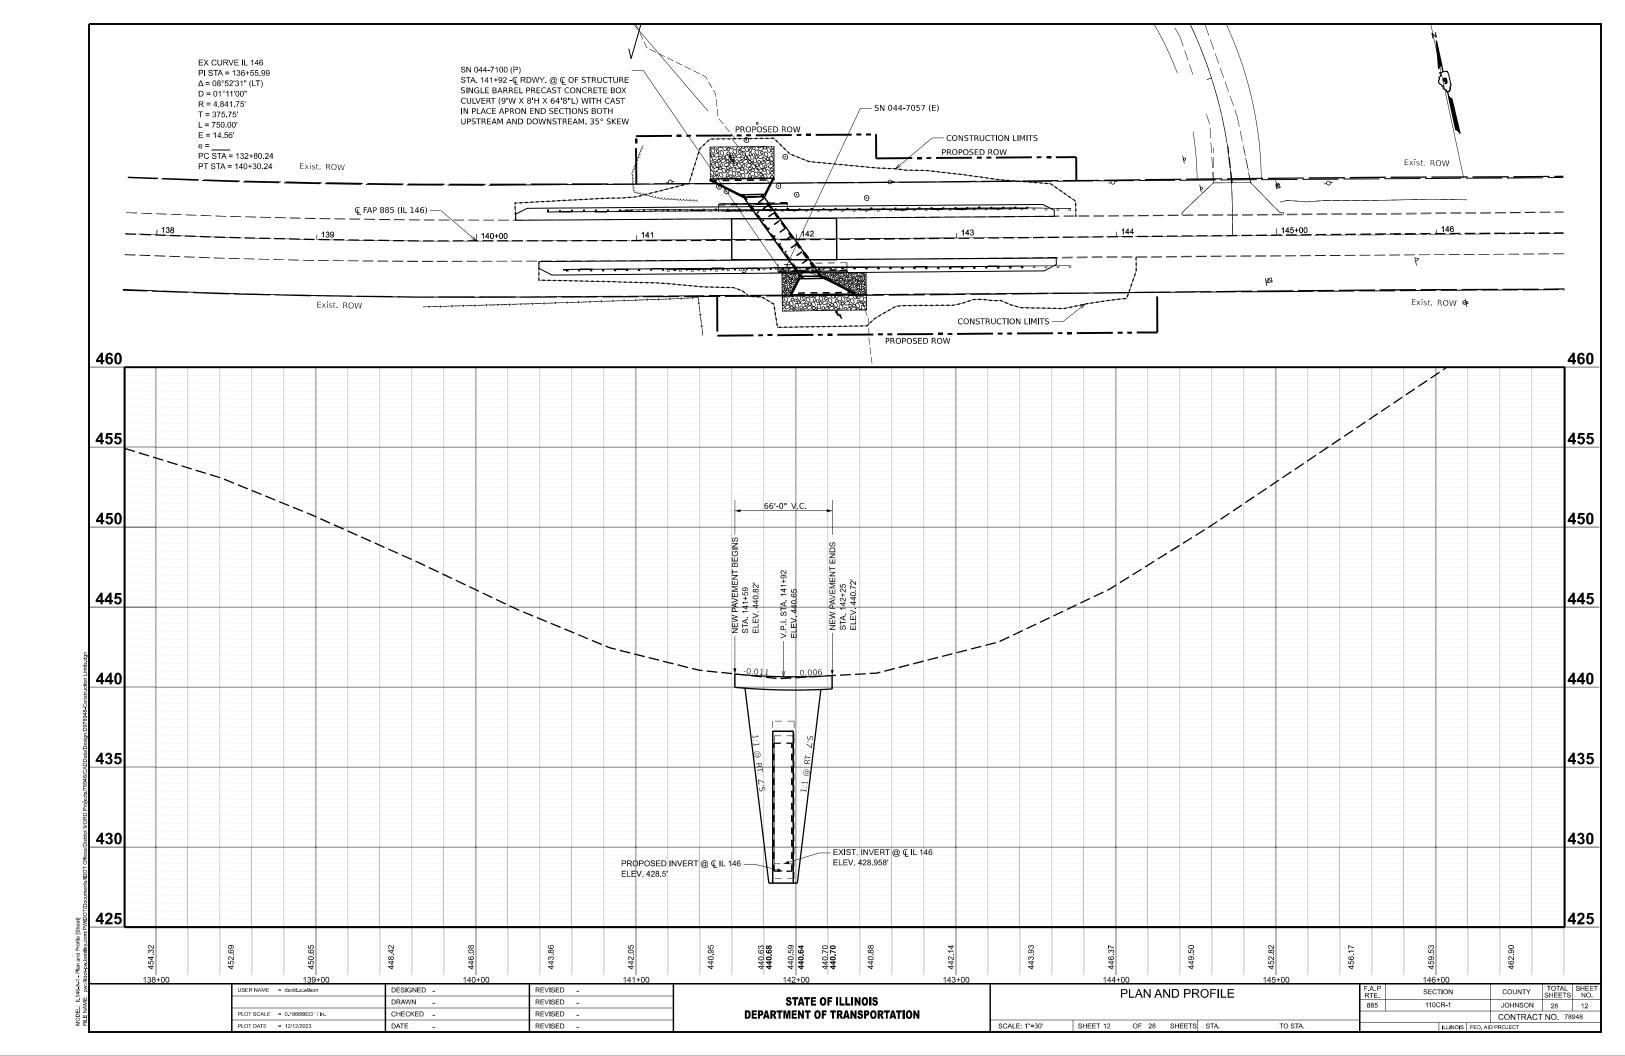


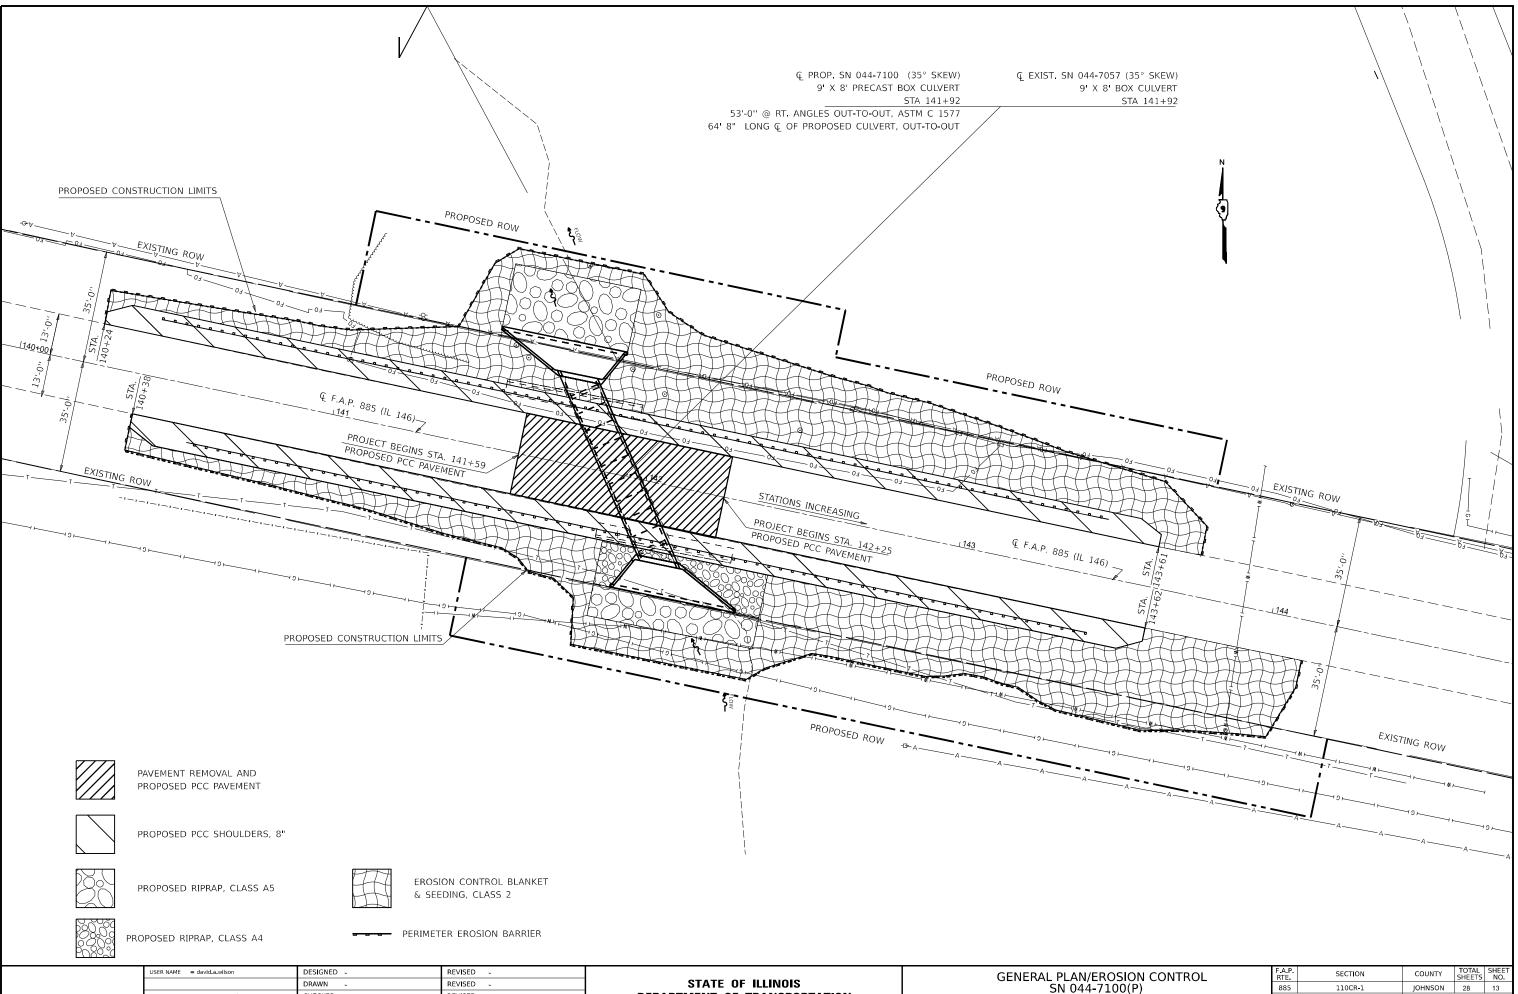


STATE OF ILLINOIS DRAWN REVISED PLOT SCALE = 0.16666633 ' / in. CHECKED -REVISED DEPARTMENT OF TRANSPORTATION PLOT DATE = 12/14/2023 DATE REVISED


SCALENO SCALE SHEET 13 OF 28 SHEETS

					о р А.
ROSION CONTROL	F.A.P. RTE.	SECTION	COUNTY	TOTAL SHEETS	SHEET NO.
7100(P)	885	110CR-1	JOHNSON	28	13
			CONTRACT	NO. 78	948
TS STA. TO STA.	-	ILLINOIS FED.	AID PROJECT		

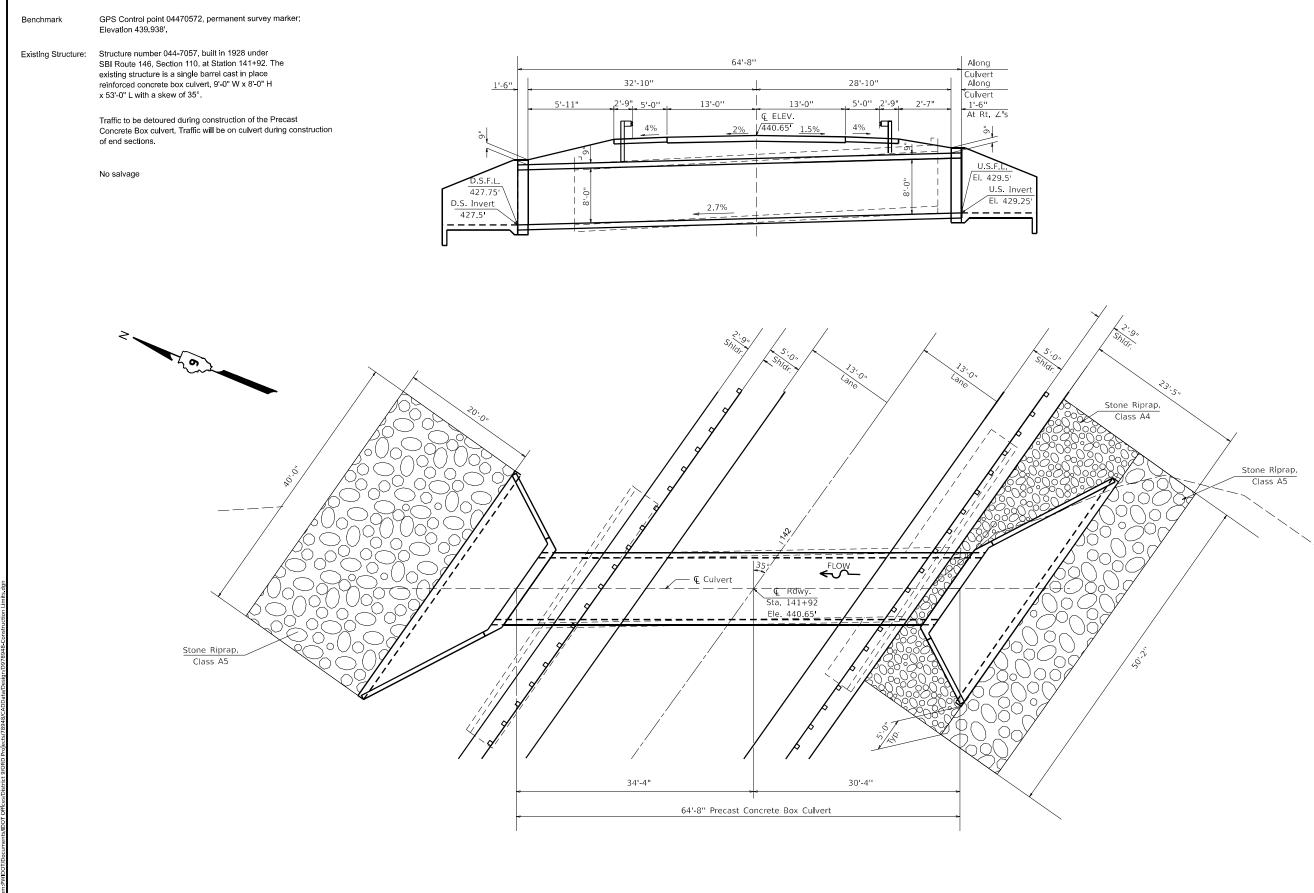


USER NAME = zachary.lomax	DESIGNED -	REVISED -									F.A.P. BTE	SECTION	COUNTY	TOTAL	SHEET
	DRAWN -	REVISED -	STATE OF ILLINOIS		GENE	RAL PI	LAN AN	ID ELE	EVATION		885	110CR-1	JOHNSON	28	14
PLOT SCALE = 0.16666633 / in.	CHECKED -	REVISED -	DEPARTMENT OF TRANSPORTATION											CT NO. 78	3948
PLOT DATE = 10/20/2023	DATE -	REVISED -		SCALENO SCALE	SHEET 14	OF 28	8 SHEET	S STA.		TO STA.		ILLINOIS FED	AID PROJECT		

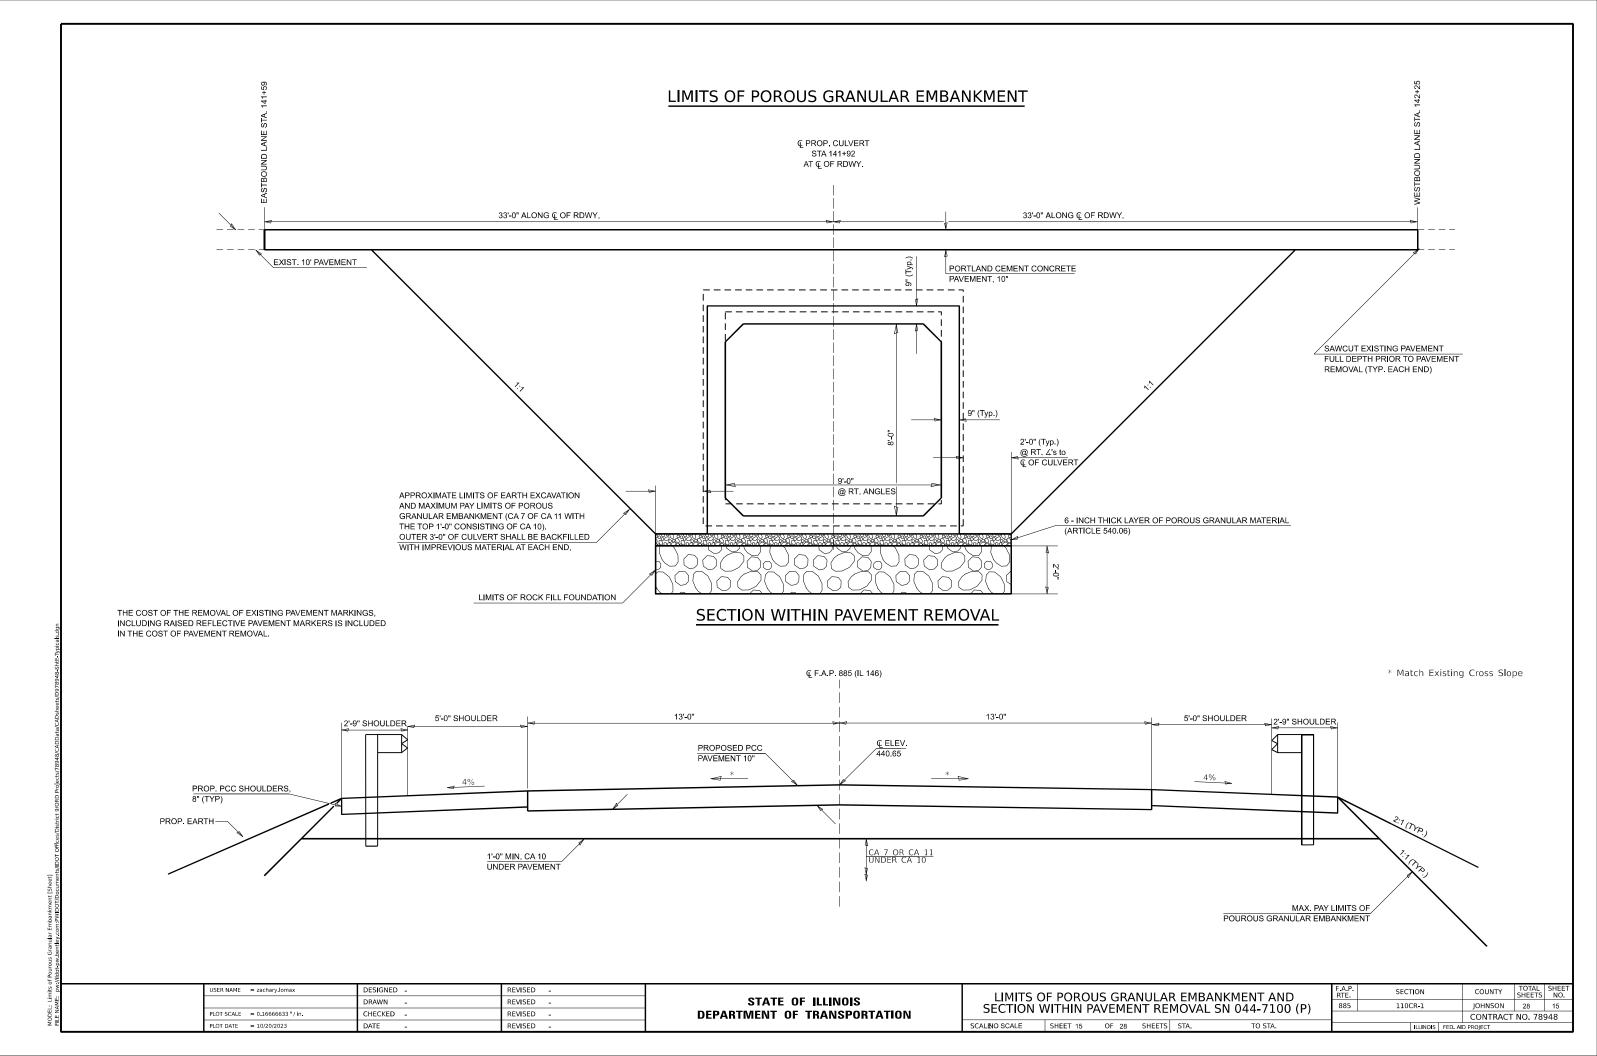

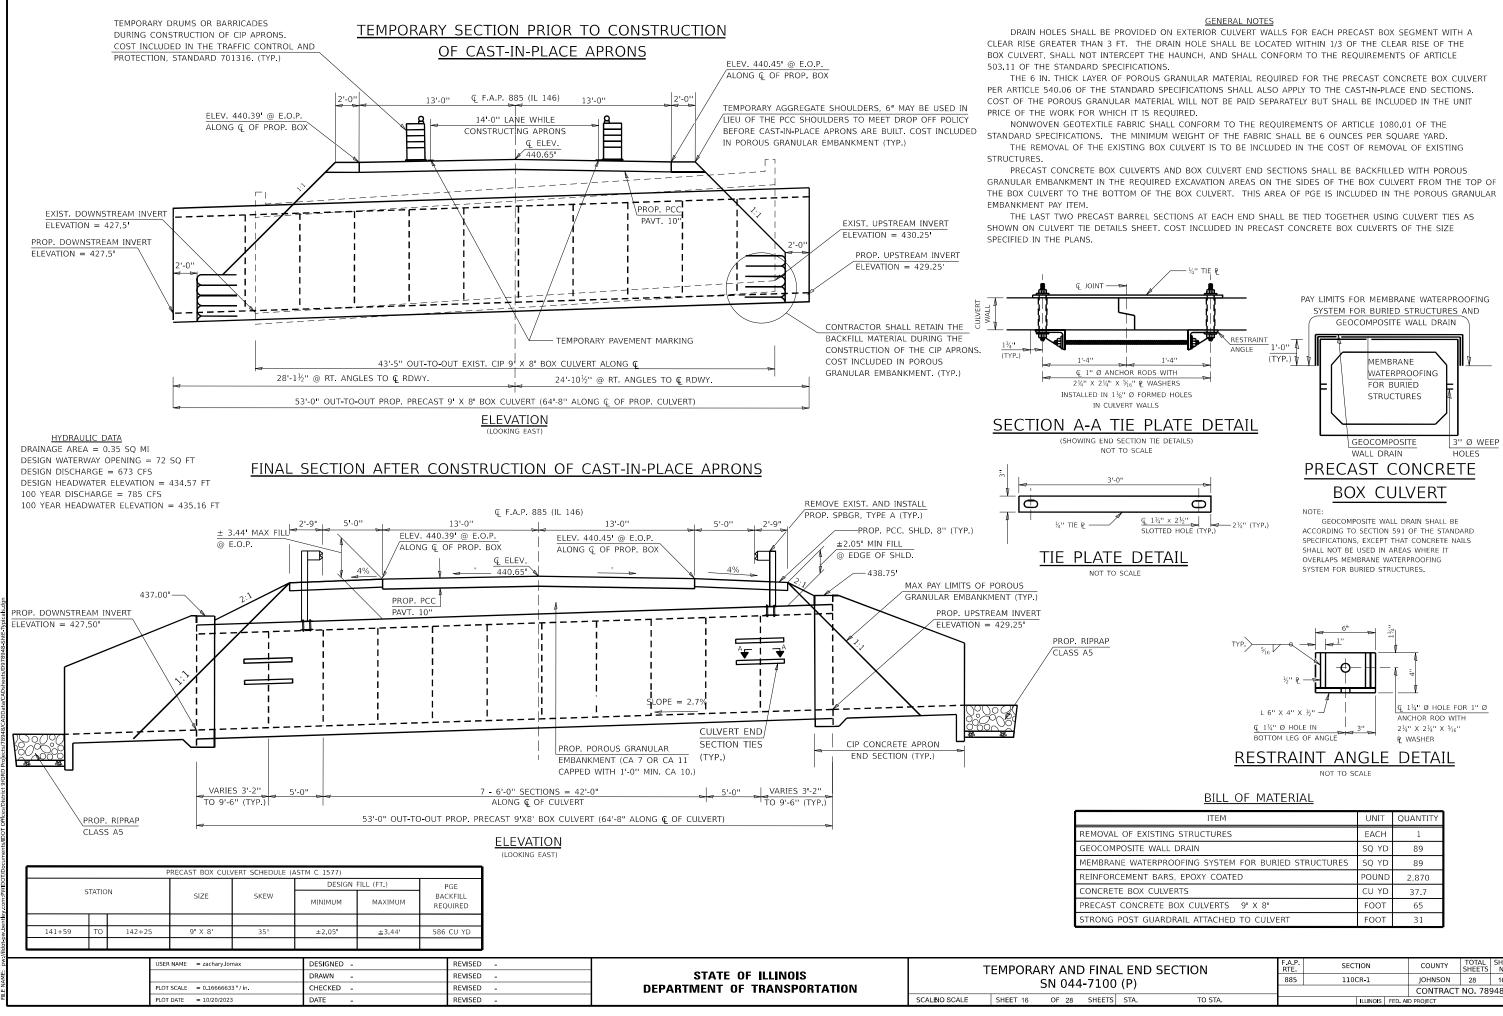


RETE BOX CULVERTS	CU YD	37.7		
ST CONCRETE BOX CULVERTS 9' X 8'	FOOT	65		
IG POST GUARDRAIL ATTACHED TO CULVERT	FOOT	31		
			•	
			TOTAL	CHE

1	L END SECTION			SECT	TION	COUNTY	TOTAL SHEETS	SHEET NO.	
) (P)		885	1100	CR-1		JOHNSON	28	16	
J (F)		_				CONTRACT	NO. 78	948	
5	STA.	TO STA.			ILLINOIS	FED. A	D PROJECT		

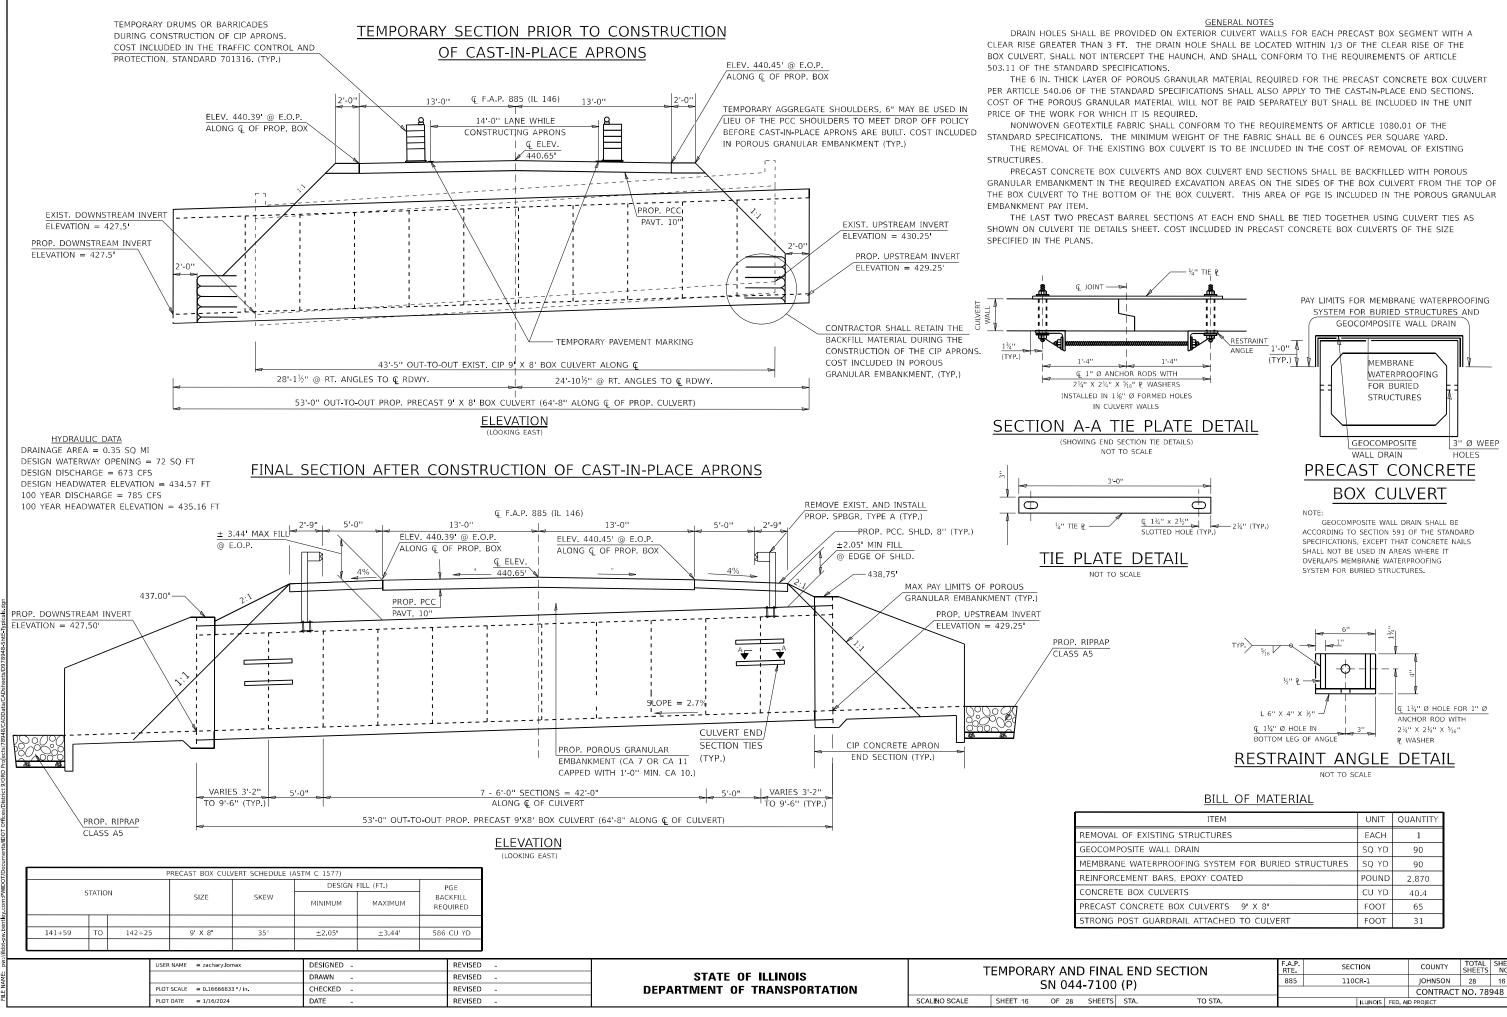

1	L END 9	SECTION	F.A.P. RTE	SECT	ION		COUNTY	TOTAL SHEETS	SHEET NO.
) (P)		885	1100	R-1		JOHNSON	28	16	
	(1)						CONTRACT	NO. 78	948
5	STA.	TO STA.			ILLINOIS	FED. A	D PROJECT		

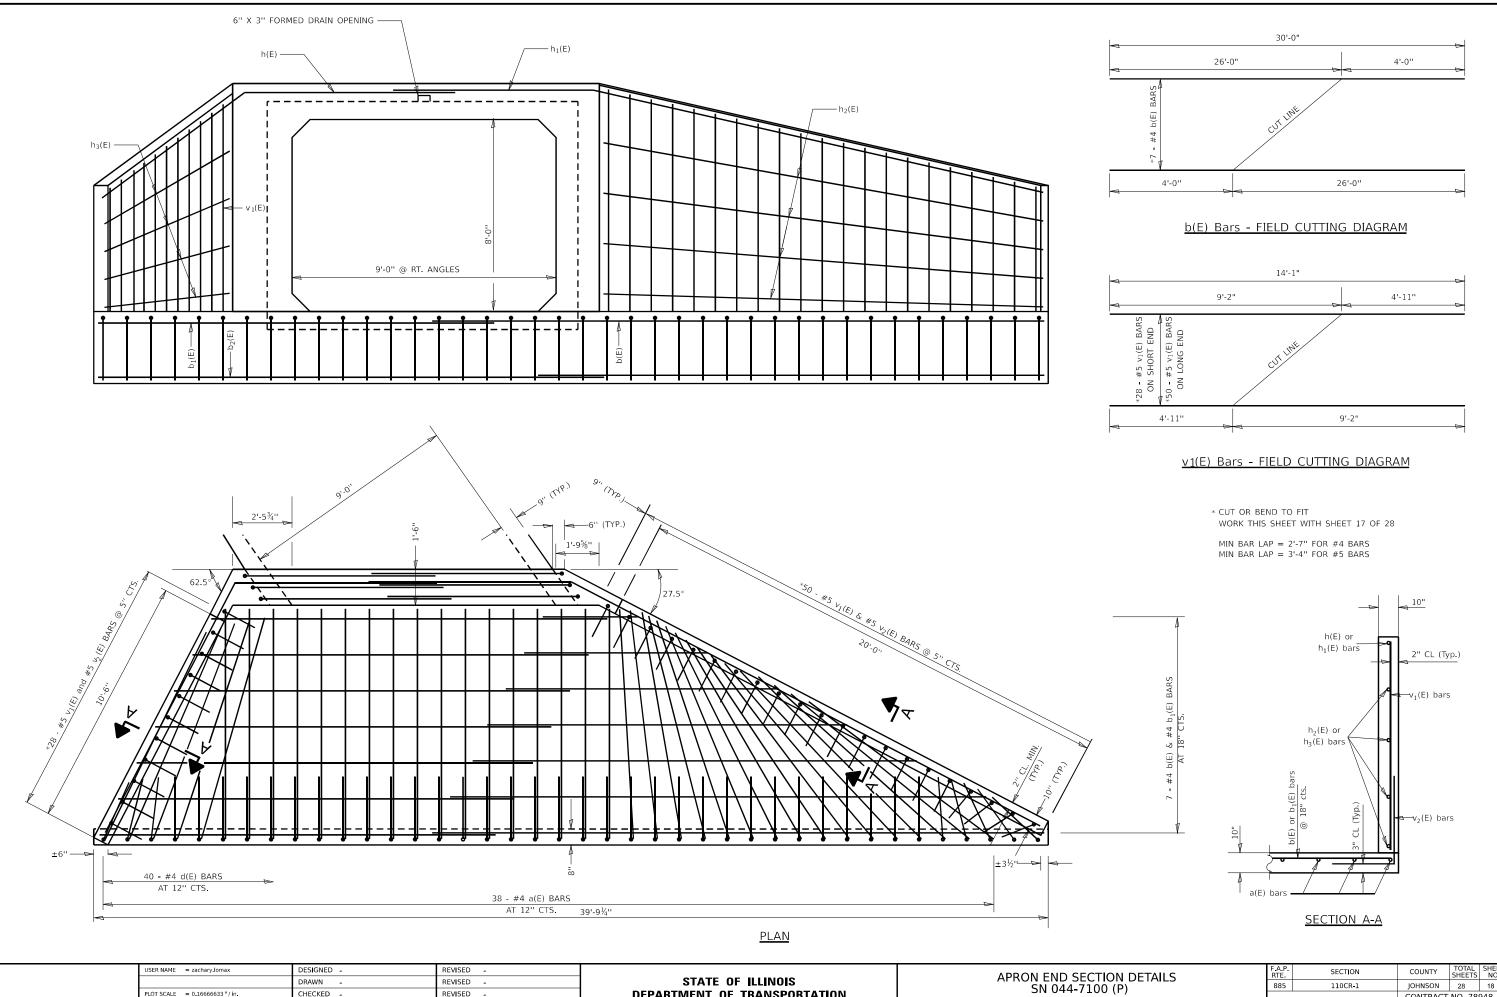

DEPARTMENT OF TRANSPORTATION

SCALENO SCALE SHEET 18 OF 28 SHEETS

PLOT SCALE = 0.16666633 ' / in.


PLOT DATE = 10/20/2023


CHECKED -

DATE


REVISED -

REVISED

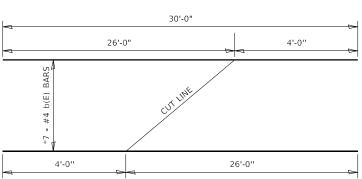


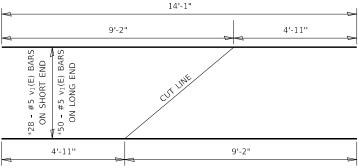


тŀ	ION DETAILS		F.A.P. RTE	SEC	TION		COUNTY	TOTAL SHEETS	SHEET NO.
	(P)		885	110	CR-1		JOHNSON	28	18
	(1)						CONTRACT	NO. 789	948
٢S	STA.	TO STA.			ILLINOIS	FED. A	D PROJECT		

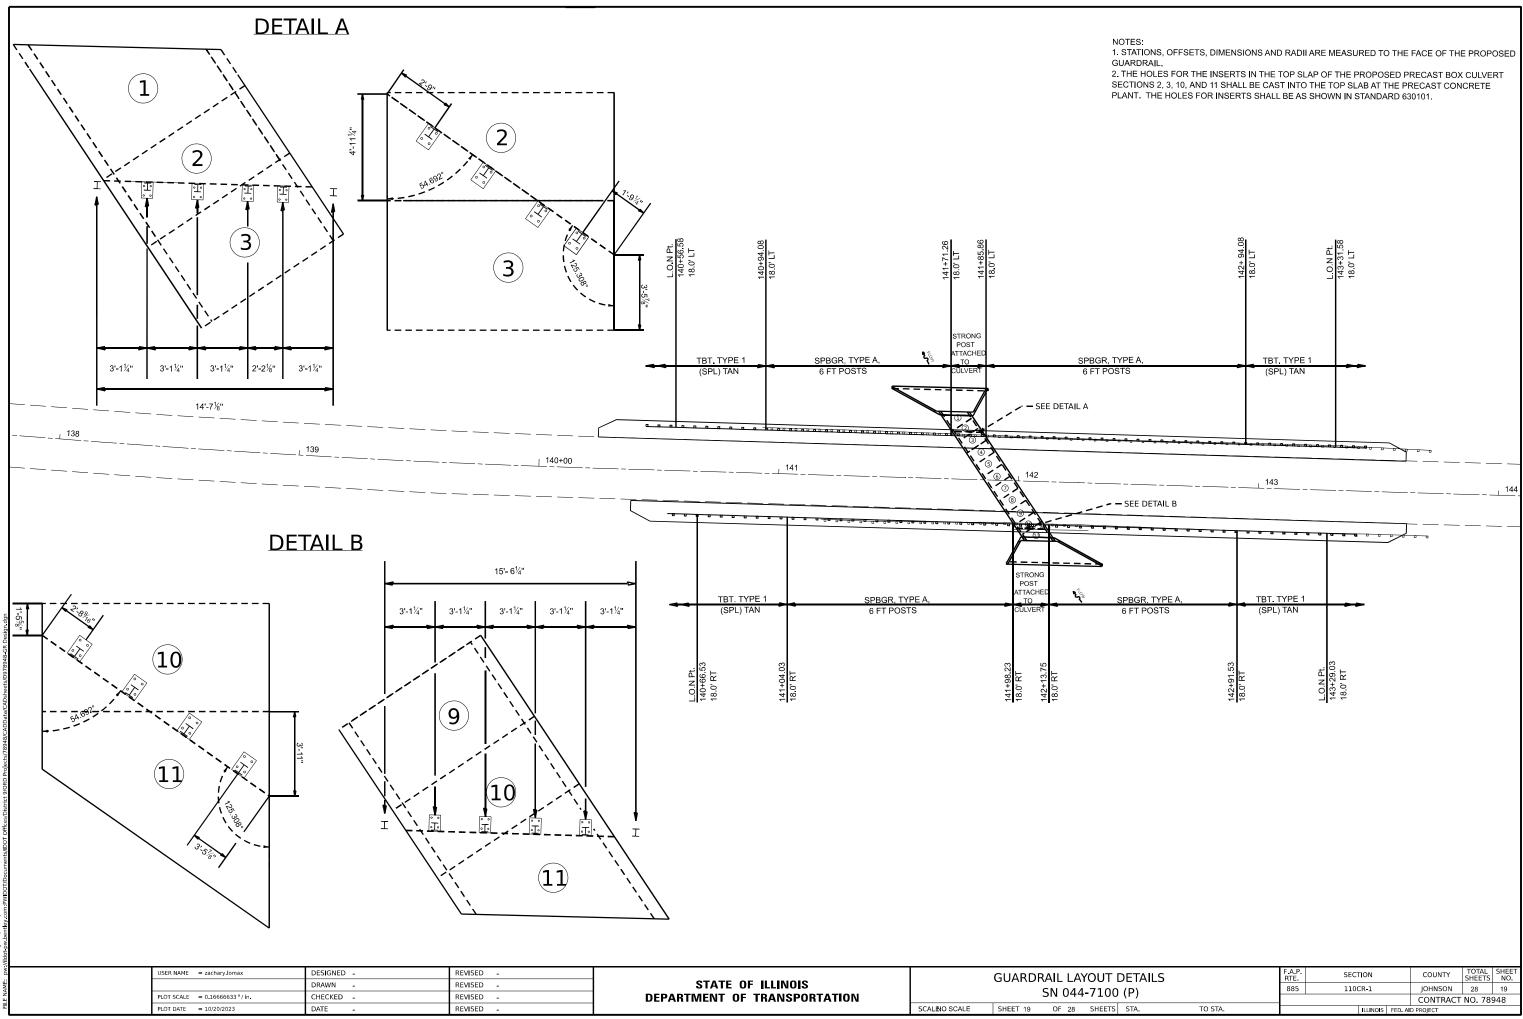

# 24' (7.2 m) PCC PAVEMENT OVER BOX CULVERT

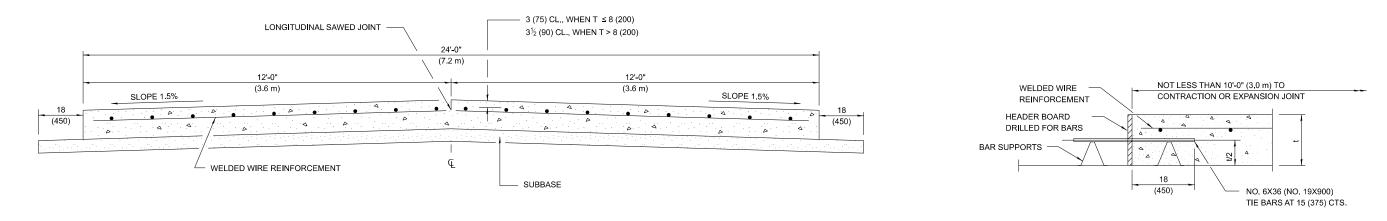

**SECTION A–A** (TYPICAL 2-LANE WITH SHOULDERS)

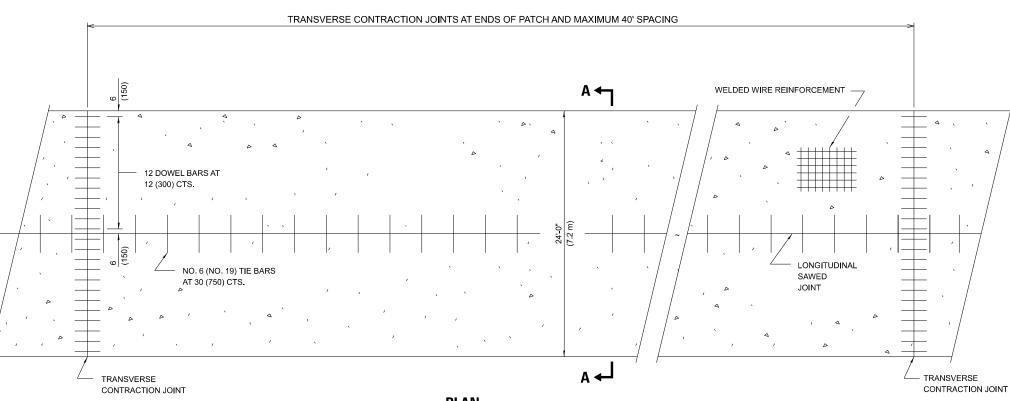

**PLAN** 

USER NAME = zachary.lomax	DESIGNED -	REVISED -			פוח	STRICT	STAND	DARDS		F.A.P RTE	SECTION	COUNTY T	TOTAL SHEET
	DRAWN -	REVISED -	STATE OF ILLINOIS							885	110CR-1	JOHNSON	28 20
PLOT SCALE = 0.16666633 ' / in.	CHECKED -	REVISED -	DEPARTMENT OF TRANSPORTATION									CONTRACT N	JO. 78948
PLOT DATE = 10/20/2023	DATE -	REVISED -		SCALE: 1"=50'	SHEET 20	OF 28	SHEETS	STA+	TO STA. <u>+</u>		ILLINOIS FEE	AID PROJECT	

DEL: District Standards [Sheet] NAME: nw://ildot.nw.bentlev.com:P/MDOT/D

## TRANSVERSE CONSTRUCTION JOINT

(IF NEEDED PER STANDARD SPECIFICATIONS)

### **GENERAL NOTES**


SEE STANDARD 420001 FOR DETAILS NOT SHOWN.

SEE STANDARD 420701 FOR WELDED WIRE REINFORCEMENT DETAILS.


ALL DIMENSIONS ARE IN INCHES (MILLIMETERS) UNLESS OTHERWISE SHOWN.

ACTUAL DIMENSIONS TO MATCH FIELD CONDITIONS AND CONSTRUCTION METHODS.

	DRAWN	11-09-17
	REVISED	07-23-18
	REVISED	10-21-21
STD. 9-13	REVISED	05-04-22

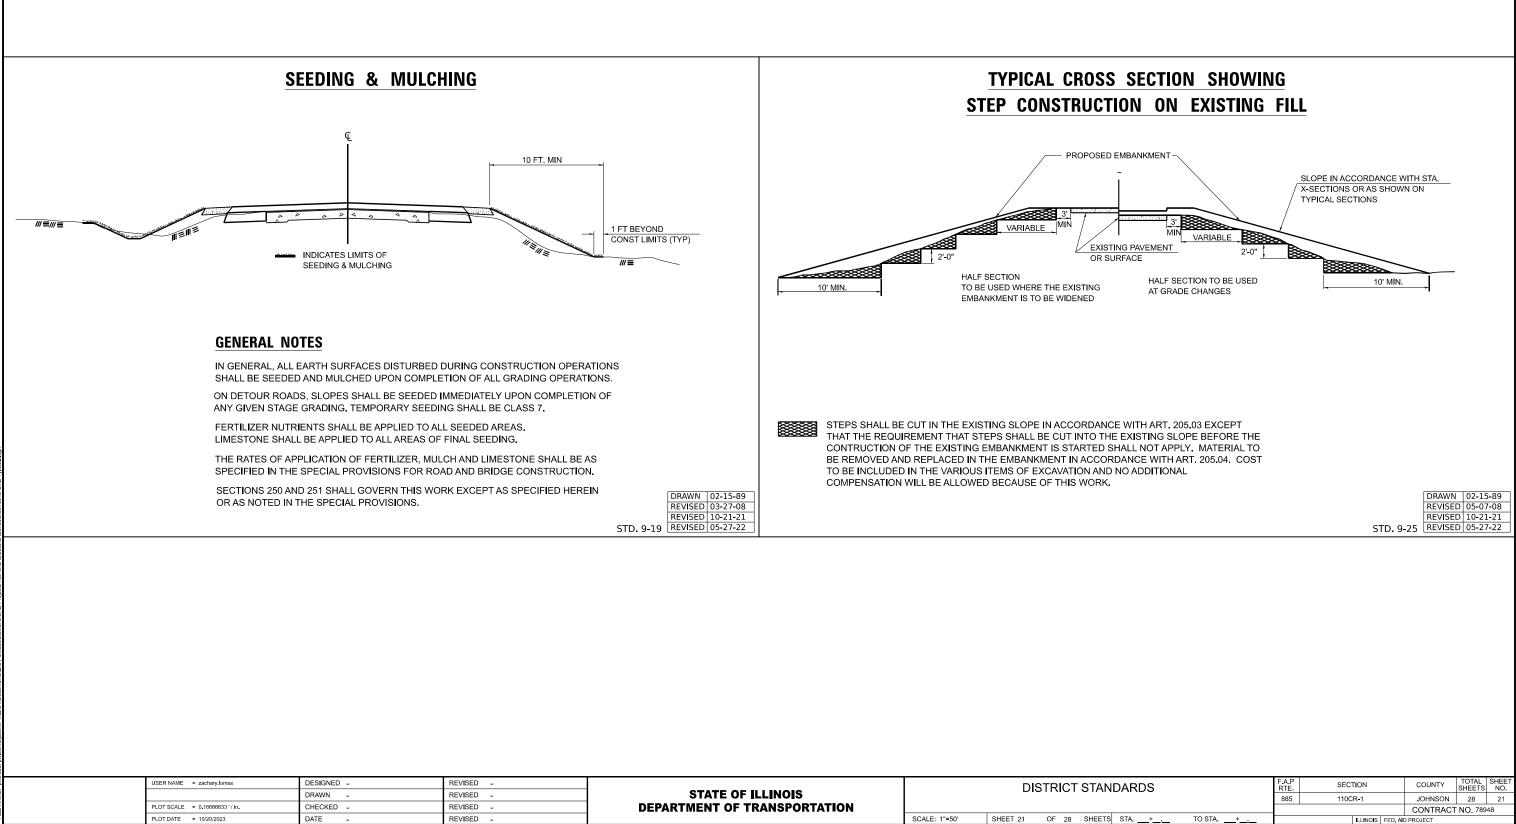

USER NAME = zachary.lomax	DESIGNED -	REVISED -		DISTRICT STAN					
	DRAWN -	REVISED -	STATE OF ILLINOIS						
PLOT SCALE = 0.16666633 ' / in.	CHECKED -	REVISED -	DEPARTMENT OF TRANSPORTATION						
PLOT DATE = 10/20/2023	DATE -	REVISED -		SCALE: 1"=50'	SHEET 21	OF 28	SHEETS	. ST/	

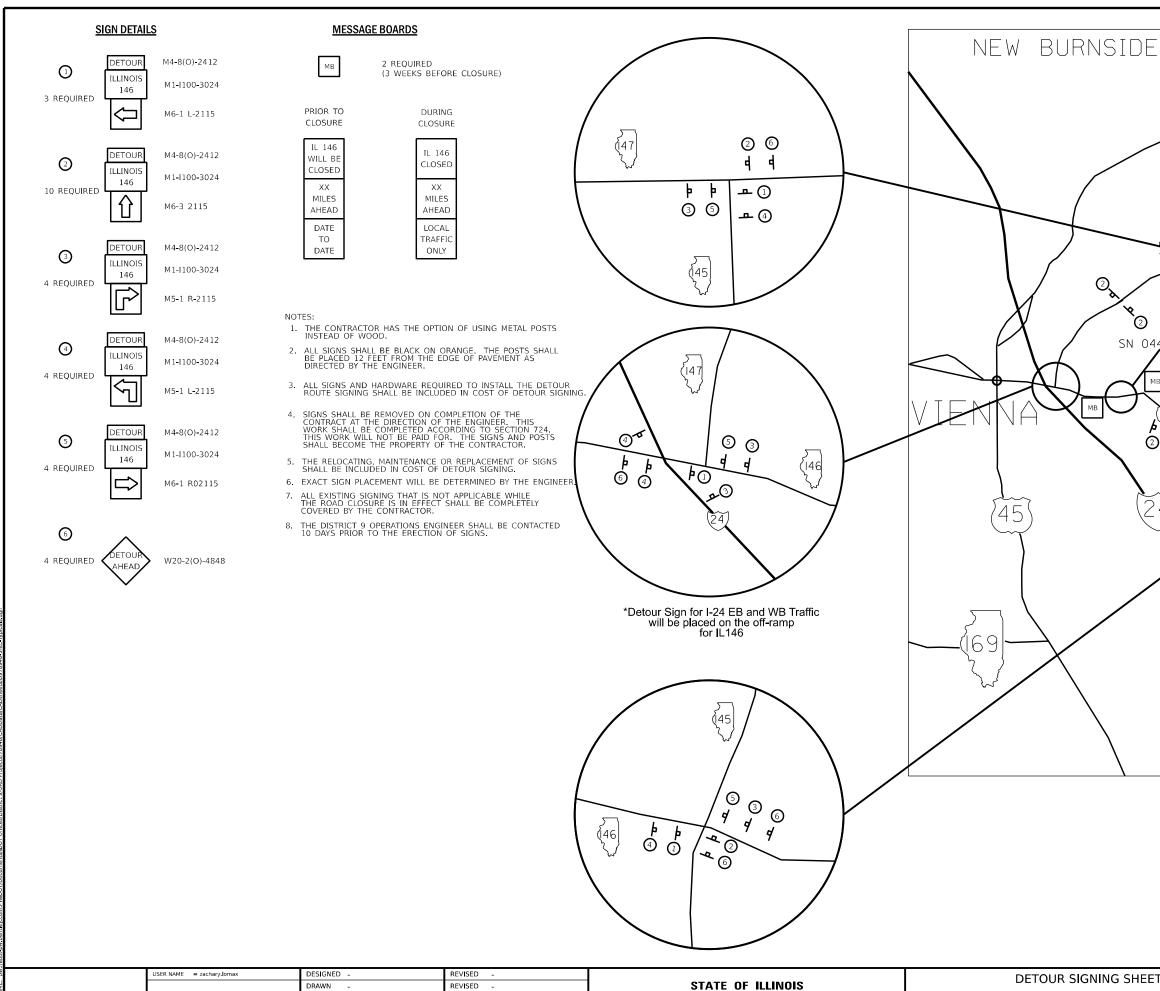

SCALENO SCALE SHEET 22 OF 28 SHEETS STA.

DEPARTMENT OF TRANSPORTATION

LOT SCALE = 0.16666633 ' / in.


LOT DATE = 1/29/2024


CHECKED

DATE

REVISED


REVISED

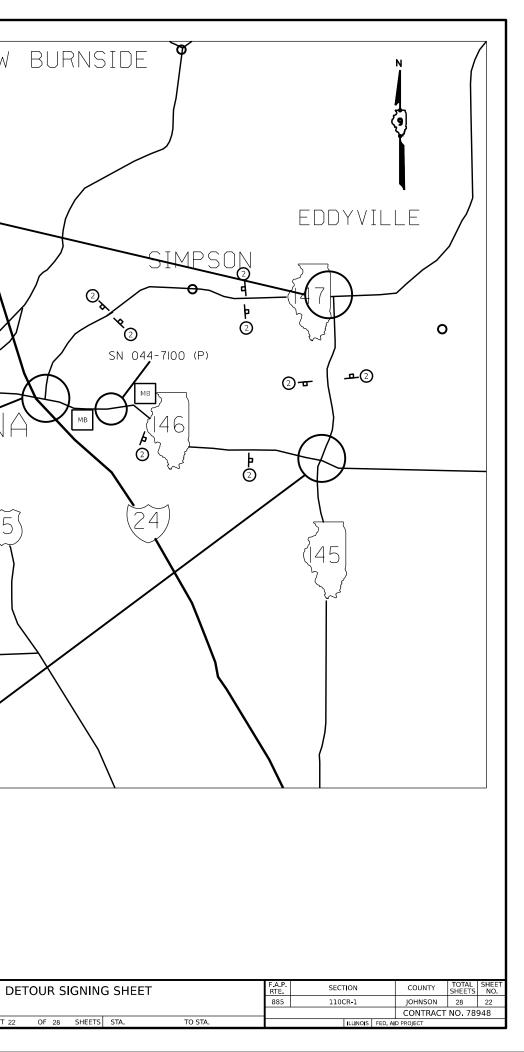


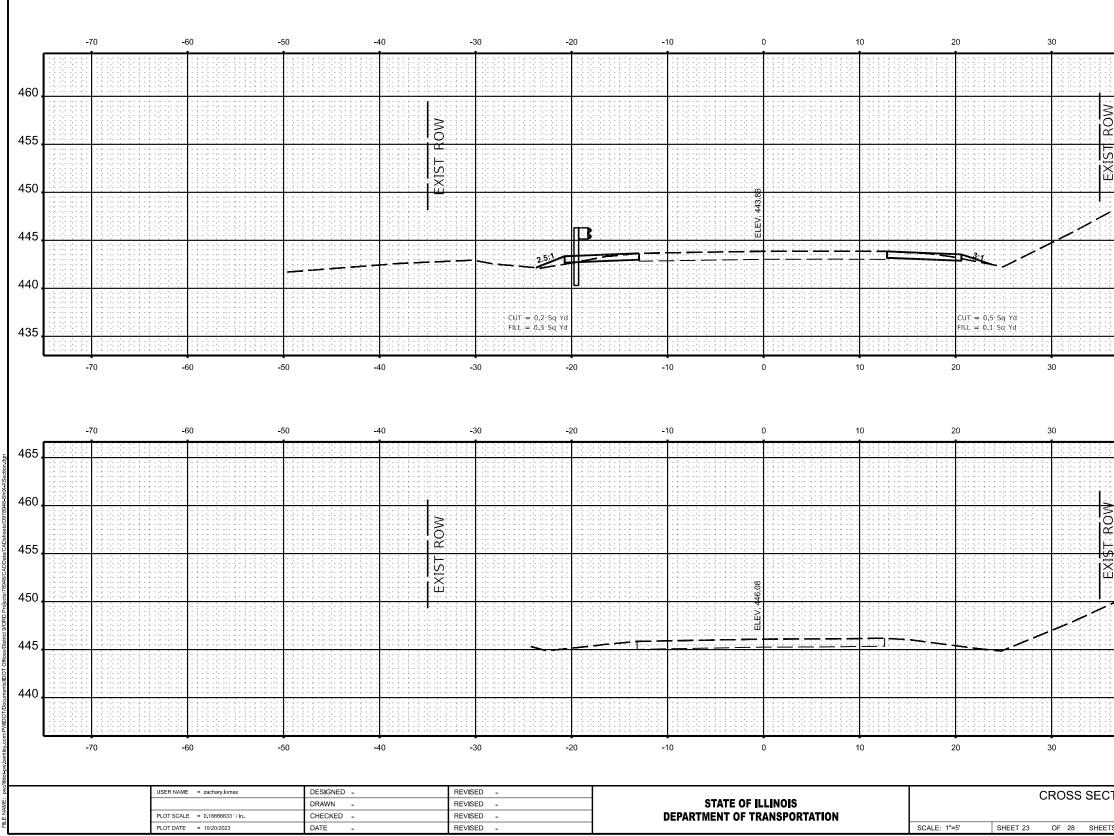


2	40	50 •	60	70					
					.460				
N N N									
<u>v</u>					. 455				
					. 450				
					. 445				
					440				
					. 435				
2	40 50 60 70 <b>STA 140+50.00</b>								
4	40	50	60	70					
4	40	50	60	70	465				
4	10	50	60	70	465				
		50	60	70	460				
		50	60	70	1 - C 2 - C    				
		50	60	70	460				
		50	60	70	460				
		50	60		. 460 . 455 . 450				
					. 460 . 455 . 450 . 445				
			60	70	. 460 . 455 . 450 . 445 . 440				
	10		60	70 STA 140+00	. 460 . 455 . 450 . 445 . 440				

CTIONS			F.A.P RTE	SECTION		COUNTY	TOTAL SHEETS	SHEET NO.	
		885	110CR-1		JOHNSON	28	23		
						CONTRACT	NO. 78	948	
TS	STA.	TO STA.		ILLINOIS FED. A			D PROJECT		

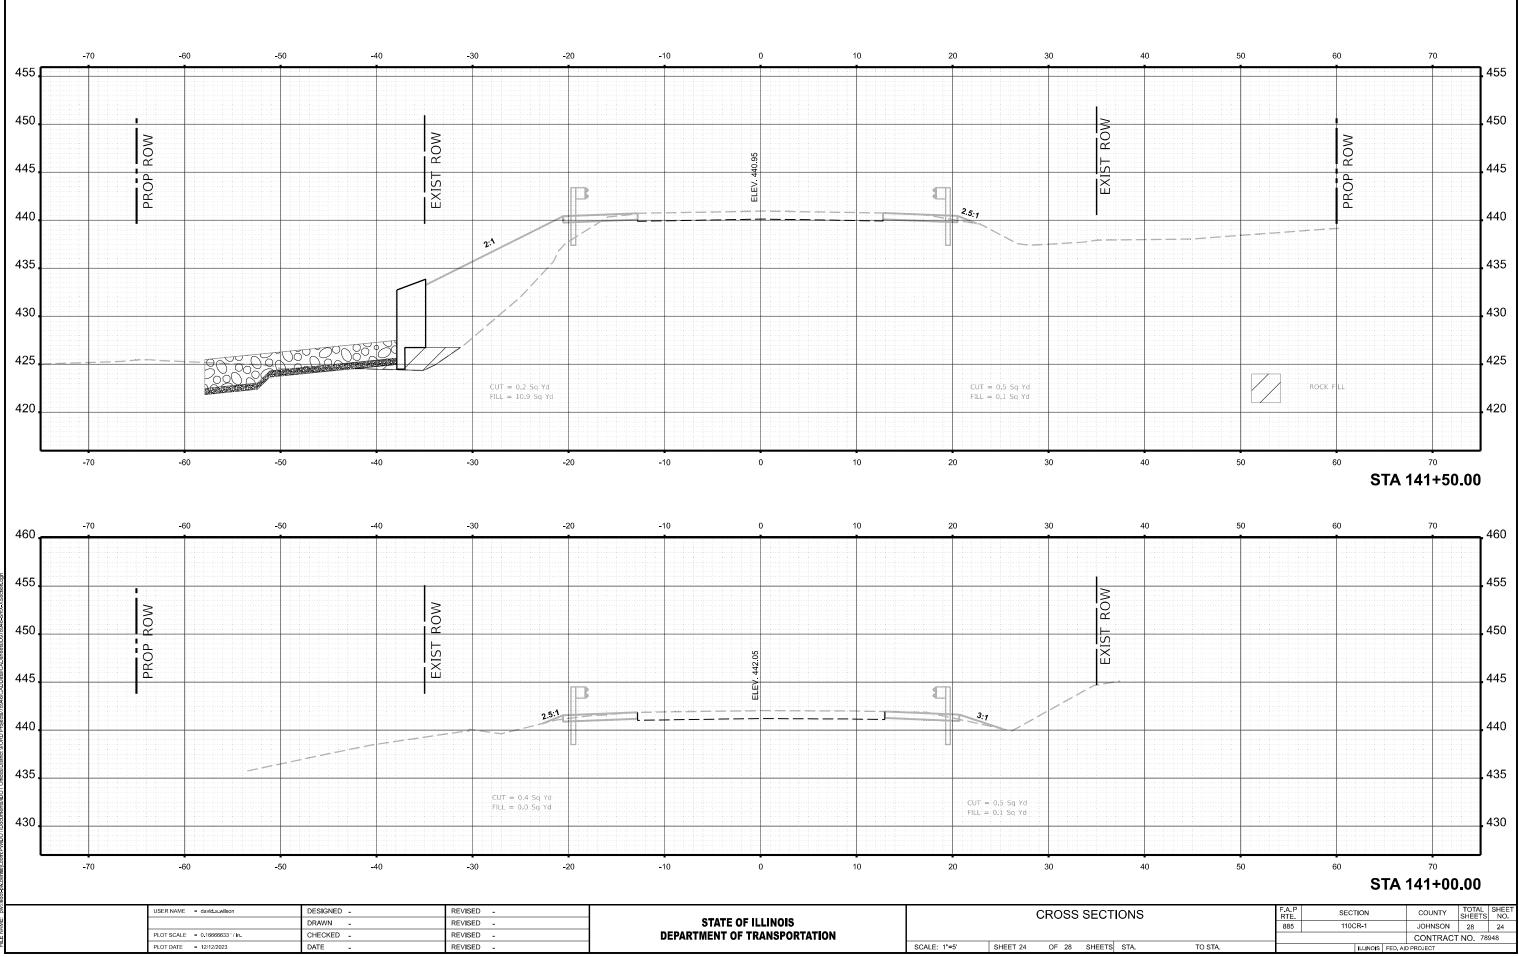


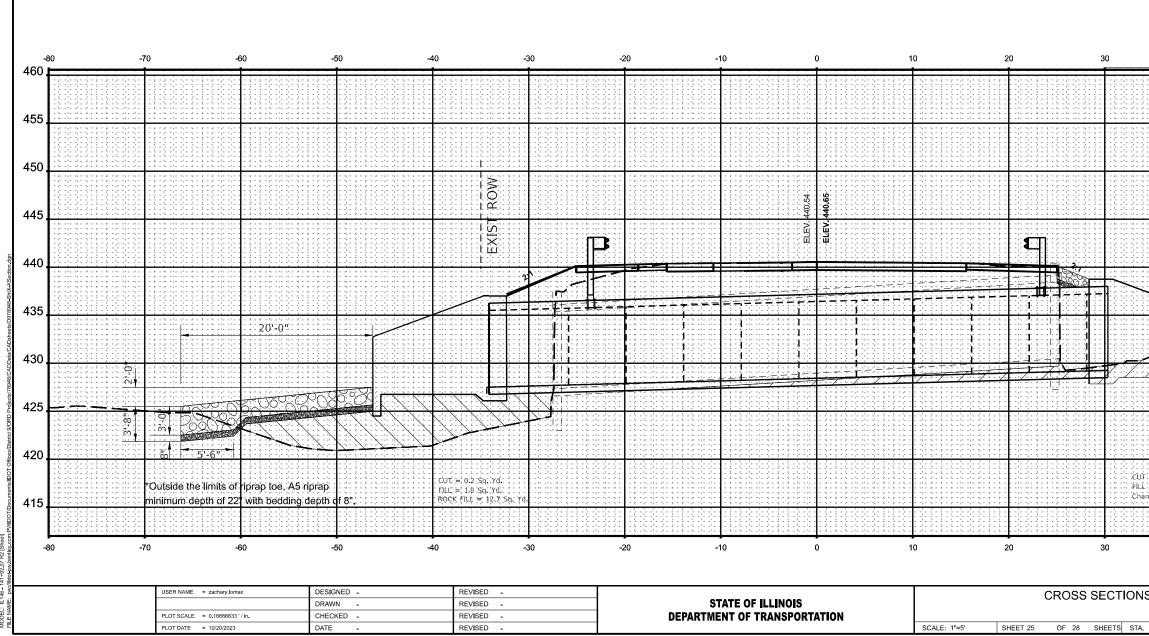


4	0	50		60	- 460			
					460			
					455			
8					450			
ST ROV					445			
EXIST					440			
	10'-0				435			
	7777		7/25		430			
		20 20			425			
		5'-6''			423			
CUT = 0.6 Sq. Yd.			ROCK FILL		420			
FILL = 0.0 Sq. Yd. Channel Ex. = 12.3	\$q. ¥d.	/	CHANNEL	EXCAVATION	415			
1	0	50		60				
40 50 STA 041+92.07 ALONG SKEW								
CTIONS		F.A.P RTE	SECTION	COUNTY	TOTAL SHEETS	SHEET NO.		
ETS STA.	TO STA.	885	110CR-1	JOHNSON CONTRA FED. AID PROJECT	N 28 CT NO. 78	25 948		
			LEINOIS					

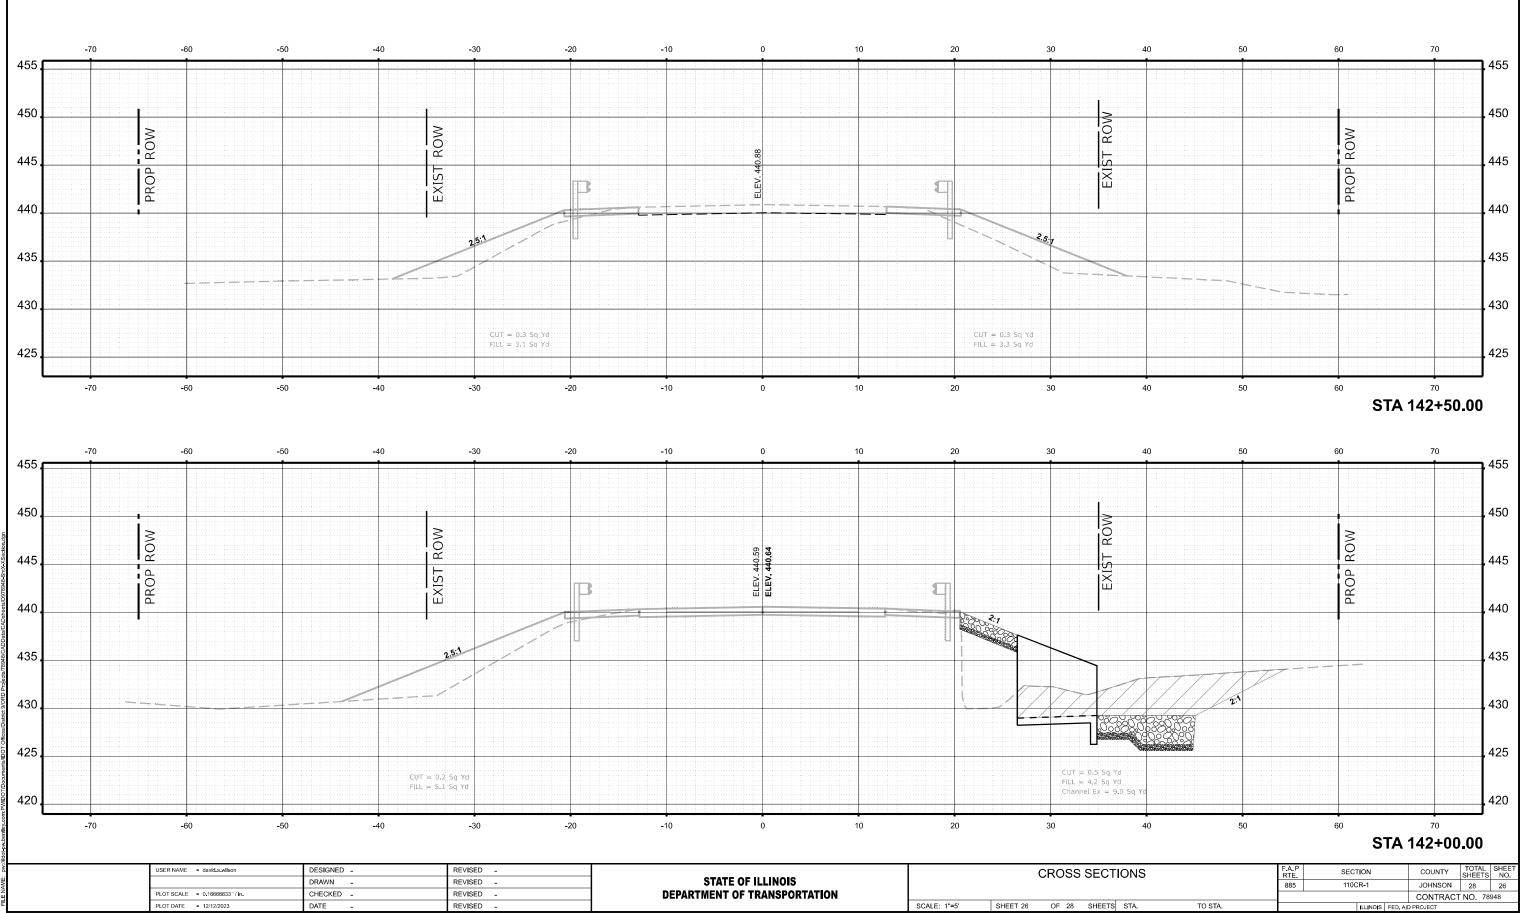

-60 -50 <del>-</del>40 -30 -10 10 30 -70 -20 0 20 455 ROW PROP ROW ROW 450 EXIST EXIST 445 3:1 440 maken inco 435 CUT = 0.2 Sq Yd FILL = 0.9 Sq Yd CUT = 0,2 Sq Yd FILL = 5,6 Sq Yd 430 -70 -60 -50 -40 -30 -20 -10 0 10 20 30 -70 -60 -50 -40 -30 -20 -10 10 20 30 0 455 ROW 450 PROP ROW ROW IST EXIST 442. 445 ΙÄ ELEV E \_\_\_\_\_ 440 3:1 435 CUT = 0.2 Sq Yd FILL = 3.0 Sq Yd CUT = 0.3 Sq Yd FILL = 3.8 Sq Yd 430 -70 -60 -50 -40 -30 -20 -10 0 10 20 30 JSER NAME = david.a.wilson DESIGNED -REVISED -CROSS SECTIONS STATE OF ILLINOIS DEPARTMENT OF TRANSPORTATION DRAWN -REVISED -PLOT SCALE = 0.16666633 ' / in. CHECKED -REVISED -LOT DATE = 12/12/2023 DATE REVISED -SCALE: 1"=5' SHEET 27 OF 28 SHEETS STA.

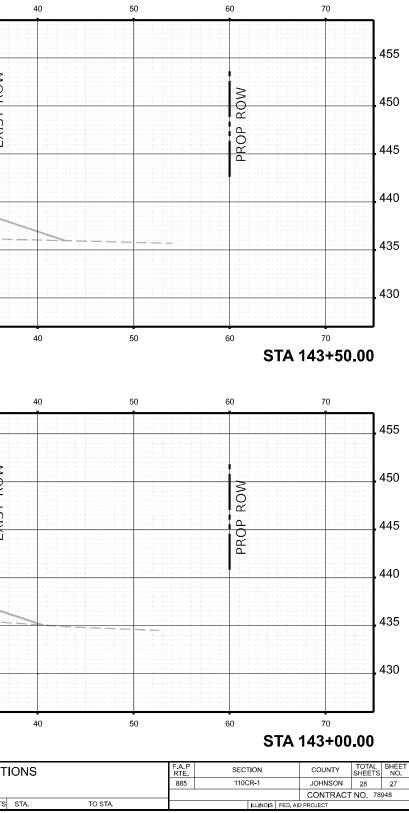

-60 -50 -40 -30 **-**20 -10 10 20 0

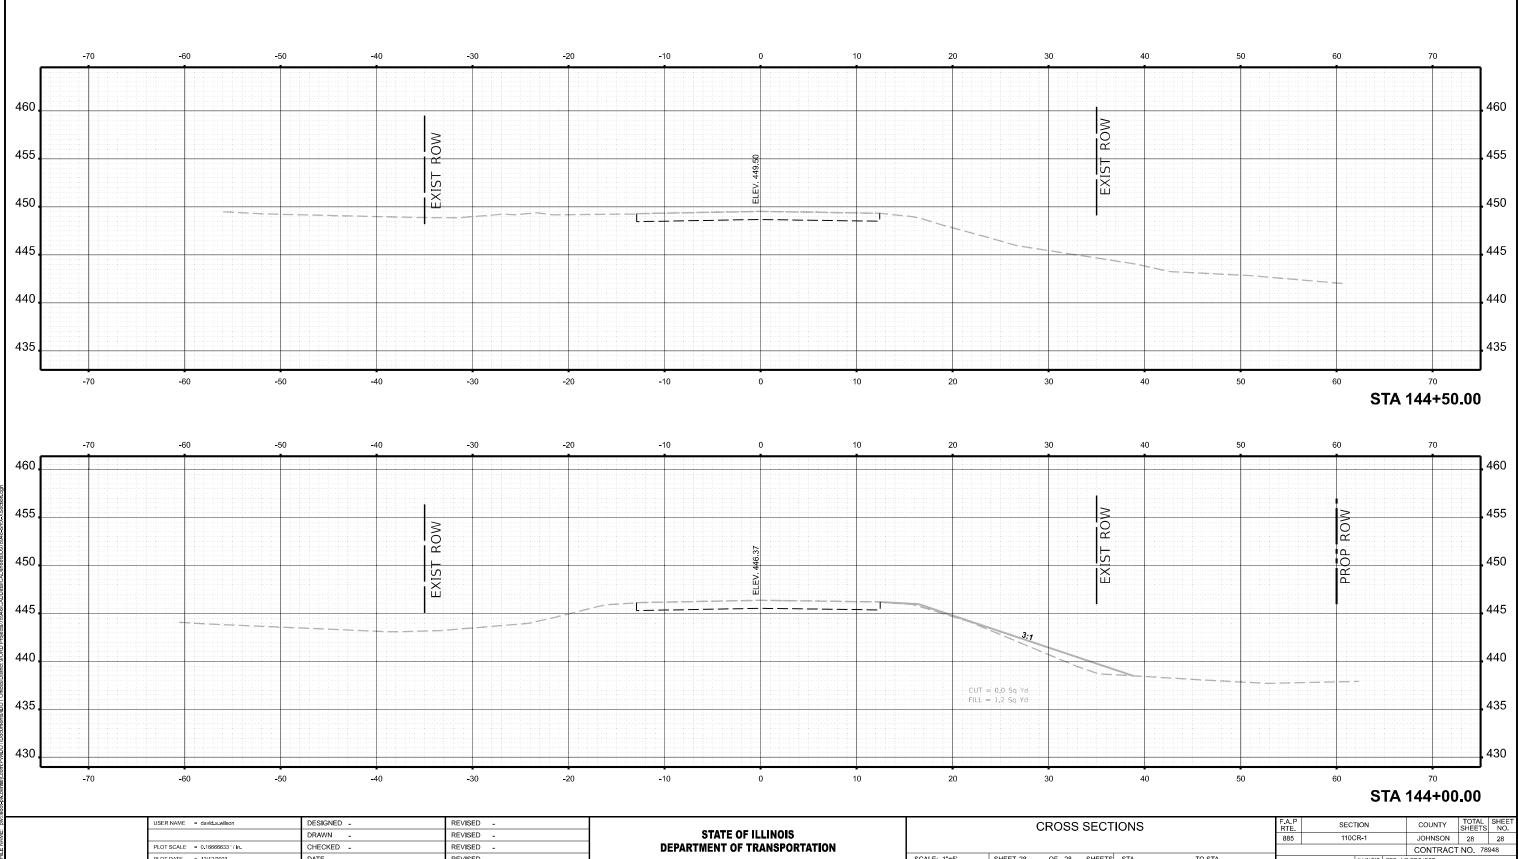

STATE OF ILLINOIS DEPARTMENT OF TRANSPORTATION LOT DATE = 12/12/2023 DATE REVISED -SCALE: 1"=5' SHEET 28 OF 28 SHEETS STA.

TO STA. ILLINOIS FEE