


F.A.P. RTE.	SECTION	COUNTY	TOTAL SHEETS	SHEET NO.
343	*	COOK	283	131
STA.		TO STA.		
FED. ROAD DIST. NO. 1		ILLINOIS FED. AID PROJECT		
* 700-Y-R & 70HB-R-1		62897		

KEY PLAN


- NOTE
- CONNECT EXISTING CIRCUITS TO NEW CONDUCTORS AT BASE OF POLE.
 - ALL PROPOSED UNIT DUCTS ARE 30MM DIA. POLYETHYLENE WITH (3) 1/C #4 & (1) 1/C #6 GND (EPR-TYPE RHW).
 - ALL PROPOSED PUSHED CONDUITS ARE 75MM DIA. RGS.
 - REFER TO IDOT DISTRICT 1 STANDARD DETAIL BE-902 FOR UPRR UNDERPASS LUMINAIRE INSTALLATION DETAILS. STANDARD DETAIL SHALL BE MODIFIED TO HAVE 3" (75MM) DIA. PVC RGCC PASS THROUGH A PENETRATION IN THE MSE WALL TO THE JUNCTION BOX EMBEDDED IN THE PARAPET WALL, INSTEAD OF DROPPING DOWN IN FRONT OF THE MSE WALL.

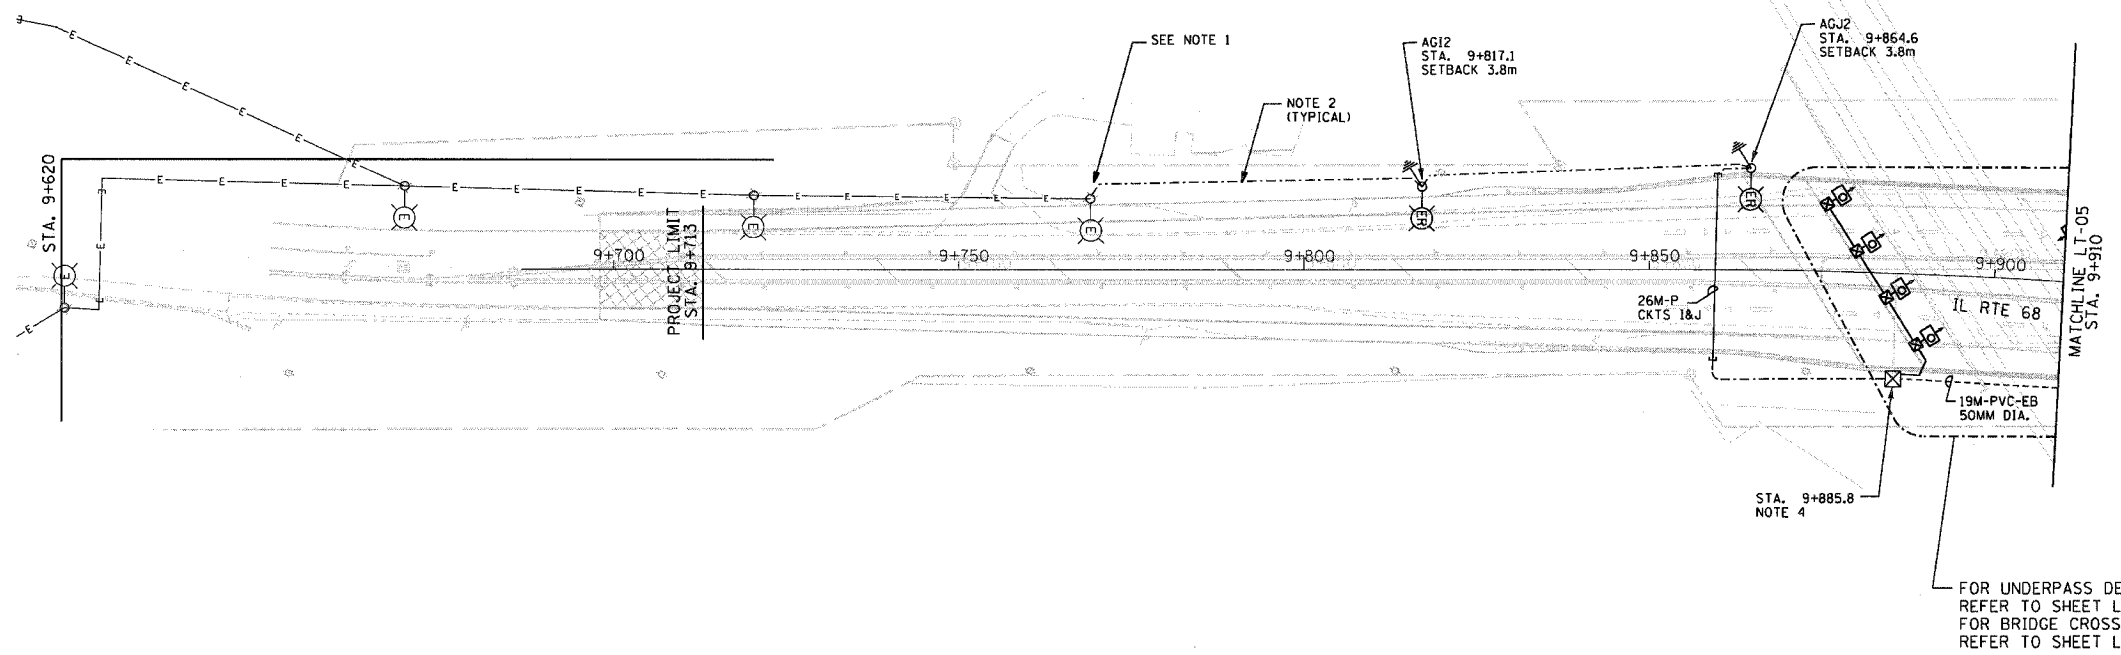

FOR UNDERPASS DETAILS REFER TO SHEET LT-18
FOR BRIDGE CROSSING DETAILS REFER TO SHEET LT-17



1 PROPOSED ROADWAY LIGHTING PLAN
SCALE: 1 : 500
5 0 5 10 15 20 25
SCALE IN METERS

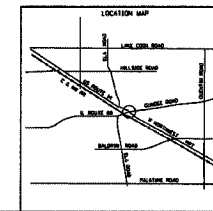

REVISIONS	
NAME	DATE

LT-06 OF 19

ILLINOIS DEPARTMENT OF TRANSPORTATION
ILLINOIS ROUTE 68 AT U.S. ROUTE 14
ROADWAY LIGHTING PROPOSED PLAN
IL 68 STA. 9+620 TO STA. 9+910

SCALE 1:500
DATE NOVEMBER 2006

DRAWN BY R.P.J.
DESIGNED BY I.B.
CHECKED BY A.D.O.

Rick Johns
ID01 - District 01
02-05-1001-STV-03 - IL 68 over US 14
P102-05-ID01-STV-03 - IL 68 over US 14
11/27/2006 3:36:53 PM 500.0000 M / M. - Proposed Plan.dgn