
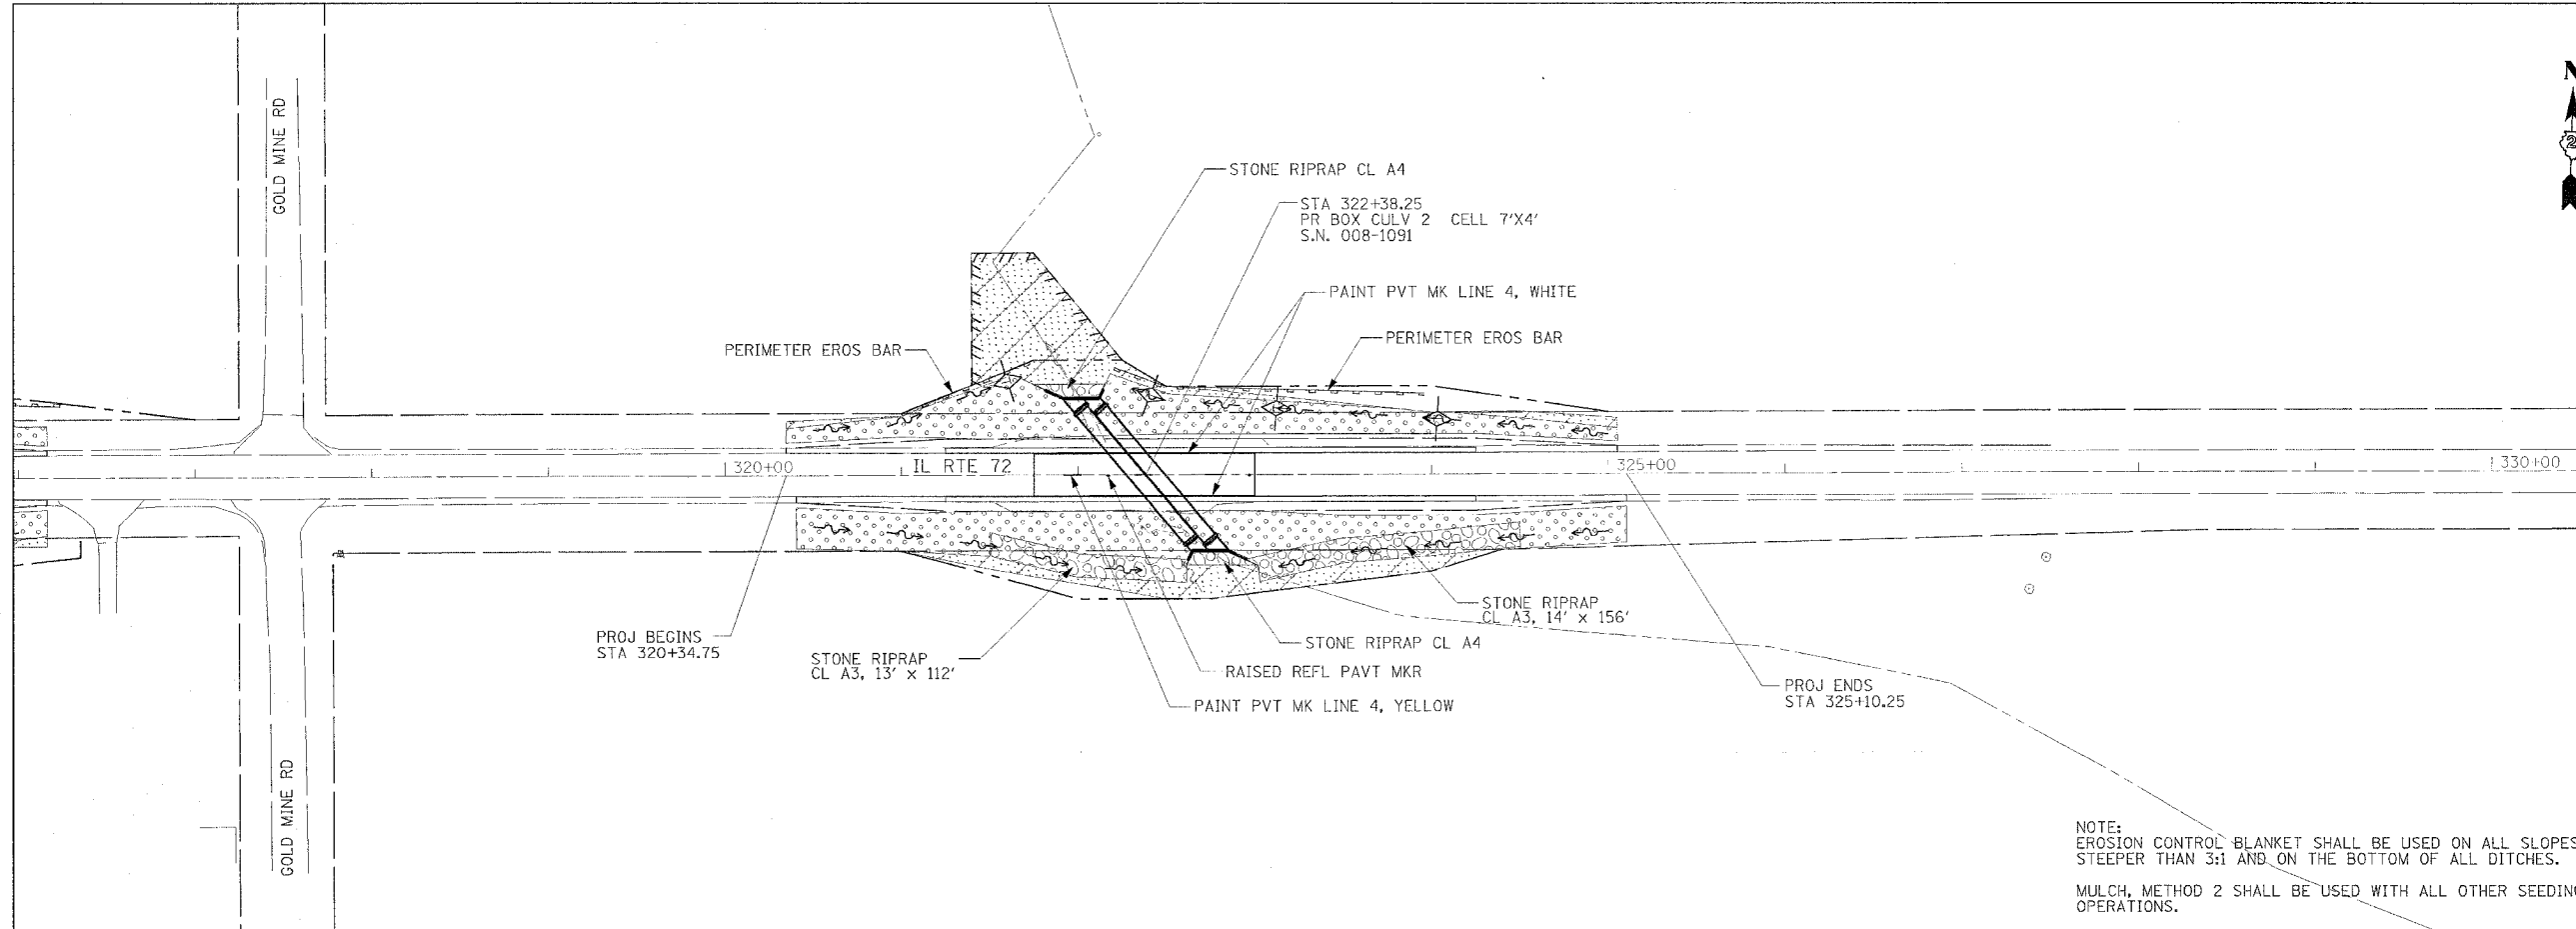


| F.A.P. RTE. | SECTION | COUNTY | TOTAL SHEETS | SHEET NO. |
|-------------|---------|--------|--------------|-----------|
| 545 | 114T-1 | | 118 | 24 |

| STA. | TO STA. |
|---------------------|---------------------------|
| FED. ROAD DIST. NO. | ILLINOIS FED. AID PROJECT |



CARROLL & OGLE

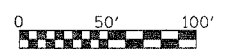

LEGEND

- SEEDING, CLASS 2A
- SEEDING, CLASS 4
- SEEDING, CLASS 1
- RIP RAP
- PR DITCH FL
- TREE TRUNK PROTECTION
- TEMP DITCH CHECKS
- INLET AND PIPE PROTECTION
- PERIMETER EROSION BARRIER

NOTE:
EROSION CONTROL BLANKET SHALL BE USED ON ALL SLOPES
STEEPER THAN 3:1 AND ON THE BOTTOM OF ALL DITCHES.
MULCH, METHOD 2 SHALL BE USED WITH ALL OTHER SEEDING
OPERATIONS.

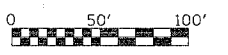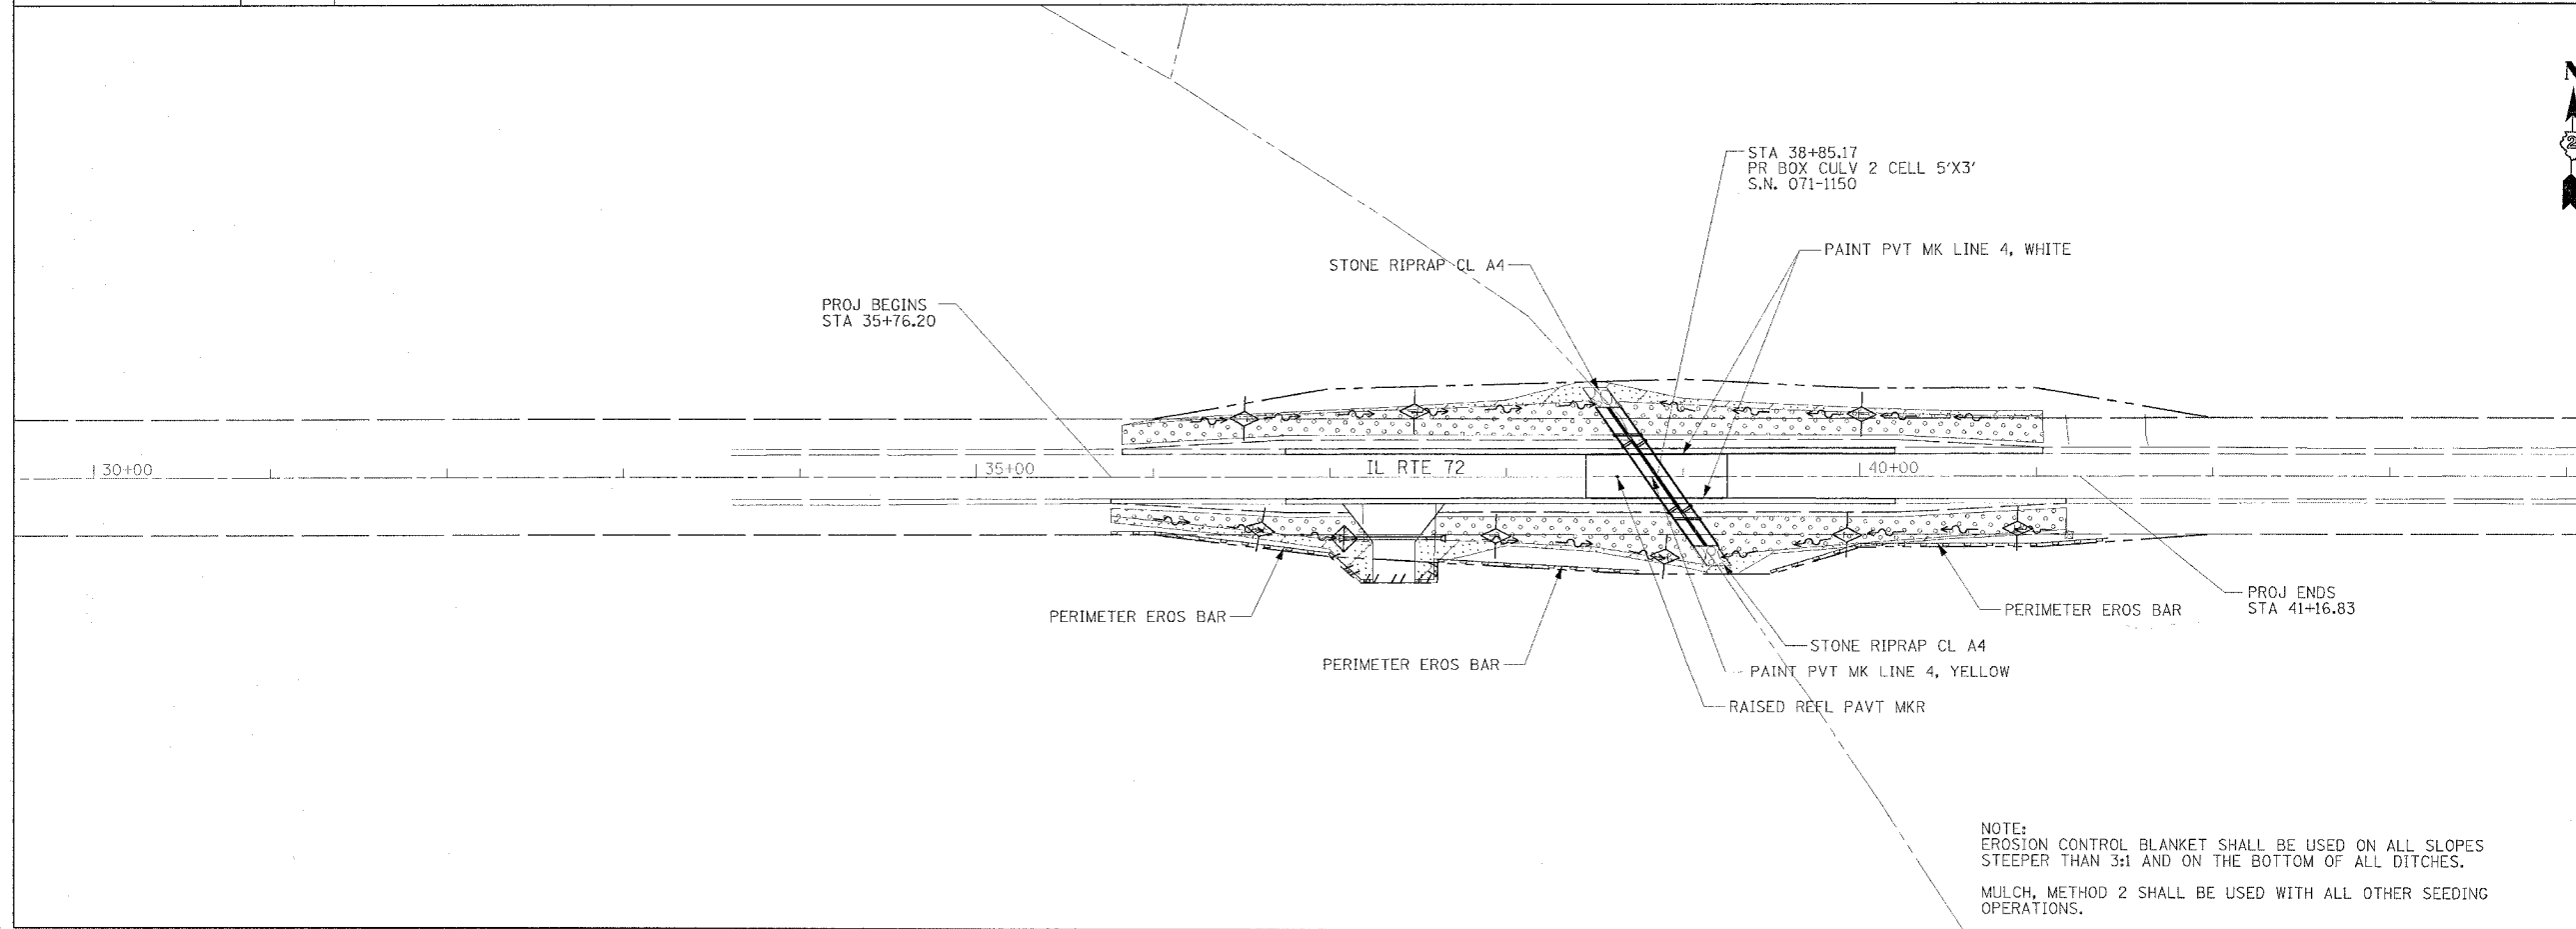

LEGEND

- SEEDING, CLASS 2A
- SEEDING, CLASS 4
- SEEDING, CLASS 1
- RIP RAP
- PR DITCH FL
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OPERATIONS.

PLOT DATE = 8/24/05
FILE NAME = #114T-1
PLOT SCALE = 1"=50'
USER NAME = JMS/STW

EROSION CONTROL AND PAVEMENT MARKINGS