


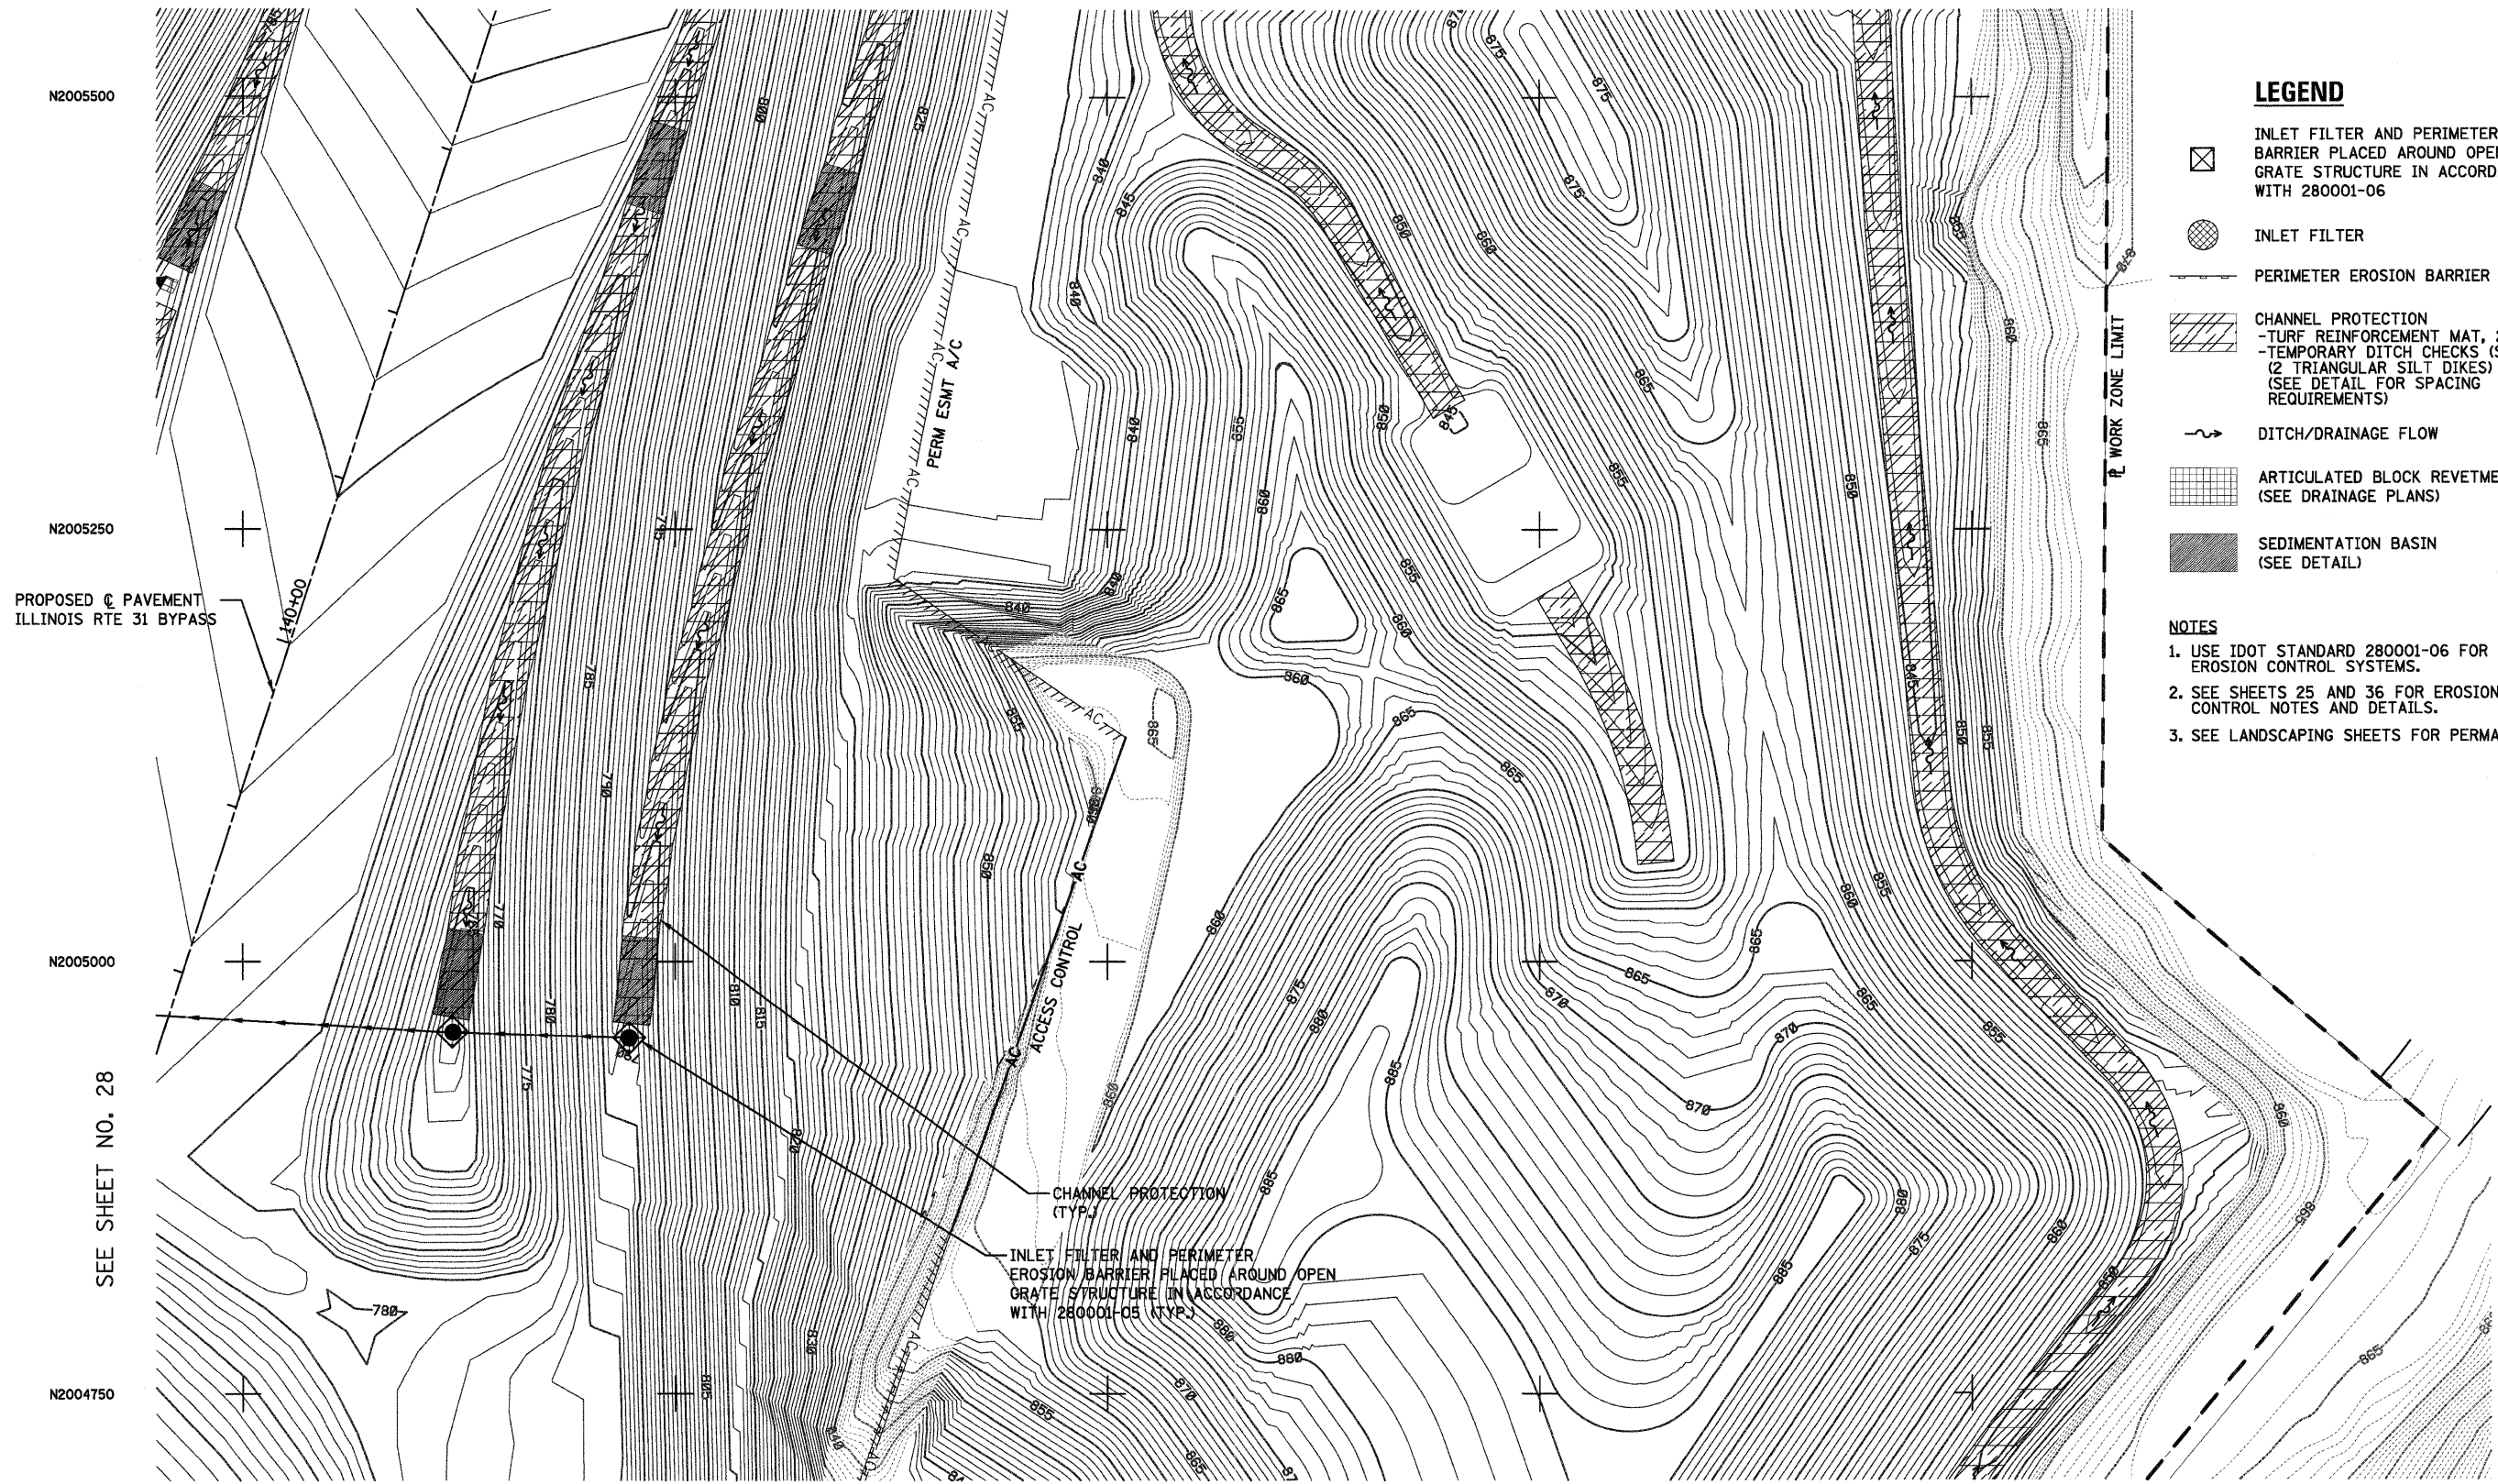


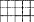



SEE SHEET NO. 31



LEGEND

-  INLET FILTER AND PERIMETER EROSION BARRIER PLACED AROUND OPEN GRATE STRUCTURE IN ACCORDANCE WITH 280001-06
-  INLET FILTER
-  PERIMETER EROSION BARRIER
-  CHANNEL PROTECTION
-TURF REINFORCEMENT MAT, 21' WIDE
-TEMPORARY DITCH CHECKS (SPECIAL)
(2 TRIANGULAR SILT DIKES)
(SEE DETAIL FOR SPACING REQUIREMENTS)
-  DITCH/DRAINAGE FLOW
-  ARTICULATED BLOCK REVETMENT MAT
(SEE DRAINAGE PLANS)
-  SEDIMENTATION BASIN
(SEE DETAIL)

NOTES

1. USE IDOT STANDARD 280001-06 FOR TYPICAL TEMPORARY EROSION CONTROL SYSTEMS.
2. SEE SHEETS 25 AND 36 FOR EROSION AND SEDIMENT CONTROL NOTES AND DETAILS.
3. SEE LANDSCAPING SHEETS FOR PERMANENT SEEDING.

N2005500

N2005250

PROPOSED PAVEMENT
ILLINOIS RTE 31 BYPASS

N2005000

SEE SHEET NO. 28

N2004750

E994500

E994750

SEE SHEET NO. 27

E995000

E995250

E995500

E995750



FILE NAME = ...\\D162F78-shr-eros-24.dgn	USER NAME = ctb	DESIGNED - DTE	REVISIONS - REVISIONS - REVISIONS - REVISIONS -	STATE OF ILLINOIS DEPARTMENT OF TRANSPORTATION		EROSION AND SEDIMENT CONTROL PLANS		F.A. RTE.	SECTION	COUNTY	TOTAL SHEETS	SHEET NO.
	PLOT SCALE = 600.0000' / Ft.	CHECKED - GAB				SCALE: 1" = 50'			18A-1	McHENRY	115	29
	PLOT DATE = 1/18/2012	DATE - 1/20/2012				SHEET NO. 5 OF 12 SHEETS					CONTRACT NO. 60F78	
ILLINOIS FED. AID PROJECT												