

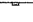

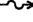
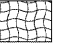



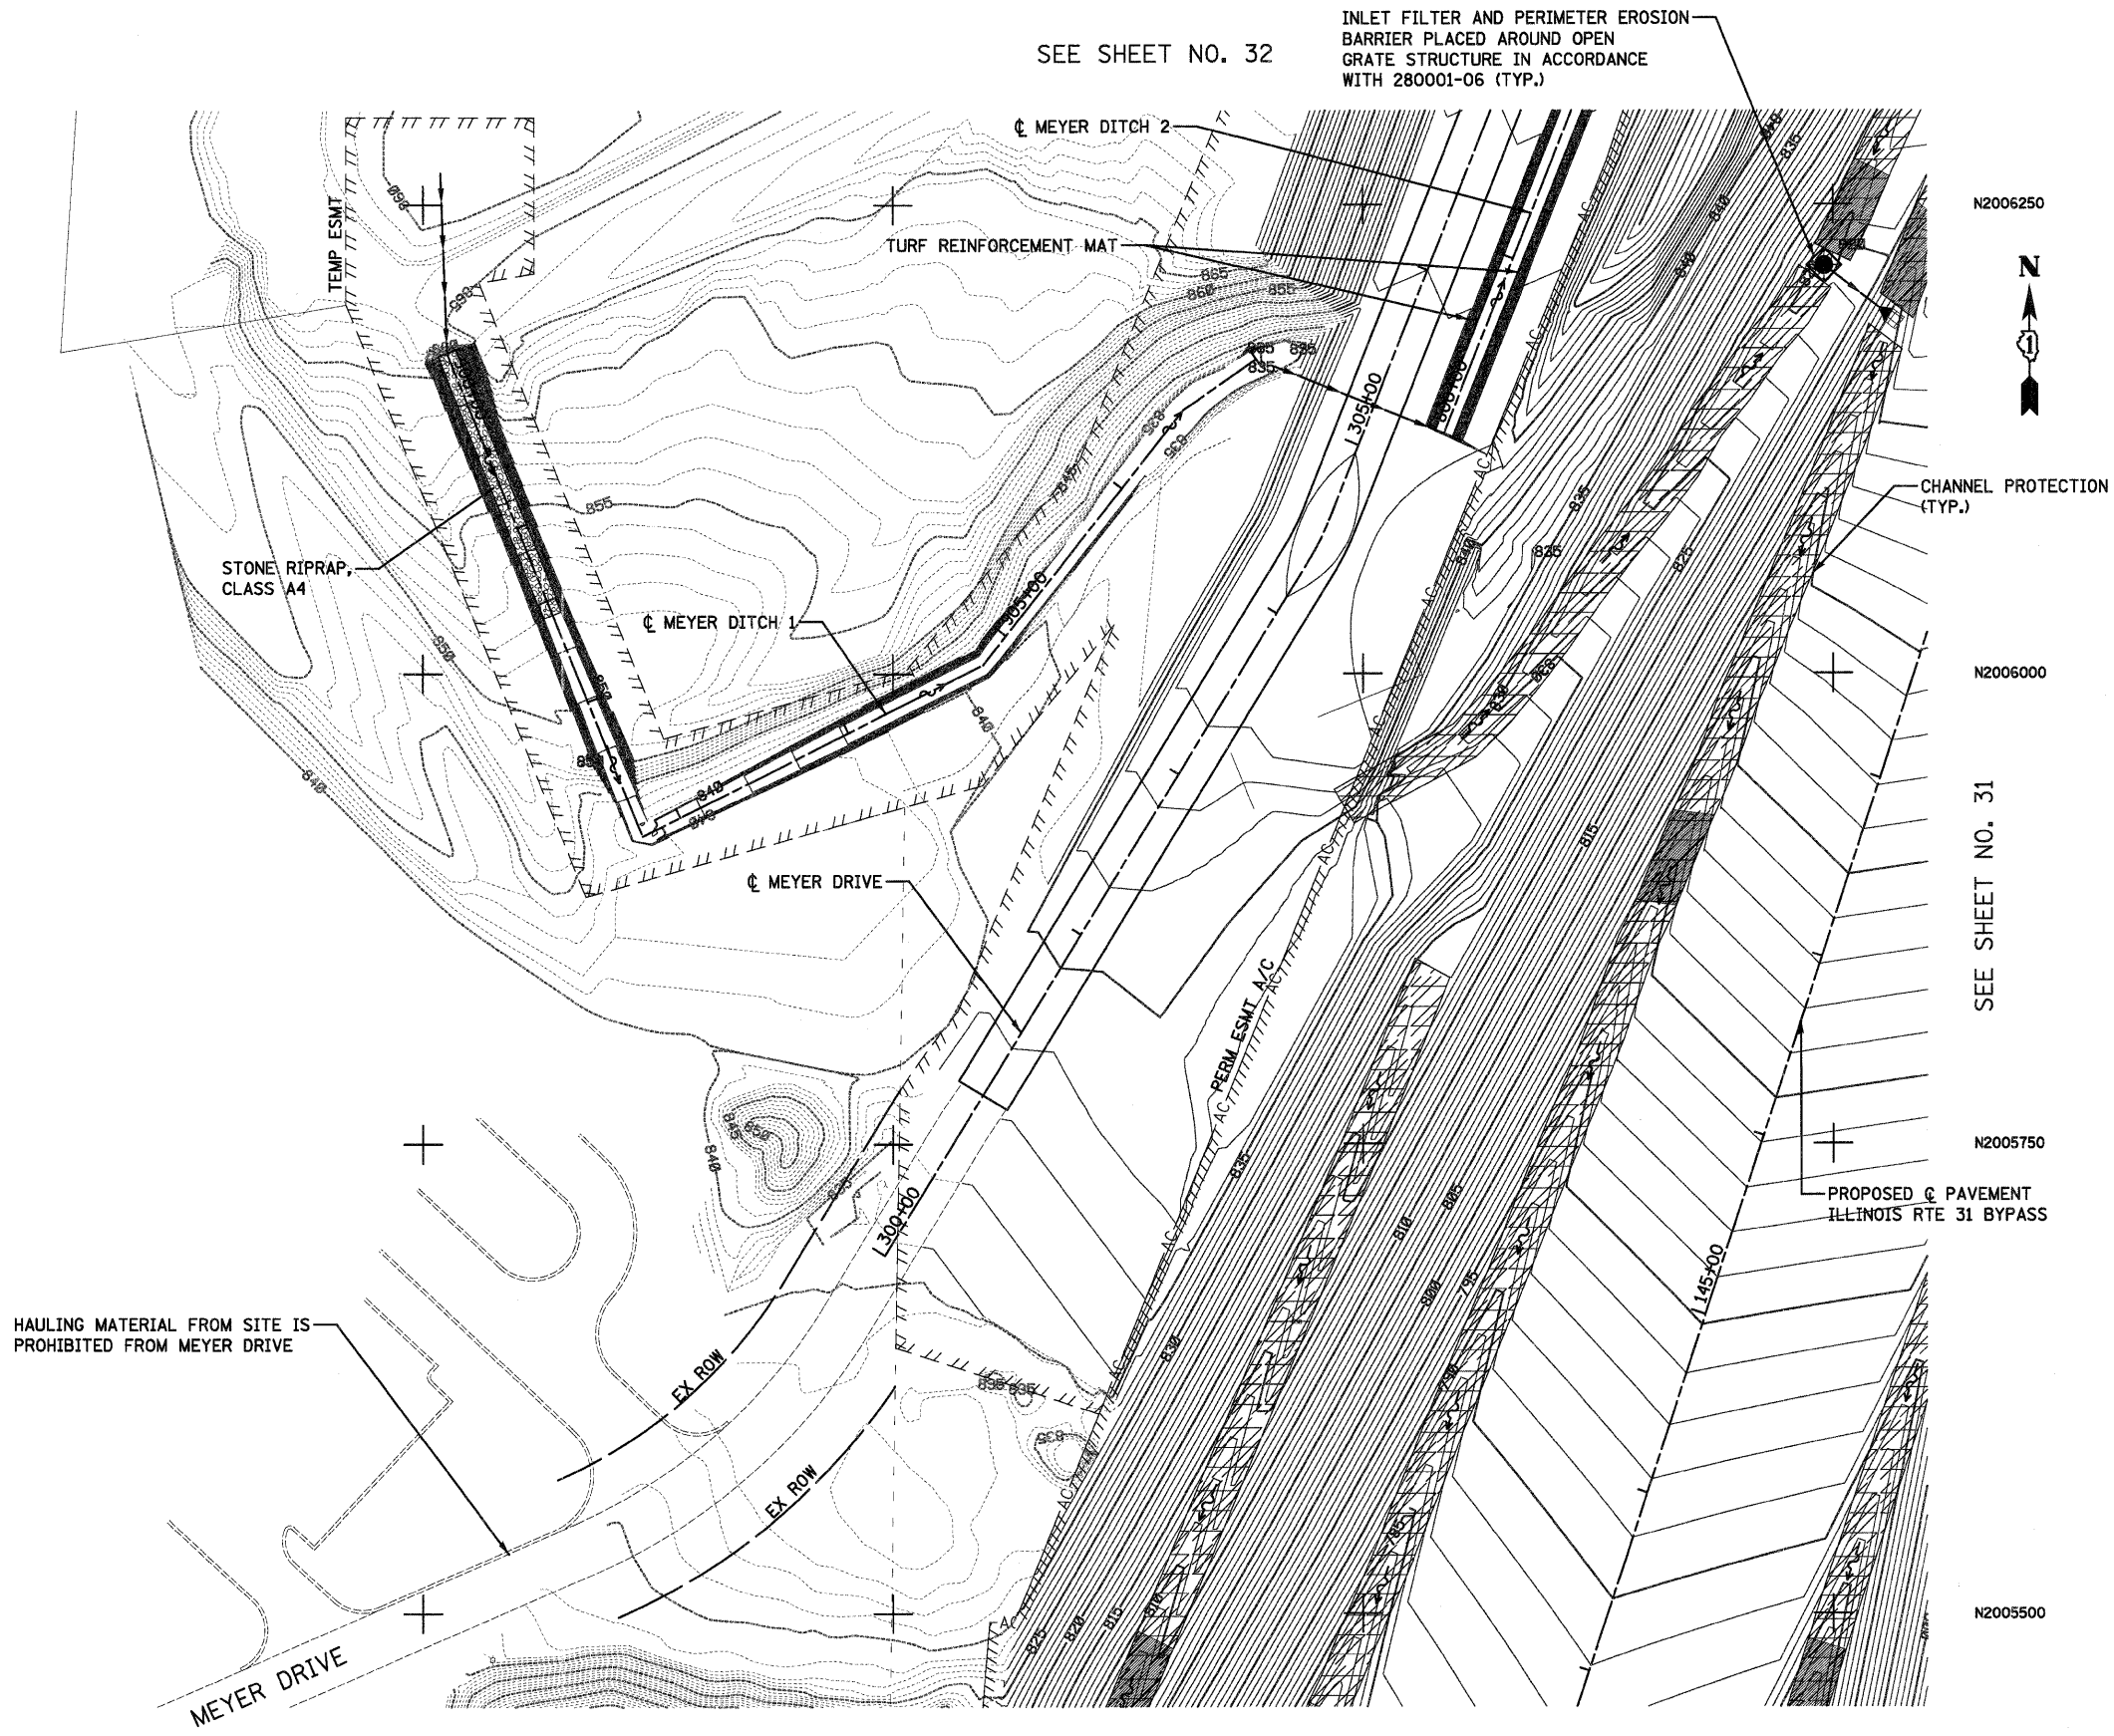


LEGEND

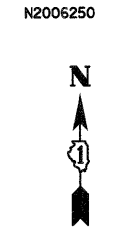
-  INLET FILTER AND PERIMETER EROSION BARRIER PLACED AROUND OPEN GRATE STRUCTURE IN ACCORDANCE WITH 280001-06
-  INLET FILTER
-  PERIMETER EROSION BARRIER
-  CHANNEL PROTECTION
-TURF REINFORCEMENT MAT, 21' WIDE
-TEMPORARY DITCH CHECKS (SPECIAL)
(2 TRIANGULAR SILT DIKES)
(SEE DETAIL FOR SPACING REQUIREMENTS)
-  DITCH/DRAINAGE FLOW
-  TURF REINFORCEMENT MAT, TO BE PLACED ONLY ALONG SIDE SLOPES
-  ARTICULATED BLOCK REVETMENT MAT (SEE DRAINAGE PLANS)
-  SEDIMENTATION BASIN (SEE DETAIL)
-  STONE RIP RAP, CLASS A4
STONE RIP RAP, CLASS A1
FILTER FABRIC

- NOTES**
1. USE IDOT STANDARD 280001-06 FOR TYPICAL TEMPORARY EROSION CONTROL SYSTEMS.
 2. SEE SHEETS 25 AND 36 FOR EROSION AND SEDIMENT CONTROL NOTES AND DETAILS.
 3. SEE LANDSCAPING SHEETS FOR PERMANENT SEEDING.



SEE SHEET NO. 32

INLET FILTER AND PERIMETER EROSION BARRIER PLACED AROUND OPEN GRATE STRUCTURE IN ACCORDANCE WITH 280001-06 (TYP.)



SEE SHEET NO. 31

HAULING MATERIAL FROM SITE IS PROHIBITED FROM MEYER DRIVE

SEE SHEET NO. 28



FILE NAME = ...\\D162F78-shr-eros-25.dgn	USER NAME = ctb	DESIGNED - DTE	REVISED -	STATE OF ILLINOIS DEPARTMENT OF TRANSPORTATION	EROSION AND SEDIMENT CONTROL PLANS	F.A. RTE.	SECTION	COUNTY	TOTAL SHEETS	SHEET NO.	
		DRAWN - DTE	REVISED -					18A-1	McHENRY	115	30
		CHECKED - GAB	REVISED -			CONTRACT NO. 60F78					
		DATE - 1/20/2012	REVISED -			ILLINOIS FED. AID PROJECT					
				SCALE: 1" = 50'		SHEET NO. 6 OF 12 SHEETS		STA. TO STA.			