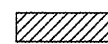
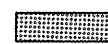
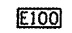
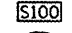



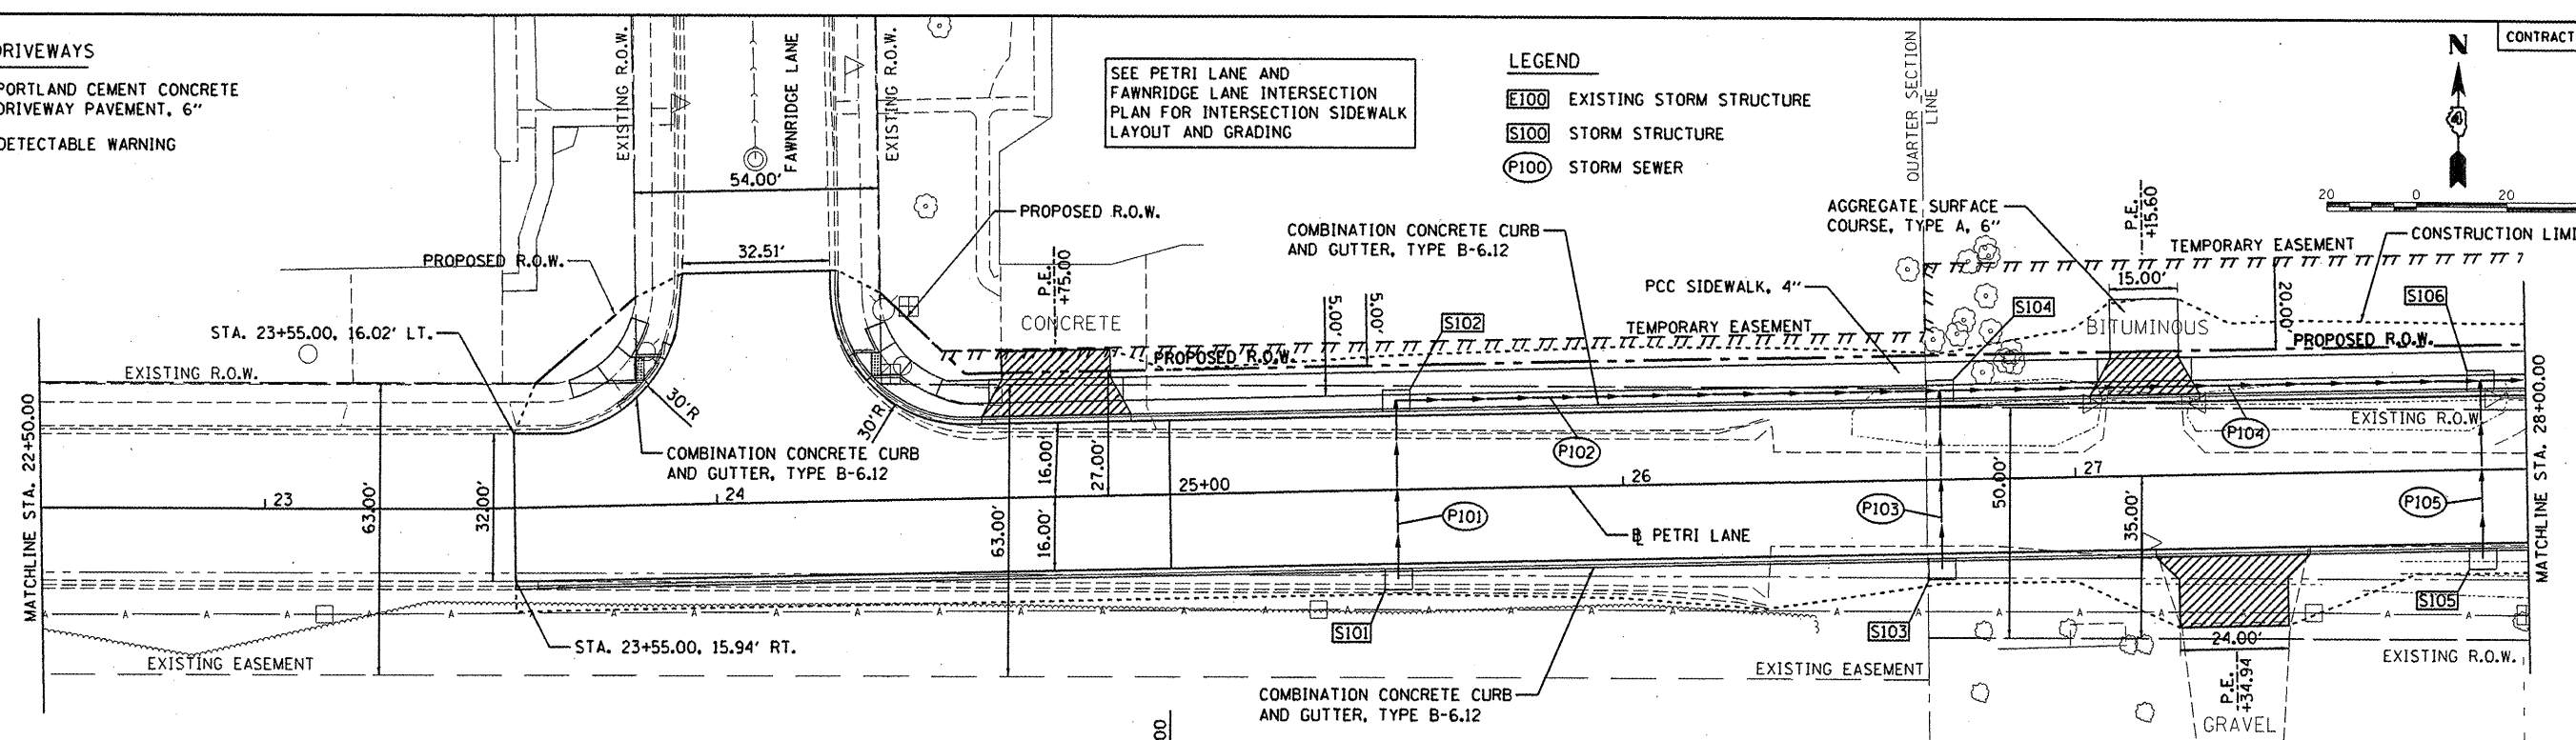
LEGEND - DRIVEWAYS

-  PORTLAND CEMENT CONCRETE DRIVEWAY PAVEMENT, 6"
-  DETECTABLE WARNING

LEGEND

-  EXISTING STORM STRUCTURE
-  STORM STRUCTURE
-  STORM SEWER


SEE PETRI LANE AND FAWNRIE LANE INTERSECTION PLAN FOR INTERSECTION SIDEWALK LAYOUT AND GRADING



PIPE NUMBER	FROM STRUCTURE	U/S INVERT	TO STRUCTURE	D/S INVERT	CLASS/TYPE	DIAMETER	LENGTH	SLOPE	TRENCH BACKFILL
P101	S101	537.70	S102	537.50	STORM SEWERS, CLASS A, TYPE 1	12	36	0.56%	4.7
P102	S102	537.50	S104	536.50	STORM SEWERS, CLASS A, TYPE 2	12	115	0.87%	39.2
P103	S103	536.70	S104	536.50	STORM SEWERS, CLASS A, TYPE 1	12	36	0.56%	4.7
P104	S104	536.50	S106	535.45	STORM SEWERS, CLASS A, TYPE 2	12	115	0.91%	36.8
P105	S105	535.65	S106	535.45	STORM SEWERS, CLASS A, TYPE 1	12	36	0.56%	4.7

STRUCTURE NUMBER	STATION	OFFSET	RIM ELEV	TYPE	INVERT ELEVATIONS			
					N	S	E	W
S101	25+50.00	19.33	RT	541.37				
S102	25+50.00	19.33	LT	541.37	537.50	537.50		
S103	26+70.00	19.33	RT	540.20	536.70			
S104	26+70.00	19.33	LT	540.20	536.50	536.50	536.50	
S105	27+90.00	19.33	RT	539.03	535.65			
S106	27+90.00	19.33	LT	539.03	535.45	535.45	535.45	

WIDENING OVERLAY FULL RECONSTRUCT

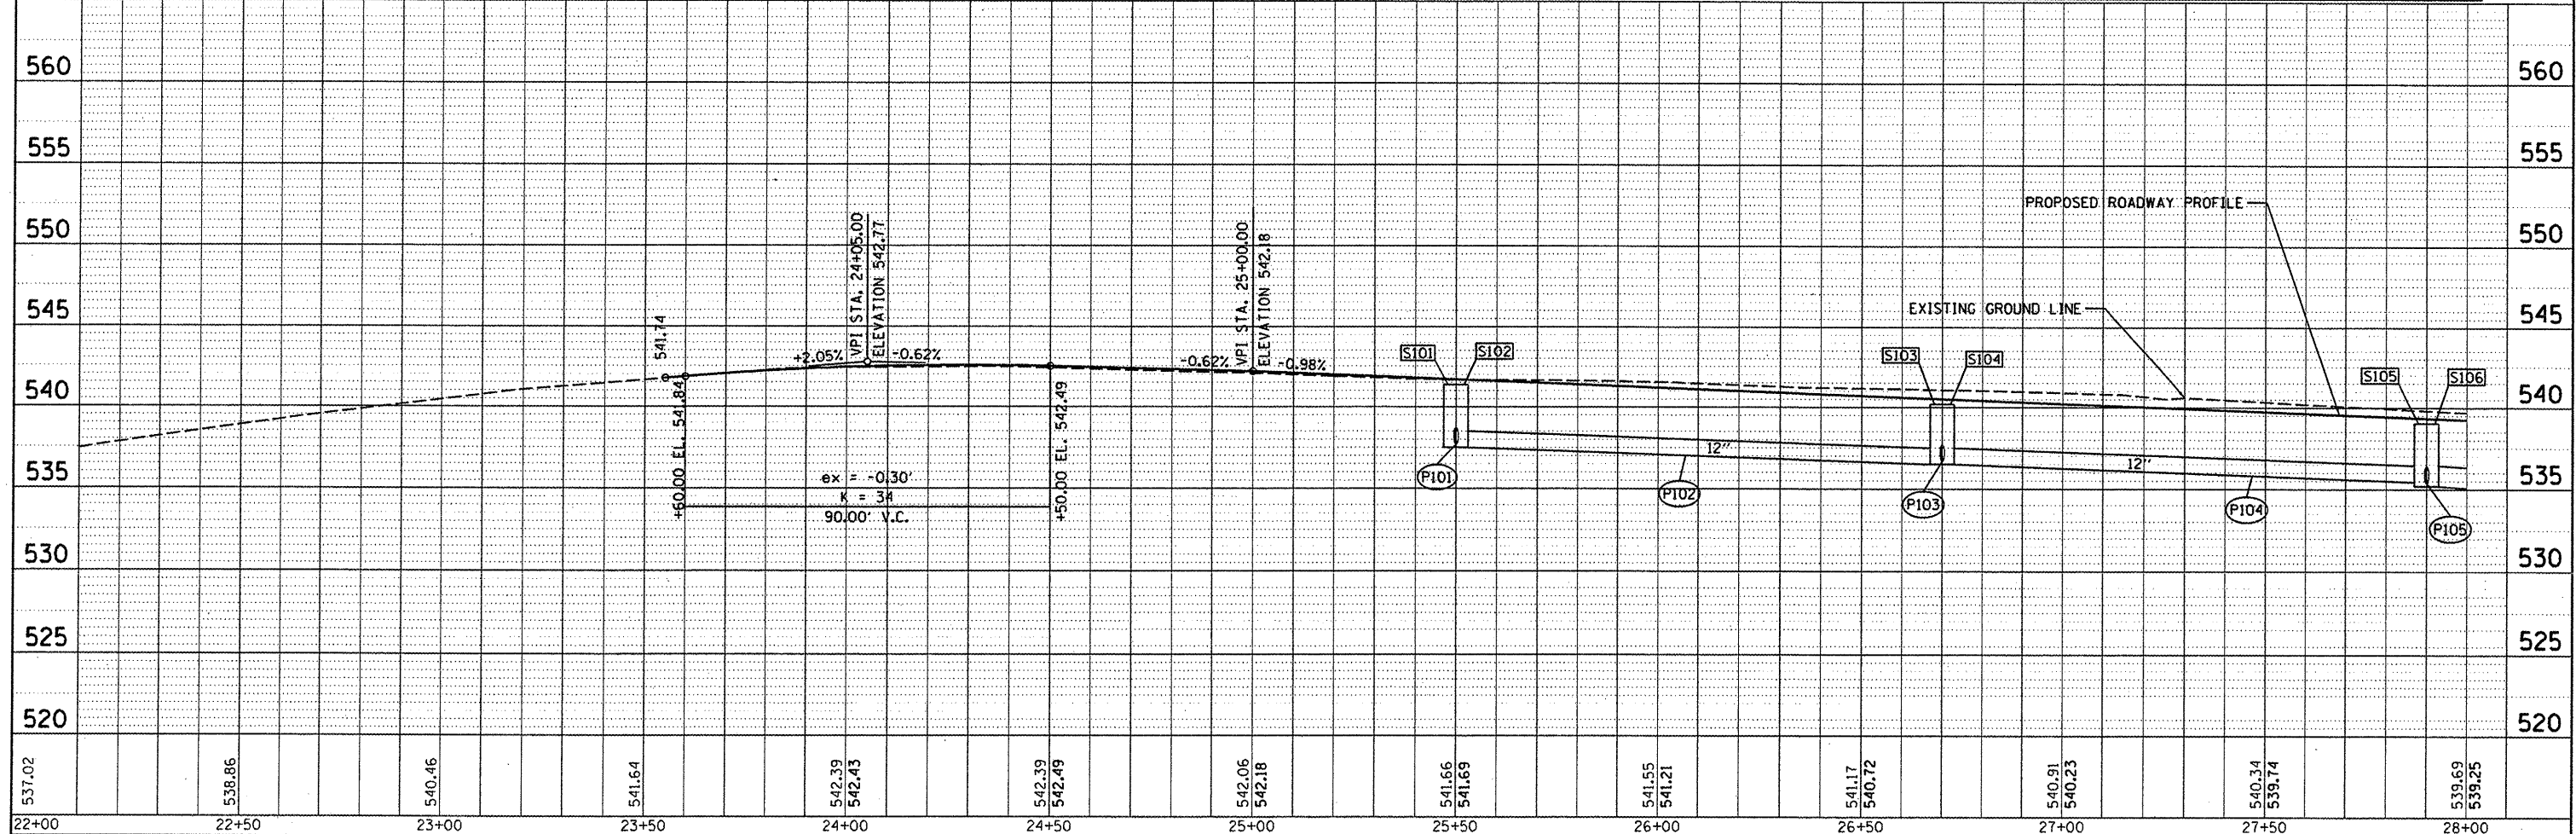

537.02	538.86	540.46	541.64	542.39	542.43	542.39	542.49	542.06	542.18	541.66	541.69	541.55	541.21	541.17	540.72	540.91	540.23	540.34	539.74	539.69	539.25
22+00	22+50	23+00	23+50	24+00	24+50	25+00	25+50	26+00	26+50	27+00	27+50	28+00									

STATE OF ILLINOIS DEPARTMENT OF TRANSPORTATION

PETRI LANE PLAN AND PROFILE

SCALE: 1"=20' SHEET NO. OF SHEETS STA. 22+50.00 TO STA. 28+00.00

F.A.U. RTE. 6698	SECTION 10-00183-00-FP	COUNTY TAZEWELL	TOTAL SHEETS 81	SHEET NO. 29
CONTRACT NO. 89595				
ILLINOIS FED. AID PROJECT M-5093 (154)				

PLAN SURVEYED BY DATE  
 PLOTTED BY DATE  
 CHECKED BY DATE  
 NOTE BOOK NO. OF PAGES CHECKED  
 CAD FILE NAME

PROFILE SURVEYED BY DATE  
 PLOTTED BY DATE  
 CHECKED BY DATE  
 NOTE BOOK NO. OF PAGES CHECKED  
 STRUCTURE NOTATION: CPFD