


- LEGEND**
- E100 EXISTING STORM STRUCTURE
 - S100 STORM STRUCTURE
 - P100 STORM SEWER

SEE DETENTION BASIN GRADING AND DETAILS SHEET

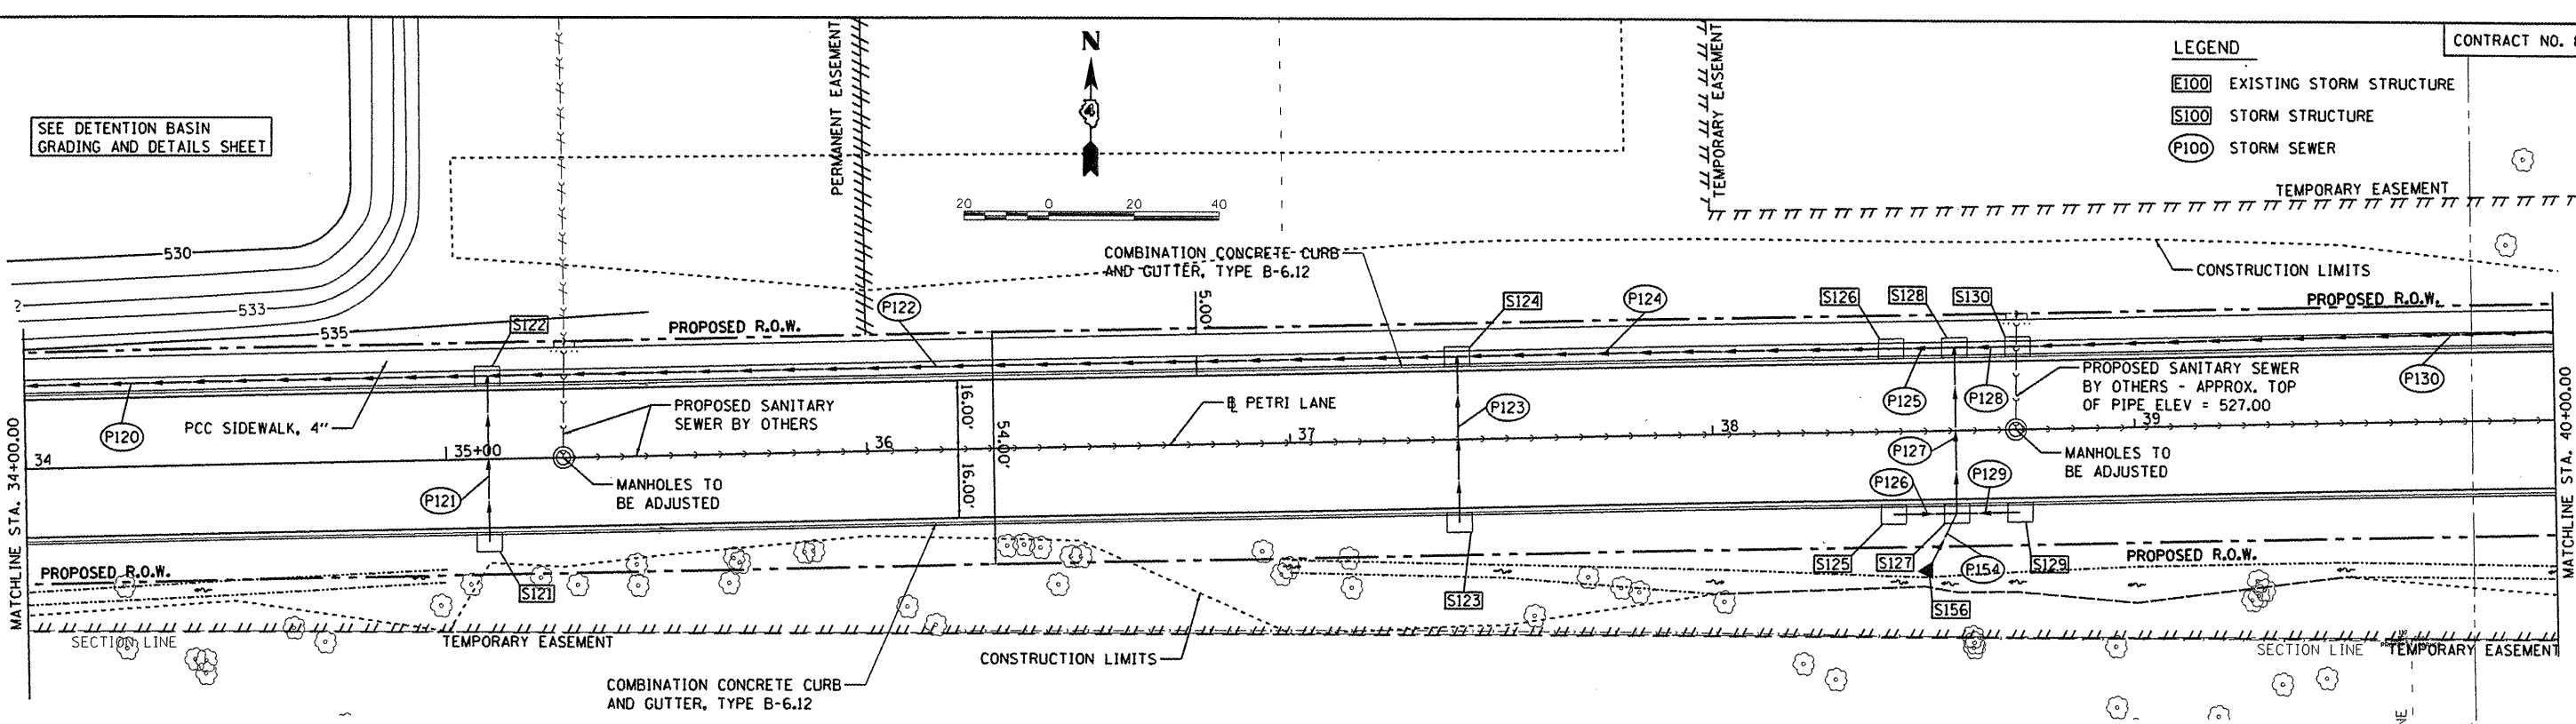


PIPE NUMBER	FROM STRUCTURE	U/S INVERT	TO STRUCTURE	D/S INVERT	CLASS/TYPE	DIAMETER	LENGTH	SLOPE	TRENCH BACKFILL
P120	S122	531.53	S120	531.14	STORM SEWERS, CLASS A, TYPE 2	18	132	0.30%	43.8
P121	S121	532.40	S122	531.69	STORM SEWERS, CLASS A, TYPE 1	12	36	2.00%	5.4
P122	S124	532.20	S122	531.63	STORM SEWERS, CLASS A, TYPE 2	18	225	0.30%	145.6
P123	S123	533.10	S124	532.88	STORM SEWERS, CLASS A, TYPE 1	12	36	0.62%	4.7
P124	S126	532.58	S124	532.20	STORM SEWERS, CLASS A, TYPE 2	18	98	0.39%	37.5
P125	S128	532.70	S126	532.58	STORM SEWERS, CLASS A, TYPE 2	18	10	1.20%	3.1
P126	S125	533.35	S127	533.28	STORM SEWERS, CLASS A, TYPE 2	12	10	0.70%	2.6
P127	S127	533.28	S128	533.08	STORM SEWERS, CLASS A, TYPE 1	12	36	0.56%	4.7
P128	S130	533.10	S128	532.95	STORM SEWERS, CLASS A, TYPE 2	15	10	1.50%	2.6
P129	S129	533.35	S127	533.28	STORM SEWERS, CLASS A, TYPE 2	12	10	0.70%	2.6
P130	S132	536.80	S130	533.10	STORM SEWERS, CLASS A, TYPE 2	15	240	1.54%	67.7
P154	S156	533.60	S127	533.40	STORM SEWERS, CLASS A, TYPE 1	12	15	1.33%	3.2

STRUCTURE NUMBER	STATION	OFFSET	RIM ELEV	TYPE	INVERT ELEVATIONS			
					N	S	E	W
S121	35+10.00	19.33	RT	536.08				
S122	35+10.00	19.33	LT	536.08	532.40	531.69	531.53	531.53
S123	37+40.00	19.33	RT	536.94	533.10			
S124	37+40.00	19.33	LT	536.94		532.88	532.20	532.20
S125	38+42.60	19.33	RT	536.25			533.35	
S126	38+42.60	19.33	LT	536.25		532.58	532.58	532.58
S127	38+57.60	19.33	RT	536.23	533.28	533.40	533.28	533.28
S128	38+57.60	19.33	LT	536.23		533.08	532.95	532.70
S129	38+72.60	19.33	RT	536.25			533.35	
S130	38+72.60	19.33	LT	536.25			533.10	533.10
S156	38+50.00	33.66	RT	n/a	533.60			

- LEGEND - DRIVEWAYS**
- PORTLAND CEMENT CONCRETE DRIVEWAY PAVEMENT, 6"
 - DETECTABLE WARNING

DATE: _____
 BY: _____
 SURVEYED: _____
 PLOTTED: _____
 CHECKED: _____
 NO. _____
 PLAN: _____

DATE: _____
 BY: _____
 SURVEYED: _____
 PLOTTED: _____
 CHECKED: _____
 NO. _____
 PROFILE: _____

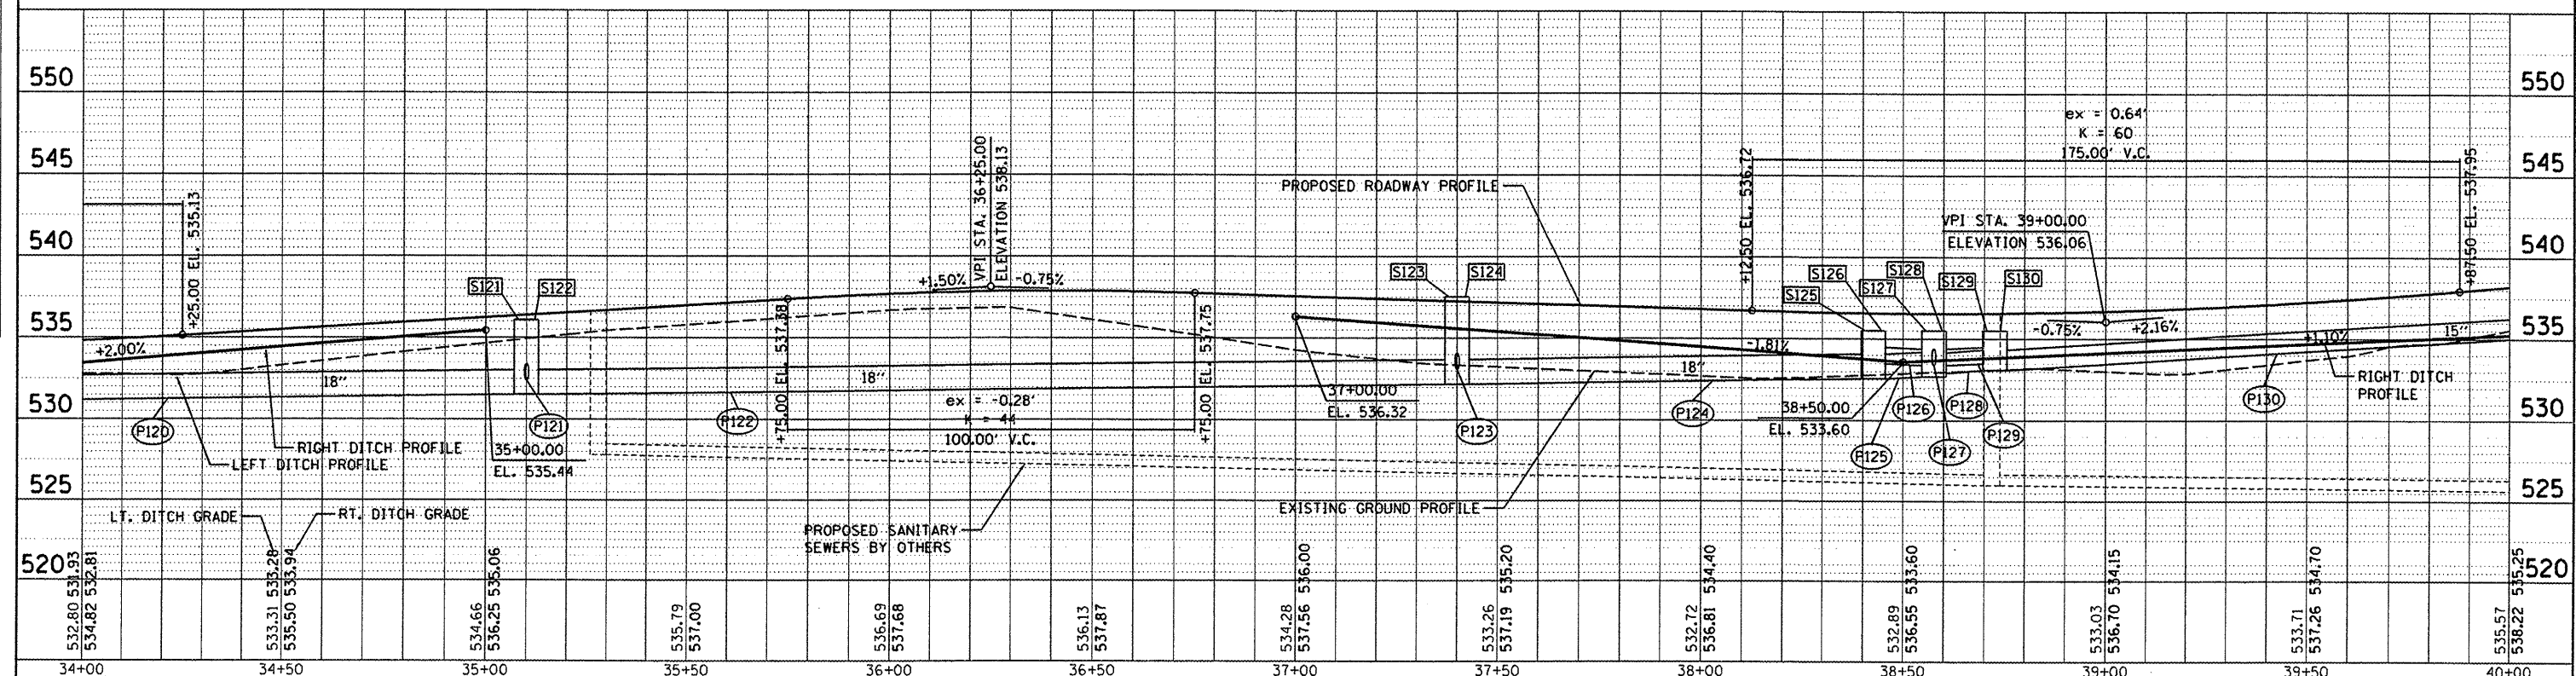

FILE NAME: I:\08Jobs\08L0212\CAD\Road\Sheet\c-705.dgn	USER NAME: dews00878	DESIGNED: - DLC	REVISED: -
		DRAWN: - DLC	REVISED: -
		CHECKED: - MGD	REVISED: -
		DATE: - 9/14/2011	REVISED: -

**STATE OF ILLINOIS
DEPARTMENT OF TRANSPORTATION**

**PETRI LANE
PLAN AND PROFILE**

SCALE: 1"=20' SHEET NO. OF SHEETS STA. 34+00.00 TO STA. 40+00.00

F.A.U. RTE. 6698	SECTION 10-00183-00-FP	COUNTY TAZEWELL	TOTAL SHEETS 81	SHEET NO. 31
CONTRACT NO. 89595			ILLINOIS FED. AID PROJECT M-5093 (154)	