


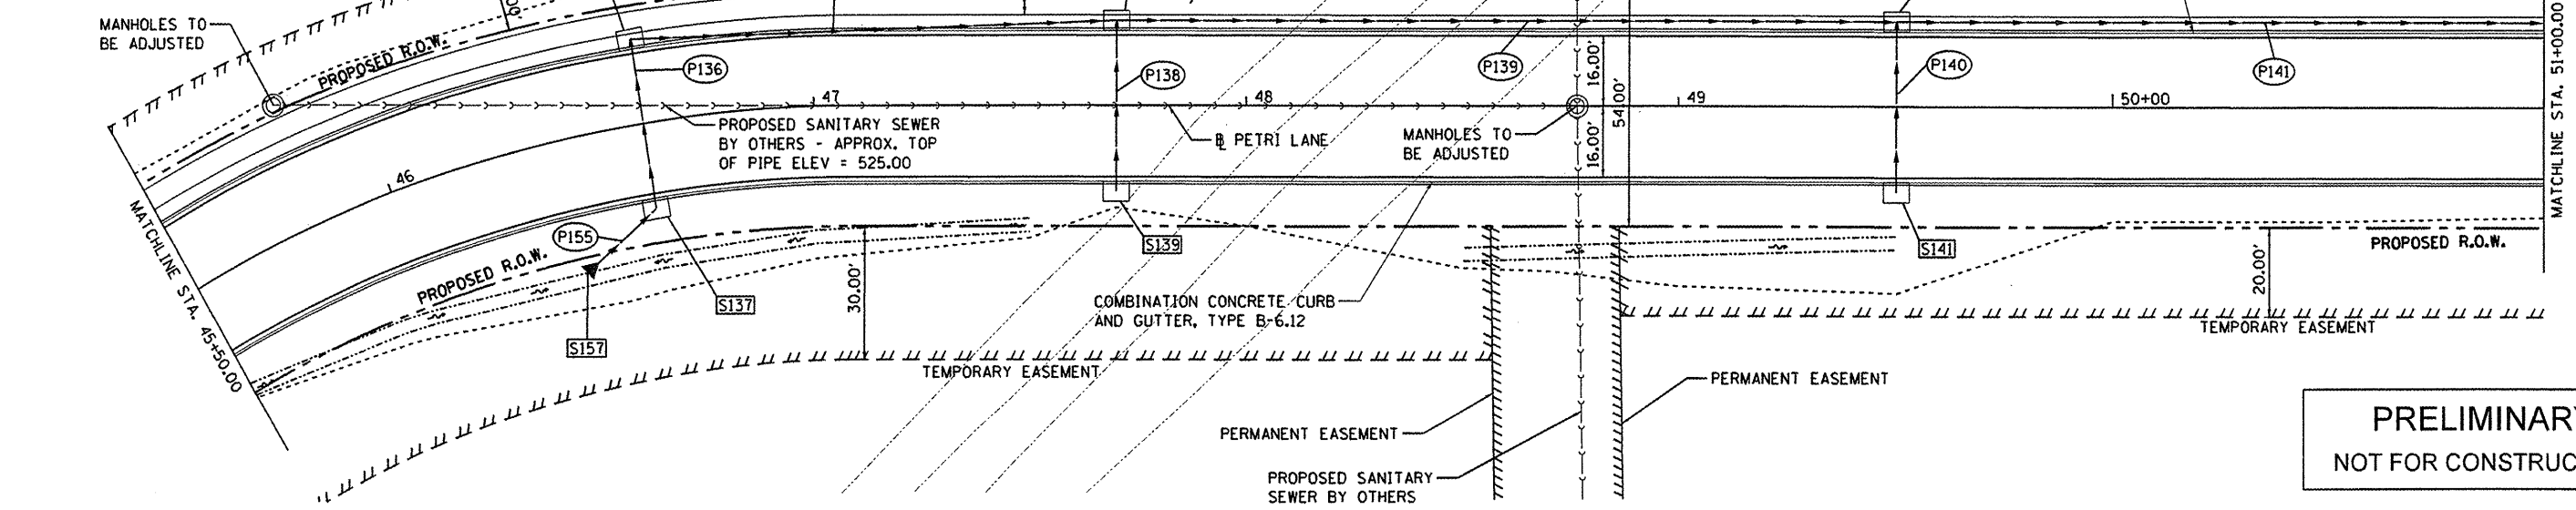

LEGEND

- E100 EXISTING STORM STRUCTURE
- S100 STORM STRUCTURE
- P100 STORM SEWER




PRELIMINARY
NOT FOR CONSTRUCTION

PIPE NUMBER	FROM STRUCTURE	U/S INVERT	TO STRUCTURE	D/S INVERT	CLASS/TYPE	DIAMETER	LENGTH	SLOPE	TRENCH BACKFILL
P136	S137	544.80	S138	544.60	STORM SEWERS, CLASS A, TYPE 1	12	36	0.56%	4.7
P137	S138	544.60	S140	544.03	STORM SEWERS, CLASS A, TYPE 2	12	108	0.53%	39.1
P138	S139	544.45	S140	544.25	STORM SEWERS, CLASS A, TYPE 1	12	36	0.56%	4.7
P139	S140	544.03	S142	538.17	STORM SEWERS, CLASS A, TYPE 2	12	175	3.35%	63.4
P140	S141	538.70	S142	538.50	STORM SEWERS, CLASS A, TYPE 1	12	36	0.56%	4.7
P141	S142	538.17	S144	532.31	STORM SEWERS, CLASS A, TYPE 2	12	175	3.35%	59.7
P155	S157	546.90	S137	545.80	STORM SEWERS, CLASS A, TYPE 1	12	19	5.95%	4.0

STRUCTURE NUMBER	STATION	OFFSET	RIM ELEV	TYPE	INVERT ELEVATIONS			
					N	S	E	W
S137	46+60.00	19.33	RT	548.57	544.80	545.80		
S138	46+60.00	19.33	LT	548.57		544.60	544.60	
S139	47+70.00	19.33	RT	547.95	544.45			
S140	47+70.00	19.33	LT	547.95		544.25	544.03	544.03
S141	49+50.00	19.33	RT	542.37	538.70			
S142	49+50.00	19.33	LT	542.37		538.50	538.17	538.17
S157	46+40.00	32.43	RT	n/a	546.90			

LEGEND - DRIVEWAYS

- PORTLAND CEMENT CONCRETE DRIVEWAY PAVEMENT, 6"
- DETECTABLE WARNING

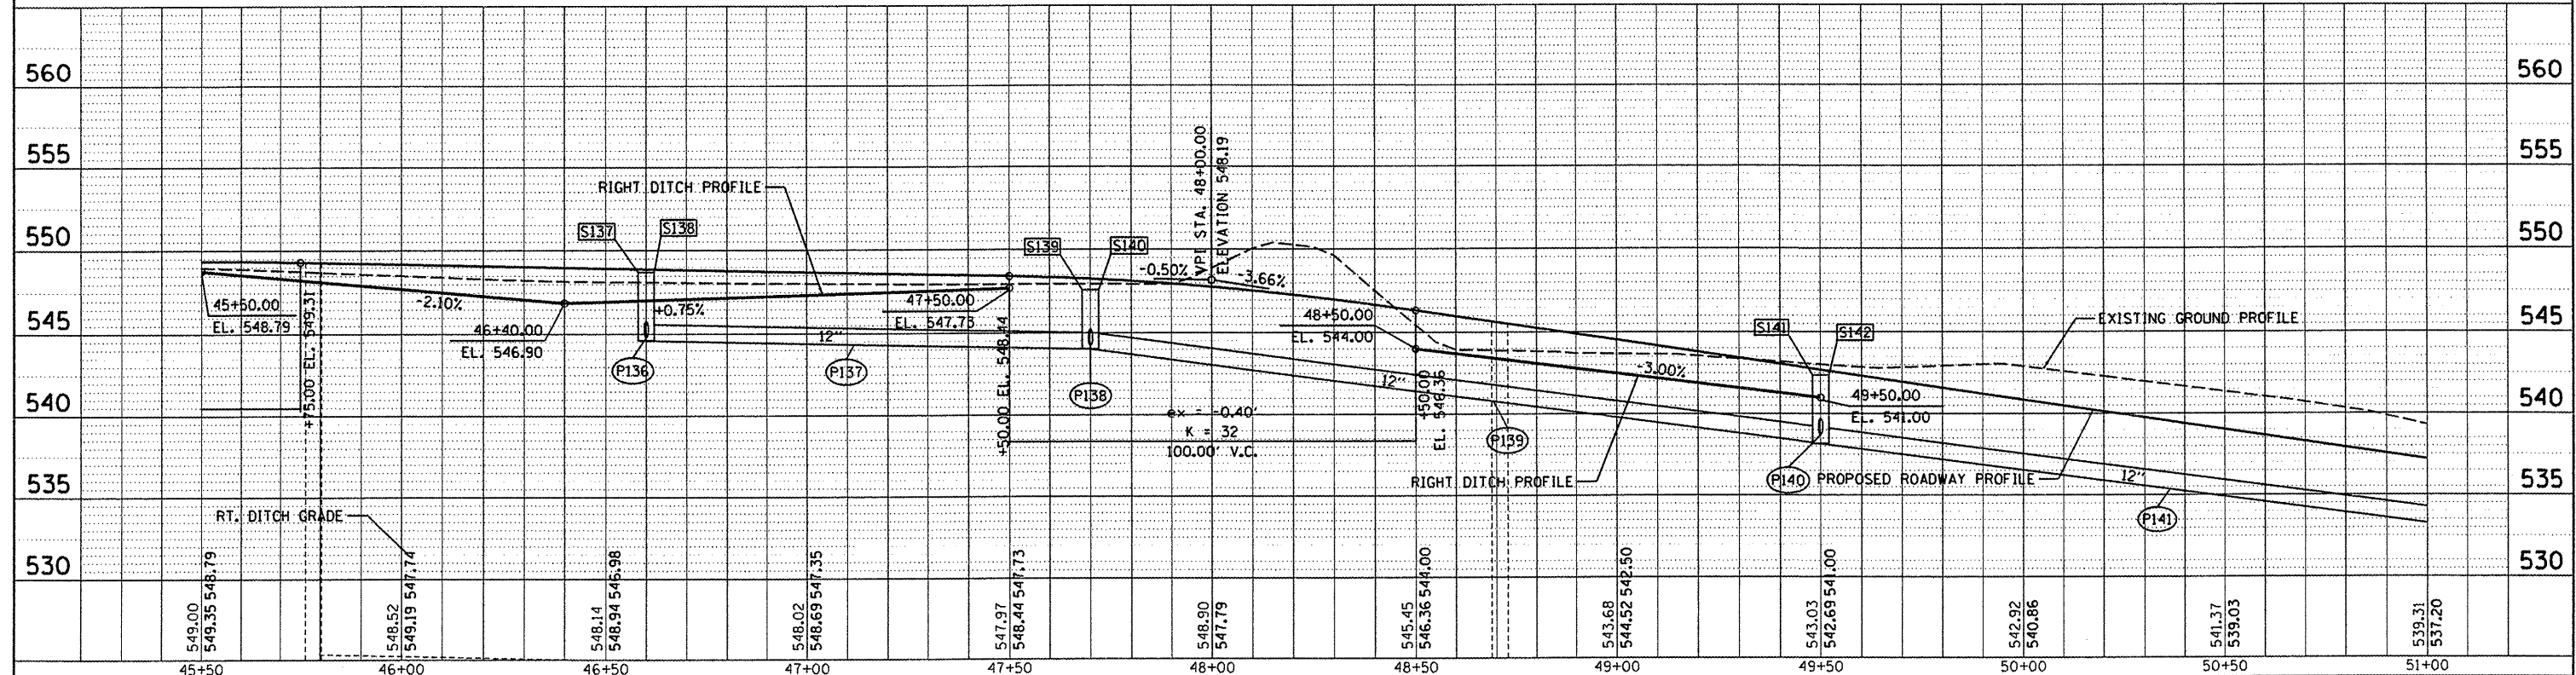

FILE NAME =	USER NAME = dawso00878	DESIGNED - DLC	REVISED -	
I:\08Jobs\08L0212\CAD\Road\Sheet\c-707.dgn		DRAWN - DLC	REVISED -	
PLOT SCALE = 40.000' / in.		CHECKED - MGD	REVISED -	
PLOT DATE = 09/14/2011		DATE - 9/14/2011	REVISED -	

STATE OF ILLINOIS
DEPARTMENT OF TRANSPORTATION

PETRI LANE
PLAN AND PROFILE

SCALE: 1"=20' SHEET NO. OF SHEETS STA. 45+50.00 TO STA. 51+00.00

F.A.L. RTE.	SECTION	COUNTY	TOTAL SHEETS	SHEET NO.
6698	10-00183-00-FP	TAZEWELL	81	33
CONTRACT NO. 89595				
(ILLINOIS) FED. AID PROJECT M-5093 (IS)				

SURVEYED BY: _____ DATE: _____
 PLOTTED BY: _____
 CHECKED BY: _____
 NOTE BOOK NO.: _____
 STRUCTURE NO.: _____

SURVEYED BY: _____ DATE: _____
 PLOTTED BY: _____
 CHECKED BY: _____
 NOTE BOOK NO.: _____
 STRUCTURE NO.: _____