





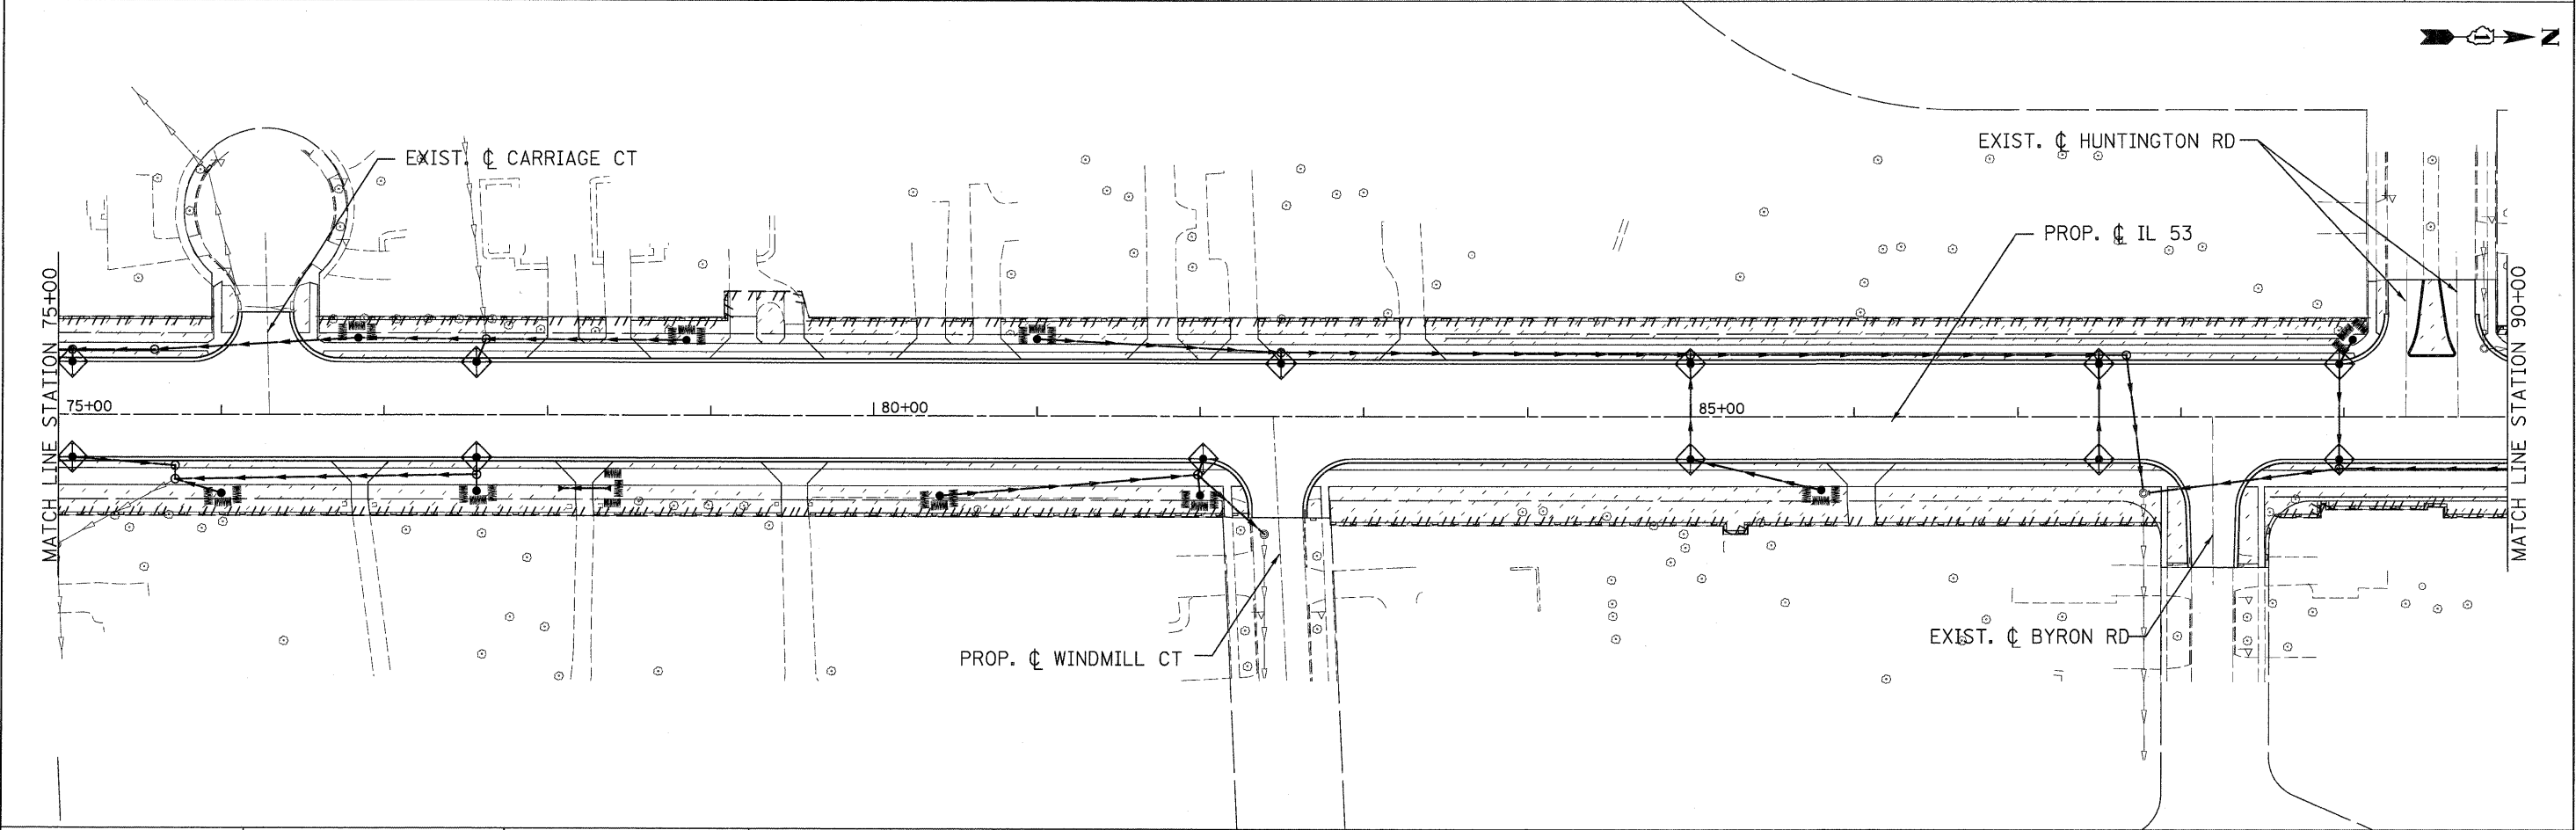
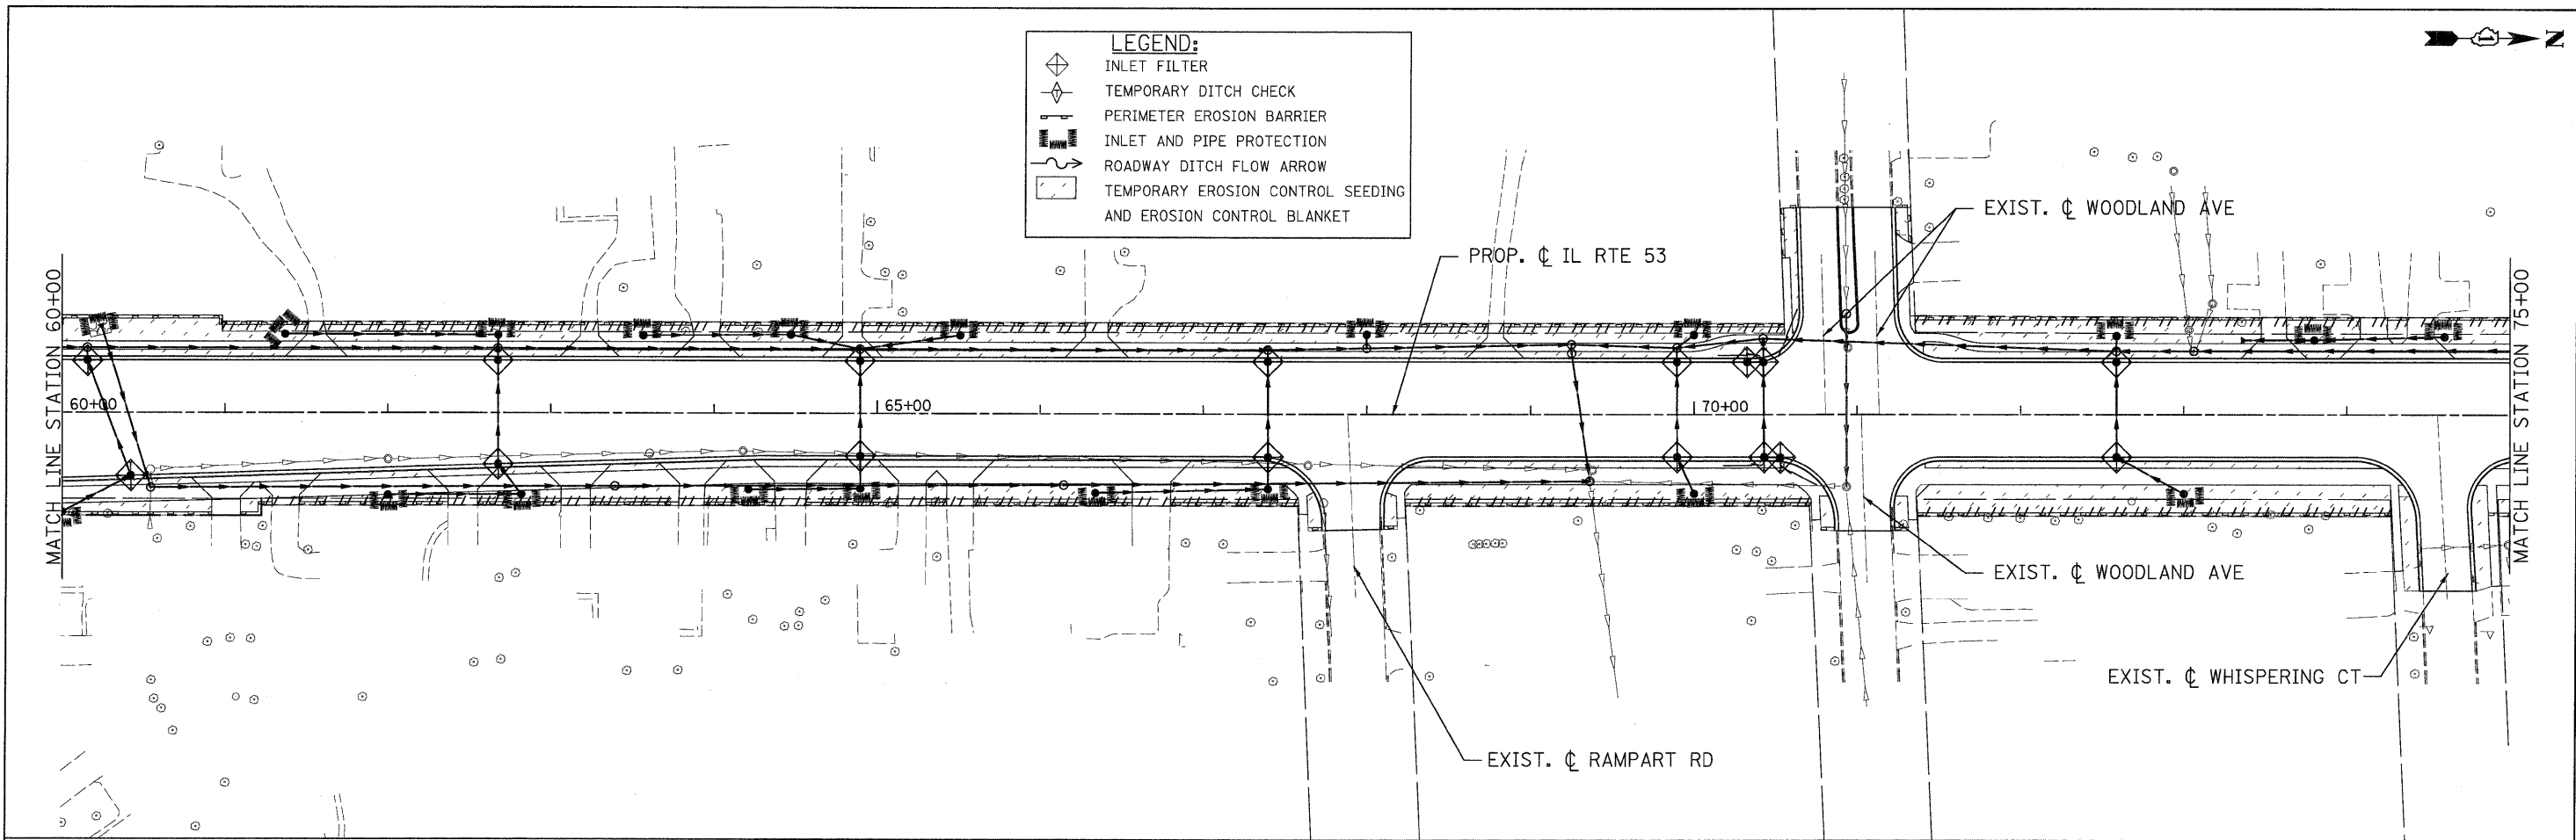


LEGEND:

-  INLET FILTER
-  TEMPORARY DITCH CHECK
-  PERIMETER EROSION BARRIER
-  INLET AND PIPE PROTECTION
-  ROADWAY DITCH FLOW ARROW
-  TEMPORARY EROSION CONTROL SEEDING AND EROSION CONTROL BLANKET

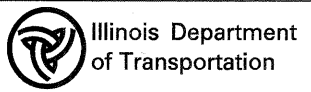


PATRICK ENGINEERING INC.
 4970 VARSITY DRIVE
 LISLE, IL 60532
 patrickengineering.com

USER NAME = ckersten(Lisle_R)
 PLOT CONFIG = PDF(Grey_Large).plt
 PLOT SCALE = 1:50
 PLOT DATE = 12/3/2010

DESIGNED - D. DOERFLER
 DRAWN - C. HELLAND
 CHECKED - A. JAMES
 DATE - 12/3/2010

REVISED -
 REVISED -
 REVISED -
 REVISED -



**ILLINOIS ROUTE 53
 SOIL EROSION AND SEDIMENT CONTROL PLAN**

SCALE: 1"=50' SHEET ERO-02 OF 13 STA. 60+00 TO STA. 90+00

F.A.U. RTE. 2578	SECTION 532B	COUNTY DUPAGE	TOTAL SHEETS 781	SHEET NO. 244
CONTRACT NO. 60477				
FED. ROAD DIST. NO. [ILLINOIS] FED. AID PROJECT				

G:\1001\9356_AB_(IL53)\Drawings\CA00 Sheets\019139797-sht_eros_244.dgn