

| PARCEL NUMBER | OWNER | TOTAL HOLDINGS | AREA TAKEN | PREVIOUS DESIGNATION | REMAINDER | AREA OF EASEMENT | PURPOSE OF EASEMENT | TAX NUMBER | PROPERTY ACQUIRED BY |
|---------------|---|----------------|------------|----------------------|-----------|------------------|---------------------|----------------------------------|----------------------|
| 1DS0133 | White Oaks Commons Townhome Association | 1.915 AC± | 0.076 AC± | NA | 1.839 AC± | NA | NA | 02-13-207-012 | |
| 1DS0133TE | | | NA | NA | NA | 0.019 AC± | DRIVE | | |
| 1DS0134 | Itasca Place Condominiums | 4.577 AC± | 0.140 AC± | NA | 4.437 AC± | NA | NA | 02-13-208-001 THRU 02-13-208-140 | |
| 1DS0210 | Chicago Title Land Trust Company, fka Chicago Title and Trust Company, as Trustee, under the provisions of a Trust Agreement dated August 17, 1991 and known as Trust No. 1096536 | 1.312 AC± | 0.039 AC± | NA | 1.273 AC± | NA | NA | 02-13-207-007 | |
| 1DS0211TE | Gayatri Gyan Mandir | 0.921 AC± | NA | NA | NA | 0.048 AC± | GRADING | 03-18-300-001 | |
| 1DS0212TE | Todd J. Snick and Jacqueline A. Snick, his wife | 0.911 AC± | NA | NA | NA | 0.052 AC± | GRADING | 03-18-101-004 | |

LEGEND

SECTION LINE
 QUARTER SECTION LINE
 QUARTER, QUARTER SECTION LINE
 PLATTED LOT LINE
 PROPERTY (DEED) LINE
 API
 APPARENT PROPERTY LINE
 CENTERLINE
 EXISTING RIGHT OF WAY LINE
 EXISTING EASEMENT
 PROPOSED RIGHT OF WAY LINE
 PROPOSED EASEMENT
 MEASURED DIMENSION
 RECORD DATA


EXISTING BUILDINGS

IRON PIPE OR ROD FOUND
 CUT CROSS FOUND OR SET
 THESE STAKES REFERENCE FOUND OR SET MONUMENTATION, SET 5/8 INCH IRON ROD FLUSH WITH THE GROUND TO THE MONUMENTATION, IDENTIFIED BY COLORED PLASTIC CAP BEARING SURVEYORS REGISTRATION NUMBER.
 THESE STAKES, IN CULTIVATED AREAS, REFERENCE FOUND OR SET MONUMENTATION, BURIED 5/8 INCH ROD 20 INCHES BELOW GROUND TO THE MONUMENTATION, IDENTIFIED BY COLORED PLASTIC CAP BEARING SURVEYORS REGISTRATION NUMBER.
 STAKING OF PROPOSED RIGHT OF WAY, SET DIVISION OF HIGHWAYS SURVEY MARKER TO MONUMENT THE POSITION SHOWN, IDENTIFIED BY INSCRIPTION DATA AND SURVEYORS REGISTRATION NUMBER.
 STAKING OF PROPOSED RIGHT OF WAY IN CULTIVATED AREAS, BURIED 5/8 INCH IRON ROD 20 INCHES BELOW GROUND TO MARK FUTURE SURVEY MARKER POSITION, IDENTIFIED BY COLORED PLASTIC CAP BEARING SURVEYORS REGISTRATION NUMBER.
 PERMANENT SURVEY MARKER, IDOT STD. 2135 (TO BE SET BY OTHERS)
 RIGHT OF WAY STAKING PROPOSED TO BE SET

STATE OF ILLINOIS }
 COUNTY OF KANE }

THIS IS TO CERTIFY THAT I, REJENA H. LYON, AN ILLINOIS PROFESSIONAL LAND SURVEYOR, HAVE SURVEYED THE PLAT OF HIGHWAYS SHOWN HEREON IN SECTION 24, TOWNSHIP 40 NORTH, RANGE 10 EAST, AND SECTION 19, TOWNSHIP 40 NORTH, RANGE 11 EAST OF THE THIRD PRINCIPAL MERIDIAN, DUPAGE COUNTY; THAT THE SURVEY IS TRUE AND COMPLETE AS SHOWN TO THE BEST OF MY KNOWLEDGE AND BELIEF; THAT THE PLAT CORRECTLY REPRESENTS SAID SURVEY; THAT ALL MONUMENTS FOUND AND ESTABLISHED ARE OF PERMANENT QUALITY AND OCCUPY THE POSITIONS SHOWN HEREON AND THAT THE MONUMENTS ARE SUFFICIENT TO ENABLE THE SURVEY TO BE RETRACED, MADE FOR THE DEPARTMENT OF TRANSPORTATION, STATE OF ILLINOIS. THIS PROFESSIONAL SERVICE CONFORMS TO THE CURRENT ILLINOIS MINIMUM STANDARDS FOR A BOUNDARY SURVEY FOR THAT PORTION SHOWN AS PROPOSED RIGHT-OF-WAY.

DATED AT ELGIN, ILLINOIS, THIS _____ DAY OF _____, 20__ A.D.

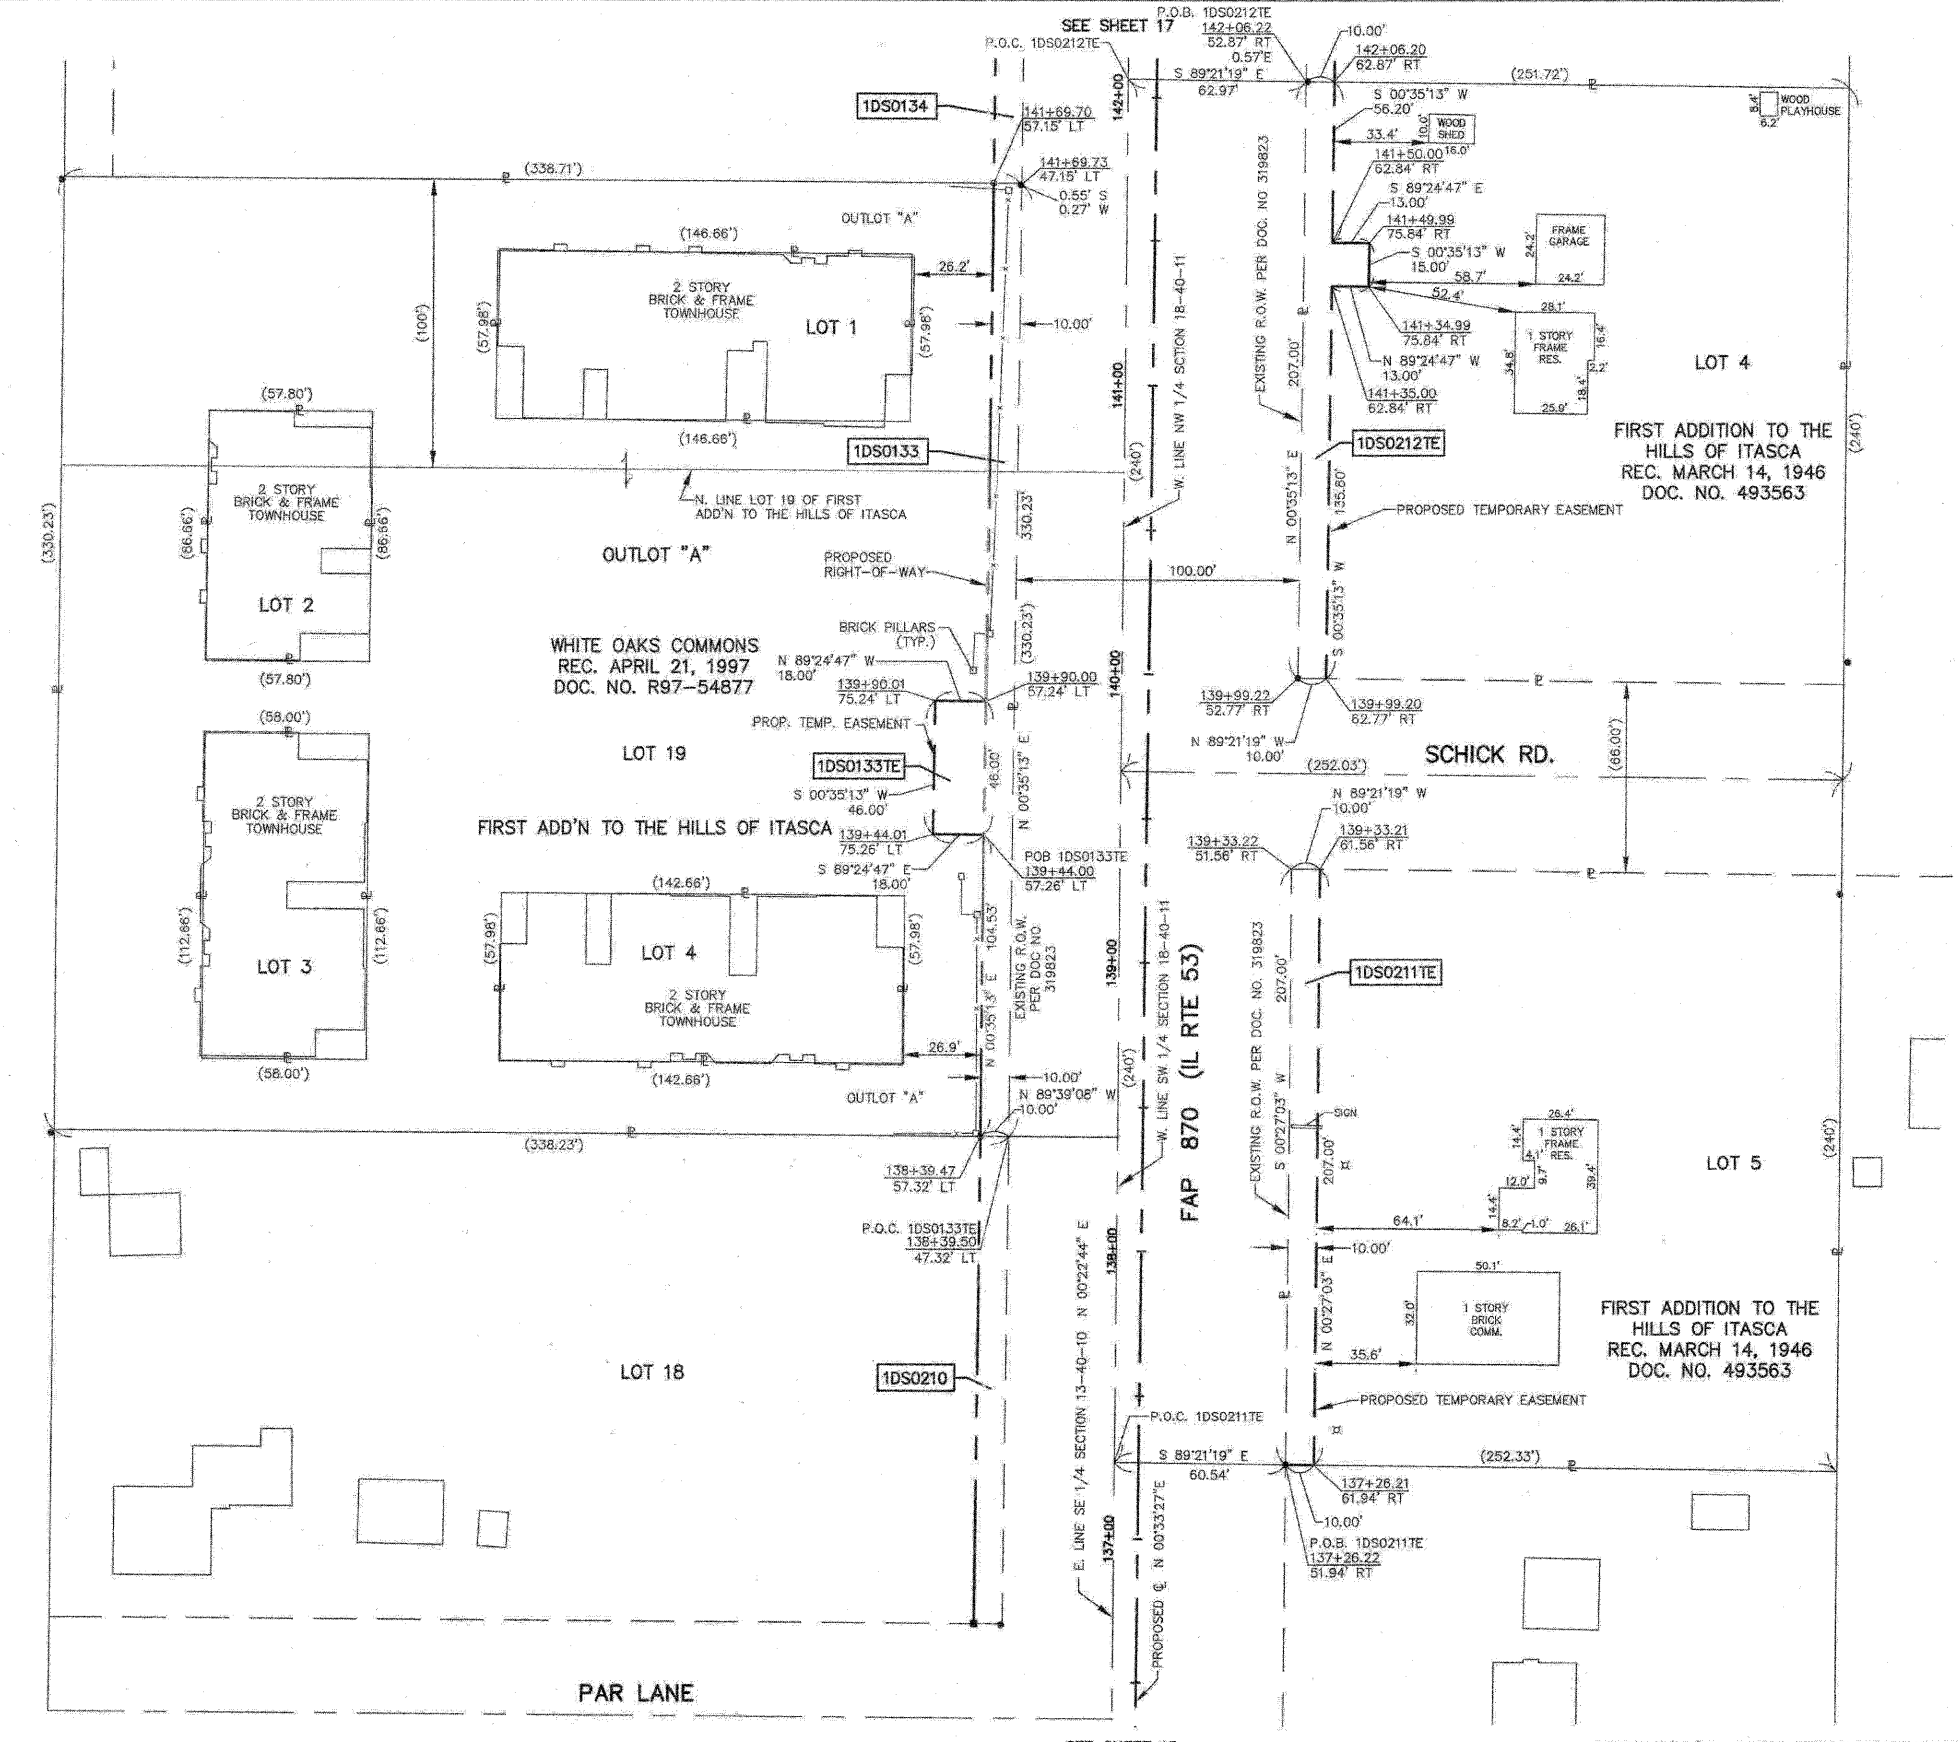

ILLINOIS PROFESSIONAL LAND SURVEYOR NO. 3302
 ACCOUNT NO. 2-04-0052(a)

REJENA H. LYON
 3302 PROFESSIONAL LAND SURVEYOR STATE OF ILLINOIS
 ELGIN, ILLINOIS
 LICENSE EXPIRES 11/30/2010

ALL BEARINGS ARE BASED ON ILLINOIS STATE PLANE COORDINATE SYSTEM NAD 83, EAST ZONE GRID.

RECEIVED
 SEP 02 2009
 PLATS & LEGALS

HAMPTON, LENZINI AND RENWICK, INC.
 CIVIL ENGINEERS • STRUCTURAL ENGINEERS • LAND SURVEYORS
 380 SHEPARD DRIVE
 ELGIN, ILLINOIS 60123
 847.697.5700 www.hlrengineering.com

PLAT OF HIGHWAYS
 STATE OF ILLINOIS
 DEPARTMENT OF TRANSPORTATION
 F.A.P. 870 (IL RTE 53)

DUPAGE COUNTY SECTION
 PROJECT JOB NO. R-91-069-00
 STATION 137+00 TO STATION 142+00
 SCALE: 1"=30' SHEET 16 OF X

BUREAU OF LAND ACQUISITION
 201 WEST CENTER COURT
 SCHAMBERG, ILLINOIS 60196

| PARCEL NUMBER | OWNER | TOTAL HOLDINGS | AREA TAKEN | PREVIOUS DEDICATION | REMAINDER | AREA OF EASEMENT | PURPOSE OF EASEMENT | TAX NUMBER | PROPERTY ACQUIRED BY |
|---------------|--|----------------|--------------------|---------------------|-----------|------------------|---------------------|----------------------------------|----------------------|
| 1DS0134 | Itasca Place Condominiums | 4.577 AC± | 0.140 AC± | NA | 4.437 AC± | NA | NA | 02-13-208-001 THRU 02-13-208-140 | |
| 1DS0136TE | Karen Fahlgren, an unmarried woman and Timothy J. Chalke, an unmarried man, as joint tenants | 0.873 AC± | NA | NA | NA | 0.031 AC± | GRADING | 03-18-101-002 | |
| 1DS0137 | Church of Christ | 1.134 AC± | 0.008 AC± (343 SF) | NA | 1.126 AC± | NA | NA | 03-18-101-015 | |
| 1DS0137E | | | NA | NA | NA | 0.042 AC± | GRADING | | |
| 1DS0212TE | Todd J. Snick and Jacqueline A. Snick, his wife | 0.911 AC± | NA | NA | NA | 0.052 AC± | GRADING | 03-18-101-004 | |

LEGEND

STATE OF ILLINOIS)
 COUNTY OF KANE)

THIS IS TO CERTIFY THAT I, REJENA H. LYON, AN ILLINOIS PROFESSIONAL LAND SURVEYOR, HAVE SURVEYED THE PLAT OF HIGHWAYS SHOWN HEREON IN SECTION 24, TOWNSHIP 40 NORTH, RANGE 10 EAST, AND SECTION 19, TOWNSHIP 40 NORTH, RANGE 11 EAST OF THE THIRD PRINCIPAL MERIDIAN, DUPAGE COUNTY, THAT THE SURVEY IS TRUE AND COMPLETE AS SHOWN TO THE BEST OF MY KNOWLEDGE AND BELIEF; THAT THE PLAT CORRECTLY REPRESENTS SAID SURVEY; THAT ALL MONUMENTS FOUND AND ESTABLISHED ARE OF PERMANENT QUALITY AND OCCUPY THE POSITIONS SHOWN HEREON AND THAT THE MONUMENTS ARE SUFFICIENT TO ENABLE THE SURVEY TO BE RETRACED. MADE FOR THE DEPARTMENT OF TRANSPORTATION, STATE OF ILLINOIS. THIS PROFESSIONAL SERVICE CONFORMS TO THE CURRENT ILLINOIS MINIMUM STANDARDS FOR A BOUNDARY SURVEY FOR THAT PORTION SHOWN AS PROPOSED RIGHT-OF-WAY.

DATED AT ELGIN, ILLINOIS, THIS _____ DAY OF _____, 20__ A.D.

ILLINOIS PROFESSIONAL LAND SURVEYOR NO. 3302
 ACCOUNT NO. 2-04-0052(a)

RECEIVED
 APR 20 2010
 PLATS & LEGALS



ALL BEARINGS ARE BASED ON ILLINOIS STATE PLANE COORDINATE SYSTEM NAD 83, EAST ZONE GRID.


HAMPTON, LENZINI AND RENWICK, INC.
 CIVIL ENGINEERS • STRUCTURAL ENGINEERS • LAND SURVEYORS
HLR
 380 SHEPARD DRIVE
 ELGIN, ILLINOIS 60123
 847.657.8700 www.hlrengineering.com
104.000569 ILLINOIS PROFESSIONAL DESIGN FIRM & STRUCTURAL ENGINEERING CORP.

PLAT OF HIGHWAYS
 STATE OF ILLINOIS
 DEPARTMENT OF TRANSPORTATION
 F.A.P. 870 (IL RTE 53)
 DUPAGE COUNTY SECTION
 PROJECT JOB NO. R-91-069-00
 STATION 141+50 TO STATION 146+50
 SCALE: 1"=30' SHEET 17 OF X


BUREAU OF LAND ACQUISITION
 201 WEST CENTER COURT
 SCHAMBURG, ILLINOIS 60196

TOPO UPDATED 7/27/09
 FIELD WORK COMPLETED 6/27/03

REVISED 4/20/10 REVISED PARCEL 1DS0136TE
 REVISED 4/12/10 DELETED PARCEL 1DS0213TE
 REVISED 9/1/09 COMBINED PARCELS 1DS0134 & 1DS0135, NEW SUB, OWNERSHIP, PIN

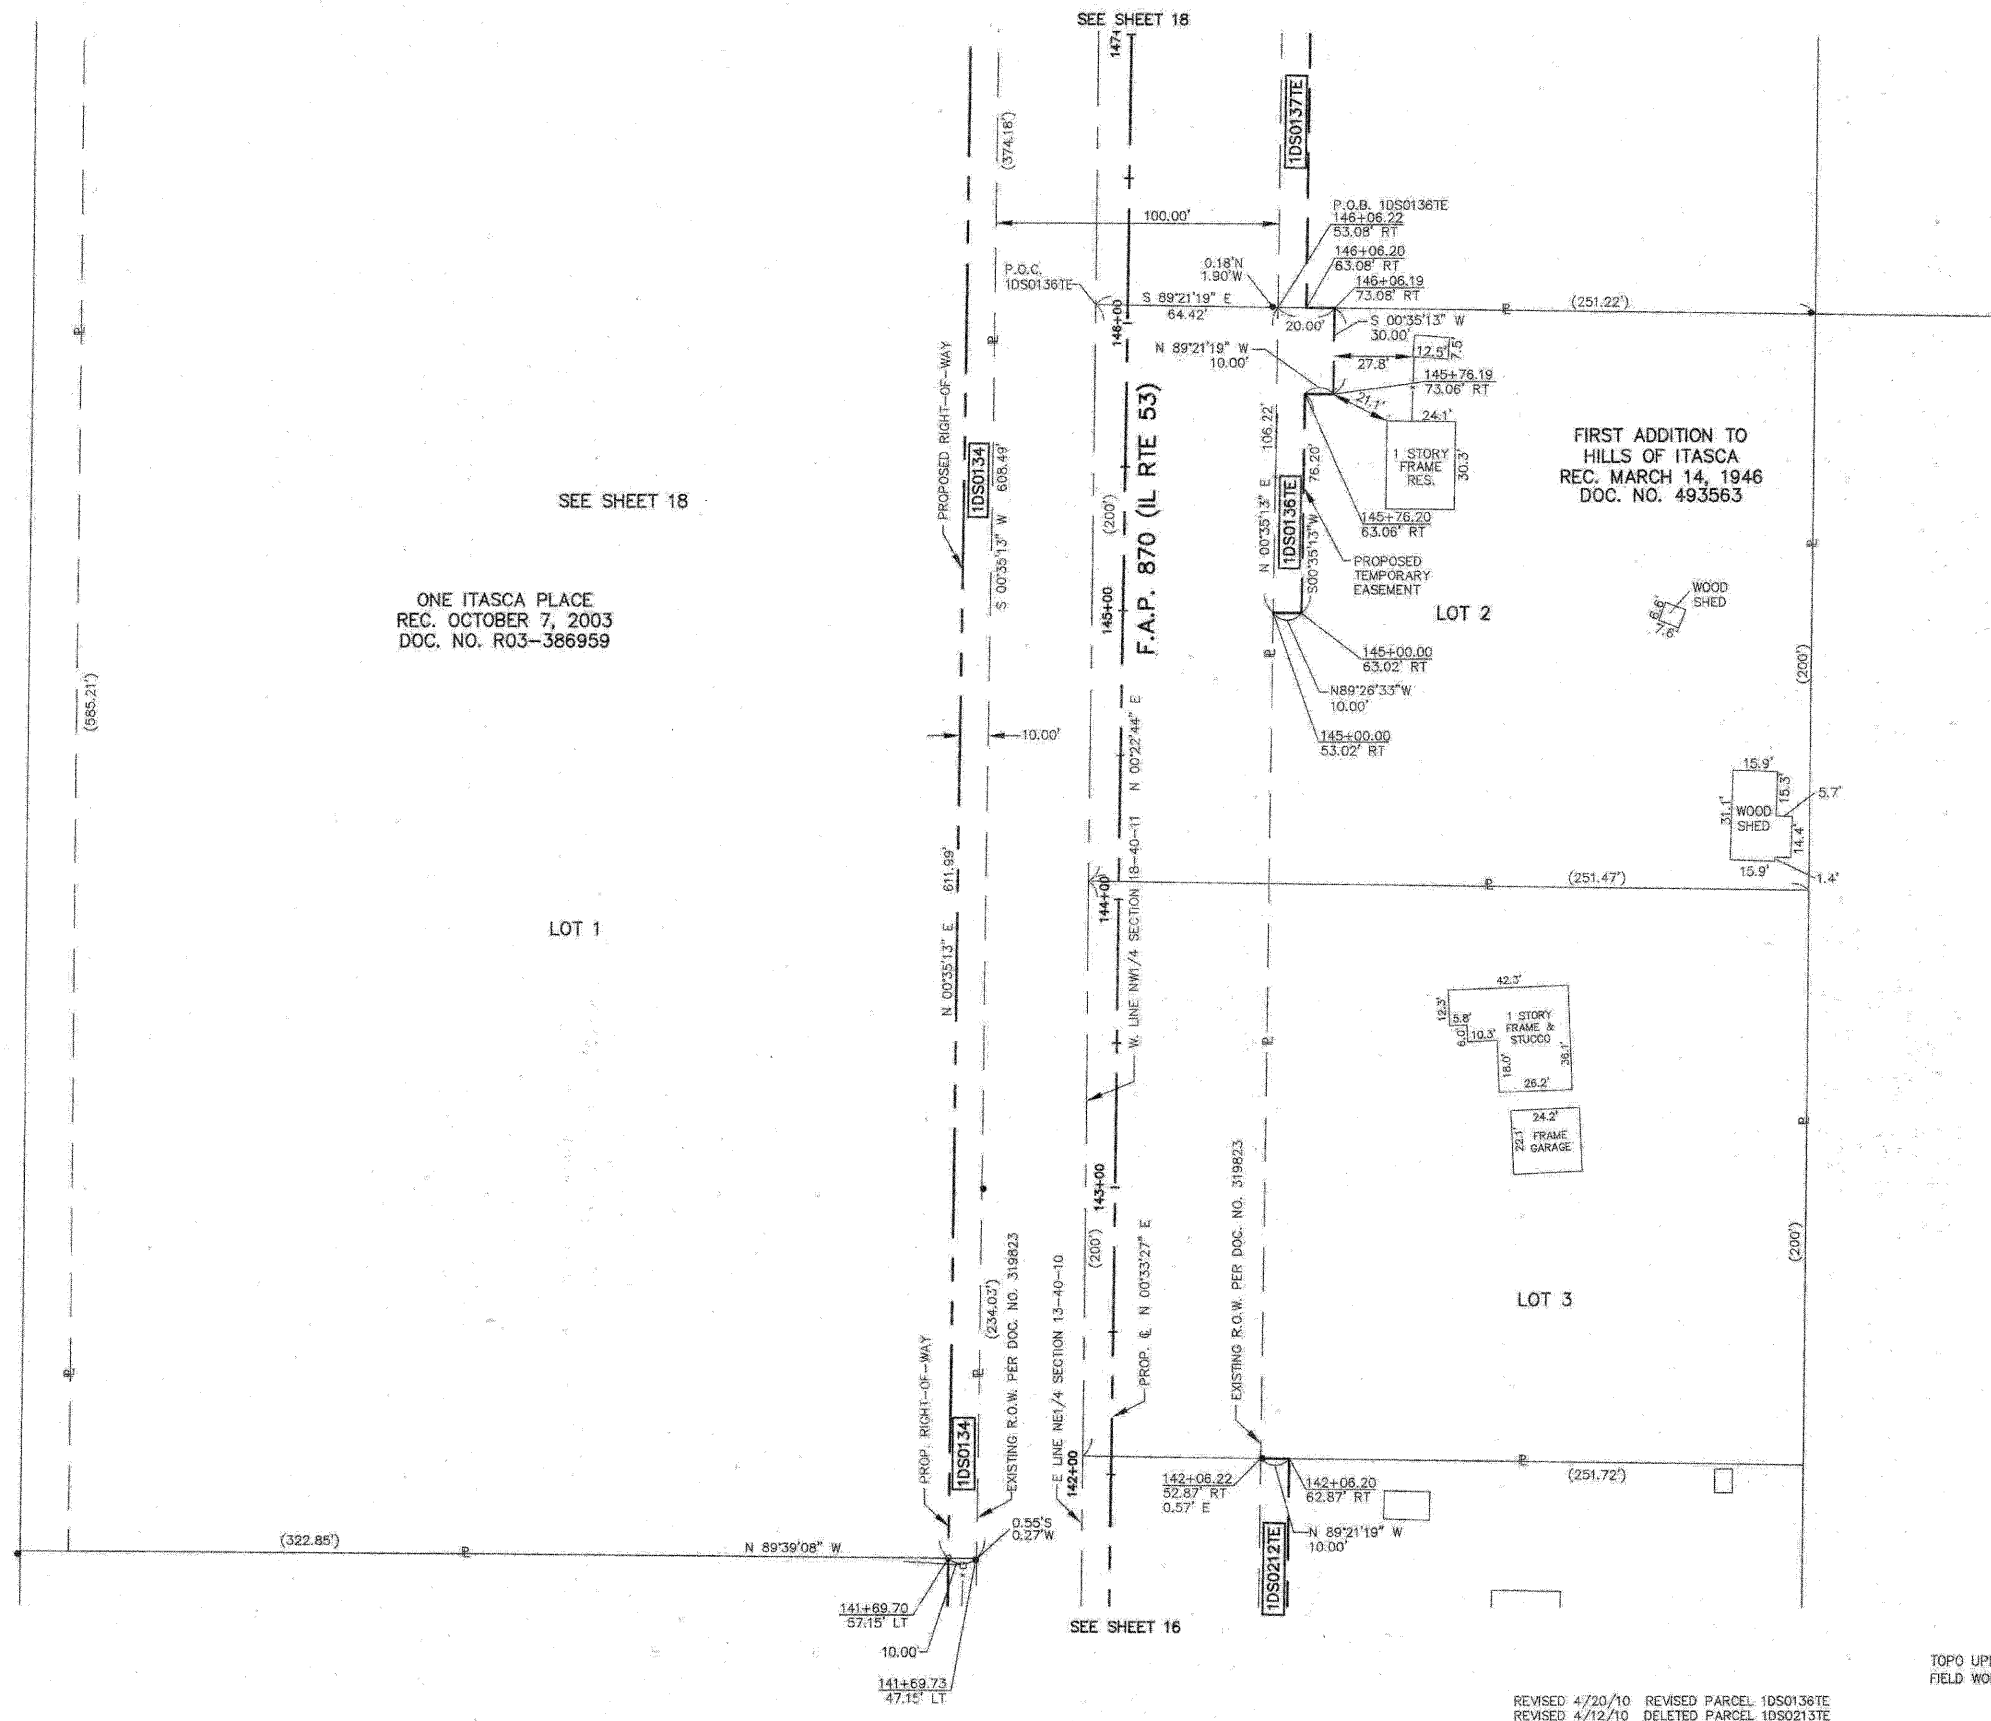

| PARCEL NUMBER | OWNER | TOTAL HOLDINGS | AREA TAKEN | PREVIOUS DEDICATION | REMAINDER | AREA OF EASEMENT | PURPOSE OF EASEMENT | TAX NUMBER | PROPERTY ACQUIRED BY |
|---------------|--|----------------|--------------------|---------------------|-----------|------------------|---------------------|----------------------------------|----------------------|
| 1DS0134 | Itasca Place Condominiums | 4.577 AC± | 0.140 AC± | NA | 4.437 AC± | NA | NA | 02-13-208-001 THRU 02-13-208-140 | |
| 1DS0136TE | Karen Fahlgren, an unmarried woman and Timothy J. Chalke, an unmarried man, as joint tenants | 0.873 AC± | NA | NA | NA | 0.031 AC± | GRADING | 03-18-101-002 | |
| 1DS0137 | Church of Christ | 1.134 AC± | 0.008 AC± (343 SF) | NA | 1.126 AC± | NA | NA | 03-18-101-015 | |
| 1DS0137TE | | | NA | NA | NA | 0.042 AC± | GRADING | | |

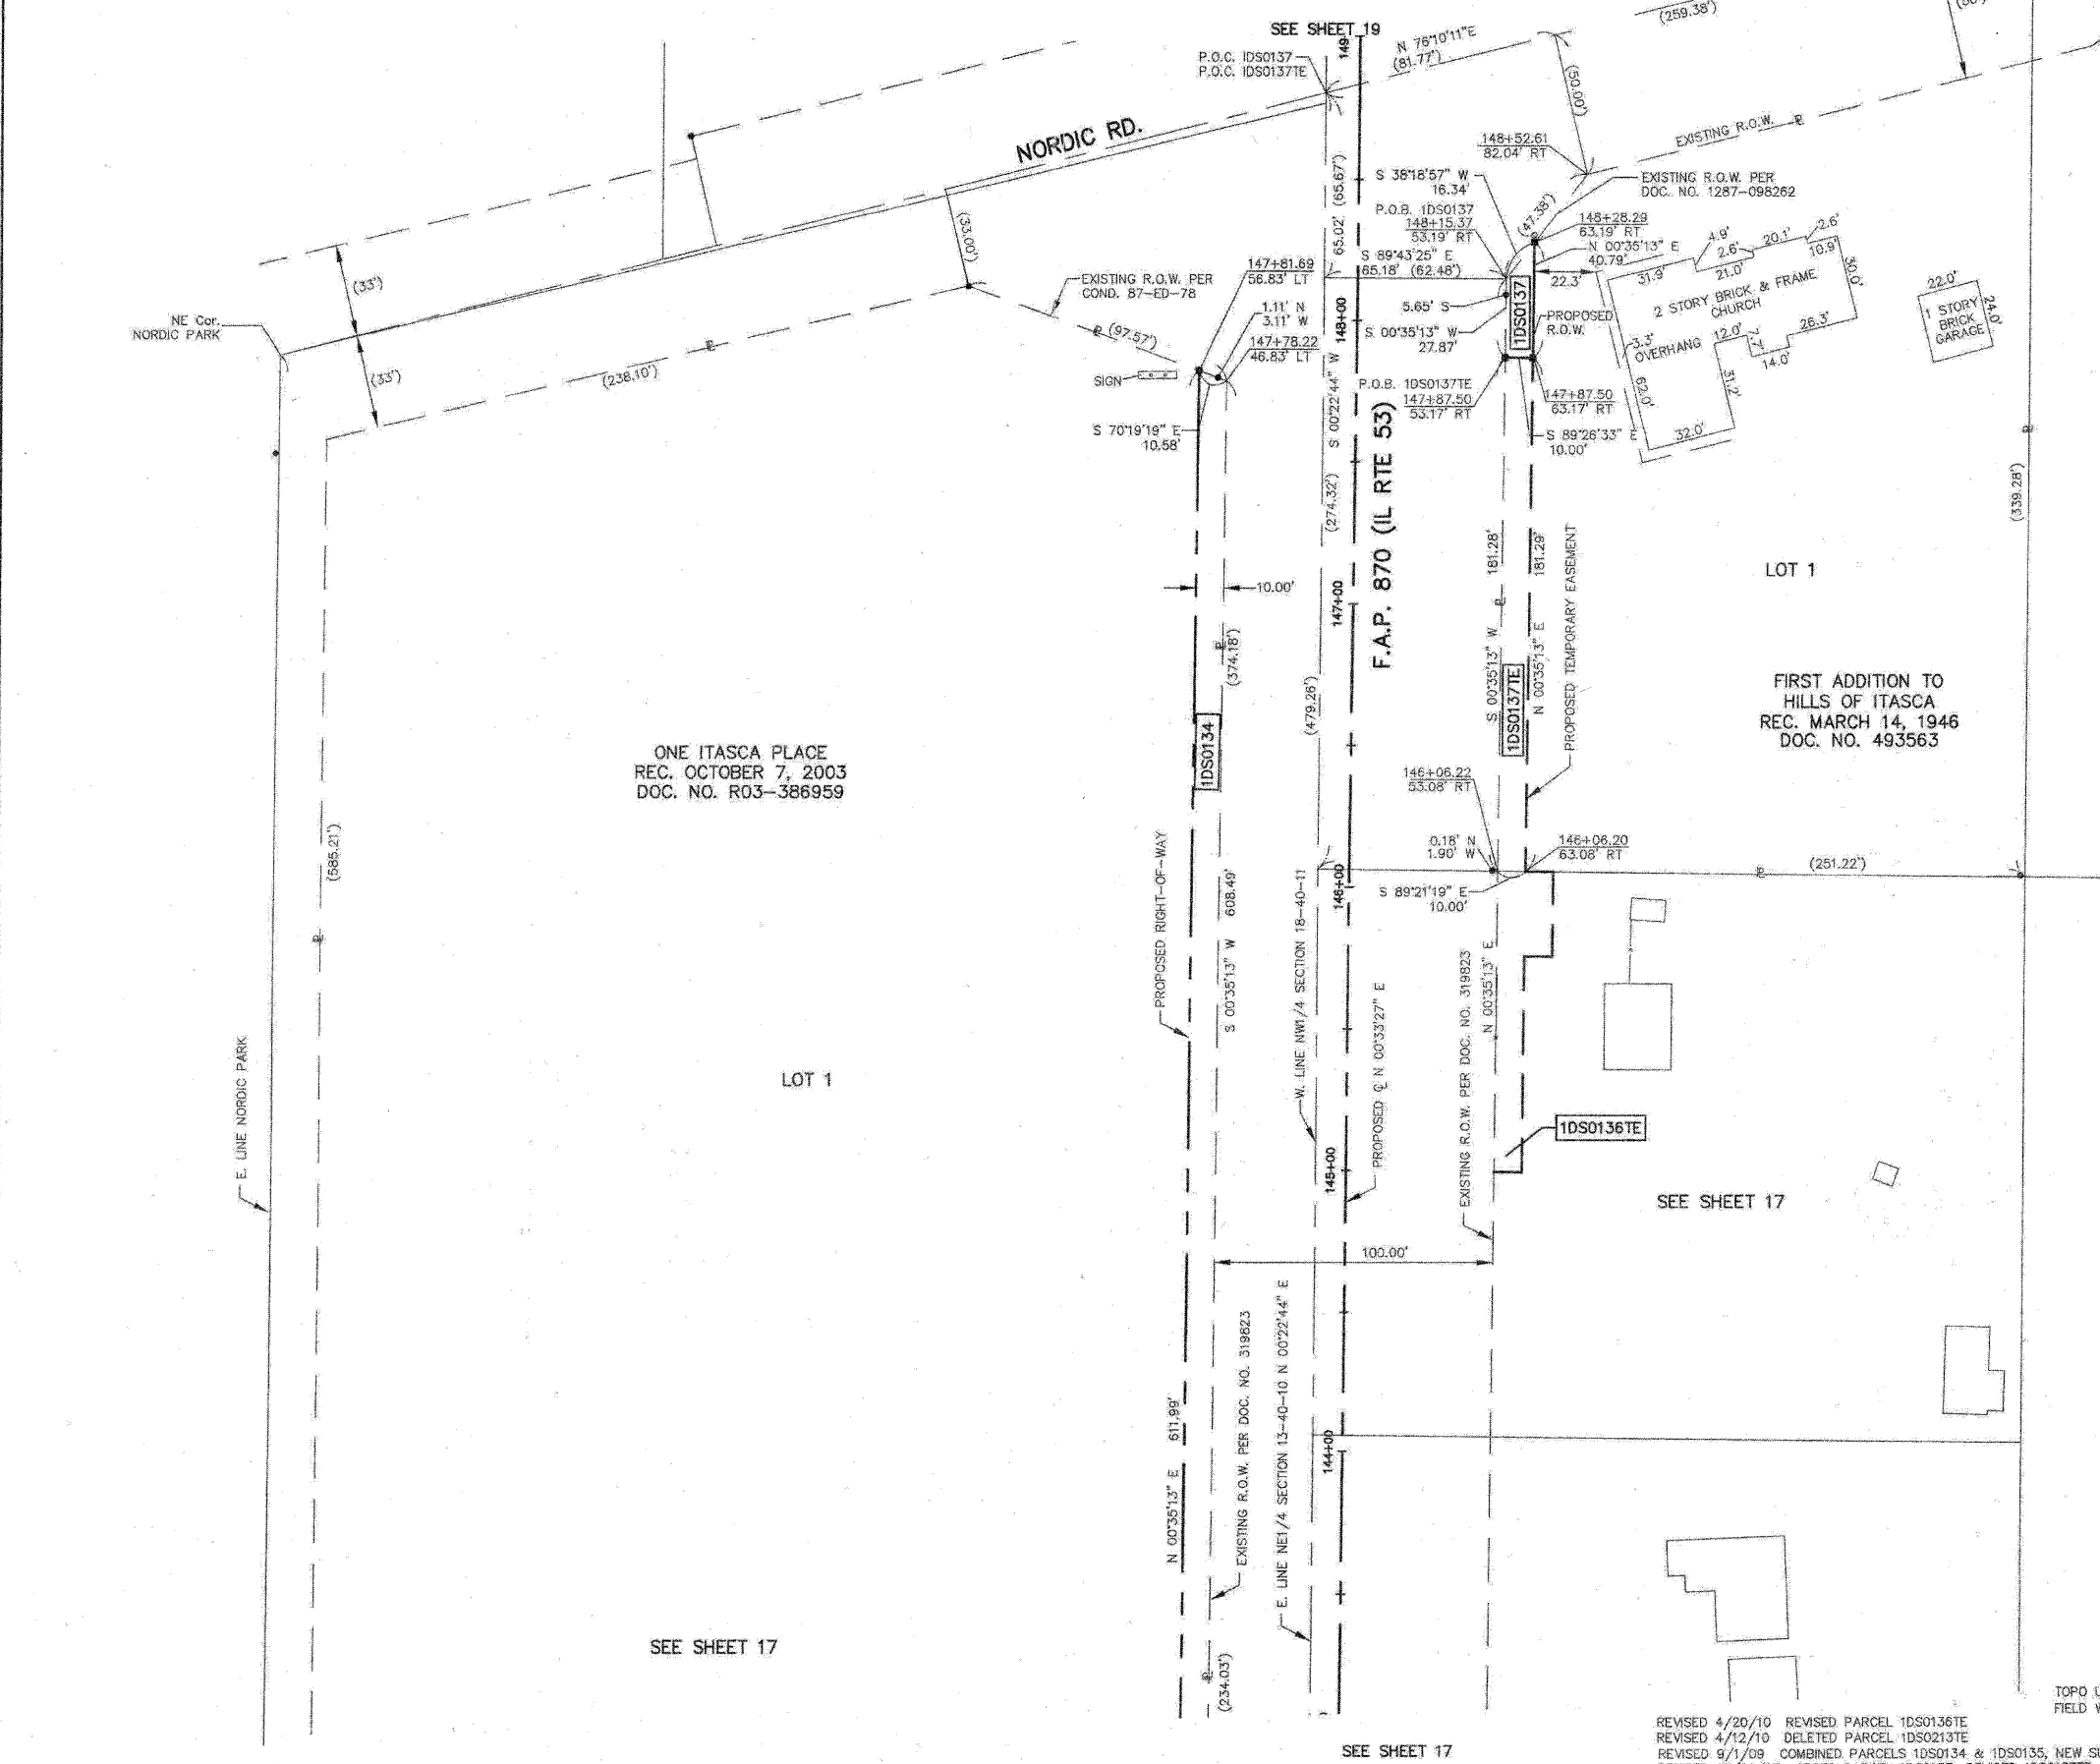

LEGEND

- SECTION LINE
- QUARTER SECTION LINE
- QUARTER, QUARTER SECTION LINE
- PLATTED LOT LINE
- PROPERTY (DEED) LINE
- APL APPARENT PROPERTY LINE
- CENTERLINE
- EXISTING RIGHT OF WAY LINE
- EXISTING EASEMENT
- PROPOSED RIGHT OF WAY LINE
- PROPOSED EASEMENT
- MEASURED DIMENSION
- RECORD DATA

EXISTING BUILDINGS

- IRON PIPE OR ROD FOUND
- CUT CROSS FOUND OR SET
- T1 THESE STAKES REFERENCE FOUND OR SET MONUMENTATION, SET 5/8 INCH IRON ROD FLUSH WITH THE GROUND TO THE MONUMENTATION, IDENTIFIED BY COLORED PLASTIC CAP BEARING SURVEYORS REGISTRATION NUMBER.
- T2
- T3
- BT1 THESE STAKES, IN CULTIVATED AREAS, REFERENCE FOUND OR SET MONUMENTATION, BURIED 5/8 INCH ROD 20 INCHES BELOW GROUND TO THE MONUMENTATION, IDENTIFIED BY COLORED PLASTIC CAP BEARING SURVEYORS REGISTRATION NUMBER.
- BT2
- BT3
- STAKING OF PROPOSED RIGHT OF WAY, SET DIVISION OF HIGHWAYS SURVEY MARKER TO MONUMENT THE POSITION SHOWN, IDENTIFIED BY INSCRIPTION DATA AND SURVEYORS REGISTRATION NUMBER.
- M STAKING OF PROPOSED RIGHT OF WAY IN CULTIVATED AREAS, BURIED 5/8 INCH IRON ROD 20 INCHES BELOW GROUND TO MARK FUTURE SURVEY MARKER POSITION, IDENTIFIED BY COLORED PLASTIC CAP BEARING SURVEYORS REGISTRATION NUMBER.
- PERMANENT SURVEY MARKER, IDOT STD. 2135 (TO BE SET BY OTHERS)
- RIGHT OF WAY STAKING PROPOSED TO BE SET

STATE OF ILLINOIS }
COUNTY OF KANE }

THIS IS TO CERTIFY THAT I, REJENA H. LYON, AN ILLINOIS PROFESSIONAL LAND SURVEYOR, HAVE SURVEYED THE PLAT OF HIGHWAYS SHOWN HEREON IN SECTION 24, TOWNSHIP 40 NORTH, RANGE 10 EAST, AND SECTION 19, TOWNSHIP 40 NORTH, RANGE 11 EAST OF THE THIRD PRINCIPAL MERIDIAN, DUPAGE COUNTY, THAT THE SURVEY IS TRUE AND COMPLETE AS SHOWN TO THE BEST OF MY KNOWLEDGE AND BELIEF; THAT THE PLAT CORRECTLY REPRESENTS SAID SURVEY; THAT ALL MONUMENTS FOUND AND ESTABLISHED ARE OF PERMANENT QUALITY AND OCCUPY THE POSITIONS SHOWN HEREON AND THAT THE MONUMENTS ARE SUFFICIENT TO ENABLE THE SURVEY TO BE RETRACED, MADE FOR THE DEPARTMENT OF TRANSPORTATION, STATE OF ILLINOIS. THIS PROFESSIONAL SERVICE CONFORMS TO THE CURRENT ILLINOIS MINIMUM STANDARDS FOR A BOUNDARY SURVEY FOR THAT PORTION SHOWN AS PROPOSED RIGHT-OF-WAY.

DATED AT ELGIN, ILLINOIS, THIS _____ DAY OF _____, 20__ A.D.

ILLINOIS PROFESSIONAL LAND SURVEYOR NO. 3302
ACCOUNT NO. 2-04-0052(a)

RECEIVED
APR 20 2010
PLATS & LEGALS

REJENA H. LYON
3302 PROFESSIONAL LAND SURVEYOR STATE OF ILLINOIS
ELGIN, ILLINOIS
LICENSE EXPIRES 11/30/2010

ALL BEARINGS ARE BASED ON ILLINOIS STATE PLANE COORDINATE SYSTEM NAD 83, EAST ZONE GRID.

HAMPTON, LENZINI AND RENWICK, INC.
CIVIL ENGINEERS - STRUCTURAL ENGINEERS - LAND SURVEYORS
380 SHEPARD DRIVE
ELGIN, ILLINOIS 60123
847.697.8700 www.hlrengineering.com
104.009959 ILLINOIS PROFESSIONAL DESIGN FIRM & STRUCTURAL ENGINEERING CORP.

PLAT OF HIGHWAYS
STATE OF ILLINOIS
DEPARTMENT OF TRANSPORTATION
F.A.P. 870 (IL RTE 53)

DUPAGE COUNTY PROJECT 143+00 TO STATION 149+00
SECTION JOB NO. R-91-069-00
STATION 143+00 TO STATION 149+00
SCALE: 1"=30' SHEET 18 OF X

BUREAU OF LAND ACQUISITION
201 WEST CENTER COURT
SCHAUMBURG, ILLINOIS 60196

REVISED 4/20/10 REVISED PARCEL 1DS0136TE
REVISED 4/12/10 DELETED PARCEL 1DS0213TE
REVISED 9/1/09 COMBINED PARCELS 1DS0134 & 1DS0135, NEW SUB, OWNERSHIP, PIN
REVISED 10/22/03 ADDED PARCEL 1DS0137; REVISED 1DS0137TE

TOPD UPDATED 7/27/09
FIELD WORK COMPLETED 6/27/03

PART OF SECTION 13, TWP 40 NORTH, RANGE 10 EAST & SECTION 18, TWP 40 NORTH, RANGE 11 EAST OF THE THIRD PRINCIPAL MERIDIAN, DUPAGE COUNTY, ILLINOIS.

| PARCEL NUMBER | OWNER | TOTAL HOLDINGS | AREA TAKEN | PREVIOUS DEDICATION | REMAINDER | AREA OF EASEMENT | PURPOSE OF EASEMENT | TAX NUMBER | PROPERTY ACQUIRED BY |
|---------------|--|----------------|------------|---------------------|-----------|------------------|---------------------|-------------------|----------------------|
| 1DS0138 | Gerald A. Aspito and Jacquelyn J. Aspito, as joint tenants | 1.352 AC± | 0.048 AC ± | NA | 1.304 AC± | NA | NA | 02-13-200-008 | |
| 1DS0138TE | | | NA | NA | NA | 0.033 AC± | GRADING | | |
| 1DS0139TE | Richard H. Stasch and Judith L. Stasch, in joint tenancy | 0.936 AC± | NA | NA | NA | 0.145 AC± | GRADING | 02-13-200-013 | |
| 1DS0140 | Hanmee Presbyterian Church | 7.552 AC± | 0.203 AC± | NA | 7.349 AC± | NA | NA | 03-18-100-013 pt. | |
| 1DS0141 | | | 0.798 AC± | 0.780 AC± | 3.822 AC± | NA | NA | | |
| 1DS3141TE-1 | AGL Investments No. 17, Limited Partnership | 4.620 AC± | NA | NA | NA | 0.275 AC± | GRADING | 02-13-200-016 Pt. | |
| 1DS3141TE-2 | | | NA | NA | NA | 0.185 AC± | GRADING | | |
| 1DS0223 | Matyas Family Trust dated 10-14-1997 | 0.512 AC± | 0.025 AC± | NA | 0.487 AC± | NA | NA | 02-13-200-014 | |
| 1DS0223TE | | | NA | NA | NA | 0.025 AC± | GRADING | | |

LEGEND

- SECTION CORNER
- SECTION LINE
- QUARTER SECTION LINE
- QUARTER, QUARTER SECTION LINE
- PLATTED LOT LINE
- PROPERTY (DEED) LINE
- APL APPARENT PROPERTY LINE
- CENTERLINE
- EXISTING RIGHT OF WAY LINE
- EXISTING EASEMENT
- PROPOSED RIGHT OF WAY LINE
- PROPOSED EASEMENT
- MEASURED DIMENSION
- RECORD DATA

IRON PIPE OR ROD FOUND
 + CUT CROSS FOUND OR SET
 ● T1 THESE STAKES REFERENCE FOUND OR SET MONUMENTATION, SET 5/8 INCH IRON ROD FLUSH WITH THE GROUND TO THE MONUMENTATION, IDENTIFIED BY COLORED PLASTIC CAP BEARING SURVEYORS REGISTRATION NUMBER.
 ● T2
 ● T3
 ● BT1 THESE STAKES, IN CULTIVATED AREAS, REFERENCE FOUND OR SET MONUMENTATION, BURIED 5/8 INCH ROD 20 INCHES BELOW GROUND TO THE MONUMENTATION, IDENTIFIED BY COLORED PLASTIC CAP BEARING SURVEYORS REGISTRATION NUMBER.
 ● BT2
 ● BT3
 ■ STAKING OF PROPOSED RIGHT OF WAY, SET DIVISION OF HIGHWAYS SURVEY MARKER TO MONUMENT THE POSITION SHOWN, IDENTIFIED BY INSCRIPTION DATA AND SURVEYORS REGISTRATION NUMBER.
 ■ M STAKING OF PROPOSED RIGHT OF WAY IN CULTIVATED AREAS, BURIED 5/8 INCH IRON ROD 20 INCHES BELOW GROUND TO MARK FUTURE SURVEY MARKER POSITION, IDENTIFIED BY COLORED PLASTIC CAP BEARING SURVEYORS REGISTRATION NUMBER.
 ● PERMANENT SURVEY MARKER, IDOT STD. 2135 (TO BE SET BY OTHERS)
 □ RIGHT OF WAY STAKING PROPOSED TO BE SET

STATE OF ILLINOIS } SS
 COUNTY OF KANE }

THIS IS TO CERTIFY THAT I, REJENA H. LYON, AN ILLINOIS PROFESSIONAL LAND SURVEYOR, HAVE SURVEYED THE PLAT OF HIGHWAYS SHOWN HEREON IN SECTION 24, TOWNSHIP 40 NORTH, RANGE 10 EAST, AND SECTION 19, TOWNSHIP 40 NORTH, RANGE 11 EAST OF THE THIRD PRINCIPAL MERIDIAN, DUPAGE COUNTY; THAT THE SURVEY IS TRUE AND COMPLETE AS SHOWN TO THE BEST OF MY KNOWLEDGE AND BELIEF; THAT THE PLAT CORRECTLY REPRESENTS SAID SURVEY; THAT ALL MONUMENTS FOUND AND ESTABLISHED ARE OF PERMANENT QUALITY AND OCCUPY THE POSITIONS SHOWN HEREON AND THAT THE MONUMENTS ARE SUFFICIENT TO ENABLE THE SURVEY TO BE RETRACED, MADE FOR THE DEPARTMENT OF TRANSPORTATION, STATE OF ILLINOIS. THIS PROFESSIONAL SERVICE CONFORMS TO THE CURRENT ILLINOIS MINIMUM STANDARDS FOR A BOUNDARY SURVEY FOR THAT PORTION SHOWN AS PROPOSED RIGHT-OF-WAY.

DATED AT ELGIN, ILLINOIS, THIS _____ DAY OF _____, 20__ A.D.

ILLINOIS PROFESSIONAL LAND SURVEYOR NO. 3302
 ACCOUNT NO. 2-04-0052(g)

REJENA H. LYON
 3302 PROFESSIONAL LAND SURVEYOR STATE OF ILLINOIS
 ELGIN, ILLINOIS
 LICENSE EXPIRES 1/30/2010

ALL BEARINGS ARE BASED ON ILLINOIS STATE PLANE COORDINATE SYSTEM NAD 83, EAST ZONE GRID.



TOPO UPDATED 7/27/09
 FIELD WORK COMPLETED 6/27/03

HAMPTON, LENZINI AND RENWICK, INC.
 CIVIL ENGINEERS - STRUCTURAL ENGINEERS - LAND SURVEYORS
HLR
 380 SHEPARD DRIVE
 ELGIN, ILLINOIS 60123
 847.697.6700 www.hirengineering.com
 104.000955
 ILLINOIS PROFESSIONAL DESIGN FIRM & STRUCTURAL ENGINEERING CORP.

PLAT OF HIGHWAYS
 STATE OF ILLINOIS
 DEPARTMENT OF TRANSPORTATION
 F.A.P. 870 (IL RTE 53)

DuPAGE COUNTY SECTION
 PROJECT JOB NO. R-91-069-00
 STATION 148+00 TO STATION 155+00
 SCALE: 1"=40' SHEET 19 OF X

BUREAU OF LAND ACQUISITION
 201 WEST CENTER COURT
 SCHAMBURG, ILLINOIS 60196

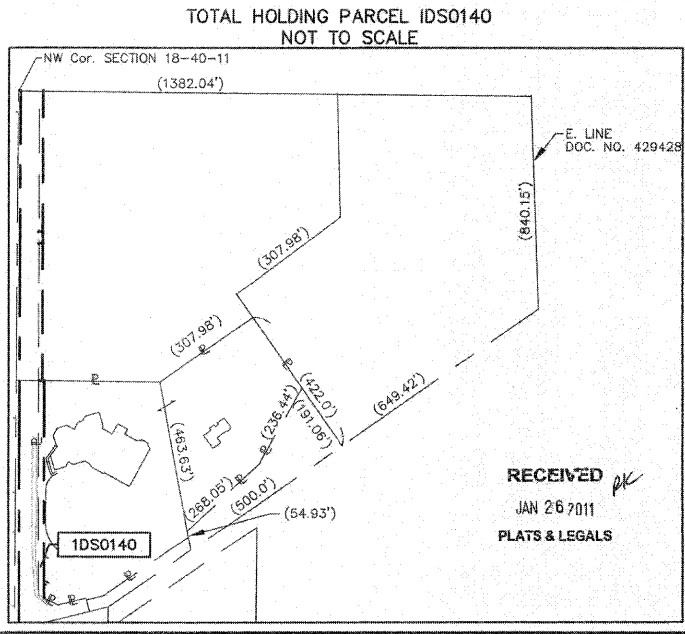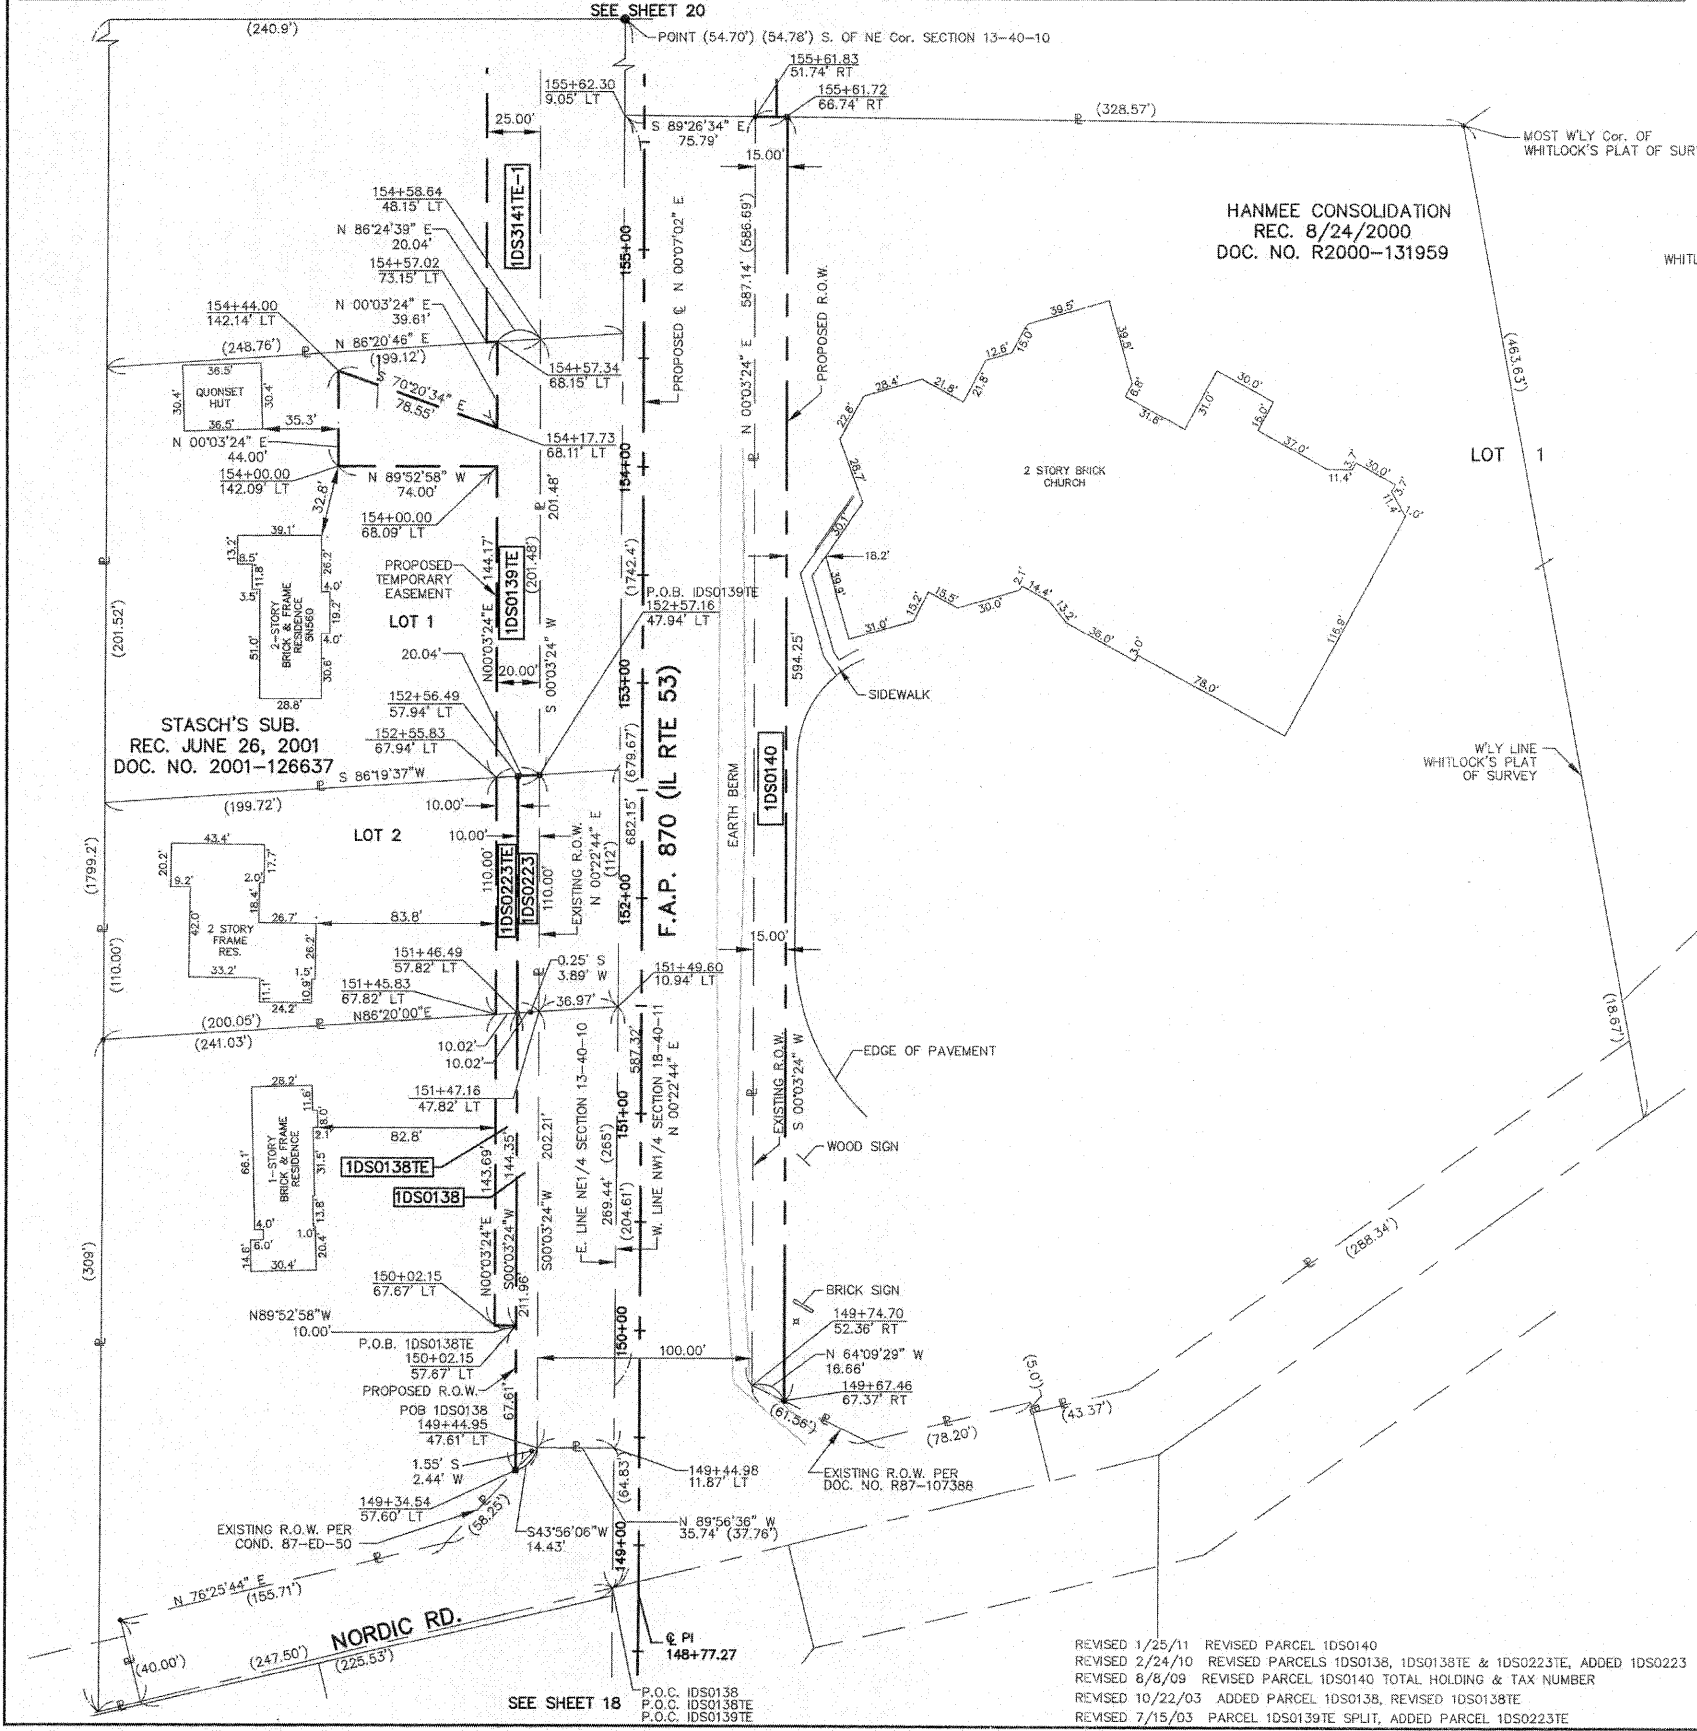

F.A.P. 870 (IL RTE 53)

DuPAGE COUNTY JOB NO. R-91-069-00

404

PART OF SECTION 13, TWP 40 NORTH, RANGE 10 EAST & SECTION 18, TWP 40 NORTH, RANGE 11 EAST OF THE THIRD PRINCIPAL MERIDIAN, DUPAGE COUNTY, ILLINOIS.

| PARCEL NUMBER | OWNER | TOTAL HOLDINGS | AREA TAKEN | PREVIOUS DEDICATION | REMAINDER | AREA OF EASEMENT | PURPOSE OF EASEMENT | TAX NUMBER | PROPERTY ACQUIRED BY |
|---------------|---|----------------|-----------------|---------------------|------------|--------------------|---------------------|---------------------|----------------------|
| 1DS0141 | | | 0.798 AC± | 0.798 AC± | 3.822 AC± | NA | NA | | |
| 1DS3141TE-1 | AGL Investments No. 17 Limited Partnership | 4.620 AC± | NA | NA | NA | 0.275 AC± | GRADING | 02-13-200-018 Pt. | |
| 1DS3141TE-2 | | | NA | NA | NA | 0.185 AC± | GRADING | | |
| 1DS0142 DED-A | Itasca Park District, a Municipal Corporation | 18.738 AC± | 0.007 AC(320SF) | NA | 18.738 AC± | NA | NA | 03-18-100-017 | R2006-244468 |
| 1DS0142 DED-B | | | 0.016 AC±* | NA | NA | NA | NA | 03-18-100-016 | |
| 1DS3142TE-1 | | | NA | NA | NA | 0.086 AC± | GRADING | 03-18-100-017 | R2009-106535 |
| 1DS3142TE-2 | | | NA | NA | NA | 0.746 AC± | GRADING & DRIVE | 03-18-100-016 & 017 | |
| 1DS0143PE | Village of Itasca | 1.853 AC± | NA | NA | NA | 0.007 AC± (298 SF) | BRIDGE | 02-13-200-015 | R2007-114323 |
| 1DS0143TE | | | NA | NA | NA | 0.185 AC± | GRADING | | R2007-114324 |

* AREA TO BE ACQUIRED BY DEDICATION ONLY

LEGEND

SECTION CORNER
QUARTER SECTION CORNER

SECTION LINE
QUARTER SECTION LINE
QUARTER, QUARTER SECTION LINE
PLATTED LOT LINE
PROPERTY (DEED) LINE

APL
APPARENT PROPERTY LINE
CENTERLINE
EXISTING RIGHT OF WAY LINE
EXISTING EASEMENT
PROPOSED RIGHT OF WAY LINE
PROPOSED EASEMENT
MEASURED DIMENSION
RECORD DATA

EXISTING BUILDINGS

IRON PIPE OR ROD FOUND
CUT CROSS FOUND OR SET
PK NAIL FOUND OR SET
5/8" REBAR SET

T1, T2, T3: THESE STAKES REFERENCE FOUND OR SET MONUMENTATION, SET 5/8 INCH IRON ROD FLUSH WITH THE GROUND TO THE MONUMENTATION, IDENTIFIED BY COLORED PLASTIC CAP BEARING SURVEYORS REGISTRATION NUMBER.





BT1, BT2, BT3: THESE STAKES, IN CULTIVATED AREAS, REFERENCE FOUND OR SET MONUMENTATION, BURIED 5/8 INCH ROD 20 INCHES BELOW GROUND TO THE MONUMENTATION, IDENTIFIED BY COLORED PLASTIC CAP BEARING SURVEYORS REGISTRATION NUMBER.

S: STAKING OF PROPOSED RIGHT OF WAY SET DIVISION OF HIGHWAYS SURVEY MARKER TO MONUMENT THE POSITION SHOWN, IDENTIFIED BY INSCRIPTION, DATA AND SURVEYORS REGISTRATION NUMBER.

M: STAKING OF PROPOSED RIGHT OF WAY IN CULTIVATED AREAS, BURIED 5/8 INCH IRON ROD 20 INCHES BELOW GROUND TO MARK FUTURE SURVEY MARKER POSITION, IDENTIFIED BY COLORED PLASTIC CAP BEARING SURVEYORS REGISTRATION NUMBER.

PM: PERMANENT SURVEY MARKER, IDOT STD. 2135 (TO BE SET BY OTHERS)

R: RIGHT OF WAY STAKING PROPOSED TO BE SET

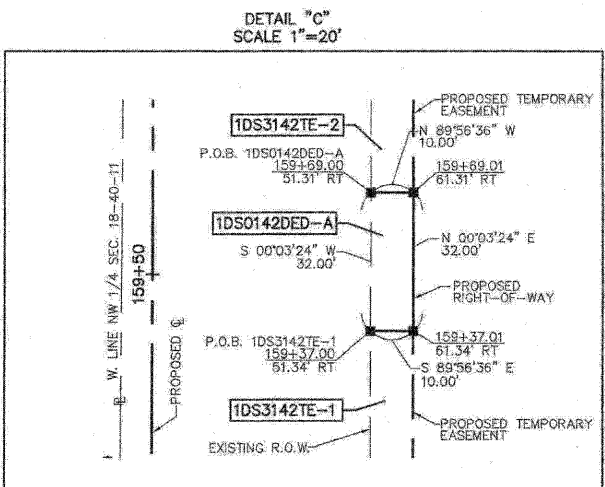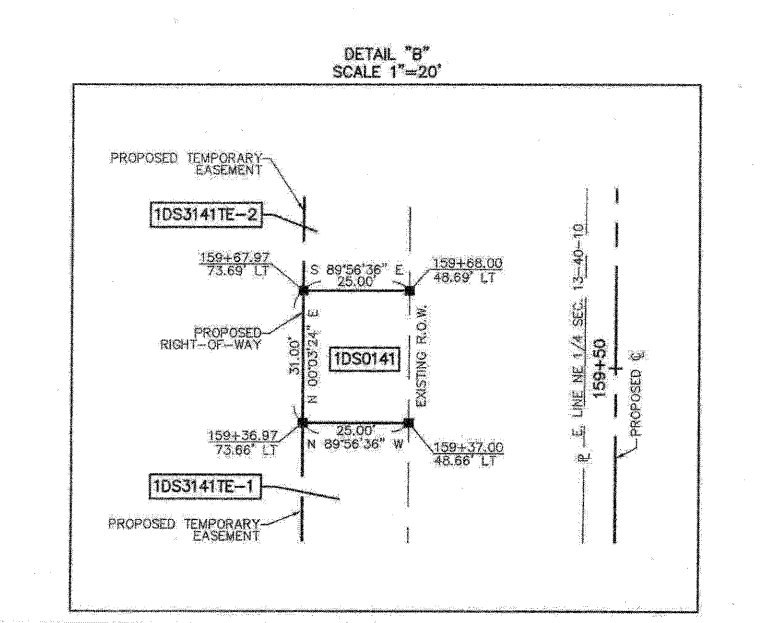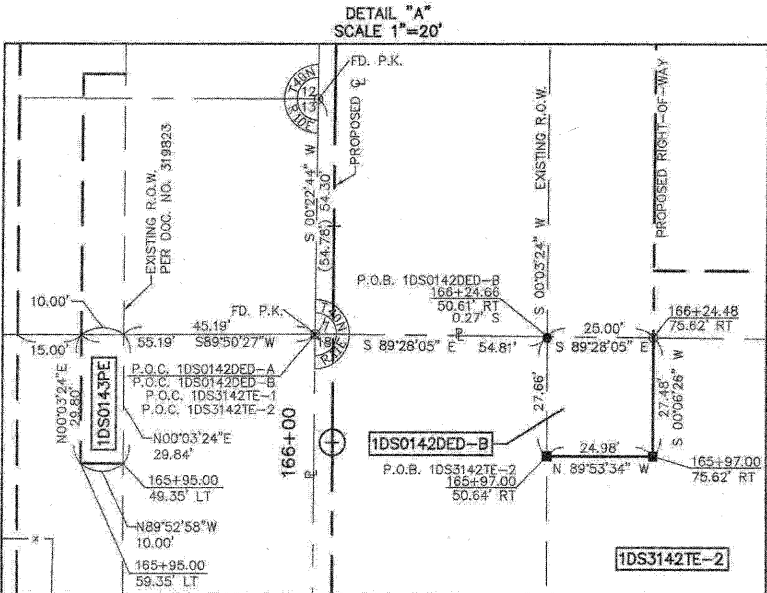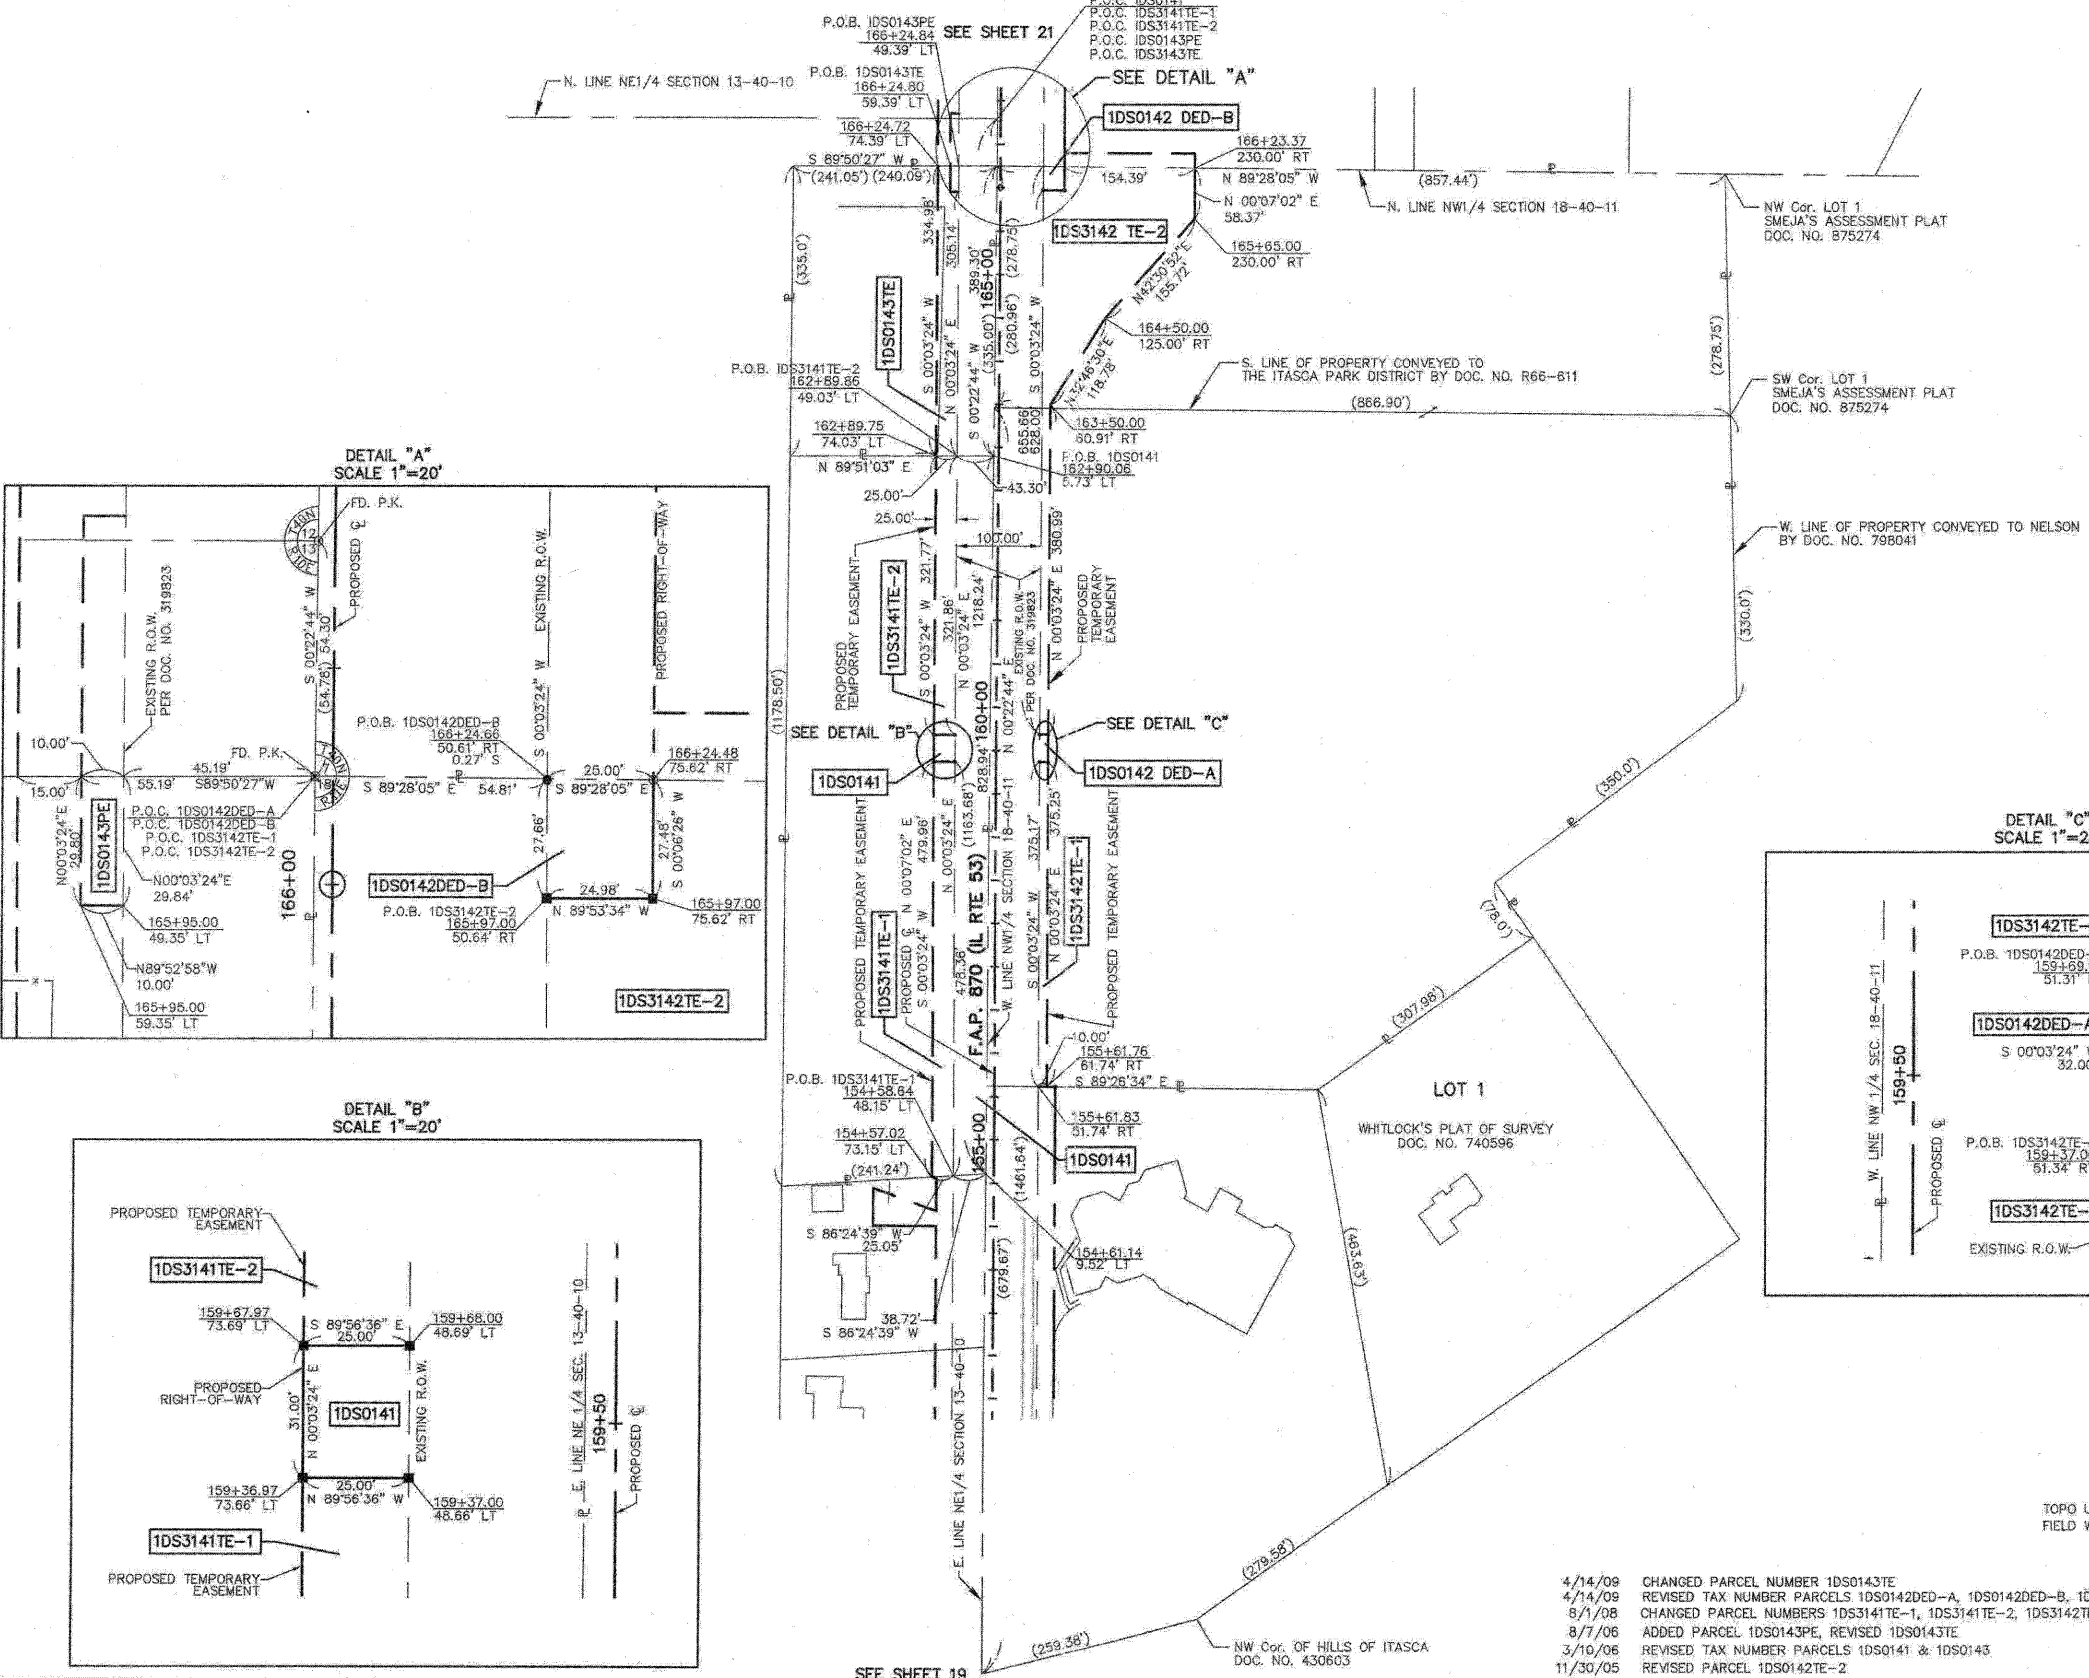

STATE OF ILLINOIS)
COUNTY OF KANE)

THIS IS TO CERTIFY THAT I, REJENA H. LYON, AN ILLINOIS PROFESSIONAL LAND SURVEYOR, HAVE SURVEYED THE PLAT OF HIGHWAYS SHOWN HEREON IN SECTION 24, TOWNSHIP 40 NORTH, RANGE 10 EAST, AND SECTION 19, TOWNSHIP 40 NORTH, RANGE 11 EAST OF THE THIRD PRINCIPAL MERIDIAN, DUPAGE COUNTY, THAT THE SURVEY IS TRUE AND COMPLETE AS SHOWN TO THE BEST OF MY KNOWLEDGE AND BELIEF; THAT THE PLAT CORRECTLY REPRESENTS SAID SURVEY; THAT ALL MONUMENTS FOUND AND ESTABLISHED ARE OF PERMANENT QUALITY AND OCCUPY THE POSITIONS SHOWN HEREON AND THAT THE MONUMENTS ARE SUFFICIENT TO ENABLE THE SURVEY TO BE RETRACED, MADE FOR THE DEPARTMENT OF TRANSPORTATION, STATE OF ILLINOIS. THIS PROFESSIONAL SERVICE CONFORMS TO THE CURRENT ILLINOIS MINIMUM STANDARDS FOR A BOUNDARY SURVEY FOR THAT PORTION SHOWN AS PROPOSED RIGHT-OF-WAY.

DATED AT ELGIN, ILLINOIS, THIS _____ DAY OF _____, 20__ A.D.

ILLINOIS PROFESSIONAL LAND SURVEYOR NO. 3302
ACCOUNT NO. 2-04-0052(g)

REJENA H. LYON
3302
PROFESSIONAL
LAND
SURVEYOR
STATE OF
ILLINOIS
ELGIN, ILLINOIS
LICENSE EXPIRES 11/30/2010

ALL BEARINGS ARE BASED ON ILLINOIS STATE PLANE COORDINATE SYSTEM NAD 83, EAST ZONE GRID.

RECEIVED
SEP 02 2009
PLATS & LEGALS

HAMPTON, LENZINI AND RENWICK, INC.
CIVIL ENGINEERS - STRUCTURAL ENGINEERS - LAND SURVEYORS

380 SHEPARD DRIVE
ELGIN, ILLINOIS 60123
847.697.8700 www.hltengineering.com

184.000959
ILLINOIS PROFESSIONAL DESIGN FIRM & STRUCTURAL ENGINEERING CORP.

PLAT OF HIGHWAYS
STATE OF ILLINOIS
DEPARTMENT OF TRANSPORTATION
F.A.P. 870 (IL RTE 53)

DuPAGE COUNTY SECTION
PROJECT JOB NO. R-91-069-00
STATION 154+00 TO STATION 167+00
SCALE: 1"=100' SHEET 20 OF X

BUREAU OF LAND ACQUISITION
201 WEST CENTER COURT
SCHAMBERG, ILLINOIS 60196

4/14/09 CHANGED PARCEL NUMBER 1DS0143TE
4/14/09 REVISED TAX NUMBER PARCELS 1DS0142DED-A, 1DS0142DED-B, 1DS3142TE-1, & 1DS3142TE-2
8/1/08 CHANGED PARCEL NUMBERS 1DS3141TE-1, 1DS3141TE-2, 1DS3142TE-1, 1DS3142TE-2, & 1DS3143TE
8/7/06 ADDED PARCEL 1DS0143PE, REVISED 1DS0143TE
3/10/06 REVISED TAX NUMBER PARCELS 1DS0141 & 1DS0143
11/30/05 REVISED PARCEL 1DS0142TE-2

PART OF SECTION 12, TWP 40 NORTH, RANGE 10 EAST & SECTION 7, TWP 40 NORTH, RANGE 11 EAST OF THE THIRD PRINCIPAL MERIDIAN, DUPAGE COUNTY, ILLINOIS.

| PARCEL NUMBER | OWNER | TOTAL HOLDINGS | AREA TAKEN | PREVIOUS DEDICATION | REMAINDER | AREA OF EASEMENT | PURPOSE OF EASEMENT | TAX NUMBER | PROPERTY ACQUIRED BY |
|---------------|---|----------------|--------------------|---------------------|-----------|------------------|---------------------|---------------|----------------------|
| 1DS2144PE | Chicago Title Land Trust, as Trustee under the provisions of a Trust Agreement dated the 1st day of November 1970 known as Trust Number 38203 | 2,966 AC± | NA | NA | NA | 0.014 AC± | BRIDGE | 02-12-404-004 | R2007-114325 |
| 1DS3144TE | | | NA | NA | NA | 0.075 AC± | GRADING | | R2009-083351 |
| 1DS0145 | Spring Lake L.L.C., an Illinois Limited Liability Company | 4,079 AC± | 0.271 AC± | NA | 3,808 AC± | NA | NA | 03-07-301-013 | R2007-038112 |
| 1DS3145TE | | | NA | NA | NA | 0.057 AC± | DRIVEWAY | | R2009-061372 |
| 1DS0147 | First American Bank, as Trustee under Trust No. F89-167, dated December 1, 1989 | 0.225 AC± | 0.004 AC (183 SF)± | NA | 0.221 AC± | NA | NA | 02-12-405-074 | COND. 08ED000138 |

LEGEND

- IRON PIPE OR ROD FOUND
- + CUT CROSS FOUND OR SET
- T1 THESE STAKES REFERENCE FOUND OR SET MONUMENTATION, SET 5/8 INCH IRON ROD FLUSH WITH THE GROUND TO THE MONUMENTATION, IDENTIFIED BY COLORED PLASTIC CAP BEARING SURVEYORS REGISTRATION NUMBER.
- T2
- T3
- BT1 THESE STAKES, IN CULTIVATED AREAS, REFERENCE FOUND OR SET MONUMENTATION, BURIED 5/8 INCH ROD 20 INCHES BELOW GROUND TO THE MONUMENTATION, IDENTIFIED BY COLORED PLASTIC CAP BEARING SURVEYORS REGISTRATION NUMBER.
- BT2
- BT3
- STAKING OF PROPOSED RIGHT OF WAY, SET DIVISION OF HIGHWAYS SURVEY MARKER TO MONUMENT THE POSITION SHOWN, IDENTIFIED BY INSCRIPTION DATA AND SURVEYORS REGISTRATION NUMBER.
- M STAKING OF PROPOSED RIGHT OF WAY IN CULTIVATED AREAS, BURIED 5/8 INCH IRON ROD 20 INCHES BELOW GROUND TO MARK FUTURE SURVEY MARKER POSITION, IDENTIFIED BY COLORED PLASTIC CAP BEARING SURVEYORS REGISTRATION NUMBER.
- PERMANENT SURVEY MARKER, IDOT STD. 2135 (TO BE SET BY OTHERS)
- RIGHT OF WAY STAKING PROPOSED TO BE SET

SECTION CORNER
QUARTER SECTION CORNER

SECTION LINE
QUARTER SECTION LINE
QUARTER, QUARTER SECTION LINE
PLATTED LOT LINE
PROPERTY (DEED) LINE

APL APPARENT PROPERTY LINE
CENTERLINE
EXISTING RIGHT OF WAY LINE
EXISTING EASEMENT
PROPOSED RIGHT OF WAY LINE
PROPOSED EASEMENT
MEASURED DIMENSION
RECORD DATA


EXISTING BUILDINGS

STATE OF ILLINOIS }
COUNTY OF KANE }
SS

THIS IS TO CERTIFY THAT I, REJENA H. LYON, AN ILLINOIS PROFESSIONAL LAND SURVEYOR, HAVE SURVEYED THE PLAT OF HIGHWAYS SHOWN HEREON IN SECTION 24, TOWNSHIP 40 NORTH, RANGE 10 EAST, AND SECTION 19, TOWNSHIP 40 NORTH, RANGE 11 EAST OF THE THIRD PRINCIPAL MERIDIAN, DUPAGE COUNTY; THAT THE SURVEY IS TRUE AND COMPLETE AS SHOWN TO THE BEST OF MY KNOWLEDGE AND BELIEF; THAT THE PLAT CORRECTLY REPRESENTS SAID SURVEY; THAT ALL MONUMENTS FOUND AND ESTABLISHED ARE OF PERMANENT QUALITY AND OCCUPY THE POSITIONS SHOWN HEREON AND THAT THE MONUMENTS ARE SUFFICIENT TO ENABLE THE SURVEY TO BE RETRACED, MADE FOR THE DEPARTMENT OF TRANSPORTATION, STATE OF ILLINOIS. THIS PROFESSIONAL SERVICE CONFORMS TO THE CURRENT ILLINOIS MINIMUM STANDARDS FOR A BOUNDARY SURVEY FOR THAT PORTION SHOWN AS PROPOSED RIGHT-OF-WAY.

DATED AT ELGIN, ILLINOIS, THIS _____ DAY OF _____, 20__ A.D.

ILLINOIS PROFESSIONAL LAND SURVEYOR NO. 3302
ACCOUNT NO. 2-04-0052(a)

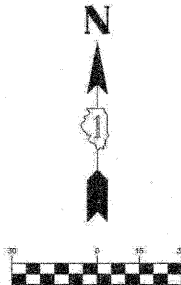

ALL BEARINGS ARE BASED ON ILLINOIS STATE PLANE COORDINATE SYSTEM NAD 83, EAST ZONE GRID.

RECEIVED
SEP 02 2009
PLATS & LEGALS


TOPO UPDATED 7/27/09
FIELD WORK COMPLETED 6/27/03

HAMPTON, LENZINI AND RENWICK, INC.
CIVIL ENGINEERS - STRUCTURAL ENGINEERS - LAND SURVEYORS
380 SHEPARD DRIVE
ELGIN, ILLINOIS 60123
847.697.6700 www.hlrengineering.com

PLAT OF HIGHWAYS
STATE OF ILLINOIS
DEPARTMENT OF TRANSPORTATION
F.A.P. 870 (IL RTE 53)

DUPAGE COUNTY PROJECT 166+00 TO STATION 171+00
SECTION JOB NO. R-91-069-00
SCALE: 1"=30' SHEET 21 OF X

BUREAU OF LAND ACQUISITION
201 WEST CENTER COURT
SCHAMBURG, ILLINOIS 60196

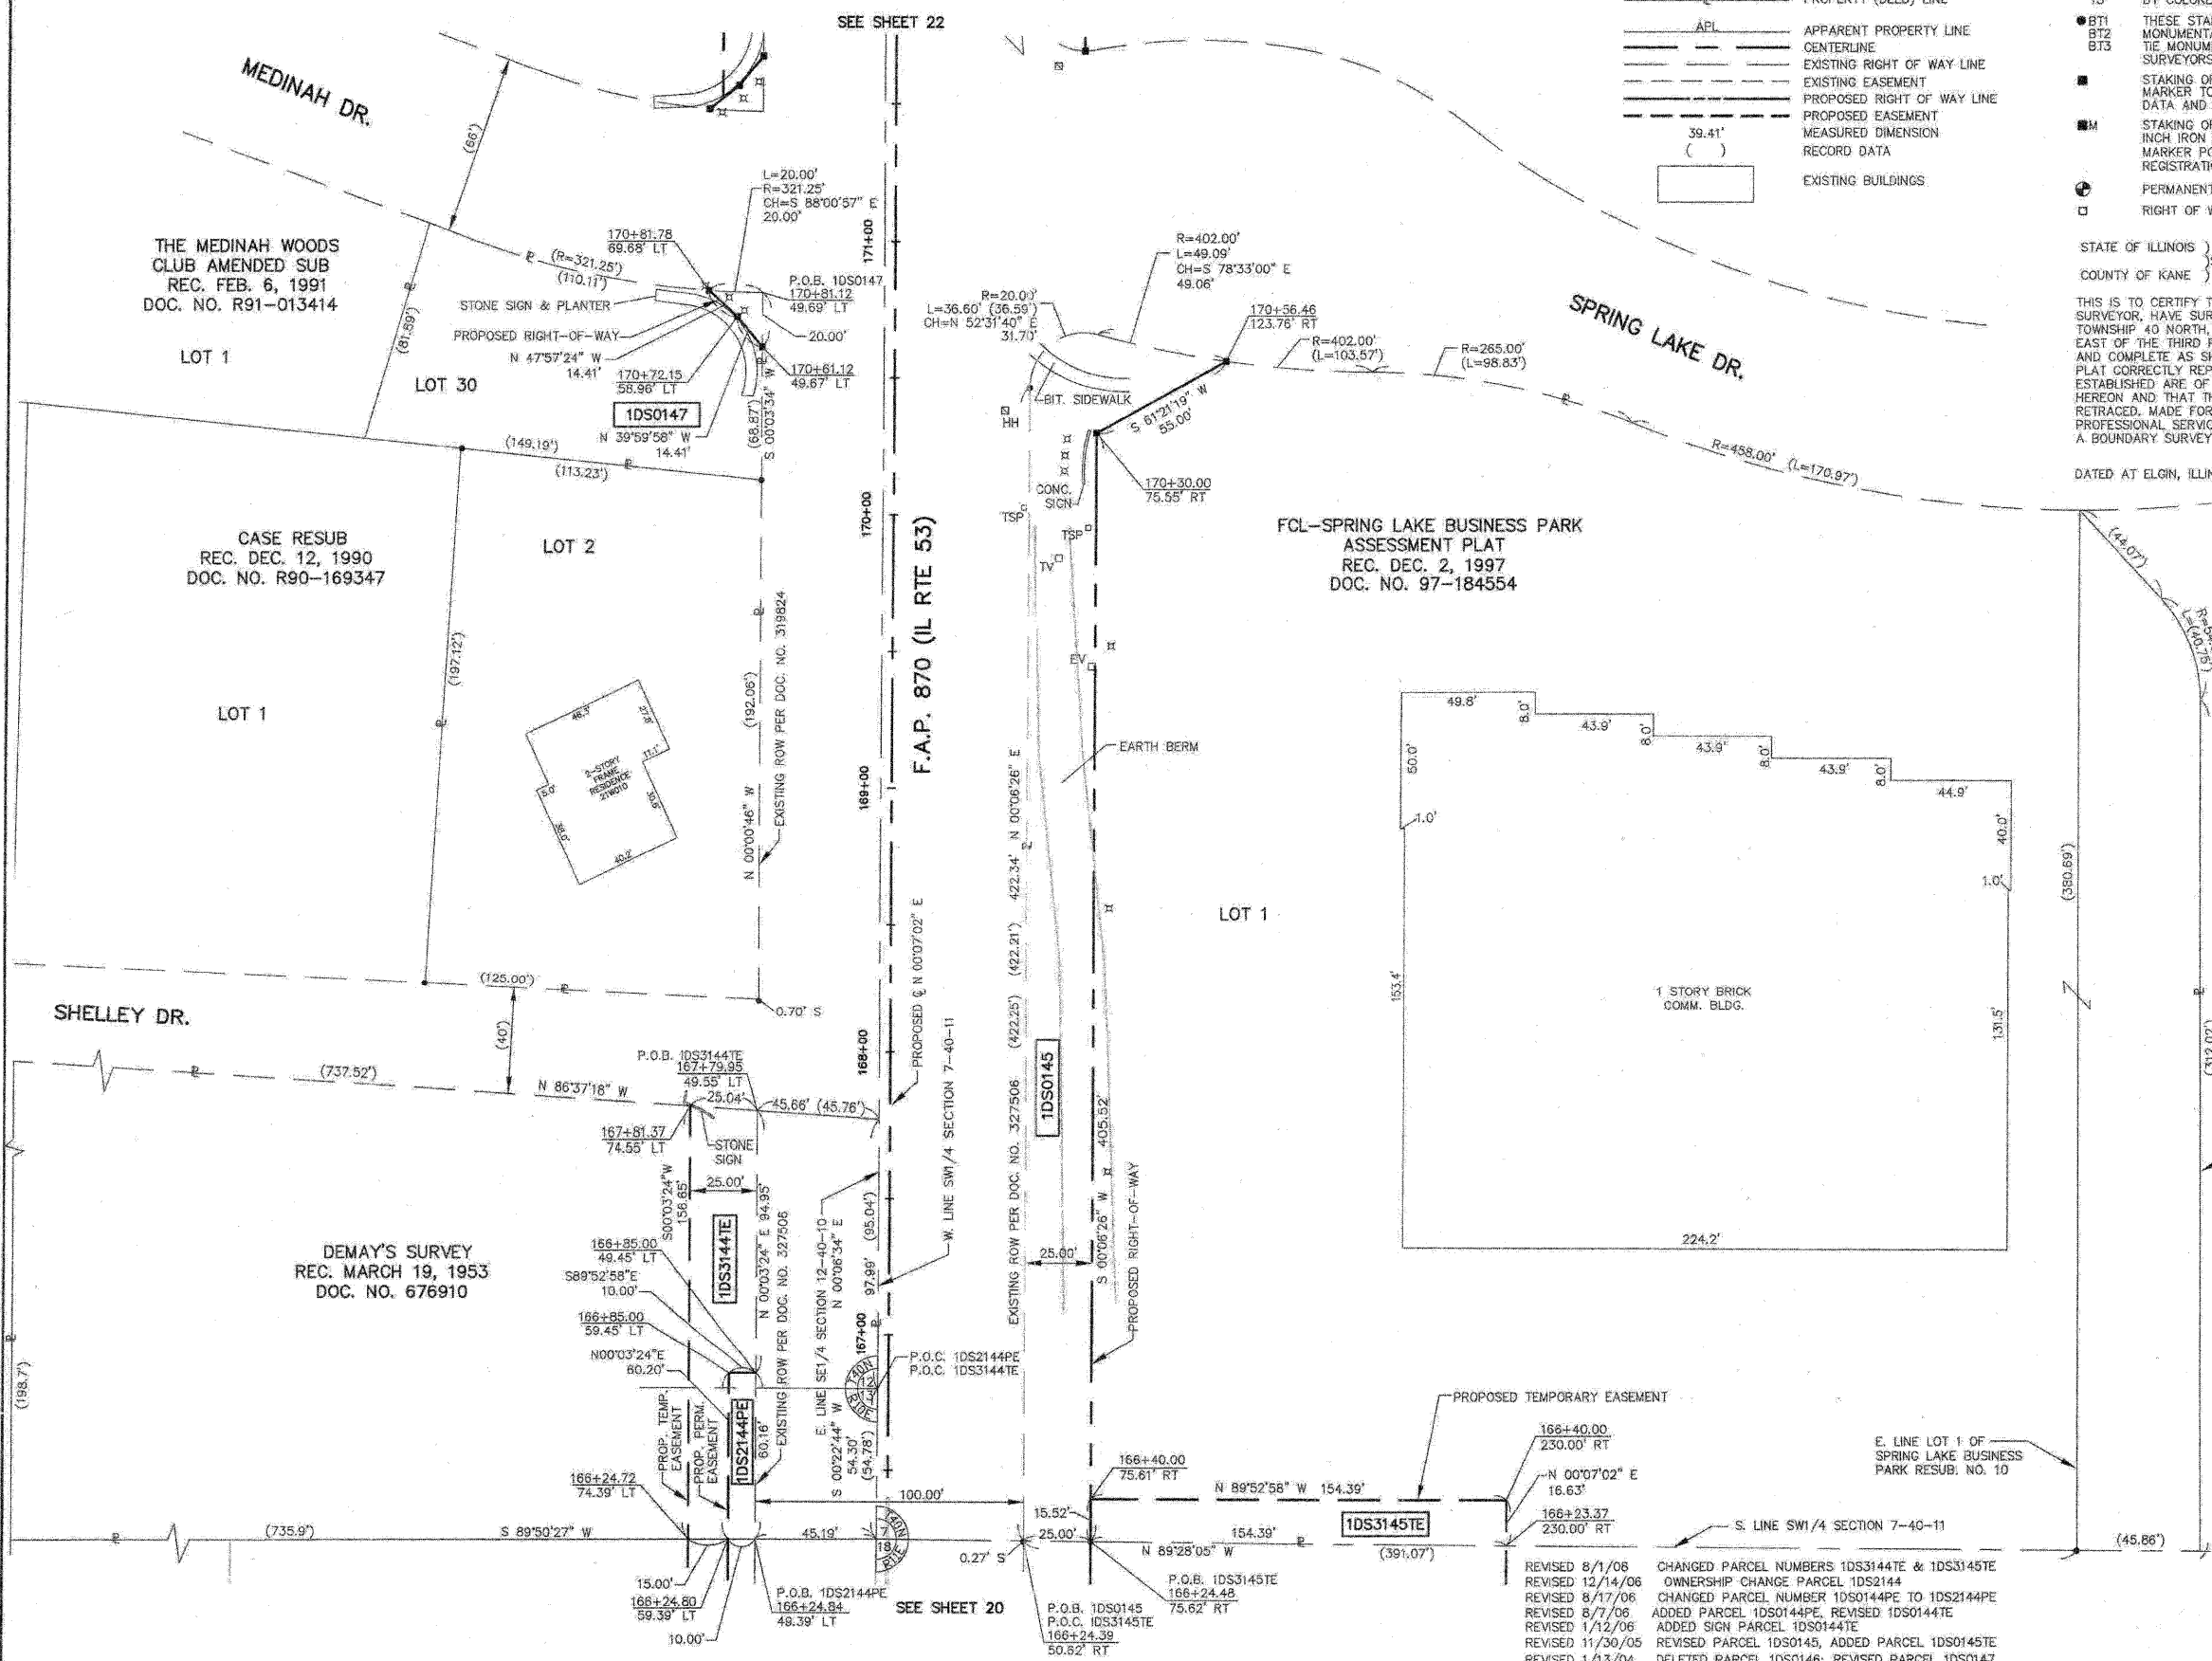

PART OF SECTION 12, TWP 40 NORTH, RANGE 10 EAST & SECTION 7, TWP 40 NORTH, RANGE 11 EAST OF THE THIRD PRINCIPAL MERIDIAN, DUPAGE COUNTY, ILLINOIS.

| PARCEL NUMBER | OWNER | TOTAL HOLDINGS | AREA TAKEN | PREVIOUS DEDICATION | REMAINDER | AREA OF EASEMENT | PURPOSE OF EASEMENT | TAX NUMBER | PROPERTY ACQUIRED BY |
|---------------|---|----------------|--------------------|---------------------|-----------|------------------|---------------------|-------------------|----------------------|
| 1DS0148 | Medinah Woods Club Townhome Association, Inc. and Medinah Woods Club Homeowners Association, an Illinois not-for-profit corporation each to an undivided 1/2 interest | 0.401 AC± | 0.004 AC (182 SF)± | NA | 0.397 AC± | NA | NA | 02-12-405-155 | |
| 1DS01487E | | | NA | NA | NA | 0.049 AC± | GRADING | | |
| 1DS0149 | National Safety Council, a Federally Chartered not-for-profit corporation | 8.034 AC± | 0.161 AC± | NA | 7.873 AC± | NA | NA | 03-07-302-004 | R2007-011085 |
| 1DS0150 | Medinah Woods Club Townhome Association, Inc. | 0.668 AC± | 0.187 AC± | NA | 0.481 AC± | NA | NA | 02-12-405-151(pt) | |
| 1DS0151 | Spring Lake Business Park Association, an Illinois not-for-profit corporation | 3.343 AC± | 0.128 AC± | NA | 5.217 AC± | NA | NA | 03-07-302-003 | |
| 1DS0198 | HSBC Mortgage Corporation (USA) | 0.116 AC± | 0.003 AC (142 SF)± | NA | 0.113 AC± | NA | NA | 02-12-405-134 | |
| 1DS0199TE | Medinah Woods Club Townhome Association, Inc. and Medinah Woods Club Homeowners Association, an Illinois not-for-profit corporation each to an undivided 1/2 interest | 0.609 AC± | NA | NA | NA | 0.015 AC± | GRADING | 02-12-405-151(pt) | |

LEGEND

SECTION CORNER
QUARTER SECTION CORNER

SECTION LINE
QUARTER SECTION LINE
QUARTER, QUARTER SECTION LINE
PLATTED LOT LINE
PROPERTY (DEED) LINE

APL APPARENT PROPERTY LINE
CENTERLINE
EXISTING RIGHT OF WAY LINE
EXISTING EASEMENT
PROPOSED RIGHT OF WAY LINE
PROPOSED EASEMENT
MEASURED DIMENSION
RECORD DATA

EXISTING BUILDINGS

IRON PIPE OR ROD FOUND
CUT CROSS FOUND OR SET
T1 THESE STAKES REFERENCE FOUND OR SET MONUMENTATION, SET 5/8 INCH IRON ROD FLUSH WITH THE GROUND TO THE MONUMENTATION, IDENTIFIED BY COLORED PLASTIC CAP BEARING SURVEYORS REGISTRATION NUMBER.
T2
T3
BT1 THESE STAKES, IN CULTIVATED AREAS, REFERENCE FOUND OR SET MONUMENTATION, BURIED 5/8 INCH ROD 20 INCHES BELOW GROUND TO THE MONUMENTATION, IDENTIFIED BY COLORED PLASTIC CAP BEARING SURVEYORS REGISTRATION NUMBER.
BT2
BT3
S STAKING OF PROPOSED RIGHT OF WAY, SET DIVISION OF HIGHWAYS SURVEY MARKER TO MONUMENT THE POSITION SHOWN, IDENTIFIED BY INSCRIPTION DATA AND SURVEYORS REGISTRATION NUMBER.
M STAKING OF PROPOSED RIGHT OF WAY IN CULTIVATED AREAS, BURIED 5/8 INCH IRON ROD 20 INCHES BELOW GROUND TO MARK FUTURE SURVEY MARKER POSITION, IDENTIFIED BY COLORED PLASTIC CAP BEARING SURVEYORS REGISTRATION NUMBER.
P PERMANENT SURVEY MARKER, IDOT STD. 2135 (TO BE SET BY OTHERS)
R RIGHT OF WAY STAKING PROPOSED TO BE SET

STATE OF ILLINOIS }
COUNTY OF KANE }SS

THIS IS TO CERTIFY THAT I, REJENA H. LYON, AN ILLINOIS PROFESSIONAL LAND SURVEYOR, HAVE SURVEYED THE PLAT OF HIGHWAYS SHOWN HEREON IN SECTION 24, TOWNSHIP 40 NORTH, RANGE 10 EAST, AND SECTION 19, TOWNSHIP 40 NORTH, RANGE 11 EAST OF THE THIRD PRINCIPAL MERIDIAN, DUPAGE COUNTY, THAT THE SURVEY IS TRUE AND COMPLETE AS SHOWN TO THE BEST OF MY KNOWLEDGE AND BELIEF; THAT THE PLAT CORRECTLY REPRESENTS SAID SURVEY; THAT ALL MONUMENTS FOUND AND ESTABLISHED ARE OF PERMANENT QUALITY AND OCCUPY THE POSITIONS SHOWN HEREON AND THAT THE MONUMENTS ARE SUFFICIENT TO ENABLE THE SURVEY TO BE RETRACED, MADE FOR THE DEPARTMENT OF TRANSPORTATION, STATE OF ILLINOIS. THIS PROFESSIONAL SERVICE CONFORMS TO THE CURRENT ILLINOIS MINIMUM STANDARDS FOR A BOUNDARY SURVEY FOR THAT PORTION SHOWN AS PROPOSED RIGHT-OF-WAY.

DATED AT ELGIN, ILLINOIS, THIS ____ DAY OF _____, 20____ A.D.

ILLINOIS PROFESSIONAL LAND SURVEYOR NO. 3302
ACCOUNT NO. 2-04-0052(a)

RECEIVED
AUG 13 2010
PLATS & LEGALS

3302 PROFESSIONAL LAND SURVEYOR STATE OF ILLINOIS
REJENA H. LYON
ELGIN, ILLINOIS
LICENSE EXPIRES 11/30/2010

ALL BEARINGS ARE BASED ON ILLINOIS STATE PLANE COORDINATE SYSTEM, NAD 83, EAST ZONE GRID.

TOPO UPDATED 7/27/09
FIELD WORK COMPLETED 6/27/09



HAMPTON, LENZINI AND RENWICK, INC.
CIVIL ENGINEERS • STRUCTURAL ENGINEERS • LAND SURVEYORS
380 SHEPARD DRIVE
ELGIN, ILLINOIS 60123
847.697.6700 www.hirengineering.com

194.00089
ILLINOIS PROFESSIONAL DESIGN FIRM & STRUCTURAL ENGINEERING CORP.

PLAT OF HIGHWAYS
STATE OF ILLINOIS
DEPARTMENT OF TRANSPORTATION
F.A.P. 870 (IL RTE 53)

DUPAGE COUNTY SECTION
PROJECT JOB NO. R-91-069-00
STATION 171+00 TO STATION 178+50
SCALE: 1"=40' SHEET 22 OF X

BUREAU OF LAND ACQUISITION
201 WEST CENTER COURT
SCHAUMBURG, ILLINOIS 60196

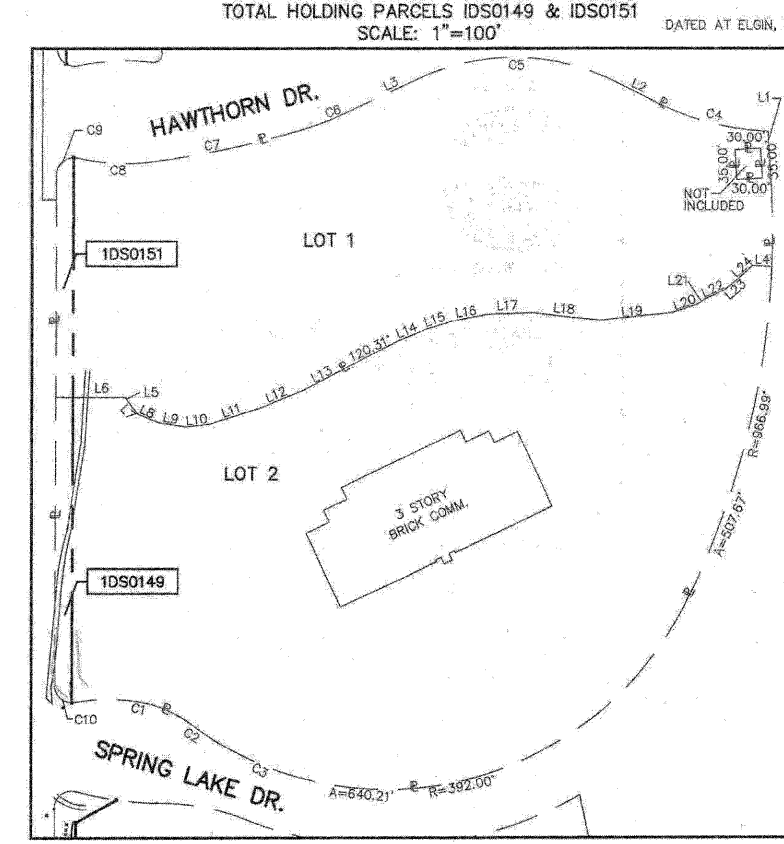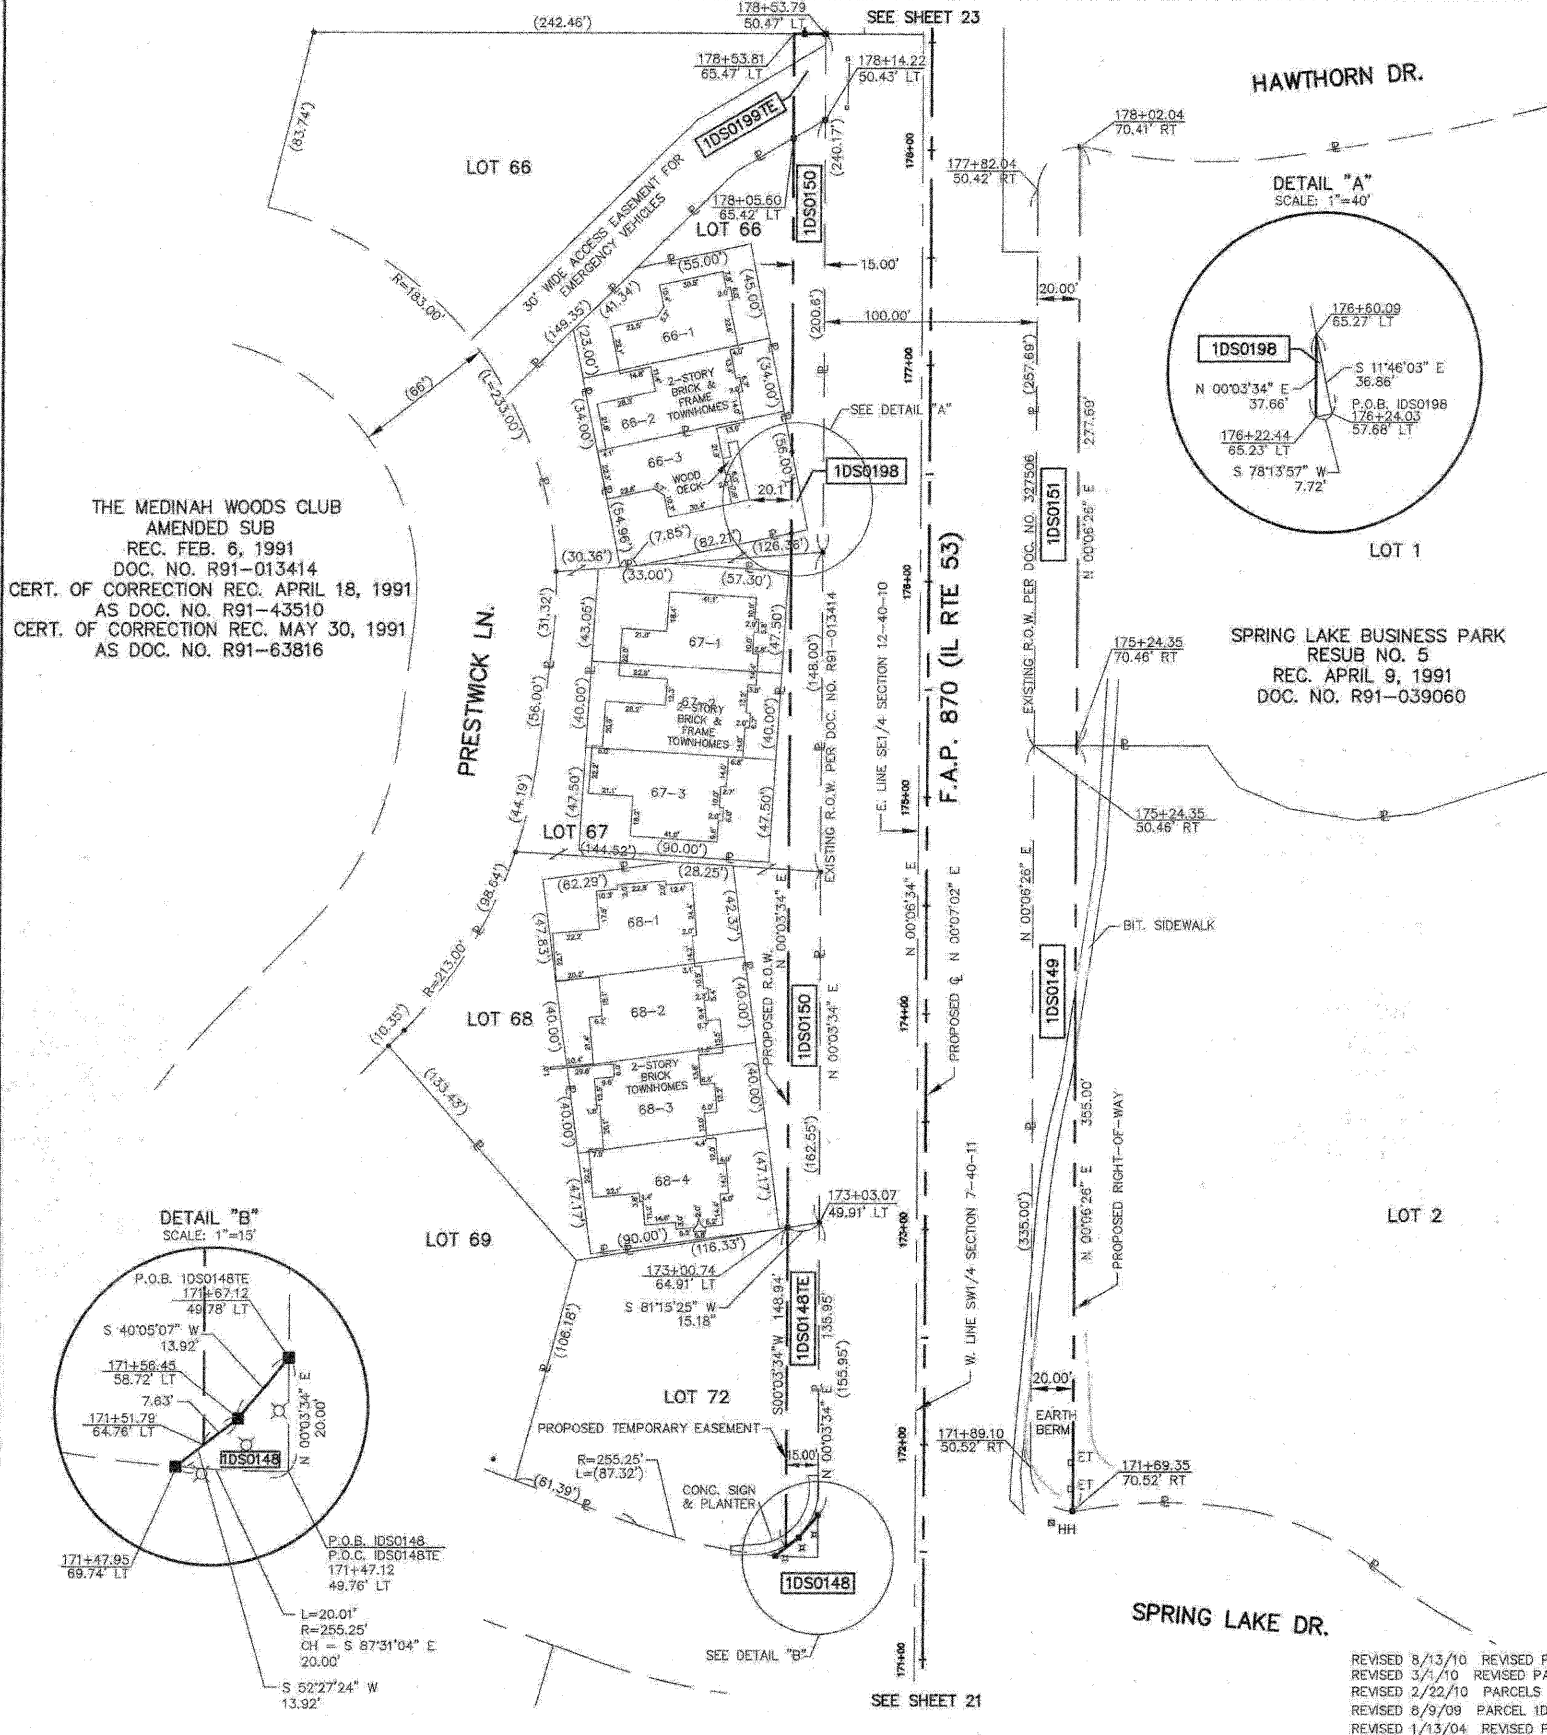

PART OF SECTION 12, TWP 40 NORTH, RANGE 10 EAST & PART OF SECTION 7, TWP 40 NORTH, RANGE 11 EAST OF THE THIRD PRINCIPAL MERIDIAN, DUPAGE COUNTY, ILLINOIS.

| PARCEL NUMBER | OWNER | TOTAL HOLDINGS | AREA TAKEN | PREVIOUS DEDICATION | REMAINDER | AREA OF EASEMENT | PURPOSE OF EASEMENT | TAX NUMBER | PROPERTY ACQUIRED BY |
|---------------|---|----------------|------------|---------------------|-------------------|------------------|---------------------|------------------|----------------------|
| 1DS0150 | Medinah Woods Club Townhome Association, Inc. | 0.668 AC± | 0.187 AC± | NA | 0.481 AC± | NA | NA | 02-12-405-191(p) | |
| 1DS0151 | Spring Lake Business Park Association, an Illinois not-for-profit corporation | 5.343 AC± | 0.126 AC± | NA | 5.217 AC± | NA | NA | 03-07-302-003 | |
| 1DS0152 | Keith Graft | 1.959 AC± | 0.081 AC± | NA | 1.878 AC± | NA | NA | 02-12-402-020 | |
| 1DS0152TE | | | NA | NA | 0.002 AC (70 SF)± | DRIVE | | | |
| 1DS0153 | Harvey O.Huebner and Leana M. Huebner; husband and wife, in joint tenancy | 0.786 AC± | 0.042 AC± | NA | 0.744 AC± | NA | NA | 02-12-402-017 | |
| 1DS0199TE | Medinah Woods Club Townhome Association, Inc. and Medinah Woods Club Homeowners Association, an Illinois not-for-profit corporation each to an undivided 1/2 interest | 0.609 AC± | NA | NA | NA | 0.015 AC± | GRADING | 02-12-405-151(p) | |
| 1DS0214 | Spring Lake Business Park Association, an Illinois not-for-profit corporation | 0.478 AC± | 0.084 AC± | NA | 0.394 AC± | NA | NA | 03-07-303-001 | |

LEGEND

SECTION CORNER
QUARTER SECTION CORNER

SECTION LINE
QUARTER SECTION LINE
QUARTER, QUARTER SECTION LINE
PLATTED LOT LINE
PROPERTY (DEED) LINE

APL APPARENT PROPERTY LINE
CENTERLINE
EXISTING RIGHT OF WAY LINE
EXISTING EASEMENT
PROPOSED RIGHT OF WAY LINE
PROPOSED EASEMENT
MEASURED DIMENSION
RECORD DATA

EXISTING BUILDINGS

IRON PIPE OR ROD FOUND
CUT CROSS FOUND OR SET
PK NAIL FOUND OR SET
5/8" REBAR SET

THESE STAKES REFERENCE FOUND OR SET MONUMENTATION, SET 5/8" IRON ROD FLUSH WITH THE GROUND TO THE MONUMENTATION, IDENTIFIED BY COLORED PLASTIC CAP BEARING SURVEYORS REGISTRATION NUMBER.

THESE STAKES, IN CULTIVATED AREAS, REFERENCE FOUND OR SET MONUMENTATION, BURIED 5/8" IRON ROD 20 INCHES BELOW GROUND TO THE MONUMENTATION, IDENTIFIED BY COLORED PLASTIC CAP BEARING SURVEYORS REGISTRATION NUMBER.

STAKING OF PROPOSED RIGHT OF WAY, SET DIVISION OF HIGHWAYS SURVEY MARKER TO MONUMENT THE POSITION SHOWN, IDENTIFIED BY INSCRIPTION DATA AND SURVEYORS REGISTRATION NUMBER.

STAKING OF PROPOSED RIGHT OF WAY IN CULTIVATED AREAS, BURIED 5/8" IRON ROD 20 INCHES BELOW GROUND TO MARK FUTURE SURVEY MARKER POSITION, IDENTIFIED BY COLORED PLASTIC CAP BEARING SURVEYORS REGISTRATION NUMBER.

PERMANENT SURVEY MARKER, IDOT STD. 2135 (TO BE SET BY OTHERS)

RIGHT OF WAY STAKING PROPOSED TO BE SET

STATE OF ILLINOIS }
COUNTY OF KANE }

THIS IS TO CERTIFY THAT I, REJENA H. LYON, AN ILLINOIS PROFESSIONAL LAND SURVEYOR, HAVE SURVEYED THE PLAT OF HIGHWAYS SHOWN HEREON IN SECTION 24, TOWNSHIP 40 NORTH, RANGE 10 EAST, AND SECTION 19, TOWNSHIP 40 NORTH, RANGE 11 EAST OF THE THIRD PRINCIPAL MERIDIAN, DUPAGE COUNTY; THAT THE SURVEY IS TRUE AND COMPLETE AS SHOWN TO THE BEST OF MY KNOWLEDGE AND BELIEF; THAT THE PLAT CORRECTLY REPRESENTS SAID SURVEY; THAT ALL MONUMENTS FOUND AND ESTABLISHED ARE OF PERMANENT QUALITY AND OCCUPY THE POSITIONS SHOWN HEREON AND THAT THE MONUMENTS ARE SUFFICIENT TO ENABLE THE SURVEY TO BE RETRACED, MADE FOR THE DEPARTMENT OF TRANSPORTATION, STATE OF ILLINOIS. THIS PROFESSIONAL SERVICE CONFORMS TO THE CURRENT ILLINOIS MINIMUM STANDARDS FOR A BOUNDARY SURVEY FOR THAT PORTION SHOWN AS PROPOSED RIGHT-OF-WAY.

DATED AT ELGIN, ILLINOIS, THIS ____ DAY OF _____, 20__ A.D.

ILLINOIS PROFESSIONAL LAND SURVEYOR NO. 3302
ACCOUNT NO. 2-04-0052(a)

RECEIVED
MAR 01 2010
PLATS & LEGALS

ALL BEARINGS ARE BASED ON ILLINOIS STATE PLANE COORDINATE SYSTEM NAD 83, EAST ZONE GRID.

REJENA H. LYON
3302 PROFESSIONAL LAND SURVEYOR
STATE OF ILLINOIS
ELGIN, ILLINOIS
LICENSE EXPIRES 11/30/2010

HAMPTON, LENZINI AND RENWICK, INC.
CIVIL ENGINEERS - STRUCTURAL ENGINEERS - LAND SURVEYORS
380 SHEPARD DRIVE
ELGIN, ILLINOIS 60123
847.897.0700 www.hlrengineering.com

184 00088
ILLINOIS PROFESSIONAL DESIGN FIRM & STRUCTURAL ENGINEERING CORP.



PLAT OF HIGHWAYS
STATE OF ILLINOIS
DEPARTMENT OF TRANSPORTATION
F.A.P. 870 (IL RTE 53)

DUPAGE COUNTY SECTION
PROJECT JOB NO. R-91-069-00
STATION 1774+00 TO STATION 1834+00
SCALE: 1"=30' SHEET 23 OF X

BUREAU OF LAND ACQUISITION
201 WEST CENTER COURT
SCHAUMBURG, ILLINOIS 60196

TOPO UPDATED 7/27/09
FIELD WORK COMPLETED 6/27/03

REVISED 3/1/10 REVISED PARCEL 1DS0150TE TO FEE TAKE
REVISED 2/22/10 PARCEL 1DS0199TE OWNERSHIP CHANGE
REVISED 8/9/09 PARCEL 1DS0152 OWNERSHIP CHANGE;
PARCEL 1DS0150TE TAX NUMBER CHANGE
REVISED 1/13/04 CHANGED PARCELS 1DS0150 & 1DS0199 TO TE'S.

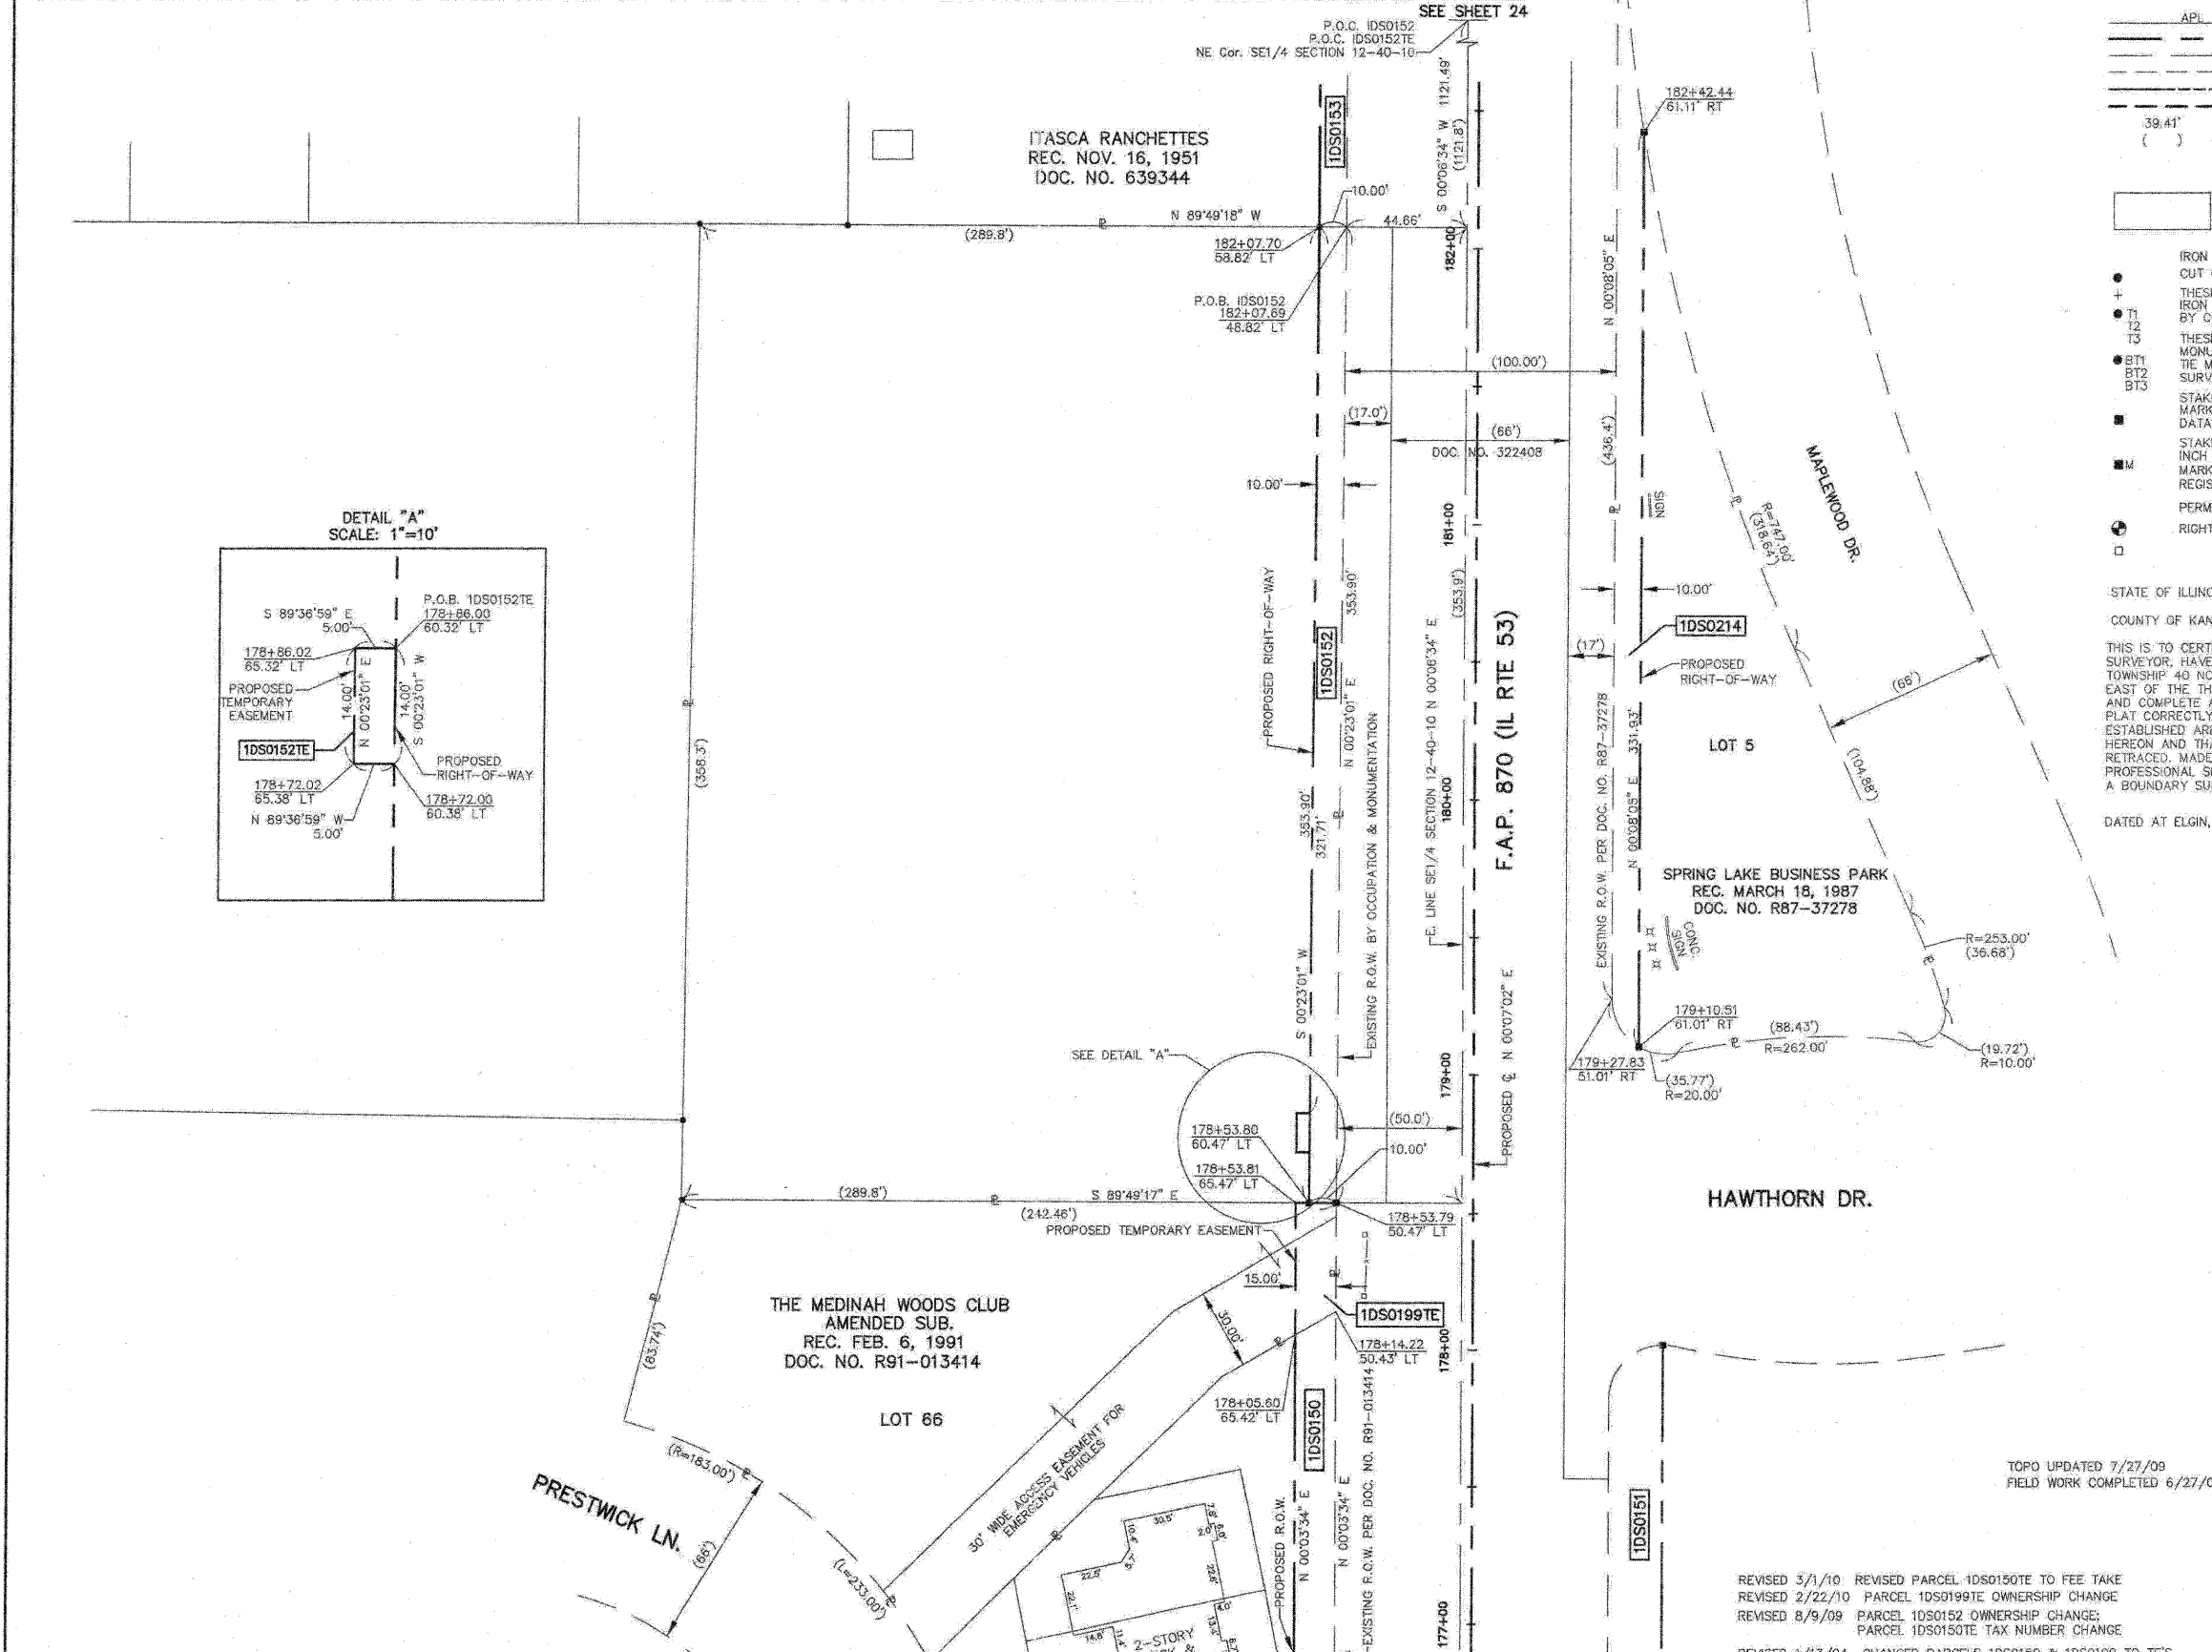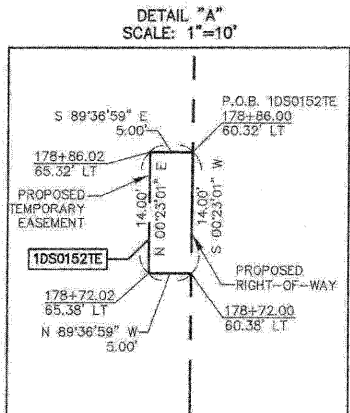

F.A.P. 870 (IL RTE 53)

DUPAGE COUNTY JOB NO. R-91-069-00

| PARCEL NUMBER | OWNER | TOTAL HOLDINGS | AREA TAKEN | PREVIOUS DEDICATION | REMAINDER | AREA OF EASEMENT | PURPOSE OF EASEMENT | TAX NUMBER | PROPERTY ACQUIRED BY |
|---------------|---|----------------|------------|---------------------|-----------|------------------|---------------------|---------------|----------------------|
| 1DS0153 | Harvey O. Huebner and Leona M. Huebner, husband and wife, in joint tenancy | 0.786 AC± | 0.042 AC± | NA | 0.744 AC± | NA | NA | 02-12-402-017 | |
| 1DS0215 | Elzbieta Rozenkova and Stanislav Rozenkova, husband and wife, as tenants by the entirety | 0.459 AC± | 0.011 AC± | NA | 0.448 AC± | NA | NA | 02-12-212-034 | |
| 1DS0216 | West Suburban Bank, as Trustee, under the provisions of a Trust Agreement dated April 5, 1985 and known as Trust No. 3811 | 0.459 AC± | 0.011 AC± | NA | 0.448 AC± | NA | NA | 02-12-212-033 | |
| 1DS0217 | Lonnie Campbell and Alma R. Campbell, husband and wife, as tenants by the entirety | 0.459 AC± | 0.011 AC± | NA | 0.448 AC± | NA | NA | 02-12-212-032 | |

LEGEND

SECTION CORNER
QUARTER SECTION CORNER

SECTION LINE
QUARTER SECTION LINE
QUARTER, QUARTER SECTION LINE
PLATTED LOT LINE
PROPERTY (DEED) LINE
APL
APPARENT PROPERTY LINE
CENTERLINE
EXISTING RIGHT OF WAY LINE
EXISTING EASEMENT
PROPOSED RIGHT OF WAY LINE
PROPOSED EASEMENT
MEASURED DIMENSION
RECORD DATA


EXISTING BUILDINGS

- IRON PIPE OR ROD FOUND
- + CUT CROSS FOUND OR SET
- T1 THESE STAKES REFERENCE FOUND OR SET MONUMENTATION, SET 5/8 INCH IRON ROD FLUSH WITH THE GROUND TO THE MONUMENTATION, IDENTIFIED BY COLORED PLASTIC CAP BEARING SURVEYORS REGISTRATION NUMBER.
- T2
- T3
- BT1 THESE STAKES, IN CULTIVATED AREAS, REFERENCE FOUND OR SET MONUMENTATION, BURIED 5/8 INCH ROD 20 INCHES BELOW GROUND TO THE MONUMENTATION, IDENTIFIED BY COLORED PLASTIC CAP BEARING SURVEYORS REGISTRATION NUMBER.
- BT2
- BT3
- STAKING OF PROPOSED RIGHT OF WAY, SET DIVISION OF HIGHWAYS SURVEY MARKER TO MONUMENT THE POSITION SHOWN, IDENTIFIED BY INSCRIPTION DATA AND SURVEYORS REGISTRATION NUMBER.
- M STAKING OF PROPOSED RIGHT OF WAY IN CULTIVATED AREAS, BURIED 5/8 INCH IRON ROD 20 INCHES BELOW GROUND TO MARK FUTURE SURVEY MARKER POSITION, IDENTIFIED BY COLORED PLASTIC CAP BEARING SURVEYORS REGISTRATION NUMBER.
- ⊙ PERMANENT SURVEY MARKER, IDOT STD. 2135 (TO BE SET BY OTHERS)
- RIGHT OF WAY STAKING PROPOSED TO BE SET

STATE OF ILLINOIS }
COUNTY OF KANE }

THIS IS TO CERTIFY THAT I, REJENA H. LYON, AN ILLINOIS PROFESSIONAL LAND SURVEYOR, HAVE SURVEYED THE PLAT OF HIGHWAYS SHOWN HEREON IN SECTION 24, TOWNSHIP 40 NORTH, RANGE 10 EAST, AND SECTION 19, TOWNSHIP 40 NORTH, RANGE 11 EAST OF THE THIRD PRINCIPAL MERIDIAN, DUPAGE COUNTY; THAT THE SURVEY IS TRUE AND COMPLETE AS SHOWN TO THE BEST OF MY KNOWLEDGE AND BELIEF; THAT THE PLAT CORRECTLY REPRESENTS SAID SURVEY; THAT ALL MONUMENTS FOUND AND ESTABLISHED ARE OF PERMANENT QUALITY AND OCCUPY THE POSITIONS SHOWN HEREON AND THAT THE MONUMENTS ARE SUFFICIENT TO ENABLE THE SURVEY TO BE RETRACED, MADE FOR THE DEPARTMENT OF TRANSPORTATION, STATE OF ILLINOIS, THIS PROFESSIONAL SERVICE CONFORMS TO THE CURRENT ILLINOIS MINIMUM STANDARDS FOR A BOUNDARY SURVEY FOR THAT PORTION SHOWN AS PROPOSED RIGHT-OF-WAY.

DATED AT ELGIN, ILLINOIS, THIS _____ DAY OF _____, 20____ A.D.

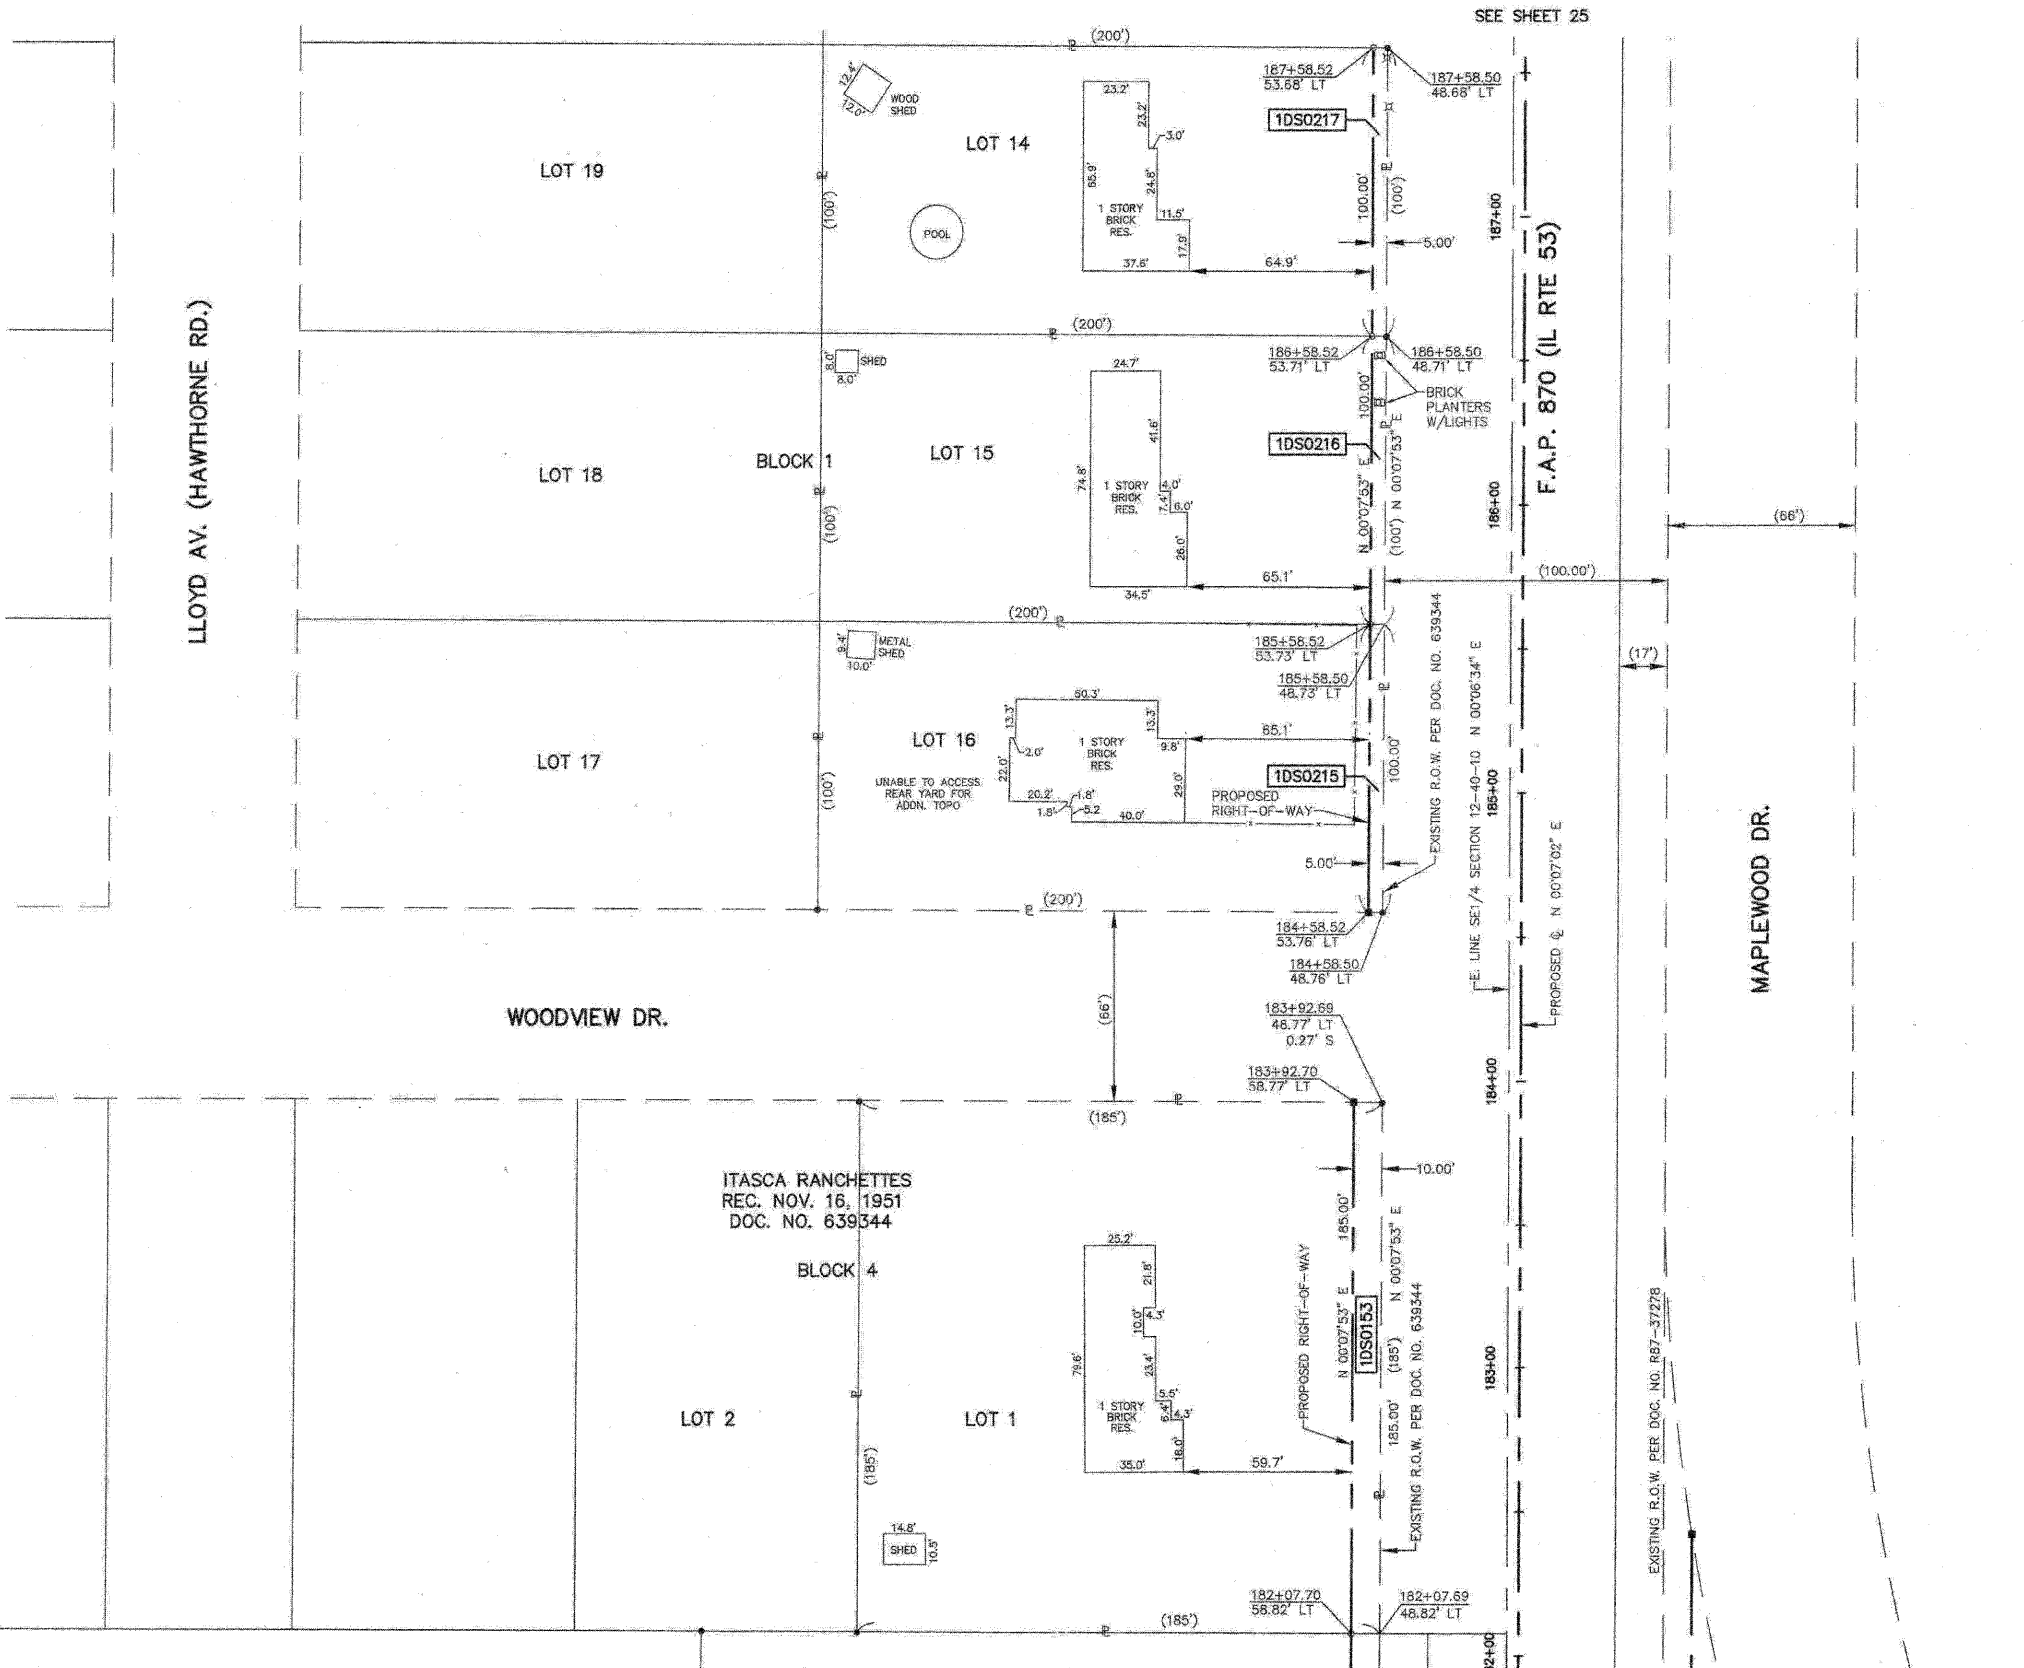

ILLINOIS PROFESSIONAL LAND SURVEYOR NO. 3302
ACCOUNT NO. 2-04-0052(a)

REJENA H. LYON
3302 PROFESSIONAL LAND SURVEYOR STATE OF ILLINOIS
ELGIN, ILLINOIS
LICENSE EXPIRES 11/30/2010

ALL BEARINGS ARE BASED ON ILLINOIS STATE PLANE COORDINATE SYSTEM NAD 83, EAST ZONE GRID.

RECEIVED
AUG 11 2009
PLATS & LEGALS

HAMPTON, LENZINI AND RENWICK, INC.
CIVIL ENGINEERS • STRUCTURAL ENGINEERS • LAND SURVEYORS
380 SHEPARD DRIVE
ELGIN, ILLINOIS 60123
847-697-6700 www.hirengineering.com

184-00989
ILLINOIS PROFESSIONAL DESIGN FIRM & STRUCTURAL ENGINEERING CORP.

PLAT OF HIGHWAYS
STATE OF ILLINOIS
DEPARTMENT OF TRANSPORTATION
F.A.P. 870 (IL RTE 53)

DUPAGE COUNTY SECTION
PROJECT JOB NO. R-91-069-00
STATION 182+00 TO STATION 193+00
SCALE: 1"=30' SHEET 24 OF X

BUREAU OF LAND ACQUISITION
201 WEST CENTER COURT
SCHAUMBURG, ILLINOIS 60196

| PARCEL NUMBER | OWNER | TOTAL HOLDINGS | AREA TAKEN | PREVIOUS DEDICATION | REMAINDER | AREA OF EASEMENT | PURPOSE OF EASEMENT | TAX NUMBER | PROPERTY ACQUIRED BY |
|---------------|--|----------------|------------|---------------------|-----------|------------------|---------------------|---------------|----------------------|
| 1DS0218 | Janina Mostalerz and Josef Mostalerz, wife and husband, and Grazyna Trynka, single never married, as joint tenants | 0.459 AC± | 0.011 AC± | NA | 0.448 AC± | NA | NA | 02-12-212-031 | |
| 1DS0219 | Stanley Jakubowski and Janelle Jakubowski, in joint tenancy | 0.459 AC± | 0.011 AC± | NA | 0.448 AC± | NA | NA | 02-12-212-030 | |
| 1DS0220 | Peter H. Bolts, an unmarried man | 0.459 AC± | 0.011 AC± | NA | 0.448 AC± | NA | NA | 02-12-212-029 | |
| 1DS0221 | David T. Calabrese, a married man | 0.459 AC± | 0.011 AC± | NA | 0.448 AC± | NA | NA | 02-12-212-028 | |
| 1DS0222 | Bruce R. Dahlquist and Jamie Dahlquist, husband and wife, as tenants by the entirety | 0.459 AC± | 0.011 AC± | NA | 0.448 AC± | NA | NA | 02-12-212-027 | |

LEGEND

SECTION CORNER
QUARTER SECTION CORNER

SECTION LINE
QUARTER SECTION LINE
QUARTER, QUARTER SECTION LINE
PLATTED LOT LINE
PROPERTY (DEED) LINE

API
APPARENT PROPERTY LINE
CENTERLINE
EXISTING RIGHT OF WAY LINE
EXISTING EASEMENT
PROPOSED RIGHT OF WAY LINE
PROPOSED EASEMENT
MEASURED DIMENSION
RECORD DATA

EXISTING BUILDINGS

IRON PIPE OR ROD FOUND
CUT CROSS FOUND OR SET
PK NAIL FOUND OR SET
5/8" REBAR SET

THESE STAKES REFERENCE FOUND OR SET MONUMENTATION, SET 5/8 INCH IRON ROD FLUSH WITH THE GROUND TO TIE MONUMENTATION, IDENTIFIED BY COLORED PLASTIC CAP BEARING SURVEYORS REGISTRATION NUMBER.


THESE STAKES, IN CULTIVATED AREAS, REFERENCE FOUND OR SET MONUMENTATION, BURIED 5/8 INCH ROD 20 INCHES BELOW GROUND TO TIE MONUMENTATION, IDENTIFIED BY COLORED PLASTIC CAP BEARING SURVEYORS REGISTRATION NUMBER.

STAKING OF PROPOSED RIGHT OF WAY, SET DIVISION OF HIGHWAYS SURVEY MARKER TO MONUMENT THE POSITION SHOWN, IDENTIFIED BY INSCRIPTION DATA AND SURVEYORS REGISTRATION NUMBER.

STAKING OF PROPOSED RIGHT OF WAY IN CULTIVATED AREAS, BURIED 5/8 INCH IRON ROD 20 INCHES BELOW GROUND TO MARK FUTURE SURVEY MARKER POSITION, IDENTIFIED BY COLORED PLASTIC CAP BEARING SURVEYORS REGISTRATION NUMBER.

PERMANENT SURVEY MARKER, IDOT STD. 2135 (TO BE SET BY OTHERS)

RIGHT OF WAY STAKING PROPOSED TO BE SET

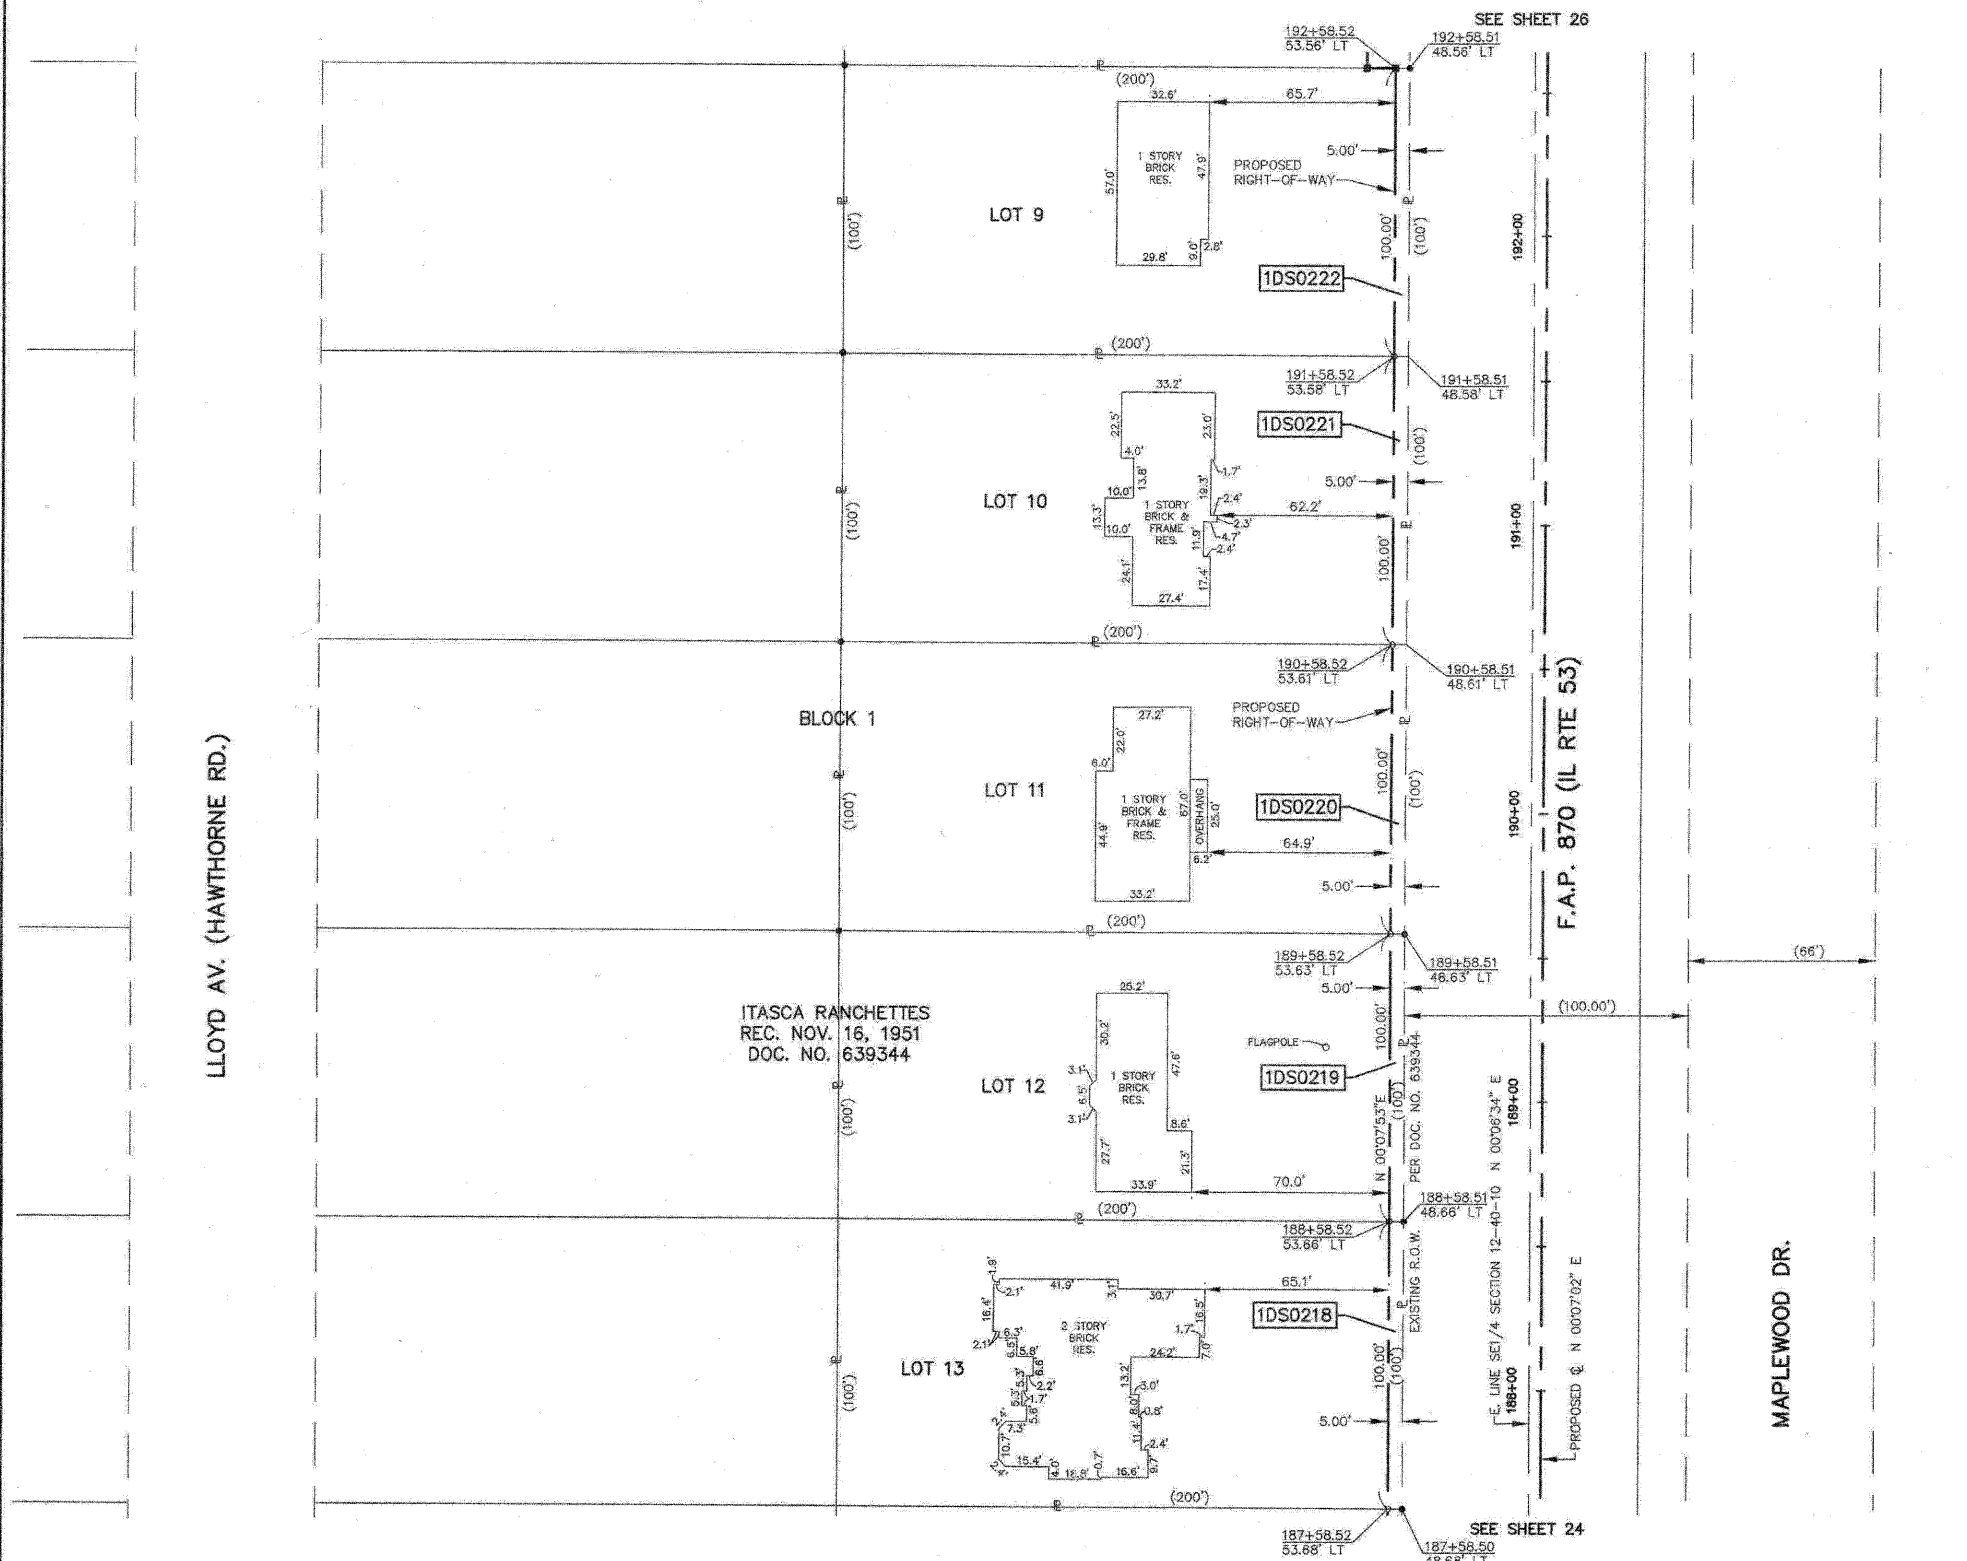

STATE OF ILLINOIS }
COUNTY OF KANE }

THIS IS TO CERTIFY THAT I, REJENA H. LYON, AN ILLINOIS PROFESSIONAL LAND SURVEYOR, HAVE SURVEYED THE PLAT OF HIGHWAYS SHOWN HEREON IN SECTION 24, TOWNSHIP 40 NORTH, RANGE 10 EAST, AND SECTION 19, TOWNSHIP 40 NORTH, RANGE 11 EAST OF THE THIRD PRINCIPAL MERIDIAN, DuPAGE COUNTY, THAT THE SURVEY IS TRUE AND COMPLETE AS SHOWN TO THE BEST OF MY KNOWLEDGE AND BELIEF; THAT THE PLAT CORRECTLY REPRESENTS SAID SURVEY, THAT ALL MONUMENTS FOUND AND ESTABLISHED ARE OF PERMANENT QUALITY AND OCCUPY THE POSITIONS SHOWN HEREON AND THAT THE MONUMENTS ARE SUFFICIENT TO ENABLE THE SURVEY TO BE RETRACED, MADE FOR THE DEPARTMENT OF TRANSPORTATION, STATE OF ILLINOIS. THIS PROFESSIONAL SERVICE CONFORMS TO THE CURRENT ILLINOIS MINIMUM STANDARDS FOR A BOUNDARY SURVEY FOR THAT PORTION SHOWN AS PROPOSED RIGHT-OF-WAY.

DATED AT ELGIN, ILLINOIS, THIS _____ DAY OF _____, 20__ A.D.

ILLINOIS PROFESSIONAL LAND SURVEYOR NO. 3302
ACCOUNT NO. 2-04-0052(e)

REJENA H. LYON
3302 PROFESSIONAL LAND SURVEYOR STATE OF ILLINOIS
ELGIN, ILLINOIS
LICENSE EXPIRES 11/30/2010

ALL BEARINGS ARE BASED ON ILLINOIS STATE PLANE COORDINATE SYSTEM NAD 83, EAST ZONE GRID.

RECEIVED
AUG 11 2009
PLATS & LEGALS

HAMPTON, LENZINI AND RENWICK, INC.
CIVIL ENGINEERS - STRUCTURAL ENGINEERS - LAND SURVEYORS
380 SHEPARD DRIVE
ELGIN, ILLINOIS 60123
847.697.6700 www.hlrengineering.com
184.000899
ILLINOIS PROFESSIONAL DESIGN FIRM & STRUCTURAL ENGINEERING CORP.

TOPO UPDATED 7/27/09
FIELD WORK COMPLETED 6/27/03

PLAT OF HIGHWAYS
STATE OF ILLINOIS
DEPARTMENT OF TRANSPORTATION
F.A.P. 870 (IL RTE 53)

DuPAGE COUNTY SECTION
PROJECT JOB NO. R-91-069-00
STATION 182+00 TO STATION 193+00
SCALE: 1"=30' SHEET 25 OF X

BUREAU OF LAND ACQUISITION
201 WEST CENTER COURT
SCHAUMBURG, ILLINOIS 60196

REVISED 8/09/09 PARCELS 1DS0218, 1DS0220 & 1DS0221 OWNERSHIP CHANGES
REVISED 6/24/03 PARCEL 1DS0221 OWNERSHIP CHANGE

PART OF SECTION 12, TWP 40 NORTH, RANGE 10 EAST & SECTION 7, TWP 40 NORTH, RANGE 11 EAST OF THE THIRD PRINCIPAL MERIDIAN, DUPAGE COUNTY, ILLINOIS.

| PARCEL NUMBER | OWNER | TOTAL HOLDINGS | AREA TAKEN | PREVIOUS DEDICATION | REMAINDER | AREA OF EASEMENT | PURPOSE OF EASEMENT | TAX NUMBER | PROPERTY ACQUIRED BY |
|---------------|--|----------------|------------|---------------------|-----------|------------------|---------------------|---------------|----------------------|
| 1DS0154 | Agata Szymanska and Jaramir Niemiec, as joint tenants | 0.459 AC± | 0.011 AC± | NA | 0.448 AC± | NA | NA | 02-12-212-026 | |
| 1DS0155 | Jeanette Baker, Trustee of the Jeanette Baker Trust dated November 14, 2003 | 0.459 AC± | 0.034 AC± | NA | 0.425 AC± | NA | NA | 02-12-212-025 | |
| 1DS0156 | Victor A. Rescino and Martha M. Rescino, his wife, as joint tenants | 0.459 AC± | 0.034 AC± | NA | 0.425 AC± | NA | NA | 02-12-212-024 | |
| 1DS0157 | Maria Catania | 0.459 AC± | 0.034 AC± | NA | 0.425 AC± | NA | NA | 02-12-212-023 | |
| 1DS0158 | Emma Schmidt Larala as Trustee of the Emma Schmidt Larala Family Trust dated July 24, 2007 | 0.459 AC± | 0.034 AC± | NA | 0.425 AC± | NA | NA | 02-12-212-022 | |
| 1DS0159 | Spring Lake Business Park Association | 0.346 AC± | 0.048 AC± | NA | 0.298 AC± | NA | NA | 03-07-103-012 | |
| 1DS0160A | United States Postal Service | 3.690 AC± | 0.065 AC± | NA | 3.528 AC± | NA | NA | 03-07-103-013 | |
| 1DS0160B | | | 0.097 AC± | NA | | NA | | | |
| 1DS0160E | | | NA | NA | | 0.029 AC± | GRADING | | |

LEGEND

- SECTION LINE
- QUARTER SECTION LINE
- QUARTER, QUARTER SECTION LINE
- PLATTED LOT LINE
- PROPERTY (DEED) LINE
- APL
- APPARENT PROPERTY LINE
- CENTERLINE
- EXISTING RIGHT OF WAY LINE
- EXISTING EASEMENT
- PROPOSED RIGHT OF WAY LINE
- PROPOSED EASEMENT
- MEASURED DIMENSION RECORD DATA

SECTION CORNER
 QUARTER SECTION CORNER

EXISTING BUILDINGS


- IRON PIPE OR ROD FOUND
- + CUT CROSS FOUND OR SET
- T1 THESE STAKES REFERENCE FOUND OR SET MONUMENTATION, SET 5/8 INCH IRON ROD FLUSH WITH THE GROUND TO THE MONUMENTATION, IDENTIFIED BY COLORED PLASTIC CAP BEARING SURVEYORS REGISTRATION NUMBER.
- T2
- T3
- BT1 THESE STAKES, IN CULTIVATED AREAS, REFERENCE FOUND OR SET MONUMENTATION, BURIED 5/8 INCH ROD 20 INCHES BELOW GROUND TO THE MONUMENTATION, IDENTIFIED BY COLORED PLASTIC CAP BEARING SURVEYORS REGISTRATION NUMBER.
- BT2
- BT3
- STAKING OF PROPOSED RIGHT OF WAY, SET DIVISION OF HIGHWAYS SURVEY MARKER TO MONUMENT THE POSITION SHOWN, IDENTIFIED BY INSCRIPTION DATA AND SURVEYORS REGISTRATION NUMBER.
- M STAKING OF PROPOSED RIGHT OF WAY IN CULTIVATED AREAS, BURIED 5/8 INCH IRON ROD 20 INCHES BELOW GROUND TO MARK FUTURE SURVEY MARKER POSITION, IDENTIFIED BY COLORED PLASTIC CAP BEARING SURVEYORS REGISTRATION NUMBER.
- PERMANENT SURVEY MARKER, IDOT STD. 2135 (TO BE SET BY OTHERS)
- RIGHT OF WAY STAKING PROPOSED TO BE SET

STATE OF ILLINOIS }
 COUNTY OF KANE }SS


THIS IS TO CERTIFY THAT I, REJENA H. LYON, AN ILLINOIS PROFESSIONAL LAND SURVEYOR, HAVE SURVEYED THE PLAT OF HIGHWAYS SHOWN HEREON IN SECTION 24, TOWNSHIP 40 NORTH, RANGE 10 EAST, AND SECTION 19, TOWNSHIP 40 NORTH, RANGE 11 EAST OF THE THIRD PRINCIPAL MERIDIAN, DUPAGE COUNTY; THAT THE SURVEY IS TRUE AND COMPLETE AS SHOWN TO THE BEST OF MY KNOWLEDGE AND BELIEF; THAT THE PLAT CORRECTLY REPRESENTS SAID SURVEY; THAT ALL MONUMENTS FOUND AND ESTABLISHED ARE OF PERMANENT QUALITY AND OCCUPY THE POSITIONS SHOWN HEREON AND THAT THE MONUMENTS ARE SUFFICIENT TO ENABLE THE SURVEY TO BE RETRACED, MADE FOR THE DEPARTMENT OF TRANSPORTATION, STATE OF ILLINOIS. THIS PROFESSIONAL SERVICE CONFORMS TO THE CURRENT ILLINOIS MINIMUM STANDARDS FOR A BOUNDARY SURVEY FOR THAT PORTION SHOWN AS PROPOSED RIGHT-OF-WAY.

DATED AT ELGIN, ILLINOIS, THIS _____ DAY OF _____, 20__ A.D.

ILLINOIS PROFESSIONAL LAND SURVEYOR NO. 3302
 ACCOUNT NO. 2-04-0052(a)

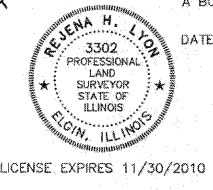

TOTAL HOLDING PARCEL IDS0159
 SCALE: 1"=100'

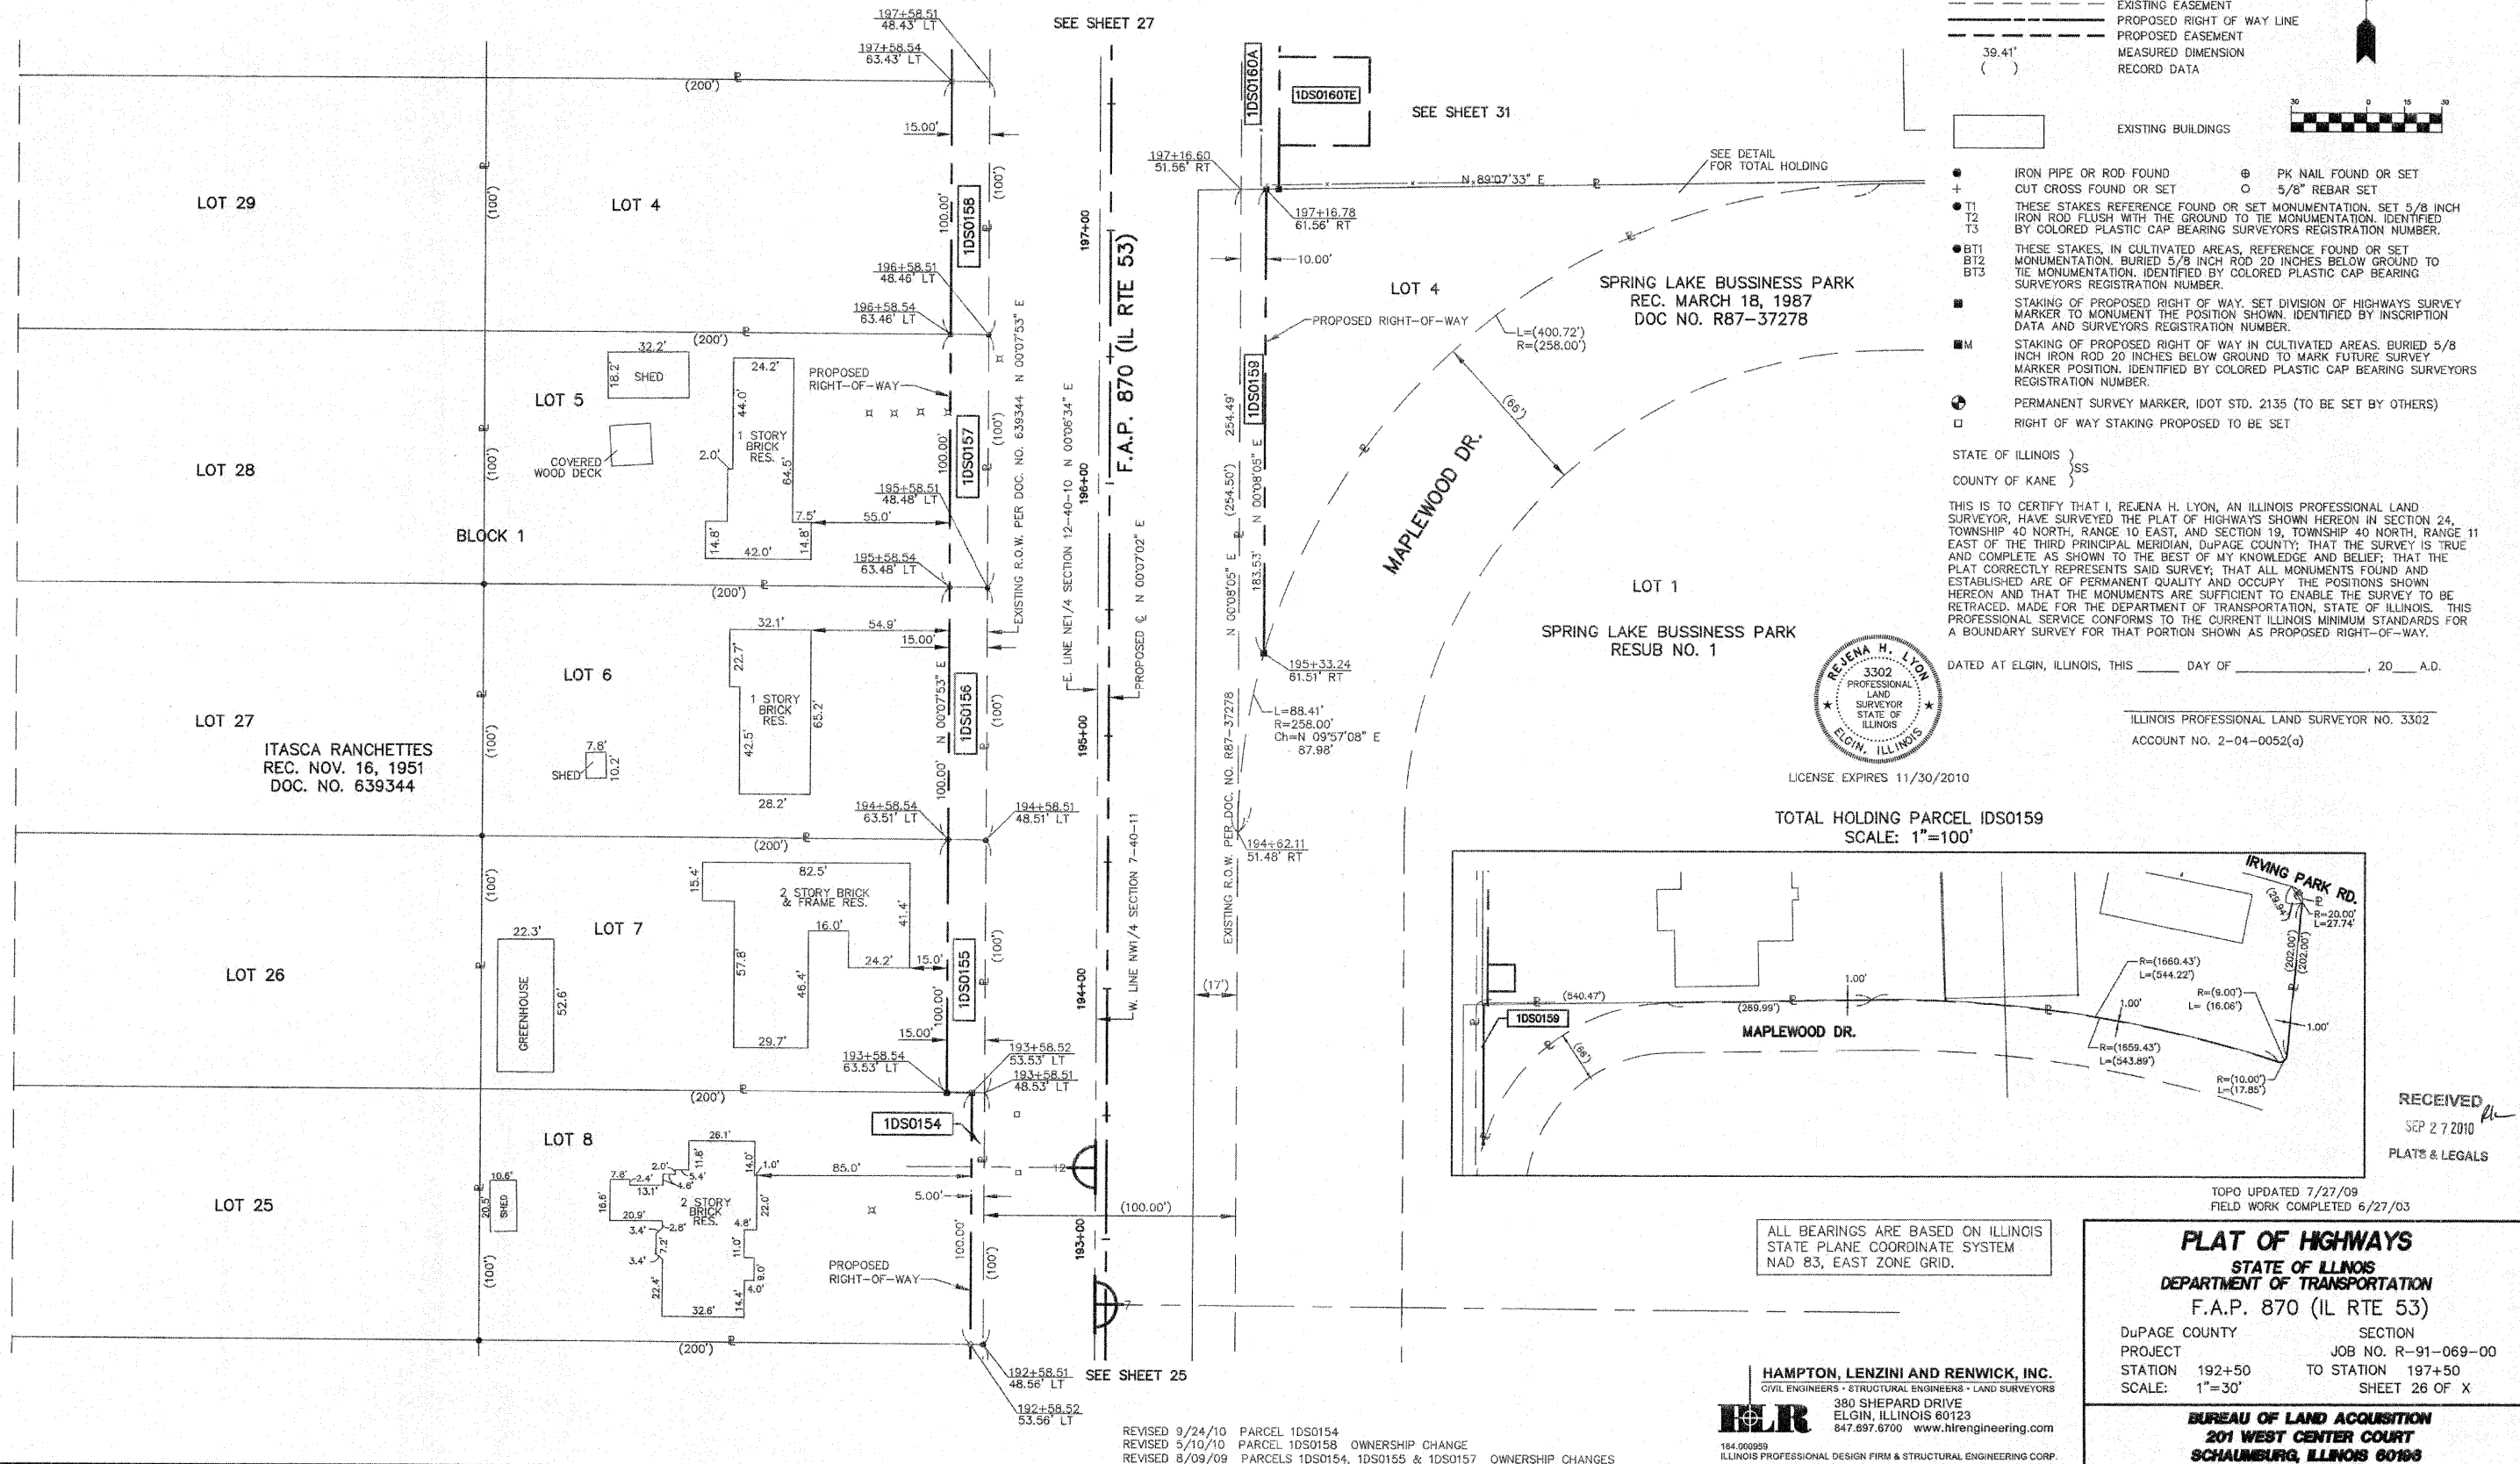

ALL BEARINGS ARE BASED ON ILLINOIS STATE PLANE COORDINATE SYSTEM NAD 83, EAST ZONE GRID.

HAMPTON, LENZINI AND RENWICK, INC.
 CIVIL ENGINEERS • STRUCTURAL ENGINEERS • LAND SURVEYORS
 380 SHEPARD DRIVE
 ELGIN, ILLINOIS 60123
 847.897.8700 www.hlrengineering.com

164.009889
 ILLINOIS PROFESSIONAL DESIGN FIRM & STRUCTURAL ENGINEERING CORP.

TOPO UPDATED 7/27/09
 FIELD WORK COMPLETED 6/27/03

PLAT OF HIGHWAYS
 STATE OF ILLINOIS
 DEPARTMENT OF TRANSPORTATION
 F.A.P. 870 (IL RTE 53)

DuPAGE COUNTY SECTION
 PROJECT JOB NO. R-91-069-00
 STATION 192+50 TO STATION 197+50
 SCALE: 1"=30' SHEET 26 OF X

BUREAU OF LAND ACQUISITION
 201 WEST CENTER COURT
 SCHAMBERG, ILLINOIS 60196

PART OF SECTION 12, TWP 40 NORTH, RANGE 10 EAST & SECTION 7, TWP 40 NORTH, RANGE 11 EAST OF THE THIRD PRINCIPAL MERIDIAN, DUPAGE COUNTY, ILLINOIS.

| PARCEL NUMBER | OWNER | TOTAL HOLDINGS | AREA TAKEN | PREVIOUS DEDICATION | REMAINDER | AREA OF EASEMENT | PURPOSE OF EASEMENT | TAX NUMBER | PROPERTY ACQUIRED BY |
|---------------|---|----------------|------------|---------------------|-----------|--------------------|---------------------|--------------------|----------------------|
| 1DS0158 | Emma Schmidt Larala as Trustee of the Emma Schmidt Larala Family Trust dated July 24, 2007 | 0.459 AC± | 0.034 AC± | NA | 0.425 AC± | NA | NA | 02-12-212-022 | |
| 1DS0160A | United States Postal Service | 3.690 AC± | 0.065 AC± | NA | 3.625 AC± | NA | NA | 03-07-103-013 | |
| 1DS0160B | | | 0.097 AC± | NA | NA | 0.029 AC± | GRADING | | |
| 1DS0160TE | | | NA | NA | NA | 0.006 AC (264 SF)± | DRIVE | | |
| 1DS0161 | Abate Enterprises, L.L.C., an Illinois limited liability company | 1,020 AC± | 0.075 AC± | NA | 0.945 AC± | NA | NA | 02-12-212-037 | |
| 1DS0161TE | | | NA | NA | NA | 0.006 AC (264 SF)± | DRIVE | | |
| 1DS0162DED | Bank Financial FS, as Trustee Under Trust Agreement Dated October 25, 2005 and known as Trust Number 010836 | 0.506 AC± | 0.152 AC±* | NA | 0.506 AC± | NA | NA | 02-12-212-019 | |
| 1DS0162TE | | | NA | NA | NA | 0.004 AC (171 SF)± | DRIVE | | |
| 1DS0163DED | Mobil Oil Corporation | 0.802 AC± | 0.147 AC±* | NA | 0.802 AC± | NA | NA | 03-07-103-015 | |
| 1DS0163TE-A | | | NA | NA | NA | 0.015 AC± | DRIVE | | |
| 1DS0163TE-B | | | NA | NA | NA | 0.009 AC (380 SF)± | DRIVE | | |
| 1DS0166 | Chicago Title Land Trust Company, as Trustee under Trust Agreement dated the 24th day of May, 2004, known as Trust Number 1113015 | 1,200 AC± | 0.073 AC± | NA | 1,127 AC± | NA | NA | 02-12-212-038 (pt) | |
| 1DS0166PE | | | NA | NA | NA | 0.056 AC± | PERMANENT | | |
| 1DS0166TE-A | | | NA | NA | NA | 0.006 AC (253 SF)± | DRIVE | | |
| 1DS0166TE-B | | | NA | NA | NA | 0.009 AC (413 SF)± | DRIVE | | |

LEGEND

SECTION CORNER: 36, 9, 10, 16, 15, 10

QUARTER SECTION CORNER: 16, 15

SECTION LINE: ---

QUARTER SECTION LINE: ---

QUARTER, QUARTER SECTION LINE: ---

PLATTED LOT LINE: ---

PROPERTY (DEED) LINE: ---

APL: ---

APPARENT PROPERTY LINE: ---

CENTERLINE: ---

EXISTING RIGHT OF WAY LINE: ---

EXISTING EASEMENT: ---

PROPOSED RIGHT OF WAY LINE: ---

PROPOSED EASEMENT: ---

MEASURED DIMENSION: 39.41'

RECORD DATA: ()

EXISTING BUILDINGS: []

IRON PIPE OR ROD FOUND: ●

CUT CROSS FOUND OR SET: +

PK NAIL FOUND OR SET: ⊕

5/8" REBAR SET: ○

T1, T2, T3: THESE STAKES REFERENCE FOUND OR SET MONUMENTATION, SET 5/8" IRON ROD FLUSH WITH THE GROUND TO THE MONUMENTATION, IDENTIFIED BY COLORED PLASTIC CAP BEARING SURVEYORS REGISTRATION NUMBER.


BT1, BT2, BT3: THESE STAKES, IN CULTIVATED AREAS, REFERENCE FOUND OR SET MONUMENTATION, BURIED 5/8" IRON ROD 20 INCHES BELOW GROUND TO THE MONUMENTATION, IDENTIFIED BY COLORED PLASTIC CAP BEARING SURVEYORS REGISTRATION NUMBER.

■: STAKING OF PROPOSED RIGHT OF WAY, SET DIVISION OF HIGHWAYS SURVEY MARKER TO MONUMENT THE POSITION SHOWN, IDENTIFIED BY INSCRIPTION DATA AND SURVEYORS REGISTRATION NUMBER.

■: STAKING OF PROPOSED RIGHT OF WAY IN CULTIVATED AREAS, BURIED 5/8" IRON ROD 20 INCHES BELOW GROUND TO MARK FUTURE SURVEY MARKER POSITION, IDENTIFIED BY COLORED PLASTIC CAP BEARING SURVEYORS REGISTRATION NUMBER.

⊙: PERMANENT SURVEY MARKER, 1/2" STD. 2135 (TO BE SET BY OTHERS)

□: RIGHT OF WAY STAKING PROPOSED TO BE SET

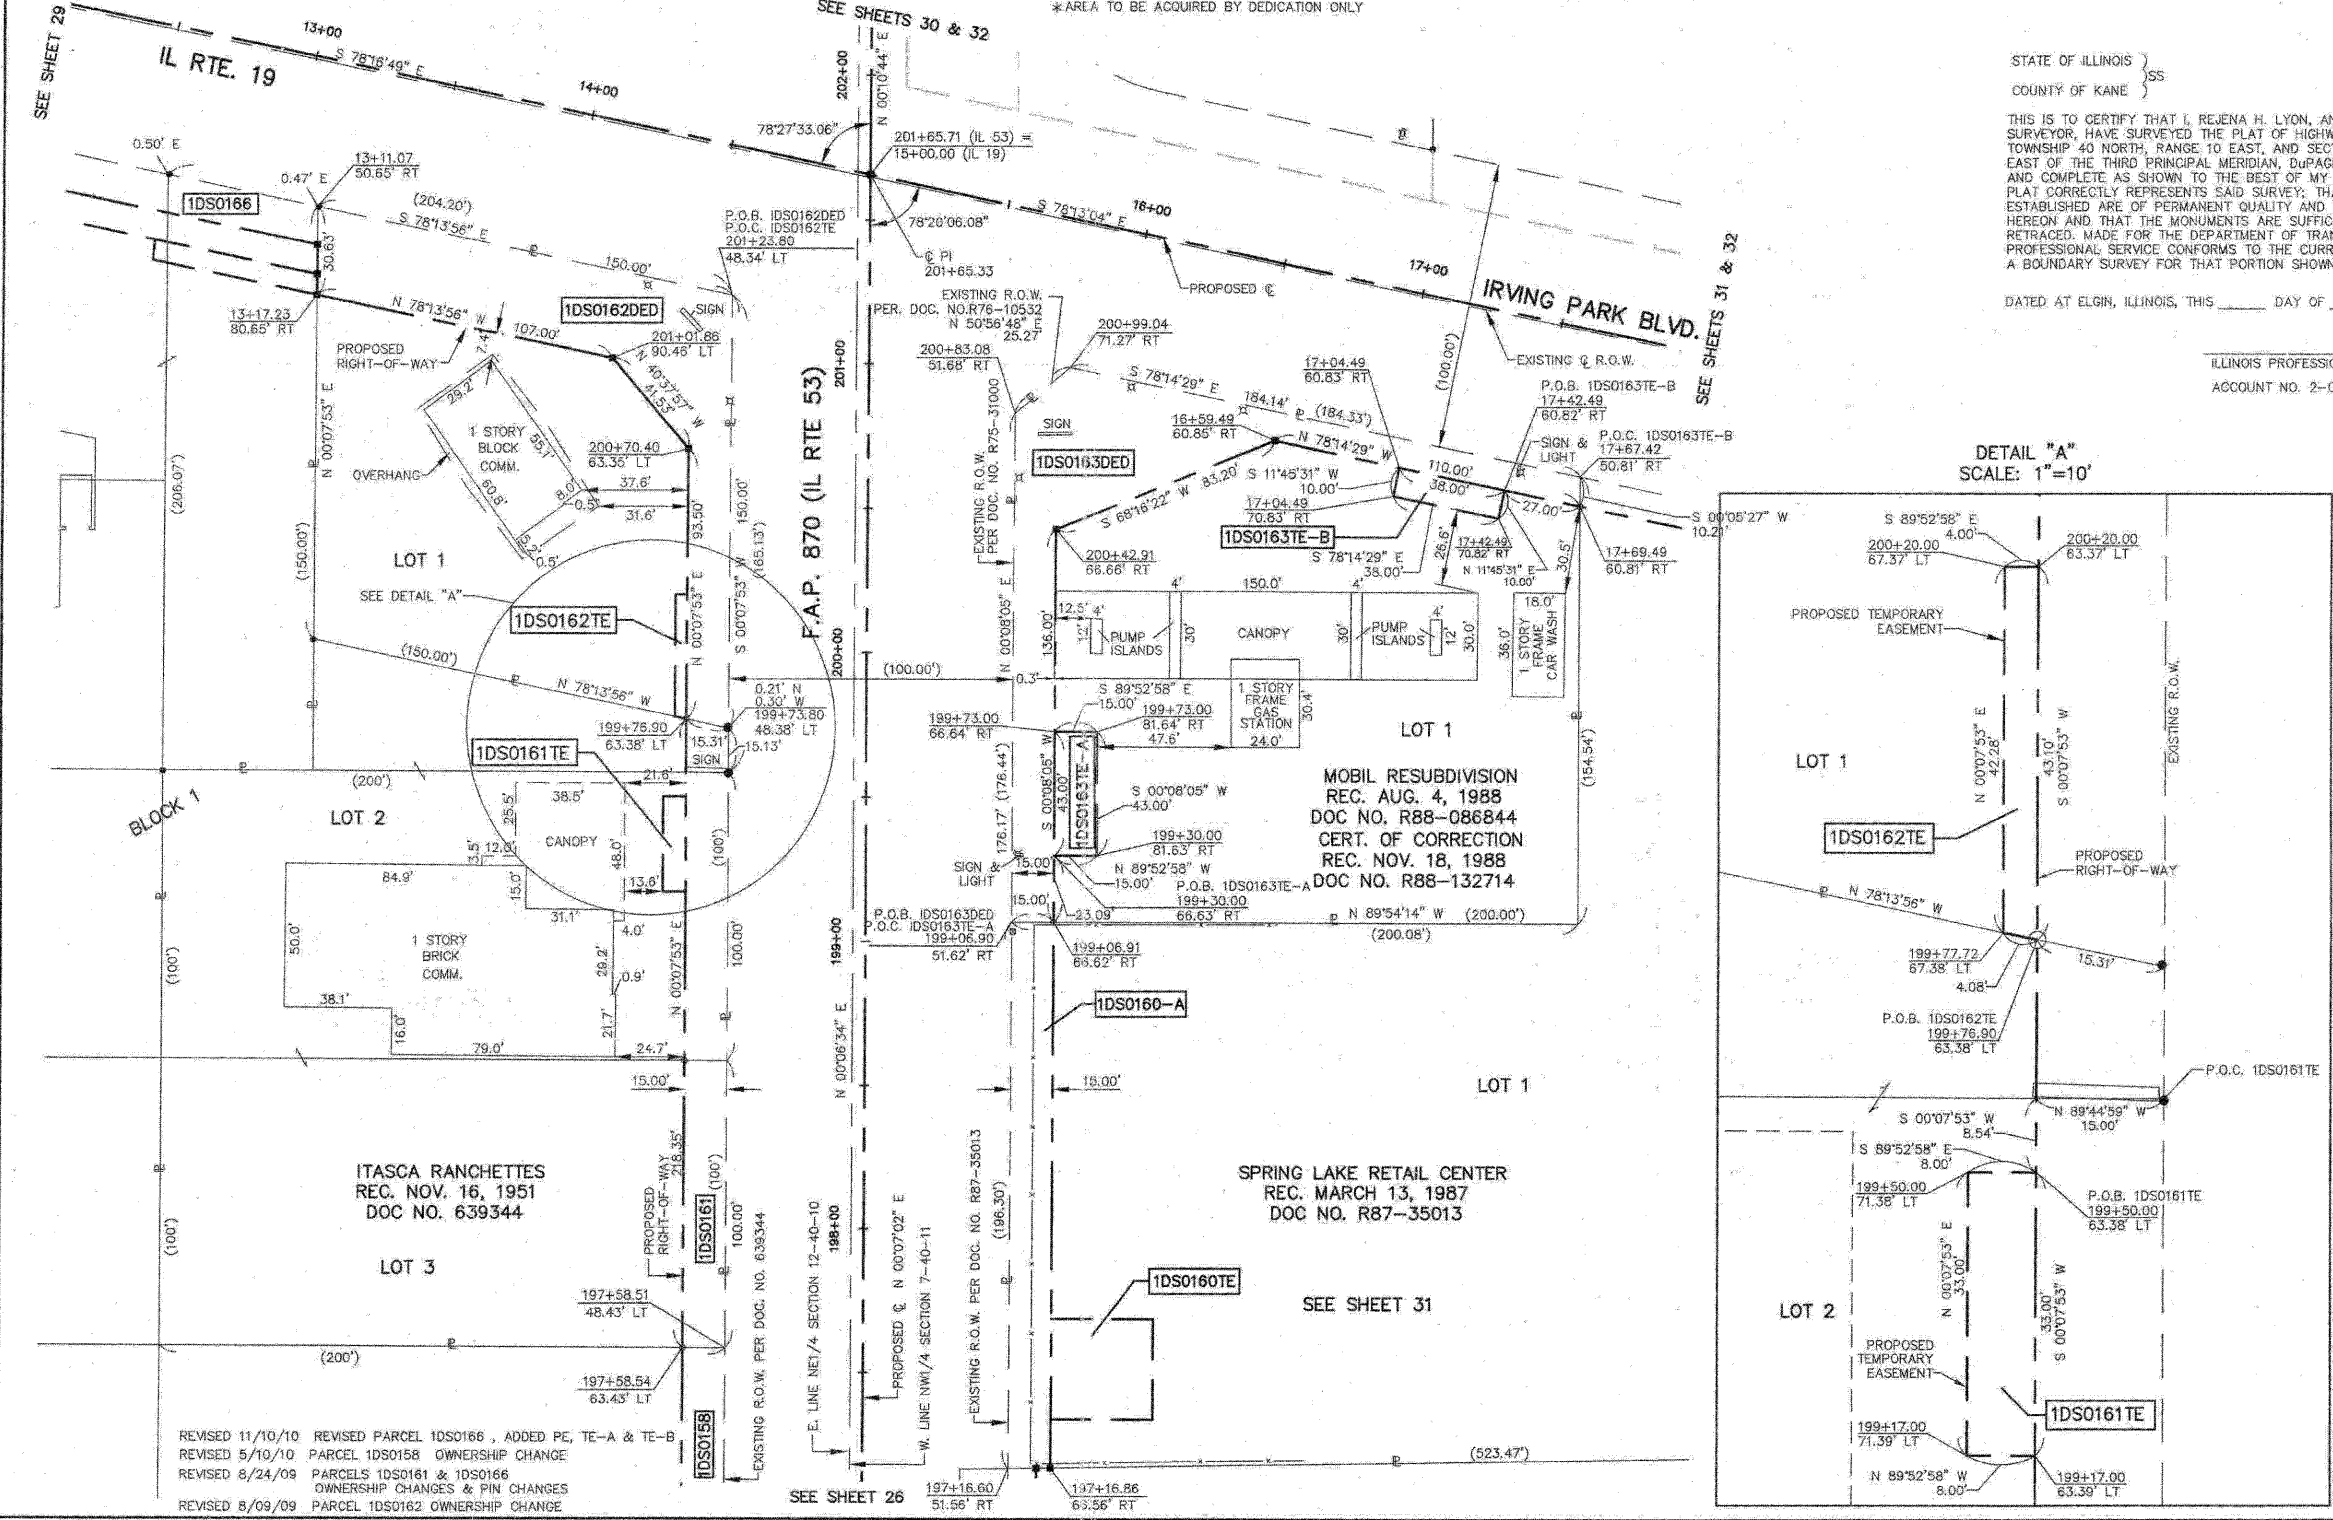


STATE OF ILLINOIS }
COUNTY OF KANE }SS

THIS IS TO CERTIFY THAT I, REJENA H. LYON, AN ILLINOIS PROFESSIONAL LAND SURVEYOR, HAVE SURVEYED THE PLAT OF HIGHWAYS SHOWN HEREON IN SECTION 24, TOWNSHIP 40 NORTH, RANGE 10 EAST, AND SECTION 19, TOWNSHIP 40 NORTH, RANGE 11 EAST OF THE THIRD PRINCIPAL MERIDIAN, DUPAGE COUNTY; THAT THE SURVEY IS TRUE AND COMPLETE AS SHOWN TO THE BEST OF MY KNOWLEDGE AND BELIEF; THAT THE PLAT CORRECTLY REPRESENTS SAID SURVEY; THAT ALL MONUMENTS FOUND AND ESTABLISHED ARE OF PERMANENT QUALITY AND OCCUPY THE POSITIONS SHOWN HEREON AND THAT THE MONUMENTS ARE SUFFICIENT TO ENABLE THE SURVEY TO BE RETRACED. MADE FOR THE DEPARTMENT OF TRANSPORTATION, STATE OF ILLINOIS. THIS PROFESSIONAL SERVICE CONFORMS TO THE CURRENT ILLINOIS MINIMUM STANDARDS FOR A BOUNDARY SURVEY FOR THAT PORTION SHOWN AS PROPOSED RIGHT-OF-WAY.

DATED AT ELGIN, ILLINOIS, THIS _____ DAY OF _____, 20__ A.D.

ILLINOIS PROFESSIONAL LAND SURVEYOR NO. 3302
ACCOUNT NO. 2-04-0052(m)

REJENA H. LYON
3302 PROFESSIONAL LAND SURVEYOR
STATE OF ILLINOIS
ELGIN, ILLINOIS
LICENSE EXPIRES 11/30/2010

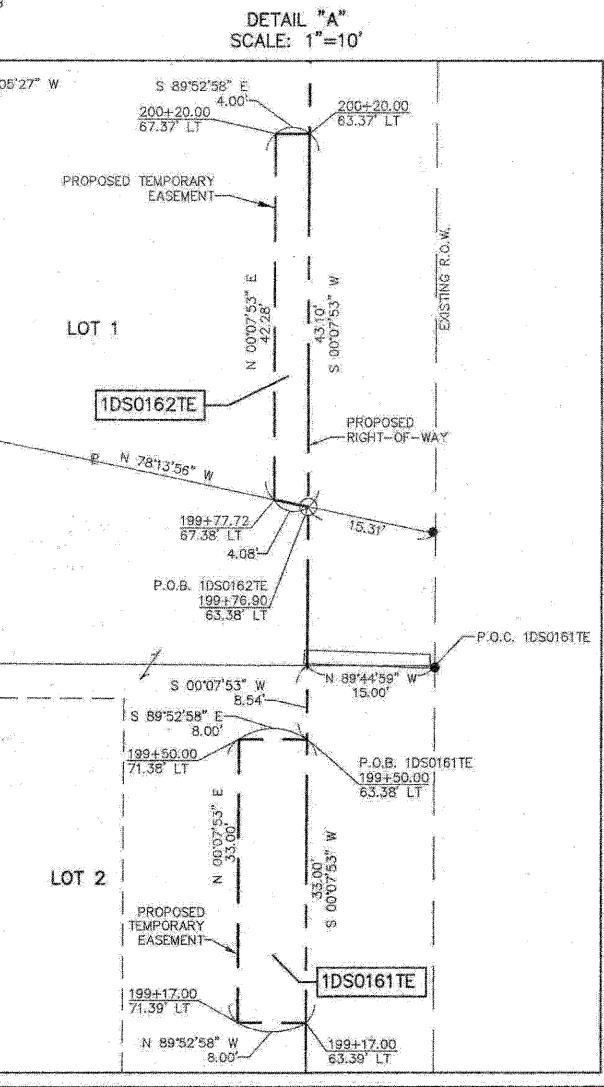

RECEIVED
NOV 17 2010
PLATS & LEGALS

ALL BEARINGS ARE BASED ON ILLINOIS STATE PLANE COORDINATE SYSTEM NAD 83, EAST ZONE GRID.

TOPO UPDATED 7/27/09
FIELD WORK COMPLETED 6/27/03

HAMPTON, LENZINI AND RENWICK, INC.
CIVIL ENGINEERS - STRUCTURAL ENGINEERS - LAND SURVEYORS
380 SHEPARD DRIVE
ELGIN, ILLINOIS 60123
847.897.8700 www.hlrengineering.com
184.000929 ILLINOIS PROFESSIONAL DESIGN FIRM & STRUCTURAL ENGINEERING CORP.

PLAT OF HIGHWAYS
STATE OF ILLINOIS
DEPARTMENT OF TRANSPORTATION
F.A.P. 870 (IL RTE 53)

DUPAGE COUNTY SECTION
PROJECT JOB NO. R-91-069-00
STATION 197+00 TO STATION 201+50
SCALE: 1"=30' SHEET 27 OF X

BUREAU OF LAND ACQUISITION
201 WEST CENTER COURT
SCHAMBURG, ILLINOIS 60196

| PARCEL NUMBER | OWNER | TOTAL HOLDINGS | AREA TAKEN | PREVIOUS DEDICATION | REMAINDER | AREA OF EASEMENT | PURPOSE OF EASEMENT | TAX NUMBER | PROPERTY ACQUIRED BY |
|---------------|--|----------------|------------|---------------------|-----------|------------------|---------------------|---|----------------------|
| 1DS0164 | Raymond F. Schmidt and Maraldine M. Schmidt, as joint tenants | 0.643 AC± | 0.044 AC± | NA | 0.599 AC± | NA | NA | 02-12-211-001 | |
| 1DS0165 | Frank Graziano | 0.748 AC± | 0.065 AC± | NA | 0.683 AC± | NA | NA | 02-12-211-018 | |
| 1DS0168 | Itasca Joint Venture, LLC, an Illinois Limited Liability Company | 8.568 AC± | 0.070 AC± | NA | 8.498 AC± | NA | NA | 02-12-204-011 02-12-204-012 02-12-204-001 | |
| 1DS0169 | Itasca Bank & Trust Co., as Trustee under the provisions of a Trust Agreement dated the 13th day of March, 1989 and known as Trust No. 10886 | 1.188 AC± | 0.045 AC± | NA | 1.143 AC± | NA | NA | 02-12-204-014 | |

LEGEND

SECTION CORNER
QUARTER SECTION CORNER

SECTION LINE
QUARTER SECTION LINE
QUARTER, QUARTER-SECTION LINE
PLATTED LOT LINE
PROPERTY (DEED) LINE

APL
APPARENT PROPERTY LINE
CENTERLINE
EXISTING RIGHT OF WAY LINE
EXISTING EASEMENT
PROPOSED RIGHT OF WAY LINE
PROPOSED EASEMENT
MEASURED DIMENSION
RECORD DATA

EXISTING BUILDINGS

IRON PIPE OR ROD FOUND
OUT-CROSS FOUND OR SET
PK NAIL FOUND OR SET
5/8" REBAR SET

T1, T2, T3: THESE STAKES REFERENCE FOUND OR SET MONUMENTATION, SET 5/8 INCH IRON ROD FLUSH WITH THE GROUND TO TIE MONUMENTATION, IDENTIFIED BY COLORED PLASTIC CAP BEARING SURVEYORS REGISTRATION NUMBER.


BT1, BT2, BT3: THESE STAKES, IN CULTIVATED AREAS, REFERENCE FOUND OR SET MONUMENTATION, BURIED 5/8 INCH ROD 20 INCHES BELOW GROUND TO TIE MONUMENTATION, IDENTIFIED BY COLORED PLASTIC CAP BEARING SURVEYORS REGISTRATION NUMBER.

STAKING OF PROPOSED RIGHT OF WAY, SET DIVISION OF HIGHWAYS SURVEY MARKER TO MONUMENT THE POSITION SHOWN, IDENTIFIED BY INSCRIPTION DATA AND SURVEYORS REGISTRATION NUMBER.

STAKING OF PROPOSED RIGHT OF WAY IN CULTIVATED AREAS, BURIED 5/8 INCH IRON ROD 20 INCHES BELOW GROUND TO MARK FUTURE SURVEY MARKER POSITION, IDENTIFIED BY COLORED PLASTIC CAP BEARING SURVEYORS REGISTRATION NUMBER.

PERMANENT SURVEY MARKER, IDOT STD. 2135 (TO BE SET BY OTHERS)

RIGHT OF WAY STAKING PROPOSED TO BE SET

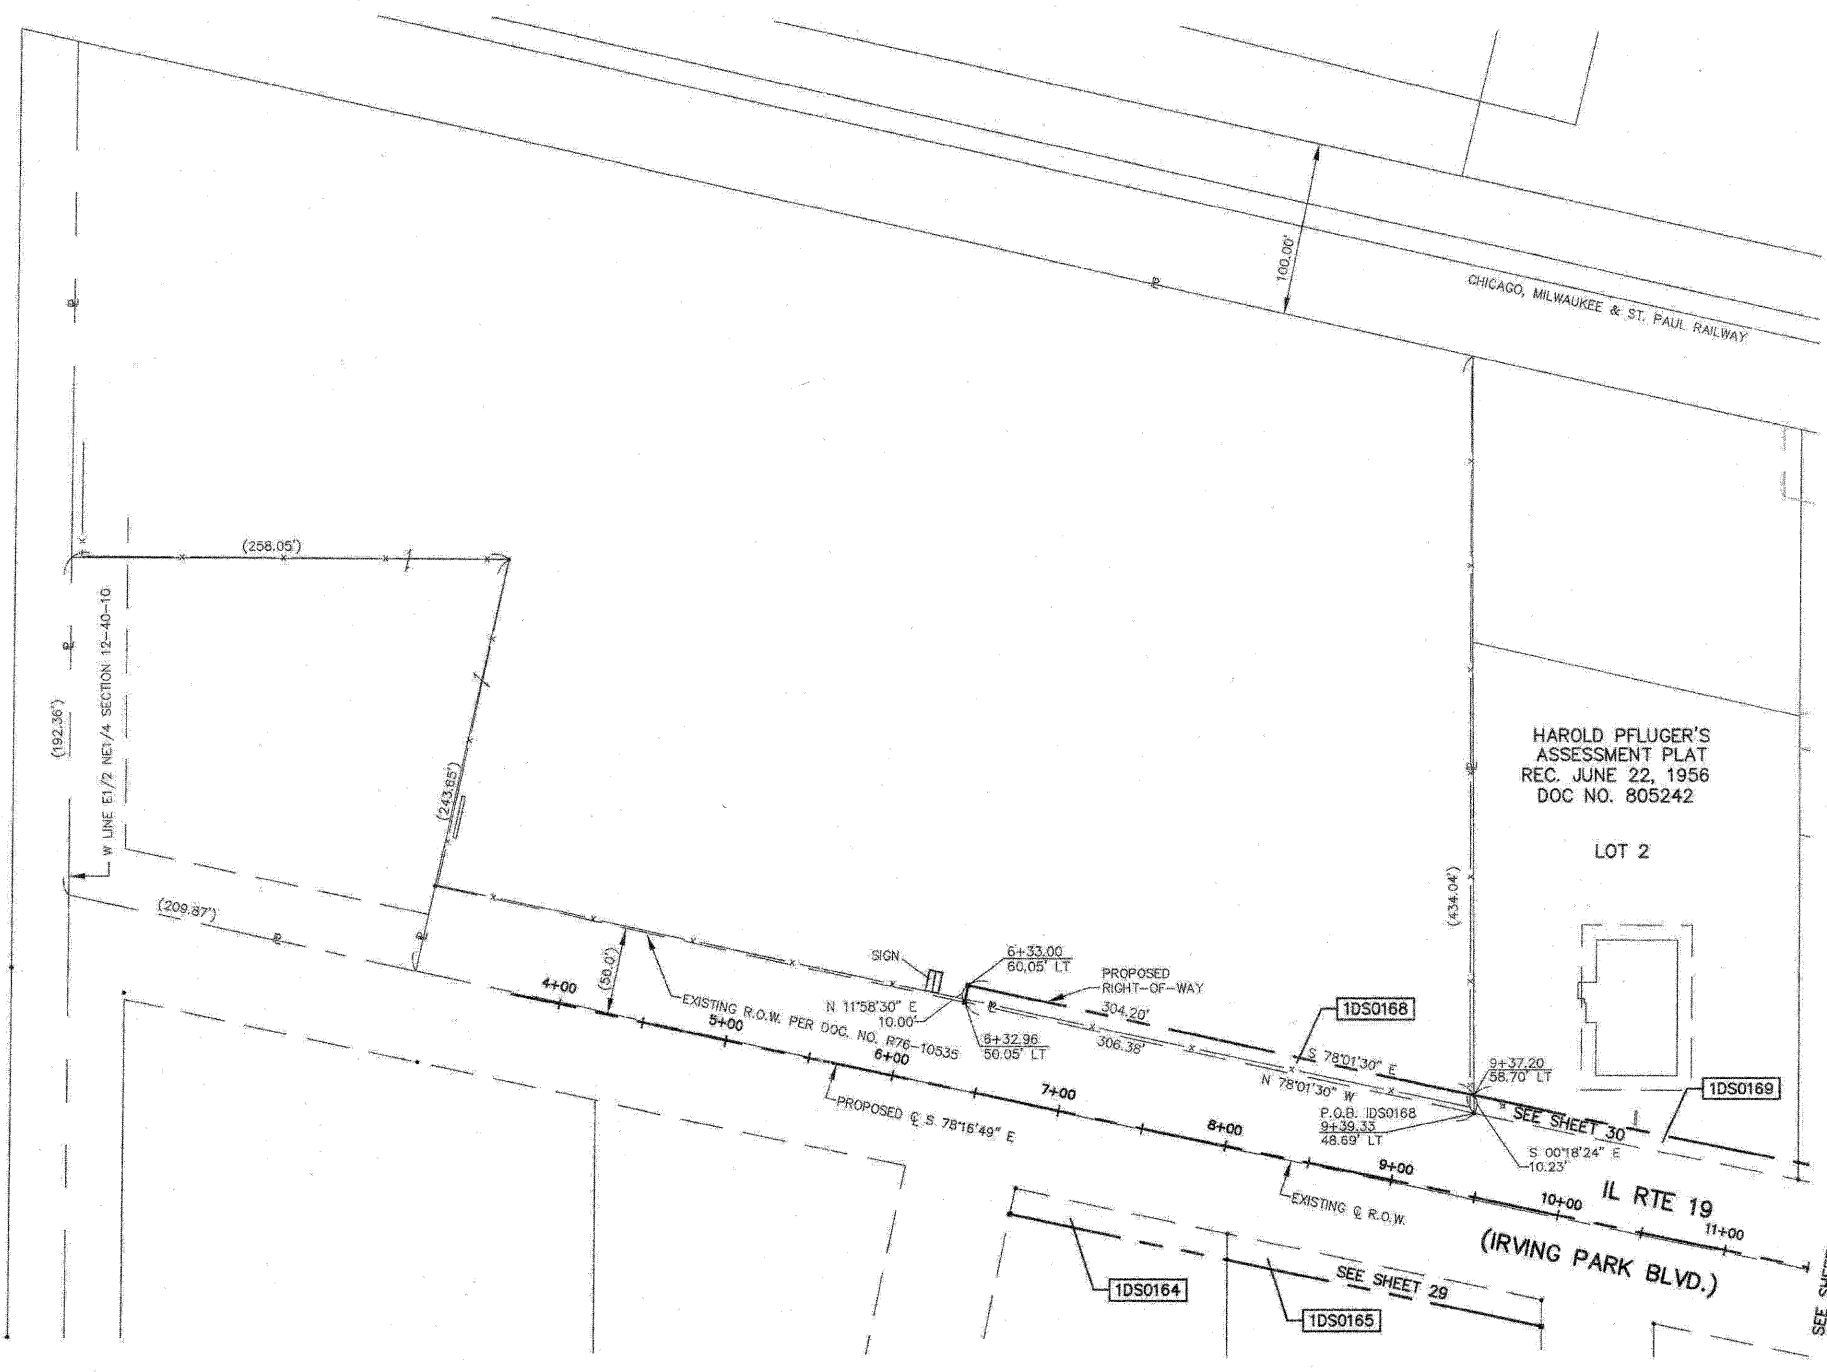

STATE OF ILLINOIS }
COUNTY OF KANE }

THIS IS TO CERTIFY THAT I, REJENA H. LYON, AN ILLINOIS PROFESSIONAL LAND SURVEYOR, HAVE SURVEYED THE PLAT OF HIGHWAYS SHOWN HEREON IN SECTION 24, TOWNSHIP 40 NORTH, RANGE 10 EAST, AND SECTION 19, TOWNSHIP 40 NORTH, RANGE 11 EAST OF THE THIRD PRINCIPAL MERIDIAN, DUPAGE COUNTY; THAT THE SURVEY IS TRUE AND COMPLETE AS SHOWN TO THE BEST OF MY KNOWLEDGE AND BELIEF; THAT THE PLAT CORRECTLY REPRESENTS SAID SURVEY; THAT ALL MONUMENTS FOUND AND ESTABLISHED ARE OF PERMANENT QUALITY AND OCCUPY THE POSITIONS SHOWN HEREON AND THAT THE MONUMENTS ARE SUFFICIENT TO ENABLE THE SURVEY TO BE RETRACED, MADE FOR THE DEPARTMENT OF TRANSPORTATION, STATE OF ILLINOIS. THIS PROFESSIONAL SERVICE CONFORMS TO THE CURRENT ILLINOIS MINIMUM STANDARDS FOR A BOUNDARY SURVEY FOR THAT PORTION SHOWN AS PROPOSED RIGHT-OF-WAY.

DATED AT ELGIN, ILLINOIS, THIS _____ DAY OF _____, 20__ A.D.

ILLINOIS PROFESSIONAL LAND SURVEYOR NO. 3302
ACCOUNT NO. 2-04-0052(a)

LICENSE EXPIRES 11/30/2010

ALL BEARINGS ARE BASED ON ILLINOIS STATE PLANE COORDINATE SYSTEM NAD 83, EAST ZONE GRID.

RECEIVED
JAN 04 2010
PLATS & LEGALS

TOPO UPDATED 7/27/09
FIELD WORK COMPLETED 6/27/03

HAMPTON, LENZINI AND RENWICK, INC.
CIVIL ENGINEERS - STRUCTURAL ENGINEERS - LAND SURVEYORS
380 SHEPARD DRIVE
ELGIN, ILLINOIS 60123
847.697.6700 www.hirengineering.com

PLAT OF HIGHWAYS
STATE OF ILLINOIS
DEPARTMENT OF TRANSPORTATION
F.A.P. 870 (IL RTE 53)


DUPAGE COUNTY SECTION
PROJECT JOB NO. R-91-069-00
STATION 4+00 (IL RTE 19) TO STATION 10+00
SCALE: 1"=50' SHEET 28 OF X

BUREAU OF LAND ACQUISITION
201 WEST CENTER COURT
SCHLAUBURG, ILLINOIS 60186

REVISED 12/31/09 PARCEL 1DS0168 ADDED TAX NUMBER
REVISED 8/09/09 PARCELS 1DS0165 & 1DS0168 OWNERSHIP CHANGES;
PARCEL 1DS0168 REVISE TOTAL HOLDING

| PARCEL NUMBER | OWNER | TOTAL HOLDINGS | AREA TAKEN | PREVIOUS DEDICATION | REMAINDER | AREA OF EASEMENT | PURPOSE OF EASEMENT | TAX NUMBER | PROPERTY ACQUIRED BY |
|---------------|--|----------------|------------|---------------------|-----------|--------------------|---------------------|--------------------------------|----------------------|
| 1DS0162DED | Bank Financial FSB, as Trustee Under Trust Agreement Dated October 25, 2005 and known as Trust Number 010836 | 0.506 AC± | 0.152 AC±* | NA | 0.506 AC± | NA | NA | 02-12-212-019 | |
| 1DS0162TE | | | NA | NA | NA | 0.004 AC (171 SF)± | DRIVE | | |
| 1DS0164 | Raymond F. Schmidt and Maraldine M. Schmidt, as joint tenants | 0.643 AC± | 0.044 AC± | NA | 0.599 AC± | NA | NA | 02-12-211-001 | |
| 1DS0165 | Frank Graziano | 0.748 AC± | 0.065 AC± | NA | 0.683 AC± | NA | NA | 02-12-211-018 | |
| 1DS0166 | Chicago Title Land Trust Company, as Trustee under Trust Agreement dated the 24th day of May, 2004, known as Trust Number 1113015 | 1.200 AC± | 0.073 AC± | NA | 1.127 AC± | NA | NA | 02-12-212-038 (pt) | |
| 1DS0166PE | | | NA | NA | NA | 0.056 AC± | PERMANENT | | |
| 1DS0166TE-A | | | NA | NA | NA | 0.006 AC (253 SF)± | DRIVE | | |
| 1DS0166TE-B | | | NA | NA | NA | 0.009 AC (413 SF)± | DRIVE | | |
| 1DS0168 | Itasca Joint Venture, LLC, an Illinois Limited Liability Company | 8.568 AC± | 0.070 AC± | NA | 8.498 AC± | NA | NA | 02-12-204-011 02-12-204-012 | |
| 1DS0169 | Itasca Bank & Trust Co., as Trustee under the provisions of a Trust Agreement dated the 13th day of March, 1989 and known as Trust No. 10686 | 1.188 AC± | 0.045 AC± | NA | 1.143 AC± | NA | NA | 02-12-204-014 | |
| 1DS0170 | Itasca Bank & Trust Co., as Trustee under the provisions of a Trust Agreement dated October 31, 1988 and known as Trust No. 10648 | 0.707 AC± | 0.036 AC± | NA | 0.671 AC± | NA | NA | 02-12-204-016 | |
| 1DS0171DED | Maya and Jiya, Inc. | 0.670 AC± | 0.125 AC±* | NA | 0.670 AC± | NA | NA | 02-12-204-006 | |
| 1DS0171TE | | | NA | NA | NA | 0.019 AC± | DRIVE | | |

* AREA TO BE ACQUIRED BY DEDICATION ONLY

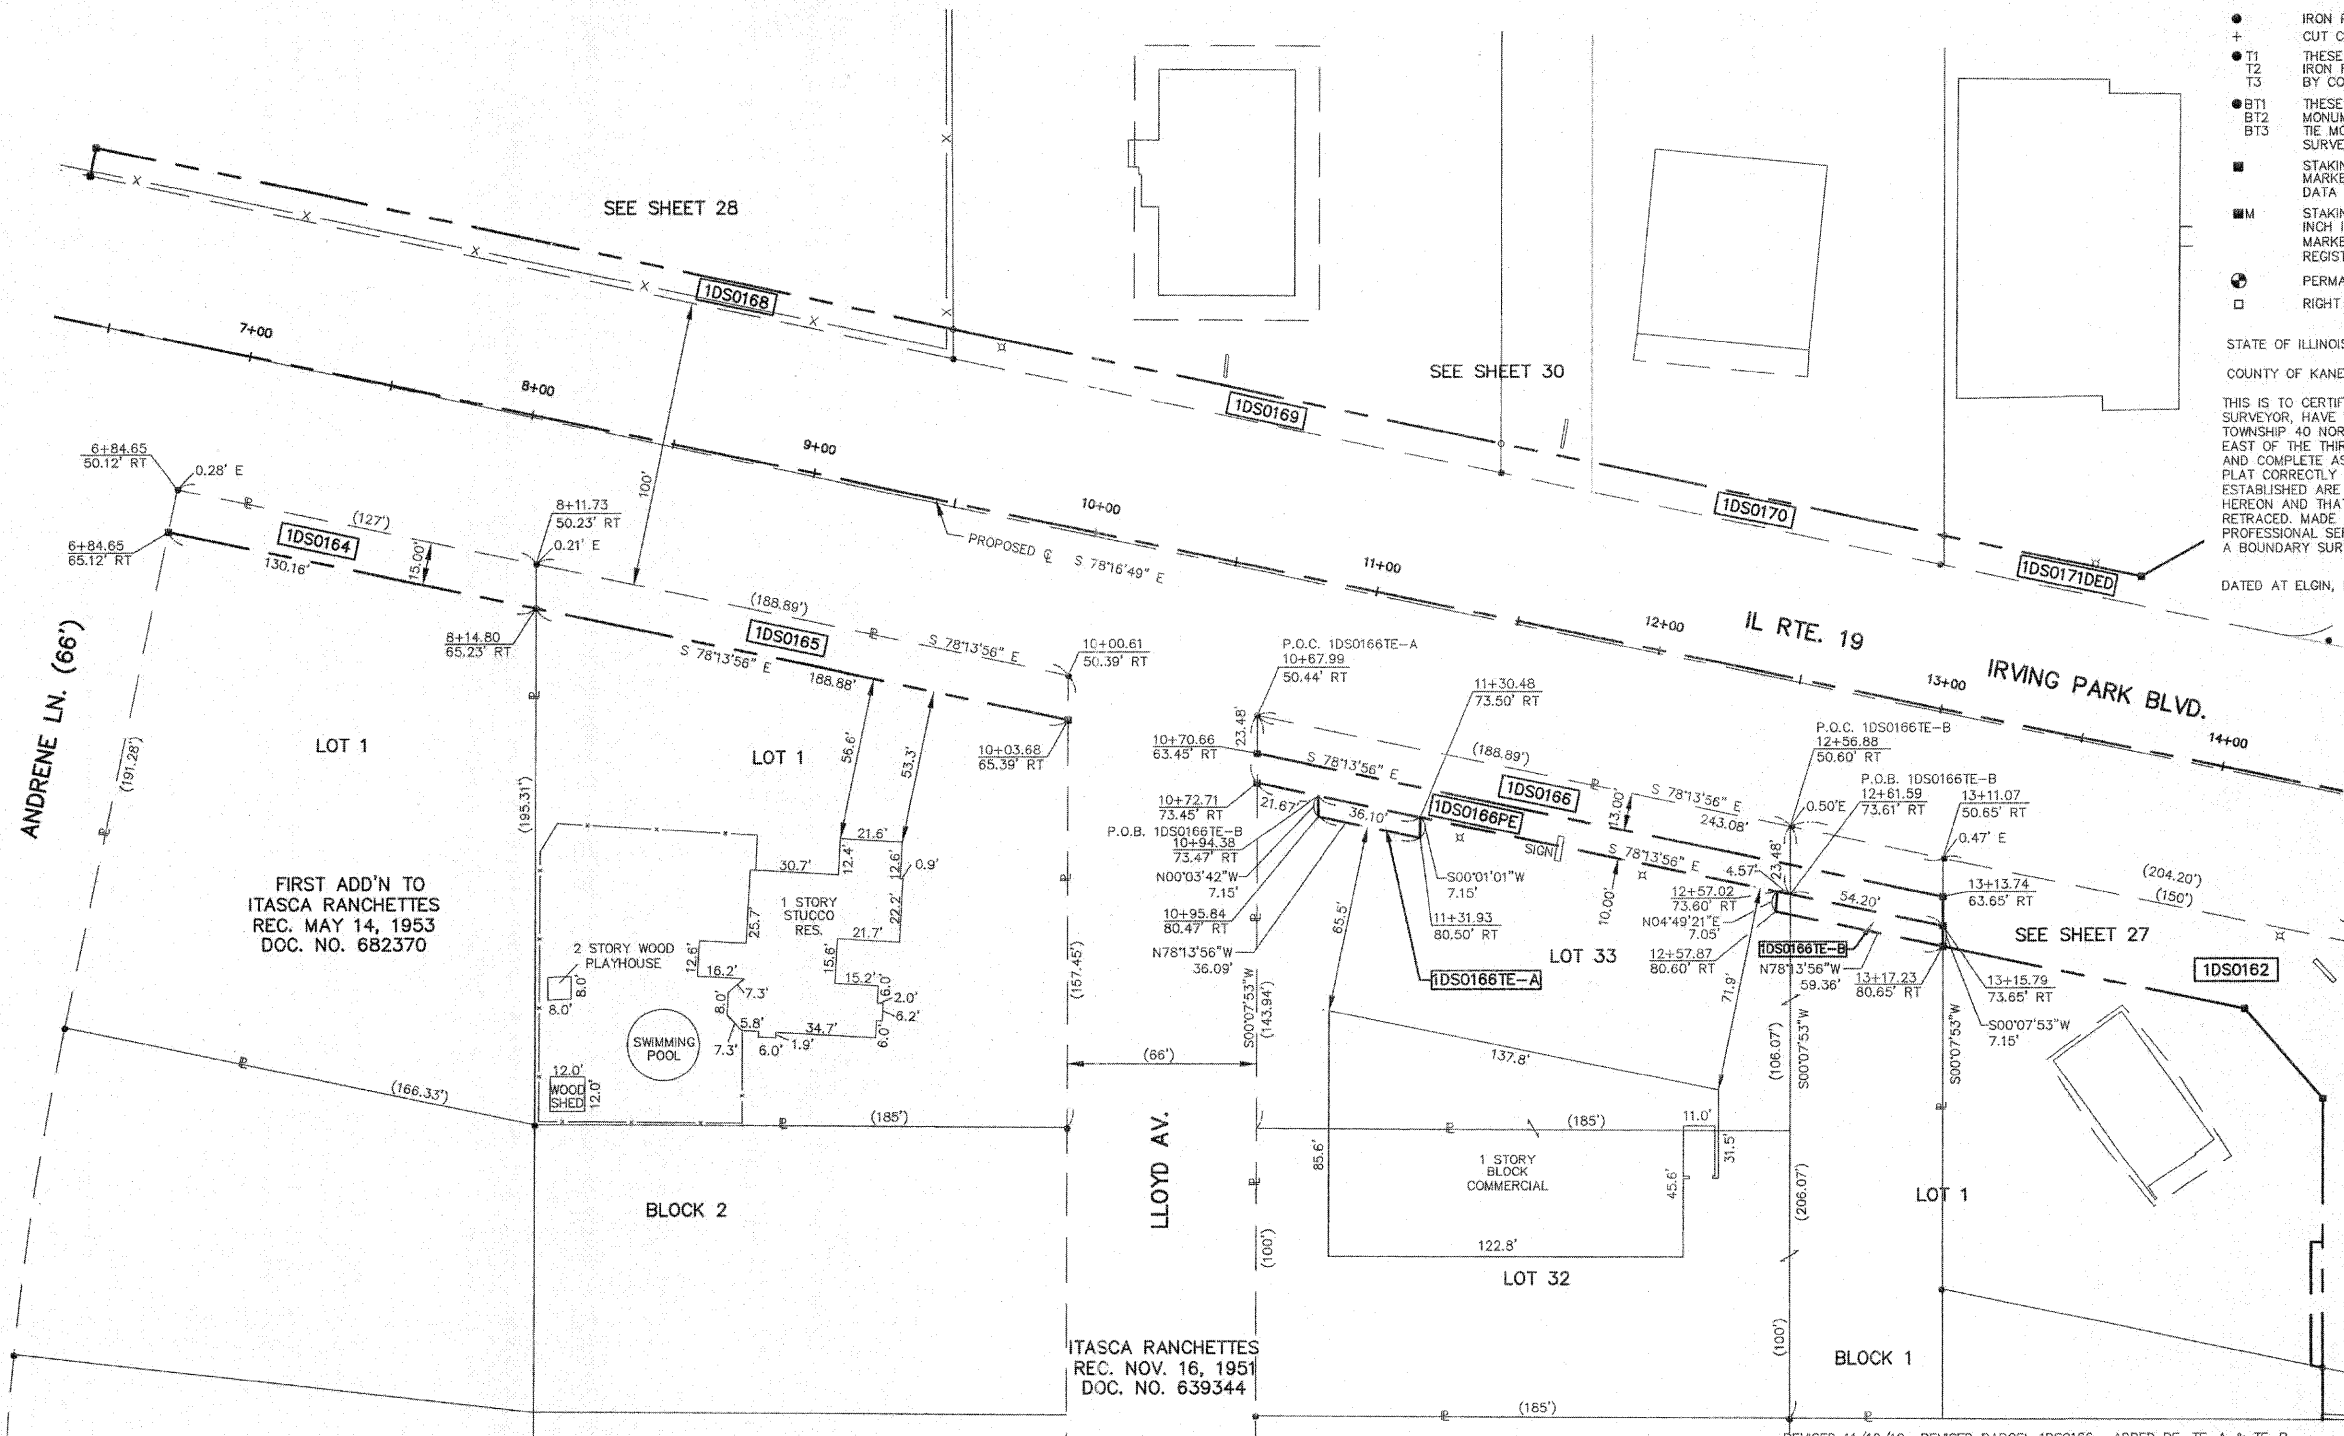

LEGEND

- SECTION CORNER
- QUARTER SECTION CORNER
- SECTION LINE
- QUARTER SECTION LINE
- PLATTED LOT LINE
- PROPERTY (DEED) LINE
- APL APPARENT PROPERTY LINE
- CENTERLINE
- EXISTING RIGHT OF WAY LINE
- EXISTING EASEMENT
- PROPOSED RIGHT OF WAY LINE
- PROPOSED EASEMENT
- MEASURED DIMENSION
- RECORD DATA
- EXISTING BUILDINGS

IRON PIPE OR ROD FOUND
CUT CROSS FOUND OR SET
T1 IRON ROD FLUSH WITH THE GROUND TO TIE MONUMENTATION, IDENTIFIED BY COLORED PLASTIC CAP BEARING SURVEYORS REGISTRATION NUMBER.
T2
T3
BT1 THESE STAKES, IN CULTIVATED AREAS, REFERENCE FOUND OR SET MONUMENTATION, BURIED 5/8 INCH ROD 20 INCHES BELOW GROUND TO TIE MONUMENTATION, IDENTIFIED BY COLORED PLASTIC CAP BEARING SURVEYORS REGISTRATION NUMBER.
BT2
BT3
S STAKING OF PROPOSED RIGHT OF WAY, SET DIVISION OF HIGHWAYS SURVEY MARKER TO MONUMENT THE POSITION SHOWN, IDENTIFIED BY INSCRIPTION DATA AND SURVEYORS REGISTRATION NUMBER.
M STAKING OF PROPOSED RIGHT OF WAY IN CULTIVATED AREAS, BURIED 5/8 INCH IRON ROD 20 INCHES BELOW GROUND TO MARK FUTURE SURVEY MARKER POSITION, IDENTIFIED BY COLORED PLASTIC CAP BEARING SURVEYORS REGISTRATION NUMBER.
PM PERMANENT SURVEY MARKER, IDOT STD. 2135 (TO BE SET BY OTHERS)
R RIGHT OF WAY STAKING PROPOSED TO BE SET

STATE OF ILLINOIS }
COUNTY OF KANE }SS

THIS IS TO CERTIFY THAT I, REJENA H. LYON, AN ILLINOIS PROFESSIONAL LAND SURVEYOR, HAVE SURVEYED THE PLAT OF HIGHWAYS SHOWN HEREON IN SECTION 24, TOWNSHIP 40 NORTH, RANGE 10 EAST, AND SECTION 19, TOWNSHIP 40 NORTH, RANGE 11 EAST OF THE THIRD PRINCIPAL MERIDIAN, DUPAGE COUNTY; THAT THE SURVEY IS TRUE AND COMPLETE AS SHOWN TO THE BEST OF MY KNOWLEDGE AND BELIEF; THAT THE PLAT CORRECTLY REPRESENTS SAID SURVEY; THAT ALL MONUMENTS FOUND AND ESTABLISHED ARE OF PERMANENT QUALITY AND OCCUPY THE POSITIONS SHOWN HEREON AND THAT THE MONUMENTS ARE SUFFICIENT TO ENABLE THE SURVEY TO BE RETRACED, MADE FOR THE DEPARTMENT OF TRANSPORTATION, STATE OF ILLINOIS. THIS PROFESSIONAL SERVICE CONFORMS TO THE CURRENT ILLINOIS MINIMUM STANDARDS FOR A BOUNDARY SURVEY FOR THAT PORTION SHOWN AS PROPOSED RIGHT-OF-WAY.

DATED AT ELGIN, ILLINOIS, THIS _____ DAY OF _____, 20__ A.D.

ILLINOIS PROFESSIONAL LAND SURVEYOR NO. 3302
ACCOUNT NO. 2-04-0052(c)

REJENA H. LYON
3302 PROFESSIONAL LAND SURVEYOR
STATE OF ILLINOIS
ELGIN, ILLINOIS
LICENSE EXPIRES 11/30/2010

ALL BEARINGS ARE BASED ON ILLINOIS STATE PLANE COORDINATE SYSTEM NAD 83, EAST ZONE GRID.

TOPO UPDATED 7/27/09
FIELD WORK COMPLETED 6/27/03

RECEIVED
NOV 17 2010

PLATS & LEGALS
HAMPTON, LENZINI AND RENWICK, INC.
CIVIL ENGINEERS - STRUCTURAL ENGINEERS - LAND SURVEYORS
380 SHEPARD DRIVE
ELGIN, ILLINOIS 60123
847.697.6700 www.hlrengineering.com
184.000659
ILLINOIS PROFESSIONAL DESIGN FIRM & STRUCTURAL ENGINEERING CORP.

PLAT OF HIGHWAYS
STATE OF ILLINOIS
DEPARTMENT OF TRANSPORTATION
F.A.P. 870 (IL RTE 53)
DUPAGE COUNTY SECTION
PROJECT JOB NO. R-91-069-00
STATION 6+50 (IL RTE 19) TO STATION 13+50
SCALE: 1"=30' SHEET 29 OF X

BUREAU OF LAND ACQUISITION
201 WEST CENTER COURT
SCHAUMBURG, ILLINOIS 60196

| PARCEL NUMBER | OWNER | TOTAL HOLDINGS | AREA TAKEN | PREVIOUS DEDICATION | REMAINDER | AREA OF EASEMENT | PURPOSE OF EASEMENT | TAX NUMBER | PROPERTY ACQUIRED BY |
|---------------|--|----------------|------------|---------------------|-----------|--------------------|---------------------|--------------------------------|----------------------|
| 1DS0162DED | Bank Financial FSB, as Trustee Under Trust Agreement Dated October 25, 2005 and known as Trust Number 010836 | 0.506 AC± | 0.152 AC±* | NA | 0.306 AC± | NA | NA | 02-12-212-019 | |
| 1DS0162TE | | | NA | NA | NA | 0.004 AC (171 SF)± | DRIVE | | |
| 1DS0164 | Raymond F. Schmidt and Maraldine M. Schmidt, as joint tenants | 0.643 AC± | 0.044 AC± | NA | 0.599 AC± | NA | NA | 02-12-211-001 | |
| 1DS0165 | Frank Graziano | 0.748 AC± | 0.065 AC± | NA | 0.683 AC± | NA | NA | 02-12-211-018 | |
| 1DS0166 | | | 0.073 AC± | NA | 1.127 AC± | NA | NA | | |
| 1DS0166PE | Chicago Title Land Trust Company, as Trustee under Trust Agreement dated the 24th day of May, 2004, known as Trust Number 1113015 | 1.200 AC± | NA | NA | NA | 0.056 AC± | PERMANENT | 02-12-212-038 (p1) | |
| 1DS0166TE-1 | | | NA | NA | NA | 0.006 AC (253 SF)± | DRIVE | | |
| 1DS0166TE-2 | | | NA | NA | NA | 0.009 AC (413 SF)± | DRIVE | | |
| 1DS0168 | Itasca Joint Venture, LLC, an Illinois Limited Liability Company | 8.568 AC± | 0.070 AC± | NA | 8.498 AC± | NA | NA | 02-12-204-011 02-12-204-012 | |
| 1DS0169 | Itasca Bank & Trust Co., as Trustee under the provisions of a Trust Agreement dated the 13th day of March, 1989 and known as Trust No. 10686 | 1.188 AC± | 0.045 AC± | NA | 1.143 AC± | NA | NA | 02-12-204-014 | |
| 1DS0170 | Itasca Bank & Trust Co., as Trustee under the provisions of a Trust Agreement dated October 31, 1988 and known as Trust No. 10648 | 0.707 AC± | 0.036 AC± | NA | 0.671 AC± | NA | NA | 02-12-204-016 | |
| 1DS0171DED | | | 0.125 AC±* | NA | 0.670 AC± | NA | NA | | |
| 1DS0171TE | Maya and Jilya, Inc. | 0.670 AC± | NA | NA | NA | 0.019 AC± | DRIVE | 02-12-204-006 | |

* AREA TO BE ACQUIRED BY DEDICATION ONLY

LEGEND

SECTION CORNER:

QUARTER SECTION CORNER:

SECTION LINE

QUARTER SECTION LINE

QUARTER, QUARTER SECTION LINE

PLATTED LOT LINE

PROPERTY (DEED) LINE

APL

APPARENT PROPERTY LINE

CENTERLINE

EXISTING RIGHT OF WAY LINE

EXISTING EASEMENT

PROPOSED RIGHT OF WAY LINE

PROPOSED EASEMENT

MEASURED DIMENSION

RECORD DATA

EXISTING BUILDINGS:

IRON PIPE OR ROD FOUND:

CUT CROSS FOUND OR SET:

T1, T2, T3: THESE STAKES REFERENCE FOUND OR SET MONUMENTATION, SET 5/8 INCH IRON ROD FLUSH WITH THE GROUND TO THE MONUMENTATION, IDENTIFIED BY COLORED PLASTIC CAP BEARING SURVEYORS REGISTRATION NUMBER.

BT1, BT2, BT3: THESE STAKES, IN CULTIVATED AREAS, REFERENCE FOUND OR SET MONUMENTATION, BURIED 5/8 INCH ROD 20 INCHES BELOW GROUND TO THE MONUMENTATION, IDENTIFIED BY COLORED PLASTIC CAP BEARING SURVEYORS REGISTRATION NUMBER.

STAKING OF PROPOSED RIGHT OF WAY: SET DIVISION OF HIGHWAYS SURVEY MARKER TO MONUMENT THE POSITION SHOWN, IDENTIFIED BY INSCRIPTION DATA AND SURVEYORS REGISTRATION NUMBER.

STAKING OF PROPOSED RIGHT OF WAY IN CULTIVATED AREAS: BURIED 5/8 INCH IRON ROD 20 INCHES BELOW GROUND TO MARK FUTURE SURVEY MARKER POSITION, IDENTIFIED BY COLORED PLASTIC CAP BEARING SURVEYORS REGISTRATION NUMBER.

PERMANENT SURVEY MARKER, IDOT STD. 2135 (TO BE SET BY OTHERS):

RIGHT OF WAY STAKING, PROPOSED TO BE SET:

STATE OF ILLINOIS }
COUNTY OF KANE }SS

THIS IS TO CERTIFY THAT I, REJENA H. LYON, AN ILLINOIS PROFESSIONAL LAND SURVEYOR, HAVE SURVEYED THE PLAT OF HIGHWAYS SHOWN HEREON IN SECTION 24, TOWNSHIP 40 NORTH, RANGE 10 EAST, AND SECTION 18, TOWNSHIP 40 NORTH, RANGE 11 EAST OF THE THIRD PRINCIPAL MERIDIAN, DUPAGE COUNTY, THAT THE SURVEY IS TRUE AND COMPLETE AS SHOWN TO THE BEST OF MY KNOWLEDGE AND BELIEF; THAT THE PLAT CORRECTLY REPRESENTS SAID SURVEY; THAT ALL MONUMENTS FOUND AND ESTABLISHED ARE OF PERMANENT QUALITY AND OCCUPY THE POSITIONS SHOWN HEREON AND THAT THE MONUMENTS ARE SUFFICIENT TO ENABLE THE SURVEY TO BE RETRACED, MADE FOR THE DEPARTMENT OF TRANSPORTATION, STATE OF ILLINOIS. THIS PROFESSIONAL SERVICE CONFORMS TO THE CURRENT ILLINOIS MINIMUM STANDARDS FOR A BOUNDARY SURVEY FOR THAT PORTION SHOWN AS PROPOSED RIGHT-OF-WAY.

DATED AT ELGIN, ILLINOIS, THIS _____ DAY OF _____, 20____ A.D.

ILLINOIS PROFESSIONAL LAND SURVEYOR NO. 3302
ACCOUNT NO. 2-04-0052(e)

RECEIVED
NOV 15 2010
PLATS & LEGALS

LICENSURE EXPIRES 11/30/2010

ALL BEARINGS ARE BASED ON ILLINOIS STATE PLANE COORDINATE SYSTEM NAD 83, EAST ZONE GRID.

TOPO UPDATED 7/27/09
FIELD WORK COMPLETED 5/27/09

RECEIVED
NOV 12 2010
PLATS & LEGALS


HAMPTON, LENZINI AND RENWICK, INC.
CIVIL ENGINEERS - STRUCTURAL ENGINEERS - LAND SURVEYORS
300 SHEPARD DRIVE
ELGIN, ILLINOIS 60123
647.697.6700 www.hlrengineering.com

184.000659
ILLINOIS PROFESSIONAL DESIGN FIRM & STRUCTURAL ENGINEERING CORP.

PLAT OF HIGHWAYS
STATE OF ILLINOIS
DEPARTMENT OF TRANSPORTATION
F.A.P. 870 (IL RTE 53)

DUPAGE COUNTY SECTION
PROJECT JOB NO. R-91-069-00
STATION 6+50 (IL RTE 19) TO STATION 13+50
SCALE: 1"=30' SHEET 29 OF X

BUREAU OF LAND ACQUISITION
201 WEST CENTER COURT
SCHAUMBURG, ILLINOIS 60196

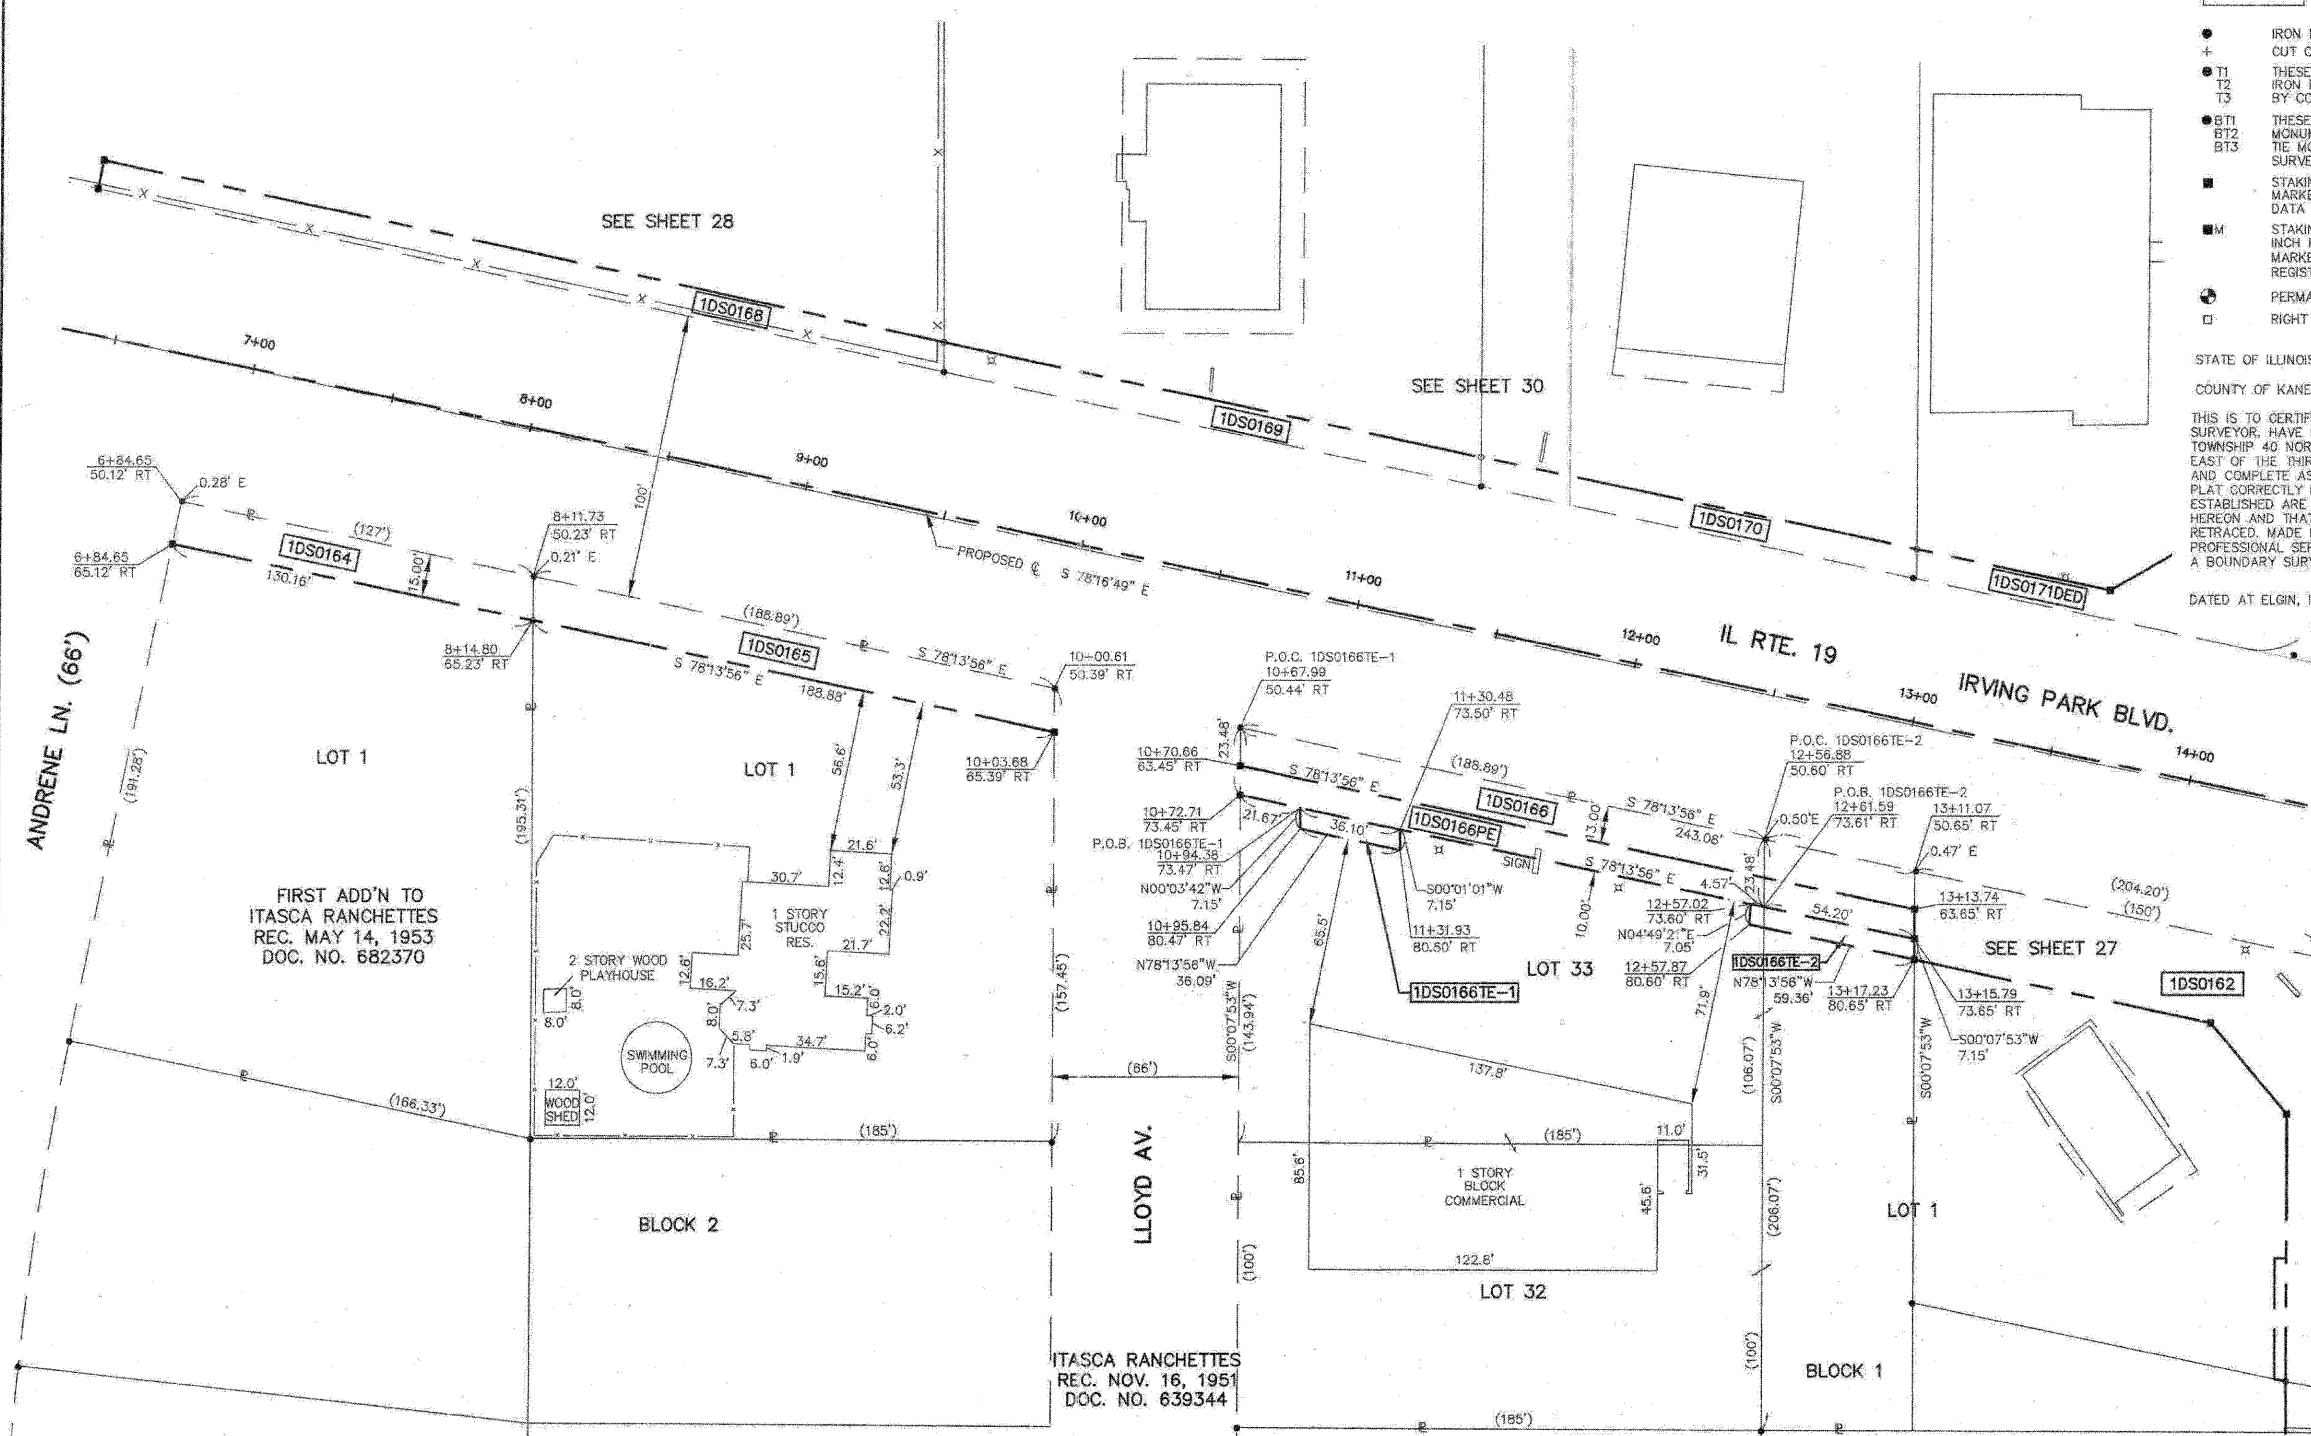

REVISED 11/10/10 PARCEL 1DS0166, ADDED PE, TE-1 & TE-2
REVISED 8/24/09 PARCEL 1DS0166 OWNERSHIP CHANGE, PIN CHANGE
REVISED 8/09/09 PARCELS 1DS0162, 1DS0165, 1DS0166 & 1DS0171 OWNERSHIP CHANGES; PARCEL 1DS0168 REVISE TOTAL HOLDING

| PARCEL NUMBER | OWNER | TOTAL HOLDINGS | AREA TAKEN | PREVIOUS DEDICATION | REMAINDER | AREA OF EASEMENT | PURPOSE OF EASEMENT | TAX NUMBER | PROPERTY ACQUIRED BY |
|---------------|--|----------------|------------|---------------------|-----------|--------------------|---------------------|---------------|----------------------|
| 1DS0189 | Itasca Bank & Trust Co., as Trustee under the provisions of a Trust Agreement dated the 13th day of March, 1989 and known as Trust No. 10656 | 1.168 AC± | 0.045 AC± | NA | 1.143 AC± | NA | NA | 02-12-204-014 | |
| 1DS0170 | Itasca Bank & Trust Co., as Trustee under the provisions of a Trust Agreement dated October 31, 1988 and known as Trust No. 10648 | 0.707 AC± | 0.035 AC± | NA | 0.671 AC± | NA | NA | 02-12-204-016 | |
| 1DS0171DED | Maya and Jlya, Inc. | 0.870 AC± | 0.125 AC±* | NA | 0.670 AC± | NA | NA | 02-12-204-006 | |
| 1DS0171TE | | | NA | NA | NA | 0.019 AC± | DRIVE | | |
| 1DS0177 | ITASCA BANK AND TRUST CO., TRUSTEE, Tr. No. 10237 | 2.157 AC± | 0.056 AC± | NA | 2.102 AC± | NA | NA | 02-12-204-010 | |
| 1DS0177E-A | | | NA | NA | NA | 0.009 AC (391 SF)± | DRIVE | | |
| 1DS0177E-B | | | NA | NA | NA | 0.014 AC± | DRIVE | | |

* AREA TO BE ACQUIRED BY DEDICATION ONLY

LEGEND



SECTION CORNER



QUARTER SECTION CORNER

- SECTION LINE
- QUARTER SECTION LINE
- QUARTER, QUARTER SECTION LINE
- PLATTED LOT LINE
- PROPERTY (DEED) LINE
- APL
- APPARENT PROPERTY LINE
- CENTERLINE
- EXISTING RIGHT OF WAY LINE
- EXISTING EASEMENT
- PROPOSED RIGHT OF WAY LINE
- PROPOSED EASEMENT
- MEASURED DIMENSION
- RECORD DATA



EXISTING BUILDINGS

- IRON PIPE OR ROD FOUND
- ⊕ CUT CROSS FOUND OR SET
- ⊙ PK NAIL FOUND OR SET
- 5/8" REBAR SET
- T1 THESE STAKES REFERENCE FOUND OR SET MONUMENTATION, SET 5/8" IRON ROD FLUSH WITH THE GROUND TO THE MONUMENTATION, IDENTIFIED BY COLORED PLASTIC CAP BEARING SURVEYORS REGISTRATION NUMBER.
- T2
- T3
- BT1 THESE STAKES, IN CULTIVATED AREAS, REFERENCE FOUND OR SET MONUMENTATION, BURIED 5/8" IRON ROD 20 INCHES BELOW GROUND TO THE MONUMENTATION, IDENTIFIED BY COLORED PLASTIC CAP BEARING SURVEYORS REGISTRATION NUMBER.
- BT2
- BT3
- STAKING OF PROPOSED RIGHT OF WAY, SET DIVISION OF HIGHWAYS SURVEY MARKER TO MONUMENT THE POSITION SHOWN, IDENTIFIED BY INSCRIPTION DATA AND SURVEYORS REGISTRATION NUMBER.
- STAKING OF PROPOSED RIGHT OF WAY IN CULTIVATED AREAS, BURIED 5/8" IRON ROD 20 INCHES BELOW GROUND TO MARK FUTURE SURVEY MARKER POSITION, IDENTIFIED BY COLORED PLASTIC CAP BEARING SURVEYORS REGISTRATION NUMBER.
- ⊕ PERMANENT SURVEY MARKER, IDOT STD. 2135 (TO BE SET BY OTHERS)
- RIGHT OF WAY STAKING PROPOSED TO BE SET

STATE OF ILLINOIS }
COUNTY OF KANE }

THIS IS TO CERTIFY THAT I, REJENA H. LYON, AN ILLINOIS PROFESSIONAL LAND SURVEYOR, HAVE SURVEYED THE PLAT OF HIGHWAYS SHOWN HEREON IN SECTION 24, TOWNSHIP 40 NORTH, RANGE 10 EAST, AND SECTION 19, TOWNSHIP 40 NORTH, RANGE 11 EAST OF THE THIRD PRINCIPAL MERIDIAN, DuPAGE COUNTY, THAT THE SURVEY IS TRUE AND COMPLETE AS SHOWN TO THE BEST OF MY KNOWLEDGE AND BELIEF; THAT THE PLAT CORRECTLY REPRESENTS SAID SURVEY; THAT ALL MONUMENTS FOUND AND ESTABLISHED ARE OF PERMANENT QUALITY AND OCCUPY THE POSITIONS SHOWN HEREON AND THAT THE MONUMENTS ARE SUFFICIENT TO ENABLE THE SURVEY TO BE RETRACED; MADE FOR THE DEPARTMENT OF TRANSPORTATION, STATE OF ILLINOIS. THIS PROFESSIONAL SERVICE CONFORMS TO THE CURRENT ILLINOIS MINIMUM STANDARDS FOR A BOUNDARY SURVEY FOR THAT PORTION SHOWN AS PROPOSED RIGHT-OF-WAY.

DATED AT ELGIN, ILLINOIS, THIS _____ DAY OF _____, 20__ A.D.

ILLINOIS PROFESSIONAL LAND SURVEYOR NO. 3302
ACCOUNT NO. 2-04-0052(c)



LICENSE EXPIRES 11/30/2010


ALL BEARINGS ARE BASED ON ILLINOIS STATE PLANE COORDINATE SYSTEM NAD 83, EAST ZONE GRID.

TOPO UPDATED 7/27/09
FIELD WORK COMPLETED 6/27/03

HAMPTON, LENZINI AND RENWICK, INC.
CIVIL ENGINEERS • STRUCTURAL ENGINEERS • LAND SURVEYORS
HLR 380 SHEPARD DRIVE
ELGIN, ILLINOIS 60123
847.697.6700 www.hlrengineering.com
184.035899
ILLINOIS PROFESSIONAL DESIGN FIRM & STRUCTURAL ENGINEERING CORP.

RECEIVED
AUG 25 2009
PLATS & LEGALS

PLAT OF HIGHWAYS
STATE OF ILLINOIS
DEPARTMENT OF TRANSPORTATION
F.A.P. 870 (IL RTE 53)
DuPAGE COUNTY SECTION
PROJECT JOB NO. R-91-069-00
STATION 9+00 (IL RTE 19) TO STATION 15+00
SCALE: 1"=30' SHEET 30 OF X
BUREAU OF LAND ACQUISITION
201 WEST CENTER COURT
SCHAUMBURG, ILLINOIS 60196

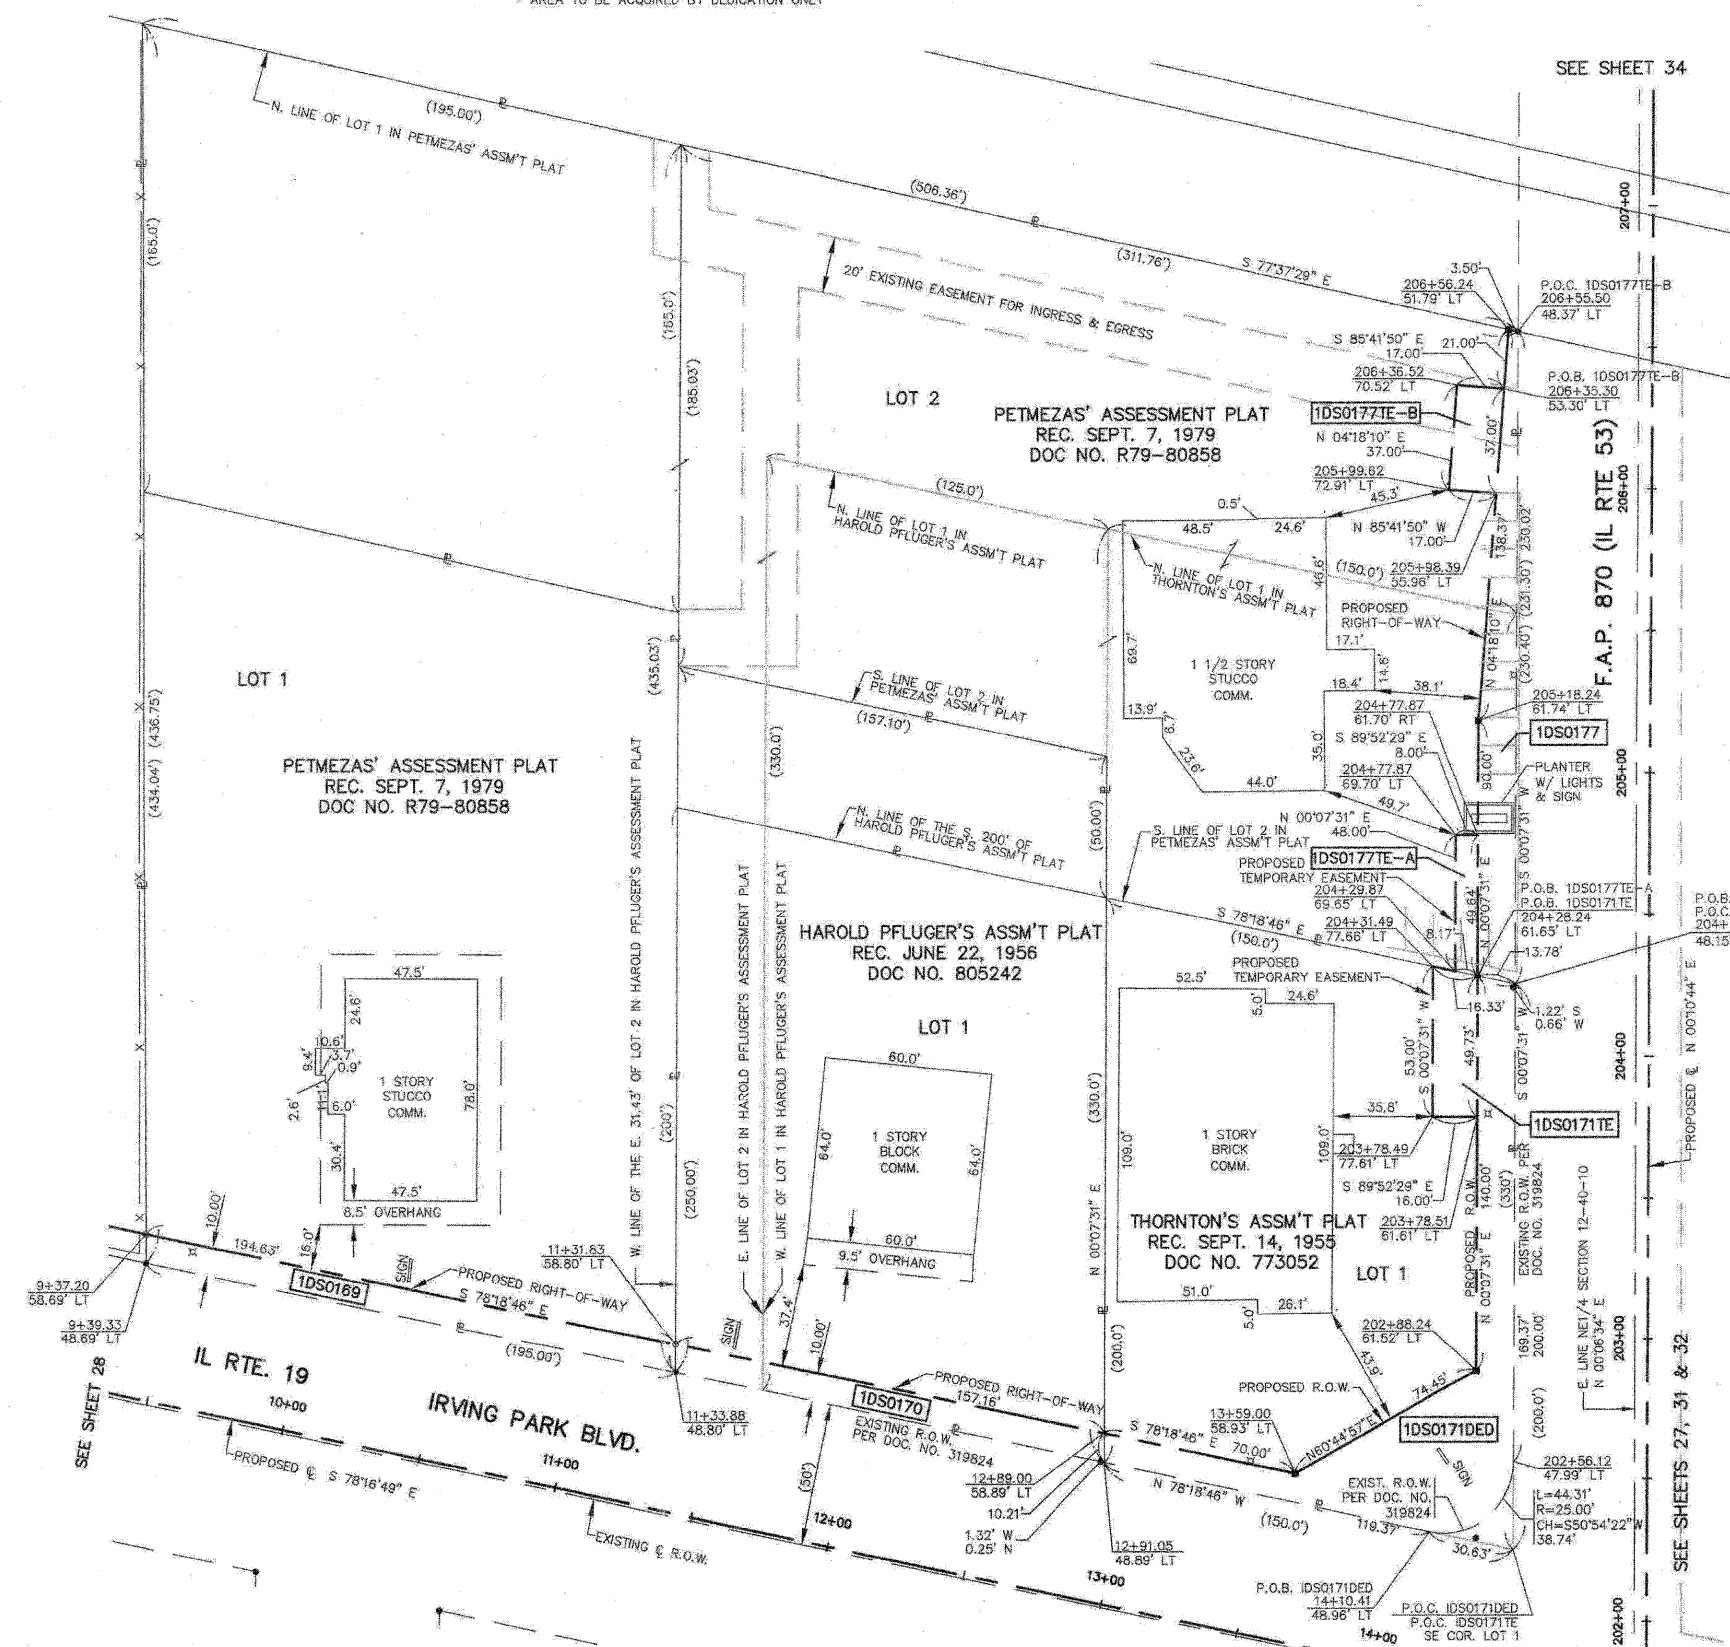

REVISED 8/09/09 PARCEL 1DS0171 OWNERSHIP CHANGE

F.A.P. 870 (IL RTE 53)

DuPAGE COUNTY

JOB NO. R-91-069-00

4/16

| PARCEL NUMBER | OWNER | TOTAL HOLDINGS | AREA TAKEN | PREVIOUS DEDICATION | REMAINDER | AREA OF EASEMENT | PURPOSE OF EASEMENT | TAX NUMBER | PROPERTY ACQUIRED BY | |
|---------------|------------------------------|----------------|------------|---------------------|-----------|------------------|---------------------|---------------|----------------------|---------|
| 1DS0160A | United States Postal Service | 3.690 AC± | 0.065 AC± | NA | 3.528 AC± | NA | NA | 03-07-103-013 | | |
| 1DS0160B | | | 0.097 AC± | NA | | NA | NA | | | |
| 1DS0160TE | | | NA | NA | | NA | 0.029 AC± | | | GRADING |
| 1DS0163DED | Mobil Oil Corporation | 0.802 AC± | 0.147 AC±* | NA | 0.802 AC± | NA | NA | 03-07-103-015 | | |
| 1DS0163TE-A | | | NA | NA | | NA | 0.015 AC± | | | DRIVE |
| 1DS0163TE-B | | | NA | NA | | NA | 0.009 AC (380 SF)± | | | DRIVE |

* AREA TO BE ACQUIRED BY DEDICATION ONLY

LEGEND

- SECTION LINE
- QUARTER SECTION LINE
- QUARTER, QUARTER SECTION LINE
- PLATTED LOT LINE
- PROPERTY (DEED) LINE
- APL APPARENT PROPERTY LINE
- CENTERLINE
- EXISTING RIGHT OF WAY LINE
- EXISTING EASEMENT
- PROPOSED RIGHT OF WAY LINE
- PROPOSED EASEMENT
- MEASURED DIMENSION
- RECORD DATA

SECTION CORNER

QUARTER SECTION CORNER

EXISTING BUILDINGS

- IRON PIPE OR ROD FOUND
- + CUT CROSS FOUND OR SET
- T1 THESE STAKES REFERENCE FOUND OR SET MONUMENTATION, SET 5/8 INCH IRON ROD FLUSH WITH THE GROUND TO THE MONUMENTATION, IDENTIFIED BY COLORED PLASTIC CAP BEARING SURVEYORS REGISTRATION NUMBER.
- T2
- T3
- BT1 THESE STAKES, IN CULTIVATED AREAS, REFERENCE FOUND OR SET MONUMENTATION, BURIED 5/8 INCH ROD 20 INCHES BELOW GROUND TO THE MONUMENTATION, IDENTIFIED BY COLORED PLASTIC CAP BEARING SURVEYORS REGISTRATION NUMBER.
- BT2
- BT3
- STAKING OF PROPOSED RIGHT OF WAY, SET DIVISION OF HIGHWAYS SURVEY MARKER TO MONUMENT THE POSITION SHOWN, IDENTIFIED BY INSCRIPTION DATA AND SURVEYORS REGISTRATION NUMBER.
- M STAKING OF PROPOSED RIGHT OF WAY IN CULTIVATED AREAS, BURIED 5/8 INCH IRON ROD 20 INCHES BELOW GROUND TO MARK FUTURE SURVEY MARKER POSITION, IDENTIFIED BY COLORED PLASTIC CAP BEARING SURVEYORS REGISTRATION NUMBER.
- PERMANENT SURVEY MARKER, IDOT STD. 2135 (TO BE SET BY OTHERS)
- RIGHT OF WAY STAKING PROPOSED TO BE SET

STATE OF ILLINOIS }
 COUNTY OF KANE } SS

THIS IS TO CERTIFY THAT I, REJENA H. LYON, AN ILLINOIS PROFESSIONAL LAND SURVEYOR, HAVE SURVEYED THE PLAT OF HIGHWAYS SHOWN HEREON IN SECTION 24, TOWNSHIP 40 NORTH, RANGE 10 EAST, AND SECTION 19, TOWNSHIP 40 NORTH, RANGE 11 EAST OF THE THIRD PRINCIPAL MERIDIAN, DUPAGE COUNTY, THAT THE SURVEY IS TRUE AND COMPLETE AS SHOWN TO THE BEST OF MY KNOWLEDGE AND BELIEF; THAT THE PLAT CORRECTLY REPRESENTS SAID SURVEY; THAT ALL MONUMENTS FOUND AND ESTABLISHED ARE OF PERMANENT QUALITY AND OCCUPY THE POSITIONS SHOWN HEREON AND THAT THE MONUMENTS ARE SUFFICIENT TO ENABLE THE SURVEY TO BE RETRACED, MADE FOR THE DEPARTMENT OF TRANSPORTATION, STATE OF ILLINOIS; THIS PROFESSIONAL SERVICE CONFORMS TO THE CURRENT ILLINOIS MINIMUM STANDARDS FOR A BOUNDARY SURVEY FOR THAT PORTION SHOWN AS PROPOSED RIGHT-OF-WAY.

DATED AT ELGIN, ILLINOIS, THIS _____ DAY OF _____, 20____ A.D.

ILLINOIS PROFESSIONAL LAND SURVEYOR NO. 3302
 ACCOUNT NO. 2-04-0052(a)

RECEIVED
 SEP 02 2008


PLATS & LEGALS

HAMPTON, LENZINI AND RENWICK, INC.
 CIVIL ENGINEERS - STRUCTURAL ENGINEERS - LAND SURVEYORS
 380 SHEPARD DRIVE
 ELGIN, ILLINOIS 60120
 847.697.6700 www.hirengineering.com

PLAT OF HIGHWAYS
 STATE OF ILLINOIS
 DEPARTMENT OF TRANSPORTATION
 F.A.P. 870 (IL RTE 53)

DuPAGE COUNTY SECTION
 PROJECT JOB NO. R-91-069-00
 STATION 16+00 (IL RTE 19) TO STATION 24+00
 SCALE: 1"=30' SHEET 31 OF X

BUREAU OF LAND ACQUISITION
 201 WEST CENTER COURT
 SCHAMBURG, ILLINOIS 60196

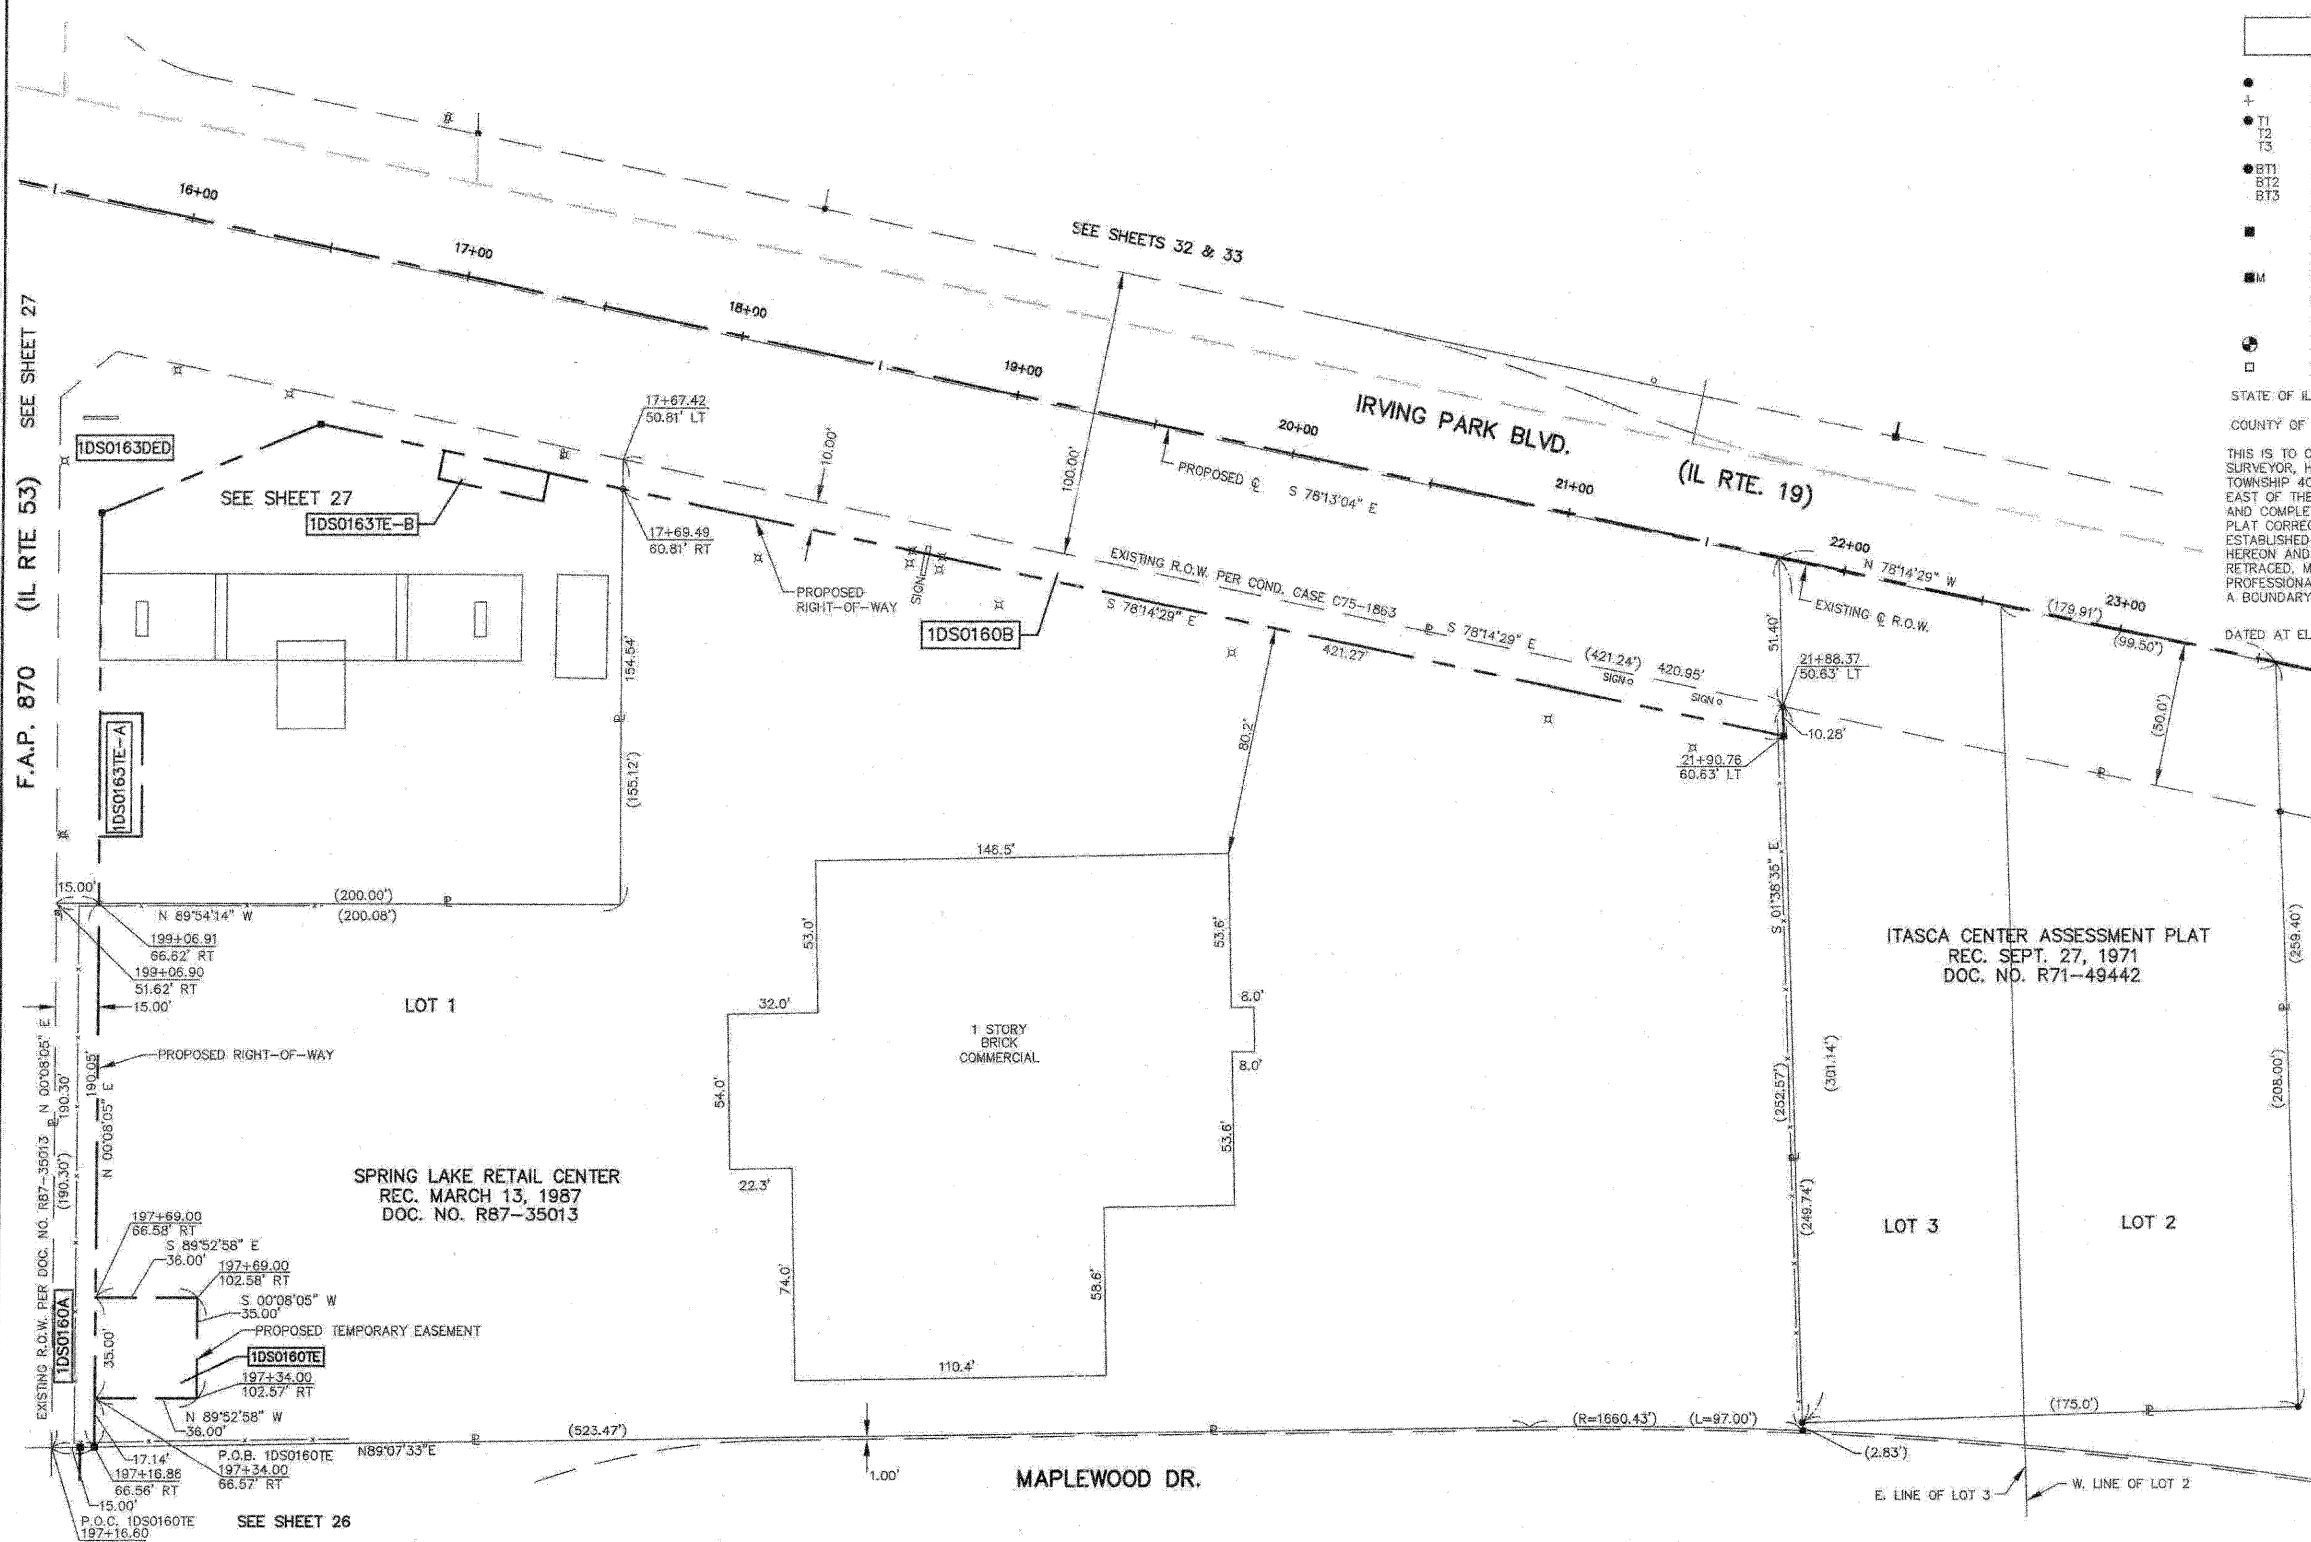

| PARCEL NUMBER | OWNER | TOTAL HOLDINGS | AREA TAKEN | PREVIOUS DEDICATION | REMAINDER | AREA OF EASEMENT | PURPOSE OF EASEMENT | TAX NUMBER | PROPERTY ACQUIRED BY |
|---------------|---|----------------|--------------------|---------------------|-----------|------------------|---------------------|---------------|----------------------|
| 1DS0172DED | | | 0.081 AC±* | NA | 0.437 AC± | NA | NA | | |
| 1DS0172TE-A | 1149 Irving Park Real Estate, Inc., an Illinois corporation | 0.437 AC± | NA | NA | NA | 0.014 AC± | DRIVE | 03-07-102-005 | |
| 1DS0172TE-B | | | NA | NA | NA | 0.029 AC± | DRIVE/SIDEWALK | | |
| 1DS0173A | | | 0.048 AC± | NA | 2.579 AC± | NA | NA | 03-07-102-011 | |
| 1DS0173B | Charter National Bank and Trust, as Trustee under Trust Agreement known as Trust No. 1750-A | 2.633 AC± | 0.006 AC (256 SF)± | NA | NA | NA | NA | 03-07-102-012 | |
| 1DS0173TE | | | NA | NA | NA | 0.043 AC± | DRIVE/SIDEWALK | | |
| 1DS0174 | PLDSPE, LLC, a Delaware limited liability company | 3.034 AC± | 0.177 AC± | NA | 2.857 AC± | NA | NA | 03-07-102-009 | |

* AREA TO BE ACQUIRED BY DEDICATION ONLY

LEGEND

SECTION CORNER
QUARTER SECTION CORNER

SECTION LINE
QUARTER SECTION LINE
QUARTER, QUARTER SECTION LINE
PLATTED LOT LINE
PROPERTY (DEED) LINE

APL
APPARENT PROPERTY LINE
CENTERLINE
EXISTING RIGHT OF WAY LINE
EXISTING EASEMENT
PROPOSED RIGHT OF WAY LINE
PROPOSED EASEMENT
MEASURED DIMENSION
RECORD DATA

EXISTING BUILDINGS

IRON PIPE OR ROD FOUND
CUT CROSS FOUND OR SET
T1
T2
T3
BT1
BT2
BT3

PK NAIL FOUND OR SET
5/8" REBAR SET

THESE STAKES REFERENCE FOUND OR SET MONUMENTATION, SET 5/8 INCH IRON ROD FLUSH WITH THE GROUND TO THE MONUMENTATION, IDENTIFIED BY COLORED PLASTIC CAP BEARING SURVEYORS REGISTRATION NUMBER.

THESE STAKES, IN CULTIVATED AREAS, REFERENCE FOUND OR SET MONUMENTATION, BURIED 5/8 INCH ROD 20 INCHES BELOW GROUND TO THE MONUMENTATION, IDENTIFIED BY COLORED PLASTIC CAP BEARING SURVEYORS REGISTRATION NUMBER.

STAKING OF PROPOSED RIGHT OF WAY, SET DIVISION OF HIGHWAYS SURVEY MARKER TO MONUMENT THE POSITION SHOWN, IDENTIFIED BY INSCRIPTION DATA AND SURVEYORS REGISTRATION NUMBER.

STAKING OF PROPOSED RIGHT OF WAY IN CULTIVATED AREAS, BURIED 5/8 INCH IRON ROD 20 INCHES BELOW GROUND TO MARK FUTURE SURVEY MARKER POSITION, IDENTIFIED BY COLORED PLASTIC CAP BEARING SURVEYORS REGISTRATION NUMBER.

PERMANENT SURVEY MARKER, 1/2" STD. 2135 (TO BE SET BY OTHERS)

RIGHT OF WAY STAKING PROPOSED TO BE SET


SEE SHEET 34

SEE SHEET 30

F.A.P. 870 (IL RTE 53)

W. LINE NE1/4 SECTION 7-40-11 N 0°06'34" E

SEE SHEET 27

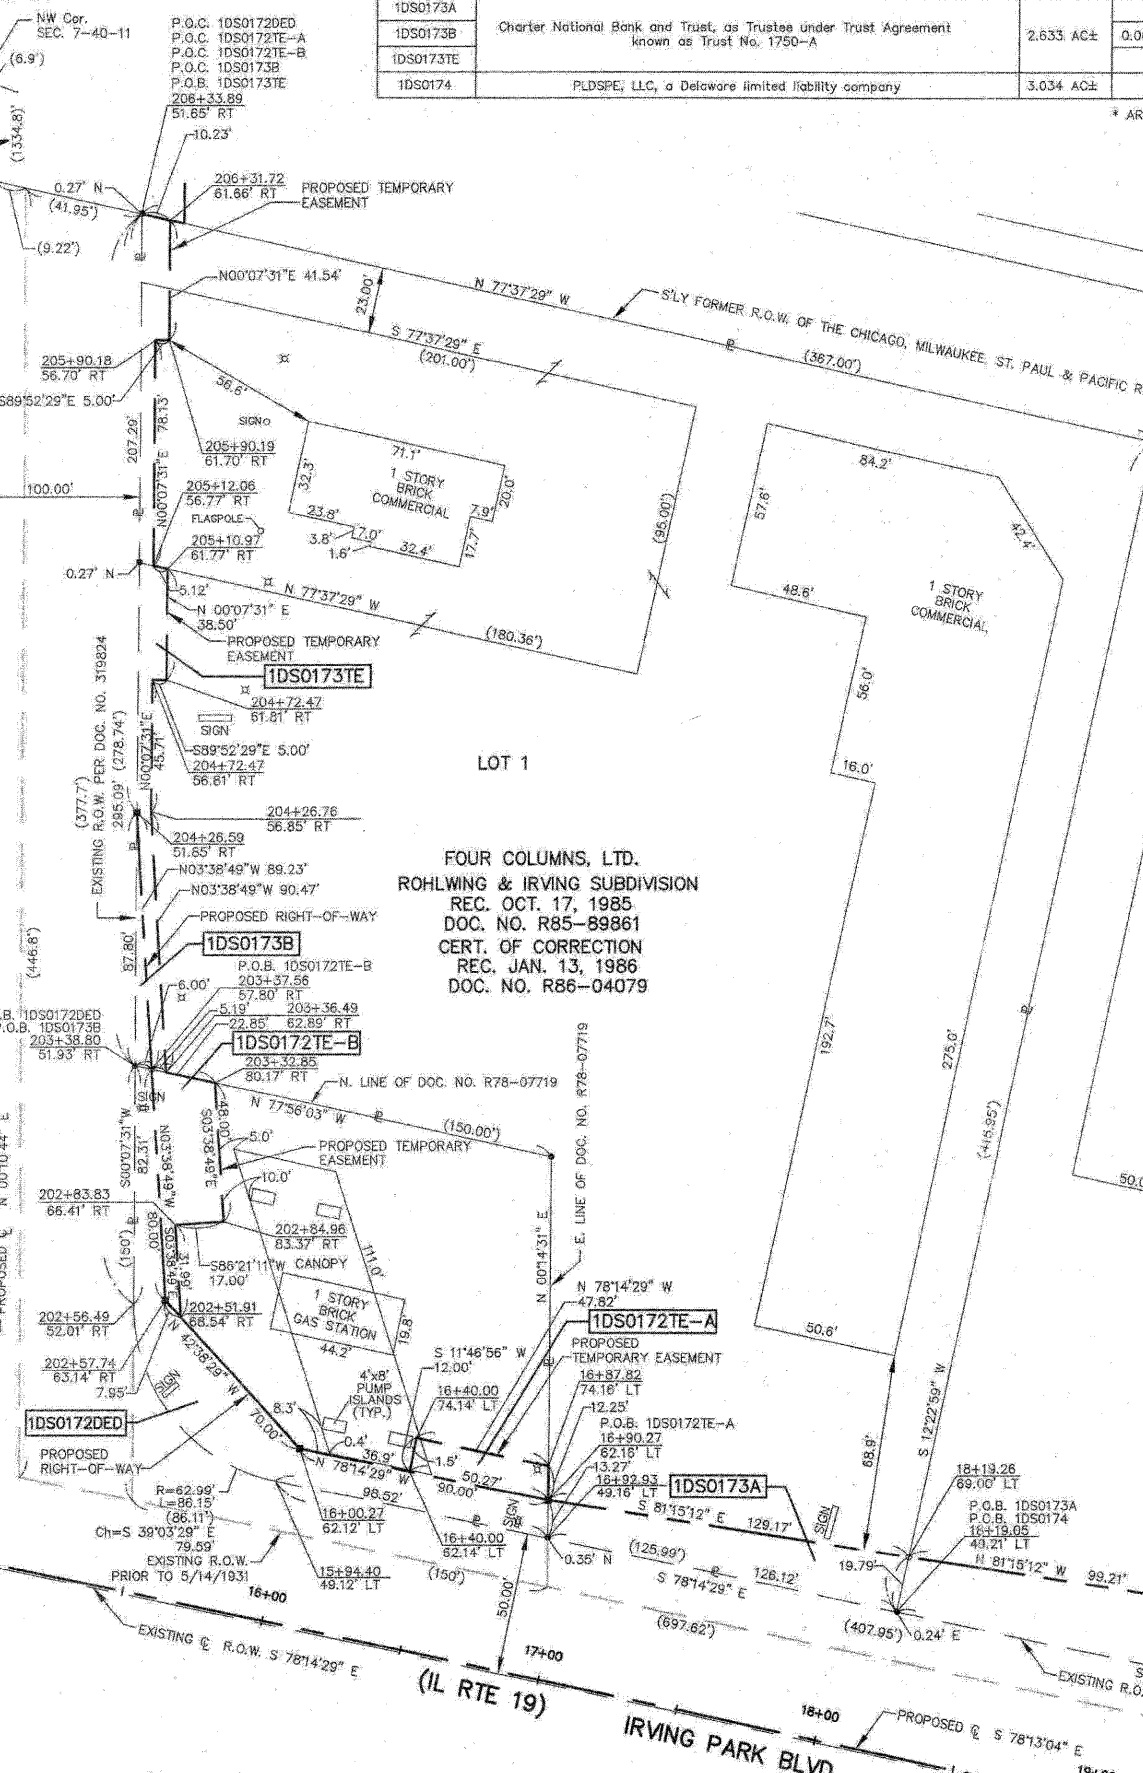

FOUR COLUMNS, LTD.
ROHLWING & IRVING SUBDIVISION
REC. OCT. 17, 1985
DOC. NO. R85-89861
CERT. OF CORRECTION
REC. JAN. 13, 1986
DOC. NO. R86-04079

STATE OF ILLINOIS)
COUNTY OF KANE)

THIS IS TO CERTIFY THAT I, REJENA H. LYON, AN ILLINOIS PROFESSIONAL LAND SURVEYOR, HAVE SURVEYED THE PLAT OF HIGHWAYS SHOWN HEREON IN SECTION 24, TOWNSHIP 40 NORTH, RANGE 11 EAST, AND SECTION 19, TOWNSHIP 40 NORTH, RANGE 11 EAST OF THE THIRD PRINCIPAL MERIDIAN, DUPAGE COUNTY; THAT THE SURVEY IS TRUE AND COMPLETE AS SHOWN TO THE BEST OF MY KNOWLEDGE AND BELIEF; THAT THE PLAT CORRECTLY REPRESENTS SAID SURVEY; THAT ALL MONUMENTS FOUND AND ESTABLISHED ARE OF PERMANENT QUALITY AND OCCUPY THE POSITIONS SHOWN HEREON AND THAT THE MONUMENTS ARE SUFFICIENT TO ENABLE THE SURVEY TO BE RETRACED, MADE FOR THE DEPARTMENT OF TRANSPORTATION, STATE OF ILLINOIS, THIS PROFESSIONAL SERVICE CONFORMS TO THE CURRENT ILLINOIS MINIMUM STANDARDS FOR A BOUNDARY SURVEY FOR THAT PORTION SHOWN AS PROPOSED RIGHT-OF-WAY.

DATED AT ELGIN, ILLINOIS, THIS _____ DAY OF _____, 20____ A.D.

ILLINOIS PROFESSIONAL LAND SURVEYOR NO. 3302
ACCOUNT NO. 2-04-0052(a)

ALL BEARINGS ARE BASED ON ILLINOIS STATE PLANE COORDINATE SYSTEM NAD 83, EAST ZONE GRID.

RECEIVED
FEB 23 2010
PLATS & LEGALS

TOPO UPDATED 7/27/09
FIELD WORK COMPLETED 6/27/03

HAMPTON, LENZINI AND RENWICK, INC.
CIVIL ENGINEERS - STRUCTURAL ENGINEERS - LAND SURVEYORS
880 SHEPARD DRIVE
ELGIN, ILLINOIS 60123
847.997.6700 www.hirengineering.com

PLAT OF HIGHWAYS
STATE OF ILLINOIS
DEPARTMENT OF TRANSPORTATION
F.A.P. 870 (IL RTE 53)

DUPAGE COUNTY SECTION
PROJECT JOB NO. R-91-069-00
STATION 15+00 (IL RTE 19) TO STATION 21+50
SCALE: 1"=30' SHEET 32 OF X

BUREAU OF LAND ACQUISITION
201 WEST CENTER COURT
SCHAUMBURG, ILLINOIS 60196


| PARCEL NUMBER | OWNER | TOTAL HOLDINGS | AREA TAKEN | PREVIOUS DEDICATION | REMAINDER | AREA OF EASEMENT | PURPOSE OF EASEMENT | TAX NUMBER | PROPERTY ACQUIRED BY |
|---------------|---|----------------|------------|---------------------|-----------|------------------|---------------------|---------------|----------------------|
| 1DS0160A | United States Postal Service | 3.690 AC± | 0.065 AC± | NA | 3.528 AC± | NA | NA | 03-07-103-013 | |
| 1DS0160B | | | 0.097 AC± | NA | | NA | NA | | |
| 1DS0160TE | | | NA | NA | | 0.029 AC± | GRADING | | |
| 1DS0174 | PLDSPE, LLC, a Delaware limited liability company | 3.034 AC± | 0.177 AC± | NA | 2.857 AC± | NA | NA | 03-07-102-009 | |
| 1DS0175 | West Suburban Industrial, SDCO, Inc. | 3.303 AC± | NA | NA | NA | 0.040 AC± | CONSTRUCTION | 03-07-102-010 | |

LEGEND

- SECTION CORNER
- QUARTER SECTION CORNER
- SECTION LINE
- QUARTER SECTION LINE
- QUARTER, QUARTER SECTION LINE
- PLATTED LOT LINE
- PROPERTY (DEED) LINE
- APL APPARENT PROPERTY LINE
- CENTERLINE
- EXISTING RIGHT OF WAY LINE
- EXISTING EASEMENT
- PROPOSED RIGHT OF WAY LINE
- PROPOSED EASEMENT
- MEASURED DIMENSION
- RECORD DATA
- EXISTING BUILDINGS

39.41' ()

0 5 10 15 20

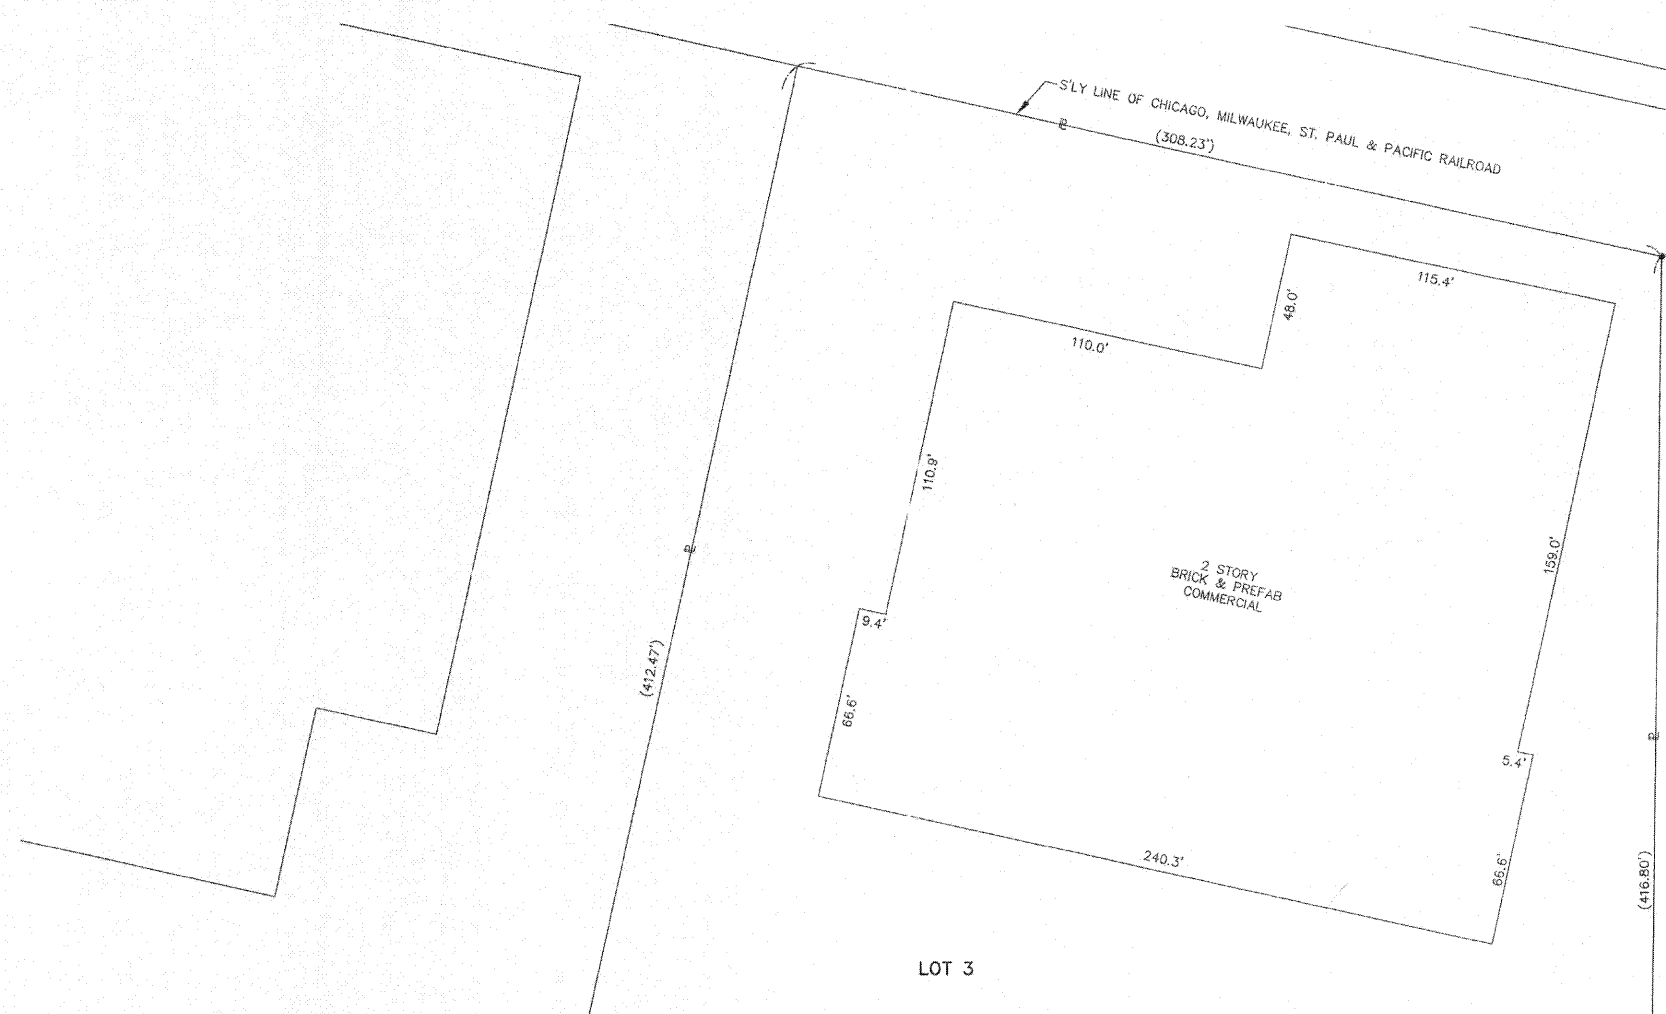

- IRON PIPE OR ROD FOUND
- + CUT CROSS FOUND OR SET
- T1 THESE STAKES REFERENCE FOUND OR SET MONUMENTATION, IDENTIFIED BY COLORED PLASTIC CAP BEARING SURVEYORS REGISTRATION NUMBER.
- T2
- T3
- BT1 THESE STAKES, IN CULTIVATED AREAS, REFERENCE FOUND OR SET MONUMENTATION, BURIED 5/8 INCH ROD 20 INCHES BELOW GROUND TO THE MONUMENTATION, IDENTIFIED BY COLORED PLASTIC CAP BEARING SURVEYORS REGISTRATION NUMBER.
- BT2
- BT3
- STAKING OF PROPOSED RIGHT OF WAY. SET DIVISION OF HIGHWAYS SURVEY MARKER TO MONUMENT THE POSITION SHOWN, IDENTIFIED BY INSCRIPTION DATA AND SURVEYORS REGISTRATION NUMBER.
- M STAKING OF PROPOSED RIGHT OF WAY IN CULTIVATED AREAS. BURIED 5/8 INCH IRON ROD, 20 INCHES BELOW GROUND TO MARK FUTURE SURVEY MARKER POSITION, IDENTIFIED BY COLORED PLASTIC CAP BEARING SURVEYORS REGISTRATION NUMBER.
- ⊕ PERMANENT SURVEY MARKER, IDOT STD. 2135 (TO BE SET BY OTHERS)
- RIGHT OF WAY STAKING PROPOSED TO BE SET

STATE OF ILLINOIS }
 COUNTY OF KANE }
 THIS IS TO CERTIFY THAT I, REJENA H. LYON, AN ILLINOIS PROFESSIONAL LAND SURVEYOR, HAVE SURVEYED THE PLAT OF HIGHWAYS SHOWN HEREON IN SECTION 24, TOWNSHIP 40 NORTH, RANGE 10 EAST, AND SECTION 19, TOWNSHIP 40 NORTH, RANGE 11 EAST OF THE THIRD PRINCIPAL MERIDIAN, DUPAGE COUNTY; THAT THE SURVEY IS TRUE AND COMPLETE AS SHOWN TO THE BEST OF MY KNOWLEDGE AND BELIEF; THAT THE PLAT CORRECTLY REPRESENTS SAID SURVEY; THAT ALL MONUMENTS FOUND AND ESTABLISHED ARE OF PERMANENT QUALITY AND OCCUPY THE POSITIONS SHOWN HEREON AND THAT THE MONUMENTS ARE SUFFICIENT TO ENABLE THE SURVEY TO BE RETRACED. MADE FOR THE DEPARTMENT OF TRANSPORTATION, STATE OF ILLINOIS. THIS PROFESSIONAL SERVICE CONFORMS TO THE CURRENT ILLINOIS MINIMUM STANDARDS FOR A BOUNDARY SURVEY FOR THAT PORTION SHOWN AS PROPOSED RIGHT-OF-WAY.

DATED AT ELGIN, ILLINOIS, THIS _____ DAY OF _____, 20__ A.D.


ILLINOIS PROFESSIONAL LAND SURVEYOR NO. 3302
 ACCOUNT NO. 2-04-0052(a)



LICENSE EXPIRES 11/30/2010

ALL BEARINGS ARE BASED ON ILLINOIS STATE PLANE COORDINATE SYSTEM NAD 83, EAST ZONE GRID.

FOUR COLUMNS, LTD.
 ROHLWING & IRVING SUBDIVISION
 REC. OCT. 17, 1985
 DOC. NO. R85-89861
 CERT. OF CORRECTION
 REC. JAN. 13, 1986
 DOC. NO. R86-04079

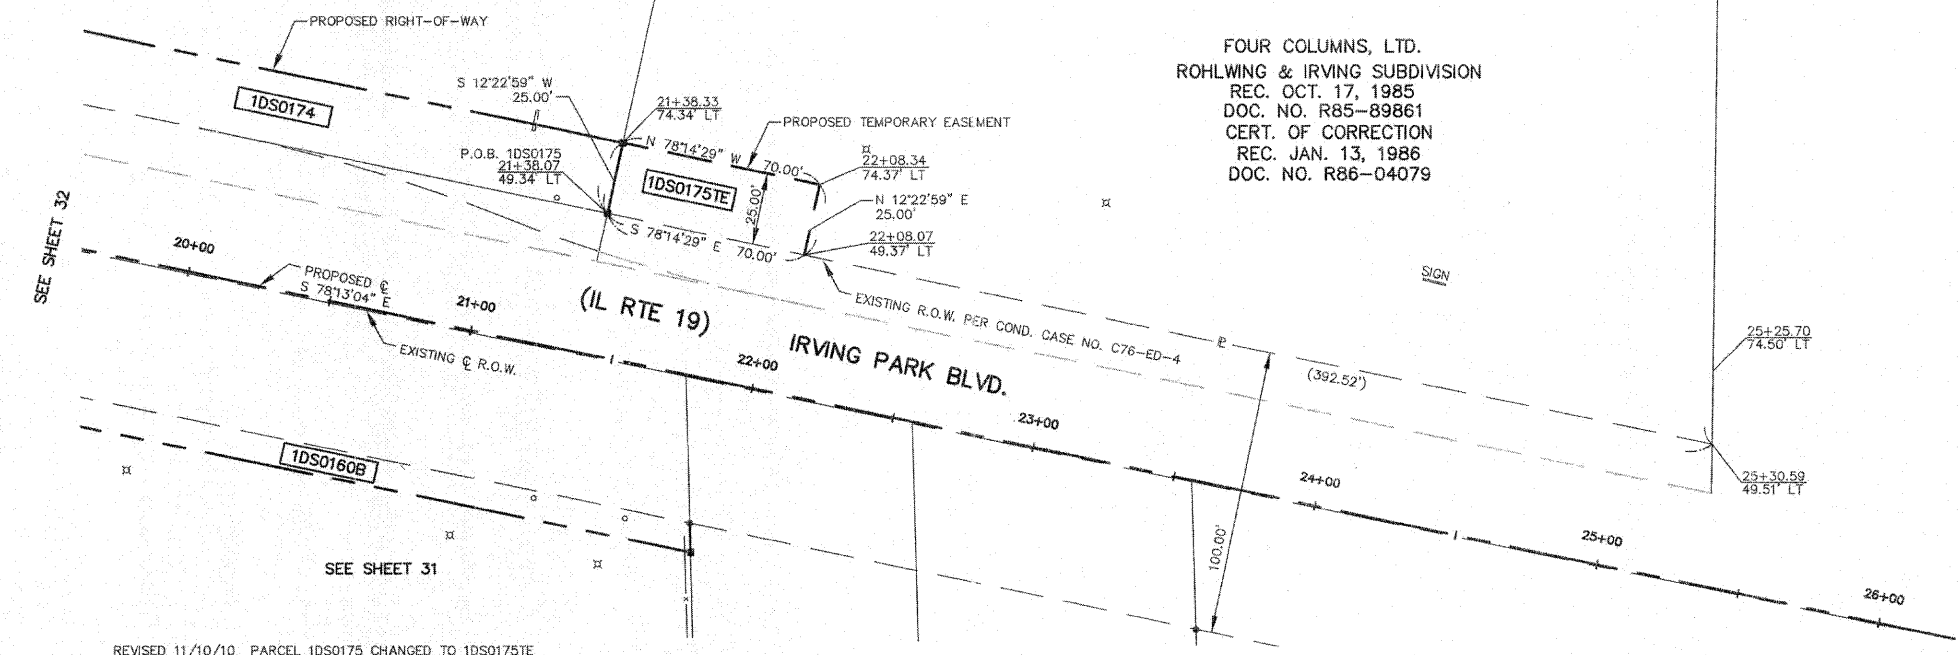

RECEIVED
 NOV 12 2010
 PLATS & LEGALS

HAMPTON, LENZINI AND RENWICK, INC.
 CIVIL ENGINEERS - STRUCTURAL ENGINEERS - LAND SURVEYORS
HLR
 380 SHEPARD DRIVE
 ELGIN, ILLINOIS 60123
 847.697.6700 www.hlrengineering.com
 184.000959
 ILLINOIS PROFESSIONAL DESIGN FIRM & STRUCTURAL ENGINEERING CORP.

TOPO UPDATED 7/27/09
 FIELD WORK COMPLETED 6/27/03

PLAT OF HIGHWAYS
 STATE OF ILLINOIS
 DEPARTMENT OF TRANSPORTATION
 F.A.P. 870 (IL RTE 53)
 DUPAGE COUNTY SECTION
 PROJECT JOB NO. R-91-069-00
 STATION 20+00 (IL RTE 19) TO STATION 26+00
 SCALE: 1"=30' SHEET 33 OF X
BUREAU OF LAND ACQUISITION
 201 WEST CENTER COURT
 SCHAUMBURG, ILLINOIS 60196

REVISED 11/10/10 PARCEL 1DS0175 CHANGED TO 1DS0175TE
 REVISED 2/22/10 PARCEL 1DS0174 OWNERSHIP CHANGE

F.A.P. 870 (IL RTE 53)

DUPAGE COUNTY

JOB NO. R-91-069-00

4/19

| PARCEL NUMBER | OWNER | TOTAL HOLDINGS | AREA TAKEN | PREVIOUS DEDICATION | REMAINDER | AREA OF EASEMENT | PURPOSE OF EASEMENT | TAX NUMBER | PROPERTY ACQUIRED BY |
|---------------|---|----------------|------------|---------------------|------------|--------------------|---------------------|---------------|----------------------|
| 1DS0224PE | The Commuter Rail Division of the Regional Transportation Authority also known as Metra | NA | NA | NA | NA | 0.168 AC± | RIGHT-OF-WAY | 03-07-504-001 | |
| 1DS0225PE | The Commuter Rail Division of the Regional Transportation Authority also known as Metra | NA | NA | NA | NA | 0.125 AC± | RIGHT-OF-WAY | 02-12-504-002 | |
| 1DS0180 | Illinois Tool Works, Inc. | 12,522 AC± | 0.263 AC± | NA | 12,259 AC± | NA | NA | 03-07-101-005 | |
| 1DS0181 | Ingraffia-Gambino Investments, LLC, an Illinois limited liability company | 9,106 AC± | 0.131 AC± | NA | 8,975 AC± | NA | NA | 02-12-201-019 | |
| 1DS0181TE | | | | | | 0.008 AC (328 SF±) | DRIVE | | |


LEGEND

- SECTION LINE
- QUARTER SECTION LINE
- QUARTER, QUARTER SECTION LINE
- PLATTED LOT LINE
- PROPERTY (DEED) LINE
- APL APPARENT PROPERTY LINE
- CENTERLINE
- EXISTING RIGHT OF WAY LINE
- EXISTING EASEMENT
- PROPOSED RIGHT OF WAY LINE
- PROPOSED EASEMENT
- MEASURED DIMENSION RECORD DATA

39.41' ()

EXISTING BUILDINGS

- IRON PIPE OR ROD FOUND
- CUT CROSS FOUND OR SET
- T1 THESE STAKES REFERENCE FOUND OR SET MONUMENTATION, SET 5/8 INCH IRON ROD FLUSH WITH THE GROUND TO THE MONUMENTATION, IDENTIFIED BY COLORED PLASTIC CAP BEARING SURVEYORS REGISTRATION NUMBER.
- T2 THESE STAKES, IN CULTIVATED AREAS, REFERENCE FOUND OR SET MONUMENTATION, BURIED 5/8 INCH ROD 20 INCHES BELOW GROUND TO THE MONUMENTATION, IDENTIFIED BY COLORED PLASTIC CAP BEARING SURVEYORS REGISTRATION NUMBER.
- T3 THESE STAKES, IN CULTIVATED AREAS, REFERENCE FOUND OR SET MONUMENTATION, BURIED 5/8 INCH ROD 20 INCHES BELOW GROUND TO THE MONUMENTATION, IDENTIFIED BY COLORED PLASTIC CAP BEARING SURVEYORS REGISTRATION NUMBER.
- BT1 STAKING OF PROPOSED RIGHT OF WAY, SET DIVISION OF HIGHWAYS SURVEY MARKER TO MONUMENT THE POSITION SHOWN, IDENTIFIED BY INSCRIPTION DATA AND SURVEYORS REGISTRATION NUMBER.
- BT2 STAKING OF PROPOSED RIGHT OF WAY IN CULTIVATED AREAS, BURIED 5/8 INCH IRON ROD 20 INCHES BELOW GROUND TO MARK FUTURE SURVEY MARKER POSITION, IDENTIFIED BY COLORED PLASTIC CAP BEARING SURVEYORS REGISTRATION NUMBER.
- BT3 PERMANENT SURVEY MARKER, IDOT STD. 2135 (TO BE SET BY OTHERS)
- PK' NAIL FOUND OR SET
- 5/8" REBAR SET
- RIGHT OF WAY STAKING PROPOSED TO BE SET

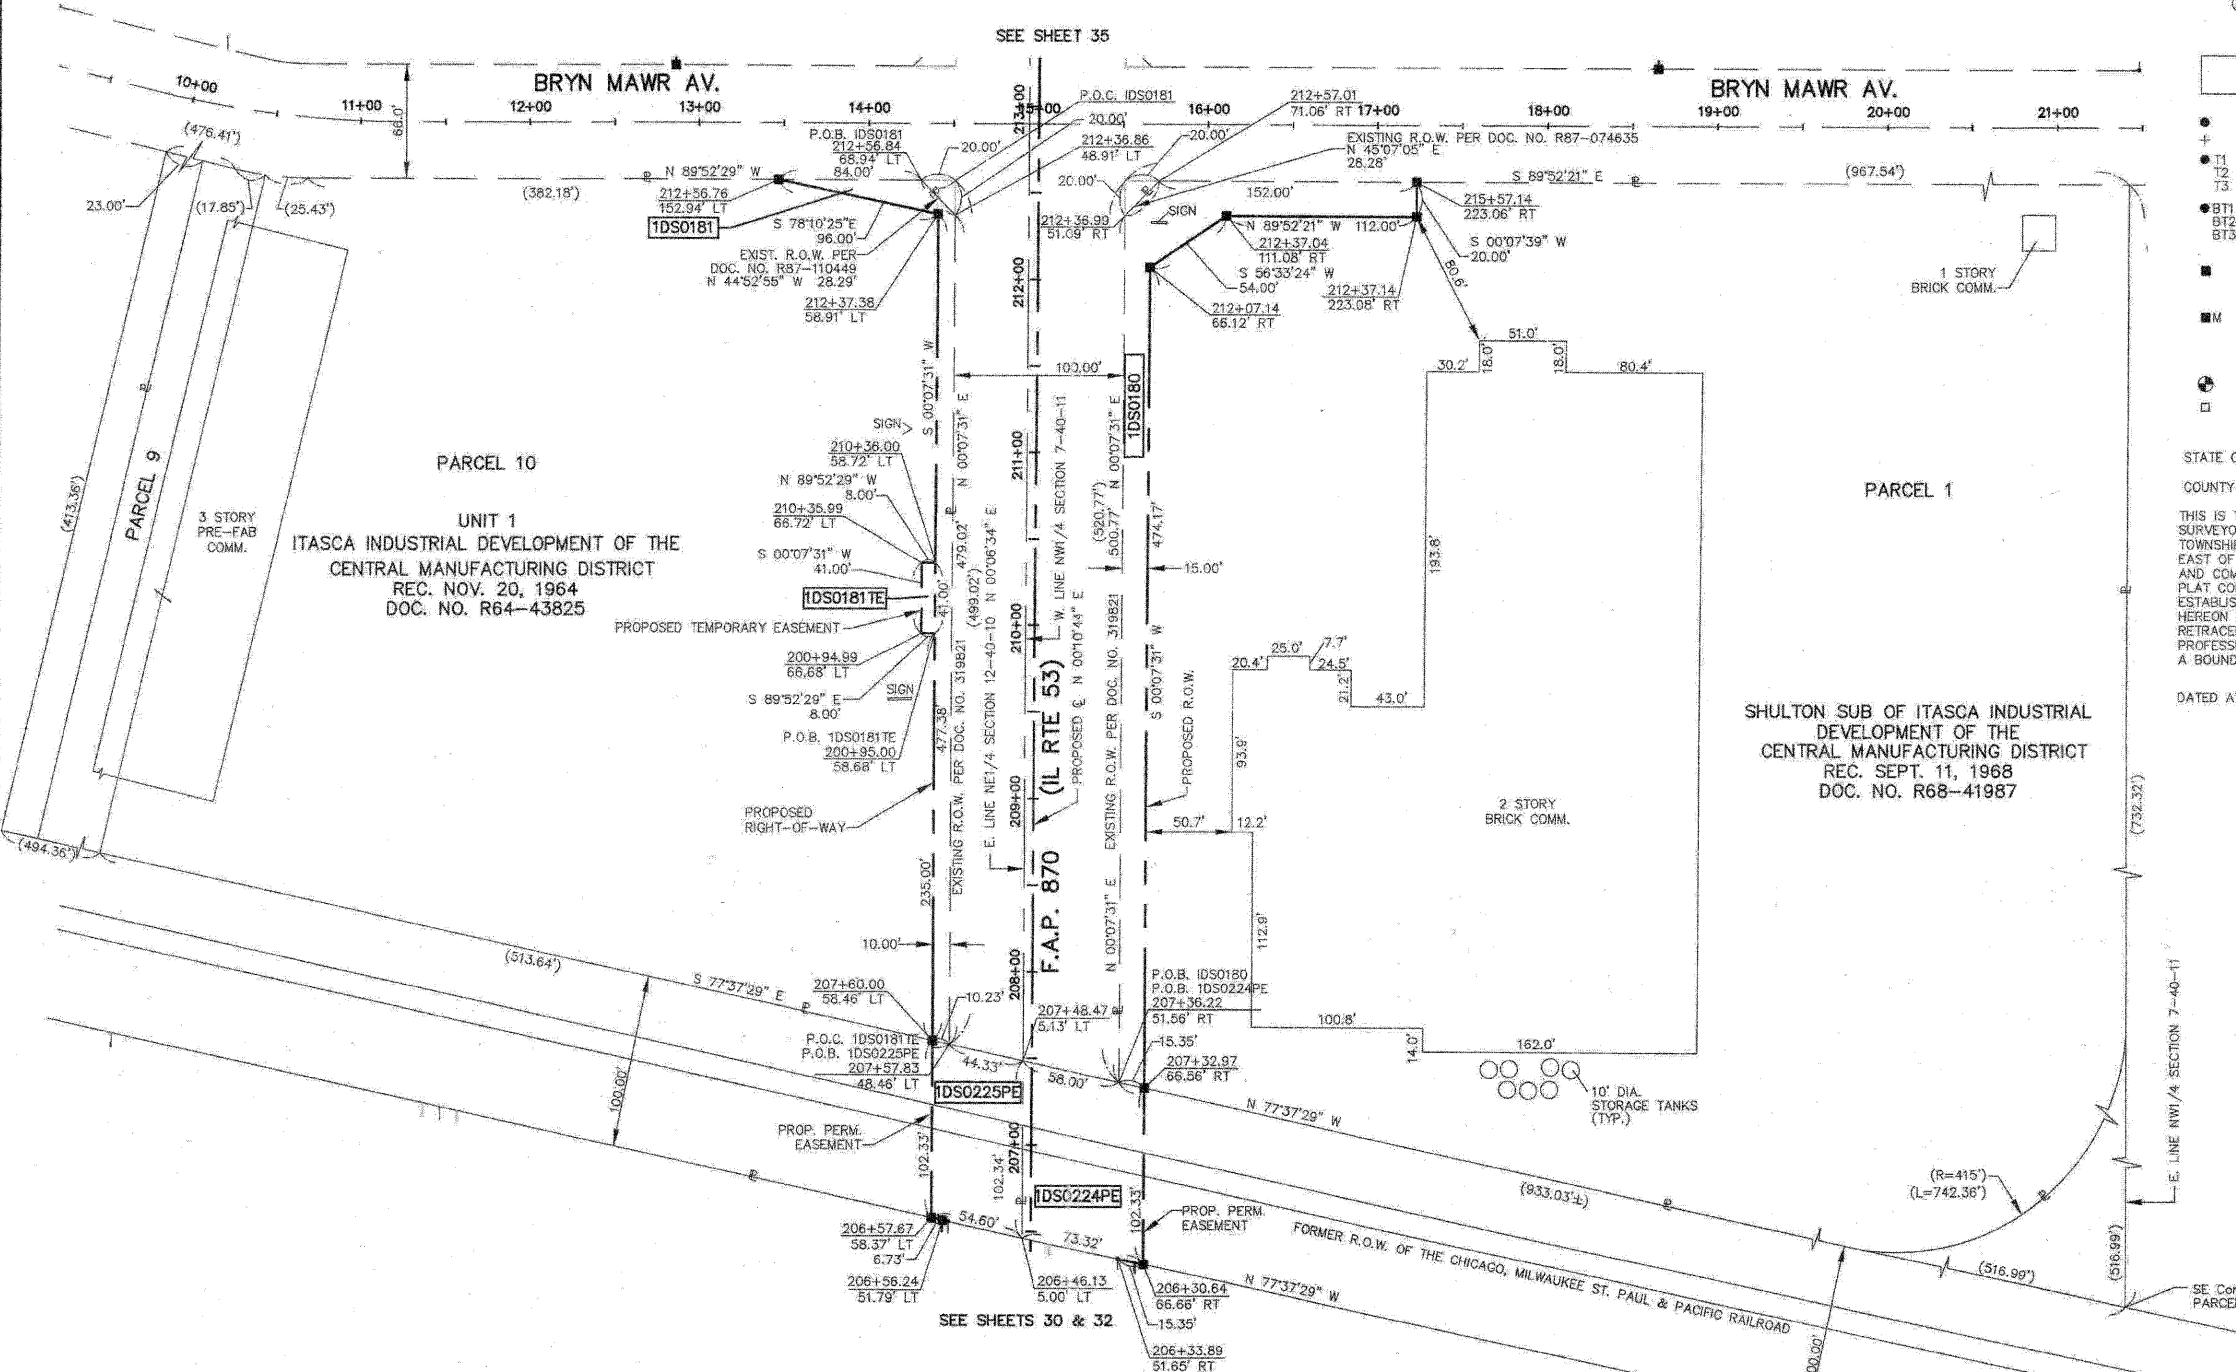

STATE OF ILLINOIS }
COUNTY OF KANE }

THIS IS TO CERTIFY THAT I, REJENA H. LYON, AN ILLINOIS PROFESSIONAL LAND SURVEYOR, HAVE SURVEYED THE PLAT OF HIGHWAYS SHOWN HEREON IN SECTION 24, TOWNSHIP 40 NORTH, RANGE 10 EAST, AND SECTION 19, TOWNSHIP 40 NORTH, RANGE 11 EAST OF THE THIRD PRINCIPAL MERIDIAN, DUPAGE COUNTY; THAT THE SURVEY IS TRUE AND COMPLETE AS SHOWN TO THE BEST OF MY KNOWLEDGE AND BELIEF; THAT THE PLAT CORRECTLY REPRESENTS SAID SURVEY; THAT ALL MONUMENTS FOUND AND ESTABLISHED ARE OF PERMANENT QUALITY AND OCCUPY THE POSITIONS SHOWN HEREON AND THAT THE MONUMENTS ARE SUFFICIENT TO ENABLE THE SURVEY TO BE RETRACED, MADE FOR THE DEPARTMENT OF TRANSPORTATION, STATE OF ILLINOIS. THIS PROFESSIONAL SERVICE CONFORMS TO THE CURRENT ILLINOIS MINIMUM STANDARDS FOR A BOUNDARY SURVEY FOR THAT PORTION SHOWN AS PROPOSED RIGHT-OF-WAY.

DATED AT ELGIN, ILLINOIS, THIS ____ DAY OF _____, 20__ A.D.

ILLINOIS PROFESSIONAL LAND SURVEYOR NO. 3302
ACCOUNT NO. 2-04-0052(a)

RECEIVED
MAR 2 9 2010

PLATS & LEGALS LICENSE EXPIRES 11/30/2010

ALL BEARINGS ARE BASED ON ILLINOIS STATE PLANE COORDINATE SYSTEM NAD 83, EAST ZONE GRID.

HAMPTON, LENZINI AND RENWICK, INC.
CIVIL ENGINEERS - STRUCTURAL ENGINEERS - LAND SURVEYORS

380 SHEPARD DRIVE
ELGIN, ILLINOIS 60123
647.697.5700 www.hlrengineering.com

PLAT OF HIGHWAYS
STATE OF ILLINOIS
DEPARTMENT OF TRANSPORTATION
F.A.P. 870 (IL RTE 53)

DUPAGE COUNTY SECTION
PROJECT JOB NO. R-91-069-00
STATION 206+00 TO STATION 213+00
SCALE: 1"=50' SHEET 34 OF X

BUREAU OF LAND ACQUISITION
201 WEST CENTER COURT
SCHAUMBURG, ILLINOIS 60196

REVISED 3/29/10 PARCELS 1DS0224PE & 1DS0225PE OWNERSHIP CHANGES
REVISED 2/22/10 PARCEL 1DS0181 OWNERSHIP CHANGE
REVISED 12/23/09 ADDED PARCELS 1DS0224PE & 1DS0225PE
REVISED 8/09/09 PARCEL 1DS0181 OWNERSHIP CHANGE

TOPO UPDATED 7/27/09
FIELD WORK COMPLETED 6/27/03

| PARCEL NUMBER | OWNER | TOTAL HOLDINGS | AREA TAKEN | PREVIOUS DEDICATION | REMAINDER | AREA OF EASEMENT | PURPOSE OF EASEMENT | TAX NUMBER | PROPERTY ACQUIRED BY |
|---------------|--|----------------|------------|---------------------|------------|------------------|---------------------|---------------|----------------------|
| 1DS0182 | JP Eat Five, LLC, a Delaware Limited Liability Company | 7.073 AC± | 0.322 AC± | NA | 6.751 AC± | NA | NA | 02-12-214-010 | |
| 1DS0183 | AMB-SGP CIF-Illinois, L.P. | 18.893 AC± | 0.242 AC± | NA | 16.451 AC± | NA | NA | 03-07-100-009 | |
| 1DS0185 | 210 Mittel Drive Partnership | 5.444 AC± | 0.102 AC± | NA | 5.342 AC± | NA | NA | 03-06-303-006 | |

LEGEND

- SECTION LINE
- QUARTER SECTION LINE
- PLATTED LOT LINE
- PROPERTY (DEED) LINE
- APPARENT PROPERTY LINE
- CENTERLINE
- EXISTING RIGHT OF WAY LINE
- EXISTING EASEMENT
- PROPOSED RIGHT OF WAY LINE
- PROPOSED EASEMENT
- MEASURED DIMENSION RECORD DATA
- EXISTING BUILDINGS
- IRON PIPE OR ROD FOUND
- CUT CROSS FOUND OR SET
- THESE STAKES REFERENCE FOUND OR SET MONUMENTATION, SET 5/8" INCH IRON ROD FLUSH WITH THE GROUND TO THE MONUMENTATION, IDENTIFIED BY COLORED PLASTIC CAP BEARING SURVEYORS REGISTRATION NUMBER.
- THESE STAKES, IN CULTIVATED AREAS, REFERENCE FOUND OR SET MONUMENTATION, BURIED 5/8" INCH ROD 20 INCHES BELOW GROUND TO THE MONUMENTATION, IDENTIFIED BY COLORED PLASTIC CAP BEARING SURVEYORS REGISTRATION NUMBER.
- STAKING OF PROPOSED RIGHT OF WAY, SET DIVISION OF HIGHWAYS SURVEY MARKER TO MARK THE POSITION SHOWN, IDENTIFIED BY INSCRIPTION DATA AND SURVEYORS REGISTRATION NUMBER.
- STAKING OF PROPOSED RIGHT OF WAY IN CULTIVATED AREAS, BURIED 5/8" INCH IRON ROD 20 INCHES BELOW GROUND TO MARK FUTURE SURVEY MARKER POSITION, IDENTIFIED BY COLORED PLASTIC CAP BEARING SURVEYORS REGISTRATION NUMBER.
- PERMANENT SURVEY MARKER, IDOT STD. 2135 (TO BE SET BY OTHERS)
- RIGHT OF WAY STAKING PROPOSED TO BE SET



STATE OF ILLINOIS }
 COUNTY OF KANE }SS

THIS IS TO CERTIFY THAT I, REJENA H. LYON, AN ILLINOIS PROFESSIONAL LAND SURVEYOR, HAVE SURVEYED THE PLAT OF HIGHWAYS SHOWN HEREON IN SECTION 24, TOWNSHIP 40 NORTH, RANGE 10 EAST, AND SECTION 19, TOWNSHIP 40 NORTH, RANGE 11 EAST OF THE THIRD PRINCIPAL MERIDIAN, DUPAGE COUNTY; THAT THE SURVEY IS TRUE AND COMPLETE AS SHOWN TO THE BEST OF MY KNOWLEDGE AND BELIEF; THAT THE PLAT CORRECTLY REPRESENTS SAID SURVEY; THAT ALL MONUMENTS FOUND AND ESTABLISHED ARE OF PERMANENT QUALITY AND OCCUPY THE POSITIONS SHOWN HEREON AND THAT THE MONUMENTS ARE SUFFICIENT TO ENABLE THE SURVEY TO BE RETRACED; MADE FOR THE DEPARTMENT OF TRANSPORTATION, STATE OF ILLINOIS; THIS PROFESSIONAL SERVICE CONFORMS TO THE CURRENT ILLINOIS MINIMUM STANDARDS FOR A BOUNDARY SURVEY FOR THAT PORTION SHOWN AS PROPOSED RIGHT-OF-WAY.

DATED AT ELGIN, ILLINOIS, THIS _____ DAY OF _____, 20__ A.D.



ILLINOIS PROFESSIONAL LAND SURVEYOR NO. 3302
 ACCOUNT NO. 2-04-0052(a)
RECEIVED
 AUG 17 2010
 PLATS & LEGALS

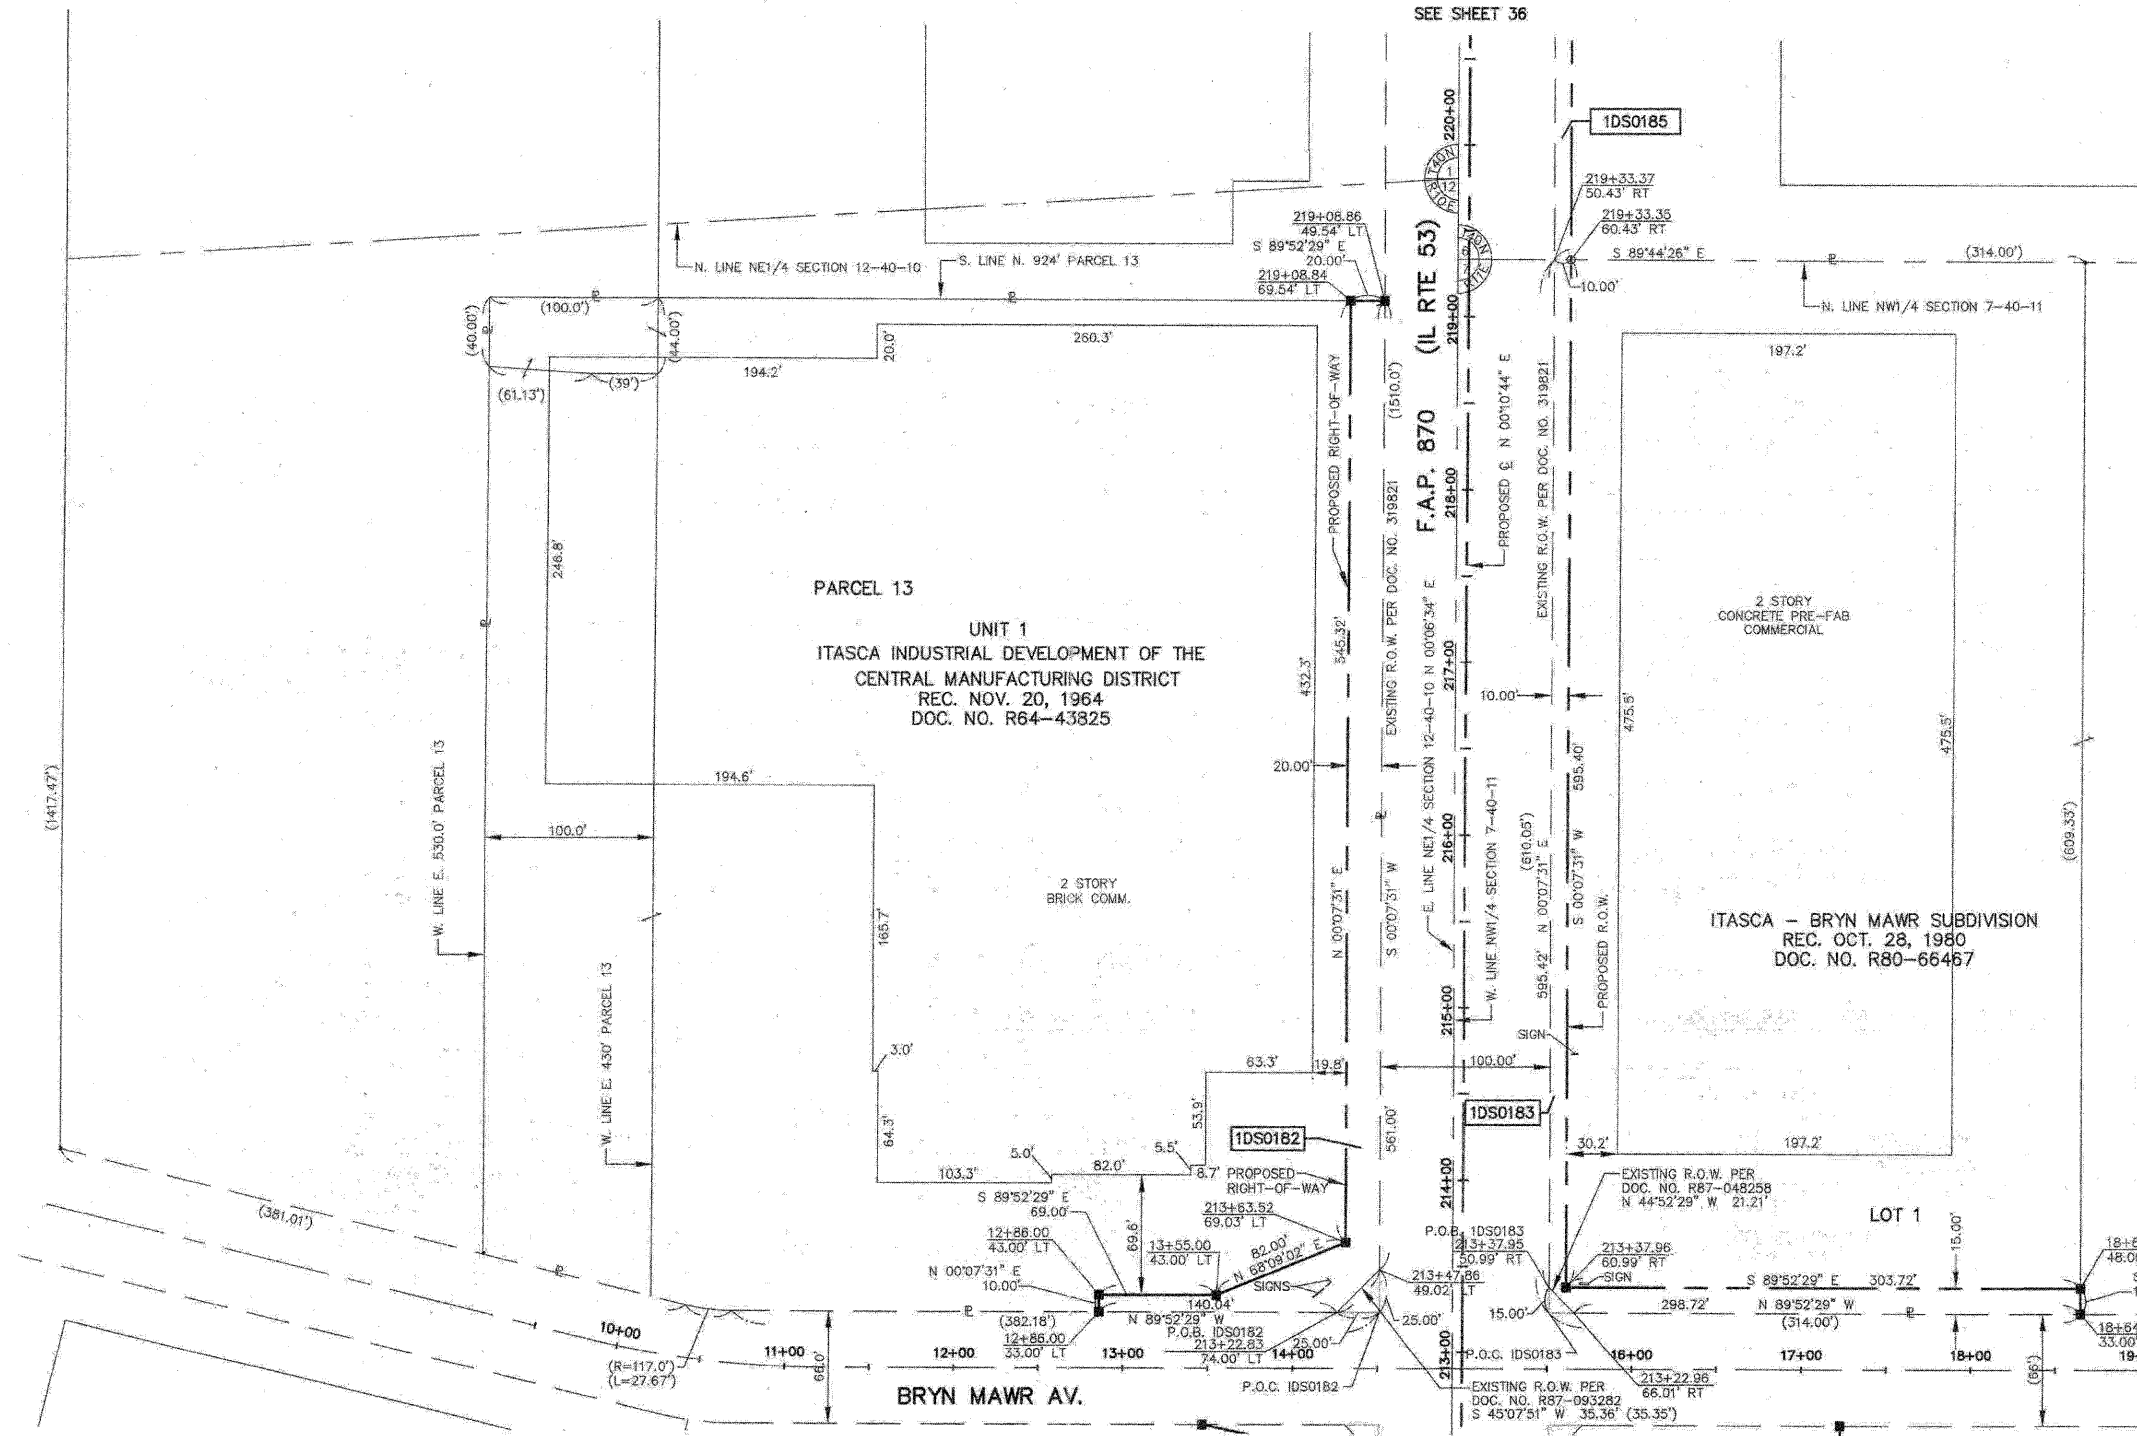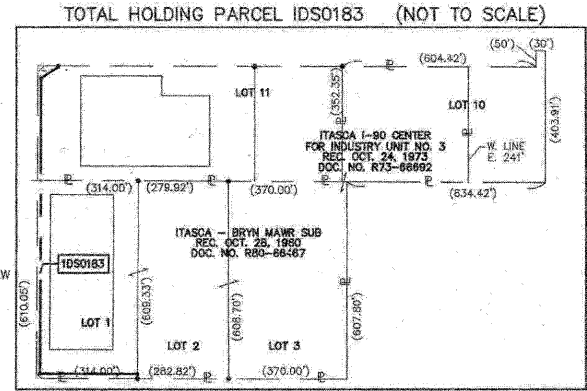

ALL BEARINGS ARE BASED ON ILLINOIS STATE PLANE COORDINATE SYSTEM NAD 83, EAST ZONE GRID.

TOPO UPDATED 7/27/09
 FIELD WORK COMPLETED 6/27/03

HAMPTON, LENZINI AND RENWICK, INC.
 CIVIL ENGINEERS - STRUCTURAL ENGINEERS - LAND SURVEYORS
 380 SHEPARD DRIVE
 ELGIN, ILLINOIS 60123
 847.697.6700 www.hlrengineering.com

PLAT OF HIGHWAYS
 STATE OF ILLINOIS
 DEPARTMENT OF TRANSPORTATION
 F.A.P. 870 (IL RTE 53)

DUPAGE COUNTY SECTION
 PROJECT JOB NO. R-91-069-00
 STATION 213+00 TO STATION 219+50
 SCALE: 1"=50' SHEET 35 OF X

BUREAU OF LAND ACQUISITION
 201 WEST CENTER COURT
 SCHAUMBURG, ILLINOIS 60196

| PARCEL NUMBER | OWNER | TOTAL HOLDINGS | AREA TAKEN | PREVIOUS DEDICATION | REMAINDER | AREA OF EASEMENT | PURPOSE OF EASEMENT | TAX NUMBER | PROPERTY ACQUIRED BY |
|---------------|--|----------------|------------|---------------------|------------|------------------|---------------------|---------------|----------------------|
| 1DS0182 | IP Ent. Fve, LLC, a Delaware Limited Liability Company | 7.073 AC± | 0.322 AC± | NA | 6.751 AC± | NA | NA | 02-12-214-010 | |
| 1DS0183 | AMB-SGP CIF-Illinois, L.P. | 16.693 AC± | 0.242 AC± | NA | 16.451 AC± | NA | NA | 03-07-100-009 | |
| 1DS0185 | 210 Mittel Drive Partnership | 5.444 AC± | 0.102 AC± | NA | 5.342 AC± | NA | NA | 03-06-303-006 | |
| 1DS0187 | ZJB Properties, L.L.C., an Illinois limited liability company | 3.993 AC± | 0.144 AC± | NA | 3.849 AC± | NA | NA | 03-06-302-014 | |
| 1DS0189 | TR Property Management, LLC, an Illinois limited liability company | 1.885 AC± | 0.102 AC± | NA | 1.783 AC± | NA | NA | 03-06-302-012 | |

LEGEND

SECTION CORNER
SECTION LINE
QUARTER SECTION LINE
QUARTER, QUARTER SECTION LINE
PLATTED LOT LINE
PROPERTY (DEED) LINE
APL
APPARENT PROPERTY LINE
CENTERLINE
EXISTING RIGHT OF WAY LINE
EXISTING EASEMENT
PROPOSED RIGHT OF WAY LINE
PROPOSED EASEMENT
MEASURED DIMENSION
RECORD DATA


EXISTING BUILDINGS

- IRON PIPE OR ROD FOUND
- + CUT CROSS FOUND OR SET
- T1 THESE STAKES REFERENCE FOUND OR SET MONUMENTATION, SET 5/8 INCH IRON ROD FLUSH WITH THE GROUND TO THE MONUMENTATION, IDENTIFIED BY COLORED PLASTIC CAP BEARING SURVEYORS REGISTRATION NUMBER.
- T2
- T3
- BT1 THESE STAKES, IN CULTIVATED AREAS, REFERENCE FOUND OR SET MONUMENTATION, BURIED 5/8 INCH ROD 20 INCHES BELOW GROUND TO THE MONUMENTATION, IDENTIFIED BY COLORED PLASTIC CAP BEARING SURVEYORS REGISTRATION NUMBER.
- BT2
- BT3
- STAKING OF PROPOSED RIGHT OF WAY, SET DIVISION OF HIGHWAYS SURVEY MARKER TO MONUMENT THE POSITION SHOWN, IDENTIFIED BY INSCRIPTION DATA AND SURVEYORS REGISTRATION NUMBER.
- M STAKING OF PROPOSED RIGHT OF WAY IN CULTIVATED AREAS, BURIED 5/8 INCH IRON ROD 20 INCHES BELOW GROUND TO MARK FUTURE SURVEY MARKER POSITION, IDENTIFIED BY COLORED PLASTIC CAP BEARING SURVEYORS REGISTRATION NUMBER.
- ⊕ PERMANENT SURVEY MARKER, IDOT STD. 2135 (TO BE SET BY OTHERS)
- RIGHT OF WAY STAKING PROPOSED TO BE SET

STATE OF ILLINOIS }
COUNTY OF KANE }SS

THIS IS TO CERTIFY THAT I, REJENA H. LYON, AN ILLINOIS PROFESSIONAL LAND SURVEYOR, HAVE SURVEYED THE PLAT OF HIGHWAYS SHOWN HEREON IN SECTION 24, TOWNSHIP 40 NORTH, RANGE 10 EAST, AND SECTION 19, TOWNSHIP 40 NORTH, RANGE 11 EAST OF THE THIRD PRINCIPAL MERIDIAN, DUPAGE COUNTY; THAT THE SURVEY IS TRUE AND COMPLETE AS SHOWN TO THE BEST OF MY KNOWLEDGE AND BELIEF; THAT THE PLAT CORRECTLY REPRESENTS SAID SURVEY; THAT ALL MONUMENTS FOUND AND ESTABLISHED ARE OF PERMANENT QUALITY AND OCCUPY THE POSITIONS SHOWN HEREON AND THAT THE MONUMENTS ARE SUFFICIENT TO ENABLE THE SURVEY TO BE RETRACED; MADE FOR THE DEPARTMENT OF TRANSPORTATION, STATE OF ILLINOIS. THIS PROFESSIONAL SERVICE CONFORMS TO THE CURRENT ILLINOIS MINIMUM STANDARDS FOR A BOUNDARY SURVEY FOR THAT PORTION SHOWN AS PROPOSED RIGHT-OF-WAY.

DATED AT ELGIN, ILLINOIS, THIS _____ DAY OF _____, 20____ A.D.

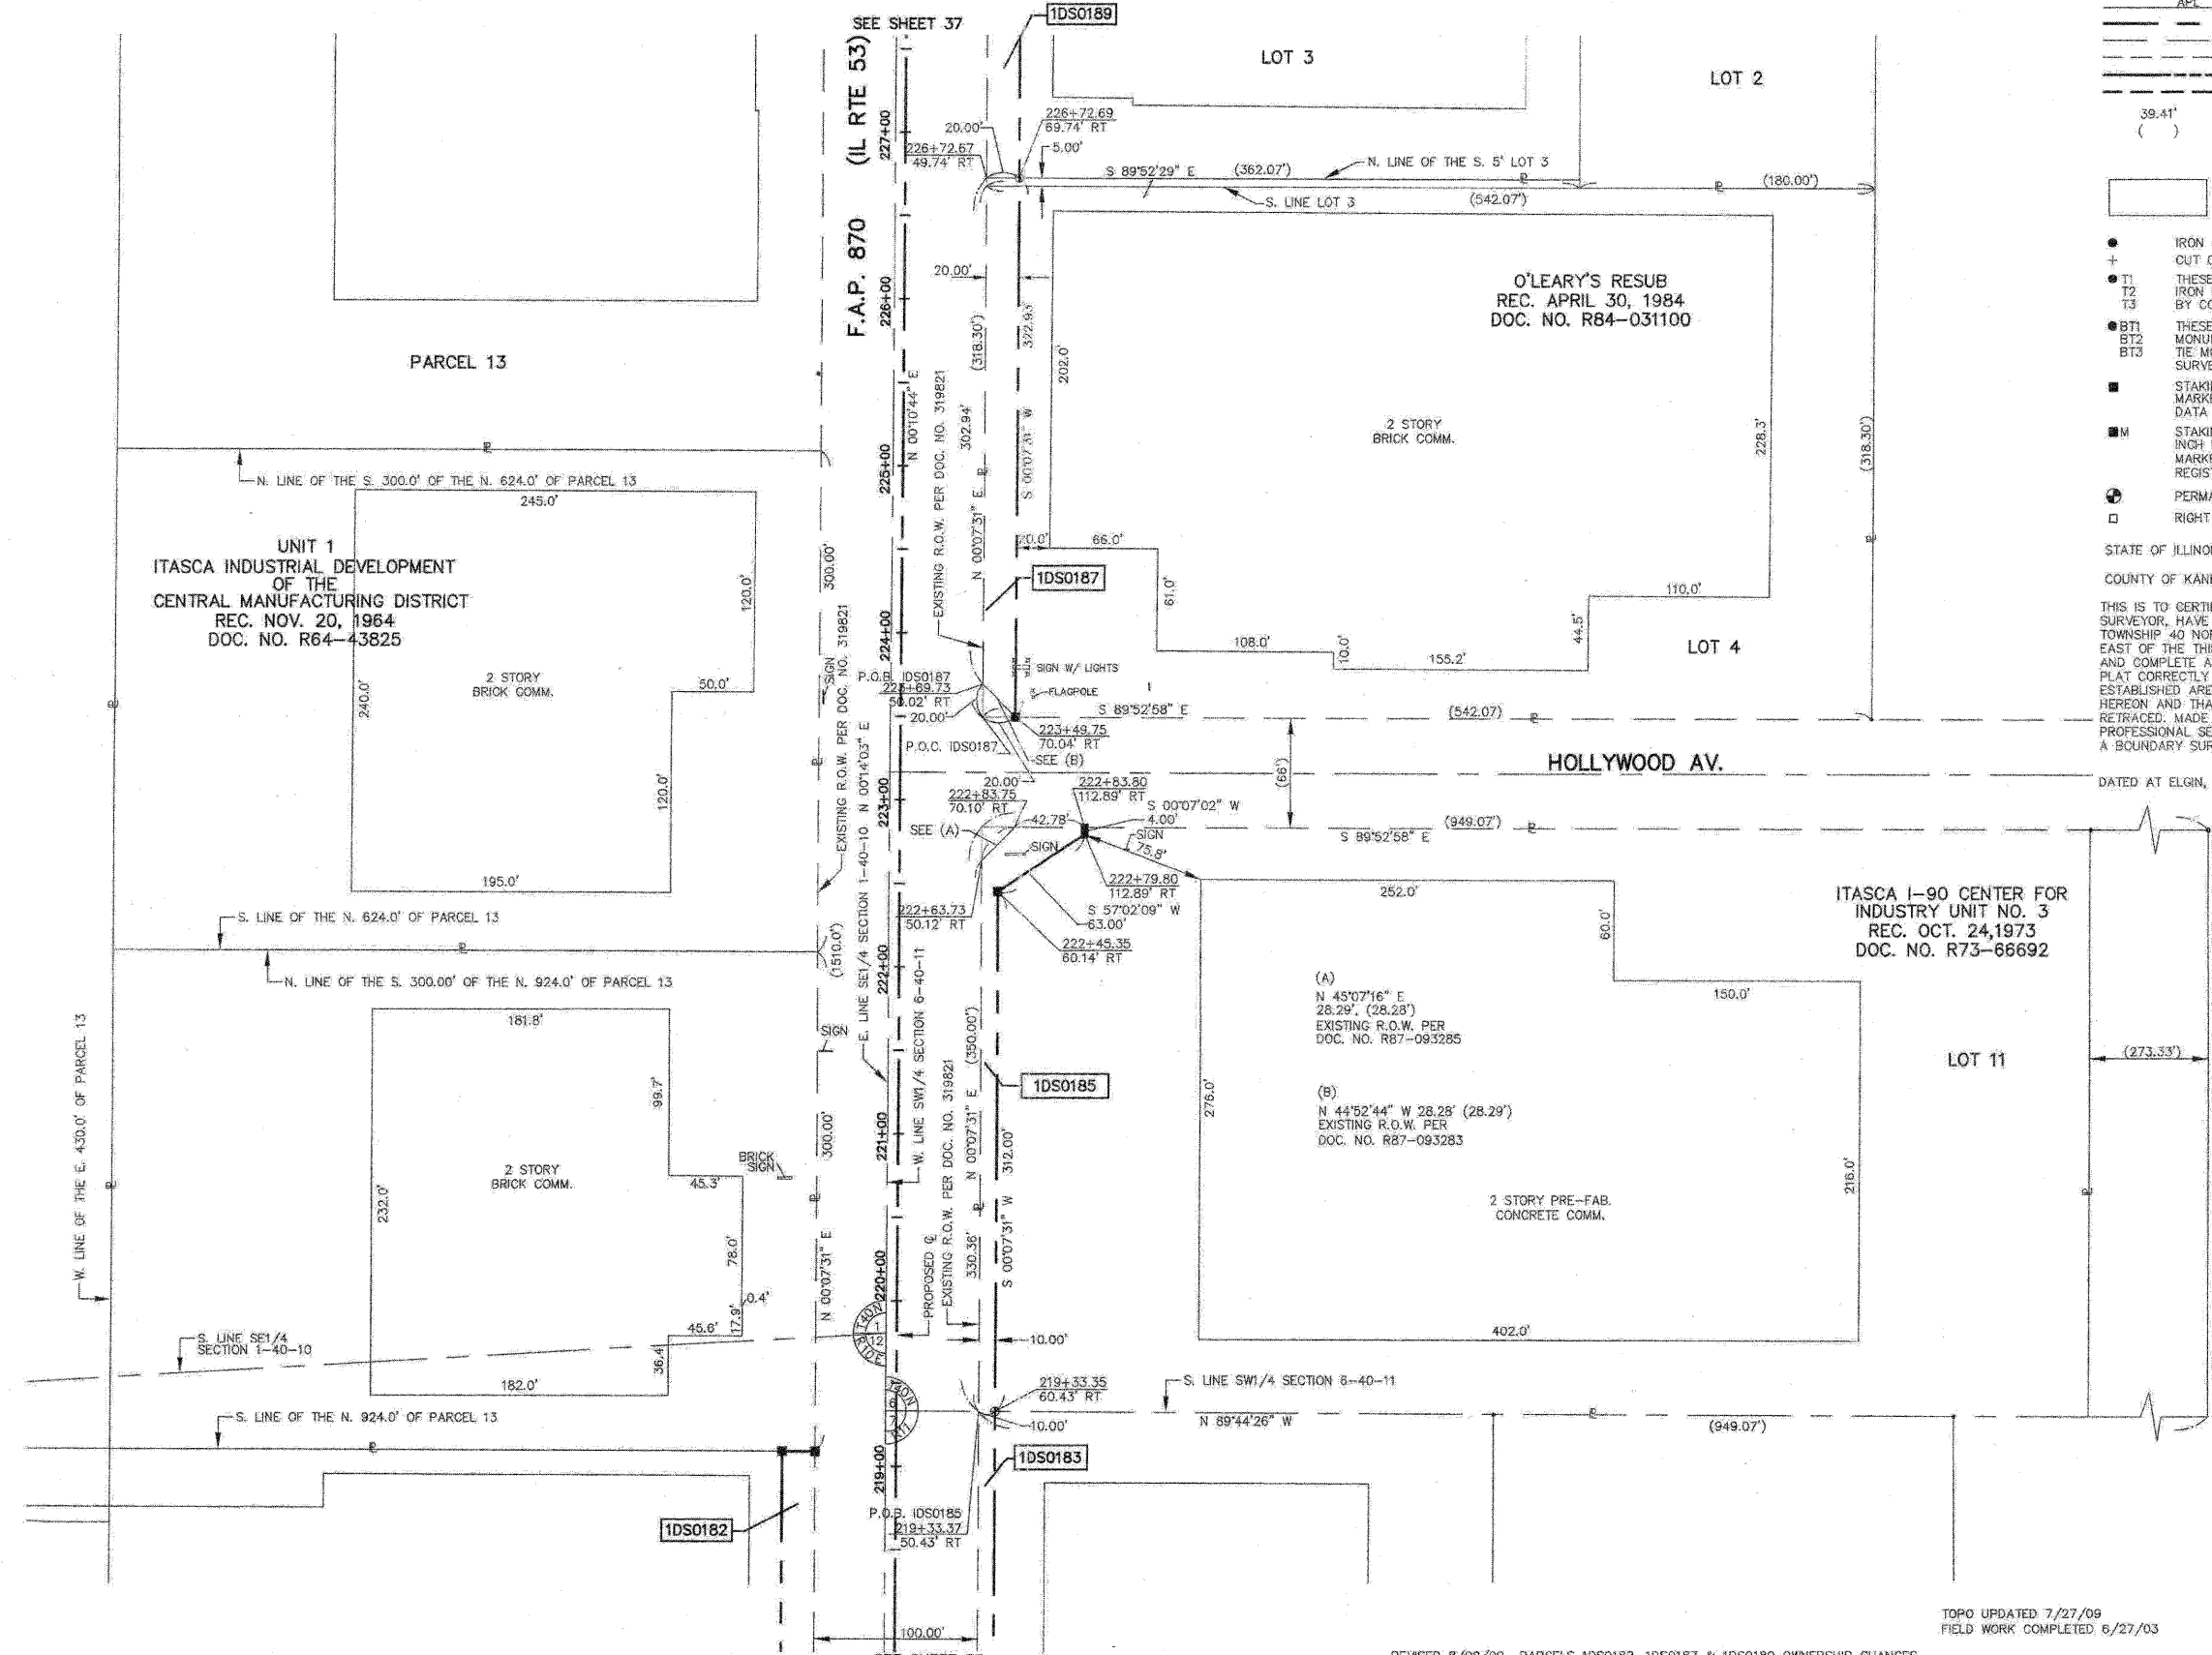

ILLINOIS PROFESSIONAL LAND SURVEYOR NO. 3302
ACCOUNT NO. 2-04-0052(c)

RECEIVED
AUG 11 2009

PLATS & LEGALS

LICENSE EXPIRES 11/30/2010

ALL BEARINGS ARE BASED ON ILLINOIS STATE PLANE COORDINATE SYSTEM NAD 83, EAST ZONE GRID.

HAMPTON, LENZINI AND RENWICK, INC.
CIVIL ENGINEERS • STRUCTURAL ENGINEERS • LAND SURVEYORS
380 SHEPARD DRIVE
ELGIN, ILLINOIS 60123
847.697.6700 www.hirengineering.com

PLAT OF HIGHWAYS
STATE OF ILLINOIS
DEPARTMENT OF TRANSPORTATION
F.A.P. 870 (IL RTE 53)

DUPAGE COUNTY SECTION
PROJECT JOB NO. R-91-069-00
STATION 219+00 TO STATION 227+00
SCALE: 1"=50' SHEET 36 OF X

BUREAU OF LAND ACQUISITION
201 WEST CENTER COURT
SCHAUMBURG, ILLINOIS 60196

| PARCEL NUMBER | OWNER | TOTAL HOLDINGS | AREA TAKEN | PREVIOUS DEDICATION | REMAINDER | AREA OF EASEMENT | PURPOSE OF EASEMENT | TAX NUMBER | PROPERTY ACQUIRED BY |
|---------------|--|----------------|------------|---------------------|-----------|------------------|---------------------|---------------|----------------------|
| 1DS0187 | ZJB Properties, L.L.C., an Illinois limited liability company | 3.993 AC± | 0.144 AC± | NA | 3.849 AC± | NA | NA | 03-06-302-014 | |
| 1DS0189 | TR Property Management, LLC, an Illinois limited liability company | 1.885 AC± | 0.102 AC± | NA | 1.783 AC± | NA | NA | 03-06-302-012 | |
| 1DS0190 | Alan W. Jardis | 2.717 AC± | 0.205 AC± | NA | 2.512 AC± | NA | NA | 02-01-402-028 | |
| 1DS0191 | Zeke Partners, LLC, an Illinois limited liability company | 3.040 AC± | 0.143 AC± | NA | 2.897 AC± | NA | NA | 03-06-301-016 | |
| 1DS0192 | The Manufacturers Life Insurance Company | 6.350 AC± | 0.085 AC± | NA | 6.265 AC± | NA | NA | 02-01-402-032 | |

LEGEND

- SECTION LINE
- QUARTER SECTION LINE
- QUARTER, QUARTER SECTION LINE
- FLATTED LOT LINE
- PROPERTY (DEED) LINE
- APL APPARENT PROPERTY LINE
- CENTERLINE
- EXISTING RIGHT OF WAY LINE
- EXISTING EASEMENT
- PROPOSED RIGHT OF WAY LINE
- PROPOSED EASEMENT
- MEASURED DIMENSION
- RECORD DATA

SECTION CORNER
QUARTER CORNER

39.41'
()

EXISTING BUILDINGS

- IRON PIPE OR ROD FOUND
- CUT CROSS FOUND OR SET
- PK NAIL FOUND OR SET
- 5/8" REBAR SET
- TI THESE STAKES REFERENCE FOUND OR SET MONUMENTATION, SET 5/8 INCH IRON ROD FLUSH WITH THE GROUND TO THE MONUMENTATION, IDENTIFIED BY COLORED PLASTIC CAP BEARING SURVEYORS REGISTRATION NUMBER.
- T2
- T3
- BT1 THESE STAKES, IN CULTIVATED AREAS, REFERENCE FOUND OR SET MONUMENTATION, BURIED 5/8 INCH ROD 20 INCHES BELOW GROUND TO THE MONUMENTATION, IDENTIFIED BY COLORED PLASTIC CAP BEARING SURVEYORS REGISTRATION NUMBER.
- BT2
- BT3
- STAKING OF PROPOSED RIGHT OF WAY, SET DIVISION OF HIGHWAYS SURVEY MARKER TO MONUMENT THE POSITION SHOWN, IDENTIFIED BY INSCRIPTION DATA AND SURVEYORS REGISTRATION NUMBER.
- M STAKING OF PROPOSED RIGHT OF WAY IN CULTIVATED AREAS, BURIED 5/8 INCH IRON ROD 20 INCHES BELOW GROUND TO MARK FUTURE SURVEY MARKER POSITION, IDENTIFIED BY COLORED PLASTIC CAP BEARING SURVEYORS REGISTRATION NUMBER.
- PERMANENT SURVEY MARKER, IDOT STD. 2135 (TO BE SET BY OTHERS)
- RIGHT OF WAY STAKING PROPOSED TO BE SET

STATE OF ILLINOIS }
COUNTY OF KANE }

THIS IS TO CERTIFY THAT I, REJENA H. LYON, AN ILLINOIS PROFESSIONAL LAND SURVEYOR, HAVE SURVEYED THE PLAT OF HIGHWAYS SHOWN HEREON IN SECTION 24, TOWNSHIP 40 NORTH, RANGE 10 EAST, AND SECTION 19, TOWNSHIP 40 NORTH, RANGE 11 EAST OF THE THIRD PRINCIPAL MERIDIAN, DUPAGE COUNTY, THAT THE SURVEY IS TRUE AND COMPLETE AS SHOWN TO THE BEST OF MY KNOWLEDGE AND BELIEF, THAT THE PLAT CORRECTLY REPRESENTS SAID SURVEY, THAT ALL MONUMENTS FOUND AND ESTABLISHED ARE OF PERMANENT QUALITY AND OCCUPY THE POSITIONS SHOWN HEREON AND THAT THE MONUMENTS ARE SUFFICIENT TO ENABLE THE SURVEY TO BE RETRACED. MADE FOR THE DEPARTMENT OF TRANSPORTATION, STATE OF ILLINOIS. THIS PROFESSIONAL SERVICE CONFORMS TO THE CURRENT ILLINOIS MINIMUM STANDARDS FOR A BOUNDARY SURVEY FOR THAT PORTION SHOWN AS PROPOSED RIGHT-OF-WAY.

DATED AT ELGIN, ILLINOIS, THIS _____ DAY OF _____, 20____ A.D.

ILLINOIS PROFESSIONAL LAND SURVEYOR NO. 3302
ACCOUNT NO. 2-04-0052(e)

RECEIVED
AUG 13 2010
PLATS & LEGALS


REJENA H. LYON
3302 PROFESSIONAL LAND SURVEYOR STATE OF ILLINOIS
ELGIN, ILLINOIS
LICENSE EXPIRES 11/30/2010

ALL BEARINGS ARE BASED ON ILLINOIS STATE PLANE COORDINATE SYSTEM NAD 83, EAST ZONE GRID.

HAMPTON, LENZINI AND RENWICK, INC.
CIVIL ENGINEERS - STRUCTURAL ENGINEERS - LAND SURVEYORS
380 SHEPARD DRIVE
ELGIN, ILLINOIS 60123
847.697.6700 www.hlrengineering.com
194.00899 ILLINOIS PROFESSIONAL DESIGN FIRM & STRUCTURAL ENGINEERING CORP.


PLAT OF HIGHWAYS
STATE OF ILLINOIS
DEPARTMENT OF TRANSPORTATION
F.A.P. 870 (IL RTE 53)
DuPAGE COUNTY SECTION
PROJECT JOB NO. R-91-069-00
STATION 225+00 TO STATION 234+00
SCALE: 1"=50' SHEET 37 OF X

BUREAU OF LAND ACQUISITION
201 WEST CENTER COURT
SCHAUMBURG, ILLINOIS 60196

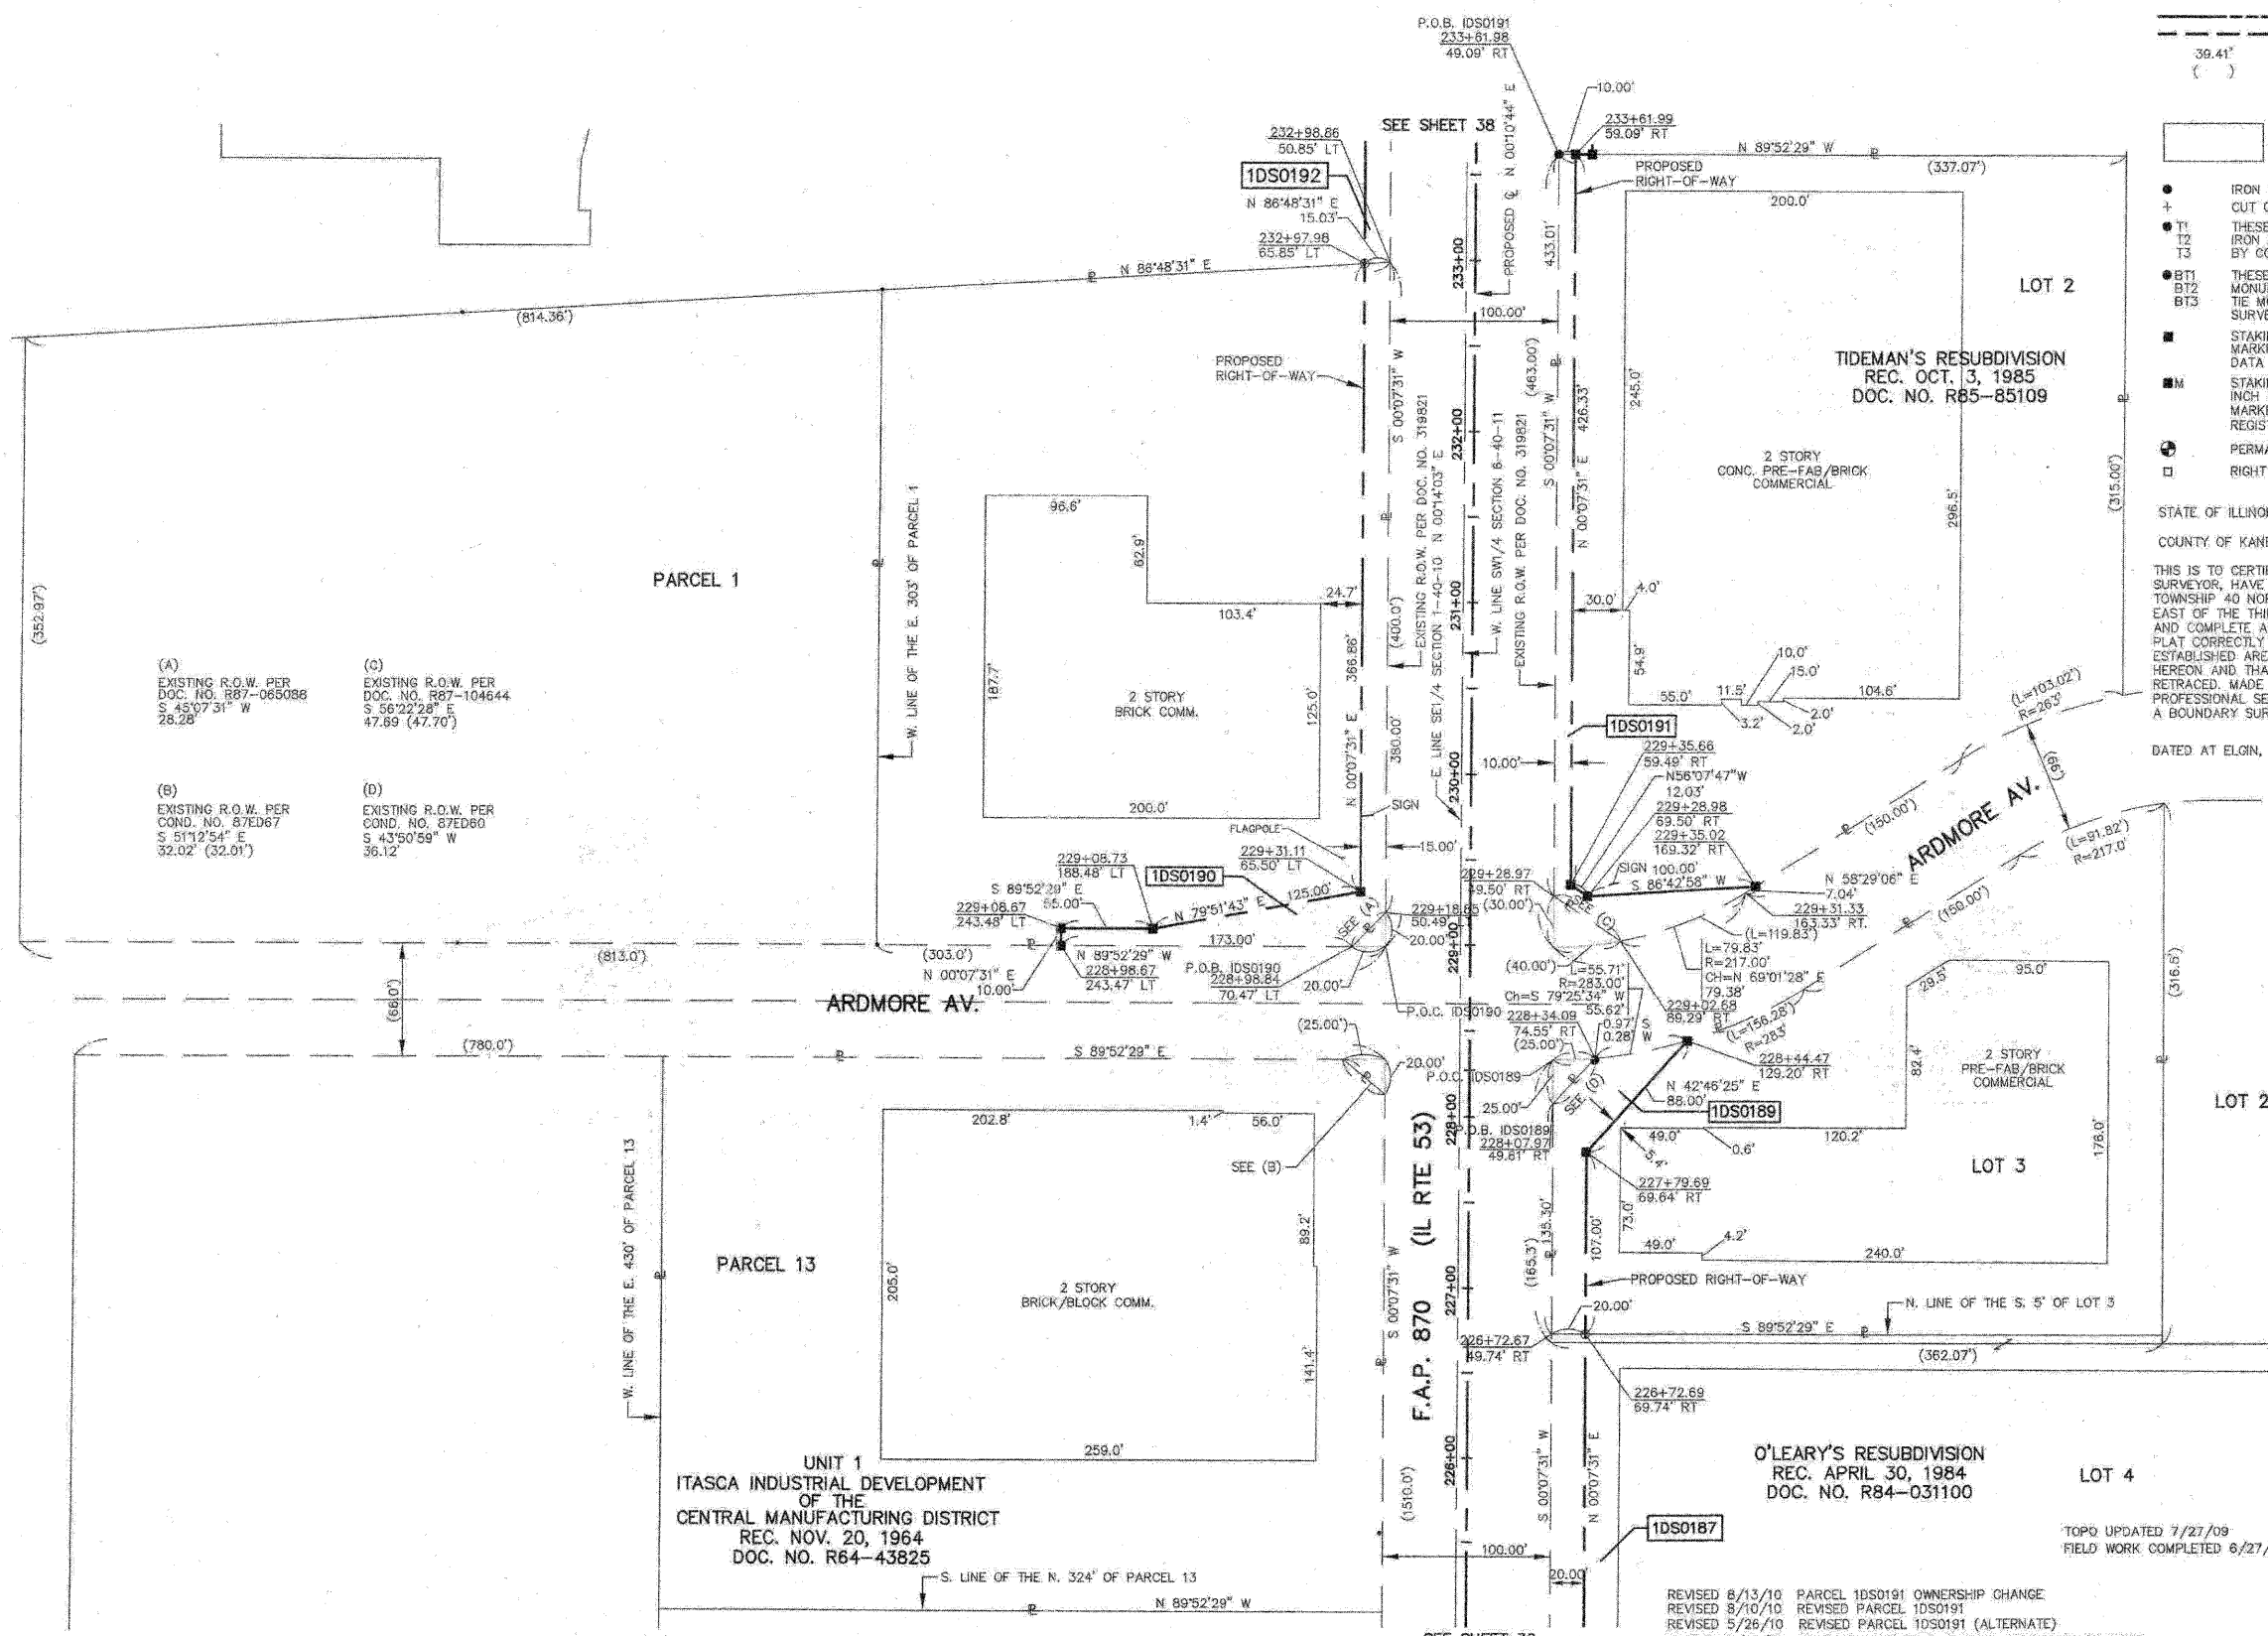

| PARCEL NUMBER | OWNER | TOTAL HOLDINGS | AREA TAKEN | PREVIOUS DEDICATION | REMAINDER | AREA OF EASEMENT | PURPOSE OF EASEMENT | TAX NUMBER | PROPERTY ACQUIRED BY |
|---------------|---|----------------|------------|---------------------|------------|------------------|---------------------|---------------|----------------------|
| 1DS0190 | Alan W. Jorda | 2.717 AC± | 0.205 AC± | NA | 2.512 AC± | NA | NA | 02-01-402-025 | |
| 1DS0191 | Zeke Partners, LLC, an Illinois limited liability company | 3.040 AC± | 0.242 AC± | NA | 2.798 AC± | NA | NA | 03-06-301-016 | |
| 1DS0192 | The Manufacturers Life Insurance Company | 8.350 AC± | 0.085 AC± | NA | 8.265 AC± | NA | NA | 02-01-402-032 | |
| 1DS0193 | 1140 West Thorndale Avenue Investors, LLC, a Delaware limited liability company | 3.112 AC± | 0.190 AC± | NA | 2.922 AC± | NA | NA | 03-06-301-012 | |
| 1DS0194DED | Gullo Property, LLC | 1.401 AC± | 0.079 AC±* | NA | 1.401 AC± | NA | NA | 02-01-402-030 | |
| 1DS0195DED | HP/Old Thorndale #2 Limited Partnership | 10.404 AC± | 0.407 AC±* | NA | 10.404 AC± | NA | NA | 02-01-400-018 | |
| 1DS0196 | Tortorello Family Limited Partnership by Lynn L. Tortorello and Anthony W. Tortorello, Trustees of the Lynn L. Tortorello Living Trust, dated May 22, 2009, General Partnership | 2.741 AC± | 0.128 AC± | NA | 2.613 AC± | NA | NA | 03-06-300-009 | |

*AREA TO BE ACQUIRED BY DEDICATION ONLY

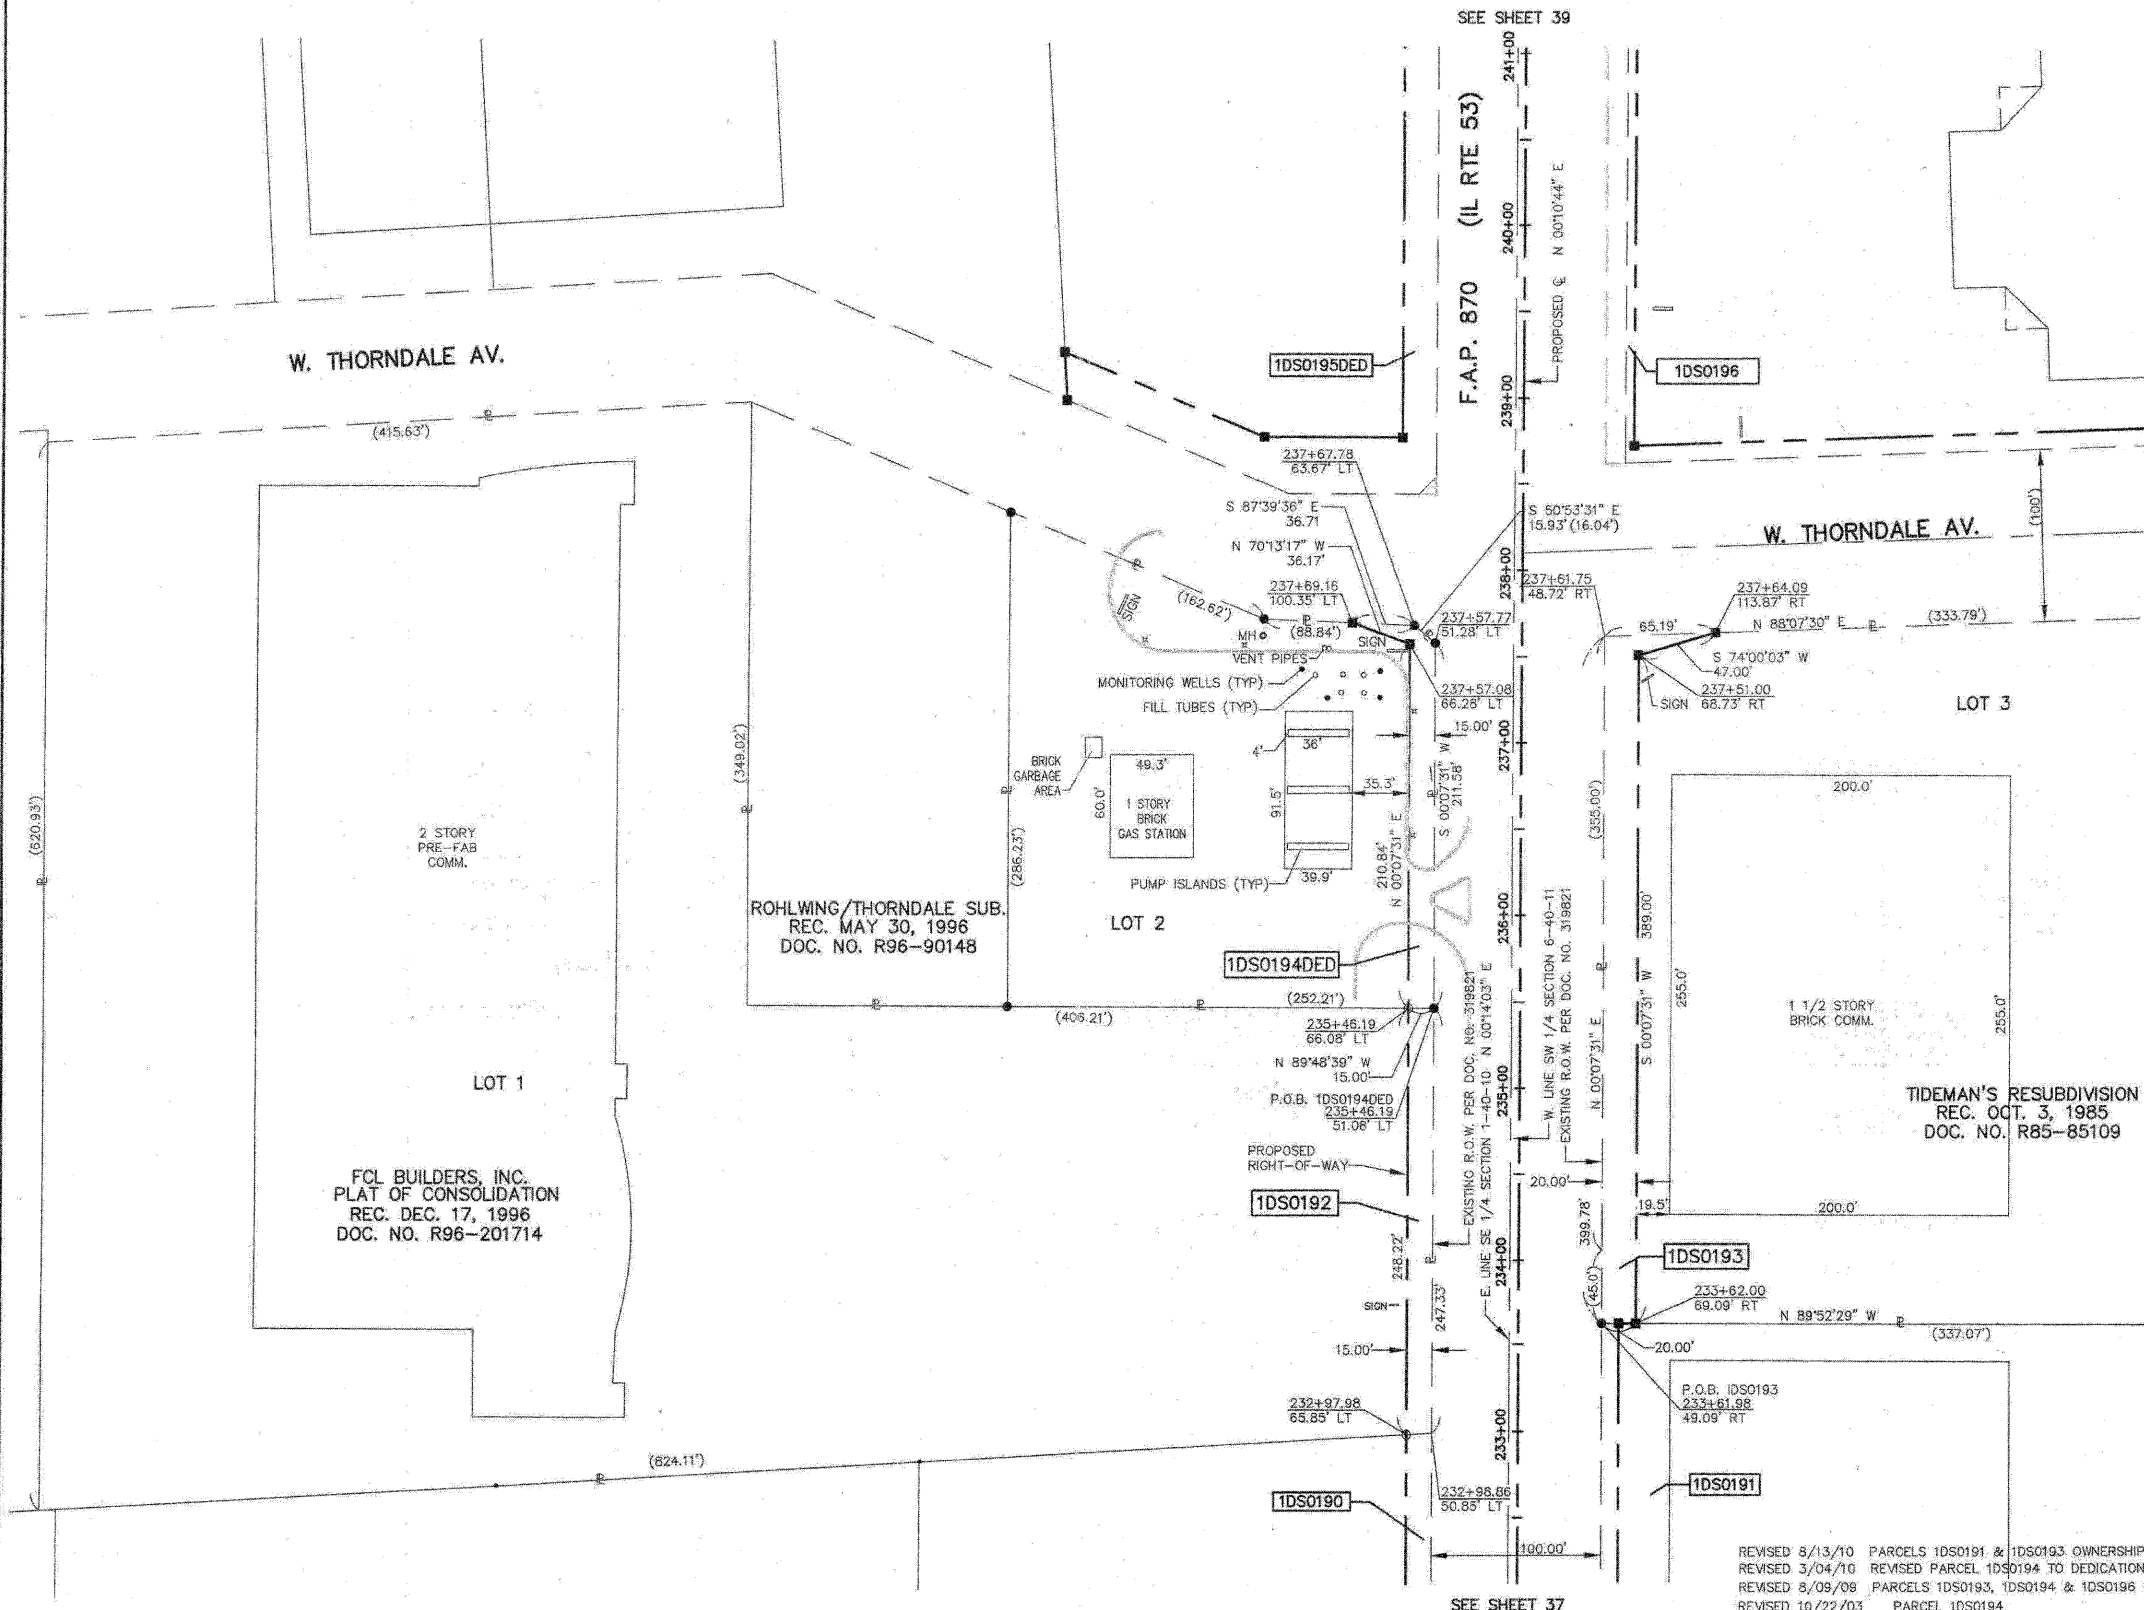

LEGEND

SECTION CORNER
 QUARTER SECTION CORNER

SECTION LINE
 QUARTER SECTION LINE
 QUARTER, QUARTER SECTION LINE
 PLATTED LOT LINE
 PROPERTY (DEED) LINE

APL
 APPARENT PROPERTY LINE
 CENTERLINE
 EXISTING RIGHT OF WAY LINE
 EXISTING EASEMENT
 PROPOSED RIGHT OF WAY LINE
 PROPOSED EASEMENT
 MEASURED DIMENSION
 RECORD DATA

EXISTING BUILDINGS

IRON PIPE OR ROD FOUND
 CUT CROSS FOUND OR SET
 T1
 T2
 T3
 BT1
 BT2
 BT3
 STAKING OF PROPOSED RIGHT OF WAY, SET DIVISION OF HIGHWAYS SURVEY MARKER TO MONUMENT THE POSITION SHOWN, IDENTIFIED BY INSCRIPTION DATA AND SURVEYORS REGISTRATION NUMBER.
 STAKING OF PROPOSED RIGHT OF WAY IN CULTIVATED AREAS, BURIED 5/8 INCH IRON ROD 20 INCHES BELOW GROUND TO MARK FUTURE SURVEY MARKER POSITION, IDENTIFIED BY COLORED PLASTIC CAP BEARING SURVEYORS REGISTRATION NUMBER.
 PERMANENT SURVEY MARKER, (DOT STD.) 2135 (TO BE SET BY OTHERS)
 RIGHT OF WAY STAKING PROPOSED TO BE SET

PK NAIL FOUND OR SET
 5/8" REBAR SET

THESE STAKES REFERENCE FOUND OR SET MONUMENTATION, SET 5/8 INCH IRON ROD FLUSH WITH THE GROUND TO THE MONUMENTATION, IDENTIFIED BY COLORED PLASTIC CAP BEARING SURVEYORS REGISTRATION NUMBER.
 THESE STAKES, IN CULTIVATED AREAS, REFERENCE FOUND OR SET MONUMENTATION, BURIED 5/8 INCH ROD 20 INCHES BELOW GROUND TO THE MONUMENTATION, IDENTIFIED BY COLORED PLASTIC CAP BEARING SURVEYORS REGISTRATION NUMBER.

STATE OF ILLINOIS }
 COUNTY OF KANE }

THIS IS TO CERTIFY THAT I, REJENA H. LYON, AN ILLINOIS PROFESSIONAL LAND SURVEYOR, HAVE SURVEYED THE PLAT OF HIGHWAYS SHOWN HEREON IN SECTION 24, TOWNSHIP 40 NORTH, RANGE 10 EAST, AND SECTION 19, TOWNSHIP 40 NORTH, RANGE 11 EAST OF THE THIRD PRINCIPAL MERIDIAN, DUPAGE COUNTY, THAT THE SURVEY IS TRUE AND COMPLETE AS SHOWN TO THE BEST OF MY KNOWLEDGE AND BELIEF, THAT THE PLAT CORRECTLY REPRESENTS SAID SURVEY, THAT ALL MONUMENTS FOUND AND ESTABLISHED ARE OF PERMANENT QUALITY AND OCCUPY THE POSITIONS SHOWN HEREON AND THAT THE MONUMENTS ARE SUFFICIENT TO ENABLE THE SURVEY TO BE RETRACED, MADE FOR THE DEPARTMENT OF TRANSPORTATION, STATE OF ILLINOIS. THIS PROFESSIONAL SERVICE CONFORMS TO THE CURRENT ILLINOIS MINIMUM STANDARDS FOR A BOUNDARY SURVEY FOR THAT PORTION SHOWN AS PROPOSED RIGHT-OF-WAY.

DATED AT ELGIN, ILLINOIS, THIS _____ DAY OF _____, 20____ A.D.

ILLINOIS PROFESSIONAL LAND SURVEYOR NO. 3302
 ACCOUNT NO. 2-04-0052(c)

RECEIVED
 AUG 13 2010
 PLATS & LEGALS
 LICENSE EXPIRES 11/30/2010

ALL BEARINGS ARE BASED ON ILLINOIS STATE PLANE COORDINATE SYSTEM NAD 83, EAST ZONE GRID.

TOPO UPDATED 7/27/09
 FIELD WORK COMPLETED 6/27/03

HAMPTON, LENZINI AND RENWICK, INC.
 CIVIL ENGINEERS • STRUCTURAL ENGINEERS • LAND SURVEYORS
 ILLR 380 SHEPARD DRIVE
 ELGIN, ILLINOIS 60123
 847.697.6700 www.hirengineering.com
 194.000899 ILLINOIS PROFESSIONAL DESIGN FIRM & STRUCTURAL ENGINEERING CORP.

PLAT OF HIGHWAYS
 STATE OF ILLINOIS
 DEPARTMENT OF TRANSPORTATION
 F.A.P. 870 (IL RTE 53)



DuPAGE COUNTY SECTION
 PROJECT JOB NO. R-91-069-00
 STATION 233+00 TO STATION 238+00
 SCALE: 1"=50' SHEET 38 OF X

BUREAU OF LAND ACQUISITION
 201 WEST CENTER COURT
 SCHAMBERG, ILLINOIS 60196

| PARCEL NUMBER | OWNER | TOTAL HOLDINGS | AREA TAKEN | PREVIOUS DEDICATION | REMAINDER | AREA OF EASEMENT | PURPOSE OF EASEMENT | TAX NUMBER | PROPERTY ACQUIRED BY |
|---------------|---|----------------|------------|---------------------|------------|------------------|---------------------|---------------|----------------------|
| 1DS01950ED | HP/Old Thorndale #2 Limited Partnership | 10.404 AC± | 0.407 AC±* | NA | 10.404 AC± | NA | NA | 02-01-400-018 | |
| 1DS0196 | Tortorello Family Limited Partnership by Lynn L. Tortorello and Anthony W. Tortorello, Trustees of the Lynn L. Tortorello Living Trust, dated May 22, 2009, General Partnership | 2.741 AC± | 0.128 AC± | NA | 2.813 AC± | NA | NA | 03-06-300-009 | |
| 1DS0197 | Village of Itasca | 3.442 AC± | 0.031 AC± | NA | 3.411 AC± | NA | NA | 03-06-300-008 | |

*AREA TO BE ACQUIRED BY DEDICATION ONLY

LEGEND

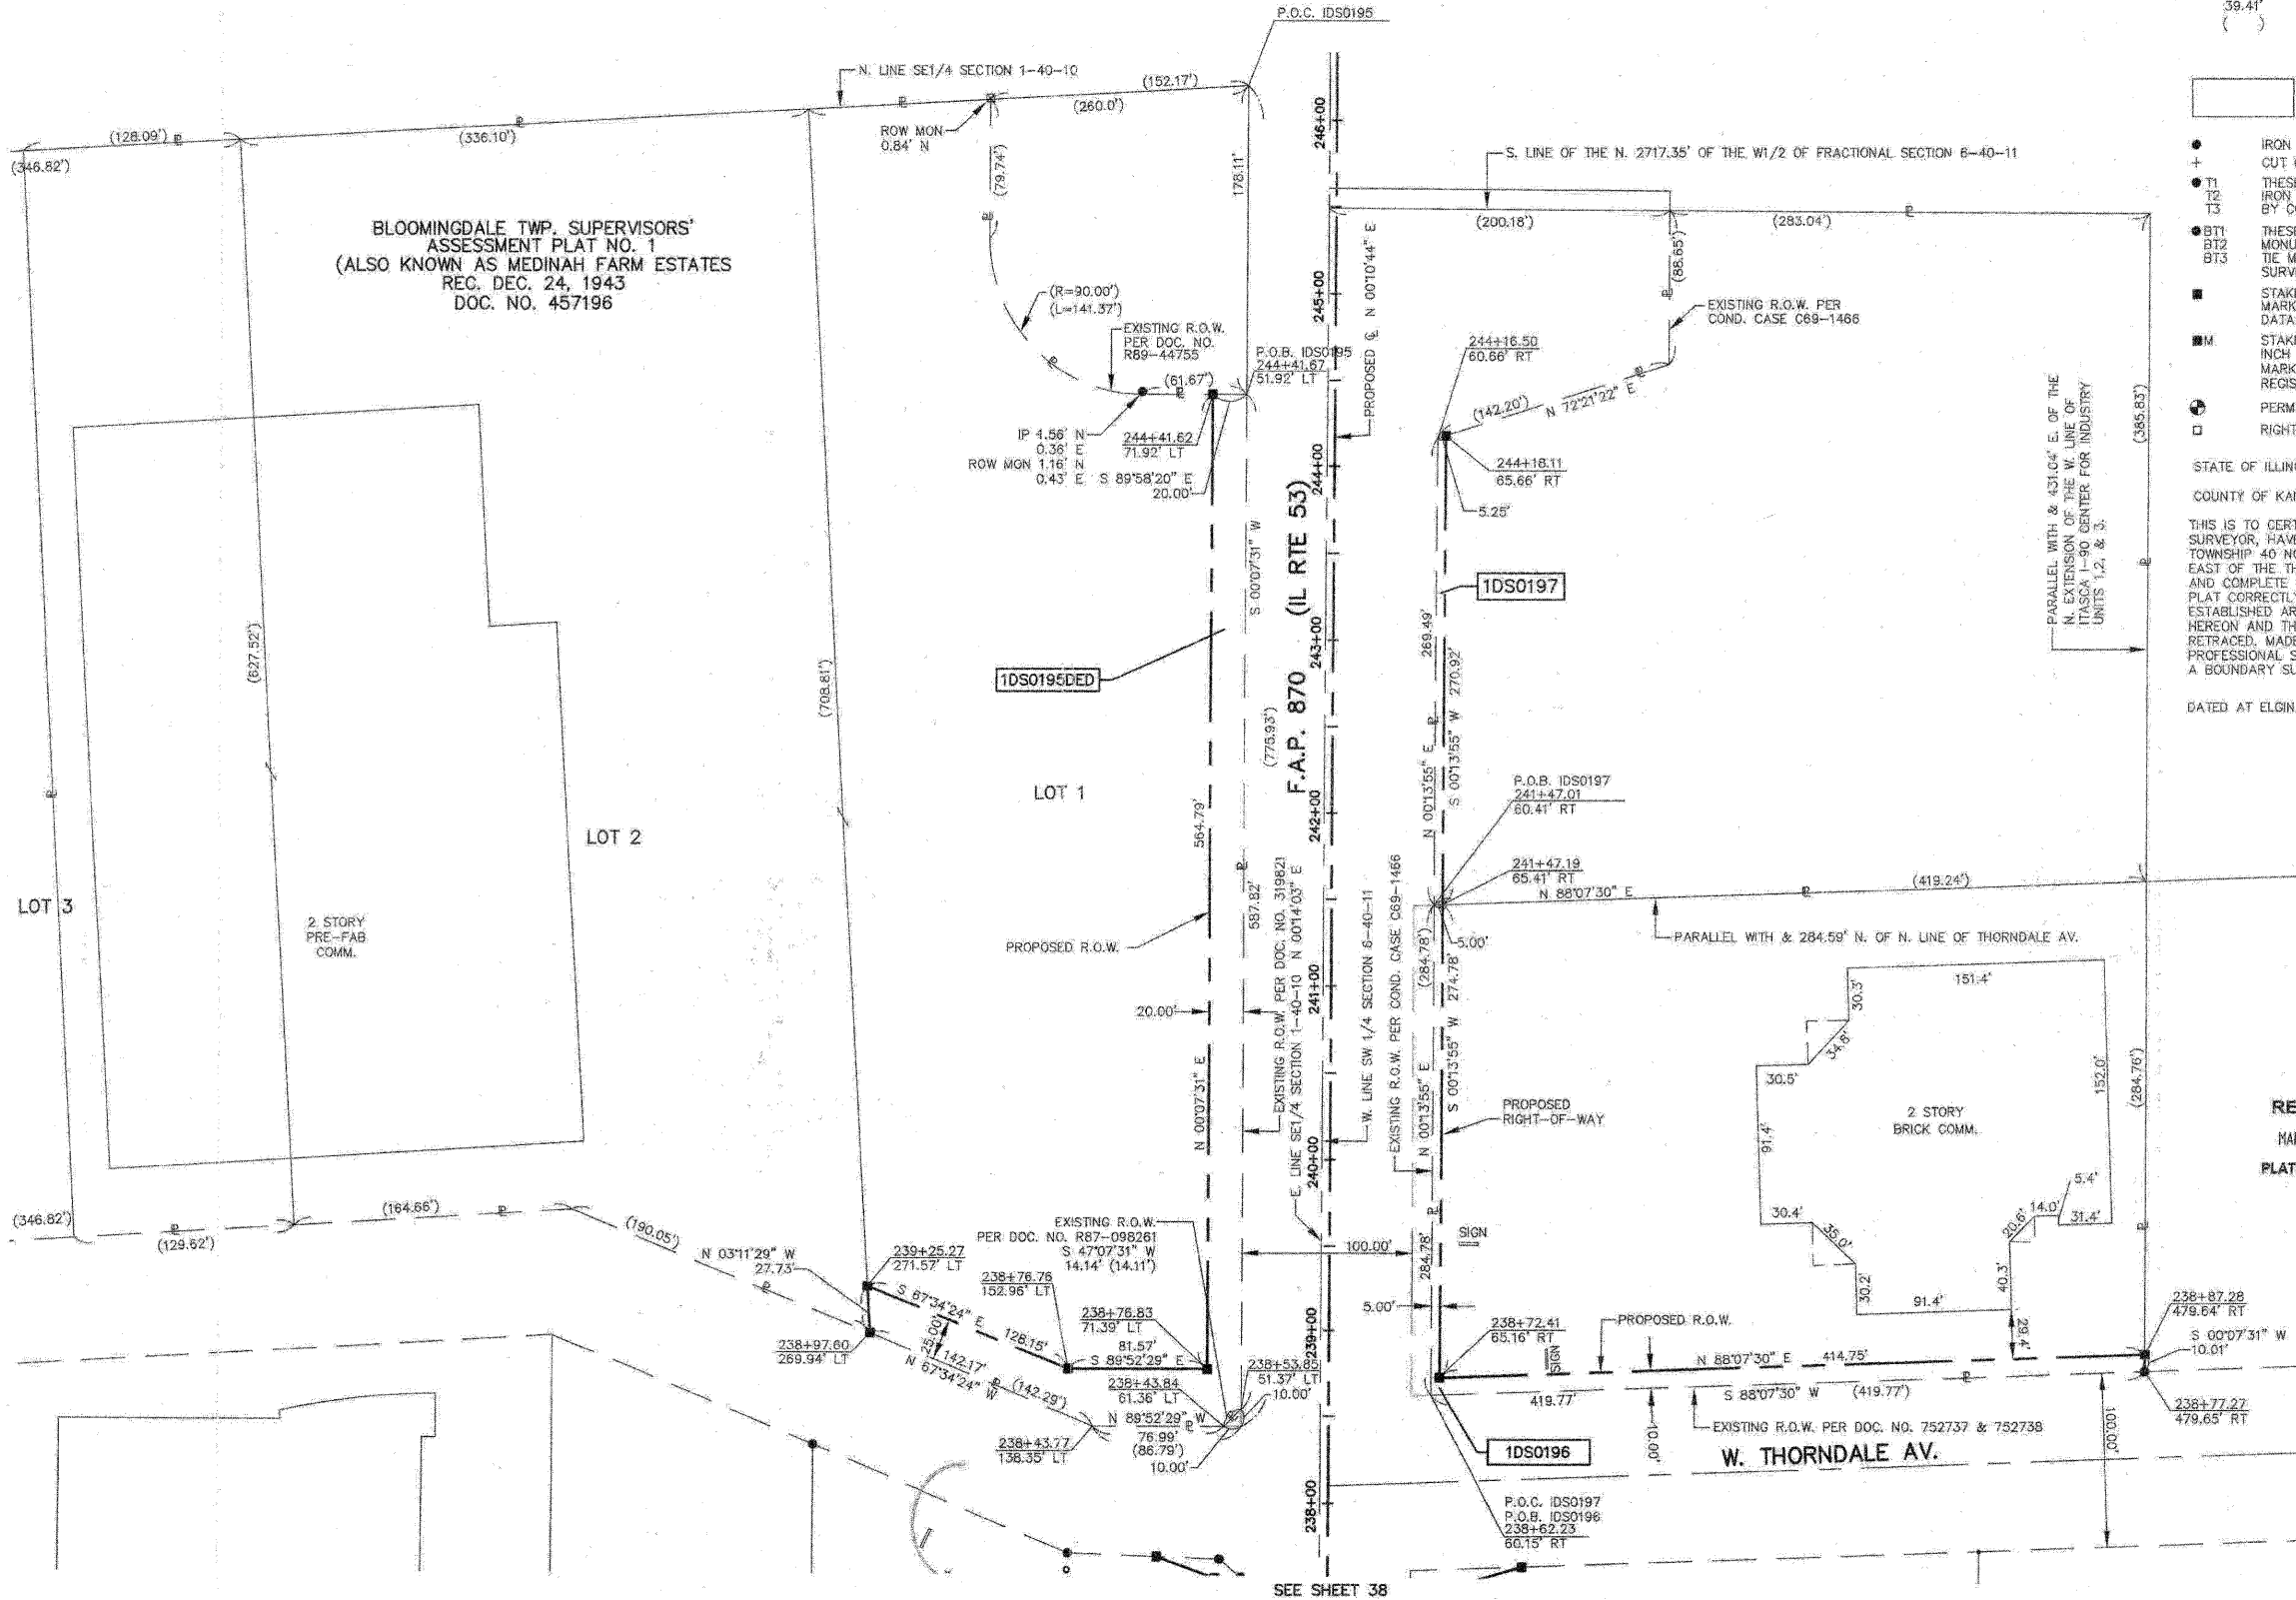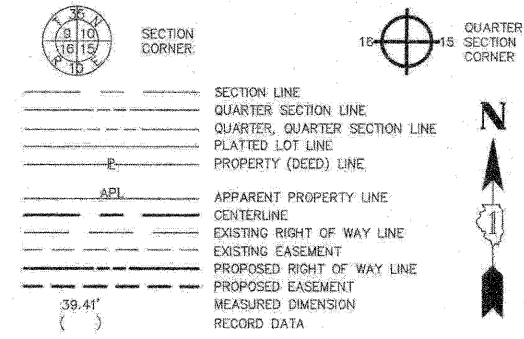

STATE OF ILLINOIS }
 COUNTY OF KANE }
 THIS IS TO CERTIFY THAT I, REJENA H. LYON, AN ILLINOIS PROFESSIONAL LAND SURVEYOR, HAVE SURVEYED THE PLAT OF HIGHWAYS SHOWN HEREON IN SECTION 24, TOWNSHIP 40 NORTH, RANGE 10 EAST, AND SECTION 19, TOWNSHIP 40 NORTH, RANGE 11 EAST OF THE THIRD PRINCIPAL MERIDIAN, DUPAGE COUNTY, THAT THE SURVEY IS TRUE AND COMPLETE AS SHOWN TO THE BEST OF MY KNOWLEDGE AND BELIEF; THAT THE PLAT CORRECTLY REPRESENTS SAID SURVEY; THAT ALL MONUMENTS FOUND AND ESTABLISHED ARE OF PERMANENT QUALITY AND OCCUPY THE POSITIONS SHOWN HEREON AND THAT THE MONUMENTS ARE SUFFICIENT TO ENABLE THE SURVEY TO BE RETRACED, MADE FOR THE DEPARTMENT OF TRANSPORTATION, STATE OF ILLINOIS. THIS PROFESSIONAL SERVICE CONFORMS TO THE CURRENT ILLINOIS MINIMUM STANDARDS FOR A BOUNDARY SURVEY FOR THAT PORTION SHOWN AS PROPOSED RIGHT-OF-WAY.
 DATED AT ELGIN, ILLINOIS, THIS _____ DAY OF _____, 20__ A.D.

ILLINOIS PROFESSIONAL LAND SURVEYOR NO. 3302
 ACCOUNT NO. 2-04-0052(a)

 LICENSE EXPIRES 11/30/2010

ALL BEARINGS ARE BASED ON ILLINOIS STATE PLANE COORDINATE SYSTEM NAD 83, EAST ZONE GRID.

RECEIVED
 MAR 03 2010
 PLATS & LEGALS

TOPO UPDATED 7/27/09
 FIELD WORK COMPLETED 6/27/03

HAMPTON, LENZINI AND RENWICK, INC.
 CIVIL ENGINEERS - STRUCTURAL ENGINEERS - LAND SURVEYORS

 380 SHEPARD DRIVE
 ELGIN, ILLINOIS 60123
 847.897.6700 www.hlrengineering.com
 184.000659
 ILLINOIS PROFESSIONAL DESIGN FIRM & STRUCTURAL ENGINEERING CORP.


PLAT OF HIGHWAYS
 STATE OF ILLINOIS
 DEPARTMENT OF TRANSPORTATION
 F.A.P. 870 (IL RTE 53)
 DUPAGE COUNTY SECTION
 PROJECT JOB NO. R-91-069-00
 STATION 238+00 TO STATION 245+00
 SCALE: 1"=50' SHEET 39 OF X

BUREAU OF LAND ACQUISITION
 201 WEST CENTER COURT
 SCHAUMBURG, ILLINOIS 60196


LOOP DETECTOR NOTES

- EACH PAIR OF LOOP WIRES SHALL BE PLACED IN A SEPARATE EMPTY COILABLE NONMETALLIC CONDUIT FROM THE EDGE OF PAVEMENT TO THE HANDHOLE. SPACING BETWEEN THE HOLES DRILLED IN THE PAVEMENT SHALL NOT BE LESS THAN 6" (150 mm). EMPTY COILABLE NONMETALLIC CONDUIT SHALL BE INCLUDED IN THE COST OF THE LOOP WIRE.
- THE NUMBER OF LOOP TURNS SHALL BE AS RECOMMENDED BY THE AMPLIFIER MANUFACTURER. ALL ADJACENT SIDES OF THE LOOPS SHALL BE INSTALLED IN SUCH A WAY THAT THE CURRENT FLOW IS IN THE SAME DIRECTION TO REINFORCE ITS MAGNETIC FIELDS FOR SMALL VEHICLE DETECTION.
- EACH LOOP LEAD-IN SHALL BE IDENTIFIED AND PERMANENTLY TAGGED IN THE HANDHOLE. EACH LEAD-IN CABLE TAG SHALL INDICATE THE LOCATION OF THE LOOP, LOOP ROTATION (CLOCKWISE/COUNTERCLOCKWISE), LOOP LEAD-IN DIRECTION (IN OR OUT), LOOP CABLE NUMBER AND LOCATION IN CABINET, AND NUMBER OF TURNS IN THE DETECTOR LOOPS IN WATER PROOF INK AS INDICATED ON THE DISTRICT 1 STANDARD TRAFFIC SIGNAL DESIGN DETAIL. THE CONTRACTOR SHALL MARK LOOP LOCATIONS ON RECORD DRAWINGS AND PRESENT TO THE ENGINEER AFTER FINAL INSPECTION. LOOPS SHALL BE MARKED BY LANE AND LOOP NUMBER. SEE DETAIL BELOW.
- ALL LOOP CABLE SHALL BE FASTENED WITH PLASTIC TIE WRAP TO THE HANDHOLE HOOKS.
- IN ASPHALT PAVEMENT, LOOPS SHOULD BE PLACED IN THE BINDER AND DIVESHOLES MARKED AT THE CURB WITH A SAW-CUT. THE SAW-CUT SHALL BE CUT IN ACCORDANCE WITH LOCAL AND E.P.A. DUST CONTROL REQUIREMENTS. DETECTOR LOOP(S) SHALL NOT BE INSTALLED IN WET CONDITIONS AND THE SAW-CUTS MUST BE FREE OF DEBRIS AND RESIDUE SUCH AS DUST AND WATER WHICH IS TO BE ACHIEVED BY THE USE OF COMPRESSED AIR, WIRE BRUSHING AND HEAT DRYING ACCORDING TO SEALANT MANUFACTURER REQUIREMENTS. THE DETECTOR WIRE SHALL BE HELD IN PLACE BY THE USE OF FORM WEDGES. WEDGES SHALL BE SPACED NO MORE THAN 18" (450 mm) APART.
- LOOP SPLICES SHALL BE SOLDERED USING A SOLDERING IRON. BLOW TORCHES OR OTHER DEVICES WHICH OXIDIZE COPPER CABLE SHALL NOT BE ALLOWED FOR SOLDERING OPERATIONS. SEE DETAIL BELOW RIGHT.
- PERFORMED DETECTOR LOOPS SHALL BE USED, AS SHOWN ON THE PLANS, WHERE NEW CONCRETE PAVEMENT IS PROPOSED. THE INSTALLATION OF PREFORMED LOOPS SHALL BE IN ACCORDANCE WITH THE DISTRICT 1 SPECIFICATIONS OR AS DIRECTED BY THE ENGINEER.

LOOP LEAD-IN CABLE TAG

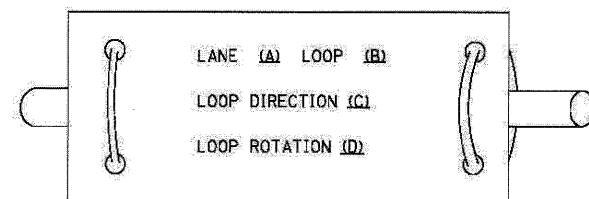


- LANE 1 IS THE LANE CLOSEST TO THE CENTERLINE OF THE ROADWAY
- LOOP #1 IS THE LOOP IN THE LANE CLOSEST TO THE INTERSECTION.
- LABEL LOOP CABLE "IN" OR LOOP CABLE "OUT".
- LABEL LOOP CABLE CLOCKWISE OR LOOP CABLE COUNTERCLOCKWISE.

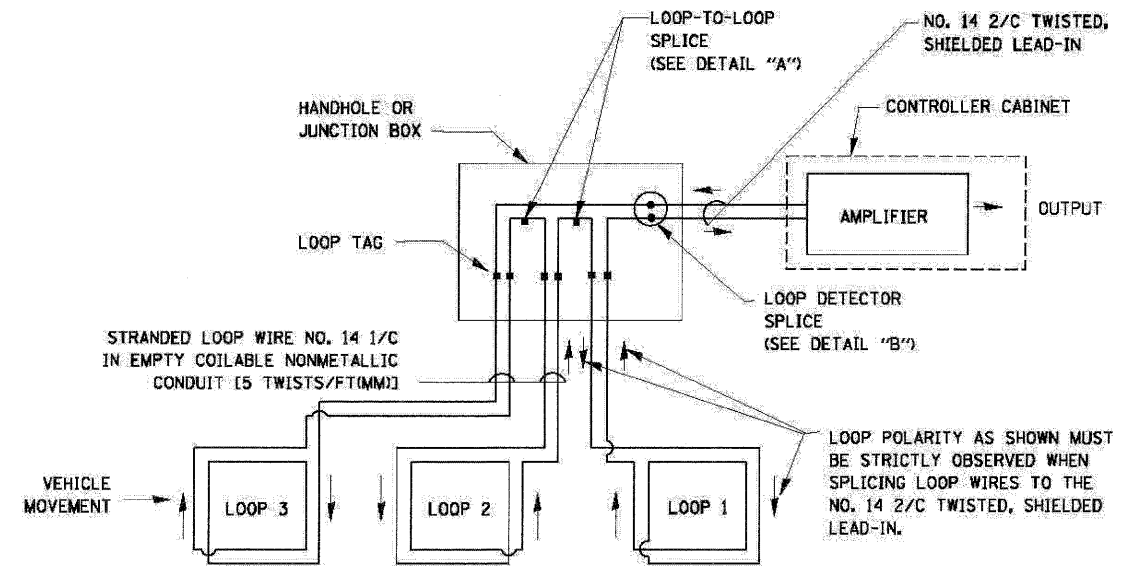


DETECTOR LOOP WIRING SCHEMATIC

- LOOPS SHALL BE SPLICED IN SERIES.
- SAW-CUTS SHALL BE A MINIMUM WIDTH OF 5/16" (8 mm).
- SAW-CUT DEPTHS SHALL BE 3" (75 mm). IF IN CONCRETE, THE SAW-CUT DEPTH SHALL BE TO THE TOP OF THE REINFORCEMENT.
- LOOP CORNERS SHALL BE DRILLED WITH A 2" (50 mm) DIAMETER CORE.

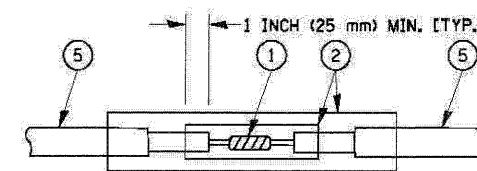


DETAIL "A"
LOOP-TO-LOOP SPLICE

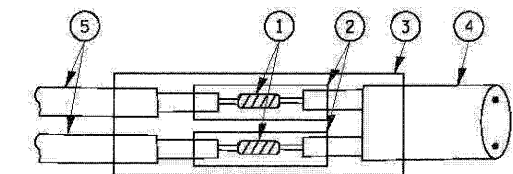


DETAIL "B"
LOOP-TO-CONTROLLER SPLICE

TYPE I LOOP

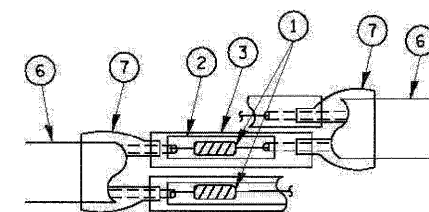

DETAIL "A"
PRE-FORMED LOOP
LOOP-TO-LOOP SPLICE

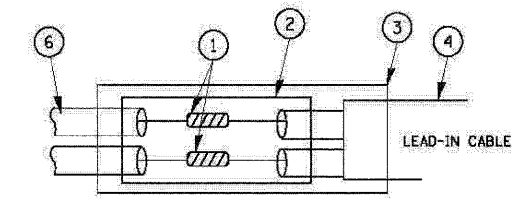


DETAIL "B"
PRE-FORMED LOOP
LOOP-TO-CONTROLLER SPLICE

LOOP DETECTOR SPLICE

- WESTERN UNION SPLICE SOLDERED WITH ROSIN CORE FLUX. ALL EXPOSED SURFACES OF THE SOLDER SHALL BE SMOOTH.
- WCSMW 30/100 HEAT SHRINK TUBE, MINIMUM LENGTH 3" (75 mm), UNDERWATER GRADE.
- WCS 200/750 HEAT SHRINK TUBE, MINIMUM LENGTH 6" (150 mm), UNDERWATER GRADE.
- NO. 14 2/C TWISTED, SHIELDED CABLE.
- LOOP CONDUCTOR WITH FLEXIBLE PLASTIC TUBE.
- PRE-FORMED LOOP
- XL POLYOLEFIN 2 CONDUCTOR BREAKOUT SEALS, TYCO CBR-2 OR APPROVED EQUAL

TRAFFIC SIGNAL MAST ARM AND SIGNAL POST


MAST ARM MOUNTED SIGNALS IN EXISTING, PROPOSED OR FUTURE SIDEWALK/BICYCLE PATH AREA. INTERSECTION SHOWN WITH PEDESTRIAN SIGNALS AND PEDESTRIAN PUSHBUTTON DETECTORS.

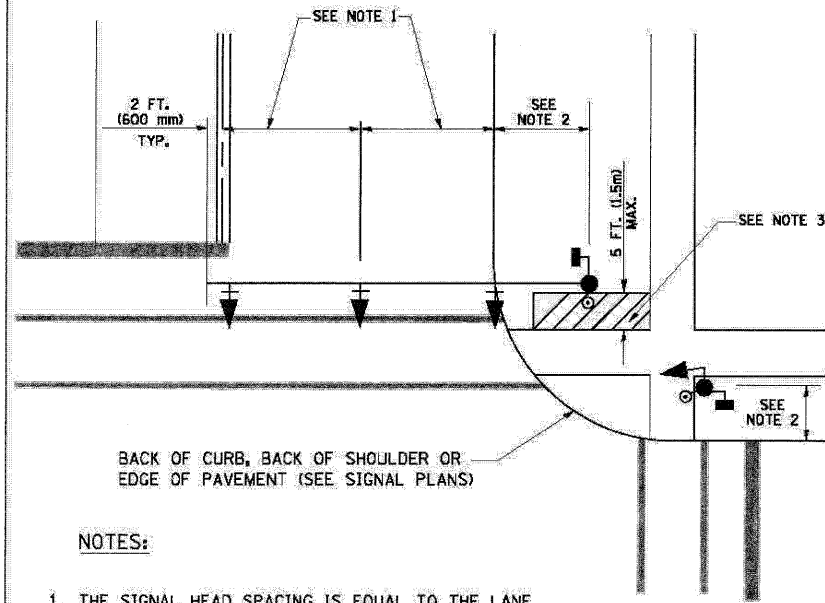

NOTES:

1. THE SIGNAL HEAD SPACING IS EQUAL TO THE LANE WIDTH OR AS SHOWN ON THE TRAFFIC SIGNAL PLAN.
2. REFER TO THE TRAFFIC SIGNAL EQUIPMENT OFFSET TABLE.
3. PROVIDE A LEVEL ALL-WEATHER SURFACE (CONCRETE SIDEWALK, ASPHALT BICYCLE PATH SURFACE OR MATCHING MATERIAL TO THE ADJACENT SURFACE) UP TO THE MAST ARM SHAFT OR THE SIGNAL POST.
4. THE FACE OF THE PEDESTRIAN PUSHBUTTON SHALL BE PARALLEL TO THE CROSSWALK TO BE USED.
5. THE LOCATIONS AND INSTALLATION OF PEDESTRIAN SIGNAL HEADS AND PEDESTRIAN PUSHBUTTONS SHALL MEET THE REQUIREMENTS OF THE MUTCD AND INFORMATION FOUND IN THE "AMERICANS WITH DISABILITIES ACT ACCESSIBILITY GUIDELINES FOR BUILDINGS AND FACILITIES."


PEDESTRIAN SIGNAL POST AND PEDESTRIAN PUSH BUTTON POST

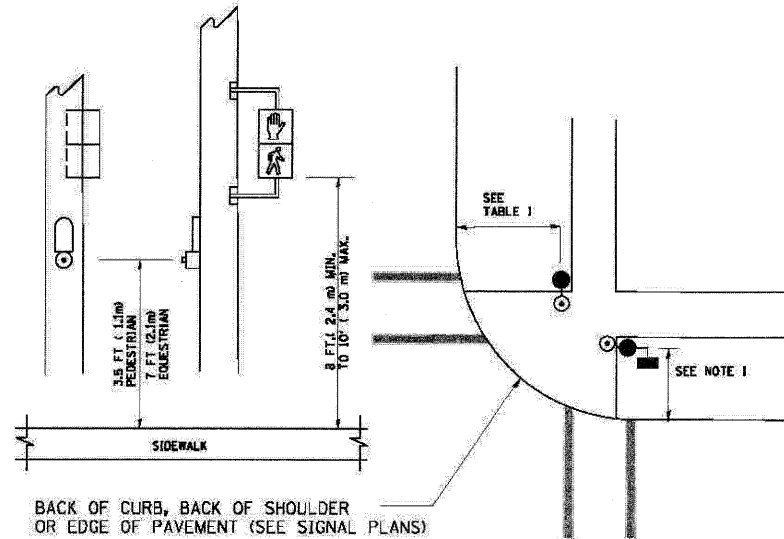

NOTES:

1. REFER TO THE TRAFFIC SIGNAL EQUIPMENT OFFSET TABLE.
2. PROVIDE A LEVEL ALL-WEATHER SURFACE (CONCRETE SIDEWALK, ASPHALT BICYCLE PATH SURFACE OR MATCHING MATERIAL TO THE ADJACENT SURFACE) UP TO THE PEDESTRIAN SIGNAL POST OR THE PEDESTRIAN PUSH BUTTON POST.
3. THE FACE OF THE PEDESTRIAN PUSHBUTTON SHALL BE PARALLEL TO THE CROSSWALK TO BE USED.
4. THE LOCATIONS AND INSTALLATION OF PEDESTRIAN SIGNAL HEADS AND PEDESTRIAN PUSHBUTTONS SHALL MEET THE REQUIREMENTS OF THE MUTCD AND INFORMATION FOUND IN THE "AMERICANS WITH DISABILITIES ACT ACCESSIBILITY GUIDELINES FOR BUILDINGS AND FACILITIES."

RECOMMENDED PUSHBUTTON LOCATIONS

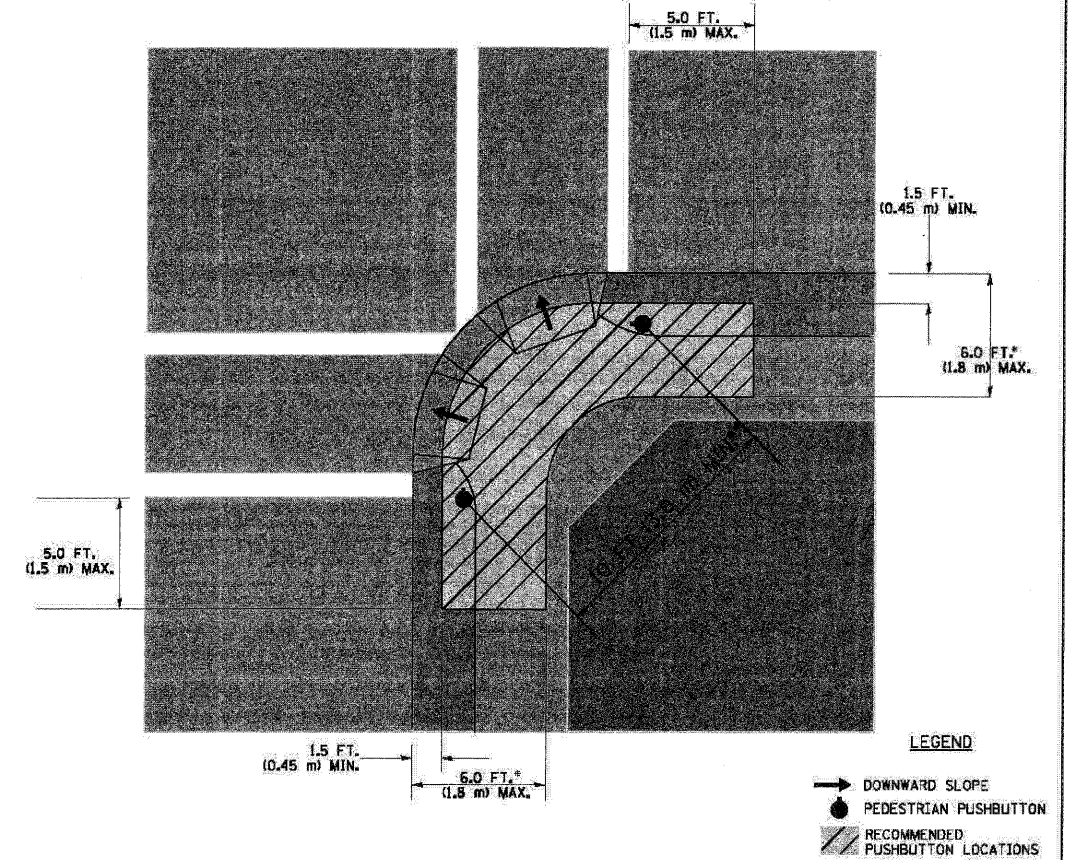

- * WHERE THERE ARE CONSTRAINTS THAT MAKE IT IMPRACTICAL TO PLACE THE PEDESTRIAN PUSHBUTTON BETWEEN 1.5 FT (0.45 m) AND 6 FT (1.8 m) FROM THE EDGE OF THE CURB, SHOULDER, OR PAVEMENT, IT SHOULD NOT BE FURTHER THAN 10 FT (3 m) FROM THE EDGE OF CURB, SHOULDER, OR PAVEMENT.
- ** WHERE THERE ARE CONSTRAINTS ON A PARTICULAR CORNER THAT MAKE IT IMPRACTICAL TO PROVIDE THE 10 FT (3 m) SEPERATION BETWEEN THE TWO PEDESTRIAN PUSHBUTTONS, THE PUSHBUTTONS MAY BE PLACED CLOSER TOGETHER OR ON THE SAME POLE.

NOTES:



1. PEDESTRIAN SIGNAL HEADS SHALL BE MOUNTED WITH THE BOTTOM OF THE SIGNAL HOUSING INCLUDING BRACKETS NOT LESS THAN 8 FT (2.4 m) OR MORE THAN 10 FT (3 m) ABOVE SIDEWALK LEVEL, AND SHALL BE POSITIONED AND ADJUSTED TO PROVIDE MAXIMUM VISIBILITY AT THE BEGINNING OF THE CONTROLLED CROSSWALK.
2. THE BOTTOM OF THE SIGNAL HOUSING (INCLUDING BRACKETS) OF A VEHICULAR SIGNAL FACE THAT IS NOT LOCATED OVER A HIGHWAY SHALL BE AT LEAST 8 FT (2.4 m) BUT NOT MORE THAN 19 FT (5.8 m) ABOVE THE SIDEWALK OR, IF THERE IS NO SIDEWALK, ABOVE THE PAVEMENT GRADE AT THE CENTER OF THE ROADWAY.
3. THE BOTTOM OF THE SIGNAL HOUSING AND ANY RELATED ATTACHMENTS TO A SIGNAL FACE LOCATED OVER ANY PORTION OF A HIGHWAY SHALL BE ACCORDING TO CURRENT STATE STANDARDS 877001, 877002, 877006, 877011 AND 877012 WITH A MINIMUM OF 16 FT (5.0 m) AND A MAXIMUM OF 18 FT (5.5 m) FROM THE HIGHEST POINT OF PAVEMENT.
4. THE BOTTOM OF THE TEMPORARY SPAN WIRE MOUNTED SIGNAL HOUSING AND ANY RELATED ATTACHMENTS TO A SIGNAL FACE LOCATED OVER ANY PORTION OF A HIGHWAY SHALL BE ACCORDING TO CURRENT STATE STANDARD 880001 WITH A MINIMUM OF 17 FT (5.18 m) FROM THE HIGHEST POINT OF PAVEMENT.
5. THE TOP OF THE SIGNAL HOUSING OF A SIGNAL FACE LOCATED OVER ANY PORTION OF A HIGHWAY SHALL NOT BE MORE THAN 25.6 FT (7.8 m) ABOVE THE PAVEMENT.

TRAFFIC SIGNAL EQUIPMENT OFFSET

| TRAFFIC SIGNAL EQUIPMENT | COMBINATION CONCRETE CURB AND GUTTER (MINIMUM DISTANCE FROM BACK OF CURB TO CENTERLINE OF FOUNDATION) | SHOULDER/NON-CURBED AREA (MINIMUM DISTANCE FROM EDGE OF PAVEMENT TO CENTERLINE OF FOUNDATION) |
|------------------------------------|---|---|
| TRAFFIC SIGNAL MAST ARM POLE | 6 FT (1.8m) | SHOULDER WIDTH + 2 FT (0.6m), MINIMUM 10 FT (3.0m) |
| TRAFFIC SIGNAL POST | 4 FT (1.2m) | SHOULDER WIDTH + 2 FT (0.6m), MINIMUM 10 FT (3.0m) |
| PEDESTRIAN SIGNAL POST | 4 FT (1.2m) | SHOULDER WIDTH + 2 FT (0.6m), MINIMUM 10 FT (3.0m) |
| PEDESTRIAN PUSHBUTTON POST | 4 FT (1.2m) | SHOULDER WIDTH + 2 FT (0.6m), MINIMUM 10 FT (3.0m) |
| TEMPORARY WOOD POLE | 6 FT (1.8m) | SHOULDER WIDTH + 2 FT (0.6m), MINIMUM 10 FT (3.0m) |
| CONTROLLER CABINET | 6 FT (1.8m) MINIMUM DISTANCE SEE NOTE 2 | SHOULDER WIDTH + 6 FT (1.8m), MINIMUM 16 FT (4.9m) SEE NOTE 3. |
| SERVICE INSTALLATION, GROUND MOUNT | 6 FT (1.8m) MINIMUM DISTANCE SEE NOTE 2 | SHOULDER WIDTH + 6 FT (1.8m), MINIMUM 16 FT (4.9m) SEE NOTE 3. |

NOTES:

1. CONTACT THE "AREA TRAFFIC SIGNAL MAINTENANCE AND OPERATIONS ENGINEER" FOR ASSISTANCE IN LOCATING THE TRAFFIC SIGNAL EQUIPMENT WHEN THERE ARE CONFLICTS WITH DITCHES OR THE MINIMUM OFFSET DISTANCES CANNOT BE MET.
2. MINIMUM DISTANCE FROM THE BACK OF CURB TO THE ROADWAY SIDE OF THE FOUNDATION.
3. MINIMUM DISTANCE FROM THE EDGE OF PAVEMENT TO THE ROADWAY SIDE OF THE FOUNDATION.
4. ANY CHANGES TO THE OFFSETS OF THE FOUNDATIONS, FROM THE MINIMUM DISTANCES LISTED IN THE "TRAFFIC SIGNAL EQUIPMENT OFFSET" CHART AND THE TRAFFIC SIGNAL INSTALLATION PLAN, COULD EFFECT THE PLACEMENT OF THE SIGNAL HEADS, PEDESTRIAN SIGNAL HEADS AND THE PEDESTRIAN PUSHBUTTONS. THE SIGNAL HEAD PLACEMENT ON THE MAST ARMS SHALL REMAIN AS PER THE TRAFFIC SIGNAL INSTALLATION PLAN AND THE "TRAFFIC SIGNAL MAST ARM AND SIGNAL POST" DETAIL ABOVE. THE PROPOSED MAST ARM LENGTHS MAY NEED TO BE REVISED TO MEET THE ABOVE REQUIREMENTS. THE PEDESTRIAN SIGNAL HEADS AND PEDESTRIAN PUSHBUTTONS MUST MEET THE REQUIREMENTS UNDER THE DETAILS ON THIS SHEET.

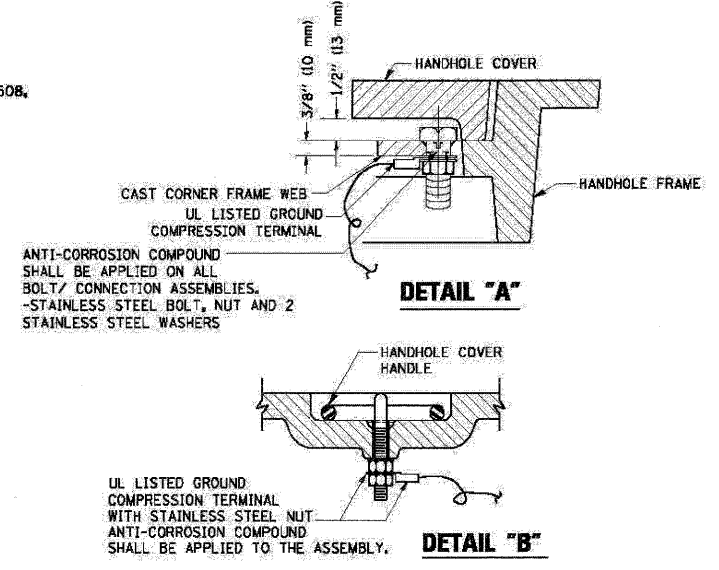
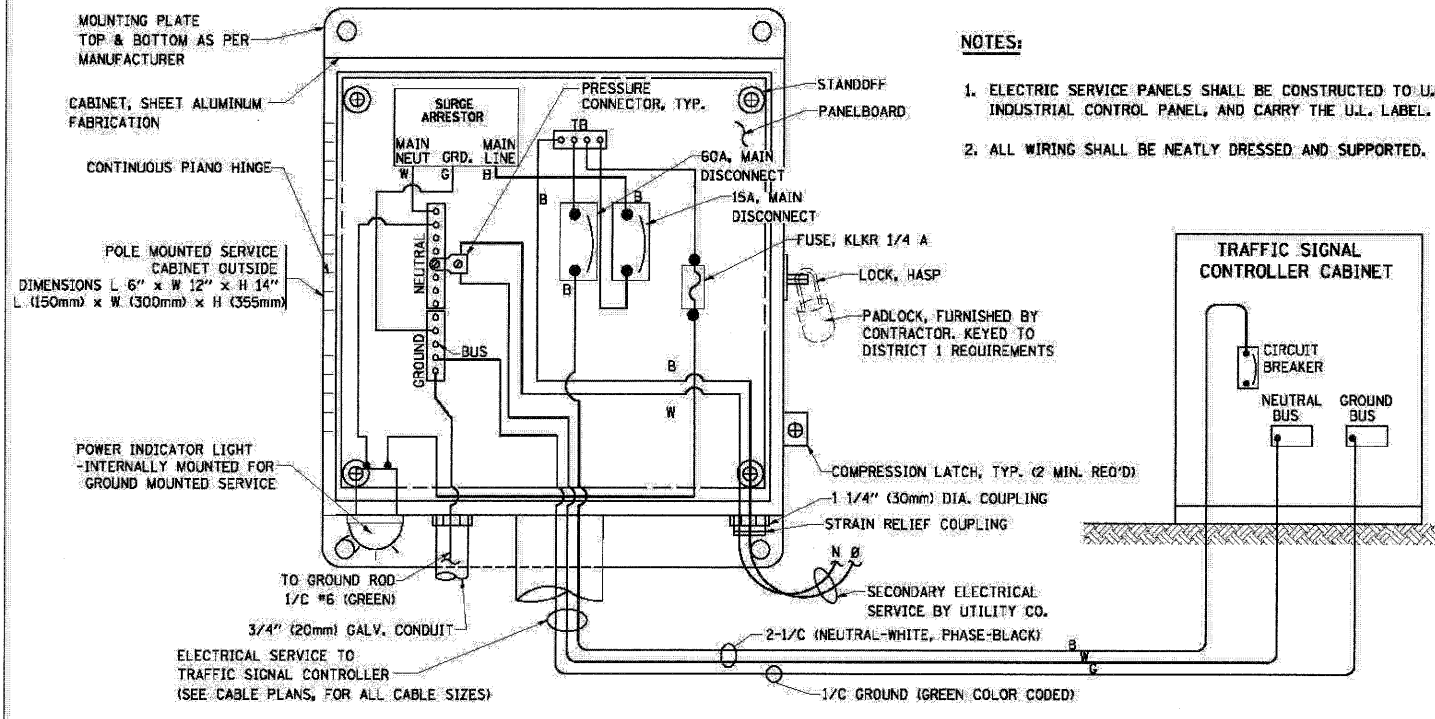


NOTES:

GROUNDING SYSTEM


- THE GROUNDING SYSTEM SHALL CONSIST OF AN INSULATED CONDUCTOR TYPE XLP, NO. 6 A.W.G., STRANDED COPPER TO BE INSTALLED IN RACEWAYS, THE GROUNDING CABLE SHALL BE INSTALLED IN A CONTINUOUS MANNER AS SHOWN ON THE CABLE PLAN PROVIDED. ALL GROUNDING CONDUCTORS SHALL BE BONDED TO METAL ENCLOSURE (HANDHOLE, POST, MAST ARM, CONTROLLER, ETC.), GROUND ROD SHALL BE 3/4" DIA. x 10'-0" (20mm x 3.0m) LONG, COPPER CLAD. ONE GROUND ROD SHALL BE INSTALLED AT ALL POST FOUNDATIONS, POLE FOUNDATIONS, CONTROLLER CABINET FOUNDATION AND ELECTRICAL SERVICE INSTALLATION AS INDICATED ON THE CABLE PLAN. IF THERE ARE ANY SPECIAL CONDITIONS SUCH AS SUB-SURFACE CONDITIONS OR INSTALLATION PROBLEMS, THE RESIDENT ENGINEER SHALL BE NOTIFIED OR CONTACT THE BUREAU OF TRAFFIC, ILLINOIS DEPARTMENT OF TRANSPORTATION DISTRICT ONE AT (847) 705-4139.
- THE NEUTRAL CONDUCTOR AND THE GROUND CONDUCTOR SHALL BE CONNECTED IN THE SERVICE INSTALLATION. AT NO OTHER POINT IN THE TRAFFIC SIGNAL SYSTEM SHALL THE NEUTRAL AND GROUND CONDUCTORS BE CONNECTED.
- ALL EQUIPMENT GROUNDING CONDUCTORS SHALL TERMINATE AT THE GROUND BUS IN THE CONTROLLER CABINET.
- THE CONTRACTOR SHALL PROVIDE A GROUND CABLE WITH CONNECTORS BETWEEN THE HANDHOLE COVER AND HANDHOLE FRAME.

ELECTRICAL SERVICE - PANEL DIAGRAM (TYPICAL FOR POLE AND GROUND MOUNTED SERVICE)
SERVICE INSTALLATION POLE MOUNT (SHOWN)
 (NOT TO SCALE)

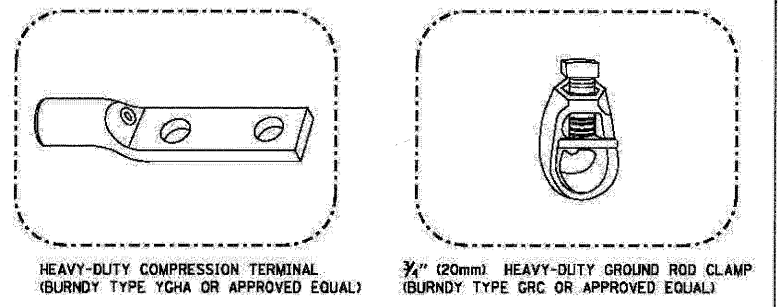
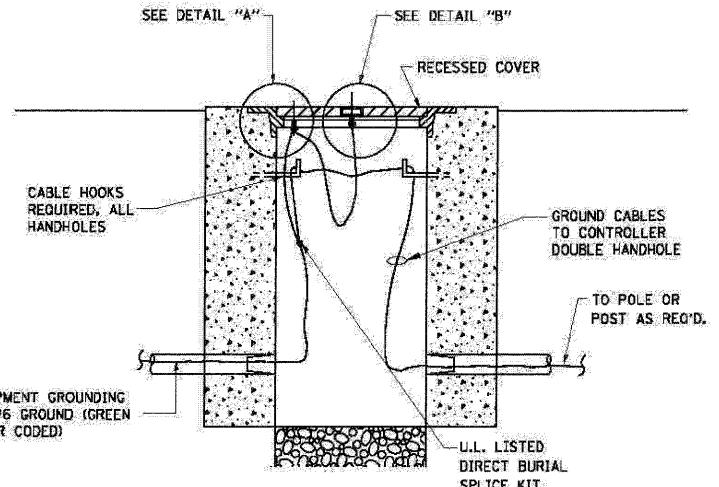


NOTES:

- ALL CLAMPS SHALL BE BRONZE OR COPPER, U.L. APPROVED.
- GROUND CABLE SHALL BE LOOPED OVER HOOKS IN THE HANDHOLES 6.5' (2.0m) SLACK SHALL BE PROVIDED IN SINGLE HANDHOLES 13' (4.0m) OF SLACK SHALL BE PROVIDED IN DOUBLE HANDHOLES, 5' (1.4m) OF SLACK SHALL BE PROVIDED BETWEEN FRAME AND COVER.

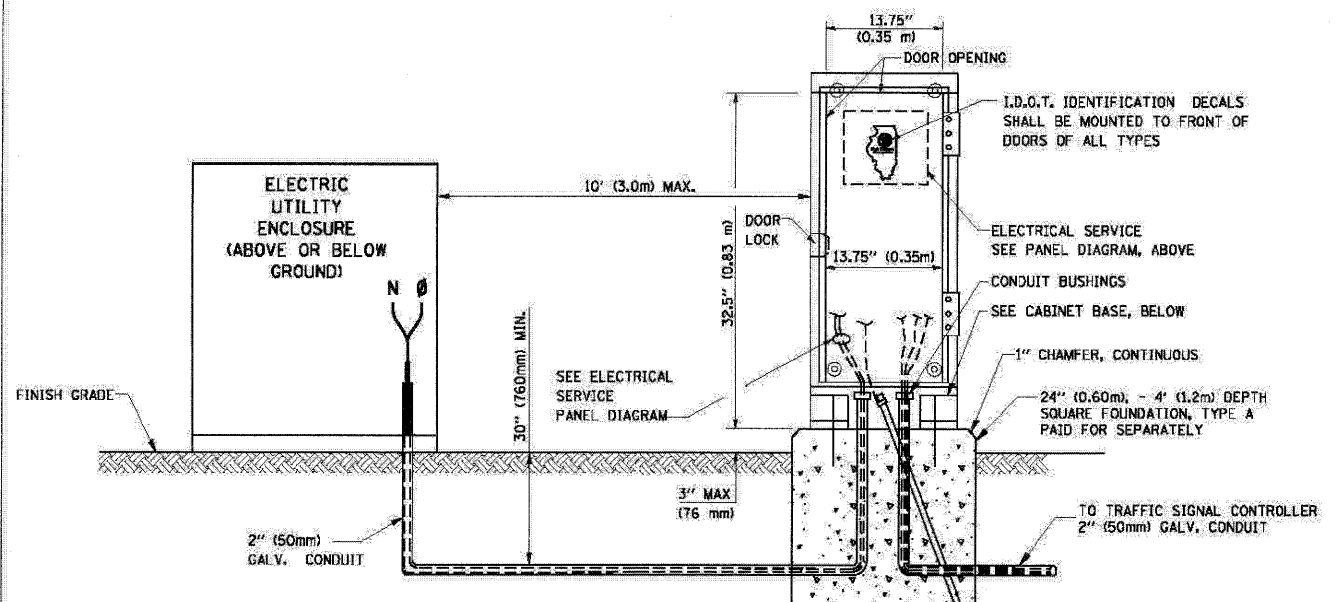


HANDHOLE COVER & FRAME - GROUNDING DETAIL
 (NOT TO SCALE)

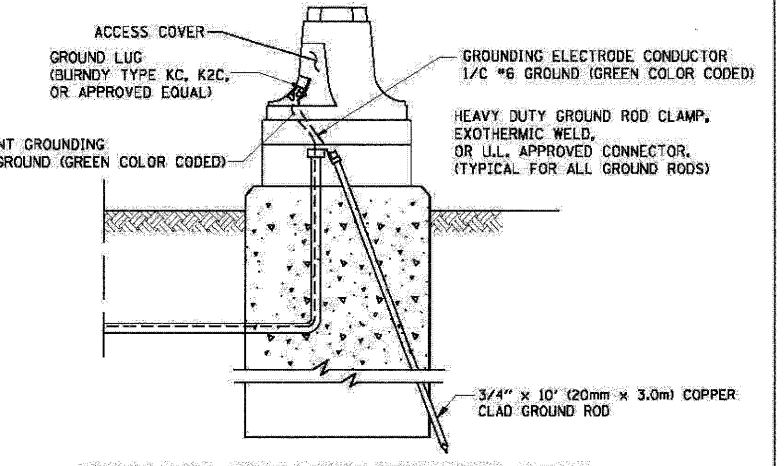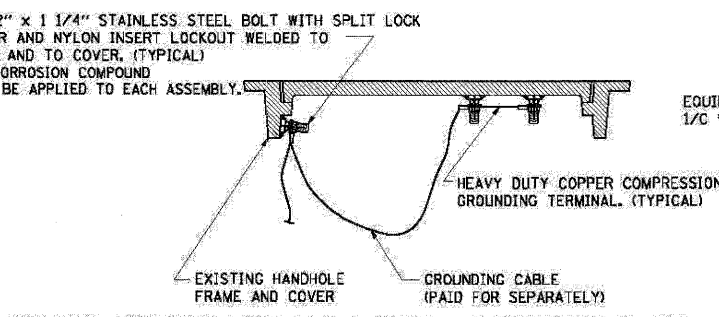

SERVICE INSTALLATION GROUND MOUNT
 (NOT TO SCALE)

CABINET - BASE BOLT PATTERN
 (NOT TO SCALE)




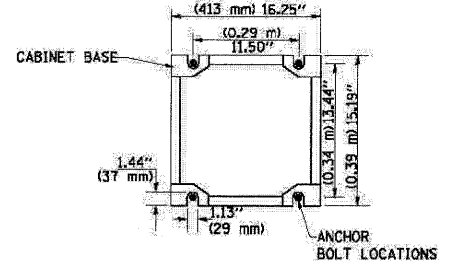


STATE OF ILLINOIS
DEPARTMENT OF TRANSPORTATION

DISTRICT ONE
 STANDARD TRAFFIC SIGNAL DESIGN DETAILS



| | | | |
|-------------|----------------------|-------------------|-----------|
| FILE NAME = | USER NAME = #USER# | DESIGNED - BKD | REVISED - |
| #FILES | | DRAWN - BKD, EA | REVISED - |
| | PLOT SCALE = #SCALE# | CHECKED - BKD, EA | REVISED - |
| | PLOT DATE = #DATE# | DATE - 02/08/2020 | REVISED - |

| | | | | | | |
|---|----------------------------------|--------------------|--------------|---------------|------------------|---------------|
| SCALE: | SHEET NO. OF SHEETS STA. TO STA. | F.A.P. RTE. 2578 | SECTION 532B | COUNTY DuPage | TOTAL SHEETS 781 | SHEET NO. 427 |
| | | CONTRACT NO. 60477 | | | | |
| FED. ROAD DIST. NO. - [ILLINOIS] FED. AID PROJECT | | | | | | |

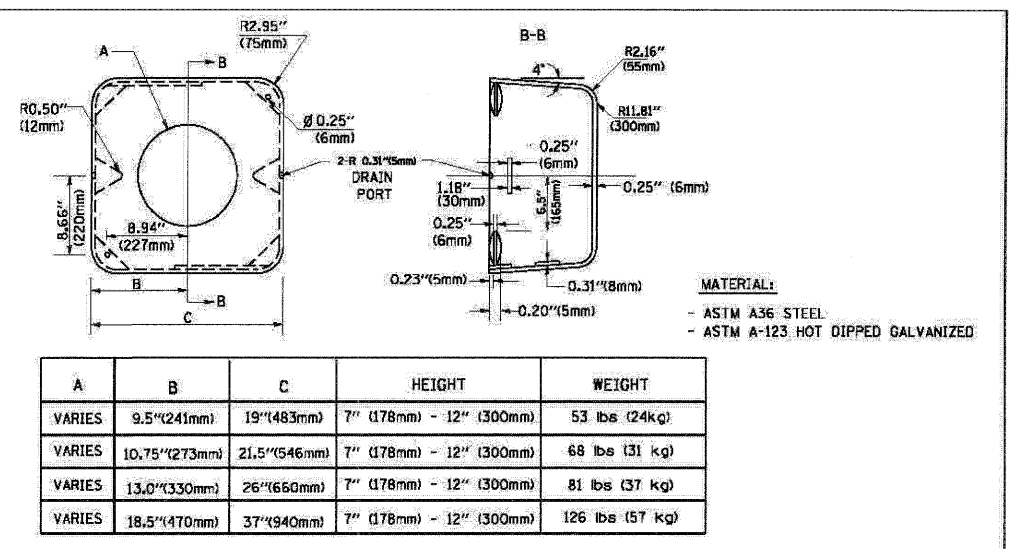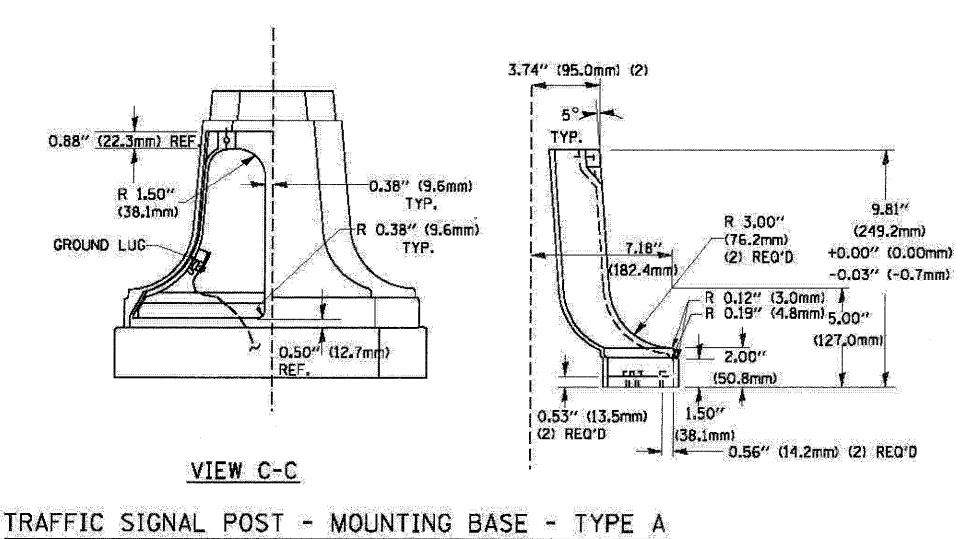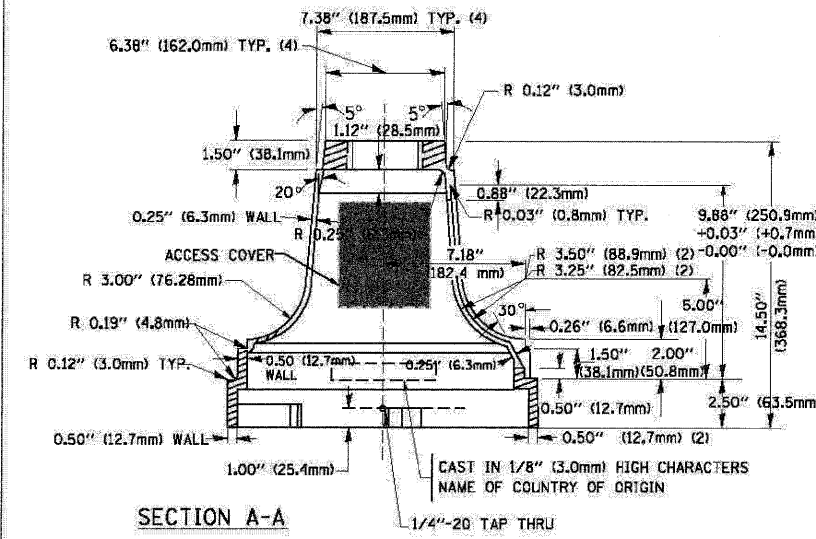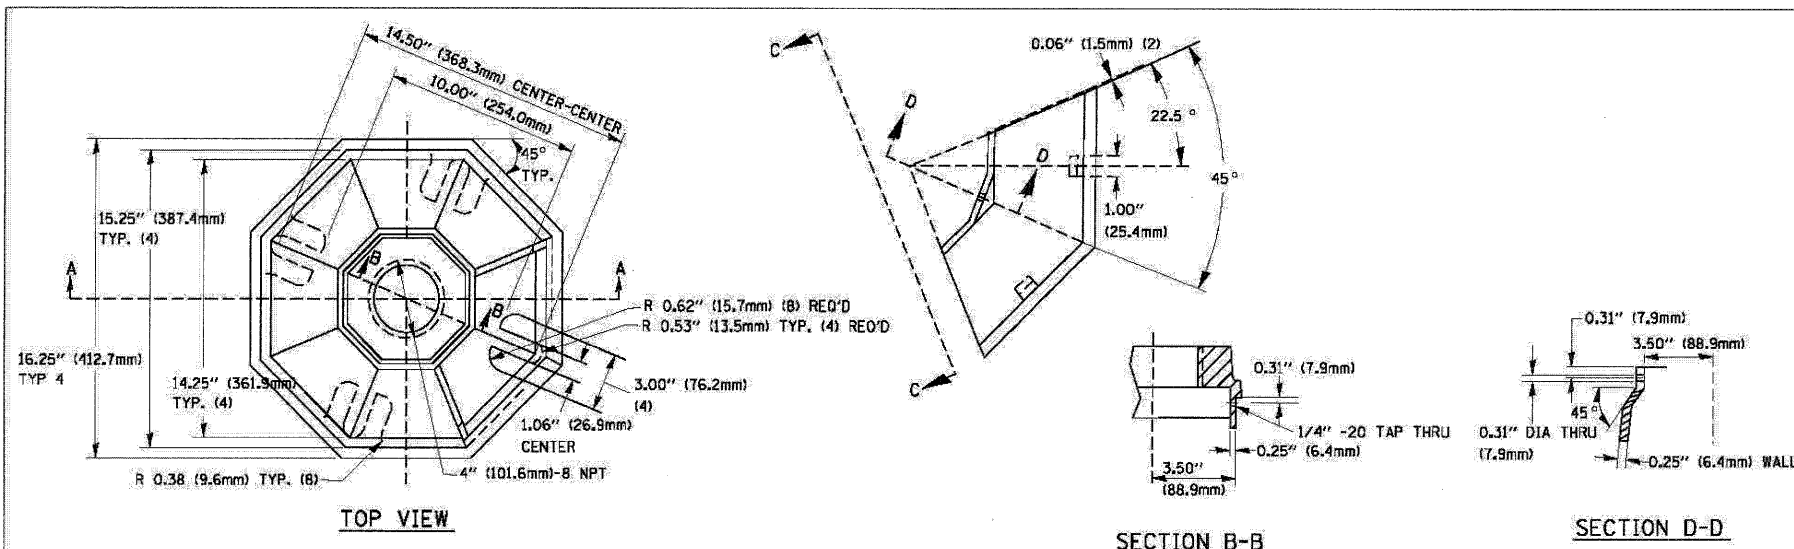


| A | B | C | HEIGHT | WEIGHT |
|-----------|-----------------|----------------|----------------------------|-----------------|
| VARIABLES | 9.5\" (241mm) | 19\" (483mm) | 7\" (178mm) - 12\" (300mm) | 53 lbs (24kg) |
| VARIABLES | 10.75\" (273mm) | 21.5\" (546mm) | 7\" (178mm) - 12\" (300mm) | 68 lbs (31 kg) |
| VARIABLES | 13.0\" (330mm) | 26\" (660mm) | 7\" (178mm) - 12\" (300mm) | 81 lbs (37 kg) |
| VARIABLES | 18.5\" (470mm) | 37\" (940mm) | 7\" (178mm) - 12\" (300mm) | 126 lbs (57 kg) |

- NOTES:**
- DIMENSION "A" IS EQUAL TO THE DIAMETER OF THE MAST ARM POLE AT THE TOP OF THE SHROUD, THE SHROUD SHALL BE TIGHT TO THE MAST ARM POLE.
 - THE SUPPLIER SHALL VERIFY THE ABOVE DIMENSIONS BASED ON MAST ARM REQUIREMENTS.
 - THE HEIGHT OF THE SHROUD SHALL COVER THE ANCHOR BOLTS, NUTS AND MAST ARM POLE BASE.

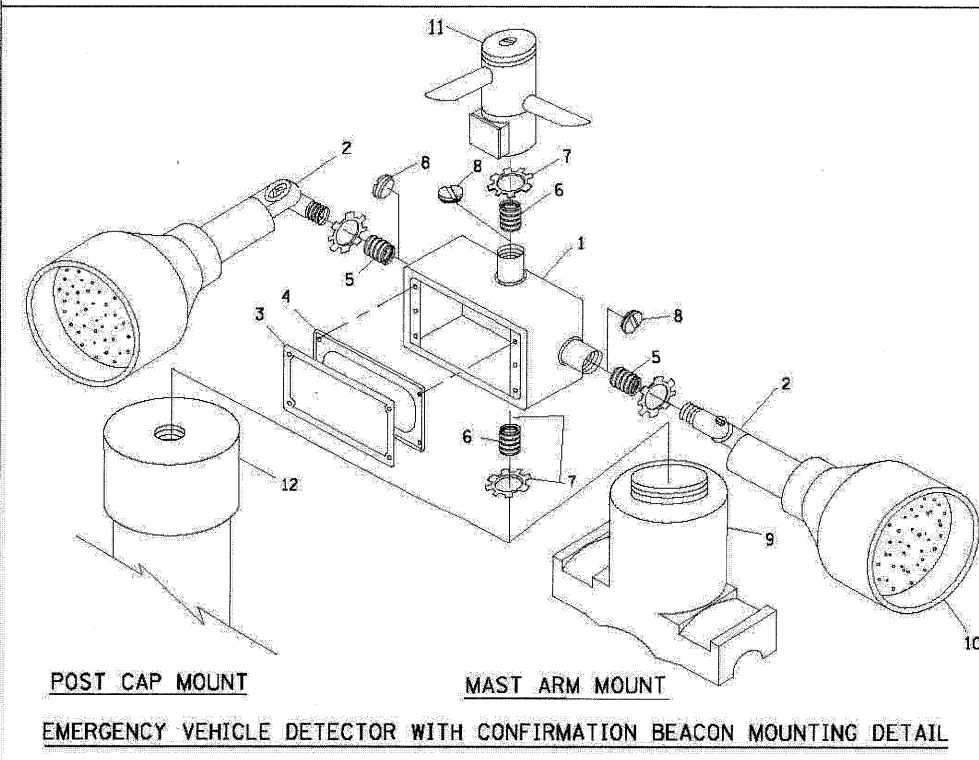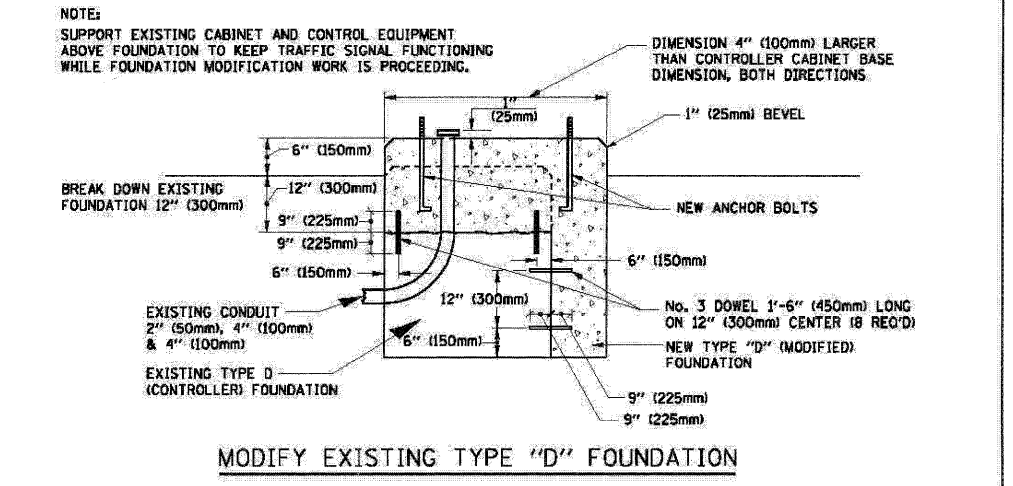


| ITEM NO. | IDENTIFICATION |
|----------|---|
| 1 | OUTLET BOX - GALV. 21 CU. IN. (0.000344 CU-M) |
| 2 | LAMP HOLDER AND COVER |
| 3 | OUTLET BOX COVER |
| 4 | RUBBER COVER GASKET |
| 5 | REDUCING BUSHING |
| 6 | 3/4\" (19 mm) CLOSE NIPPLE |
| 7 | 3/4\" (19 mm) LOCKNUT |
| 8 | 3/4\" (19 mm) HOLE PLUG |
| 9 | SADDLE BRACKET - GALV. |
| 10 | 6 WATT PAR 38 LED FLOOD LAMP |
| 11 | DETECTOR UNIT |
| 12 | POST CAP [18 FT. (5.4 m) POST MIN.] |



- NOTES:**
- ALL ELECTRICAL ITEMS, EXCEPT ITEMS *2 AND *11 SHALL BE ALUMINUM OR GALVANIZED
 - ITEM *1- OZ/GEDNEY FSX-1-50 OR EQUIVALENT
ITEM *2- MULBERRY CON-O-SHADE LAMP SHIELD OR EQUIVALENT
ITEM *9- "BAND-IT" SADDLE BRACKET OR EQUIVALENT
 - WHEN POST MOUNTING IS SPECIFIED, ITEM *9 SHALL NOT BE REQUIRED. THE DETECTION UNIT SHALL BE MOUNTED DIRECTLY ON TOP OF THE CAP BY DRILLING AND TAPPING A 3/4\" (19 mm) HOLE WITH PIPE THREADS. THE POST CAP SHALL EITHER BE SCREWED TO THE TOP OF THE POST OR A MINIMUM OF 3 TIGHTENING SCREWS SHALL BE REQUIRED ON EACH CAP.

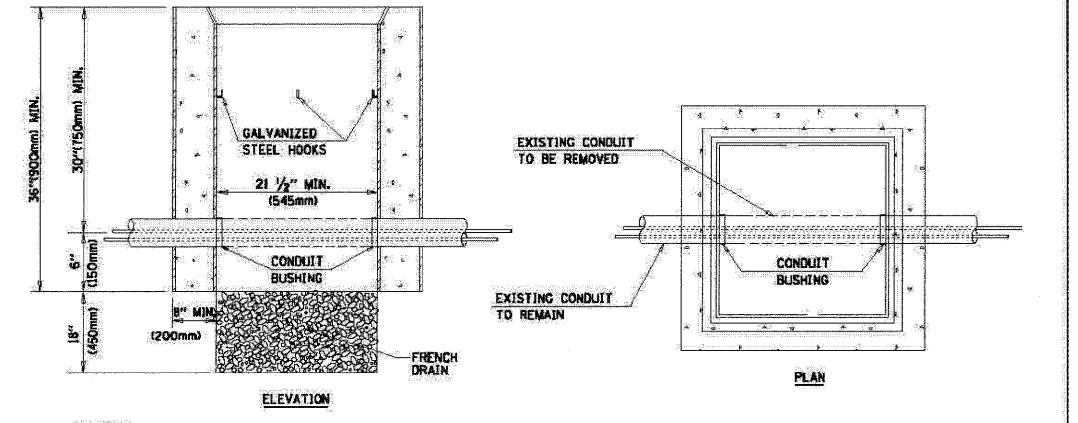



- NOTES:**
- HANDHOLE CONSTRUCTED PER STATE STANDARD 814001.
 - REMOVAL OF THE EXISTING CONDUIT FROM THE HANDHOLE AND THE INSTALLATION OF THE CONDUIT BUSHINGS SHALL BE INCIDENTAL TO THE HANDHOLE.

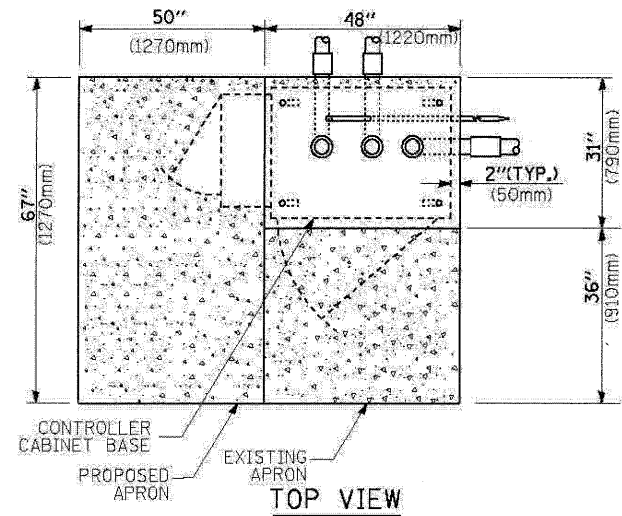

**TYPE D
FOR GROUND MOUNTED
CONTROLLER CABINET
AND UPS BATTERY CABINET**

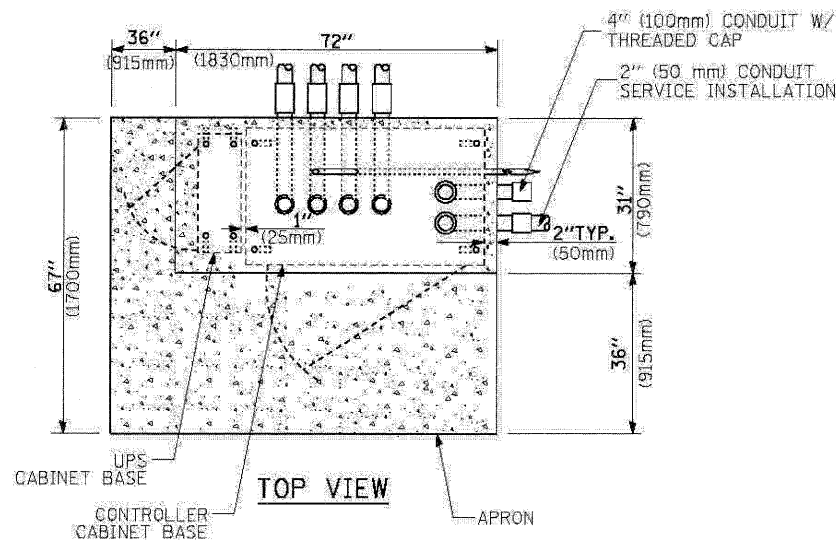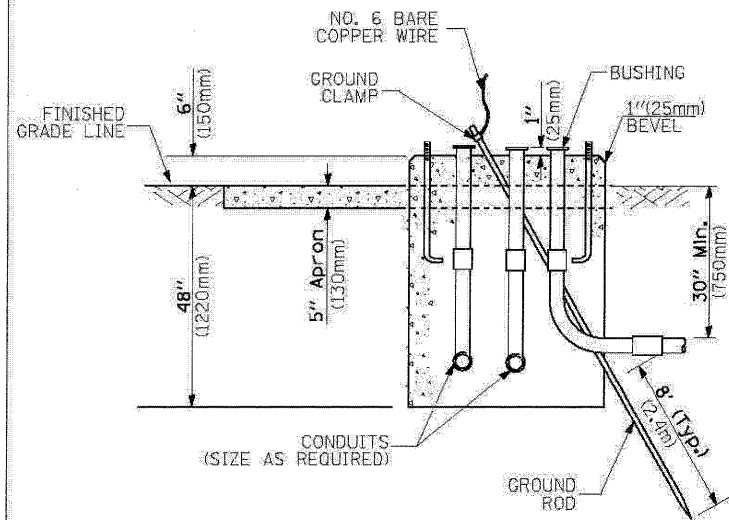

**TYPE C
FOR GROUND MOUNTED
CONTROLLER CABINET
AND UPS BATTERY CABINET**

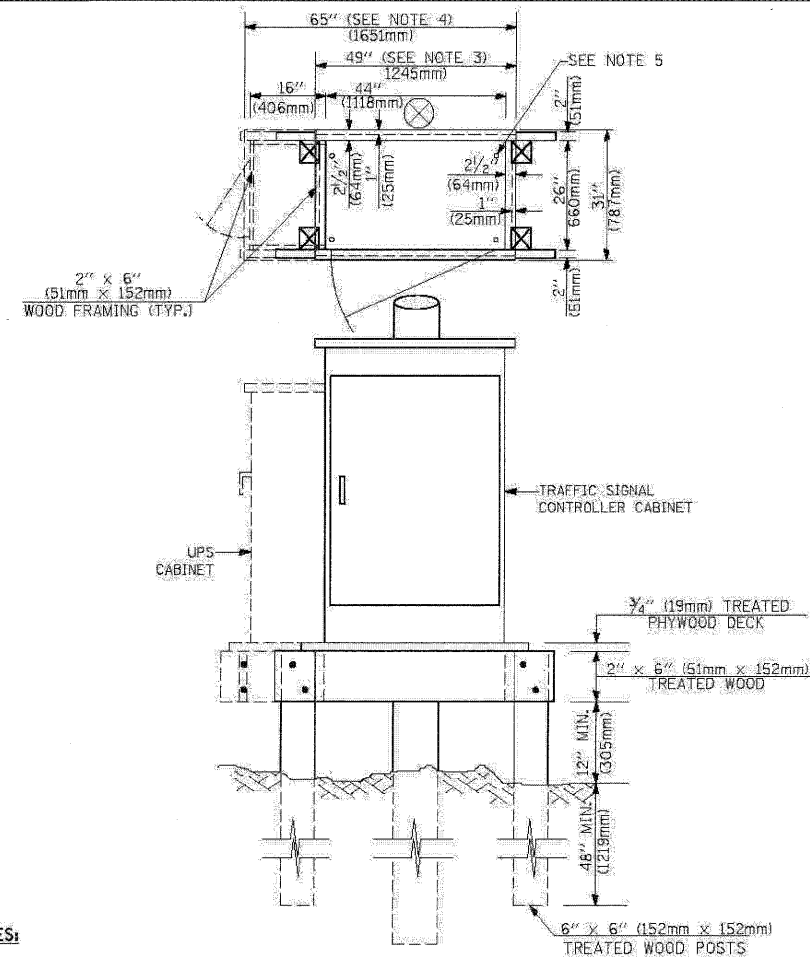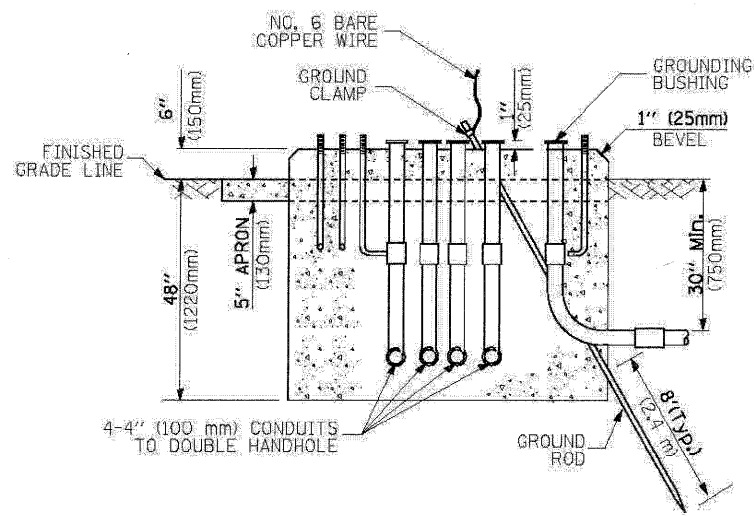

NOTES:

1. BASED ON CONTROLLER CABINET TYPE IV WITH BASE DIMENSIONS OF 26" x 44" (660mm x 1118mm). ADJUST PLATFORM SIZE TO FIT CABINET BASE DIMENSIONS BEING SUPPLIED.
2. BASED ON UNINTERRUPTIBLE POWER SUPPLY CABINET WITH BASE DIMENSIONS OF 16" x 25" (406mm x 635mm). ADJUST PLATFORM SIZE TO FIT CABINET BASE DIMENSIONS BEING SUPPLIED.
3. PLATFORM SIZE FOR CONTROLLER CABINET TYPE IV.
4. PLATFORM SIZE FOR CONTROLLER CABINET TYPE IV AND UNINTERRUPTIBLE POWER SUPPLY CABINET.
5. DRILLED HOLES THROUGH THE PLATFORM BASE TO MATCH THE CONTROLLER CABINET BOLT TEMPLATE. FASTEN THE CONTROLLER CABINET TO THE PLATFORM WITH CARRIAGE BOLTS, WASHERS AND NUTS.
6. FASTEN ALL SUPPORT WOOD FRAMING TO THE WOOD POSTS WITH 2 LAG SCREWS FOR EACH CONNECTION.

**TEMPORARY SIGNAL CONTROLLER
WOOD SUPPORT PLATFORM**

| CABLE SLACK LENGTH | FEET | METER |
|---|------|-------|
| HANDHOLE | 6.5 | 2.0 |
| DOUBLE HANDHOLE | 13.0 | 4.0 |
| SIGNAL POST | 2.0 | 0.6 |
| MAST ARM | 2.0 | 0.6 |
| CONTROLLER CABINET | 1.5 | 0.5 |
| FIBER OPTIC AT CABINET | 13.0 | 4.0 |
| ELECTRIC SERVICE AT (CABINET OR SERVICE LOCATION) | 1.5 | 0.5 |
| GROUND CABLE (SIGNAL POST, MAST ARM, CABINET) | 1.5 | 0.5 |
| GROUND CABLE (BETWEEN FRAME AND COVER) | 5.0 | 1.6 |

CABLE SLACK

| VERTICAL CABLE LENGTH | FEET | METER |
|---|--------|-------|
| MAST ARM POLE (MAST ARM MOUNTED SIGNAL HEAD) (L = MAST ARM LENGTH - DISTANCE TO SIGNAL HEAD FROM END OF ARM) | 20.0+L | 6.0+L |
| BRACKET MOUNTED (MAST ARM POLE OR SIGNAL POLE) | 13.0 | 4.0 |
| PEDESTRIAN PUSH BUTTON | 6.0 | 2.0 |
| SERVICE INSTALLATION POLE MOUNT TO SERVICE DROP | 13.5 | 4.1 |
| SERVICE INSTALLATION POLE MOUNT TO GROUND | 13.5 | 4.1 |
| SERVICE INSTALLATION GROUND MOUNT | 6.0 | 2.0 |
| FOUNDATION (SIGNAL POST, MAST ARM POLE, CONTROLLER CABINET, SERVICE-GROUND MOUNT) | 3.0 | 1.0 |

VERTICAL CABLE LENGTH

| FOUNDATION | DEPTH |
|---|--------------|
| TYPE A - Signal Post | 4'-0" (1.2m) |
| TYPE C - CONTROLLER W/ UPS | 4'-0" (1.2m) |
| TYPE D - CONTROLLER | 4'-0" (1.2m) |
| SERVICE INSTALLATION, GROUND MOUNT, TYPE A - SQUARE | 4'-0" (1.2m) |

DEPTH OF FOUNDATION

| Mast Arm Length | ① Foundation Depth | Foundation Diameter | Spiral Diameter | Quantity of Rebars | Size of Rebars |
|--|--------------------|---------------------|-----------------|--------------------|----------------|
| Less than 30' (9.1 m) | 10'-0" (3.0 m) | 30" (750mm) | 24" (600mm) | 8 | 6(19) |
| Greater than or equal to 30' (9.1 m) and less than 40' (12.2 m) | 13'-6" (4.1 m) | 30" (750mm) | 24" (600mm) | 8 | 6(19) |
| Greater than or equal to 40' (12.2 m) and less than 50' (15.2 m) | 11'-0" (3.4 m) | 36" (900mm) | 30" (750mm) | 12 | 7(22) |
| Greater than or equal to 50' (15.2 m) and up to 55' (16.8 m) | 13'-0" (4.0 m) | 36" (900mm) | 30" (750mm) | 12 | 7(22) |
| Greater than or equal to 55' (16.8 m) and less than 65' (19.8 m) | 15'-0" (4.6 m) | 36" (900mm) | 30" (750mm) | 12 | 7(22) |
| Greater than or equal to 65' (19.8 m) and up to 75' (22.9 m) | 21'-0" (6.4 m) | 42" (1060mm) | 36" (900mm) | 16 | 8(25) |
| Greater than or equal to 75' (22.9 m) | 25'-0" (7.6 m) | 42" (1060mm) | 36" (900mm) | 16 | 8(25) |

NOTES:

1. These foundation depths are for sites which have cohesive soils (clayey silt, sandy clay, etc.) along the length of the shaft, with an average Unconfined Compressive Strength (Qu) > 1.0 tsf (100 kpa). This strength shall be verified by boring data prior to construction or with testing by the Engineer during foundation drilling. The Bureau of Bridges & Structures should be contacted for a revised design if other conditions are encountered.
2. Combination mast arm assemblies under 55 feet (16.8 m) shall use 36" (900 mm) diameter foundations.
3. Combination mast arm assemblies under 56 feet (16.8 m) through 75 feet (22.9 m) shall use 42" (1060 mm) diameter foundations.
4. For mast arm assemblies with dual arms refer to state standard 878001.

DEPTH OF MAST ARM FOUNDATIONS, TYPE E

TRAFFIC SIGNAL LEGEND

| ITEM | REMOVAL | EXISTING | PROPOSED | ITEM | REMOVAL | EXISTING | PROPOSED | ITEM | REMOVAL | EXISTING | PROPOSED |
|---|---------|----------|----------|---|---------|----------|----------|--|---------|----------|----------|
| CONTROLLER CABINET | | | | EMERGENCY VEHICLE LIGHT DETECTOR | | | | ELECTRICAL CABLE IN CONDUIT, TRACER, NO. 14 1/C. UNLESS NOTED OTHERWISE | | | |
| RAILROAD CONTROL CABINET | | | | CONFIRMATION BEACON | | | | COAXIAL CABLE | | | |
| COMMUNICATIONS CABINET | | | | HANDHOLE | | | | VENDOR CABLE FOR CAMERA | | | |
| MASTER CONTROLLER | | | | HEAVY DUTY HANDHOLE | | | | COPPER INTERCONNECT CABLE, NO. 18 3 PAIR TWISTED, SHIELDED | | | |
| MASTER MASTER CONTROLLER | | | | DOUBLE HANDHOLE | | | | FIBER OPTIC CABLE NO. 62.5/125, MM12F | | | |
| UNINTERRUPTIBLE POWER SUPPLY | | | | JUNCTION BOX | | | | FIBER OPTIC CABLE NO. 62.5/125, MM12F SM12F | | | |
| SERVICE INSTALLATION, (P) POLE OR (G) GROUND MOUNT | | | | GALVANIZED STEEL CONDUIT IN TRENCH (T) OR PUSHED (P) | | | | FIBER OPTIC CABLE NO. 62.5/125, (NUMBER OF FIBERS & TYPE TO BE NOTED ON PLANS) | | | |
| TELEPHONE CONNECTION (P) POLE OF (G) GROUND MOUNT | | | | TEMPORARY SPAN WIRE, TETHER WIRE, AND CABLE | | | | GROUND ROD AT (C) CONTROLLER, (H) HANDHOLE, (P) POST, (M) MAST ARM, OR (S) SERVICE | | | |
| STEEL MAST ARM ASSEMBLY AND POLE | | | | COMMON TRENCH | | | | CONTROLLER CABINET AND FOUNDATION TO BE REMOVE | | | |
| ALUMINUM MAST ARM ASSEMBLY AND POLE | | | | COILABLE NONMETALLIC CONDUIT (EMPTY) | | | | STEEL MAST ARM POLE AND FOUNDATION TO BE REMOVE | | | |
| STEEL COMBINATION MAST ARM ASSEMBLY AND POLE WITH LUMINAIRE | | | | SYSTEM ITEM | | | | ALUMINUM MAST ARM POLE AND FOUNDATION TO BE REMOVE | | | |
| STEEL COMBINATION MAST ARM ASSEMBLY AND POLE WITH PTZ CAMERA | | | | INTERSECTION ITEM | | | | STEEL COMBINATION MAST ARM ASSEMBLY AND POLE WITH LUMINAIRE AND FOUNDATION TO BE REMOVE | | | |
| SIGNAL POST | | | | REMOVE ITEM | | | | SIGNAL POST AND FOUNDATION TO BE REMOVE | | | |
| TEMPORARY WOOD POLE (CLASS 5 OR BETTER) 45 FOOT (13.7m) MINIMUM | | | | ABANDON ITEM | | | | INTERSECTION & SAMPLING (SYSTEM) DETECTOR | | | |
| GUY WIRE | | | | 12" (300mm) TRAFFIC SIGNAL SECTION | | | | SAMPLING SYSTEM DETECTOR | | | |
| SIGNAL HEAD | | | | 12" (300mm) RED WITH 8" (200mm) YELLOW AND GREEN TRAFFIC SIGNAL FACE | | | | EXISTING INTERSECTION LOOP DETECTOR PROPOSED INTERSECTION AND SAMPLING (SYSTEM) DETECTOR | | | |
| SIGNAL HEAD CONSTRUCTION STAGES (NUMBERS INDICATE THE CONSTRUCTION STAGE) | | | | SIGNAL FACE | | | | EXISTING PREFORMED INTERSECTION LOOP DETECTOR PROPOSED INTERSECTION AND SAMPLING (SYSTEM) DETECTOR | | | |
| SIGNAL HEAD WITH BACKPLATE | | | | SIGNAL FACE WITH BACKPLATE. *P* INDICATES PROGRAMMED HEAD | | | | PREFORMED INTERSECTION AND SAMPLING (SYSTEM) DETECTOR | | | |
| SIGNAL HEAD OPTICALLY PROGRAMMED | | | | 12" (300mm) PEDESTRIAN SIGNAL HEAD WALK/DON'T WALK SYMBOL | | | | PREFORMED SAMPLING (SYSTEM) DETECTOR | | | |
| FLASHER INSTALLATION (S DENOTES SOLAR POWER) | | | | 12" (300mm) PEDESTRIAN SIGNAL HEAD INTERNATIONAL SYMBOL, OUTLINED | | | | <h2 style="margin: 0;">RAILROAD SYMBOLS</h2> | | | |
| PEDESTRIAN SIGNAL HEAD | | | | 12" (300mm) PEDESTRIAN SIGNAL HEAD INTERNATIONAL SYMBOL, SOLID | | | | | | | |
| PEDESTRIAN PUSHBUTTON DETECTOR | | | | PEDESTRIAN SIGNAL HEAD, INTERNATIONAL SYMBOL, WITH COUNTDOWN TIMER | | | | RAILROAD CONTROL CABINET | | | |
| ACCESSIBLE PEDESTRIAN PUSHBUTTON DETECTOR | | | | RADIO INTERCONNECT | | | | RAILROAD CANTILEVER MAST ARM | | | |
| ILLUMINATED SIGN "NO LEFT TURN" | | | | RADIO REPEATER | | | | FLASHING SIGNAL | | | |
| ILLUMINATED SIGN "NO RIGHT TURN" | | | | DENOTES NUMBER OF CONDUCTORS, ELECTRIC CABLE NO. 14, UNLESS NOTED OTHERWISE, ALL DETECTOR LOOP CABLE TO BE SHIELDED | | | | CROSSING GATE | | | |
| DETECTOR LOOP, TYPE I | | | | GROUND CABLE IN CONDUIT NO. 6 SOLID COPPER (GREEN) | | | | CROSSBUCK | | | |
| PREFORMED DETECTOR LOOP | | | | | | | | | | | |
| MICROWAVE VEHICLE SENSOR | | | | | | | | | | | |
| VIDEO DETECTION CAMERA | | | | | | | | | | | |
| VIDEO DETECTION ZONE | | | | | | | | | | | |
| PAN, TILT, ZOOM CAMERA | | | | | | | | | | | |
| WIRELESS DETECTOR SENSOR | | | | | | | | | | | |
| WIRELESS ACCESS POINT | | | | | | | | | | | |

NOTES FOR TEMPORARY TRAFFIC SIGNALS

1. ALL CONTROL EQUIPMENT INCLUDING EMERGENCY PRE-EMPTION AND COMMUNICATION DEVICES FOR THE TEMPORARY TRAFFIC SIGNAL(S) SHALL BE FURNISHED BY THE CONTRACTOR.
2. ONLY CONTROLLERS SUPPLIED BY ONE OF THE DISTRICT APPROVED CLOSED LOOP EQUIPMENT MANUFACTURERS WILL BE APPROVED FOR USE AT TEMPORARY SIGNAL LOCATIONS. ALL CONTROLLERS USED FOR TEMPORARY TRAFFIC SIGNALS SHALL BE FULLY ACTUATED NEMA MICROPROCESSOR BASED WITH RS232 DATA ENTRY PORTS COMPATIBLE WITH EXISTING MONITORING SOFTWARE APPROVED BY IDOT DISTRICT 1, INSTALLED IN A NEMA TS2 CABINET. ONLY ONE BRAND OF CONTROLLER WILL BE ACCEPTED FOR ANY ONE CONTRACT.
3. ALL TRAFFIC SIGNAL SECTIONS AND PEDESTRIAN SIGNAL SECTIONS SHALL BE LED AND 12" (300mm) DIAMETER. HEADS SHALL BE PLACED AS INDICATED ON THE TEMPORARY TRAFFIC SIGNAL PLAN OR AS DIRECTED BY THE ENGINEER. PEDESTRIAN SIGNALS SHALL INCLUDE SOLID INTERNATIONAL SYMBOLS. PEDESTRIAN SIGNALS WITH COUNTDOWN TIMERS SHALL BE USED WHEN THE EXISTING INSTALLATION UTILIZES COUNTDOWN TYPE OR AS DIRECTED BY THE ENGINEER. COUNTDOWN TYPE PEDESTRIAN SIGNALS ARE NOT TO BE INSTALLED AT A RAILROAD INTERSECTION. THE CONTRACTOR SHALL FURNISH ENOUGH CABLE SLACK TO RELOCATE HEADS TO ANY POSITION ON THE SPAN WIRE OR AT LOCATIONS ILLUSTRATED ON THE PLANS FOR CONSTRUCTION STAGING. THE TEMPORARY TRAFFIC SIGNAL SHALL REMAIN IN OPERATION DURING ALL SIGNAL HEAD RELOCATIONS. EACH TEMPORARY TRAFFIC SIGNAL HEAD SHALL HAVE ITS OWN CABLE FROM THE CONTROLLER CABINET TO THE SIGNAL HEAD.
4. ALL EXISTING STREET NAME AND INTERSECTION REGULATORY SIGNS SHALL BE REMOVED FROM EXISTING POLES, RELOCATED AND SECURELY FASTENED TO THE SPAN WIRE OR WOOD POLE AS DIRECTED BY THE ENGINEER.
5. ANY TEMPORARY SIGNAL WITHIN AN EXISTING CLOSED LOOP TRAFFIC SIGNAL SYSTEM SHALL BE INTERCONNECTED TO THAT SYSTEM USING SIMILAR BRAND CONTROL EQUIPMENT.
6. THE TEMPORARY TRAFFIC SIGNAL SHALL HAVE THE SIGNAL HEAD DISPLAYS, SIGNAL HEAD PLACEMENTS AND CONTROLLER PHASING MATCH THE EXISTING TRAFFIC SIGNAL, AT THE TIME OF THE TURN ON, IF NO TRAFFIC STAGING IS IN PLACE OR WILL NOT BE STAGED ON THE DAY OF THE TURN ON.
7. UNINTERRUPTIBLE POWER SUPPLY (UPS) SYSTEMS SHALL BE INSTALLED AND MADE OPERATIONAL AT TEMPORARY TRAFFIC SIGNAL INSTALLATIONS WHERE UPS IS INSTALLED AT THE EXISTING TRAFFIC SIGNAL, TEMPORARY TRAFFIC SIGNALS AT RAILROAD INTERSECTIONS, AND TEMPORARY TRAFFIC SIGNALS AT INTERSECTIONS WITH FIRE STATION ACTUATED EMERGENCY VEHICLE PRE-EMPTION, OR WHEN INDICATED ON THE PLANS.
8. TRAFFIC SIGNAL MANAGEMENT SYSTEMS SHALL BE MAINTAINED IN OPERATION AS INDICATED ON THE PLANS OR AS DIRECTED BY THE ENGINEER. REQUIRED EQUIPMENT SHALL BE AS SHOWN ON THE PLANS AND THE CONTRACTOR SHALL PLACE THE EQUIPMENT IN OPERATION TO THE SATISFACTION OF THE ENGINEER AND THE AGENCY RESPONSIBLE FOR THE TRAFFIC SIGNAL MANAGEMENT SYSTEM.
9. DETECTION AT TEMPORARY TRAFFIC SIGNALS SHALL BE INCLUDED FOR ALL APPROACHES OF THE INTERSECTION UNLESS INDICATED OTHERWISE ON THE PLANS. THE DETECTION SYSTEM MUST MEET THE SPECIFICATIONS OF DISTRICT 1 AND THE CONTRACTOR SHALL PLACE THE DETECTORS INTO OPERATION TO THE SATISFACTION OF THE ENGINEER.
10. WHEN PAN, TILT, ZOOM CAMERAS ARE INSTALLED AT THE EXISTING INTERSECTION OR ARE CALLED FOR IN THE PLANS, THE CONTRACTOR SHALL BE RESPONSIBLE FOR INSTALLING AND MAINTAINING THE CAMERAS TO THE SATISFACTION OF THE ENGINEER AND THE AGENCY RESPONSIBLE FOR THE CAMERAS.

AFTER THE PROPOSED TRAFFIC SIGNAL IS INSTALLED AND IN OPERATION, THE FOLLOWING ITEMS SHALL BE REMOVED BY THE CONTRACTOR AND SHALL BE DISPOSED OF BY THEM OUTSIDE THE RIGHT-OF-WAY AT THEIR EXPENSE. THE SALVAGE VALUE OF THE REMOVED EQUIPMENT SHALL BE REFLECTED IN THE CONTRACTOR'S BID PRICE.

- 1 EACH CONTROLLER AND CABINET COMPLETE
- 7 EACH SIGNAL HEAD, 1-FACE, 3-SECTION, SPAN WIRE MOUNTED
- 2 EACH SIGNAL HEAD, 1-FACE, 5-SECTION, SPAN WIRE MOUNTED
- 4 EACH WOOD POLE
- 423 FOOT SPAN WIRE
- 423 FOOT TETHER WIRE
- 1 LSUM AERIAL ELECTRIC CABLES
- 3 EACH VIDEO DETECTION CAMERAS
- 1 EACH WIRELESS INTERCONNECT EQUIPMENT

THE FOLLOWING ITEMS SHALL BE RELOCATED TO THE NEW SPAN WIRE LOCATIONS AS SHOWN IN THE PLANS AFTER THE NEW WOOD POLE, SPAN WIRES, TETHER WIRES, AND ELECTRIC CABLES ARE INSTALLED.

- 2 EACH SIGNAL HEAD, 1-FACE, 3-SECTION, SPAN WIRE MOUNTED
- 2 EACH SIGNAL HEAD, 1-FACE, 5-SECTION, SPAN WIRE MOUNTED
- 1 EACH LIGHT DETECTOR WITH CONFIRMATION BEACON

THE FOLLOWING EXISTING TRAFFIC SIGNAL EQUIPMENT SHALL BE REMOVED BY THE CONTRACTOR, SHALL REMAIN THE PROPERTY OF THE AGENCY LISTED BELOW. THE CONTRACTOR SHALL SAFELY STORE AND ARRANGE FOR PICK UP OF ALL EQUIPMENT TO BE RETURNED TO THE LISTED AGENCY AS PER THE TRAFFIC SIGNAL SPECIFICATIONS.


AGENCY: VILLAGE OF ADDISON

CONTACT INFORMATION:
RUDY ESPERDO
VILLAGE OF ADDISON
ENGINEERING DEPARTMENT
PHONE: (630)693-7533

- 3 EACH LIGHT DETECTOR
- 1 EACH LIGHT DETECTOR AMPLIFIER

FOR TEMPORARY TRAFFIC SIGNAL MODIFICATION, THE FOLLOWING ITEMS SHALL BE REMOVED BY THE CONTRACTOR AND SHALL BE DISPOSED OF BY THEM OUTSIDE THE RIGHT-OF-WAY AT THEIR EXPENSE. THE SALVAGE VALUE OF THE REMOVED EQUIPMENT SHALL BE REFLECTED IN THE CONTRACTOR'S BID PRICE.

- 1 EACH WOOD POLE
- 198 FOOT SPAN WIRE
- 198 FOOT TETHER WIRE
- 1 LSUM AERIAL ELECTRIC CABLES

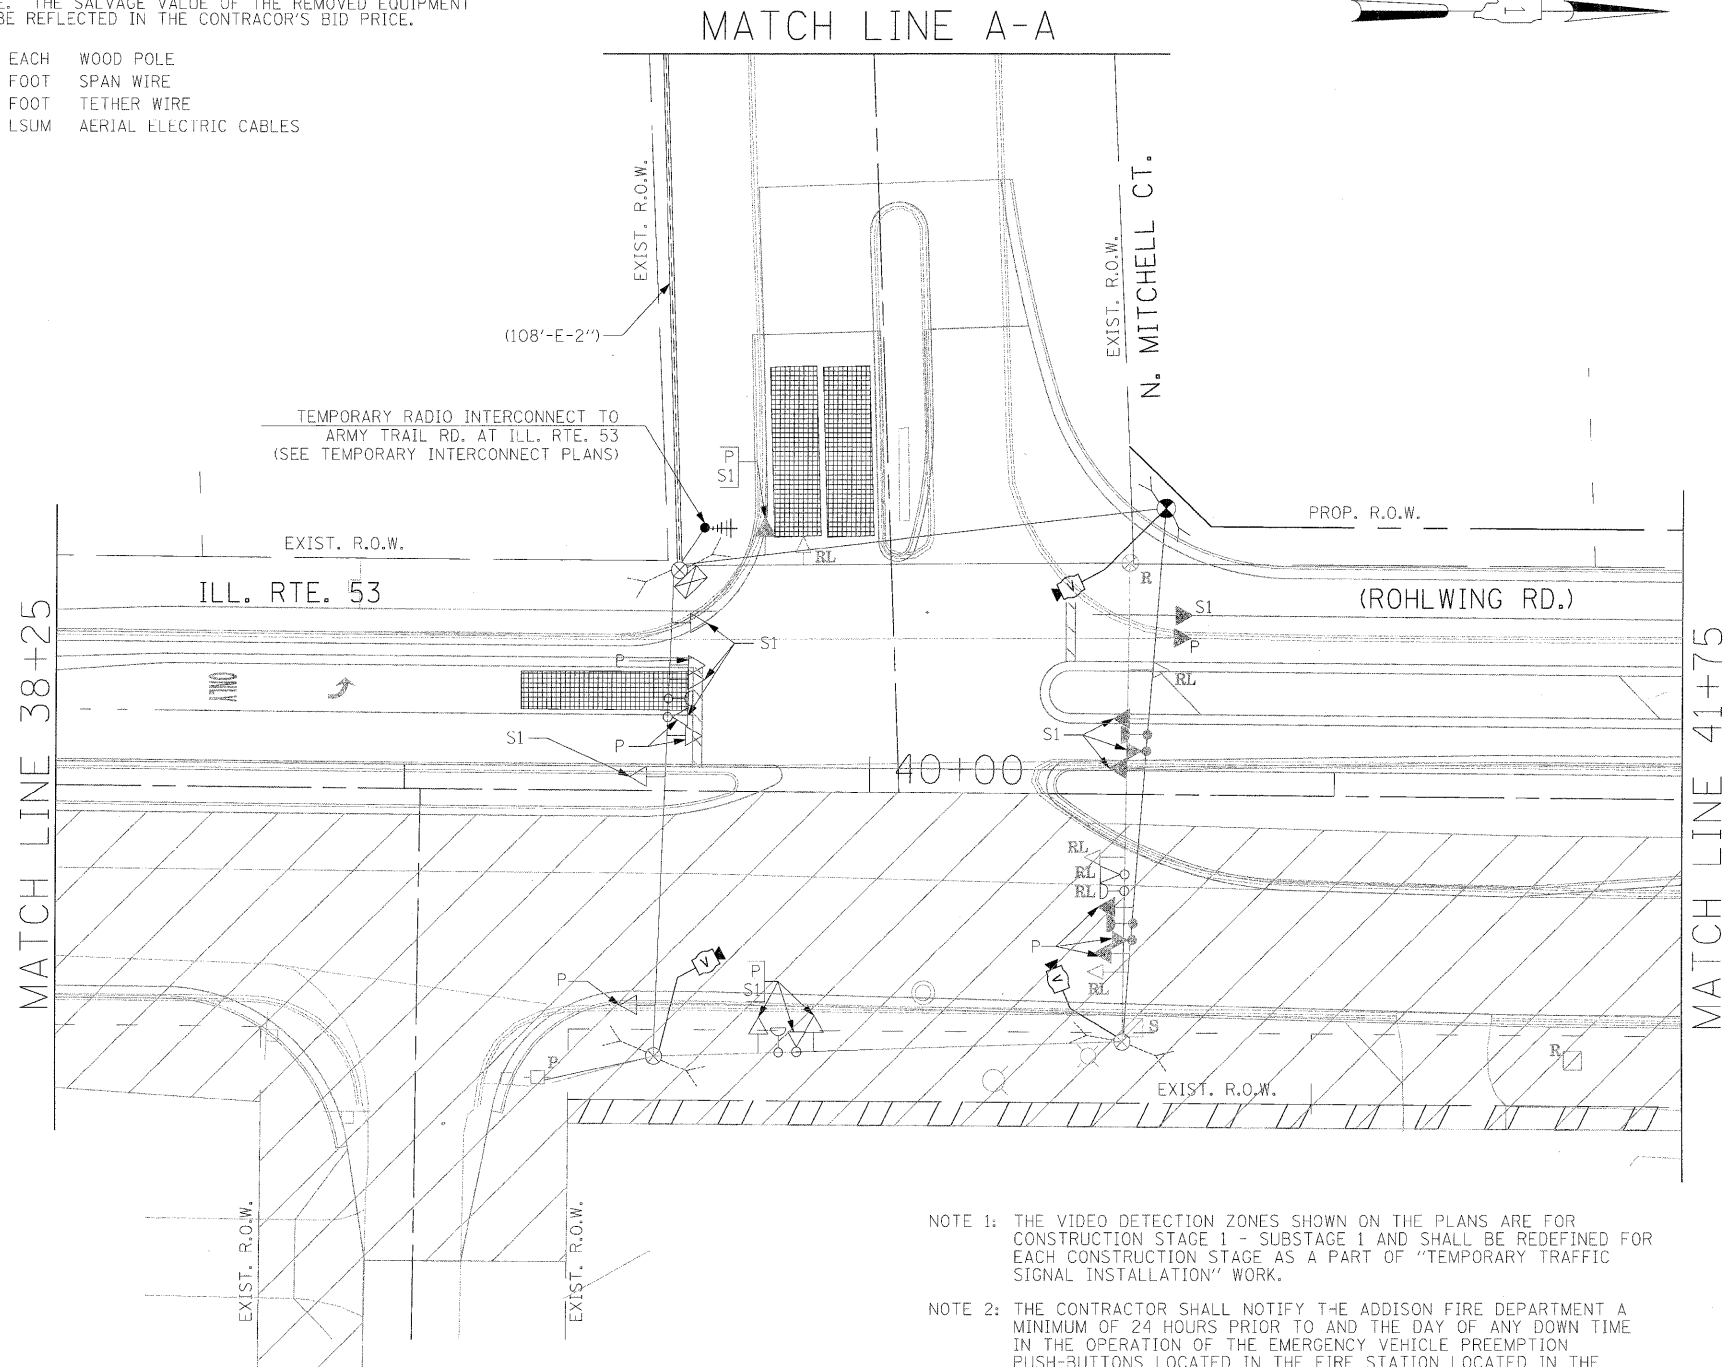

SIGNAL HEAD PLACEMENTS FOR STAGES: PRE-STAGE, AND S1




NOTE 1: THE VIDEO DETECTION ZONES SHOWN ON THE PLANS ARE FOR CONSTRUCTION STAGE 1 - SUBSTAGE 1 AND SHALL BE REDEFINED FOR EACH CONSTRUCTION STAGE AS A PART OF "TEMPORARY TRAFFIC SIGNAL INSTALLATION" WORK.

NOTE 2: THE CONTRACTOR SHALL NOTIFY THE ADDISON FIRE DEPARTMENT A MINIMUM OF 24 HOURS PRIOR TO AND THE DAY OF ANY DOWN TIME IN THE OPERATION OF THE EMERGENCY VEHICLE PREEMPTION PUSH-BUTTONS LOCATED IN THE FIRE STATION LOCATED IN THE SOUTHWEST CORNER OF THIS INTERSECTION. THE DOWN TIME SHALL NOT EXCEED 2 HOURS.

AT MITCHELL CT:
P = PRE-STAGE
S1 = STAGE 1 (NO SUBSTAGES)
S2 = STAGE 1 (NO SUBSTAGES)
S3 = STAGE 1 (NO SUBSTAGES)

THE EXISTING TEMPORARY TRAFFIC SIGNAL INSTALLATION SHALL NOT BE REMOVED UNTIL THE PROPOSED TRAFFIC SIGNAL INSTALLATION IS IN OPERATION. THE MAINTENANCE OF THE EXISTING TEMPORARY TRAFFIC SIGNAL INSTALLATION SHALL BE INCLUDED IN THE PAY ITEM "MODIFY TEMPORARY TRAFFIC SIGNAL INSTALLATION".


THE TRAFFIC SIGNAL CONTROL EQUIPMENT FOR THIS PROJECT SHALL BE "ECONOLITE" TO MATCH THE EXISTING ADJACENT SYSTEM.

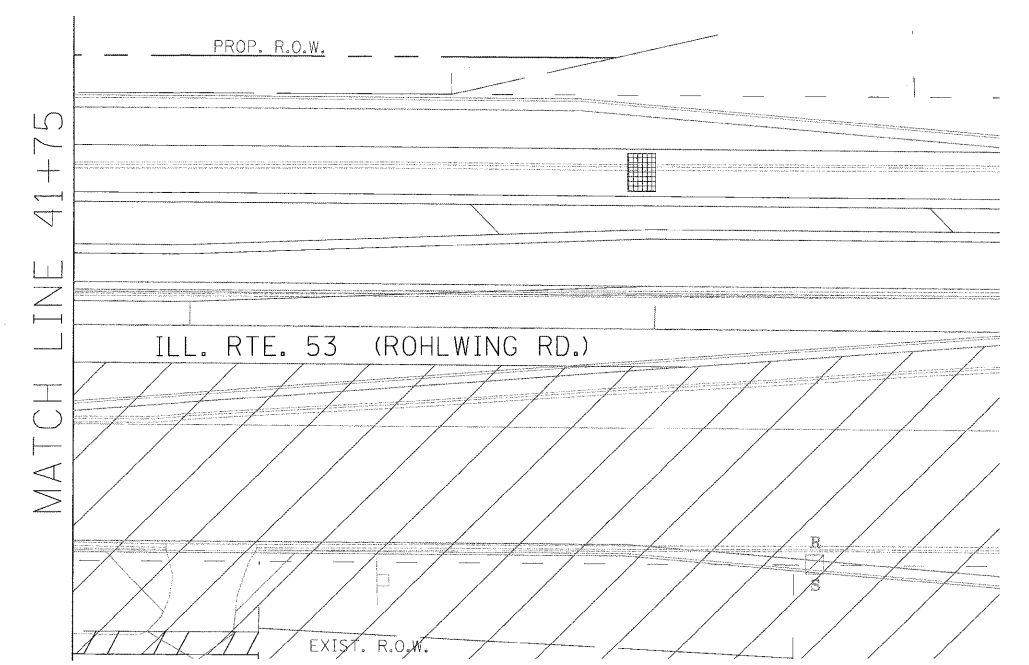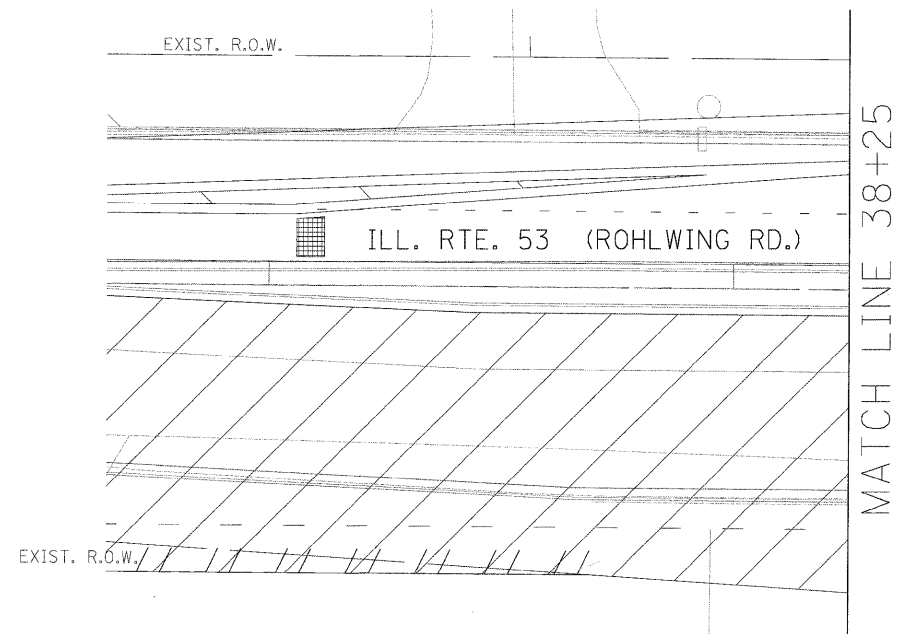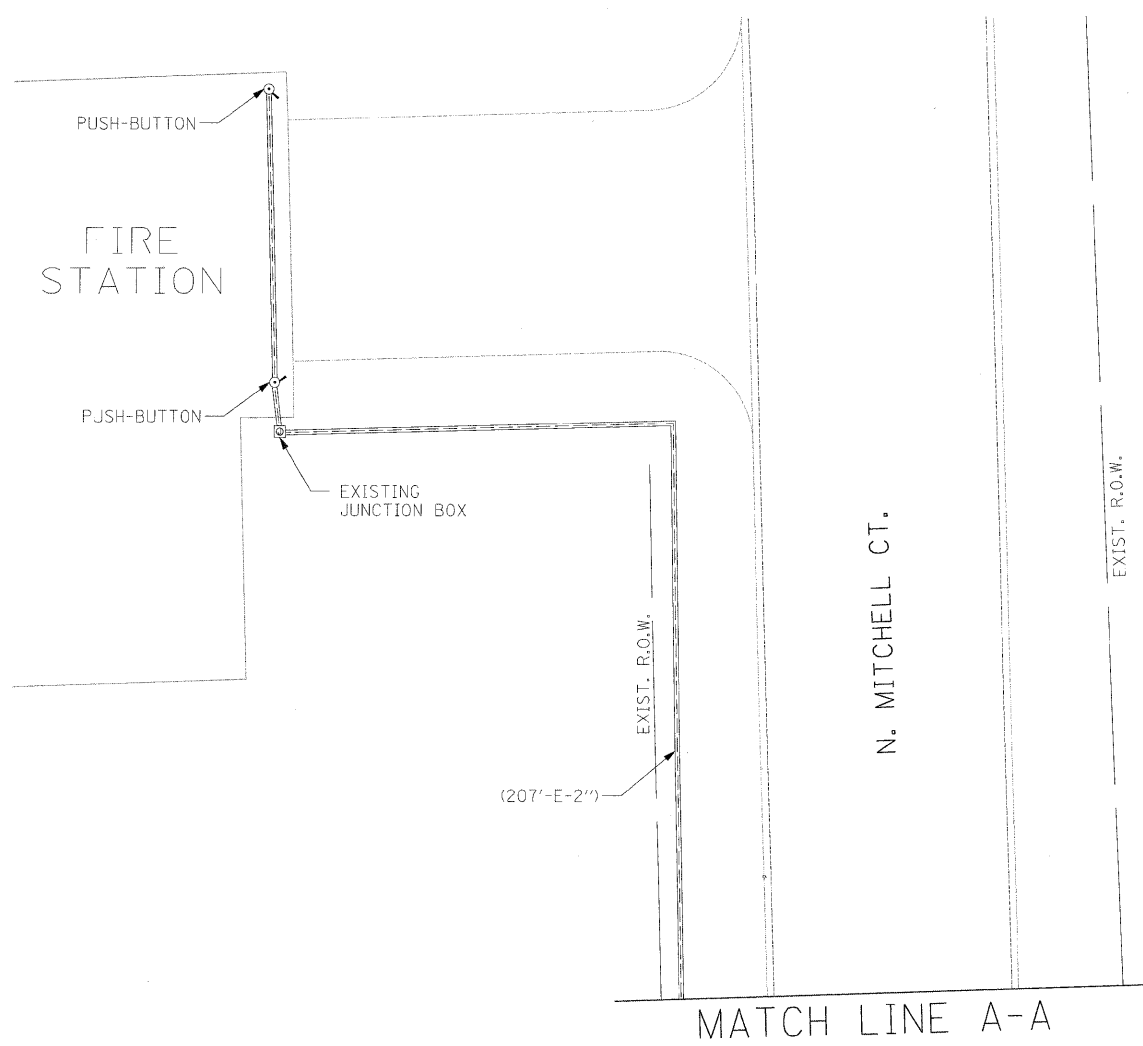

NOTE: THE VIDEO DETECTION ZONES SHOWN ON THE PLANS ARE FOR CONSTRUCTION STAGE 1 - SUBSTAGE 1 AND SHALL BE REDEFINED FOR EACH CONSTRUCTION STAGE AS A PART OF "TEMPORARY TRAFFIC SIGNAL INSTALLATION" WORK.

THE TRAFFIC SIGNAL CONTROL EQUIPMENT FOR THIS PROJECT SHALL BE "ECONOLITE" TO MATCH THE EXISTING ADJACENT SYSTEM.

| | | | | | | | | | | | |
|-------------|----------------------|-------------------|-----------|---|---|--------------------|---------|----------------------------------|--------------|---|--|
| FILE NAME = | USER NAME = #USER# | DESIGNED - PKG | REVISED - | STATE OF ILLINOIS DEPARTMENT OF TRANSPORTATION | TEMPORARY TRAFFIC SIGNAL MODIFICATION AND REMOVAL PLAN ILLINOIS ROUTE 53 (ROHLWING RD.) AT N. MITCHELL CT. PRE STAGE AND STAGE 1 (SHEET 2 OF 4). | F.A.P. RTE. | SECTION | COUNTY | TOTAL SHEETS | SHEET NO. | |
| #FILEL# | PLOT SCALE = #SCALE# | DRAWN - MAA, EA | REVISED - | | | 2578 | 532B | DuPage | 791 | 432 | |
| | PLOT DATE = #DATE# | CHECKED - PKG, EA | REVISED - | | | CONTRACT NO. 60477 | | | | | |
| | | DATE - 5/10/2010 | REVISED - | | | SCALE: 1"=20' | | SHEET NO. OF SHEETS STA. TO STA. | | FED. ROAD DIST. NO. - ILLINOIS FED. AID PROJECT | |

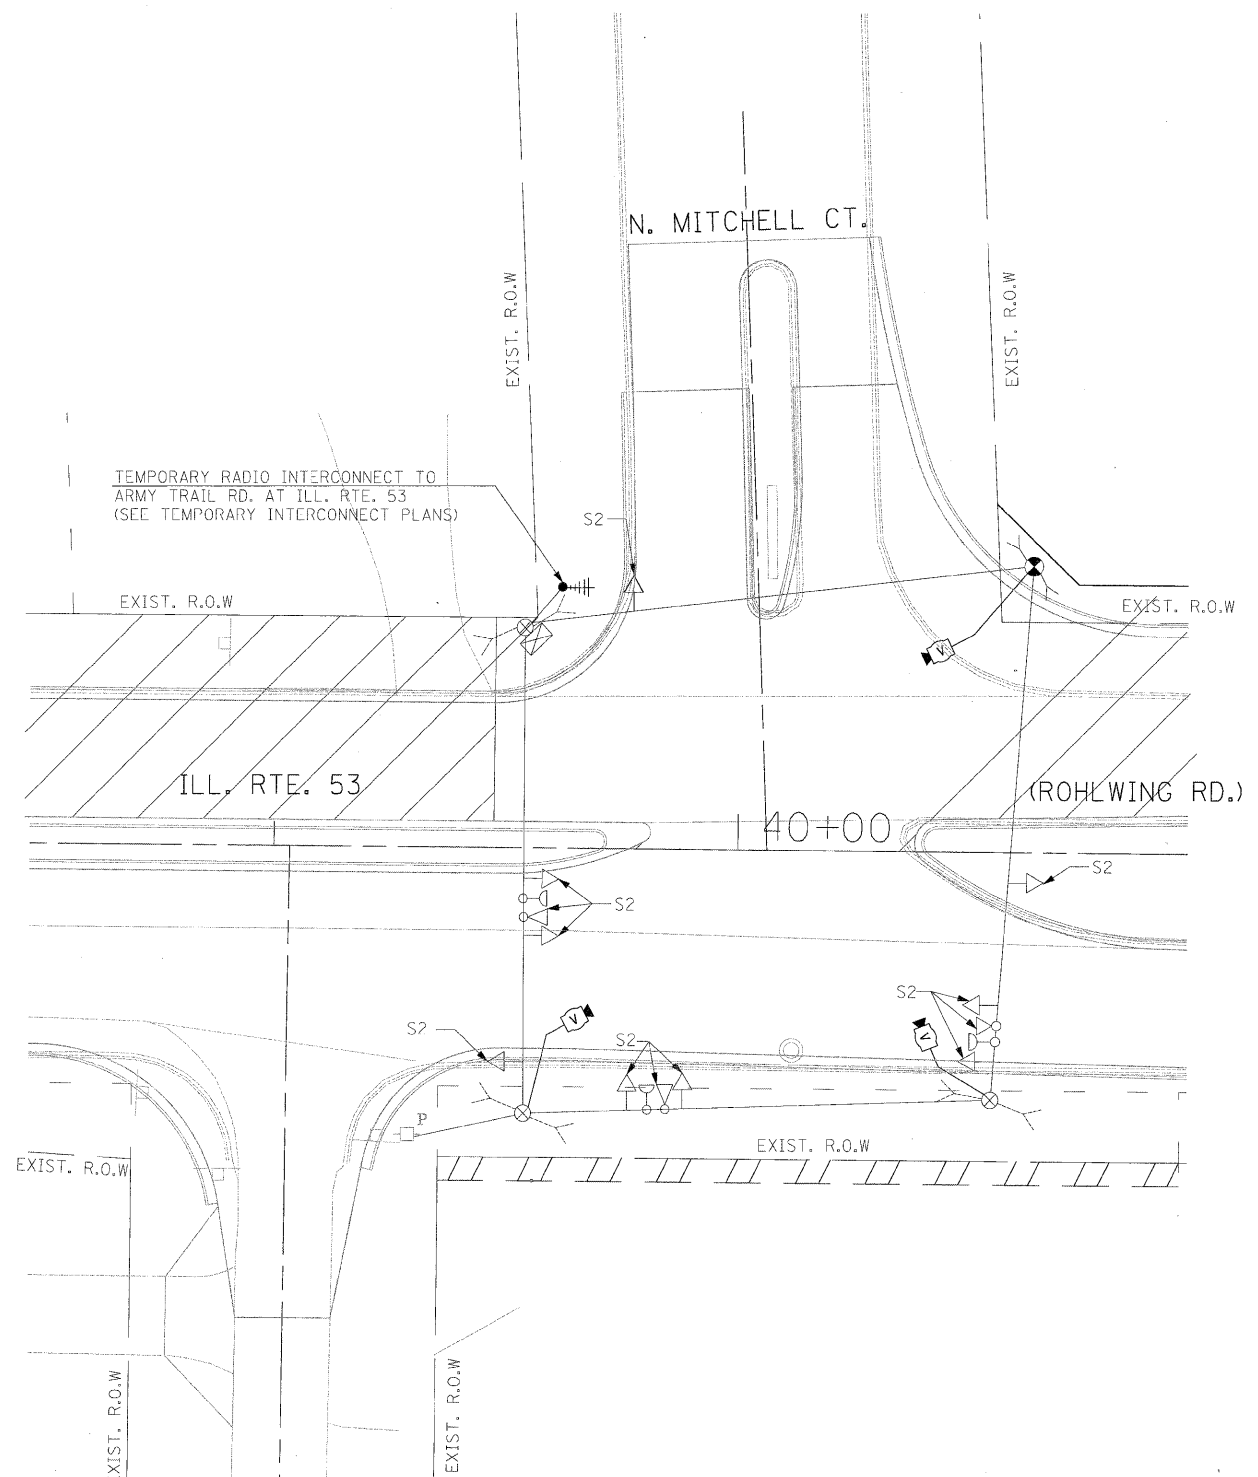


SIGNAL HEAD PLACEMENTS FOR STAGES: S2.

NOTE 1: THE VIDEO DETECTION ZONES SHOWN ON THE PLANS ARE FOR CONSTRUCTION STAGE 1 - SUBSTAGE 1 AND SHALL BE REDEFINED FOR EACH CONSTRUCTION STAGE AS A PART OF "TEMPORARY TRAFFIC SIGNAL INSTALLATION" WORK.

NOTE 2: THE SIGNAL HEAD PLACEMENT FOR N. MITCHELL COURT FOR CONSTRUCTION STAGES S2 AND S3 SHALL BE DETERMINED IN FIELD BY THE CONTRACTOR DEPENDING ON THE CONSTRUCTION STAGING USED BY THE CONTRACTOR FOR N. MITCHELL COURT.

AT MITCHELL CT:
 P = PRE-STAGE
 S1 = STAGE 1 (NO SUBSTAGES)
 S2 = STAGE 1 (NO SUBSTAGES)
 S3 = STAGE 1 (NO SUBSTAGES)

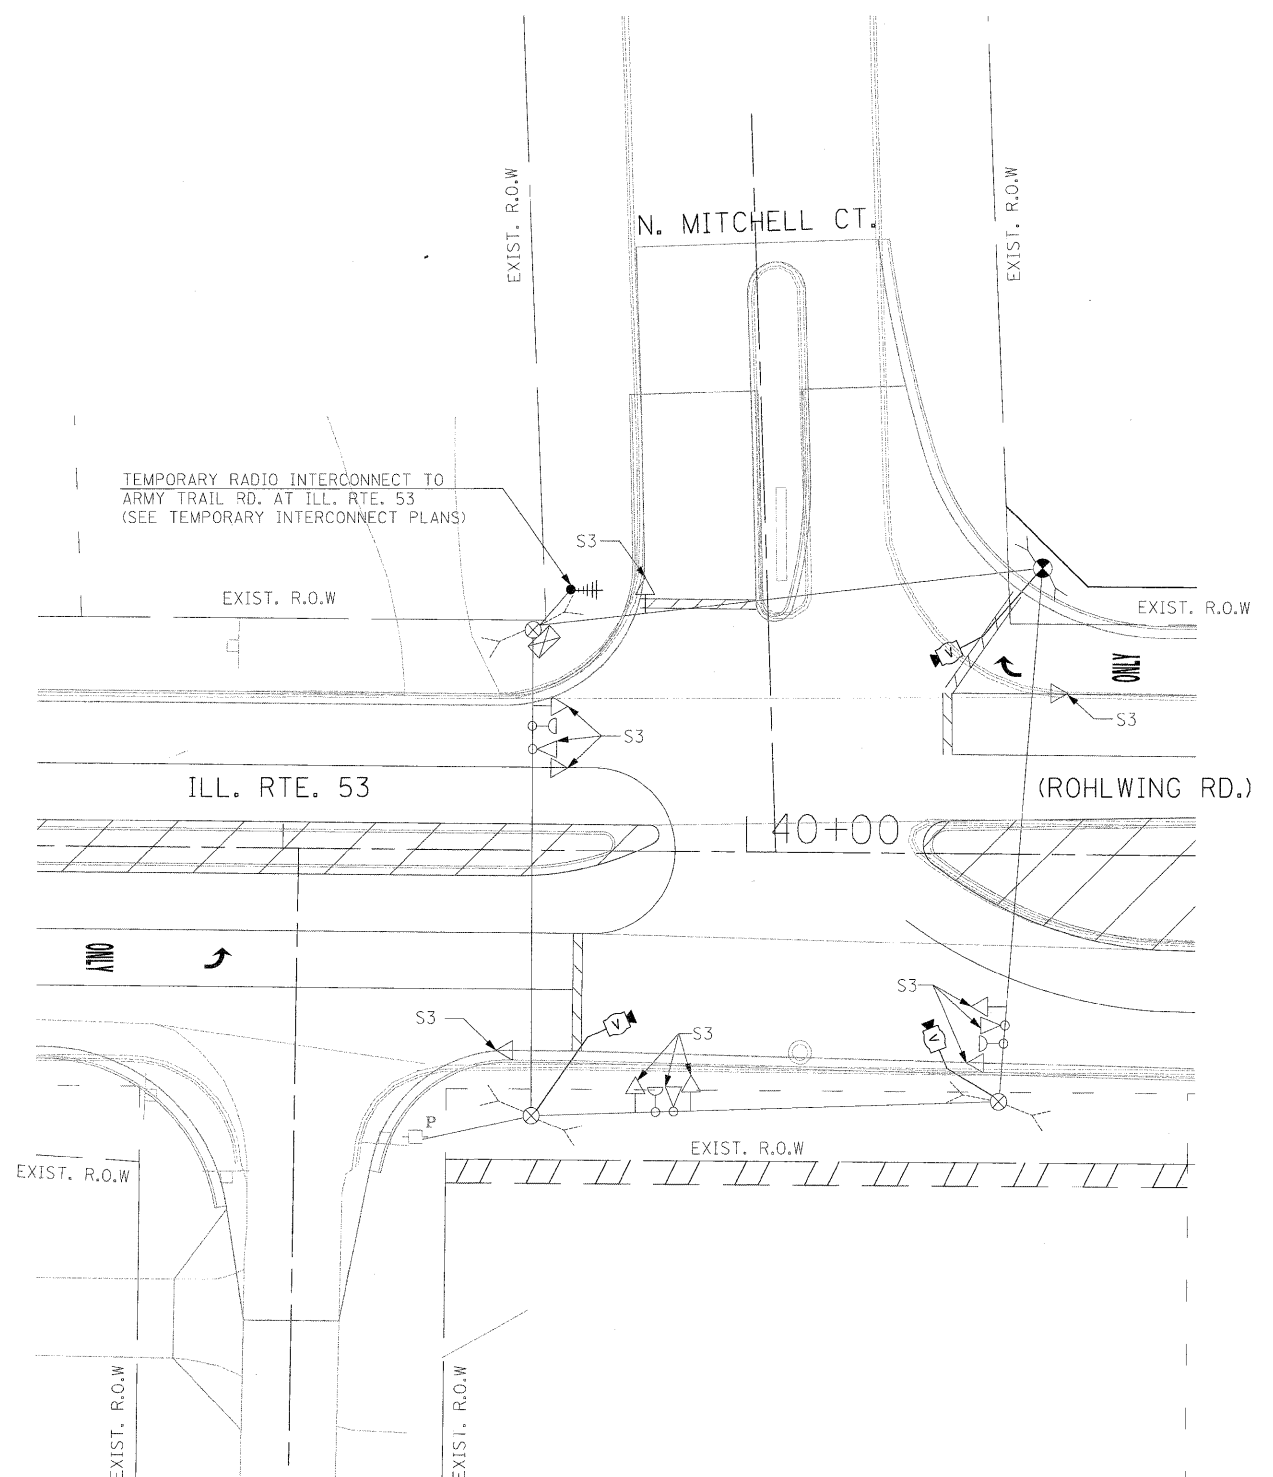


SIGNAL HEAD PLACEMENTS FOR STAGES: S3

THE TRAFFIC SIGNAL CONTROL EQUIPMENT FOR THIS PROJECT SHALL BE "ECONOLITE" TO MATCH THE EXISTING ADJACENT SYSTEM.

| | | | | | | | | | | | |
|-------------|----------------------|-------------------|-----------|---|---|---|---------|--------------|--------------|-----------|--|
| FILE NAME = | USER NAME = #USER# | DESIGNED - PKG | REVISED - | STATE OF ILLINOIS DEPARTMENT OF TRANSPORTATION | TEMPORARY TRAFFIC SIGNAL MODIFICATION AND REMOVAL PLAN ILLINOIS ROUTE 53 (ROHLWING RD.) AT N. MITCHELL CT. STAGE 2, AND STAGE 3 (SHEET 3 OF 4) | F.A.P. RTE. | SECTION | COUNTY | TOTAL SHEETS | SHEET NO. | |
| #FILE# | | DRAWN - MAA, EA | REVISED - | | | 2578 | 532B | DuPage | 781 | 433 | |
| | PLOT SCALE = #SCALE# | CHECKED - PKG, EA | REVISED - | | | CONTRACT NO. 60477 | | | | | |
| | PLOT DATE = #DATE# | DATE - 5/10/2010 | REVISED - | | | FED. ROAD DIST. NO. - ILLINOIS FED. AID PROJECT | | | | | |
| | | | | | SCALE: 1"=20' | SHEET NO. OF SHEETS | | STA. TO STA. | | | |

CONTROLLER SEQUENCE

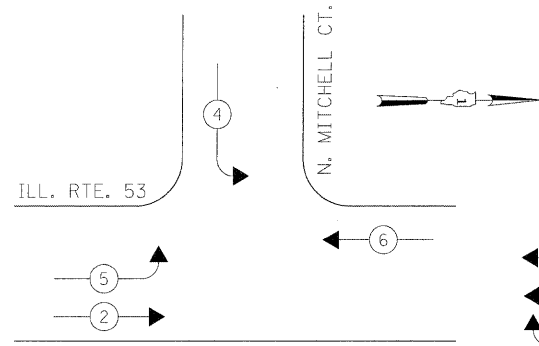


LEGEND

- ← * → DUAL ENTRY PHASE
- ← * → SINGLE ENTRY PHASE
- ◊ O.L. OVERLAP
- ← * → PEDESTRIAN PHASE
- * NUMBER REFERS TO ASSOCIATED PHASE

TEMPORARY PHASE DESIGNATION DIAGRAM


STAGES: PRE-STAGE,
S1, S2, S3, AND AFTER PROPOSED
ROADWAY GEOMETRICS ARE BUILT

TEMPORARY EMERGENCY VEHICLE PREEMPTION SEQUENCE

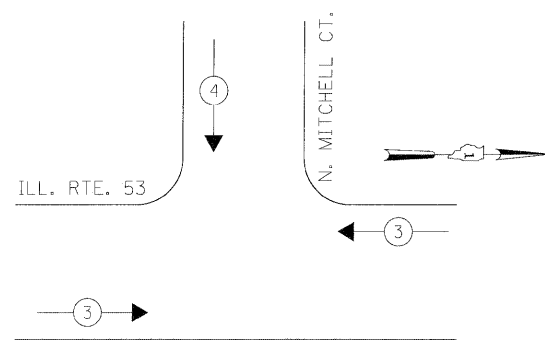

| PROPOSED EMERGENCY VEHICLE PREEMPTORS | | |
|---------------------------------------|---|---|
| EMERGENCY VEHICLE PREEMPTOR | 3 | 4 |
| MOVEMENT | ← | ↓ |

STAGES: PRE-STAGE,
S1, S2, S3, AND AFTER PROPOSED
ROADWAY GEOMETRICS ARE BUILT

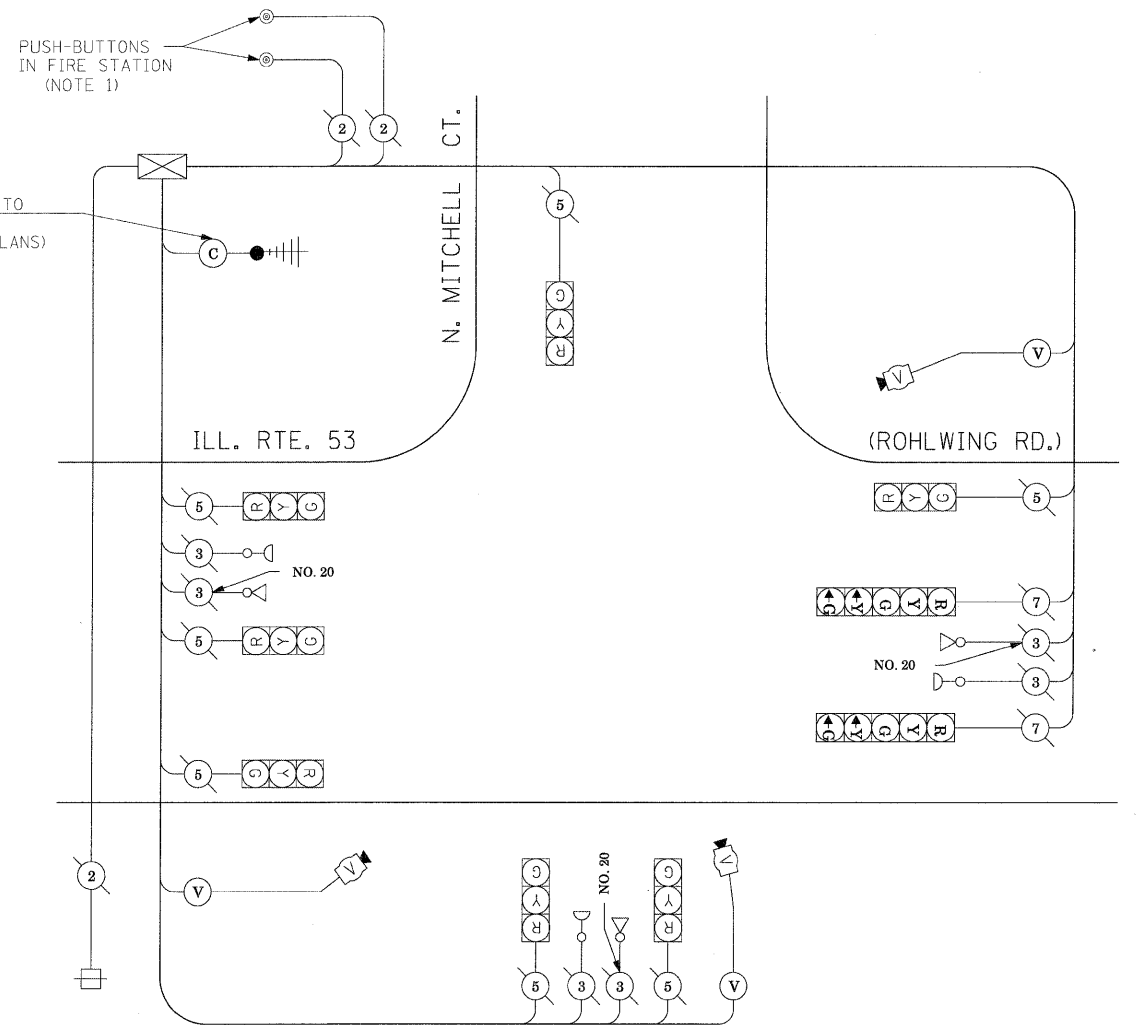

TEMPORARY CABLE PLAN

(NOT TO SCALE)

STAGES: PRE-STAGE,
S1, S2, S3, AND AFTER PROPOSED
ROADWAY GEOMETRICS ARE BUILT

NOTE 1: THE EMERGENCY VEHICLE PREEMPTION FOR THE WEST APPROACH SHALL ALSO BE ACTIVATED VIA PUSH-BUTTONS LOCATED INSIDE THE FIRE STATION PREMISES.

THE TRAFFIC SIGNAL CONTROL EQUIPMENT FOR THIS PROJECT SHALL BE "ECONOLITE" TO MATCH THE EXISTING ADJACENT SYSTEM.

| I.D.O.T. TRAFFIC SIGNAL INSTALLATION ELECTRICAL SERVICE REQUIREMENTS | | | | TOTAL WATTAGE |
|---|----------------------|-------------------|------------|---------------|
| TYPE | NO LAMPS | WATTAGE | %OPERATION | |
| | | INCAND. LED | | |
| SIGNAL (RED) | 9 | 135 17 | 0.50 | 607.5 |
| (YELLOW) | 9 | 135 25 | 0.25 | 303.75 |
| (GREEN) | 9 | 135 15 | 0.25 | 303.75 |
| ARROW | 4 | 135 12 | 0.10 | 54 |
| PED. SIGNAL | | 90 25 | 1.00 | |
| CONTROLLER | 1 | 100 100 | 1.00 | 100 |
| ILLUM. SIGN | | 25 25 | 0.05 | |
| VIDEO SYSTEM | 1 | 150 | 1.00 | 150 |
| FLASHER | | | 0.50 | |
| ENERGY COSTS TO: | | | | TOTAL = 1519 |
| ILLINOIS DEPARTMENT OF TRANSPORTATION 201 WEST CENTER COURT SCHAUMBURG, ILLINOIS 60196-1096 | | | | |
| ENERGY SUPPLY CONTACT: CURTIS TOPPS PHONE: (630) 691-4356 COMPANY: COMMONWEALTH EDISON | | | | |
| FILE NAME = | USER NAME = #USER# | DESIGNED - PKG | REVISED - | |
| #FILE# | | DRAWN - MAA, EA | REVISED - | |
| | PLOT SCALE = #SCALE# | CHECKED - PKG, EA | REVISED - | |
| | PLOT DATE = #DATE# | DATE - 5/10/2010 | REVISED - | |

STATE OF ILLINOIS
DEPARTMENT OF TRANSPORTATION

TEMPORARY CABLE PLAN, TEMPORARY PHASE DESIGNATION DIAGRAM
TEMPORARY EMERGENCY VEHICLE PREEMPTION SEQUENCE
ILLINOIS ROUTE 53 (ROHLWING RD.) AT N. MITCHELL CT.
PRE-STAGE, STAGE 1, STAGE 2, AND STAGE 3 (SHEET 4 OF 4).

| F.A.P. RTE. | SECTION | COUNTY | TOTAL SHEETS | SHEET NO. |
|--------------------|---------|--------|--------------|-----------|
| 257B | 532B | DuPage | 781 | 434 |
| CONTRACT NO. 60477 | | | | |

SCALE: NONE SHEET NO. OF SHEETS STA. TO STA.

FED. ROAD DIST. NO. - ILLINOIS FED. AID PROJECT


SCHEDULE OF QUANTITIES

| QUANTITY | UNIT | ITEM |
|----------|-------|---|
| 9 | SQ FT | SIGN PANEL - TYPE 1 |
| 21 | SQ FT | SIGN PANEL - TYPE 2 |
| 492 | FOOT | CONDUIT IN TRENCH, 2" DIA., GALVANIZED STEEL |
| 5 | FOOT | CONDUIT IN TRENCH, 2 1/2" DIA., GALVANIZED STEEL |
| 116 | FOOT | CONDUIT IN TRENCH, 3" DIA., GALVANIZED STEEL |
| 50 | FOOT | CONDUIT IN TRENCH, 4" DIA., GALVANIZED STEEL |
| 202 | FOOT | CONDUIT PUSHED, 2" DIA., GALVANIZED STEEL |
| 186 | FOOT | CONDUIT PUSHED, 4" DIA., GALVANIZED STEEL |
| 5 | EACH | HANDHOLE |
| 1 | EACH | HEAVY-DUTY HANDHOLE |
| 1 | EACH | DOUBLE HANDHOLE |
| 663 | FOOT | TRENCH AND BACKFILL FOR ELECTRICAL WORK |
| 1 | EACH | FULL-ACTUATED CONTROLLER AND TYPE IV CABINET, SPECIAL |
| 1 | EACH | TRANSCEIVER-FIBER OPTIC |
| 280 | FOOT | ELECTRIC CABLE IN CONDUIT, SIGNAL NO. 14 3C |
| 1561 | FOOT | ELECTRIC CABLE IN CONDUIT, SIGNAL NO. 14 5C |
| 440 | FOOT | ELECTRIC CABLE IN CONDUIT, SIGNAL NO. 14 7C |
| 905 | FOOT | ELECTRIC CABLE IN CONDUIT, LEAD-IN, NO. 14 1 PAIR |
| 150 | FOOT | ELECTRIC CABLE IN CONDUIT, SERVICE, NO. 6 2C |
| 1 | EACH | TRAFFIC SIGNAL POST, GALVANIZED STEEL 16 FT. |
| 1 | EACH | STEEL MAST ARM ASSEMBLY AND POLE, 28 FT. |
| 1 | EACH | STEEL MAST ARM ASSEMBLY AND POLE, 36 FT. |
| 1 | EACH | STEEL MAST ARM ASSEMBLY AND POLE, 38 FT. |
| 4 | FOOT | CONCRETE FOUNDATION, TYPE A |
| 4 | FOOT | CONCRETE FOUNDATION, TYPE C |
| 10 | FOOT | CONCRETE FOUNDATION, TYPE E 30-INCH DIAMETER |
| 30 | FOOT | CONCRETE FOUNDATION, TYPE E 36-INCH DIAMETER |
| 3 | EACH | SIGNAL HEAD, LED, 1-FACE, 3-SECTION, BRACKET MOUNTED |
| 6 | EACH | SIGNAL HEAD, LED, 1-FACE, 3-SECTION, MAST-ARM MOUNTED |
| 1 | EACH | SIGNAL HEAD, LED, 1-FACE, 5-SECTION, BRACKET MOUNTED |
| 1 | EACH | SIGNAL HEAD, LED, 1-FACE, 5-SECTION, MAST-ARM MOUNTED |
| 7 | EACH | TRAFFIC SIGNAL BACKPLATE, LOUVERED, ALUMINUM |
| 5 | EACH | INDUCTIVE LOOP DETECTOR |
| 2 | EACH | LIGHT DETECTOR |
| 1 | EACH | LIGHT DETECTOR AMPLIFIER |
| 35 | FOOT | REMOVE AND REINSTALL ELECTRIC CABLE FROM CONDUIT |
| 1 | EACH | REMOVE TEMPORARY TRAFFIC SIGNAL INSTALLATION |
| 2 | EACH | REMOVE EXISTING HANDHOLE |
| 472 | FOOT | PREFORMED DETECTOR LOOP |
| 1 | EACH | TEMPORARY TRAFFIC SIGNAL TIMING |
| 1 | EACH | SERVICE INSTALLATION - POLE MOUNTED |
| 1 | EACH | UNINTERRUPTIBLE POWER SUPPLY |
| 586 | FOOT | ELECTRIC CABLE IN CONDUIT, GROUNDING, NO. 6 1C |
| 280 | FOOT | ELECTRIC CABLE IN CONDUIT NO. 20 3/C, TWISTED, SHIELDED |
| 1 | EACH | MODIFY TEMPORARY TRAFFIC SIGNAL INSTALLATION |

100% COST TO VILLAGE OF ADDISON


| I.D.O.T. TRAFFIC SIGNAL INSTALLATION ELECTRICAL SERVICE REQUIREMENTS | | | | TOTAL WATTAGE | |
|---|-----------|---------|------------|------------------|-------|
| TYPE | NO. LAMPS | WATTAGE | %OPERATION | | |
| SIGNAL (RED) | 11 | 135 | 17 | 0.50 | 93.5 |
| | 11 | 135 | 25 | 0.25 | 68.75 |
| | 11 | 135 | 15 | 0.25 | 41.25 |
| ARROW | 4 | 135 | 12 | 0.10 | 4.8 |
| PED. SIGNAL | | 90 | 25 | 1.00 | |
| CONTROLLER | 1 | 100 | 100 | 1.00 | 100 |
| ILLUM. SIGN | | | 25 | 0.05 | |
| FLASHER | | | | 0.50 | |
| ENERGY COSTS TO: | | | | TOTAL = | 308.3 |
| ILLINOIS DEPARTMENT OF TRANSPORTATION 201 WEST CENTER COURT SCHAUMBURG, ILLINOIS 60196-1096 | | | | | |
| ENERGY SUPPLY CONTACT: CURTIS TOPPS PHONE: (630) 691-4356 COMPANY: COMMONWEALTH EDISON | | | | | |

THE TRAFFIC SIGNAL CONTROL EQUIPMENT FOR THIS PROJECT SHALL BE "ECONOLITE" TO MATCH THE EXISTING ADJACENT SYSTEM.

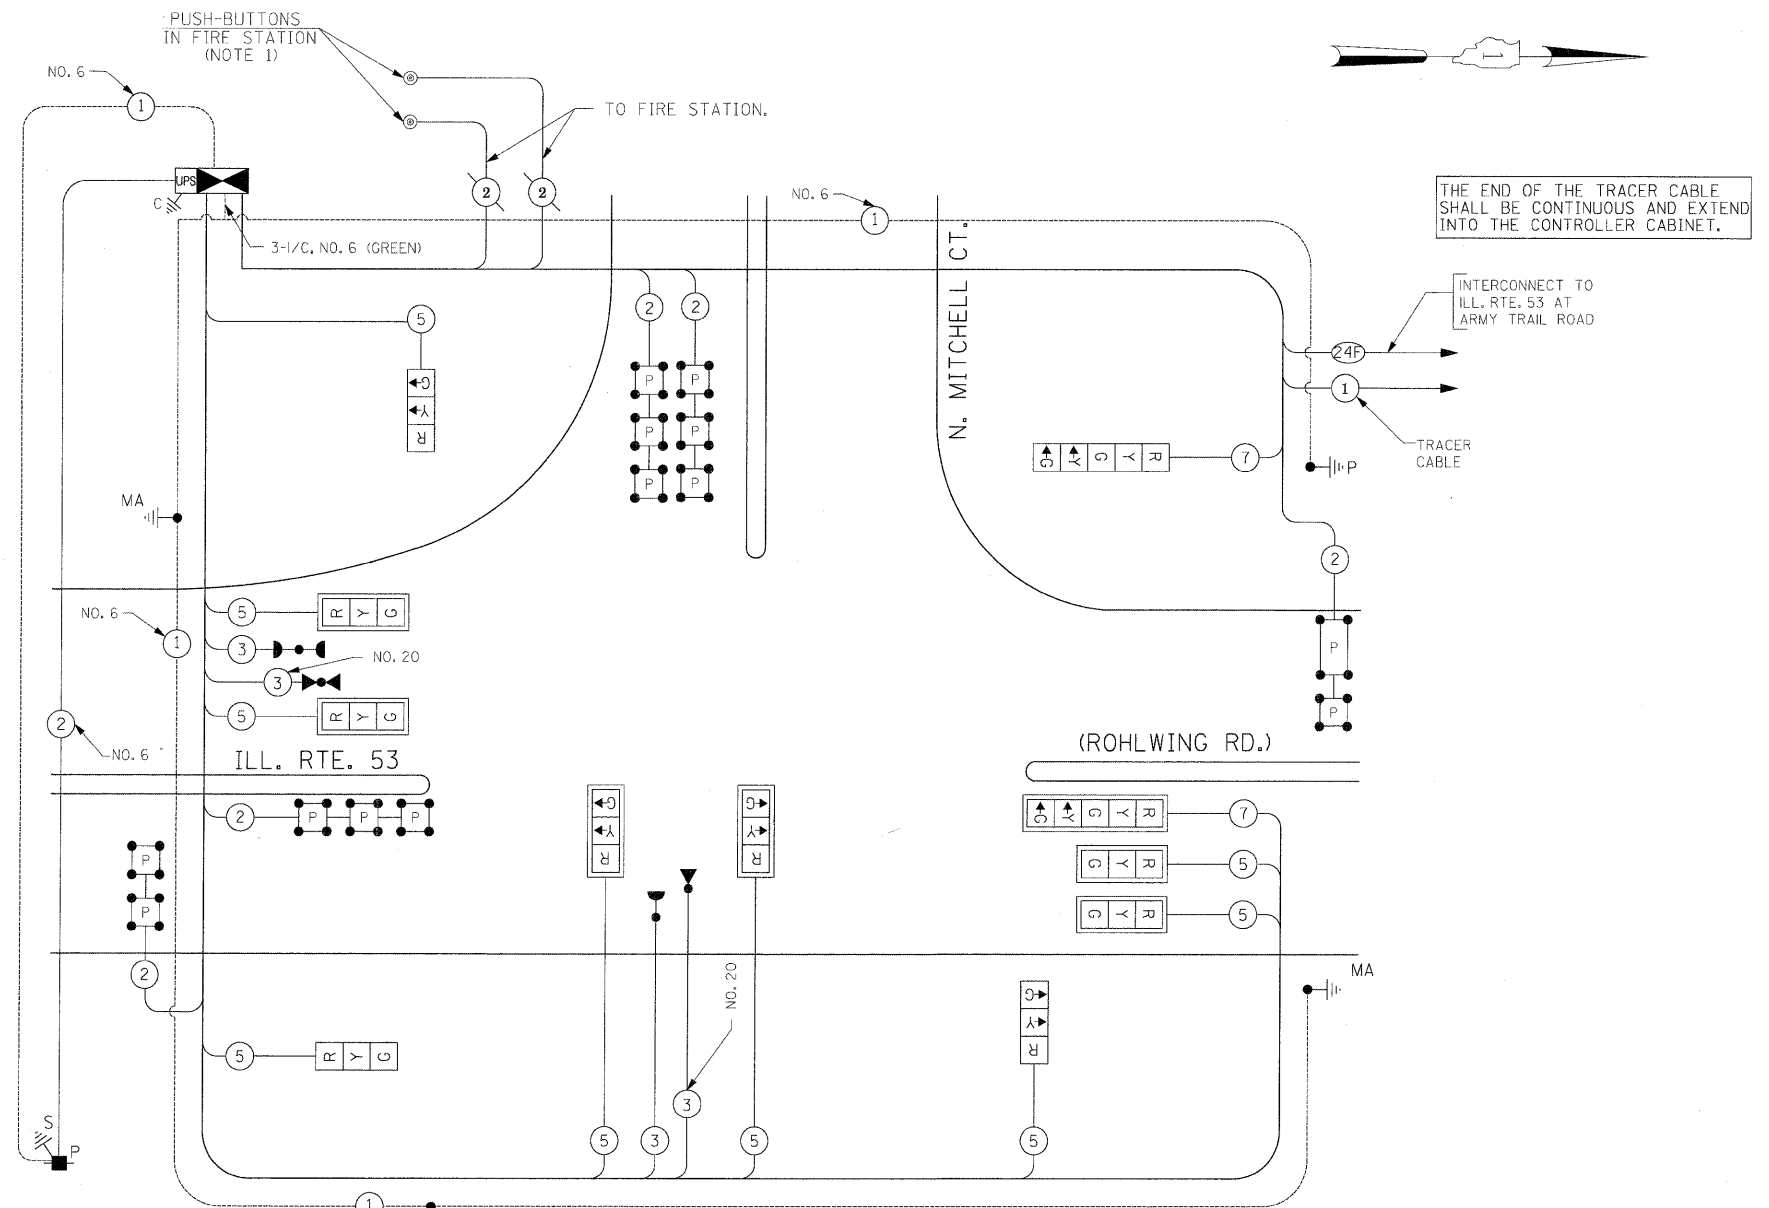


CABLE PLAN
(NOT TO SCALE)


CONTROLLER SEQUENCE

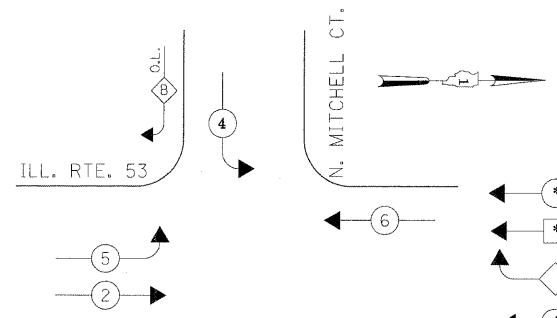

PHASE DESIGNATION DIAGRAM

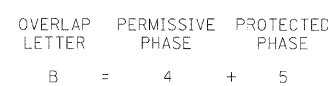

EMERGENCY VEHICLE PREEMPTION SEQUENCE

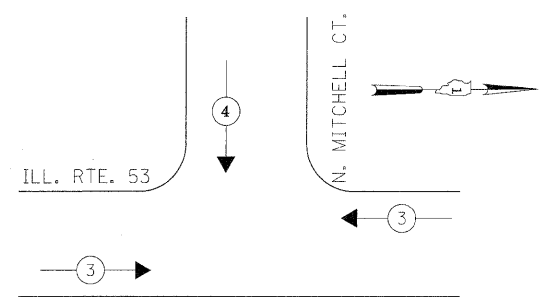

NOTE: THE EMERGENCY VEHICLE PREEMPTION FOR THE WEST APPROACH SHALL ALSO BE ACTIVATED VIA PUSH-BUTTONS LOCATED INSIDE THE FIRE STATION PREMISES.

| PROPOSED EMERGENCY VEHICLE PREEMPTORS | | |
|---------------------------------------|---|---|
| EMERGENCY VEHICLE PREEMPTOR | 3 | 4 |
| MOVEMENT | ← | ↓ |

STATE OF ILLINOIS
DEPARTMENT OF TRANSPORTATION

CABLE PLAN, PHASE DESIGNATION DIAGRAM
EMERGENCY VEHICLE PREEMPTION SEQUENCE
SCHEDULE OF QUANTITIES
ILLINOIS ROUTE 53 (ROHLWING RD.) AT N. MITCHELL CT.

| F.A.P. RTE. | SECTION | COUNTY | TOTAL SHEETS | SHEET NO. |
|--------------------|---------|--------|--------------|-----------|
| 2578 | 532B | DuPage | 781 | 437 |
| CONTRACT NO. 60477 | | | | |

SCALE: NONE SHEET NO. OF SHEETS STA. TO STA.

FED. ROAD DIST. NO. - ILLINOIS FED. AID PROJECT

NOTES FOR TEMPORARY TRAFFIC SIGNALS

1. ALL CONTROL EQUIPMENT INCLUDING EMERGENCY PRE-EMPTION AND COMMUNICATION DEVICES FOR THE TEMPORARY TRAFFIC SIGNAL(S) SHALL BE FURNISHED BY THE CONTRACTOR.
2. ONLY CONTROLLERS SUPPLIED BY ONE OF THE DISTRICT APPROVED CLOSED LOOP EQUIPMENT MANUFACTURERS WILL BE APPROVED FOR USE AT TEMPORARY SIGNAL LOCATIONS. ALL CONTROLLERS USED FOR TEMPORARY TRAFFIC SIGNALS SHALL BE FULLY ACTUATED NEMA MICROPROCESSOR BASED WITH RS232 DATA ENTRY PORTS COMPATIBLE WITH EXISTING MONITORING SOFTWARE APPROVED BY IDOT DISTRICT 1, INSTALLED IN A NEMA TS2 CABINET. ONLY ONE BRAND OF CONTROLLER WILL BE ACCEPTED FOR ANY ONE CONTRACT.
3. ALL TRAFFIC SIGNAL SECTIONS AND PEDESTRIAN SIGNAL SECTIONS SHALL BE LED AND 12" (300mm) DIAMETER. HEADS SHALL BE PLACED AS INDICATED ON THE TEMPORARY TRAFFIC SIGNAL PLAN OR AS DIRECTED BY THE ENGINEER. PEDESTRIAN SIGNALS SHALL INCLUDE SOLID INTERNATIONAL SYMBOLS. PEDESTRIAN SIGNALS WITH COUNTDOWN TIMERS SHALL BE USED WHEN THE EXISTING INSTALLATION UTILIZES COUNTDOWN TYPE OR AS DIRECTED BY THE ENGINEER. COUNTDOWN TYPE PEDESTRIAN SIGNALS ARE NOT TO BE INSTALLED AT A RAILROAD INTERSECTION. THE CONTRACTOR SHALL FURNISH ENOUGH CABLE SLACK TO RELOCATE HEADS TO ANY POSITION ON THE SPAN WIRE OR AT LOCATIONS ILLUSTRATED ON THE PLANS FOR CONSTRUCTION STAGING. THE TEMPORARY TRAFFIC SIGNAL SHALL REMAIN IN OPERATION DURING ALL SIGNAL HEAD RELOCATIONS. EACH TEMPORARY TRAFFIC SIGNAL HEAD SHALL HAVE ITS OWN CABLE FROM THE CONTROLLER CABINET TO THE SIGNAL HEAD.
4. ALL EXISTING STREET NAME AND INTERSECTION REGULATORY SIGNS SHALL BE REMOVED FROM EXISTING POLES, RELOCATED AND SECURELY FASTENED TO THE SPAN WIRE OR WOOD POLE AS DIRECTED BY THE ENGINEER.
5. ANY TEMPORARY SIGNAL WITHIN AN EXISTING CLOSED LOOP TRAFFIC SIGNAL SYSTEM SHALL BE INTERCONNECTED TO THAT SYSTEM USING SIMILAR BRAND CONTROL EQUIPMENT.
6. THE TEMPORARY TRAFFIC SIGNAL SHALL HAVE THE SIGNAL HEAD DISPLAYS, SIGNAL HEAD PLACEMENTS AND CONTROLLER PHASING MATCH THE EXISTING TRAFFIC SIGNAL, AT THE TIME OF THE TURN ON, IF NO TRAFFIC STAGING IS IN PLACE OR WILL NOT BE STAGED ON THE DAY OF THE TURN ON.
7. UNINTERRUPTIBLE POWER SUPPLY (UPS) SYSTEMS SHALL BE INSTALLED AND MADE OPERATIONAL AT TEMPORARY TRAFFIC SIGNAL INSTALLATIONS WHERE UPS IS INSTALLED AT THE EXISTING TRAFFIC SIGNAL, TEMPORARY TRAFFIC SIGNALS AT RAILROAD INTERSECTIONS, AND TEMPORARY TRAFFIC SIGNALS AT INTERSECTIONS WITH FIRE STATION ACTUATED EMERGENCY VEHICLE PRE-EMPTION, OR WHEN INDICATED ON THE PLANS.
8. TRAFFIC SIGNAL MANAGEMENT SYSTEMS SHALL BE MAINTAINED IN OPERATION AS INDICATED ON THE PLANS OR AS DIRECTED BY THE ENGINEER. REQUIRED EQUIPMENT SHALL BE AS SHOWN ON THE PLANS AND THE CONTRACTOR SHALL PLACE THE EQUIPMENT IN OPERATION TO THE SATISFACTION OF THE ENGINEER AND THE AGENCY RESPONSIBLE FOR THE TRAFFIC SIGNAL MANAGEMENT SYSTEM.
9. DETECTION AT TEMPORARY TRAFFIC SIGNALS SHALL BE INCLUDED FOR ALL APPROACHES OF THE INTERSECTION UNLESS INDICATED OTHERWISE ON THE PLANS. THE DETECTION SYSTEM MUST MEET THE SPECIFICATIONS OF DISTRICT 1 AND THE CONTRACTOR SHALL PLACE THE DETECTORS INTO OPERATION TO THE SATISFACTION OF THE ENGINEER.
10. WHEN PAN, TILT, ZOOM CAMERAS ARE INSTALLED AT THE EXISTING INTERSECTION OR ARE CALLED FOR IN THE PLANS, THE CONTRACTOR SHALL BE RESPONSIBLE FOR INSTALLING AND MAINTAINING THE CAMERAS TO THE SATISFACTION OF THE ENGINEER AND THE AGENCY RESPONSIBLE FOR THE CAMERAS.

THE FOLLOWING ITEMS SHALL BE REMOVED BY THE CONTRACTOR AND SHALL BE DISPOSED OF BY THEM OUTSIDE THE RIGHT-OF-WAY AT THEIR EXPENSE. THE SALVAGE VALUE OF THE REMOVED EQUIPMENT SHALL BE REFLECTED IN THE CONTRACTOR'S BID PRICE.

- 1 EACH CONTROLLER AND CABINET COMPLETE
- 11 EACH SIGNAL HEAD, 1-FACE, 3-SECTION, MAST ARM MOUNTED
- 1 EACH SIGNAL HEAD, 1-FACE, 3-SECTION, BRACKET MOUNTED
- 1 EACH SIGNAL HEAD, 1-FACE, 5-SECTION, BRACKET MOUNTED
- 1 EACH SIGNAL HEAD, 1-FACE, 5-SECTION, MAST ARM MOUNTED
- 2 EACH SIGNAL HEAD, 2-FACE, 3-SECTION, BRACKET MOUNTED
- 1 EACH SIGNAL HEAD, 2-FACE, 1-3 SECTION, 1-5 SECTION, BRACKET MOUNTED
- 1 EACH SIGNAL HEAD, 3-FACE, 2-3 SECTION, 1-5 SECTION, BRACKET MOUNTED
- 7 EACH PEDESTRIAN SIGNAL HEAD, 1-FACE, BRACKET MOUNTED
- 1 EACH PEDESTRIAN SIGNAL HEAD, 3-FACE, BRACKET MOUNTED
- 12 EACH TRAFFIC SIGNAL BACKPLATE
- 5 EACH TRAFFIC SIGNAL POST
- 4 EACH STEEL MAST ARM ASSEMBLY AND POLE
- 9 EACH PEDESTRIAN PUSH-BUTTON
- 1 EACH SERVICE INSTALLATION

ⓐ
LEFT ON
GREEN
ARROW
ONLY

R10-5,
24" X 30"
(8 REQUIRED)

R10-5 SIGNS SHALL BE MOUNTED, ONE EACH ON SPAN WIRE AND FAR LEFT POLE FOR ALL APPROACHES OF THE INTERSECTION.

NOTE: THE VIDEO DETECTION ZONES SHOWN ON THE PLANS ARE FOR CONSTRUCTION STAGE 1 - SUBSTAGE 1 AND SHALL BE REDEFINED FOR EACH CONSTRUCTION STAGE AS A PART OF "TEMPORARY TRAFFIC SIGNAL INSTALLATION" WORK.


THE FOLLOWING EXISTING TRAFFIC SIGNAL EQUIPMENT SHALL BE REMOVED BY THE CONTRACTOR, SHALL REMAIN THE PROPERTY OF THE AGENCY LISTED BELOW. THE CONTRACTOR SHALL SAFELY STORE AND ARRANGE FOR PICK UP OF ALL EQUIPMENT TO BE RETURNED TO THE LISTED AGENCY AS PER THE TRAFFIC SIGNAL SPECIFICATIONS.

AGENCY: VILLAGE OF ADDISON

CONTACT INFORMATION:
RUDY ESPEDIDO
VILLAGE OF ADDISON
ENGINEERING DEPARTMENT
PHONE: (630)693-7533

- 2 EACH LIGHT DETECTOR
- 1 EACH LIGHT DETECTOR AMPLIFIER

MATCH LINE 48+00

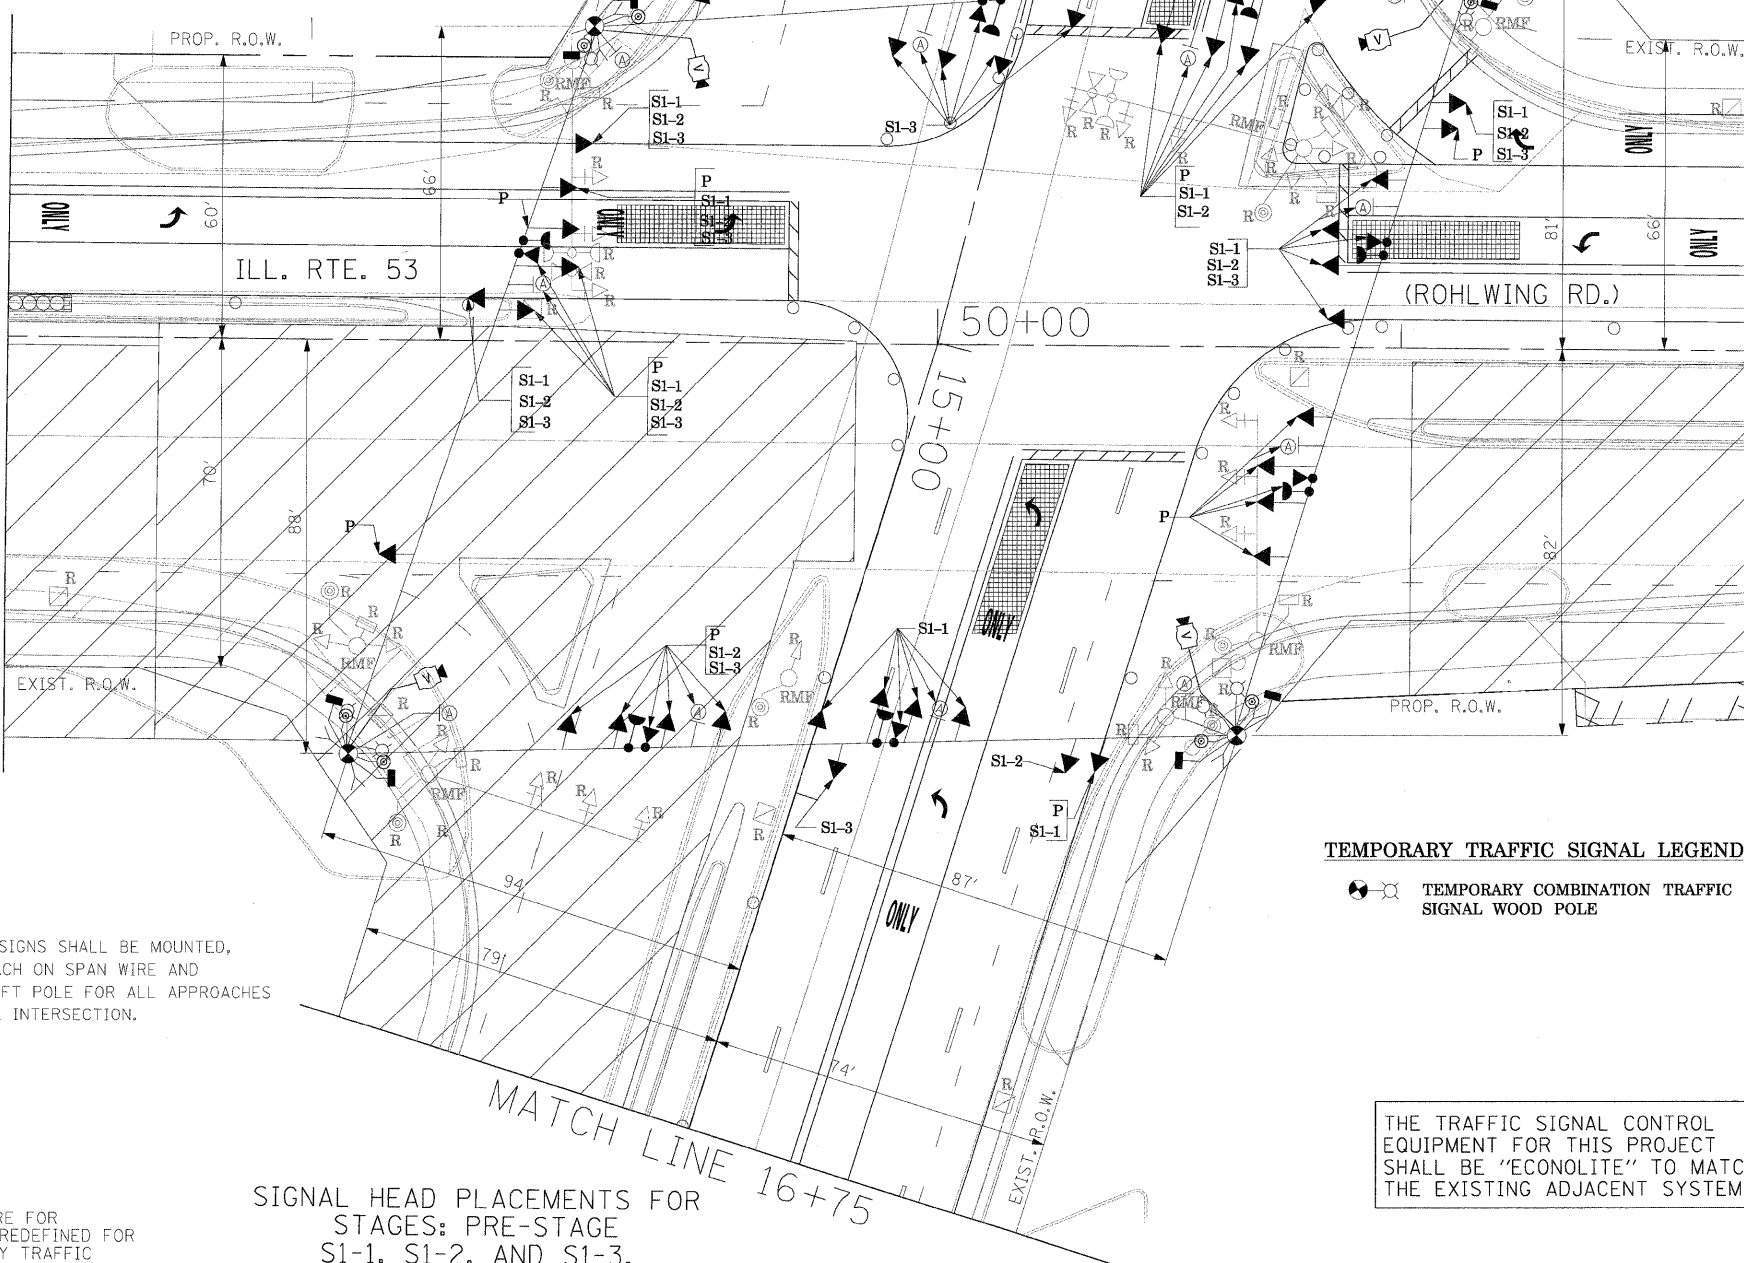

TEMPORARY RADIO INTERCONNECT TO N. MITCHELL CT. AT ILL. RTE. 53 (SEE TEMPORARY INTERCONNECT PLANS)





TEMPORARY RADIO INTERCONNECT TO I-355 RAMP B (EAST RAMP) AT ARMY TRAIL (SEE TEMPORARY INTERCONNECT PLANS)

TEMPORARY TRAFFIC SIGNAL LEGEND
 TEMPORARY COMBINATION TRAFFIC SIGNAL WOOD POLE

THE TRAFFIC SIGNAL CONTROL EQUIPMENT FOR THIS PROJECT SHALL BE "ECONOLITE" TO MATCH THE EXISTING ADJACENT SYSTEM.

SIGNAL HEAD PLACEMENTS FOR STAGES: PRE-STAGE S1-1, S1-2, AND S1-3.

| | | | | | | | | | | | | |
|-------------|----------------------|-------------------|-----------|---|--|---|--|---|---------|--------------------|--------------|-----------|
| FILE NAME = | USER NAME = #USER# | DESIGNED - PKG | REVISED - | STATE OF ILLINOIS DEPARTMENT OF TRANSPORTATION | | TEMPORARY TRAFFIC SIGNAL INSTALLATION AND REMOVAL PLAN ILLINOIS ROUTE 53 (ROHLWING RD.) AT ARMY TRAIL RD. PRE STAGE AND STAGE 1 (SHEET 1 OF 5). | | F.A.P. RTE. | SECTION | COUNTY | TOTAL SHEETS | SHEET NO. |
| #FILE# | | DRAWN - MAA, EA | REVISED - | | | | | 2578 | 532B | DuPage | 781 | 438 |
| | PLOT SCALE = #SCALE# | CHECKED - PKG, EA | REVISED - | SCALE: 1"=20' | | SHEET NO. OF SHEETS STA. TO STA. | | FED. ROAD DIST. NO. - ILLINOIS FED. AID PROJECT | | CONTRACT NO. 60477 | | |
| | PLOT DATE = #DATE# | DATE - 5/10/2010 | REVISED - | | | | | | | | | |

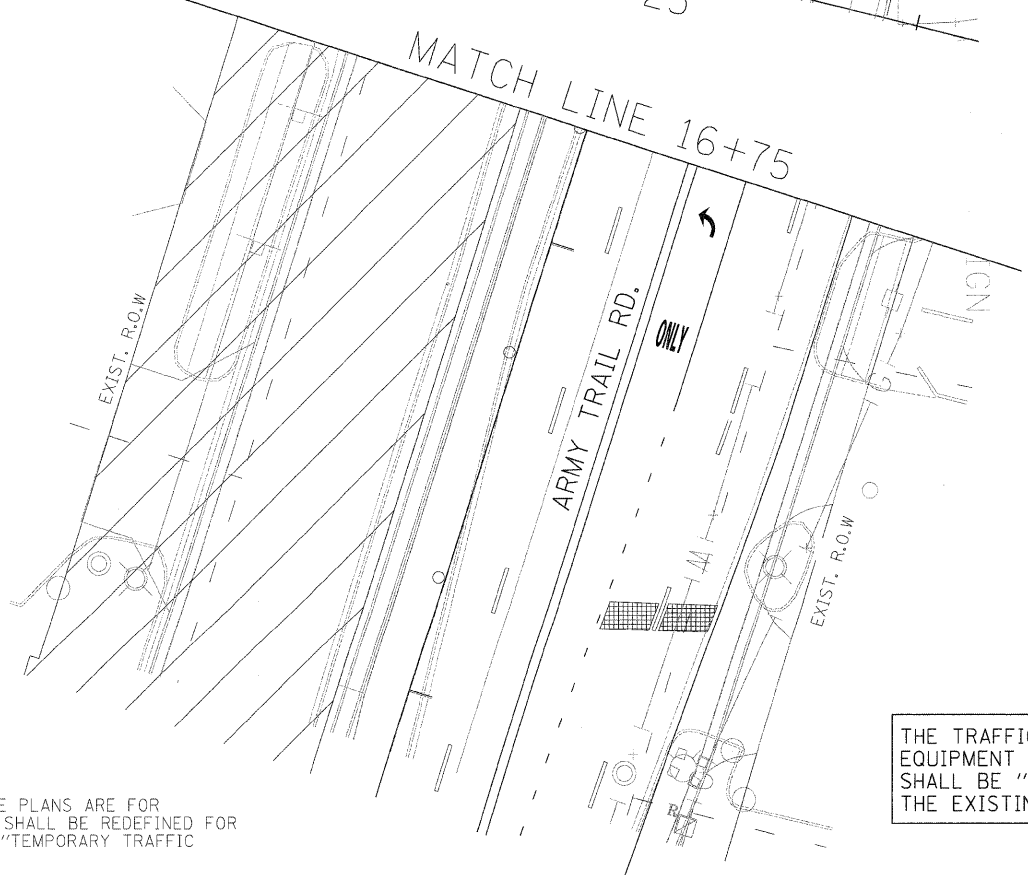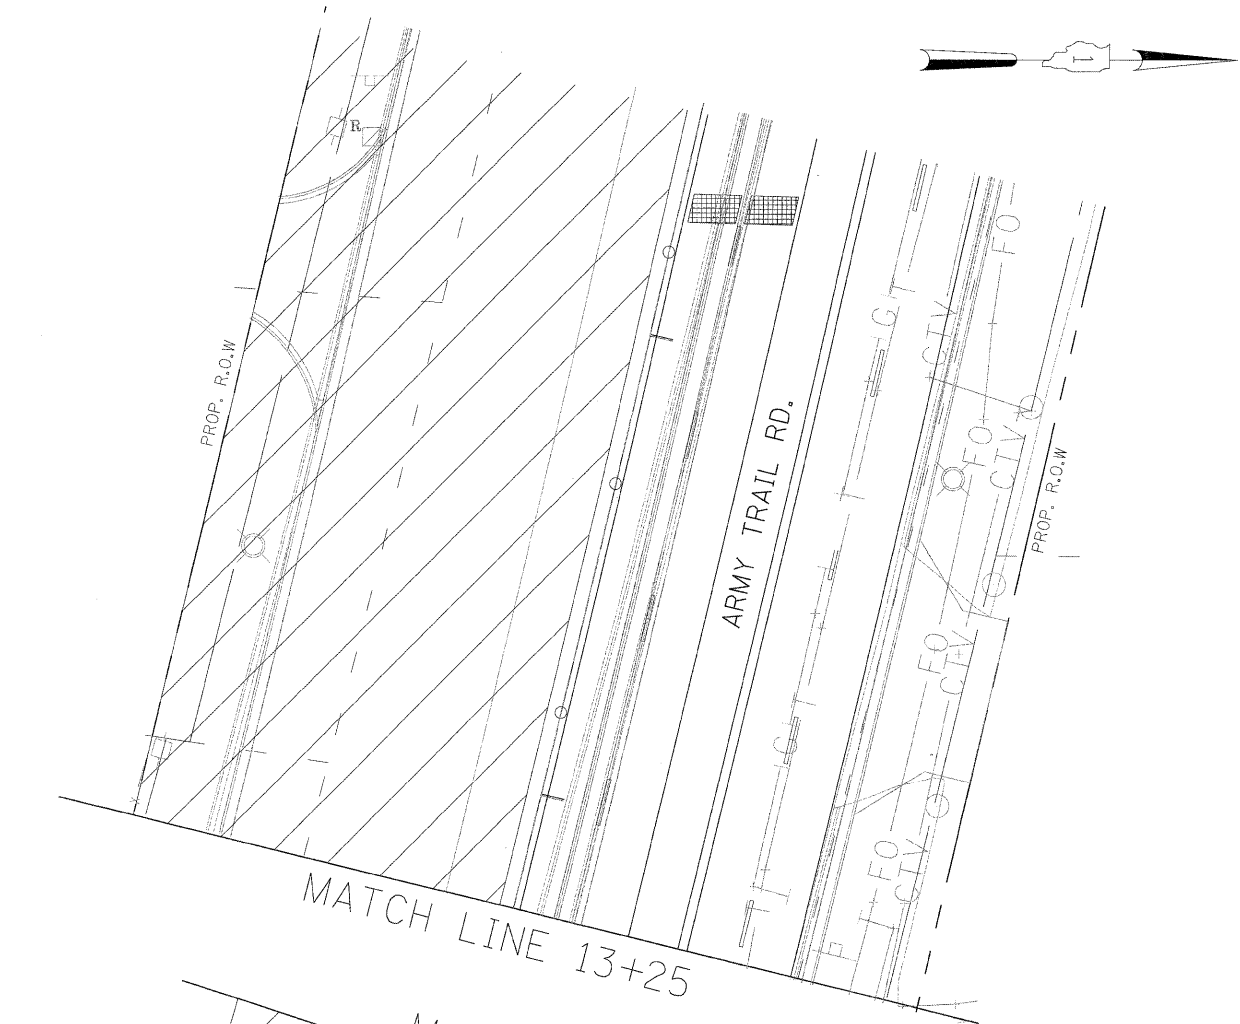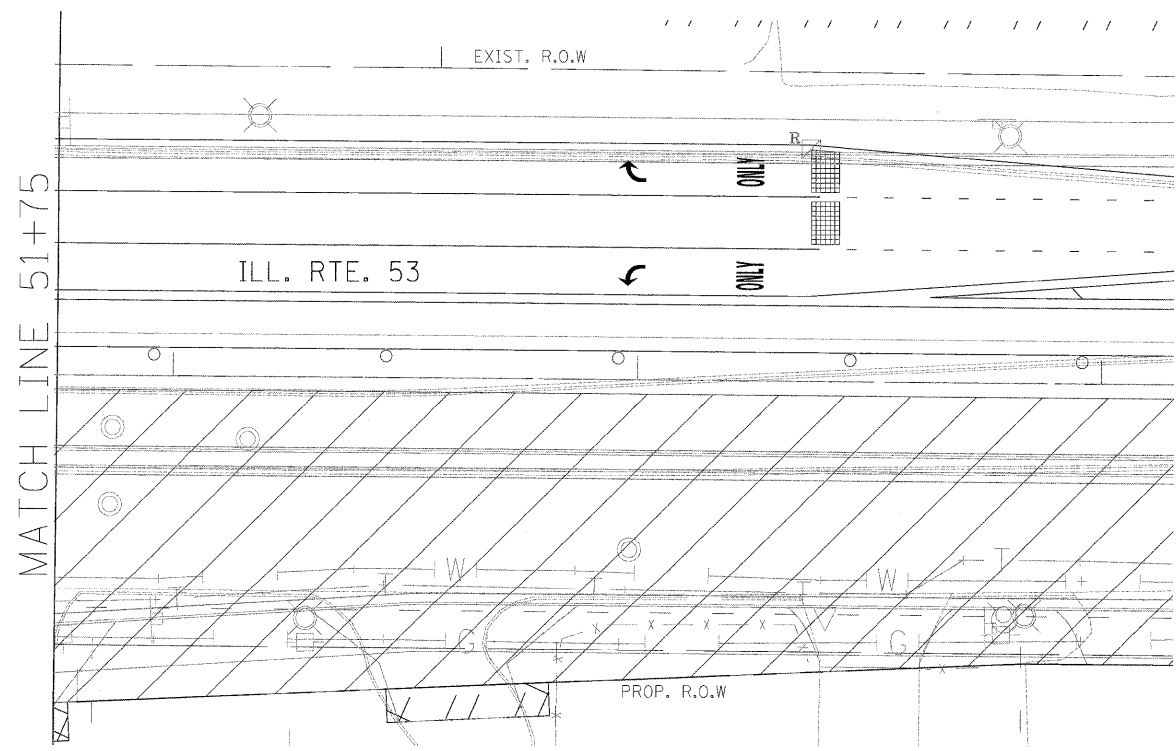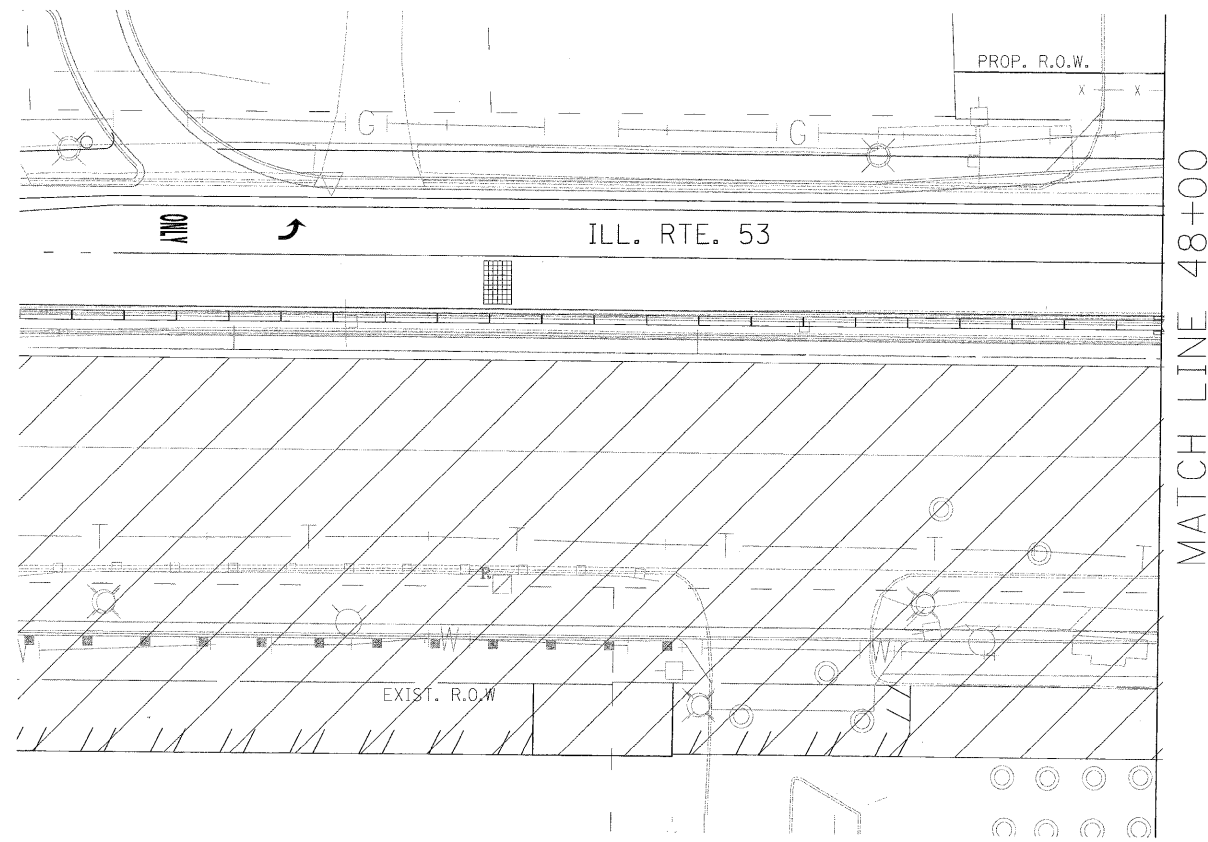

NOTE: THE VIDEO DETECTION ZONES SHOWN ON THE PLANS ARE FOR CONSTRUCTION STAGE 1 - SUBSTAGE 1 AND SHALL BE REDEFINED FOR EACH CONSTRUCTION STAGE AS A PART OF "TEMPORARY TRAFFIC SIGNAL INSTALLATION" WORK.

THE TRAFFIC SIGNAL CONTROL EQUIPMENT FOR THIS PROJECT SHALL BE "ECONOLITE" TO MATCH THE EXISTING ADJACENT SYSTEM.


| | | | |
|-------------|----------------------|-------------------|-----------|
| FILE NAME = | USER NAME = #USER# | DESIGNED - PKG | REVISED - |
| \$FILEL# | | DRAWN - MAA, EA | REVISED - |
| | PLOT SCALE = #SCALE# | CHECKED - PKG, EA | REVISED - |
| | PLOT DATE = #DATE# | DATE - 5/10/2010 | REVISED - |

**STATE OF ILLINOIS
DEPARTMENT OF TRANSPORTATION**

**TEMPORARY TRAFFIC SIGNAL INSTALLATION AND REMOVAL PLAN
ILLINOIS ROUTE 53 (ROHLWING RD.) AT ARMY TRAIL RD. PRE STAGE
AND STAGE 1 (SHEET 2 OF 5)**

SCALE: 1"=20' SHEET NO. OF SHEETS STA. TO STA.

| | | | | |
|---|---------|--------|--------------------|-----------|
| F.A.P. RTE. | SECTION | COUNTY | TOTAL SHEETS | SHEET NO. |
| 2578 | 532B | DuPage | 78 | 439 |
| FED. ROAD DIST. NO. - ILLINOIS FED. AID PROJECT | | | CONTRACT NO. 60477 | |

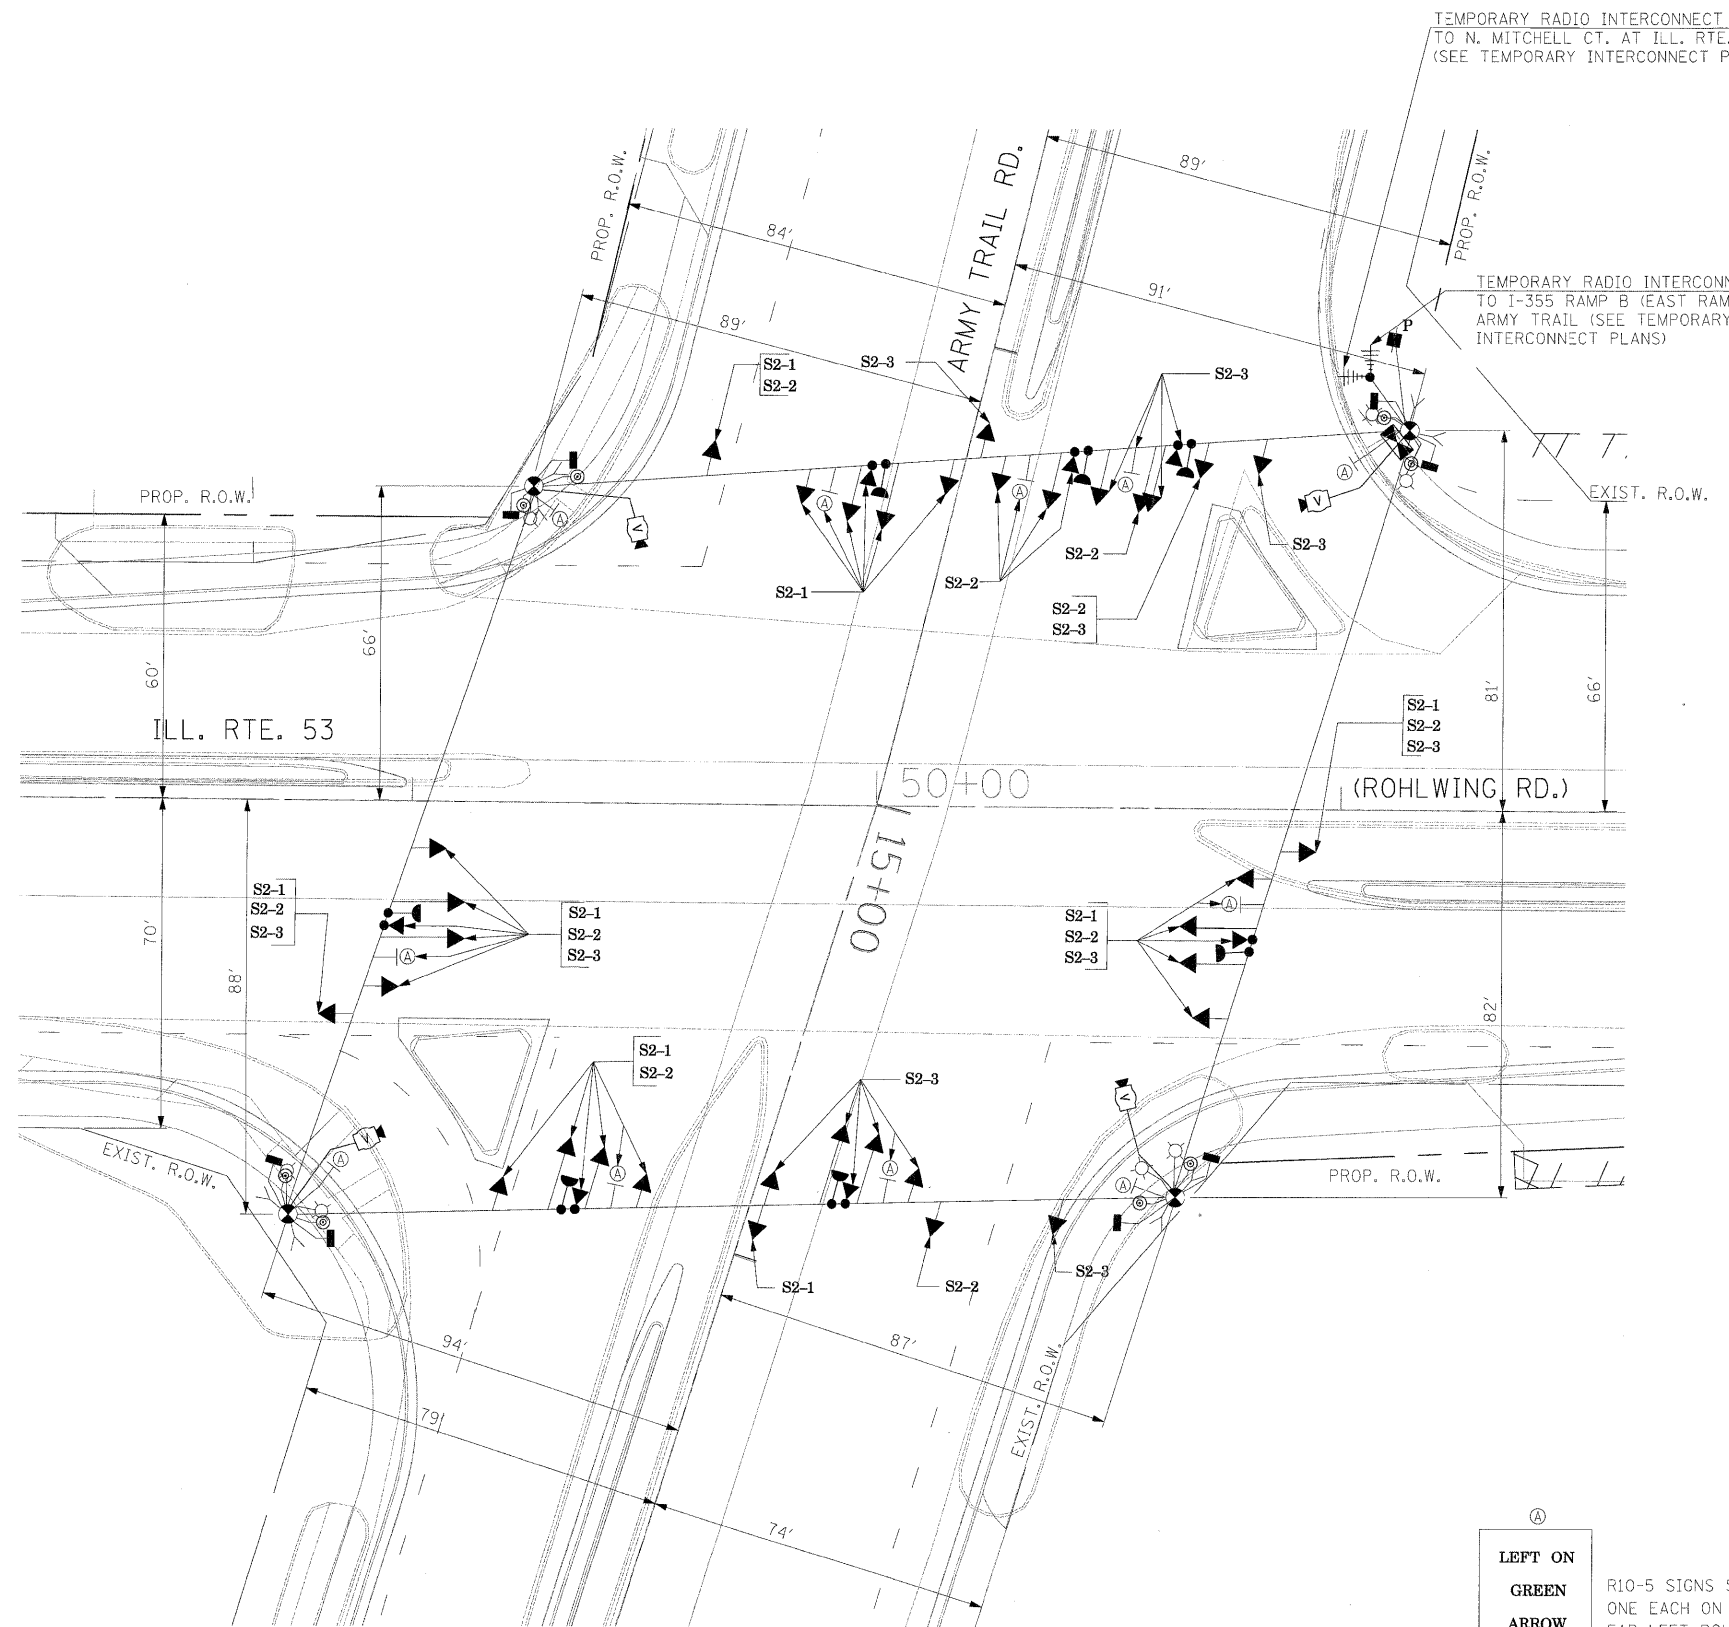

TEMPORARY TRAFFIC SIGNAL LEGEND

- ⊙ ⊗ TEMPORARY COMBINATION TRAFFIC SIGNAL WOOD POLE

NOTE: THE VIDEO DETECTION ZONES SHOWN ON THE PLANS ARE FOR CONSTRUCTION STAGE 1 - SUBSTAGE 1 AND SHALL BE REDEFINED FOR EACH CONSTRUCTION STAGE AS A PART OF "TEMPORARY TRAFFIC SIGNAL INSTALLATION" WORK.

SIGNAL HEAD PLACEMENTS FOR STAGES: S2-1, S2-2, AND S2-3.


Ⓐ
LEFT ON
GREEN
ARROW
ONLY

R10-5 SIGNS SHALL BE MOUNTED, ONE EACH ON SPAN WIRE AND FAR LEFT POLE FOR ALL APPROACHES OF THE INTERSECTION.

R10-5,
24" X 30"
(8 REQUIRED)

THE TRAFFIC SIGNAL CONTROL EQUIPMENT FOR THIS PROJECT SHALL BE "ECONOLITE" TO MATCH THE EXISTING ADJACENT SYSTEM.

| | | | | | | | | | | | | | |
|-----------------------|----------------------|-------------------|-----------|---|---|-----------|----|--------|----------------|---------|---|-----------------|--------------|
| FILE NAME = #FILE# | USER NAME = #USER# | DESIGNED - PKG | REVISED - | STATE OF ILLINOIS DEPARTMENT OF TRANSPORTATION | TEMPORARY TRAFFIC SIGNAL INSTALLATION AND REMOVAL PLAN ILLINOIS ROUTE 53 (ROHLWING RD.) AT ARMY TRAIL RD. STAGE 2 (SHEET 3 OF 5) | | | | F.A.P. RTE. | SECTION | COUNTY | TOTAL SHEETS | SHEET NO. |
| | PLOT SCALE = #SCALE# | DRAWN - MAA, EA | REVISED - | | SCALE: 1"=20' | SHEET NO. | OF | SHEETS | STA. | TO STA. | DuPage | 781 | 440 |
| | PLOT DATE = #DATE# | CHECKED - PKG, EA | REVISED - | | | | | | | | CONTRACT NO. 60477 | | |
| | | DATE - 5/10/2010 | REVISED - | | | | | | | | FED. ROAD DIST. NO. - ILLINOIS FED. AID PROJECT | | |

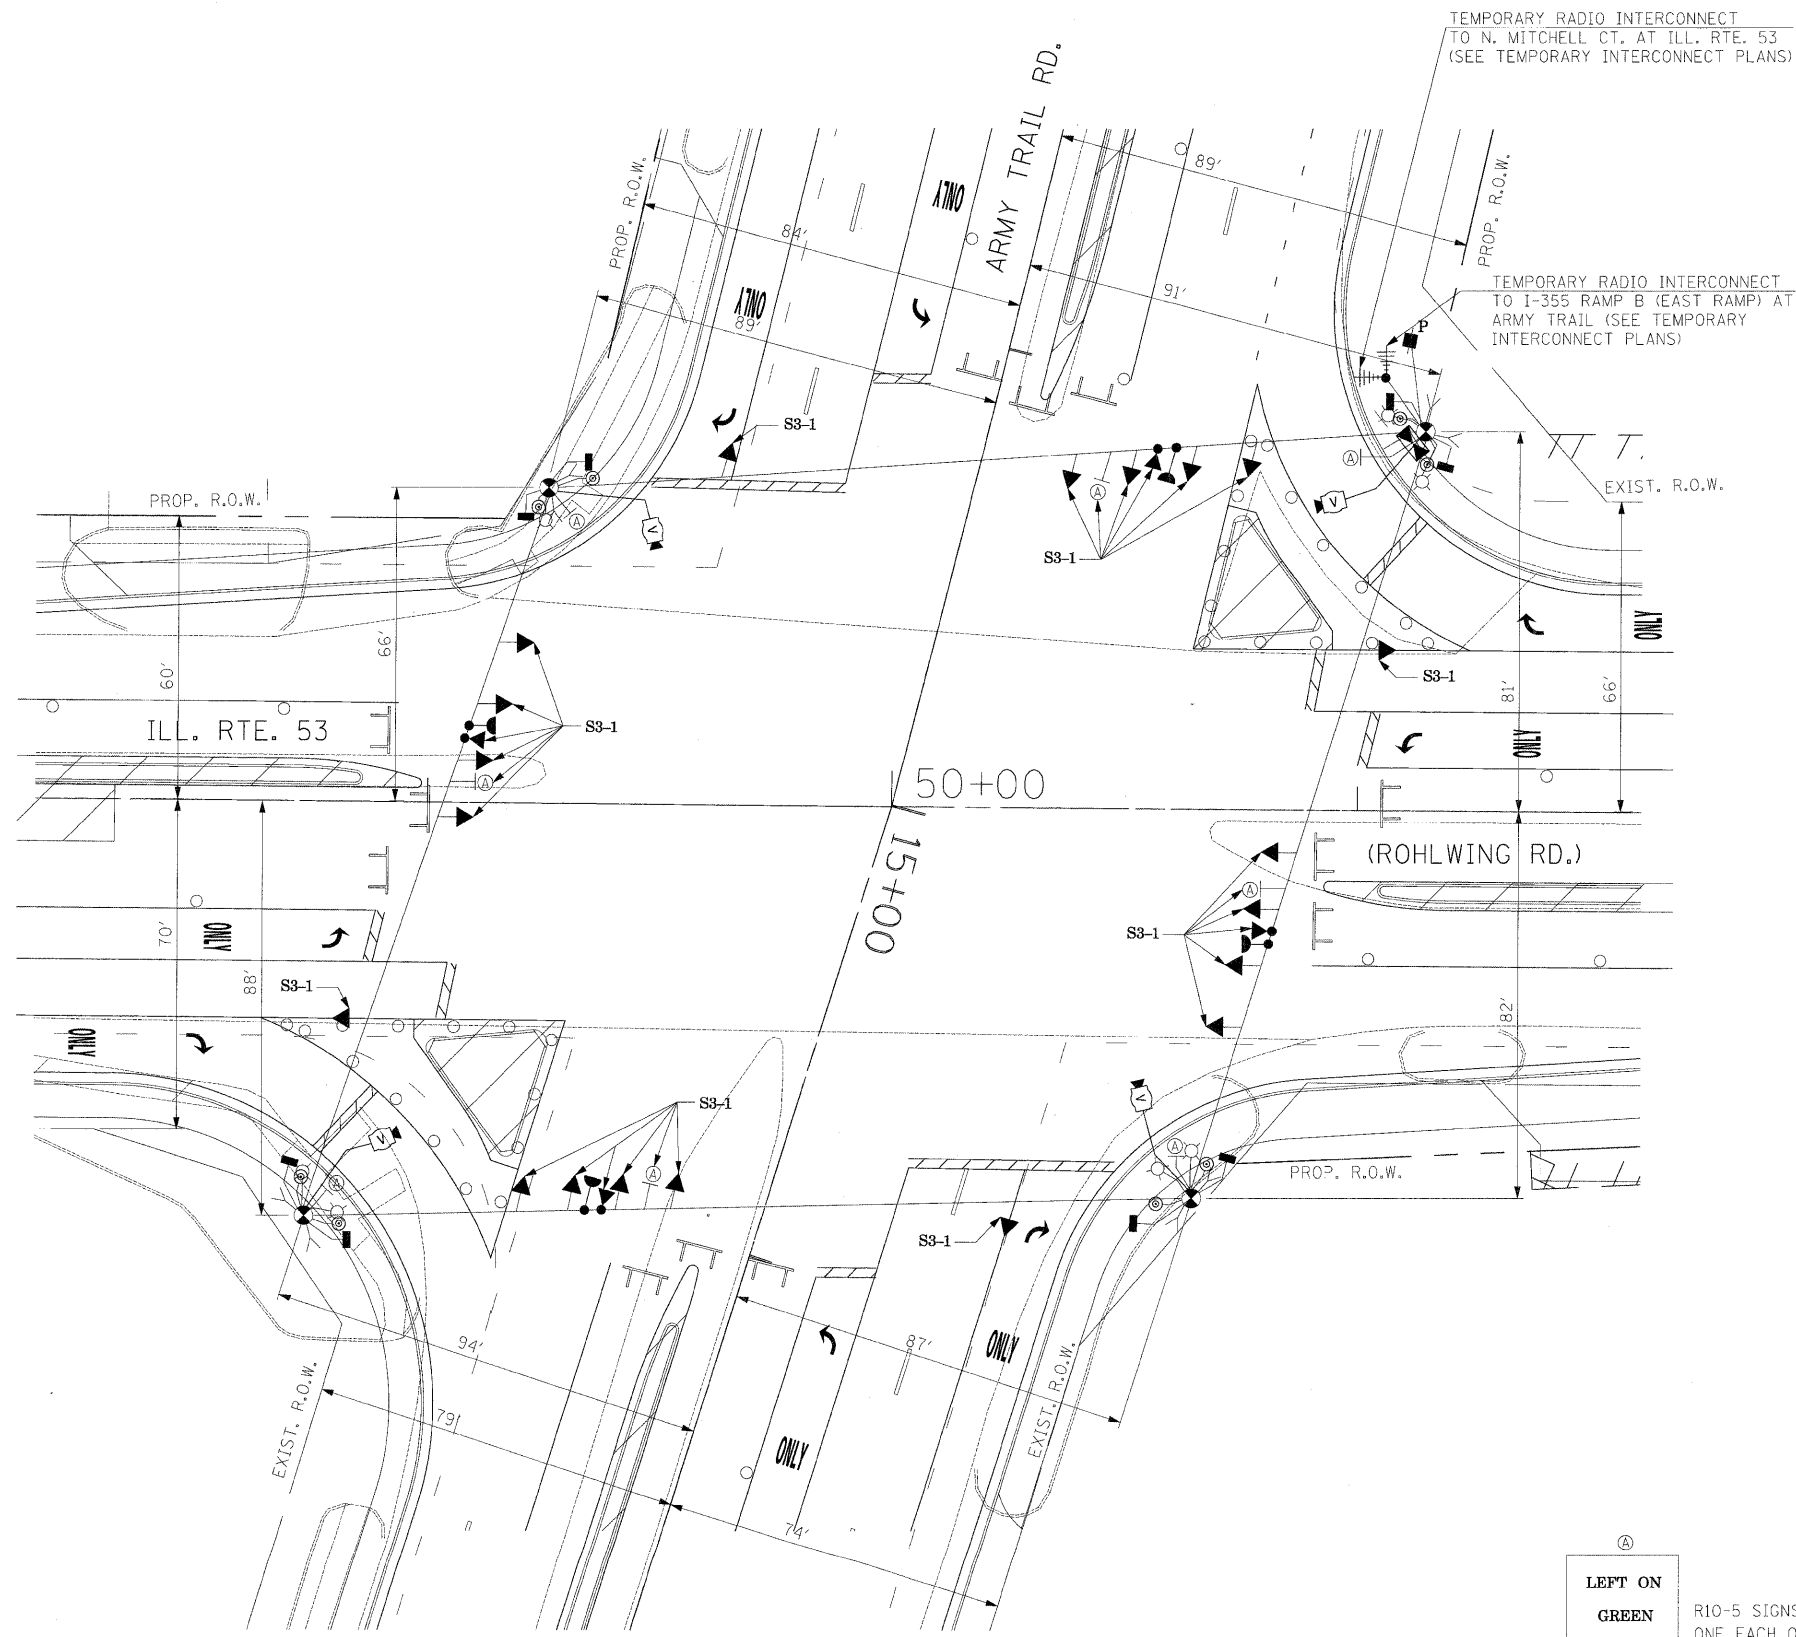

TEMPORARY TRAFFIC SIGNAL LEGEND

TEMPORARY COMBINATION TRAFFIC SIGNAL WOOD POLE

NOTE: THE VIDEO DETECTION ZONES SHOWN ON THE PLANS ARE FOR CONSTRUCTION STAGE 1 - SUBSTAGE 1 AND SHALL BE REDEFINED FOR EACH CONSTRUCTION STAGE AS A PART OF "TEMPORARY TRAFFIC SIGNAL INSTALLATION" WORK.

SIGNAL HEAD PLACEMENTS FOR STAGES: S3



(A)
 LEFT ON
 GREEN
 ARROW
 ONLY

R10-5, 24" X 30" (8 REQUIRED)

R10-5 SIGNS SHALL BE MOUNTED, ONE EACH ON SPAN WIRE AND FAR LEFT POLE FOR THE APPROACH WHERE THE R10-5 IS NEEDED.

THE TRAFFIC SIGNAL CONTROL EQUIPMENT FOR THIS PROJECT SHALL BE "ECONOLITE" TO MATCH THE EXISTING ADJACENT SYSTEM.


| | | | | | | | | | | |
|----------------------|--------------------|----------------|---|---|---|-------------|---------|--------|--------------|-----------|
| FILE NAME = | USER NAME = #USER# | DESIGNED - PKG | REVISED - | STATE OF ILLINOIS DEPARTMENT OF TRANSPORTATION | TEMPORARY TRAFFIC SIGNAL INSTALLATION AND REMOVAL PLAN ILLINOIS ROUTE 53 (ROHLWING RD.) AT ARMY TRAIL RD. STAGE 3 (SHEET 4 OF 5) | F.A.P. RTE. | SECTION | COUNTY | TOTAL SHEETS | SHEET NO. |
| #FILE# | DRAWN - MAA, EA | REVISED - | 2578 | | | 532B | DuPage | 781 | 441 | |
| PLOT SCALE = #SCALE# | CHECKED - PKG, EA | REVISED - | CONTRACT NO. 60477 | | | | | | | |
| PLOT DATE = #DATE# | DATE - 5/10/2010 | REVISED - | FED. ROAD DIST. NO. - ILLINOIS FED. AID PROJECT | | | | | | | |
| | | | | SCALE: 1"=20' | SHEET NO. OF SHEETS STA. TO STA. | | | | | |

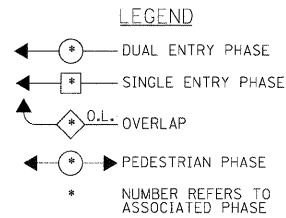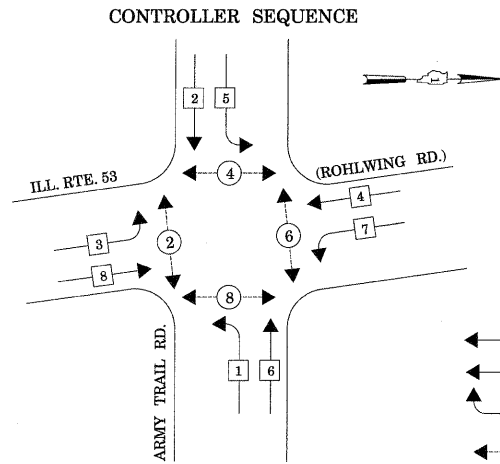

TEMPORARY PHASE DESIGNATION DIAGRAM


STAGES: PRE-STAGE, S1-1, S1-2, S1-3, S2-1, AND AFTER PROPOSED ROADWAY GEOMETRICS ARE BUILT

EMERGENCY VEHICLE PREEMPTION SEQUENCE

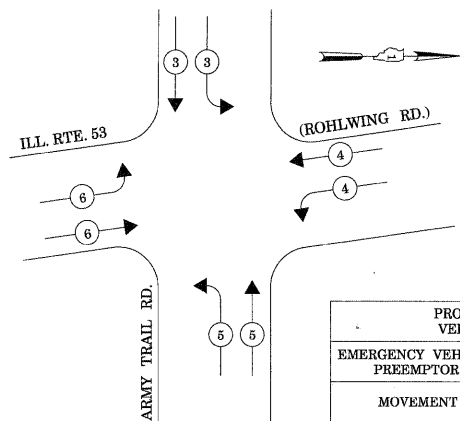

| PROPOSED EMERGENCY VEHICLE PREEMPTORS | | | | |
|---------------------------------------|---|---|---|---|
| EMERGENCY VEHICLE PREEMPTOR | 3 | 4 | 5 | 6 |
| MOVEMENT | ↕ | ↔ | ↕ | ↔ |

STAGES: PRE-STAGE, S1-1, S1-2, S1-3, S2-1, AND AFTER PROPOSED ROADWAY GEOMETRICS ARE BUILT

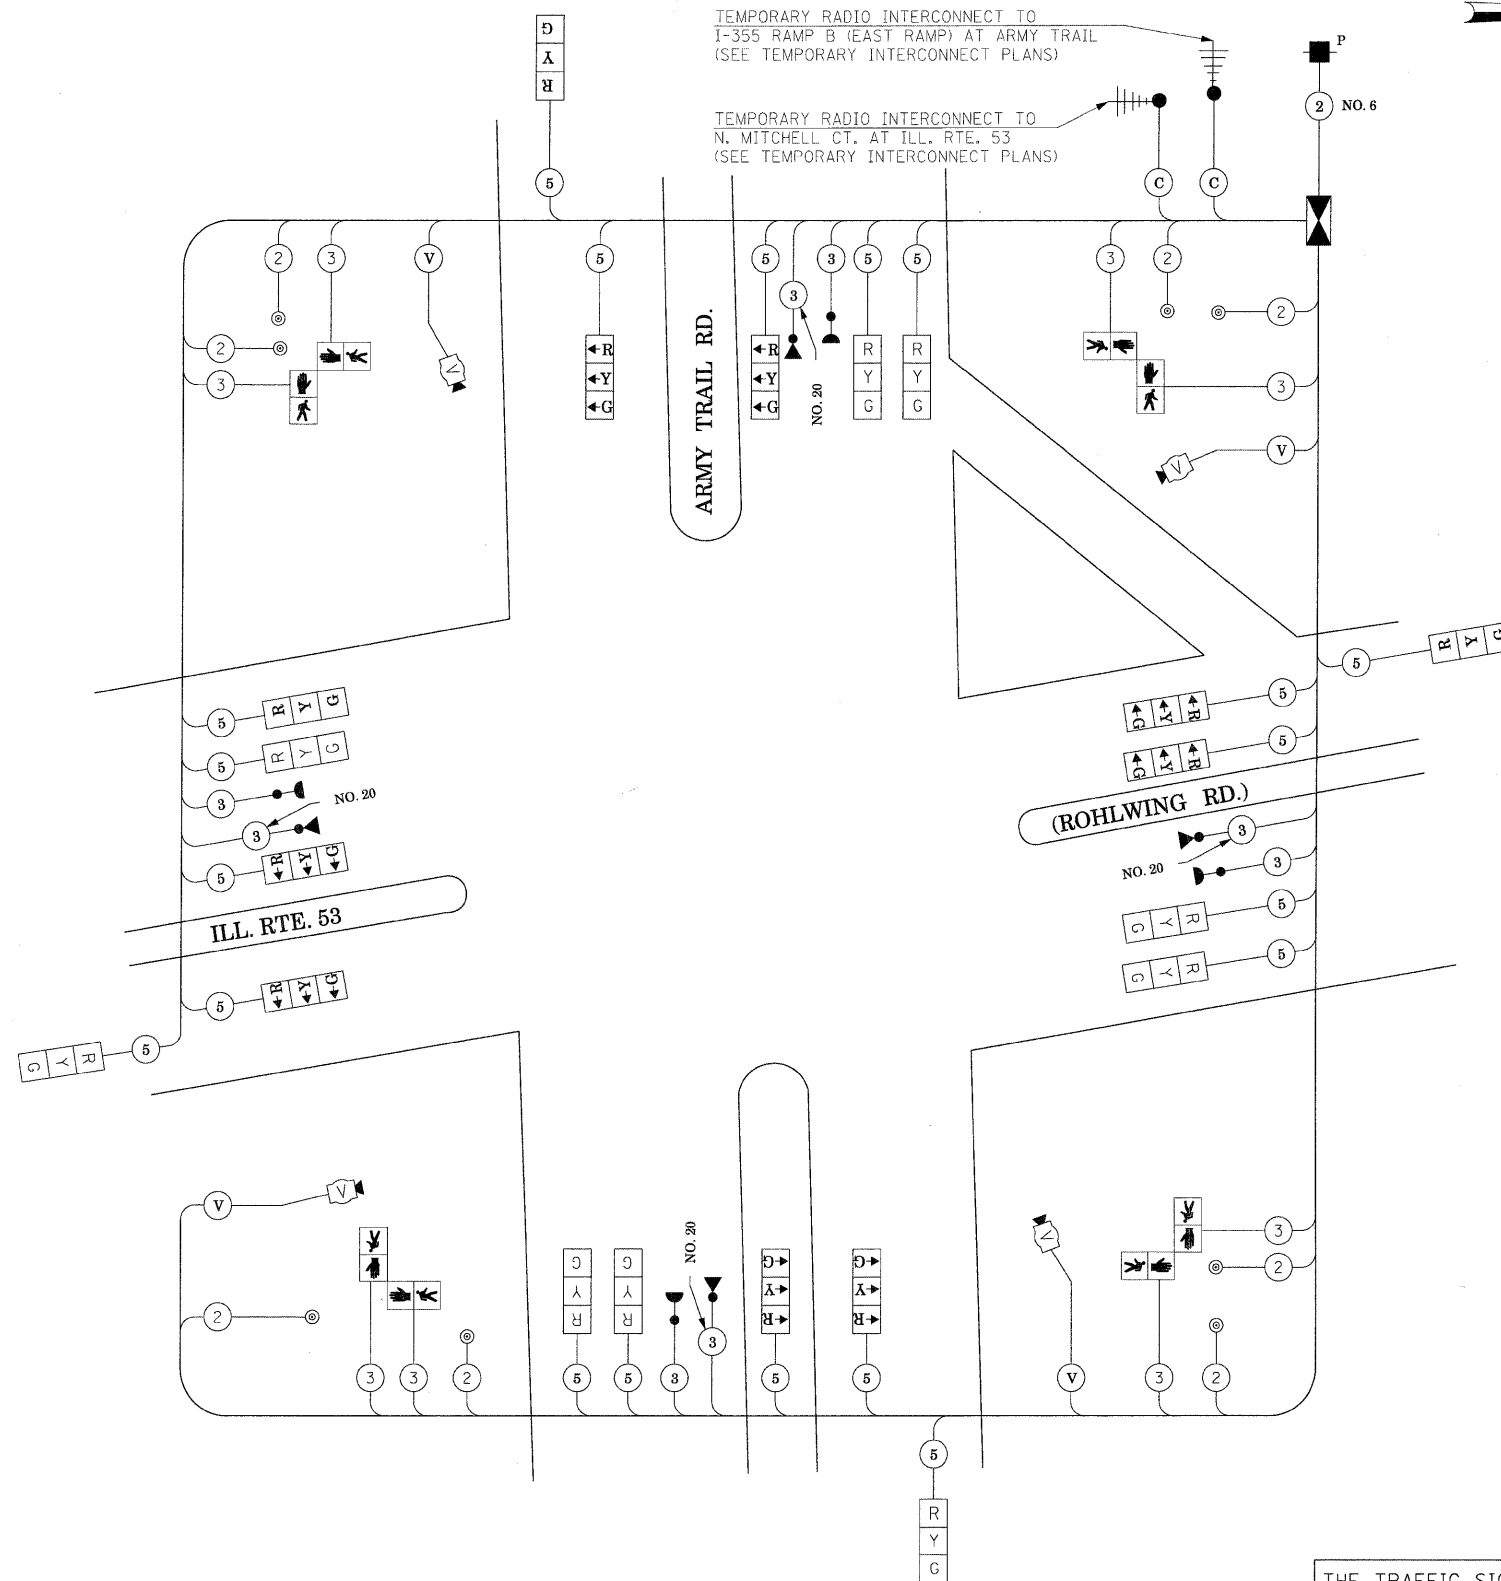

TEMPORARY CABLE PLAN

(NOT TO SCALE)
STAGES: PRE-STAGE, S1-1, S1-2, S1-3, S2-1, S2-2, S2-3, S3, AND AFTER PROPOSED ROADWAY GEOMETRICS ARE BUILT

THE TRAFFIC SIGNAL CONTROL EQUIPMENT FOR THIS PROJECT SHALL BE "ECONOLITE" TO MATCH THE EXISTING ADJACENT SYSTEM.

| I.D.O.T. TRAFFIC SIGNAL INSTALLATION ELECTRICAL SERVICE REQUIREMENTS | | | | | TOTAL WATTAGE |
|--|----------|---------|-----------|------|---------------|
| TYPE | NO LAMPS | WATTAGE | OPERATION | | |
| SIGNAL (RED) | 20 | 135 | 17 | 0.50 | 170 |
| (YELLOW) | 20 | 135 | 25 | 0.25 | 125 |
| (GREEN) | 20 | 135 | 15 | 0.25 | 75 |
| ARROW | 135 | 12 | 0.10 | | |
| PEDESTRIAN SIGNAL | 8 | 90 | 25 | 1.00 | 200 |
| CONTROLLER | 1 | 100 | 100 | 1.00 | 100 |
| ILLUM. SIGN | | 25 | | 0.05 | |
| VIDEO SYSTEM | 1 | 150 | | 1.00 | 150 |
| FLASHER | | | | 0.50 | |
| ENERGY COSTS TO: | | | TOTAL = | | 820 |

ILLINOIS DEPARTMENT OF TRANSPORTATION
201 WEST CENTER COURT
SCHAUMBURG, ILLINOIS 60196-1096
ENERGY SUPPLY CONTACT: CURTIS TOPPS
PHONE: (630) 691-4356
COMPANY: COMMONWEALTH EDISON

TEMPORARY SEQUENCE OF OPERATION (FOR STAGE 2, SUB STAGES 2,3, AND STAGE 3 WITH LEAD-LAG OPERATION FOR ILL. RTE. 53 ONLY)

| MOVEMENT | 1+5 | | | | | | | | 1+6 | | | | | | | | 2+5 | | | | | | | | 2+6 | | | | | | | | 3+8 | | | | | | | |
|---|
| | 1 | 2A | 2B | 3A | 3B | 4A | 4B | 5 | 6 | 7A | 7B | 8A | 8B | 9A | 9B | 10 | 11 | 12A | 12B | 13A | 13B | 14A | 14B | 15 | 16 | 17A | 17B | 18A | 18B | 19A | 19B | 20 | 21 | 22A | 22B | 23A | 23B | | | |
| CHANGE TO | | 1+6 | | 2+5 | | 2+6 3+8 4+7 4+8 | | ∅ | ∅ | 1+5 | | 2+5 3+8 4+7 4+8 | | 2+6 | | ∅ | ∅ | 1+5 | | 1+6 3+8 4+7 4+8 | | 2+6 | | ∅ | ∅ | 1+6 | | 2+5 | | 1+5 3+8 4+7 4+8 | | ∅ | ∅ | 1+5 1+6 2+5 2+6 4+7 | | 4+8 | | | | |
| ARMY TRAIL ROAD NEAR RIGHT AND TWO FAR RIGHT SPAN WIRE SIGNAL | E/B | R | R | R | R | R | R | R | R | R | R | R | R | R | R | G | G | Y | R | Y | R | G | G | G | G | Y | R | G | G | Y | R | R | R | R | R | R | R | | | |
| ARMY TRAIL ROAD TWO FAR LEFT SPAN WIRE SIGNALS WITH LEFT TURN ARROWS | E/B | ←G | ←Y | ←R | ←G | ←G | ←Y | ←R | ←R | ←R | ←R | ←R | ←R | ←R | ←G | ←G | ←G | ←G | ←Y | ←R | ←Y | ←R | ←R | ←R | ←R | ←R | ←R | ←R | ←R | ←R | ←R | ←R | ←R | ←R | ←R | ←R | ←R | | | |
| ARMY TRAIL ROAD NEAR RIGHT AND TWO FAR RIGHT SPAN WIRE SIGNAL | W/B | R | R | R | R | R | R | G | G | Y | R | Y | R | G | G | R | R | R | R | R | R | R | R | G | G | G | G | Y | R | Y | R | R | R | R | R | R | R | | | |
| ARMY TRAIL ROAD TWO FAR LEFT SPAN WIRE SIGNALS WITH LEFT TURN ARROWS | W/B | ←G | ←G | ←G | ←Y | ←R | ←Y | ←R | ←G | ←G | ←G | ←Y | ←R | ←Y | ←R | ←R | | | |
| ILLINOIS ROUTE 53 (ROHLWING ROAD) NEAR RIGHT AND TWO FAR RIGHT SPAN WIRE SIGNALS | N/B | R | R | G | G | Y | R | G | G |
| ILLINOIS ROUTE 53 (ROHLWING ROAD) TWO FAR LEFT SPAN WIRE SIGNALS WITH LEFT TURN ARROWS | N/B | ←R | ←R | |
| ILLINOIS ROUTE 53 (ROHLWING ROAD) NEAR RIGHT AND TWO FAR RIGHT SPAN WIRE SIGNALS | S/B | R | R | |
| ILLINOIS ROUTE 53 (ROHLWING ROAD) TWO FAR LEFT SPAN WIRE SIGNALS WITH LEFT TURN ARROWS | S/B | ←R | ←R | |
| PEDESTRIAN SIGNALS - CROSSING ILLINOIS ROUTE 53 (ROHLWING RD) ON NORTH SIDE OF ARMY TRAIL ROAD | | H | H | |
| PEDESTRIAN SIGNALS - CROSSING ILLINOIS ROUTE 53 (ROHLWING RD) ON SOUTH SIDE OF ARMY TRAIL ROAD | | H | H | |
| PEDESTRIAN SIGNALS - CROSSING ARMY TRAIL ROAD ON EAST SIDE OF ILLINOIS ROUTE 53 (ROHLWING RD) | | H | H | |
| PEDESTRIAN SIGNALS - CROSSING ARMY TRAIL ROAD ON WEST SIDE OF ILLINOIS ROUTE 53 (ROHLWING RD) | | H | H | |

| MOVEMENT | 4+8 | | | | | | | | 4+7 | | | | | | | | F L A S H |
|---|-----|----|------|-----|-----|-----|--------------------------|-----|-----|------|---------------------------------|-----|-----|-----|--|--|-----------------------|
| | 24 | 25 | 26A | 26B | 27A | 27B | 28A | 28B | 29 | 30 | 31A | 31B | 32A | 32B | | | |
| CHANGE TO | | | 4+7 | | 3+8 | | 1+5 1+6 2+5 2+6 | | | | 1+5 1+6 2+5 2+6 3+8 | | 4+8 | | | | |
| ARMY TRAIL ROAD NEAR RIGHT AND TWO FAR RIGHT SPAN WIRE SIGNAL | E/B | R | R | R | R | R | R | R | R | R | R | R | R | R | | | |
| ARMY TRAIL ROAD TWO FAR LEFT SPAN WIRE SIGNALS WITH LEFT TURN ARROWS | E/B | ←R | ←R | ←R | ←R | ←R | ←R | ←R | ←R | ←R | ←R | ←R | ←R | ←R | | | |
| ARMY TRAIL ROAD NEAR RIGHT AND TWO FAR RIGHT SPAN WIRE SIGNAL | W/B | R | R | R | R | R | R | R | R | R | R | R | R | R | | | |
| ARMY TRAIL ROAD TWO FAR LEFT SPAN WIRE SIGNALS WITH LEFT TURN ARROWS | W/B | ←R | ←R | ←R | ←R | ←R | ←R | ←R | ←R | ←R | ←R | ←R | ←R | ←R | | | |
| ILLINOIS ROUTE 53 (ROHLWING ROAD) NEAR RIGHT AND TWO FAR RIGHT SPAN WIRE SIGNALS | N/B | G | G | Y | R | G | G | Y | R | R | R | R | R | R | | | |
| ILLINOIS ROUTE 53 (ROHLWING ROAD) TWO FAR LEFT SPAN WIRE SIGNALS WITH LEFT TURN ARROWS | N/B | ←R | ←R | ←R | ←R | ←R | ←R | ←R | ←R | ←R | ←R | ←R | ←R | ←R | | | |
| ILLINOIS ROUTE 53 (ROHLWING ROAD) NEAR RIGHT AND TWO FAR RIGHT SPAN WIRE SIGNALS | S/B | G | G | G | Y | R | Y | R | G | G | Y | R | G | G | | | |
| ILLINOIS ROUTE 53 (ROHLWING ROAD) TWO FAR LEFT SPAN WIRE SIGNALS WITH LEFT TURN ARROWS | S/B | ←R | ←R | ←R | ←R | ←R | ←R | ←R | ←G | ←G | ←Y | ←R | ←Y | ←R | | | |
| PEDESTRIAN SIGNALS - CROSSING ILLINOIS ROUTE 53 (ROHLWING RD) ON NORTH SIDE OF ARMY TRAIL ROAD | | H | H | H | H | H | H | H | H | H | H | H | H | H | | | |
| PEDESTRIAN SIGNALS - CROSSING ILLINOIS ROUTE 53 (ROHLWING RD) ON SOUTH SIDE OF ARMY TRAIL ROAD | | H | H | H | H | H | H | H | H | H | H | H | H | H | | | |
| PEDESTRIAN SIGNALS - CROSSING ARMY TRAIL ROAD ON EAST SIDE OF ILLINOIS ROUTE 53 (ROHLWING RD) | | *P | **FH | H | H | H | H | H | H | H | H | H | H | H | | | |
| PEDESTRIAN SIGNALS - CROSSING ARMY TRAIL ROAD ON WEST SIDE OF ILLINOIS ROUTE 53 (ROHLWING RD) | | *P | **FH | H | H | H | H | H | *P | **FH | H | H | H | H | | | |

P = ILLUMINATED PERSON = WALK
 FH = ILLUMINATED FLASHING HAND = FLASHING DON'T WALK
 H = ILLUMINATED SOLID HAND = DON'T WALK
 PHASE 2 + 6 SHALL BE PLACED ON RECALL.

- * TO APPEAR ONLY UPON PUSHBUTTON ACTUATION.
- ** FLASHING " [] " IS TO TERMINATE AT THE COMPLETION OF THE PEDESTRIAN INTERVAL CLEARANCE.
- ∅ THIS " [] " OR FLASHING " [] " INTERVAL MAY FINISH TIMING IN THE BI-DIRECTIONAL STRAIGHT THROUGH MOVEMENT IF THE LEFT ARROW TIME IS NOT SUFFICIENT TO COMPLETE " [] " OR FLASHING " [] " INTERVALS. " [] " AND FLASHING " [] " TIMINGS TO BE SET ONLY ON THE PHASES WHERE " [] " AND FLASHING " [] " ARE INDICATED IN THE SEQUENCE OF OPERATION.

THE TRAFFIC SIGNAL CONTROL EQUIPMENT FOR THIS PROJECT SHALL BE "ECONOLITE" TO MATCH THE EXISTING ADJACENT SYSTEM.

TEMPORARY EMERGENCY VEHICLE PREEMPTION SEQUENCE OF OPERATION (FOR STAGE 2, SUB STAGES 2,3, AND STAGE 3 WITH LEAD-LAG OPERATION FOR ILL. RTE. 53 ONLY)

| CHANGE FROM NORMAL SEQUENCE OF OPERATION INTERVAL NUMBER | 1 | | 1 | | 1 | | 5 | | | 5 | | 10 | | | 10 | | 15 | | | 15 | | | 15 | | | 20 | | 20 | | 24 | | | 24 | | | 24 | | |
|--|-----|----|----|-----|----|----|----|----|-------|----|----|----|-------|----|----|----|----|----|----|-----|----|----|----|-----|-----|-------|-----|-----|-----|-----|-----|-----|-----|-----|-----|-----|---|--|
| EMERGENCY VEHICLE PRE-EMPTION SEQUENCE OF OPERATION INTERVAL NUMBER | 1A | 1B | 1C | 1D | 1E | 1F | 1G | 1H | 1J | 1K | 1L | 1M | 1N | 1P | 1Q | 1R | 1S | 1T | 1U | 1V | 1W | 1X | 1Y | 1Z | 1AA | 1BB | 1CC | 1DD | 1EE | 1FF | 1GG | 1HH | 1JJ | 1KK | 1LL | 1MM | | |
| CHANGE TO EMERGENCY VEHICLE PRE-EMPTION SEQUENCE OF OPERATION INTERVAL NUMBER | 1B | 2 | 1D | 3,5 | 1F | 4 | 1H | 1J | 2,3,5 | 4 | 1M | 1N | 3,4,5 | 2 | 1R | 1S | 2 | 1U | 1V | 3,5 | 1X | 1Y | 4 | 1AA | 1BB | 2,3,4 | 5 | 1EE | 1FF | 2,4 | 1HH | 1JJ | 3 | 1LL | 1MM | 5 | | |
| ARMY TRAIL ROAD NEAR RIGHT AND TWO FAR RIGHT SPAN WIRE SIGNAL | E/B | R | R | R | R | R | R | R | R | R | G | Y | R | G | G | G | G | C | Y | R | G | Y | R | R | R | R | R | R | R | R | R | R | R | R | R | R | R | |
| ARMY TRAIL ROAD TWO FAR LEFT SPAN WIRE SIGNALS WITH LEFT TURN ARROWS | E/B | ←G | ←G | ←Y | ←R | ←Y | ←R | ←R | ←R | ←R | ←G | ←Y | ←R | ←G | ←R | ←R | | |
| ARMY TRAIL ROAD NEAR RIGHT AND TWO FAR RIGHT SPAN WIRE SIGNAL | W/B | R | R | R | R | R | G | Y | R | G | R | R | R | R | G | Y | R | G | Y | R | G | G | G | R | R | R | R | R | R | R | R | R | R | R | R | R | R | |
| ARMY TRAIL ROAD TWO FAR LEFT SPAN WIRE SIGNALS WITH LEFT TURN ARROWS | W/B | ←Y | ←R | ←Y | ←R | ←G | ←G | ←G | ←Y | ←R | ←G | ←R | ←R | | |
| ILLINOIS ROUTE 53 (ROHLWING ROAD) NEAR RIGHT AND TWO FAR RIGHT SPAN WIRE SIGNALS | N/B | R | R | G | Y | R | G | G | Y | R | G | Y | R | G | G | G | |
| ILLINOIS ROUTE 53 (ROHLWING ROAD) TWO FAR LEFT SPAN WIRE SIGNALS WITH LEFT TURN ARROWS | N/B | ←R | ←R | ←G | ←Y | ←R | ←G | ←R | ←R | ←R | ←R | ←R | ←R | ←R | ←R | ←R | | |
| ILLINOIS ROUTE 53 (ROHLWING ROAD) NEAR RIGHT AND TWO FAR RIGHT SPAN WIRE SIGNALS | S/B | R | R | G | Y | R | G | G | G | G | Y | R | |
| ILLINOIS ROUTE 53 (ROHLWING ROAD) TWO FAR LEFT SPAN WIRE SIGNALS WITH LEFT TURN ARROWS | S/B | ←R | ←R | | |
| PEDESTRIAN SIGNALS - CROSSING ILLINOIS ROUTE 53 (ROHLWING RD) ON NORTH SIDE OF ARMY TRAIL ROAD | | H | H | H | H | H | H | H | H | H | FH | H | H | FH | FH | H | H | FH | H | H | FH | H | H | H | H | H | H | H | H | H | H | H | H | H | H | H | | |
| PEDESTRIAN SIGNALS - CROSSING ILLINOIS ROUTE 53 (ROHLWING RD) ON SOUTH SIDE OF ARMY TRAIL ROAD | | H | H | H | H | H | H | H | H | H | FH | H | H | FH | FH | H | H | FH | H | H | FH | H | H | H | H | H | H | H | H | H | H | H | H | H | H | H | | |
| PEDESTRIAN SIGNALS - CROSSING ARMY TRAIL ROAD ON EAST SIDE OF ILLINOIS ROUTE 53 (ROHLWING RD) | | H | H | FH | H | H | FH | FH | H | H | FH | H | H | FH | H | H | | |
| PEDESTRIAN SIGNALS - CROSSING ARMY TRAIL ROAD ON WEST SIDE OF ILLINOIS ROUTE 53 (ROHLWING RD) | | H | H | FH | H | H | FH | H | H | FH | H | H | | |


| CHANGE FROM NORMAL SEQUENCE OF OPERATION INTERVAL NUMBER | 29 | | 29 | | PREEMPTOR NUMBER 3 | PREEMPTOR NUMBER 4 | PREEMPTOR NUMBER 5 | PREEMPTOR NUMBER 6 | CLEAR TO NORMAL SEQUENCE | |
|--|-----|-----|-------|-----|--------------------|--------------------|--------------------|--------------------|--------------------------|---|
| EMERGENCY VEHICLE PRE-EMPTION SEQUENCE OF OPERATION INTERVAL NUMBER | 1NN | 1PP | 1QQ | 1RR | 2 | 3 | 4 | 5 | | |
| CHANGE TO EMERGENCY VEHICLE PRE-EMPTION SEQUENCE OF OPERATION INTERVAL NUMBER | 1PP | 1QQ | 2,4,5 | 3 | | | | | | |
| ARMY TRAIL ROAD NEAR RIGHT AND TWO FAR RIGHT SPAN WIRE SIGNAL | E/B | R | R | R | R | G | R | R | R | ◇ |
| ARMY TRAIL ROAD TWO FAR LEFT SPAN WIRE SIGNALS WITH LEFT TURN ARROWS | E/B | ←R | ←R | ←R | ←R | ←G | ←R | ←R | ←R | ◇ |
| ARMY TRAIL ROAD NEAR RIGHT AND TWO FAR RIGHT SPAN WIRE SIGNAL | W/B | R | R | R | R | R | R | G | R | ◇ |
| ARMY TRAIL ROAD TWO FAR LEFT SPAN WIRE SIGNALS WITH LEFT TURN ARROWS | W/B | ←R | ←R | ←R | ←R | ←R | ←R | ←G | ←R | ◇ |
| ILLINOIS ROUTE 53 (ROHLWING ROAD) NEAR RIGHT AND TWO FAR RIGHT SPAN WIRE SIGNALS | N/B | R | R | R | R | R | R | R | G | ◇ |
| ILLINOIS ROUTE 53 (ROHLWING ROAD) TWO FAR LEFT SPAN WIRE SIGNALS WITH LEFT TURN ARROWS | N/B | ←R | ←R | ←R | ←R | ←R | ←R | ←R | ←G | ◇ |
| ILLINOIS ROUTE 53 (ROHLWING ROAD) NEAR RIGHT AND TWO FAR RIGHT SPAN WIRE SIGNALS | S/B | G | Y | R | G | R | G | R | R | ◇ |
| ILLINOIS ROUTE 53 (ROHLWING ROAD) TWO FAR LEFT SPAN WIRE SIGNALS WITH LEFT TURN ARROWS | S/B | ←G | ←Y | ←R | ←G | ←R | ←G | ←R | ←R | ◇ |
| PEDESTRIAN SIGNALS - CROSSING ILLINOIS ROUTE 53 (ROHLWING RD) ON NORTH SIDE OF ARMY TRAIL ROAD | | H | H | H | H | H | H | H | H | ◇ |
| PEDESTRIAN SIGNALS - CROSSING ILLINOIS ROUTE 53 (ROHLWING RD) ON SOUTH SIDE OF ARMY TRAIL ROAD | | H | H | H | H | H | H | H | H | ◇ |
| PEDESTRIAN SIGNALS - CROSSING ARMY TRAIL ROAD ON EAST SIDE OF ILLINOIS ROUTE 53 (ROHLWING RD) | | H | H | H | H | H | H | H | H | ◇ |
| PEDESTRIAN SIGNALS - CROSSING ARMY TRAIL ROAD ON WEST SIDE OF ILLINOIS ROUTE 53 (ROHLWING RD) | | FH | H | H | FH | H | H | H | H | ◇ |

◇ EMERGENCY VEHICLE SEQUENCE SHALL PROVIDE THE PROPER CLEARANCE INTERVAL TO RESUME THE NORMAL SEQUENCE OF OPERATION OR PROPER CLEARANCE INTERVAL TO DISPLAY A DIFFERENT EMERGENCY VEHICLE INTERVAL AFTER EMERGENCY VEHICLE INTERVAL 2, 3, 4, OR 5 IS TERMINATED.

THE TRAFFIC SIGNAL CONTROL EQUIPMENT FOR THIS PROJECT SHALL BE "ECONOLITE" TO MATCH THE EXISTING ADJACENT SYSTEM.







THE CATALOG CUTS FOR STEEL COMBINATION MAST ARM ASSEMBLY AND POLE WITH DUAL MAST ARMS WILL NEED APPROVAL FROM THE BRIDGE OFFICE.

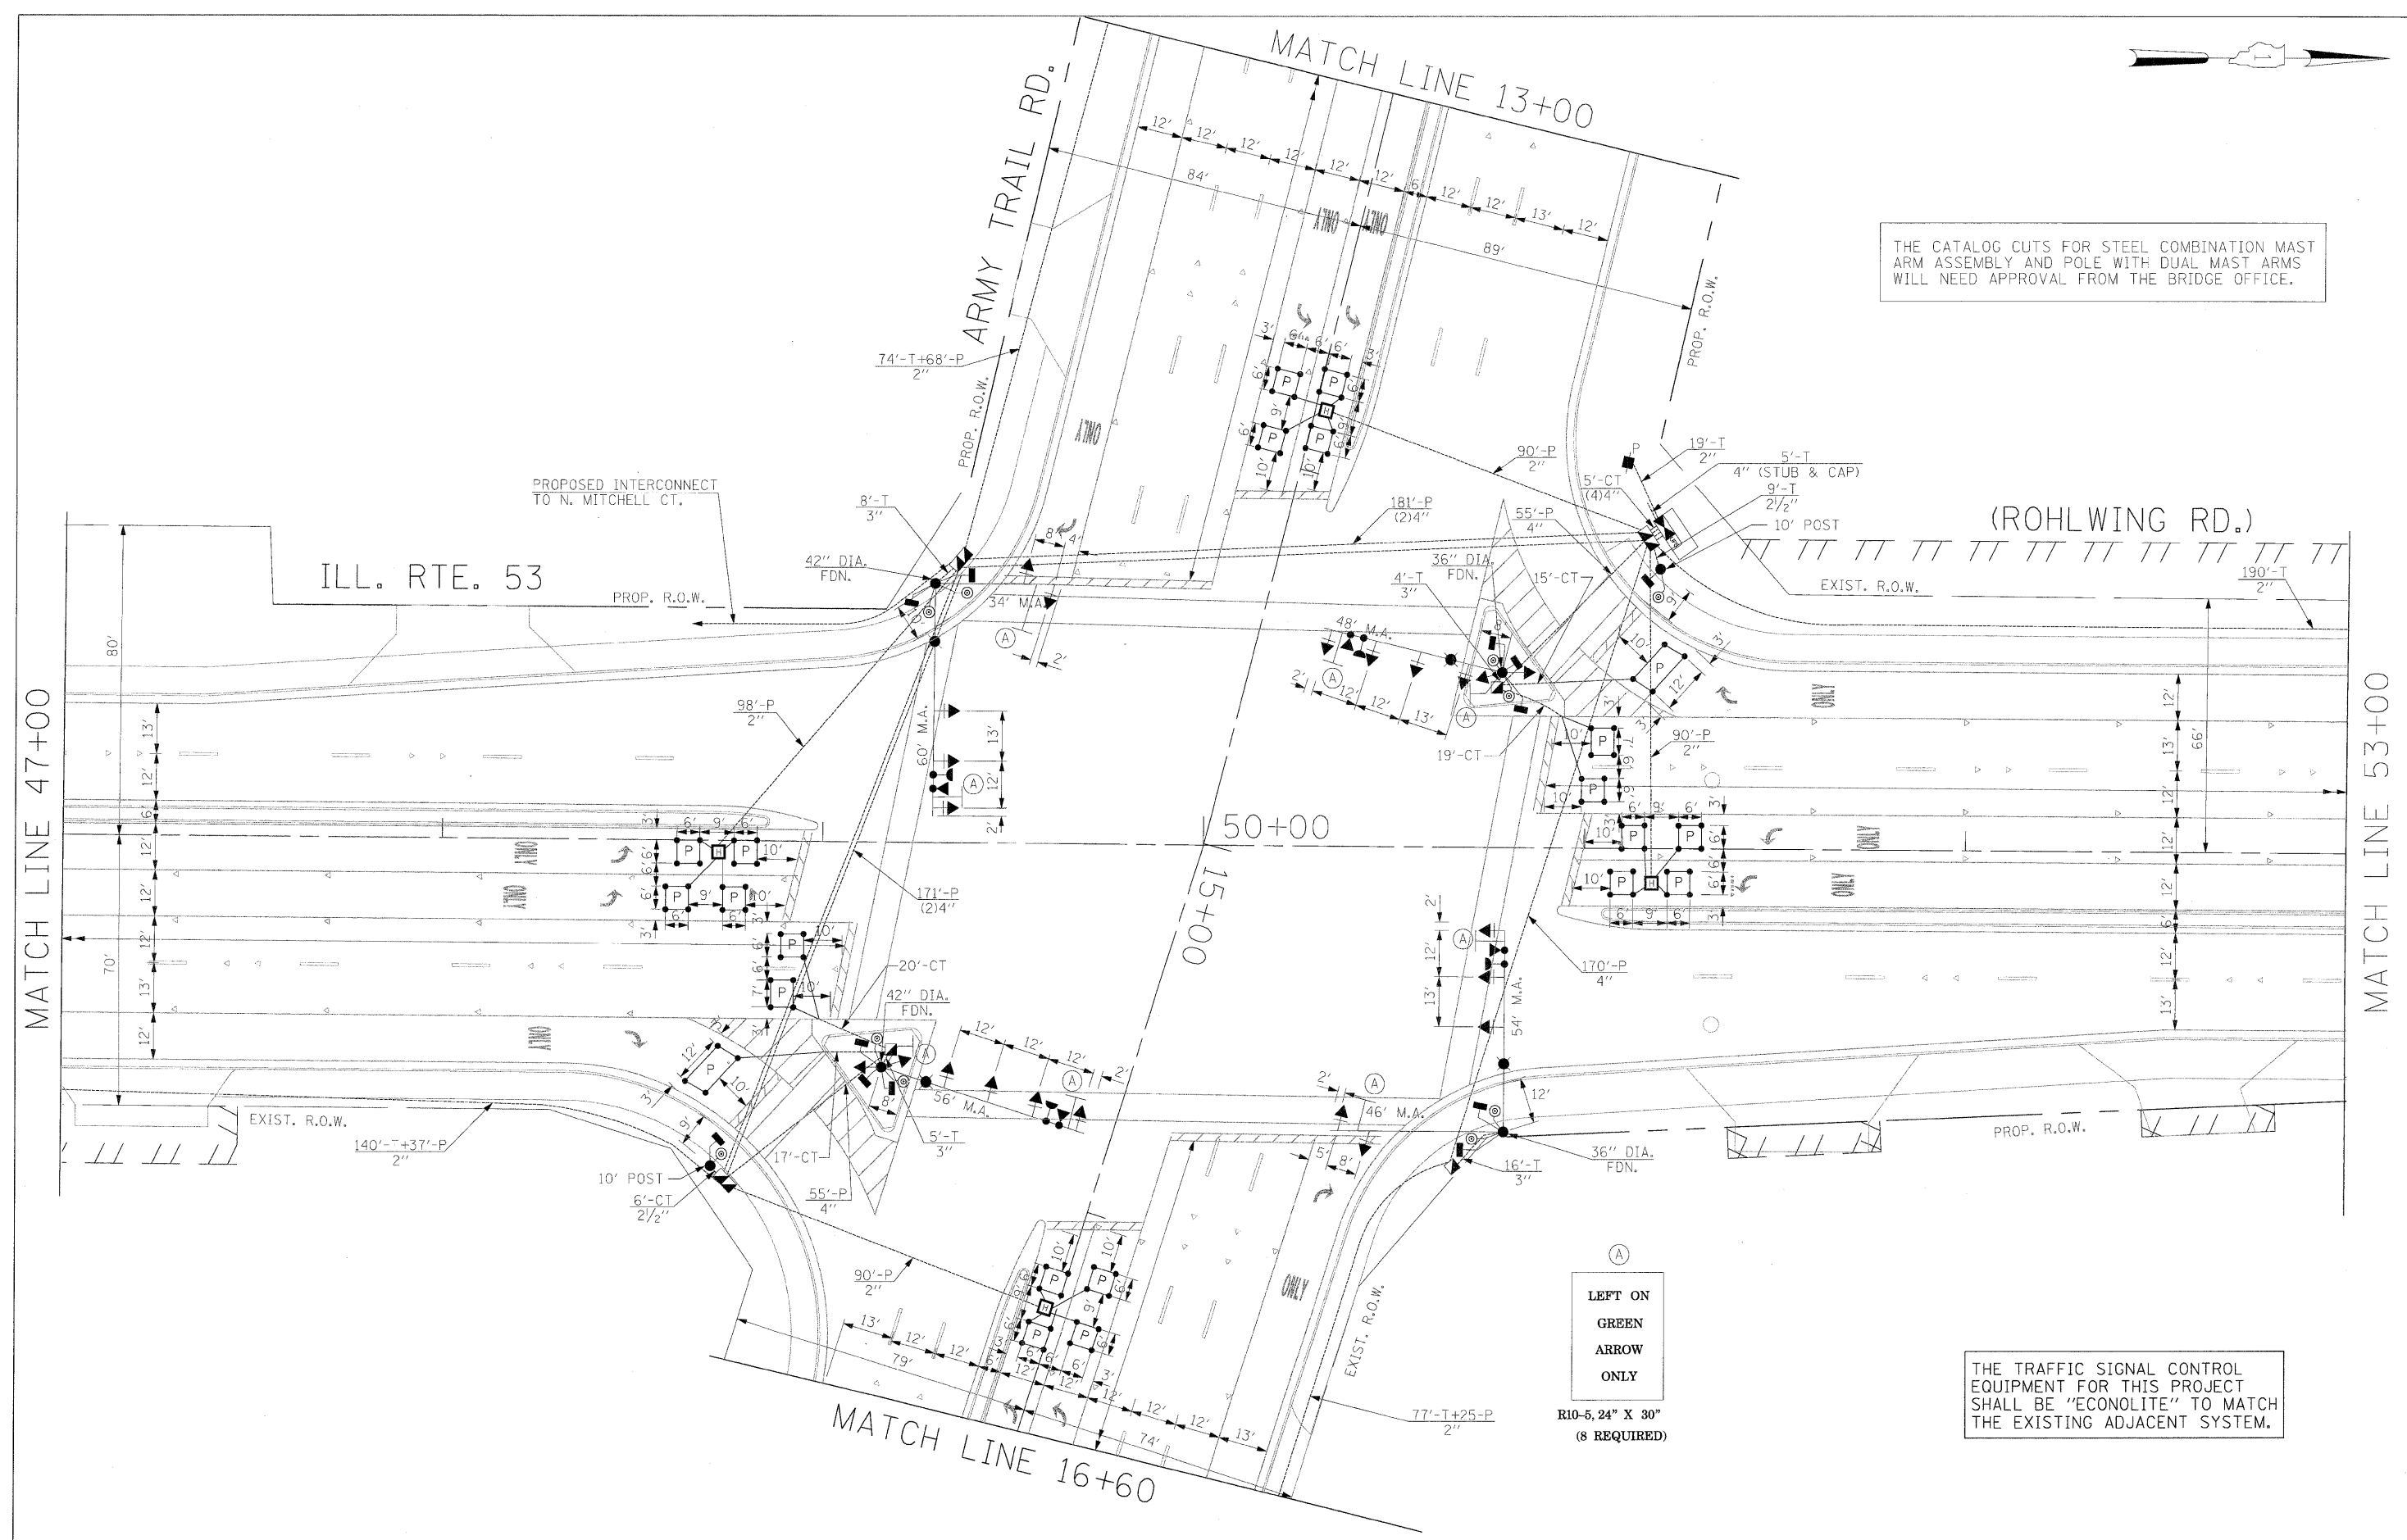

(A)
LEFT ON
GREEN
ARROW
ONLY
R10-5, 24" X 30"
(8 REQUIRED)

THE TRAFFIC SIGNAL CONTROL EQUIPMENT FOR THIS PROJECT SHALL BE "ECONOLITE" TO MATCH THE EXISTING ADJACENT SYSTEM.

| | | | | | | | | | | | | |
|-------------|--------------------|-------------------|-----------|---|---|---------------------|--------------|---|---------|--------|--------------|-----------|
| FILE NAME = | USER NAME = *USER# | DESIGNED - PKG | REVISED - | STATE OF ILLINOIS DEPARTMENT OF TRANSPORTATION | TRAFFIC SIGNAL INSTALLATION PLAN | | | F.A.P. RTE. | SECTION | COUNTY | TOTAL SHEETS | SHEET NO. |
| #FILE# | | DRAWN - MAA, EA | REVISED - | | ILLINOIS ROUTE 53 (ROHLWING RD.) AT ARMY TRAIL RD. | | | 2578 | 532B | DuPage | 781 | 445 |
| | | CHECKED - PKG, EA | REVISED - | | (SHEET 1 OF 2) | | | CONTRACT NO. 60477 | | | | |
| | | DATE - 5/10/2010 | REVISED - | | SCALE: 1"=20' | SHEET NO. OF SHEETS | STA. TO STA. | FED. ROAD DIST. NO. ILLINOIS FED. AID PROJECT | | | | |

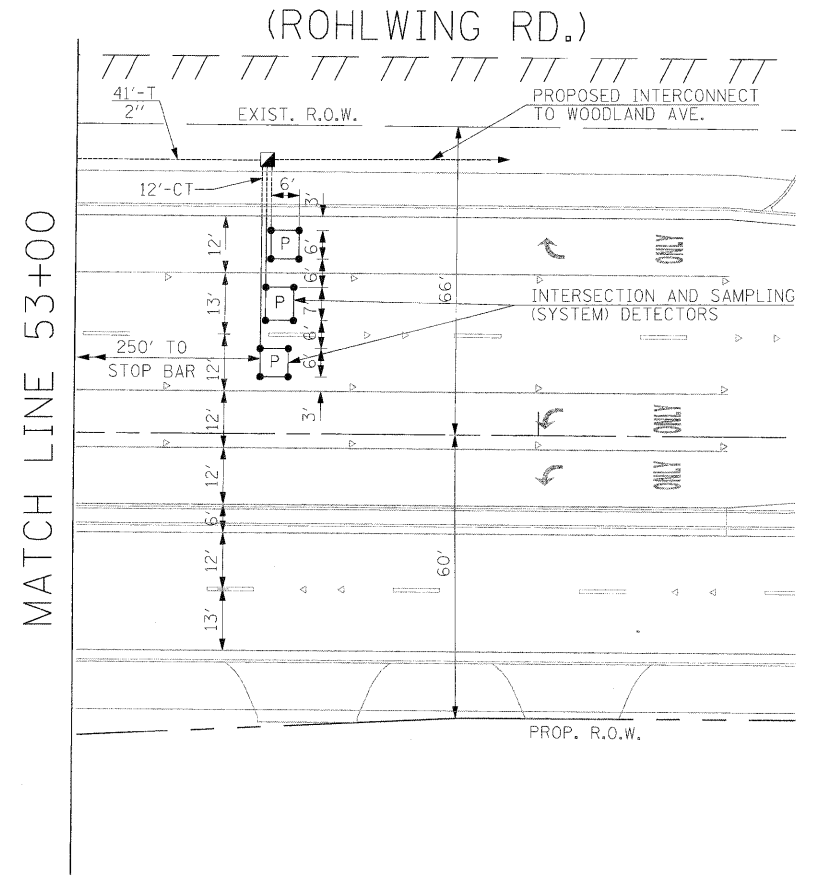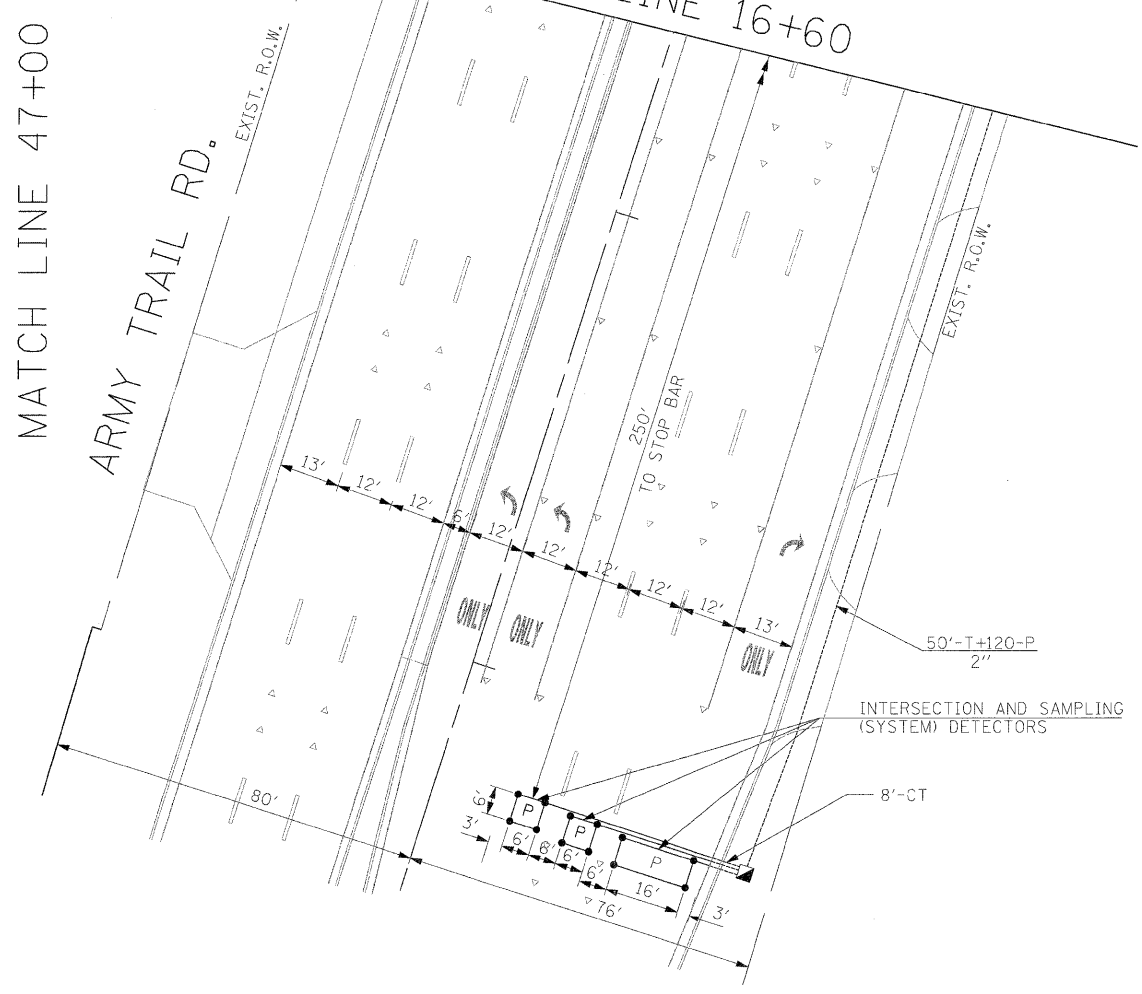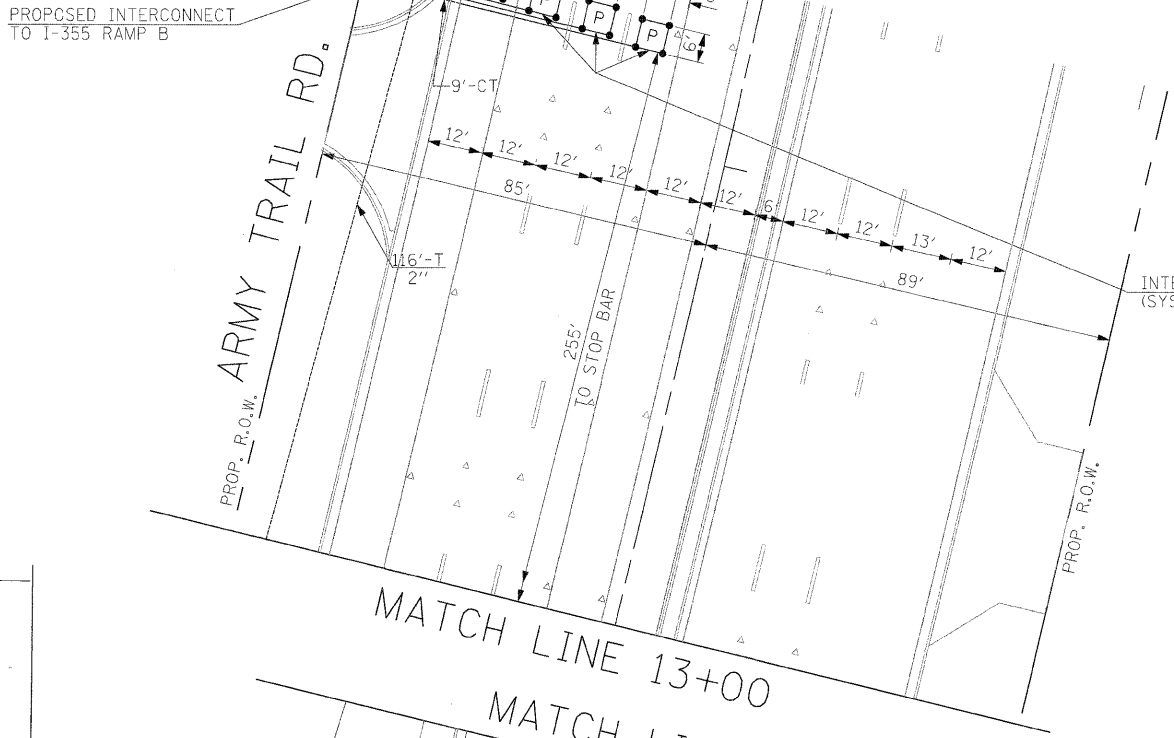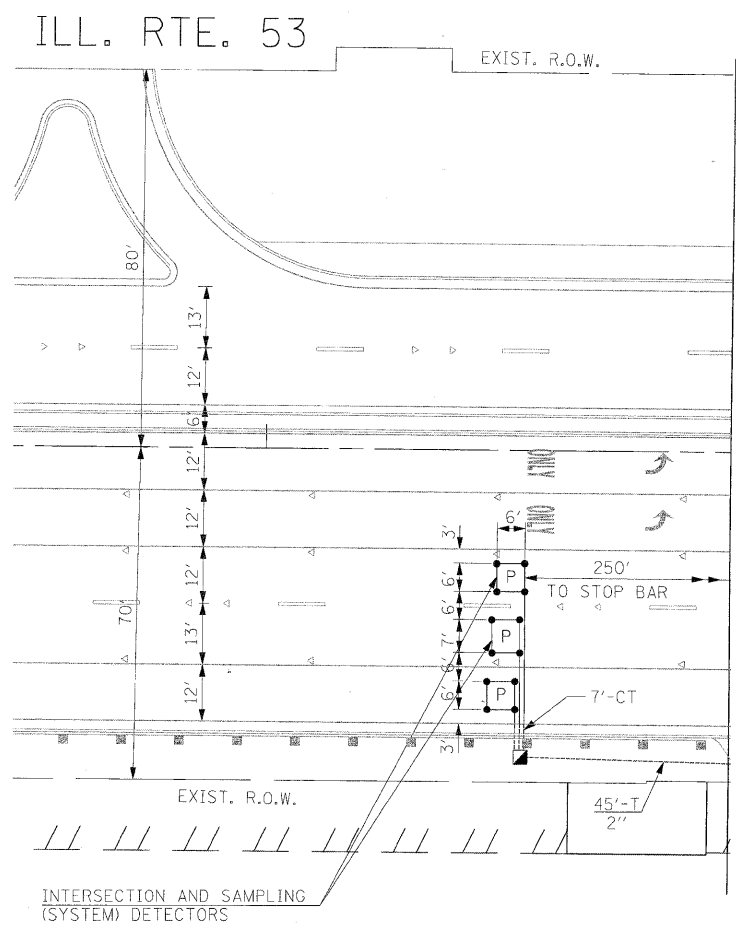

THE TRAFFIC SIGNAL CONTROL EQUIPMENT FOR THIS PROJECT SHALL BE "ECONOLITE" TO MATCH THE EXISTING ADJACENT SYSTEM.


| | | | | | | | | | | | | |
|------------------------|----------------------|-------------------|-----------|---|---|--------------------------|---------|---|-----------------|------------------|------------------------|---------------------|
| FILE NAME = #FILEL# | USER NAME = #USER# | DESIGNED - PKG | REVISED - | STATE OF ILLINOIS DEPARTMENT OF TRANSPORTATION | TRAFFIC SIGNAL INSTALLATION PLAN ILLINOIS ROUTE 53 (ROHLWING RD.) AT ARMY TRAIL RD. (SHEET 2 OF 2) | | | F.A.P. RTE. 2578 | SECTION 532B | COUNTY DuPage | TOTAL SHEETS 781 | SHEET NO. 446 |
| | PLOT SCALE = #SCALE# | DRAWN - MAA, EA | REVISED - | | SCALE: 1"=20' | SHEET NO. OF SHEETS STA. | TO STA. | CONTRACT NO. 60477 | | | | |
| | PLOT DATE = #DATE# | CHECKED - PKG, EA | REVISED - | | | | | FED. ROAD DIST. NO. - [ILLINOIS] FED. AID PROJECT | | | | |
| | | DATE - 5/10/2010 | REVISED - | | | | | | | | | |



THE END OF THE TRACER CABLE SHALL BE CONTINUOUS AND EXTEND INTO THE CONTROLLER CABINET.

THE END OF THE TRACER CABLE SHALL BE CONTINUOUS AND EXTEND INTO THE CONTROLLER CABINET.

THE END OF THE TRACER CABLE SHALL BE CONTINUOUS AND EXTEND INTO THE CONTROLLER CABINET.

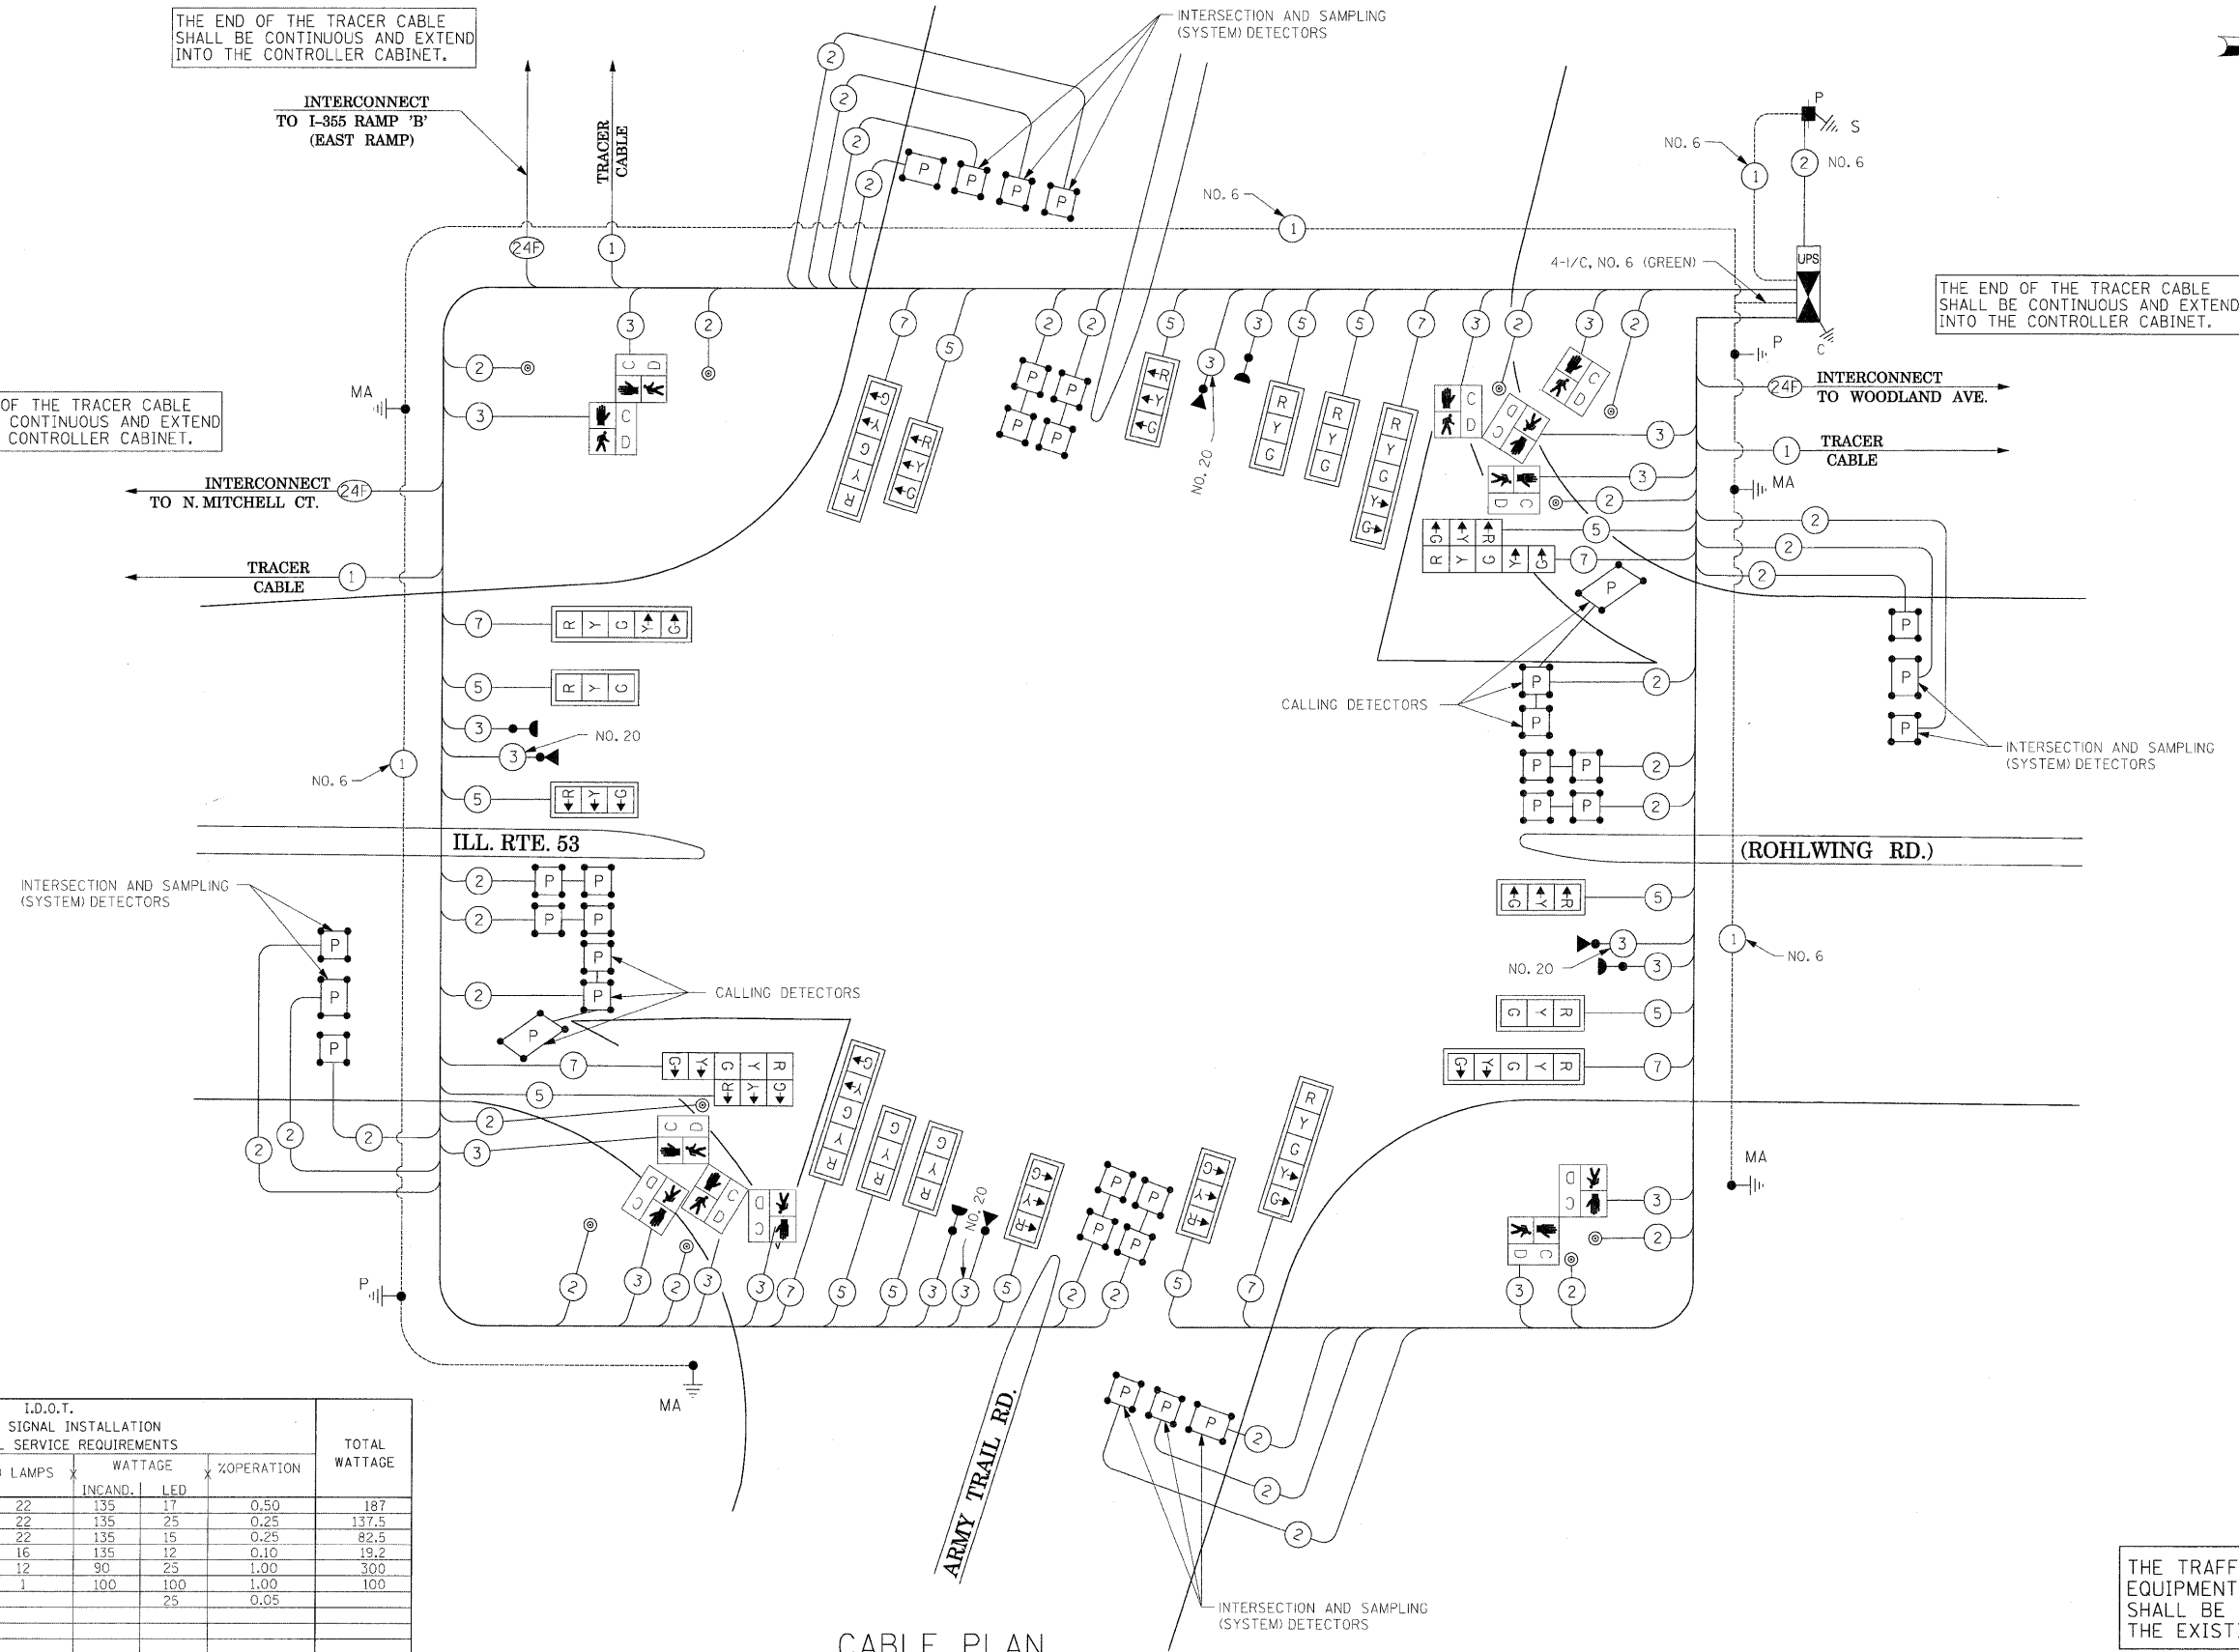

CABLE PLAN
(NOT TO SCALE)

THE TRAFFIC SIGNAL CONTROL EQUIPMENT FOR THIS PROJECT SHALL BE "ECONOLITE" TO MATCH THE EXISTING ADJACENT SYSTEM.

| I.D.O.T. TRAFFIC SIGNAL INSTALLATION ELECTRICAL SERVICE REQUIREMENTS | | | | | |
|--|----------|---------|-----|------------|---------------|
| TYPE | NO LAMPS | WATTAGE | | %OPERATION | TOTAL WATTAGE |
| | | INCAND. | LED | | |
| SIGNAL (RED) | 22 | 135 | 17 | 0.50 | 187 |
| (YELLOW) | 22 | 135 | 25 | 0.25 | 137.5 |
| (GREEN) | 22 | 135 | 15 | 0.25 | 82.5 |
| ARROW | 16 | 135 | 12 | 0.10 | 19.2 |
| PED. SIGNAL | 12 | 90 | 25 | 1.00 | 300 |
| CONTROLLER | 1 | 100 | 100 | 1.00 | 100 |
| ILLUM. SIGN | | | 25 | 0.05 | |
| FLASHER | | | | 0.50 | |
| ENERGY COSTS TO: | | | | TOTAL = | 826.2 |

ILLINOIS DEPARTMENT OF TRANSPORTATION
201 WEST CENTER COURT
SCHAUMBURG, ILLINOIS 60196-1096

ENERGY SUPPLY CONTACT: CURTIS TOPPS
PHONE: (630) 691-4356
COMPANY: COMMONWEALTH EDISON

| | | | |
|-------------|--------------------|-------------------|-----------|
| FILE NAME = | USER NAME = #USER# | DESIGNED - PKG | REVISED - |
| #FILE# | | DRAWN - MAA, EA | REVISED - |
| | | CHECKED - PKG, EA | REVISED - |
| | | DATE - 5/10/2010 | REVISED - |

STATE OF ILLINOIS
DEPARTMENT OF TRANSPORTATION

CABLE PLAN
ILLINOIS ROUTE 53 (ROHLWING RD.) AT ARMY TRAIL RD.

SCALE: NONE SHEET NO. OF SHEETS STA. TO STA.


| | | | | |
|---|--------------|---------------|------------------|---------------|
| F.A.P. RTE. 2578 | SECTION 532B | COUNTY DuPage | TOTAL SHEETS 781 | SHEET NO. 447 |
| CONTRACT NO. 60477 | | | | |
| FED. ROAD DIST. NO. - ILLINOIS FED. AID PROJECT | | | | |



WOODLAND AVE.

ILL. RTE. 53

(ROHLWING RD.)

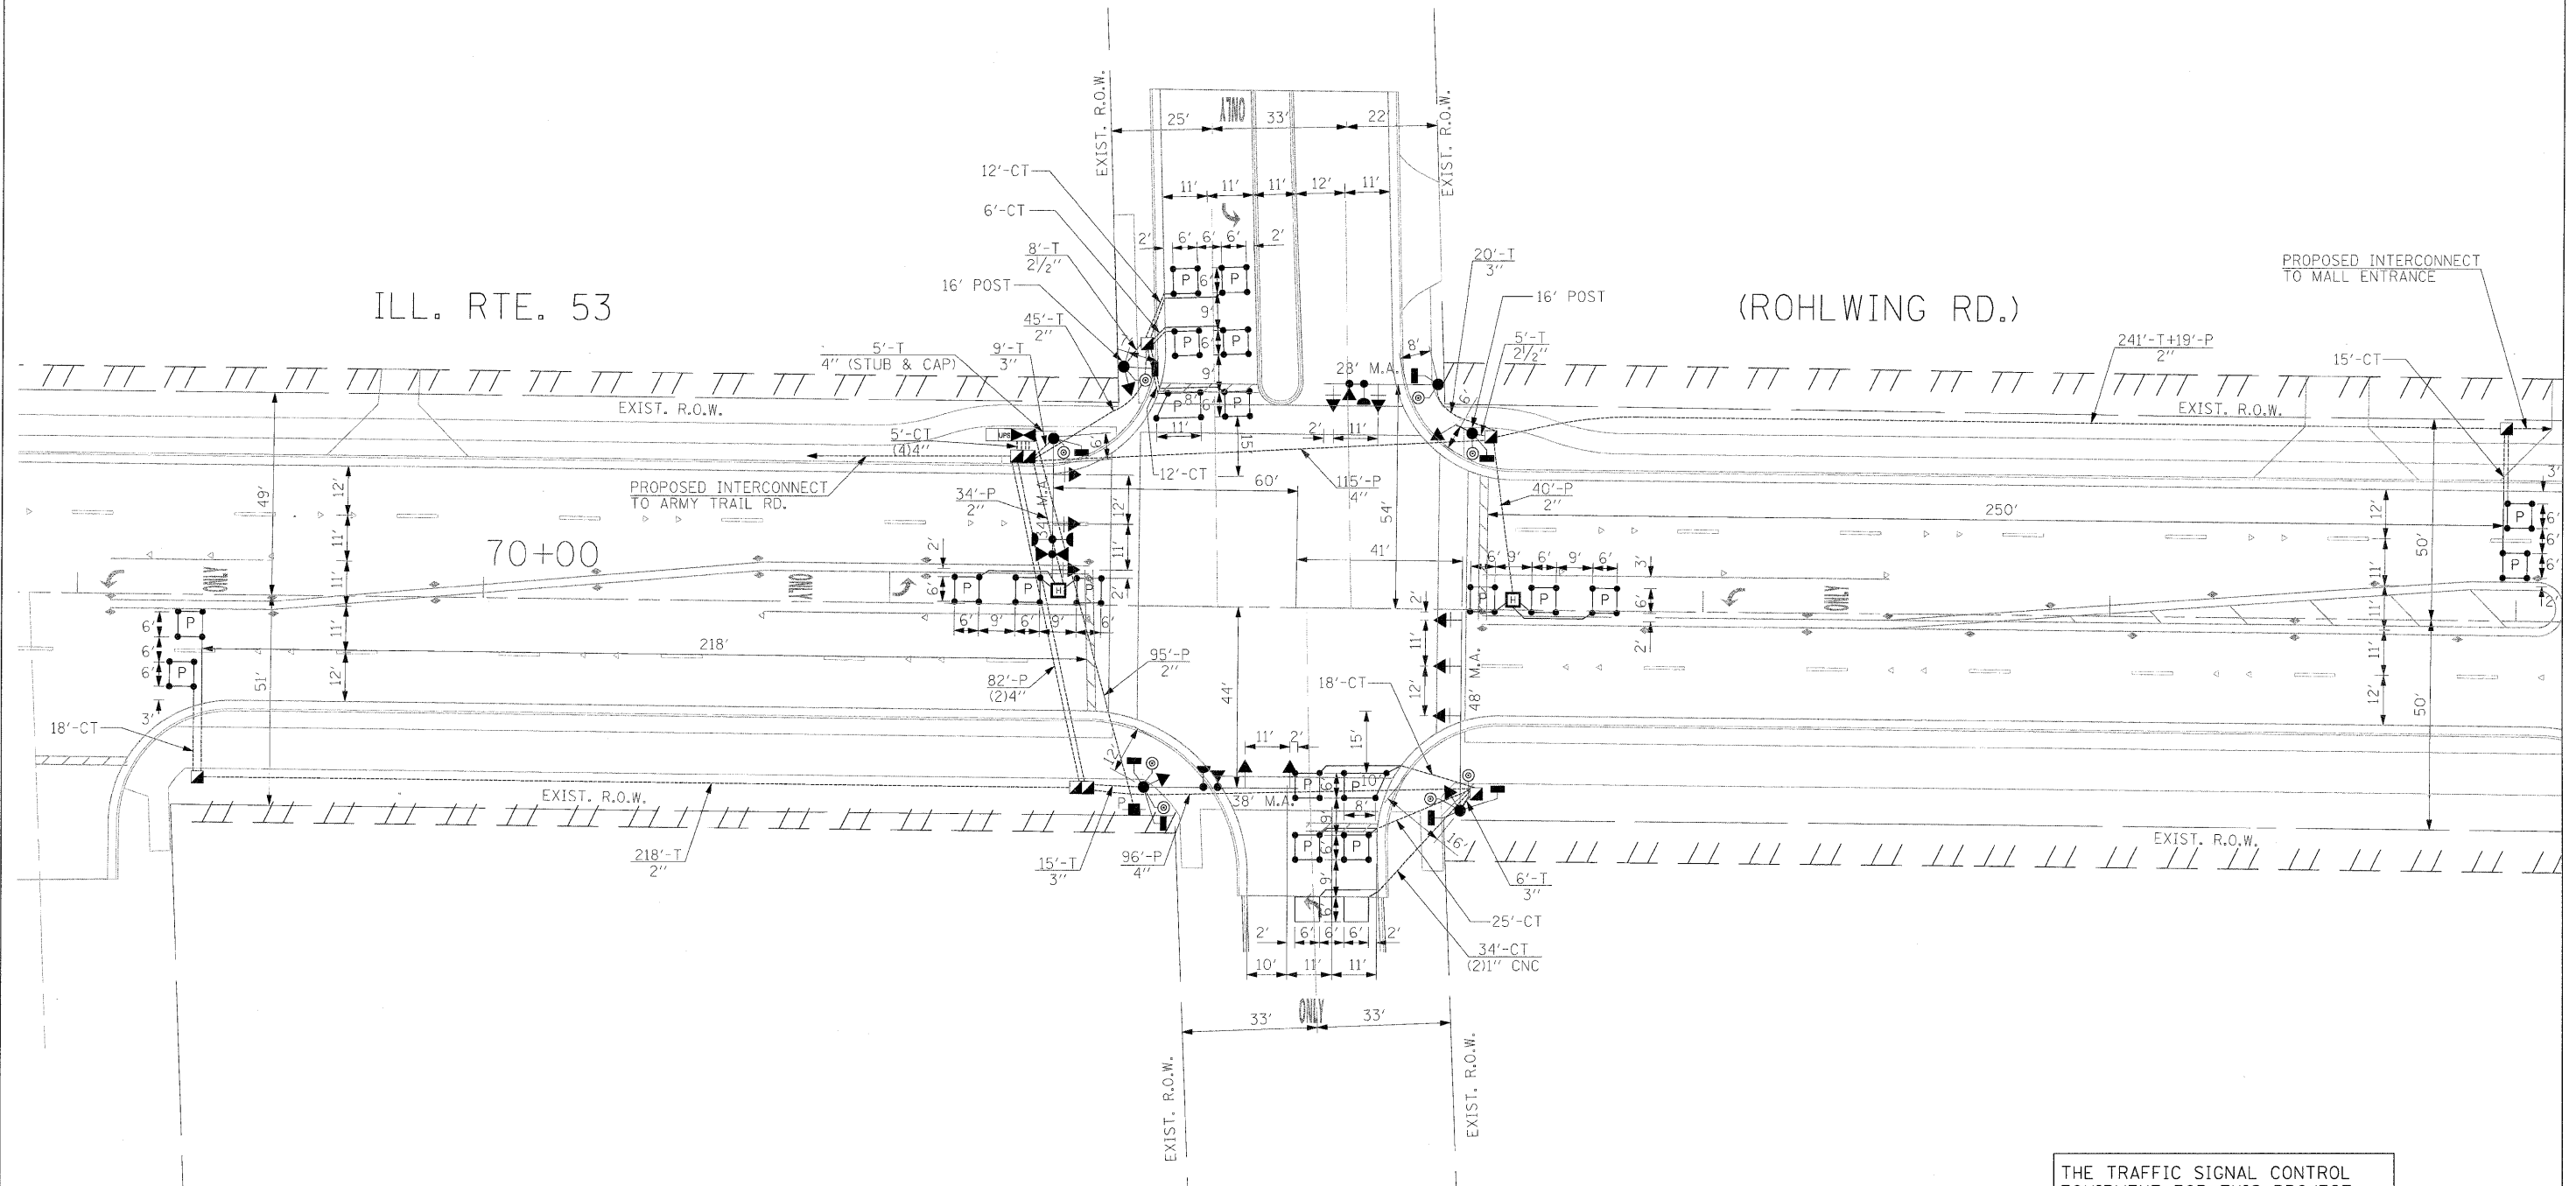

THE TRAFFIC SIGNAL CONTROL EQUIPMENT FOR THIS PROJECT SHALL BE "ECONOLITE" TO MATCH THE EXISTING ADJACENT SYSTEM.

| | | | | | | | | | | | | | |
|------------------------|----------------------|-------------------|-----------|---|---|---------------------|--------------|---|-----------------------|--------------------|------------------|---------------------|------------------|
| FILE NAME = #FILEL# | USER NAME = #USER# | DESIGNED - PKG | REVISED - | STATE OF ILLINOIS DEPARTMENT OF TRANSPORTATION | TRAFFIC SIGNAL INSTALLATION PLAN ILLINOIS ROUTE 53 (ROHLWING RD.) AT WOODLAND AVE. | | | | F.A.P. - RTE. 2578 | SECTION 532B | COUNTY DuPage | TOTAL SHEETS 781 | SHEET NO. 449 |
| | PLOT SCALE = #SCALE# | DRAWN - MAA, EA | REVISED - | | SCALE: 1"=20' | SHEET NO. OF SHEETS | STA. TO STA. | FED. ROAD DIST. NO. - ILLINOIS FED. AID PROJECT | | CONTRACT NO. 60477 | | | |
| | PLOT DATE = #DATE# | CHECKED - PKG, EA | REVISED - | | | | | | | | | | |
| | | DATE - 5/10/2010 | REVISED - | | | | | | | | | | |

SCHEDULE OF QUANTITIES


| QUANTITY | UNIT | ITEM |
|----------|-------|---|
| 18 | SQ FT | SIGN PANEL - TYPE 1 |
| 21 | SQ FT | SIGN PANEL - TYPE 2 |
| 504 | FOOT | CONDUIT IN TRENCH, 2" DIA., GALVANIZED STEEL |
| 13 | FOOT | CONDUIT IN TRENCH, 2 1/2" DIA., GALVANIZED STEEL |
| 50 | FOOT | CONDUIT IN TRENCH, 3" DIA., GALVANIZED STEEL |
| 25 | FOOT | CONDUIT IN TRENCH, 4" DIA., GALVANIZED STEEL |
| 188 | FOOT | CONDUIT PUSHED, 2" DIA., GALVANIZED STEEL |
| 375 | FOOT | CONDUIT PUSHED, 4" DIA., GALVANIZED STEEL |
| 5 | EACH | HANDHOLE |
| 2 | EACH | HEAVY-DUTY HANDHOLE |
| 2 | EACH | DOUBLE HANDHOLE |
| 581 | FOOT | TRENCH AND BACKFILL FOR ELECTRICAL WORK |
| 1 | EACH | FULL-ACTUATED CONTROLLER AND TYPE IV CABINET, SPFCAL |
| 1 | EACH | TRANSCEIVER-FIBER OPTIC |
| 1232 | FOOT | ELECTRIC CABLE IN CONDUIT, SIGNAL NO. 14 2C |
| 1769 | FOOT | ELECTRIC CABLE IN CONDUIT, SIGNAL NO. 14 3C |
| 1078 | FOOT | ELECTRIC CABLE IN CONDUIT, SIGNAL NO. 14 5C |
| 1445 | FOOT | ELECTRIC CABLE IN CONDUIT, SIGNAL NO. 14 7C |
| 1585 | FOOT | ELECTRIC CABLE IN CONDUIT, LEAD-IN, NO. 14 1 PAIR |
| 115 | FOOT | ELECTRIC CABLE IN CONDUIT, SERVICE, NO. 6 2C |
| 2 | EACH | TRAFFIC SIGNAL POST, GALVANIZED STEEL 16 FT. |
| 1 | EACH | STEEL MAST ARM ASSEMBLY AND POLE, 28 FT. |
| 1 | EACH | STEEL MAST ARM ASSEMBLY AND POLE, 34 FT. |
| 1 | EACH | STEEL MAST ARM ASSEMBLY AND POLE, 38 FT. |
| 1 | EACH | STEEL MAST ARM ASSEMBLY AND POLE, 48 FT. |
| 8 | FOOT | CONCRETE FOUNDATION, TYPE A |
| 4 | FOOT | CONCRETE FOUNDATION, TYPE C |
| 10 | FOOT | CONCRETE FOUNDATION, TYPE E 30-INCH DIAMETER |
| 45 | FOOT | CONCRETE FOUNDATION, TYPE E 36-INCH DIAMETER |
| 6 | EACH | SIGNAL HEAD, LED, 1-FACE, 3-SECTION, MAST ARM MOUNTED |
| 4 | EACH | SIGNAL HEAD, LED, 1-FACE, 5-SECTION, BRACKET MOUNTED |
| 4 | EACH | SIGNAL HEAD, LED, 1-FACE, 5-SECTION, MAST ARM MOUNTED |
| 4 | EACH | PEDESTRIAN SIGNAL HEAD, LED, 1-FACE, BRACKET MOUNTED WITH COUNTDOWN TIMER |
| 2 | EACH | PEDESTRIAN SIGNAL HEAD, LED, 2-FACE, BRACKET MOUNTED WITH COUNTDOWN TIMER |
| 10 | EACH | TRAFFIC SIGNAL BACKPLATE, LOUVERED, ALUMINUM |
| 8 | EACH | INDUCTIVE LOOP DETECTOR |
| 64 | FOOT | DETECTOR LOOP, TYPE 1 |
| 3 | EACH | LIGHT DETECTOR |
| 1 | EACH | LIGHT DETECTOR AMPLIFIER |
| 8 | EACH | PEDESTRIAN PUSH-BUTTON |
| 667 | FOOT | PREFORMED DETECTOR LOOP |
| 1 | EACH | SERVICE INSTALLATION - POLE MOUNTED |
| 1 | EACH | UNINTERRUPTIBLE POWER SUPPLY |
| 706 | FOOT | ELECTRIC CABLE IN CONDUIT, GROUNDING, NO. 6 1C |
| 481 | FOOT | ELECTRIC CABLE IN CONDUIT NO. 20 3/C, TWISTED, SHIELDED |

• 100% COST TO VILLAGE OF ADDISON


THE END OF THE TRACER CABLE SHALL BE CONTINUOUS AND EXTEND INTO THE CONTROLLER CABINET.

THE END OF THE TRACER CABLE SHALL BE CONTINUOUS AND EXTEND INTO THE CONTROLLER CABINET.

EMERGENCY VEHICLE PREEMPTION SEQUENCE

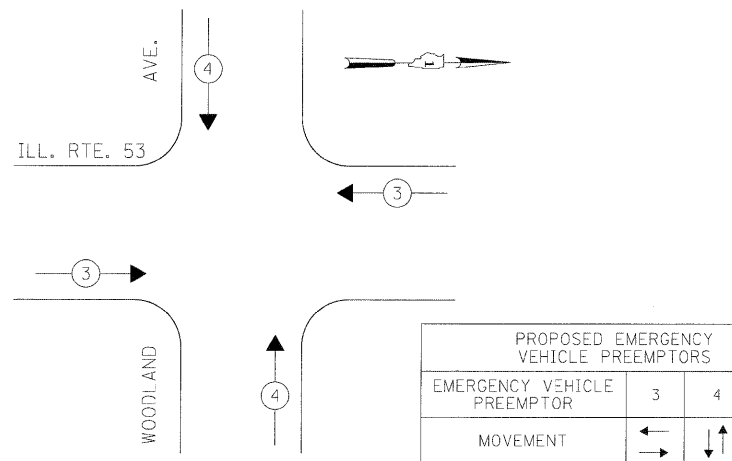

CONTROLLER SEQUENCE

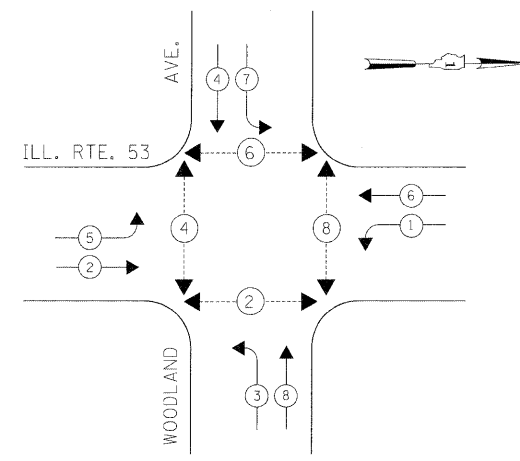

THE TRAFFIC SIGNAL CONTROL EQUIPMENT FOR THIS PROJECT SHALL BE "ECONOLITE" TO MATCH THE EXISTING ADJACENT SYSTEM.

LEGEND

- ← * → DUAL ENTRY PHASE
- ← * → SINGLE ENTRY PHASE
- ◊ O.L. OVERLAP
- ← * → PEDESTRIAN PHASE
- * NUMBER REFERS TO ASSOCIATED PHASE

| I.D.O.T. TRAFFIC SIGNAL INSTALLATION ELECTRICAL SERVICE REQUIREMENTS | | | | | TOTAL WATTAGE |
|--|----------|---------|-----|-----------|---------------|
| TYPE | NO LAMPS | WATTAGE | | OPERATION | |
| | | INCAND. | LED | | |
| SIGNAL (RED) | 14 | 135 | 17 | 0.50 | 119 |
| (YELLOW) | 14 | 135 | 25 | 0.25 | 87.5 |
| (GREEN) | 14 | 135 | 15 | 0.25 | 52.5 |
| ARROW | 16 | 135 | 12 | 0.10 | 19.2 |
| PED. SIGNAL | 8 | 90 | 25 | 1.00 | 200 |
| CONTROLLER | 1 | 100 | 100 | 1.00 | 100 |
| ILLUM. SIGN | | | 25 | 0.05 | |
| FLASHER | | | | 0.50 | |
| ENERGY COSTS TO: | | | | | TOTAL = 578.2 |

ILLINOIS DEPARTMENT OF TRANSPORTATION
201 WEST CENTER COURT
SCHAUMBURG, ILLINOIS 60196-1096
ENERGY SUPPLY CONTACT: CLRTIS TOPPS
PHONE: (630) 691-4356
COMPANY: COMMONWEALTH EDISON

| | | | |
|-------------|--------------------|-------------------|-----------|
| FILE NAME = | USER NAME = *USER* | DESIGNED - PKG | REVISED - |
| *FILE# | | DRAWN - MAA, EA | REVISED - |
| | | CHECKED - PKG, EA | REVISED - |
| | | DATE - 5/10/2010 | REVISED - |

STATE OF ILLINOIS
DEPARTMENT OF TRANSPORTATION

TRAFFIC SIGNAL CABLE PLAN, PHASE DESIGNATION DIAGRAM,
EMERGENCY VEHICLE PREEMPTION SEQUENCE, AND SCHEDULE OF QUANTITIES
ILLINOIS ROUTE 53 (ROHLWING RD.) AT WOODLAND AVE.
SCALE: NONE SHEET NO. OF SHEETS STA. TO STA.


| | | | | |
|---|--------------|---------------|------------------|---------------|
| F.A.P. RTE. 2578 | SECTION 532B | COUNTY DuPage | TOTAL SHEETS 781 | SHEET NO. 450 |
| CONTRACT NO. 60477 | | | | |
| FED. ROAD DIST. NO. - ILLINOIS FED. AID PROJECT | | | | |

NOTES FOR TEMPORARY TRAFFIC SIGNALS



1. ALL CONTROL EQUIPMENT INCLUDING EMERGENCY PRE-EMPTION AND COMMUNICATION DEVICES FOR THE TEMPORARY TRAFFIC SIGNAL(S) SHALL BE FURNISHED BY THE CONTRACTOR.
2. ONLY CONTROLLERS SUPPLIED BY ONE OF THE DISTRICT APPROVED CLOSED LOOP EQUIPMENT MANUFACTURERS WILL BE APPROVED FOR USE AT TEMPORARY SIGNAL LOCATIONS. ALL CONTROLLERS USED FOR TEMPORARY TRAFFIC SIGNALS SHALL BE FULLY ACTUATED NEMA MICROPROCESSOR BASED WITH RS232 DATA ENTRY PORTS COMPATIBLE WITH EXISTING MONITORING SOFTWARE APPROVED BY IDOT DISTRICT 1, INSTALLED IN A NEMA TS2 CABINET. ONLY ONE BRAND OF CONTROLLER WILL BE ACCEPTED FOR ANY ONE CONTRACT.
3. ALL TRAFFIC SIGNAL SECTIONS AND PEDESTRIAN SIGNAL SECTIONS SHALL BE LED AND 12" (300mm) DIAMETER. HEADS SHALL BE PLACED AS INDICATED ON THE TEMPORARY TRAFFIC SIGNAL PLAN OR AS DIRECTED BY THE ENGINEER. PEDESTRIAN SIGNALS SHALL INCLUDE SOLID INTERNATIONAL SYMBOLS. PEDESTRIAN SIGNALS WITH COUNTDOWN TIMERS SHALL BE USED WHEN THE EXISTING INSTALLATION UTILIZES COUNTDOWN TYPE OR AS DIRECTED BY THE ENGINEER. COUNTDOWN TYPE PEDESTRIAN SIGNALS ARE NOT TO BE INSTALLED AT A RAILROAD INTERSECTION. THE CONTRACTOR SHALL FURNISH ENOUGH CABLE SLACK TO RELOCATE HEADS TO ANY POSITION ON THE SPAN WIRE OR AT LOCATIONS ILLUSTRATED ON THE PLANS FOR CONSTRUCTION STAGING. THE TEMPORARY TRAFFIC SIGNAL SHALL REMAIN IN OPERATION DURING ALL SIGNAL HEAD RELOCATIONS. EACH TEMPORARY TRAFFIC SIGNAL HEAD SHALL HAVE ITS OWN CABLE FROM THE CONTROLLER CABINET TO THE SIGNAL HEAD.
4. ALL EXISTING STREET NAME AND INTERSECTION REGULATORY SIGNS SHALL BE REMOVED FROM EXISTING POLES, RELOCATED AND SECURELY FASTENED TO THE SPAN WIRE OR WOOD POLE AS DIRECTED BY THE ENGINEER.
5. ANY TEMPORARY SIGNAL WITHIN AN EXISTING CLOSED LOOP TRAFFIC SIGNAL SYSTEM SHALL BE INTERCONNECTED TO THAT SYSTEM USING SIMILAR BRAND CONTROL EQUIPMENT.
6. THE TEMPORARY TRAFFIC SIGNAL SHALL HAVE THE SIGNAL HEAD DISPLAYS, SIGNAL HEAD PLACEMENTS AND CONTROLLER PHASING MATCH THE EXISTING TRAFFIC SIGNAL, AT THE TIME OF THE TURN ON, IF NO TRAFFIC STAGING IS IN PLACE OR WILL NOT BE STAGED ON THE DAY OF THE TURN ON.
7. UNINTERRUPTIBLE POWER SUPPLY (UPS) SYSTEMS SHALL BE INSTALLED AND MADE OPERATIONAL AT TEMPORARY TRAFFIC SIGNAL INSTALLATIONS WHERE UPS IS INSTALLED AT THE EXISTING TRAFFIC SIGNAL, TEMPORARY TRAFFIC SIGNALS AT RAILROAD INTERSECTIONS, AND TEMPORARY TRAFFIC SIGNALS AT INTERSECTIONS WITH FIRE STATION ACTUATED EMERGENCY VEHICLE PRE-EMPTION, OR WHEN INDICATED ON THE PLANS.
8. TRAFFIC SIGNAL MANAGEMENT SYSTEMS SHALL BE MAINTAINED IN OPERATION AS INDICATED ON THE PLANS OR AS DIRECTED BY THE ENGINEER. REQUIRED EQUIPMENT SHALL BE AS SHOWN ON THE PLANS AND THE CONTRACTOR SHALL PLACE THE EQUIPMENT IN OPERATION TO THE SATISFACTION OF THE ENGINEER AND THE AGENCY RESPONSIBLE FOR THE TRAFFIC SIGNAL MANAGEMENT SYSTEM.
9. DETECTION AT TEMPORARY TRAFFIC SIGNALS SHALL BE INCLUDED FOR ALL APPROACHES OF THE INTERSECTION UNLESS INDICATED OTHERWISE ON THE PLANS. THE DETECTION SYSTEM MUST MEET THE SPECIFICATIONS OF DISTRICT 1 AND THE CONTRACTOR SHALL PLACE THE DETECTORS INTO OPERATION TO THE SATISFACTION OF THE ENGINEER.
10. WHEN PAN, TILT, ZOOM CAMERAS ARE INSTALLED AT THE EXISTING INTERSECTION OR ARE CALLED FOR IN THE PLANS, THE CONTRACTOR SHALL BE RESPONSIBLE FOR INSTALLING AND MAINTAINING THE CAMERAS TO THE SATISFACTION OF THE ENGINEER AND THE AGENCY RESPONSIBLE FOR THE CAMERAS.

- NOTE 1: THE VIDEO DETECTION ZONES SHOWN ON THE PLANS ARE FOR CONSTRUCTION STAGE 1 - SUBSTAGE 1 AND SHALL BE REDEFINED FOR EACH CONSTRUCTION STAGE AS A PART OF "TEMPORARY TRAFFIC SIGNAL INSTALLATION" WORK.
- NOTE 2: THE SIGNAL HEAD PLACEMENT FOR MALL ENTRANCE FOR CONSTRUCTION STAGES S2 AND S3 SHALL BE DETERMINED IN FIELD BY THE CONTRACTOR DEPENDING ON THE CONSTRUCTION STAGING USED BY THE CONTRACTOR FOR MALL ENTRANCE.


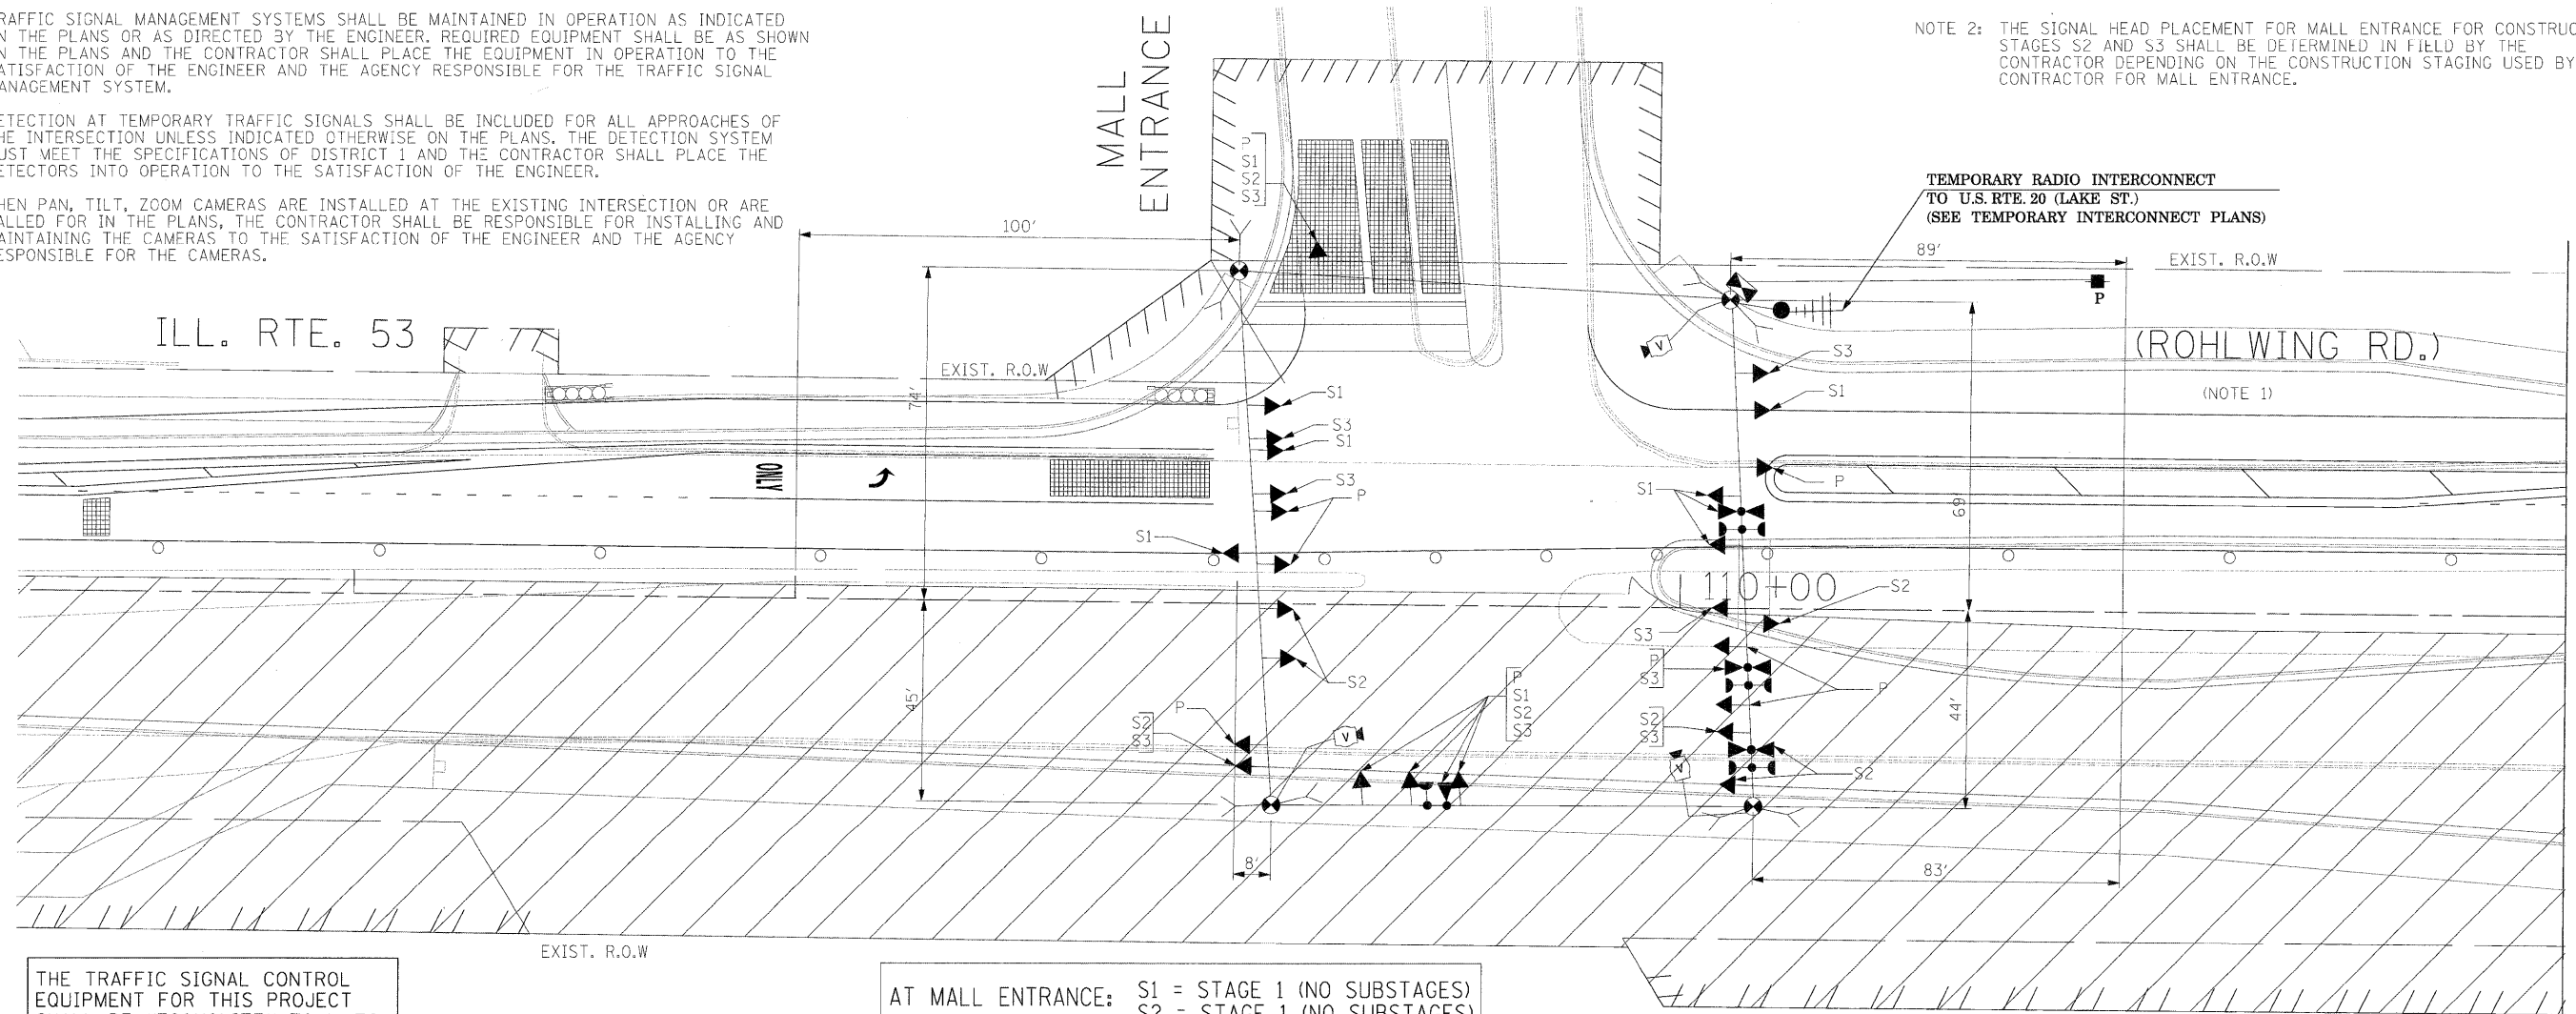


MATCH LINE STA. 122+00
(SEE SHEET 2 OF 2)

THE TRAFFIC SIGNAL CONTROL EQUIPMENT FOR THIS PROJECT SHALL BE "ECONOLITE" TO MATCH THE EXISTING ADJACENT SYSTEM.


AT MALL ENTRANCE: S1 = STAGE 1 (NO SUBSTAGES)
S2 = STAGE 1 (NO SUBSTAGES)
S3 = STAGE 1 (NO SUBSTAGES)

| | | | | | | | | | | | | |
|-------------|----------------------|-------------------|-----------|---|---|--------------------|----------------------------------|---|------------------|---------------|--|--|
| FILE NAME = | USER NAME = #USER# | DESIGNED - PKG | REVISED - | STATE OF ILLINOIS DEPARTMENT OF TRANSPORTATION | TEMPORARY TRAFFIC SIGNAL INSTALLATION PLAN ILLINOIS ROUTE 53 (ROHLWING RD.) AT MALL ENTRANCE PRE STAGE, STAGE 1, STAGE 2, AND STAGE 3 (SHEET 1 OF 2) | F.A.P. RTE. 2578 | SECTION 532B | COUNTY DuPage | TOTAL SHEETS 781 | SHEET NO. 451 | | |
| #FILE# | PLOT SCALE = #SCALE# | DRAWN - MAA, EA | REVISED - | | | SCALE: 1"=20' | SHEET NO. OF SHEETS STA. TO STA. | FED. ROAD DIST. NO. - [ILLINOIS] FED. AID PROJECT | | | | |
| | PLOT DATE = #DATE# | CHECKED - PKG, EA | REVISED - | | | CONTRACT NO. 60477 | | | | | | |
| | | DATE - 5/10/2010 | REVISED - | | | | | | | | | |

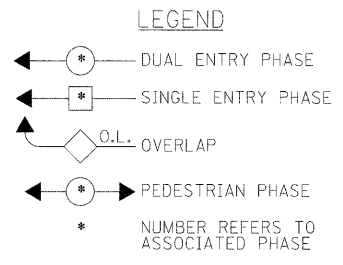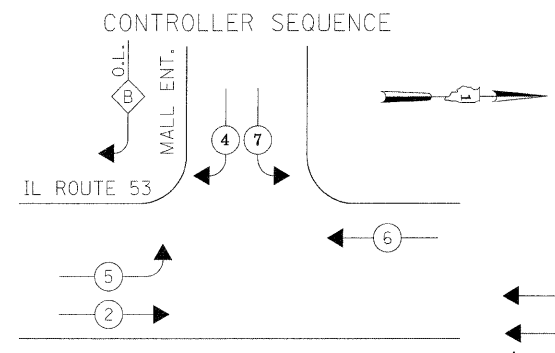

PHASE DESIGNATION DIAGRAM
 STAGES: PRE-STAGE, STAGE 1, STAGE 2, STAGE 3, AND AFTER PROPOSED ROADWAY GEOMETRICS ARE BUILT

| OVERLAP LETTER | PERMISSIVE PHASE | PROTECTED PHASE |
|----------------|------------------|-----------------|
| B | 4 | 5 |

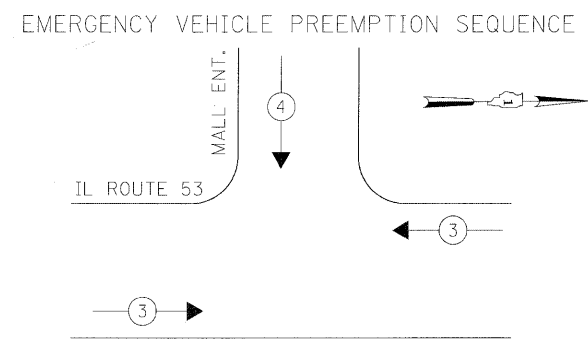

| PROPOSED EMERGENCY VEHICLE PREEMPTORS | | |
|---------------------------------------|---|---|
| EMERGENCY VEHICLE PREEMPTOR | 3 | 4 |
| MOVEMENT | ← | ↓ |


STAGES: PRE-STAGE, STAGE 1, STAGE 2, STAGE 3, AND AFTER PROPOSED ROADWAY GEOMETRICS ARE BUILT

| I.D.O.T. TRAFFIC SIGNAL INSTALLATION ELECTRICAL SERVICE REQUIREMENTS | | | | | TOTAL WATTAGE |
|--|----------|---------|-----|------------|---------------|
| TYPE | NO LAMPS | WATTAGE | | %OPERATION | |
| | | INCAND. | LED | | |
| SIGNAL (RED) | 10 | 135 | 17 | 0.50 | 85 |
| (YELLOW) | 10 | 135 | 25 | 0.25 | 62.5 |
| (GREEN) | 10 | 135 | 15 | 0.25 | 37.5 |
| ARROW | 4 | 135 | 12 | 0.10 | 4.8 |
| PED. SIGNAL | | 90 | 25 | 1.00 | |
| CONTROLLER | 1 | 100 | 100 | 1.00 | 100 |
| ILLUM. SIGN | | | 25 | 0.05 | |
| VIDEO SYSTEM | 1 | 150 | | 1.00 | 150 |
| FLASHER | | | | 0.50 | |
| ENERGY COSTS TO: | | | | TOTAL = | 439.8 |


ILLINOIS DEPARTMENT OF TRANSPORTATION
 201 WEST CENTER COURT
 SCHUMBERG, ILLINOIS 60196-1096
 ENERGY SUPPLY CONTACT: CURTIS TOPPS
 PHONE: (630) 691-4356
 COMPANY: COMMONWEALTH EDISON

| | | | |
|-------------|----------------------|-------------------|-----------|
| FILE NAME = | USER NAME = #USER# | DESIGNED - PKG | REVISED - |
| #FILE# | | DRAWN - MAA, EA | REVISED - |
| | PLOT SCALE = #SCALE# | CHECKED - PKG, EA | REVISED - |
| | PLOT DATE = #DATE# | DATE - 5/10/2010 | REVISED - |

MATCH LINE STA. 122+00 (SEE SHEET 1 OF 2)

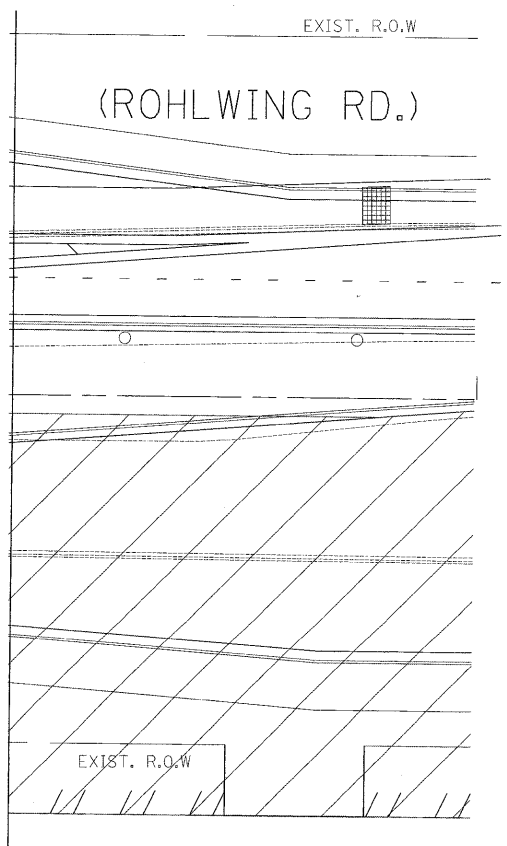

STATE OF ILLINOIS
 DEPARTMENT OF TRANSPORTATION

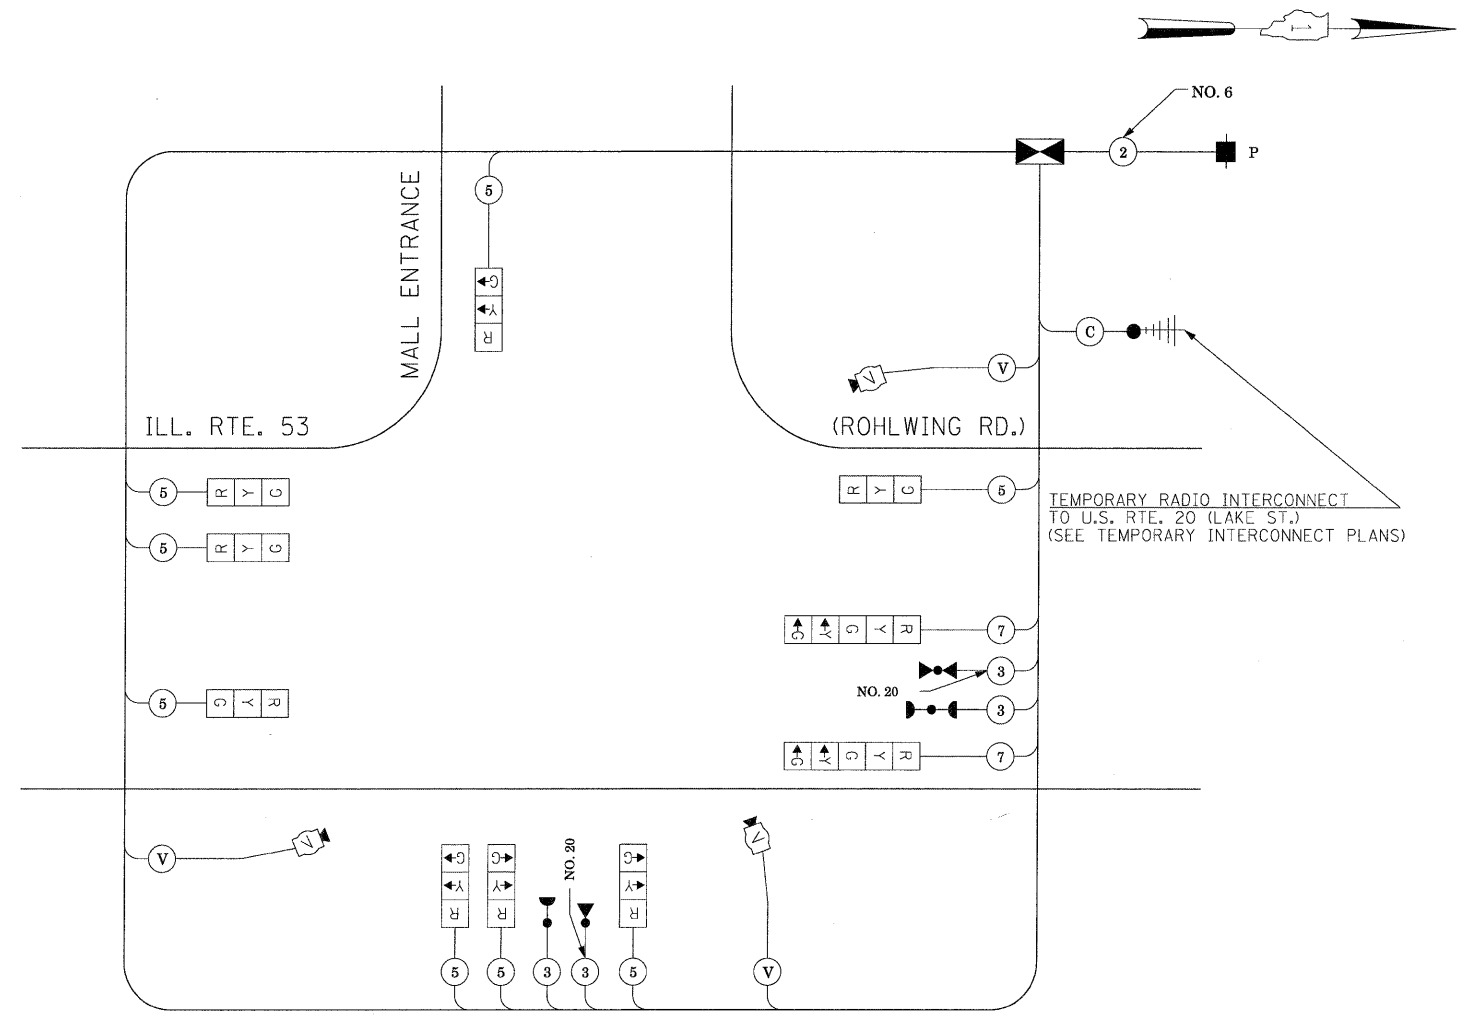

TEMPORARY CABLE PLAN

(NOT TO SCALE)
 PRE-STAGE, STAGE 1, STAGE 2, STAGE 3,
 AND AFTER PROPOSED ROADWAY GEOMETRICS ARE BUILT


THE TRAFFIC SIGNAL CONTROL EQUIPMENT FOR THIS PROJECT SHALL BE "ECONOLITE" TO MATCH THE EXISTING ADJACENT SYSTEM.

| | | | | | | | | |
|---|-----------|----|--------|---|---------|--------|--------------|-----------|
| TEMPORARY CABLE PLAN, TEMPORARY PHASE DESIGNATION DIAGRAM | | | | F.A.P. RTE. | SECTION | COUNTY | TOTAL SHEETS | SHEET NO. |
| TEMPORARY EMERGENCY VEHICLE PREEMPTION SEQUENCE | | | | 2578 | 532B | DuPage | 781 | 452 |
| ILLINOIS ROUTE 53 (ROHLWING RD.) AT MALL ENTRANCE | | | | CONTRACT NO. 60477 | | | | |
| PRE-STAGE, STAGE 1, STAGE 2, AND STAGE 3 (SHEET 2 OF 2) | | | | FED. ROAD DIST. NO. - ILLINOIS FED. AID PROJECT | | | | |
| SCALE: NONE | SHEET NO. | OF | SHEETS | STA. | TO STA. | | | |



THE TRAFFIC SIGNAL CONTROL EQUIPMENT FOR THIS PROJECT SHALL BE "ECONOLITE" TO MATCH THE EXISTING ADJACENT SYSTEM.

MATCH LINE 112+00

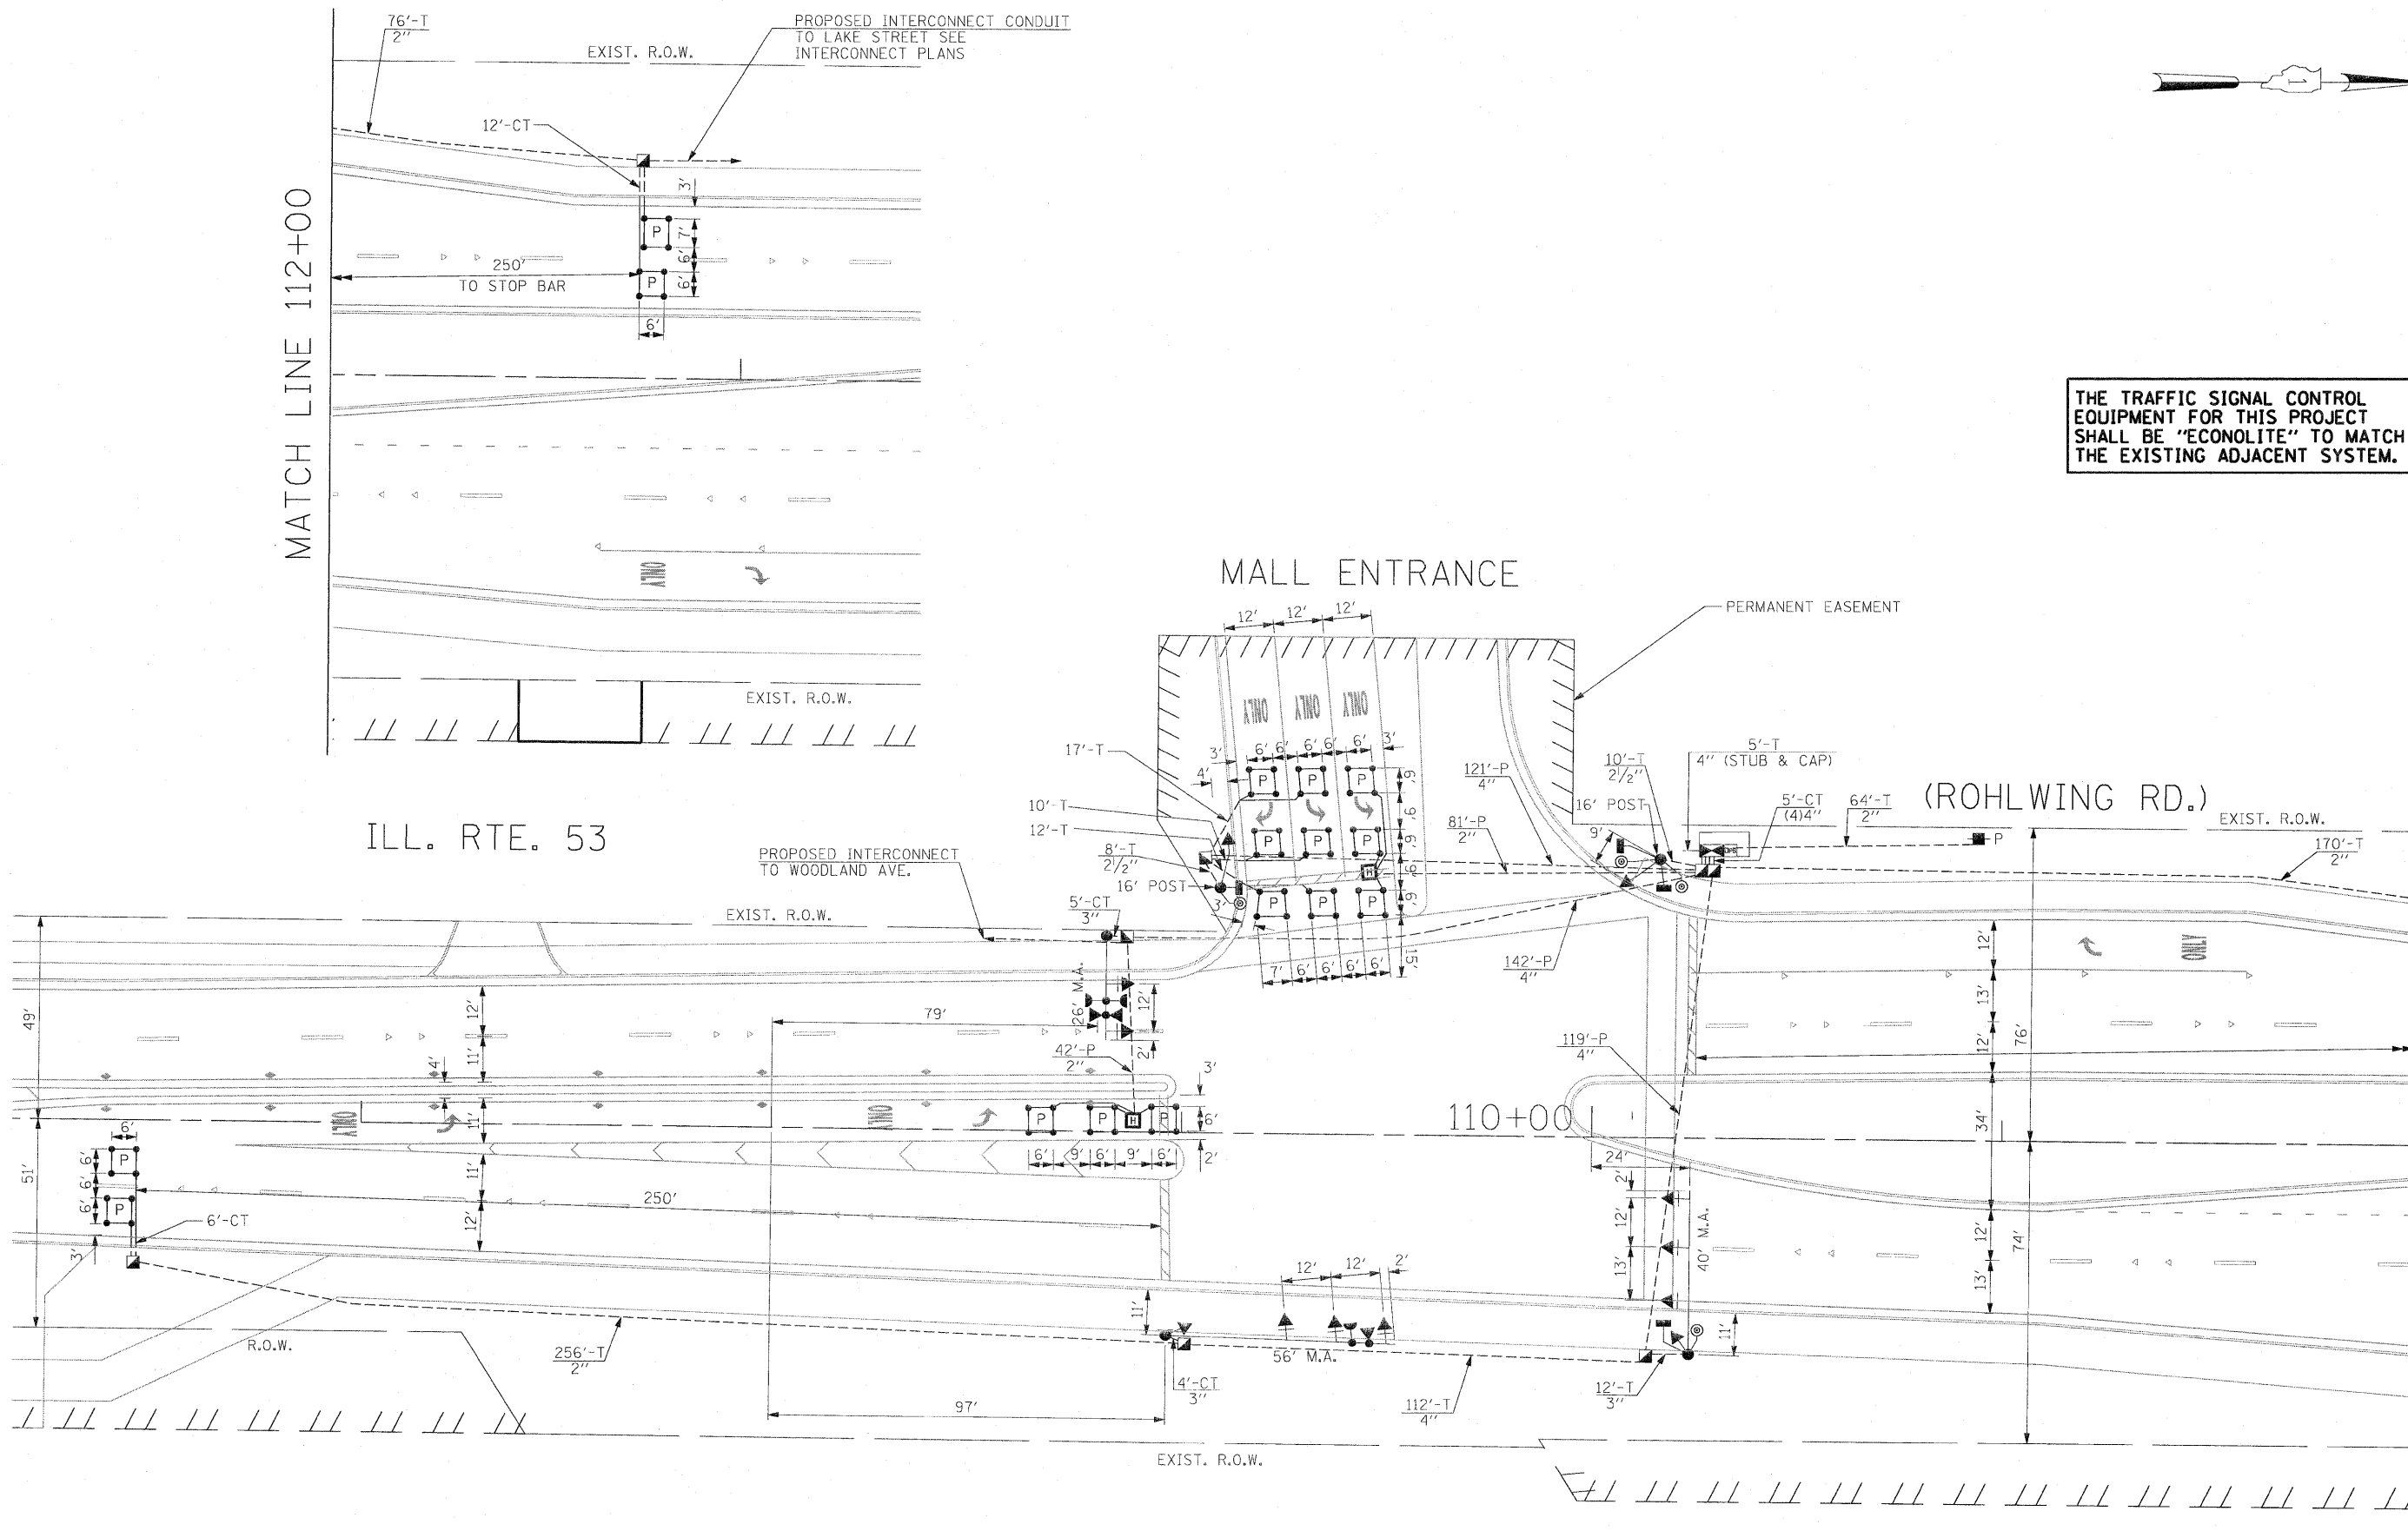

MATCH LINE 112+00


| | | | | | | | | | | | | |
|-------------------------|-----------------------|---|--|---|--|---|----------------------------------|---|-----------------|------------------|---------------------|------------------|
| FILE NAME = #FILEL\$ | USER NAME = #USER\$ | DESIGNED - PKG DRAWN - MAA, 10/18/10 | REVISED - REVISED - REVISED - REVISED - | STATE OF ILLINOIS DEPARTMENT OF TRANSPORTATION | | TRAFFIC SIGNAL INSTALLATION PLAN ILLINOIS ROUTE 53 (ROHLWING RD.) AT MALL ENTRANCE | | F.A.P. RTE. 2578 | SECTION 532B | COUNTY DuPage | TOTAL SHEETS 781 | SHEET NO. 453 |
| | PLOT SCALE = #SCALE\$ | CHECKED - PKG, E | DATE = 5/10/10 | | | SCALE: 1"=20' | SHEET NO. OF SHEETS STA. TO STA. | CONTRACT NO. 60477 | | | | |
| PLOT DATE = #DATE\$ | | | | | | | | FED. ROAD DIST. NO. - ILLINOIS FED. AID PROJECT | | | | |

SCHEDULE OF QUANTITIES

| QUANTITY | UNIT | ITEM |
|----------|-------|---|
| 9 | SQ FT | SIGN PANEL - TYPE 1 |
| 566 | FOOT | CONDUIT IN TRENCH, 2" DIA., GALVANIZED STEEL |
| 18 | FOOT | CONDUIT IN TRENCH, 2 1/2" DIA., GALVANIZED STEEL |
| 17 | FOOT | CONDUIT IN TRENCH, 3" DIA., GALVANIZED STEEL |
| 137 | FOOT | CONDUIT IN TRENCH, 4" DIA., GALVANIZED STEEL |
| 123 | FOOT | CONDUIT PUSHED, 2" DIA., GALVANIZED STEEL |
| 382 | FOOT | CONDUIT PUSHED, 4" DIA., GALVANIZED STEEL |
| 6 | EACH | HANDHOLE |
| 2 | EACH | HEAVY-DUTY HANDHOLE |
| 1 | EACH | DOUBLE HANDHOLE |
| 714 | FOOT | TRENCH AND BACKFILL FOR ELECTRICAL WORK |
| 1 | EACH | FULL-ACTUATED CONTROLLER AND TYPE IV CABINET, SPECIAL |
| 1 | EACH | TRANSCEIVER-FIBER OPTIC |
| 427 | FOOT | ELECTRIC CABLE IN CONDUIT, SIGNAL NO. 14 2C |
| 1026 | FOOT | ELECTRIC CABLE IN CONDUIT, SIGNAL NO. 14 3C |
| 2001 | FOOT | ELECTRIC CABLE IN CONDUIT, SIGNAL NO. 14 5C |
| 775 | FOOT | ELECTRIC CABLE IN CONDUIT, SIGNAL NO. 14 7C |
| 1434 | FOOT | ELECTRIC CABLE IN CONDUIT, LEAD-IN, NO. 14 1 PAIR |
| 84 | FOOT | ELECTRIC CABLE IN CONDUIT, SERVICE, NO. 6 2C |
| 2 | EACH | TRAFFIC SIGNAL POST, GALVANIZED STEEL 16 FT. |
| 1 | EACH | STEEL MAST ARM ASSEMBLY AND POLE, 26 FT. |
| 1 | EACH | STEEL MAST ARM ASSEMBLY AND POLE, 40 FT. |
| 1 | EACH | STEEL MAST ARM ASSEMBLY AND POLE, 56 FT. |
| 8 | FOOT | CONCRETE FOUNDATION, TYPE A |
| 4 | FOOT | CONCRETE FOUNDATION, TYPE C |
| 30 | FOOT | CONCRETE FOUNDATION, TYPE E 36-INCH DIAMETER |
| 21 | FOOT | CONCRETE FOUNDATION, TYPE E 42-INCH DIAMETER |
| 6 | EACH | SIGNAL HEAD, LED, 1-FACE, 3-SECTION, MAST ARM MOUNTED |
| 2 | EACH | SIGNAL HEAD, LED, 1-FACE, 3-SECTION, BRACKET MOUNTED |
| 2 | EACH | SIGNAL HEAD, LED, 1-FACE, 5-SECTION, BRACKET MOUNTED |
| 2 | EACH | SIGNAL HEAD, LED, 1-FACE, 5-SECTION, MAST ARM MOUNTED |
| 2 | EACH | PEDESTRIAN SIGNAL HEAD, LED, 1-FACE, BRACKET MOUNTED WITH COUNTDOWN TIMER |
| 1 | EACH | PEDESTRIAN SIGNAL HEAD, LED, 2-FACE, BRACKET MOUNTED WITH COUNTDOWN TIMER |
| 8 | EACH | TRAFFIC SIGNAL BACKPLATE, LOUVERED, ALUMINUM |
| 6 | EACH | INDUCTIVE LOOP DETECTOR |
| 2 | EACH | LIGHT DETECTOR |
| 1 | EACH | LIGHT DETECTOR AMPLIFIER |
| 4 | EACH | PEDESTRIAN PUSH-BUTTON |
| 1 | EACH | TEMPORARY TRAFFIC SIGNAL INSTALLATION |
| 507 | FOOT | PREFORMED DETECTOR LOOP |
| 1 | EACH | TEMPORARY TRAFFIC SIGNAL TIMING |
| 1 | EACH | SERVICE INSTALLATION - POLE MOUNTED |
| 1 | EACH | UNINTERRUPTIBLE POWER SUPPLY |
| 756 | FOOT | ELECTRIC CABLE IN CONDUIT, GROUNDING, NO. 6 1C |
| 571 | FOOT | ELECTRIC CABLE IN CONDUIT NO. 20 3/C, TWISTED, SHIELDED |

* 100% COST TO VILLAGE OF ADDISON


THE END OF THE TRACER CABLE SHALL BE CONTINUOUS AND EXTEND INTO THE CONTROLLER CABINET.

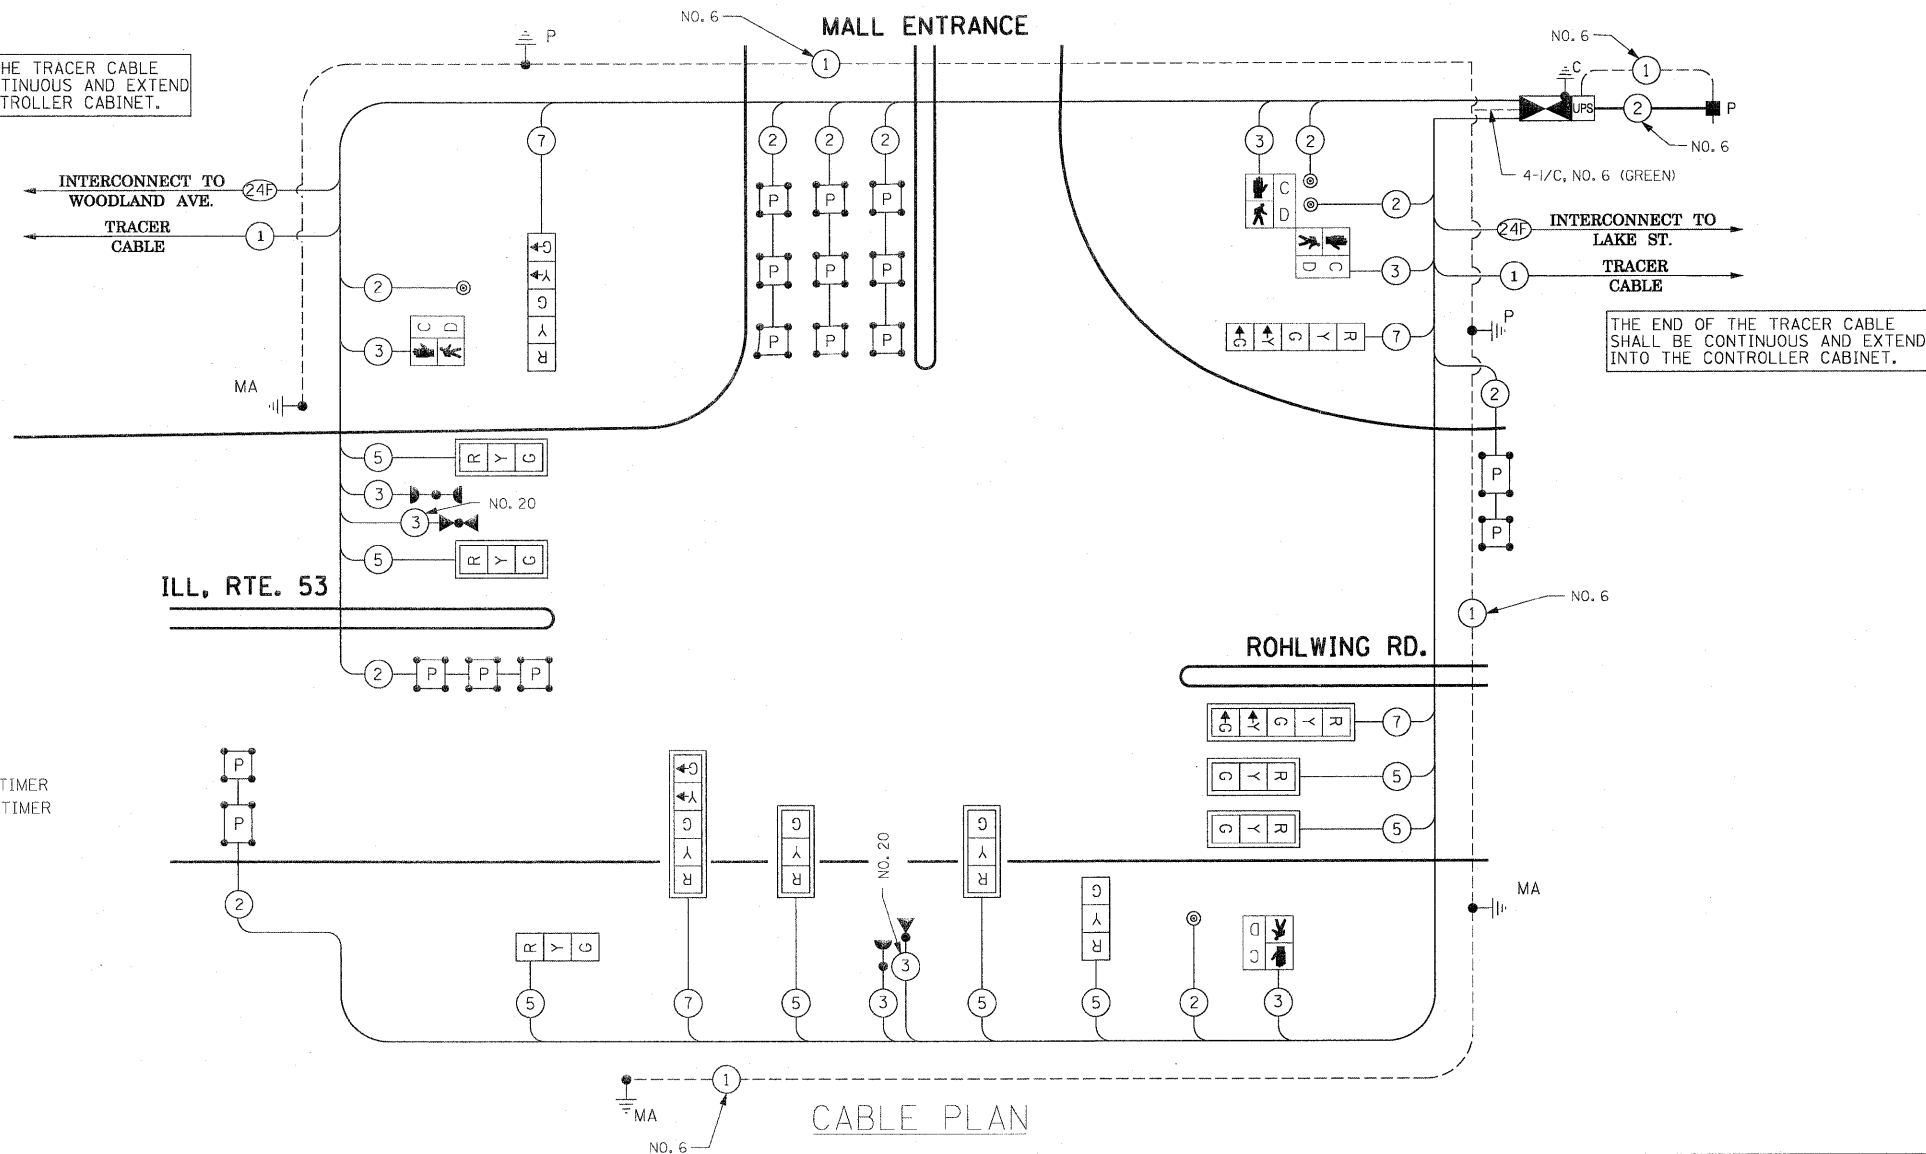


THE END OF THE TRACER CABLE SHALL BE CONTINUOUS AND EXTEND INTO THE CONTROLLER CABINET.

THE TRAFFIC SIGNAL CONTROL EQUIPMENT FOR THIS PROJECT SHALL BE "ECONOLITE" TO MATCH THE EXISTING ADJACENT SYSTEM.

CONTROLLER SEQUENCE

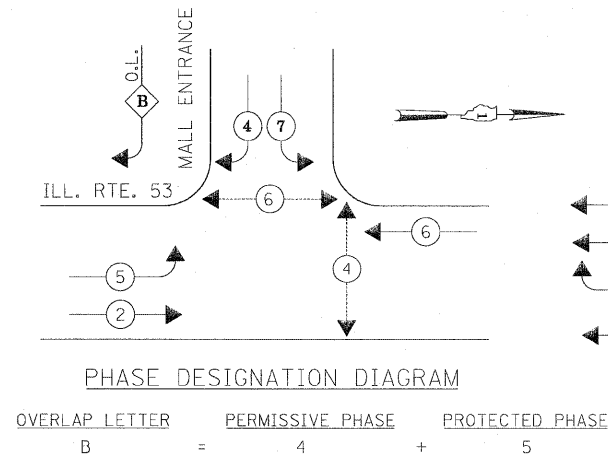

EMERGENCY VEHICLE PREEMPTION SEQUENCE

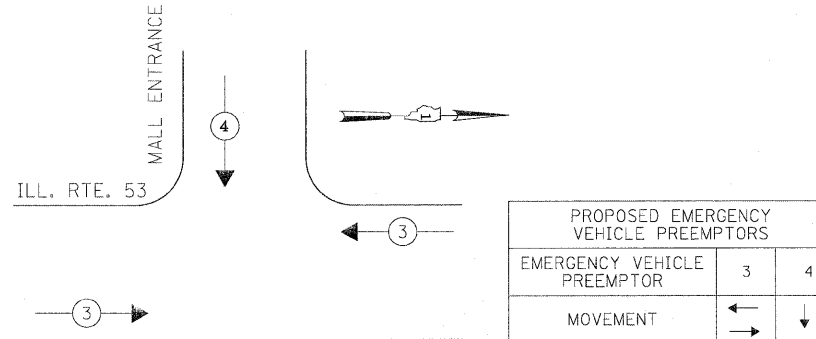

| PROPOSED EMERGENCY VEHICLE PREEMPTORS | | | |
|---------------------------------------|---|---|--|
| EMERGENCY VEHICLE PREEMPTOR | 3 | 4 | |
| MOVEMENT | ← | ↓ | |

| I.D.O.T. TRAFFIC SIGNAL INSTALLATION ELECTRICAL SERVICE REQUIREMENTS | | | | | TOTAL WATTAGE |
|--|----------|---------|-----|------------|---------------|
| TYPE | NO LAMPS | INCAND. | LED | %OPERATION | |
| SIGNAL (RED) | 12 | 135 | 17 | 0.50 | 102 |
| (YELLOW) | 12 | 135 | 25 | 0.25 | 75 |
| (GREEN) | 12 | 135 | 15 | 0.25 | 45 |
| ARROW | 8 | 135 | 12 | 0.10 | 9.6 |
| PED. SIGNAL | 4 | 90 | 25 | 1.00 | 100 |
| CONTROLLER | 1 | 100 | 100 | 1.00 | 100 |
| ILLUM. SIGN | | | 25 | 0.05 | |
| FLASHER | | | | 0.50 | |
| ENERGY COSTS TO: | | | | | TOTAL = 431.6 |

ILLINOIS DEPARTMENT OF TRANSPORTATION
201 WEST CENTER COURT
SCHAUMBURG, ILLINOIS 60196-1096

ENERGY SUPPLY CONTACT: CURTIS TOPPS
PHONE: (630) 691-4356
COMPANY: COMMONWEALTH EDISON

STATE OF ILLINOIS
DEPARTMENT OF TRANSPORTATION

TRAFFIC SIGNAL CABLE PLAN, PHASE DESIGNATION DIAGRAM,
EMERGENCY VEHICLE PREEMPTION SEQUENCE, AND SCHEDULE OF QUANTITIES
ILLINOIS ROUTE 53 (ROHLWING RD.) AT MALL ENTRANCE

| F.A.P. RTE. | SECTION | COUNTY | TOTAL SHEETS | SHEET NO. |
|-------------|---------|--------|--------------|-----------|
| 2578 | 532B | DuPage | 781 | 454 |

CONTRACT NO. 60477

SCALE: NONE SHEET NO. OF SHEETS STA. TO STA.

FED. ROAD DIST. NO. ILLINOIS FED. AID PROJECT

NOTES FOR TEMPORARY TRAFFIC SIGNALS

1. ALL CONTROL EQUIPMENT INCLUDING EMERGENCY PRE-EMPTION AND COMMUNICATION DEVICES FOR THE TEMPORARY TRAFFIC SIGNAL(S) SHALL BE FURNISHED BY THE CONTRACTOR.
2. ONLY CONTROLLERS SUPPLIED BY ONE OF THE DISTRICT APPROVED CLOSED LOOP EQUIPMENT MANUFACTURERS WILL BE APPROVED FOR USE AT TEMPORARY SIGNAL LOCATIONS. ALL CONTROLLERS USED FOR TEMPORARY TRAFFIC SIGNALS SHALL BE FULLY ACTUATED NEMA MICROPROCESSOR BASED WITH RS232 DATA ENTRY PORTS COMPATIBLE WITH EXISTING MONITORING SOFTWARE APPROVED BY IDOT DISTRICT 1, INSTALLED IN A NEMA TS2 CABINET. ONLY ONE BRAND OF CONTROLLER WILL BE ACCEPTED FOR ANY ONE CONTRACT.
3. ALL TRAFFIC SIGNAL SECTIONS AND PEDESTRIAN SIGNAL SECTIONS SHALL BE LED AND 12" (300mm) DIAMETER. HEADS SHALL BE PLACED AS INDICATED ON THE TEMPORARY TRAFFIC SIGNAL PLAN OR AS DIRECTED BY THE ENGINEER. PEDESTRIAN SIGNALS SHALL INCLUDE SOLID INTERNATIONAL SYMBOLS. PEDESTRIAN SIGNALS WITH COUNTDOWN TIMERS SHALL BE USED WHEN THE EXISTING INSTALLATION UTILIZES COUNTDOWN TYPE OR AS DIRECTED BY THE ENGINEER. COUNTDOWN TYPE PEDESTRIAN SIGNALS ARE NOT TO BE INSTALLED AT A RAILROAD INTERSECTION. THE CONTRACTOR SHALL FURNISH ENOUGH CABLE SLACK TO RELOCATE HEADS TO ANY POSITION ON THE SPAN WIRE OR AT LOCATIONS ILLUSTRATED ON THE PLANS FOR CONSTRUCTION STAGING. THE TEMPORARY TRAFFIC SIGNAL SHALL REMAIN IN OPERATION DURING ALL SIGNAL HEAD RELOCATIONS. EACH TEMPORARY TRAFFIC SIGNAL HEAD SHALL HAVE ITS OWN CABLE FROM THE CONTROLLER CABINET TO THE SIGNAL HEAD.
4. ALL EXISTING STREET NAME AND INTERSECTION REGULATORY SIGNS SHALL BE REMOVED FROM EXISTING POLES, RELOCATED AND SECURELY FASTENED TO THE SPAN WIRE OR WOOD POLE AS DIRECTED BY THE ENGINEER.
5. ANY TEMPORARY SIGNAL WITHIN AN EXISTING CLOSED LOOP TRAFFIC SIGNAL SYSTEM SHALL BE INTERCONNECTED TO THAT SYSTEM USING SIMILAR BRAND CONTROL EQUIPMENT.
6. THE TEMPORARY TRAFFIC SIGNAL SHALL HAVE THE SIGNAL HEAD DISPLAYS, SIGNAL HEAD PLACEMENTS AND CONTROLLER PHASING MATCH THE EXISTING TRAFFIC SIGNAL, AT THE TIME OF THE TURN ON, IF NO TRAFFIC STAGING IS IN PLACE OR WILL NOT BE STAGED ON THE DAY OF THE TURN ON.
7. UNINTERRUPTIBLE POWER SUPPLY (UPS) SYSTEMS SHALL BE INSTALLED AND MADE OPERATIONAL AT TEMPORARY TRAFFIC SIGNAL INSTALLATIONS WHERE UPS IS INSTALLED AT THE EXISTING TRAFFIC SIGNAL, TEMPORARY TRAFFIC SIGNALS AT RAILROAD INTERSECTIONS, AND TEMPORARY TRAFFIC SIGNALS AT INTERSECTIONS WITH FIRE STATION ACTUATED EMERGENCY VEHICLE PRE-EMPTION, OR WHEN INDICATED ON THE PLANS.
8. TRAFFIC SIGNAL MANAGEMENT SYSTEMS SHALL BE MAINTAINED IN OPERATION AS INDICATED ON THE PLANS OR AS DIRECTED BY THE ENGINEER. REQUIRED EQUIPMENT SHALL BE AS SHOWN ON THE PLANS AND THE CONTRACTOR SHALL PLACE THE EQUIPMENT IN OPERATION TO THE SATISFACTION OF THE ENGINEER AND THE AGENCY RESPONSIBLE FOR THE TRAFFIC SIGNAL MANAGEMENT SYSTEM.
9. DETECTION AT TEMPORARY TRAFFIC SIGNALS SHALL BE INCLUDED FOR ALL APPROACHES OF THE INTERSECTION UNLESS INDICATED OTHERWISE ON THE PLANS. THE DETECTION SYSTEM MUST MEET THE SPECIFICATIONS OF DISTRICT 1 AND THE CONTRACTOR SHALL PLACE THE DETECTORS INTO OPERATION TO THE SATISFACTION OF THE ENGINEER.
10. WHEN PAN, TILT, ZOOM CAMERAS ARE INSTALLED AT THE EXISTING INTERSECTION OR ARE CALLED FOR IN THE PLANS, THE CONTRACTOR SHALL BE RESPONSIBLE FOR INSTALLING AND MAINTAINING THE CAMERAS TO THE SATISFACTION OF THE ENGINEER AND THE AGENCY RESPONSIBLE FOR THE CAMERAS.

THE FOLLOWING ITEMS SHALL BE REMOVED BY THE CONTRACTOR AND SHALL BE DISPOSED OF BY THEM OUTSIDE THE RIGHT-OF-WAY AT THEIR EXPENSE. THE SALVAGE VALUE OF THE REMOVED EQUIPMENT SHALL BE REFLECTED IN THE CONTRACTOR'S BID PRICE.

- | | | |
|----|------|--|
| 1 | EACH | CONTROLLER AND CABINET COMPLETE |
| 4 | EACH | SIGNAL HEAD, 1-FACE, 3-SECTION, MAST ARM MOUNTED |
| 6 | EACH | SIGNAL HEAD, 1-FACE, 5-SECTION, MAST ARM MOUNTED |
| 1 | EACH | SIGNAL HEAD, 2-FACE, 1-3 SECTION, 1-5 SECTION, BRACKET MOUNTED |
| 3 | EACH | SIGNAL HEAD, 2-FACE, 5-SECTION, BRACKET MOUNTED |
| 2 | EACH | PEDESTRIAN SIGNAL HEAD, 1-FACE, BRACKET MOUNTED |
| 2 | EACH | PEDESTRIAN SIGNAL HEAD, 2-FACE, BRACKET MOUNTED |
| 2 | EACH | PEDESTRIAN SIGNAL HEAD, 3-FACE, BRACKET MOUNTED |
| 10 | EACH | TRAFFIC SIGNAL BACKPLATE |
| 4 | EACH | TRAFFIC SIGNAL POST |
| 4 | EACH | STEEL MAST ARM ASSEMBLY AND POLE |
| 6 | EACH | PEDESTRIAN PUSH-BUTTON |
| 1 | EACH | SERVICE INSTALLATION |

THE FOLLOWING EXISTING TRAFFIC SIGNAL EQUIPMENT SHALL BE REMOVED BY THE CONTRACTOR, SHALL REMAIN THE PROPERTY OF THE AGENCY LISTED BELOW. THE CONTRACTOR SHALL SAFELY STORE AND ARRANGE FOR PICK UP OF ALL EQUIPMENT TO BE RETURNED TO THE LISTED AGENCY AS PER THE TRAFFIC SIGNAL SPECIFICATIONS.

- | | | |
|---|------|--------------------------|
| 2 | EACH | LIGHT DETECTOR |
| 1 | EACH | LIGHT DETECTOR AMPLIFIER |

THE CONTRACTOR SHALL CONTACT THE ENFORCEMENT CAMERA VENDOR AND THE MUNICIPALITY TO ADVISE THEM OF THE PROPOSED IMPROVEMENT FOR REMOVAL OF THEIR EQUIPMENTS, TWO WEEKS PRIOR TO START OF WORK. THE CONTACT INFORMATION IS:


| | | |
|--------------------|---------------|-------------------|
| MUNICIPALITY | NAME | VENDOR |
| VILLAGE OF ADDISON | RUDE ESPEDIDO | REDSPEED ILLINOIS |
| | CONTACT | ROBYN LEIGHTON |
| | PHONE | (630) 317-5736 |
| (630) 693-7533 | | |

TEMPORARY TRAFFIC SIGNAL LEGEND

⊗ ⊗ TEMPORARY COMBINATION TRAFFIC SIGNAL WOOD POLE

TEMPORARY RADIO INTERCONNECT TO RAMP G (EAST RAMP)
(SEE TEMPORARY INTERCONNECT PLANS)

TEMPORARY RADIO INTERCONNECT TO MALL ENTRANCE
(SEE TEMPORARY INTERCONNECT PLANS)

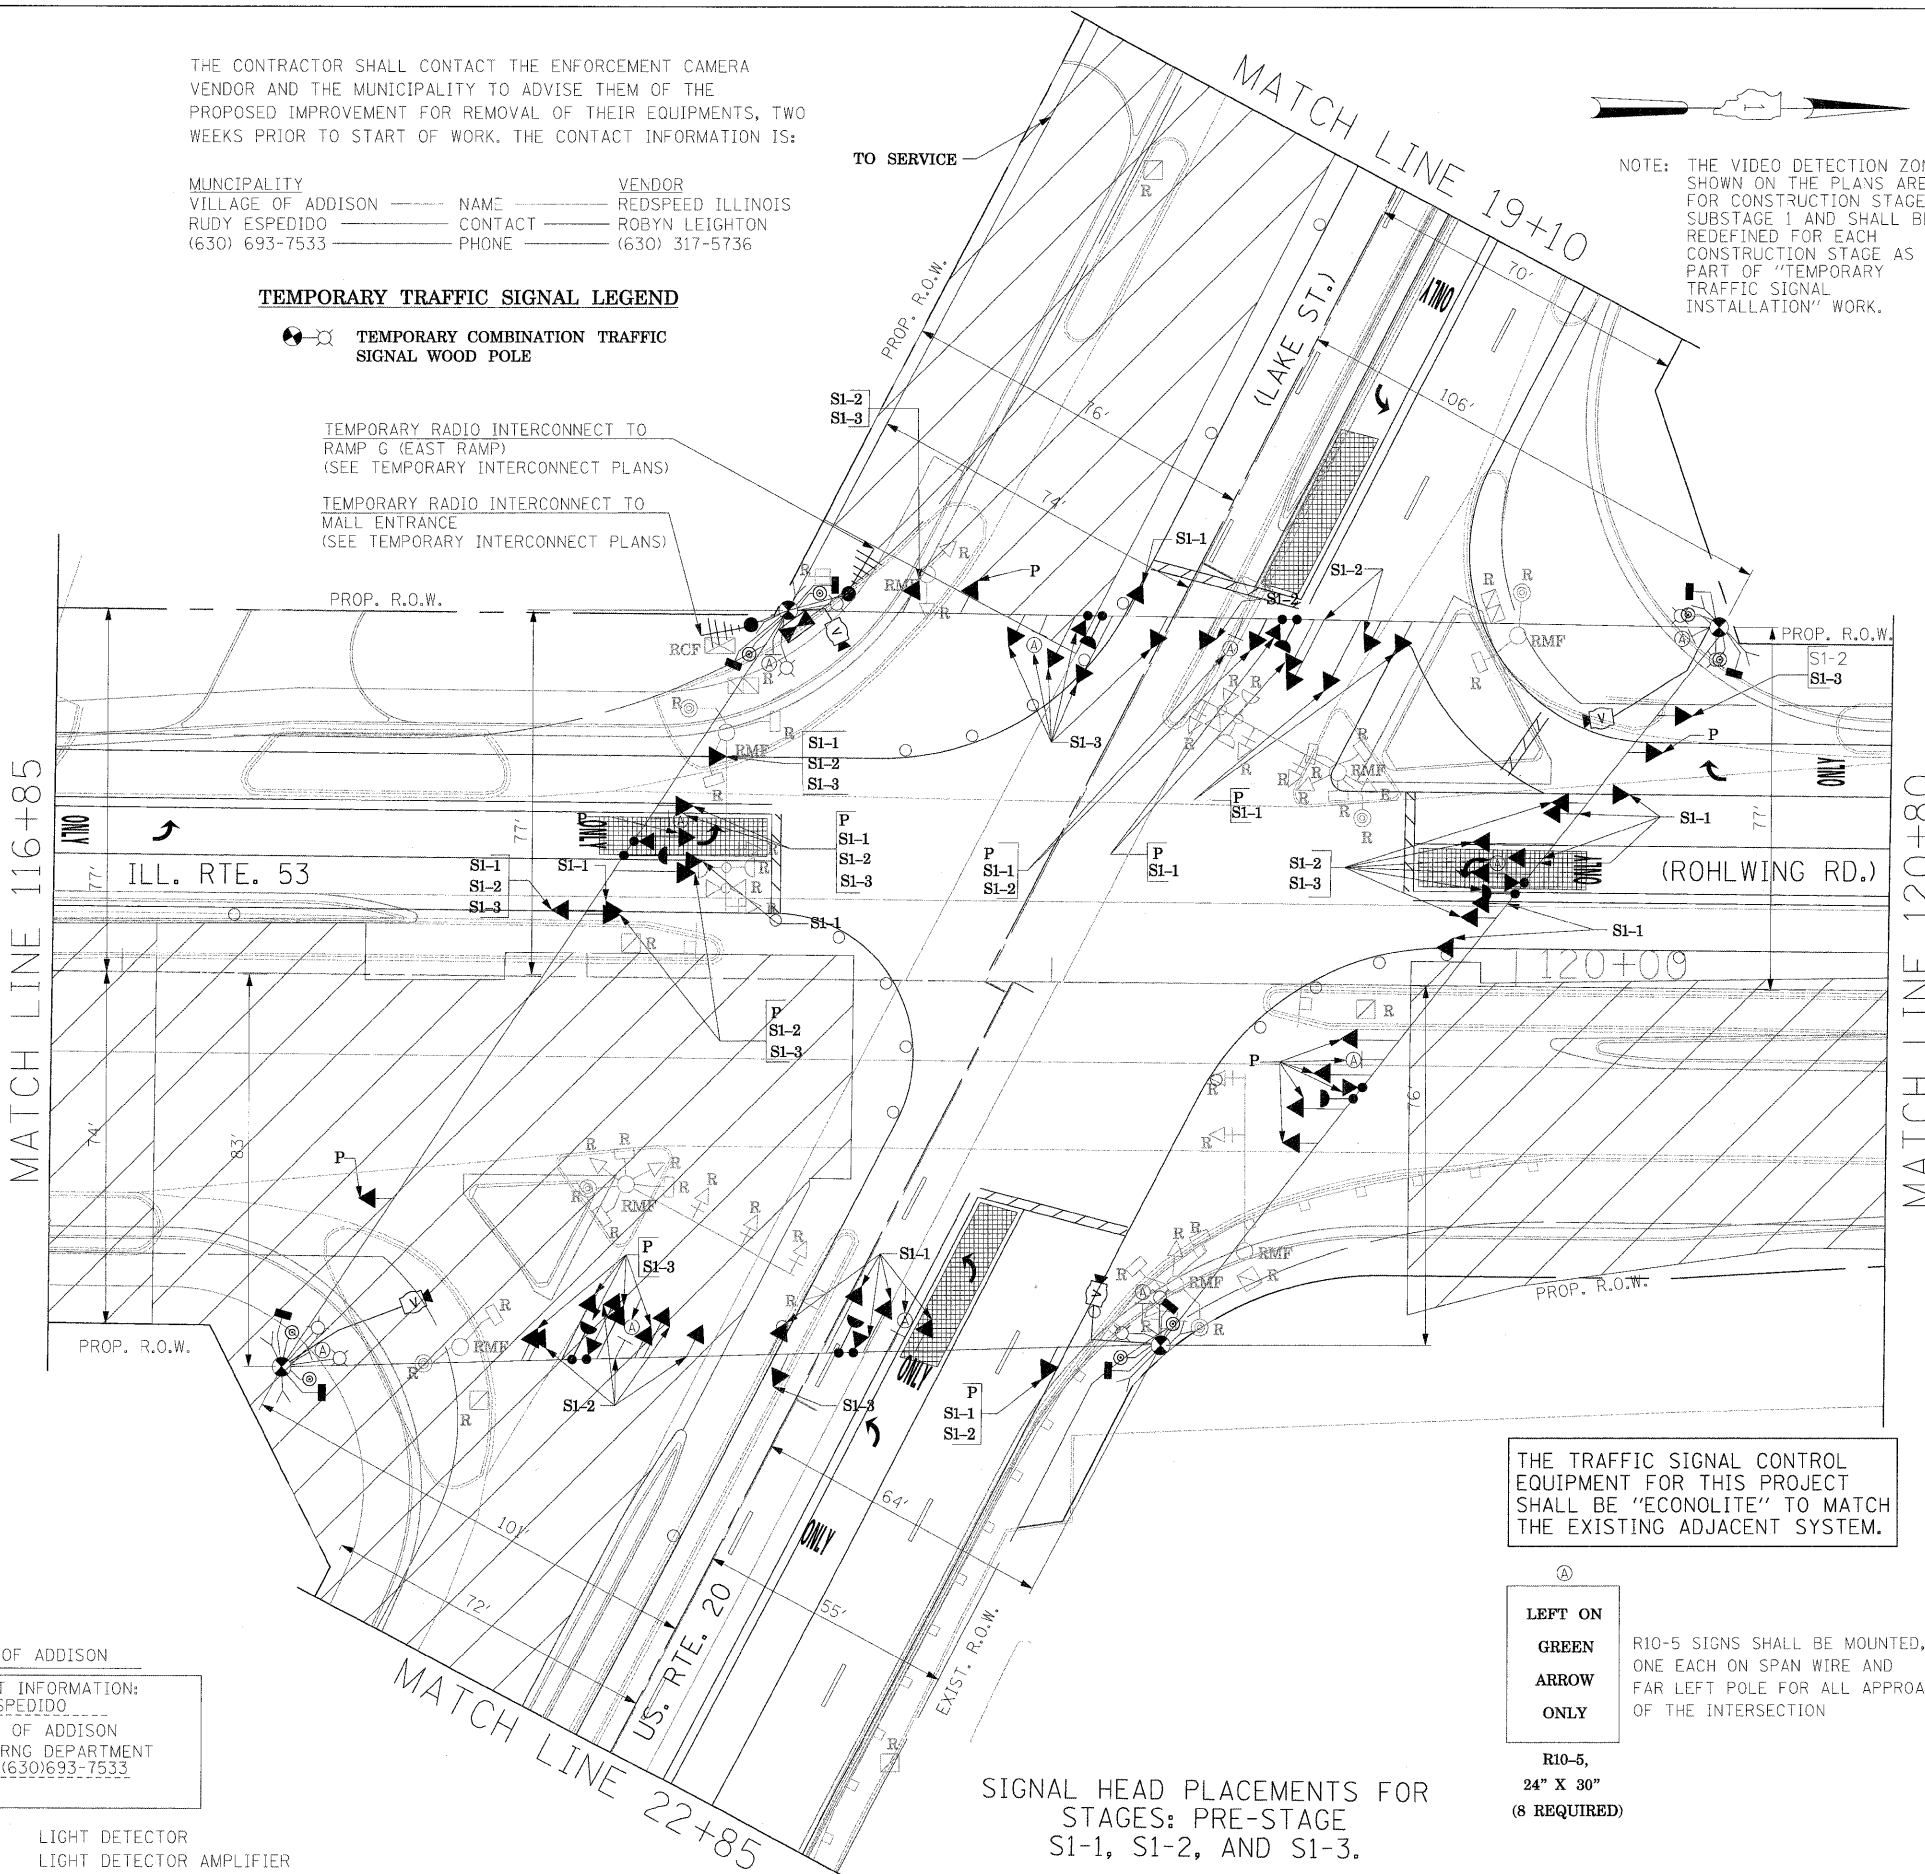

NOTE: THE VIDEO DETECTION ZONES SHOWN ON THE PLANS ARE FOR CONSTRUCTION STAGE 1 - SUBSTAGE 1 AND SHALL BE REDEFINED FOR EACH CONSTRUCTION STAGE AS A PART OF "TEMPORARY TRAFFIC SIGNAL INSTALLATION" WORK.




THE TRAFFIC SIGNAL CONTROL EQUIPMENT FOR THIS PROJECT SHALL BE "ECONOLITE" TO MATCH THE EXISTING ADJACENT SYSTEM.

Ⓐ
LEFT ON
GREEN
ARROW
ONLY

R10-5,
24" X 30"
(8 REQUIRED)

SIGNAL HEAD PLACEMENTS FOR STAGES: PRE-STAGE S1-1, S1-2, AND S1-3.

| | | | | | | | | | | | | | | |
|-------------|----------------------|-------------------|-----------|---|--|-----------|----|--------|-------------|---------|--------|---|-----------|--------------------|
| FILE NAME = | USER NAME = #USER# | DESIGNED - PKG | REVISED - | STATE OF ILLINOIS DEPARTMENT OF TRANSPORTATION | TEMPORARY TRAFFIC SIGNAL INSTALLATION AND REMOVAL PLAN ILLINOIS ROUTE 53 (ROHLWING RD.) AT U.S. ROUTE 20 (LAKE ST.) PRE STAGE AND STAGE 1 (SHEET 1 OF 6). | | | | F.A.P. RTE. | SECTION | COUNTY | TOTAL SHEETS | SHEET NO. | |
| \$FILEL\$ | | DRAWN - MAA, EA | REVISED - | | SCALE: 1"=20' | SHEET NO. | OF | SHEETS | STA. | TO STA. | 2578 | 532B | DuPage | 781 455 |
| | PLOT SCALE = #SCALE# | CHECKED - PKG, EA | REVISED - | | | | | | | | | | | |
| | PLOT DATE = #DATE# | DATE - 5/10/2010 | REVISED - | | | | | | | | | | | CONTRACT NO. 60477 |
| | | | | | | | | | | | | FED. ROAD DIST. NO. - ILLINOIS FED. AID PROJECT | | |

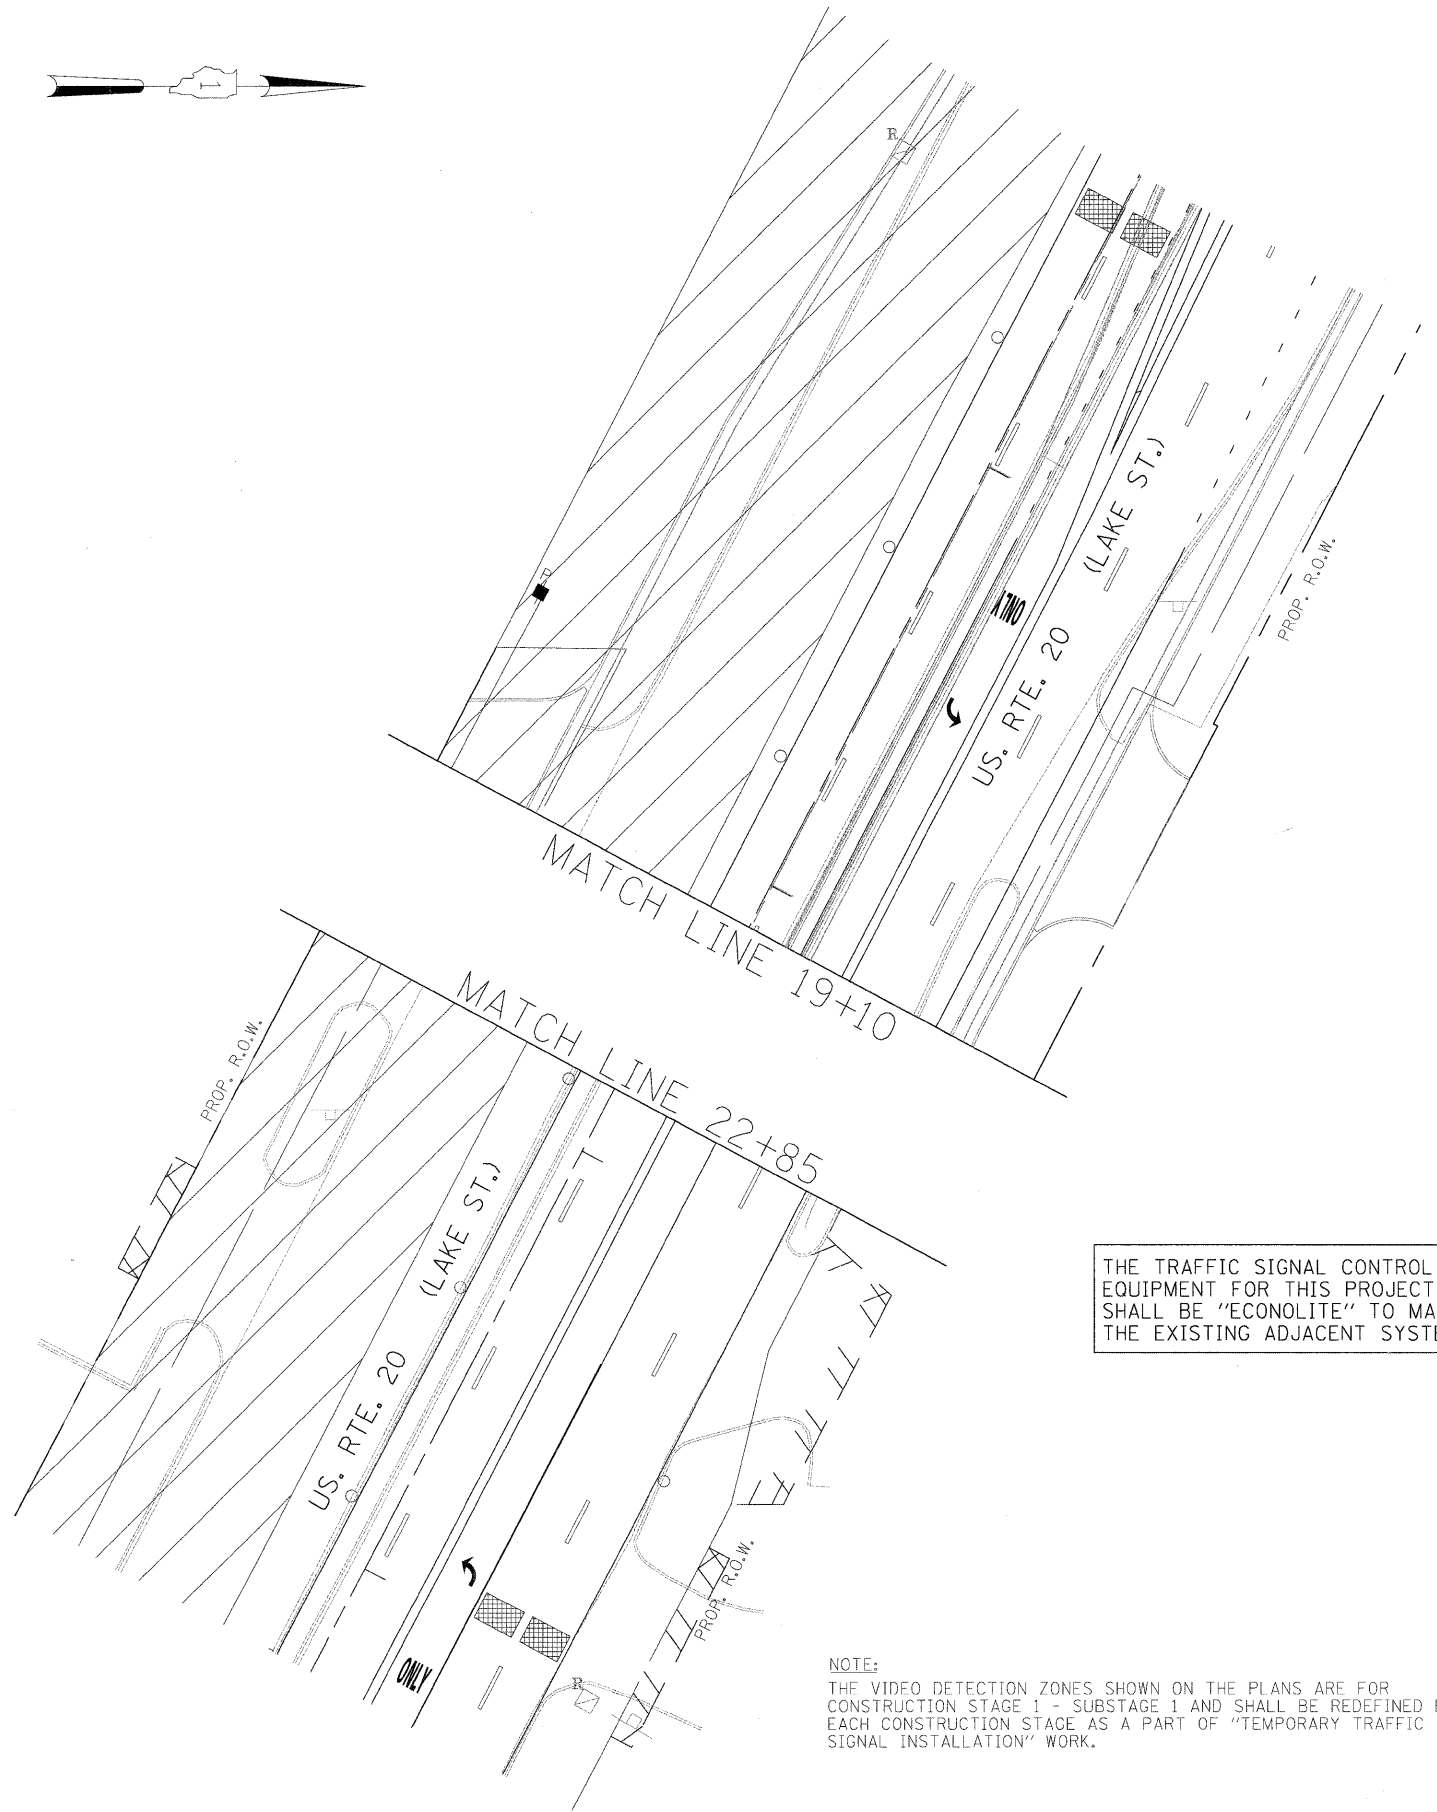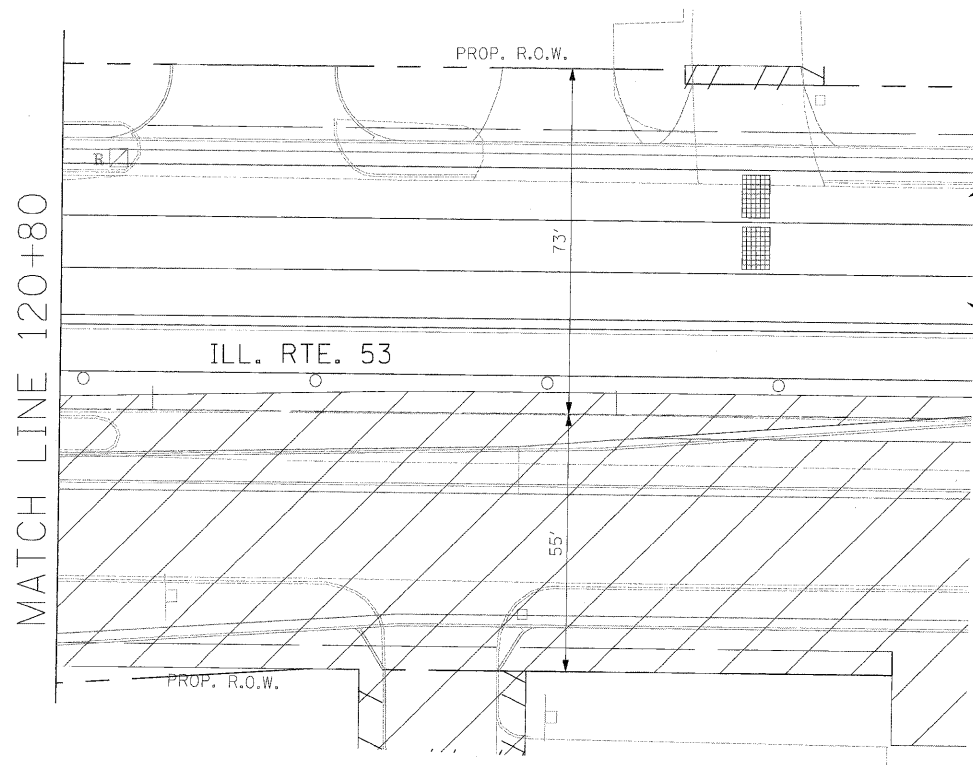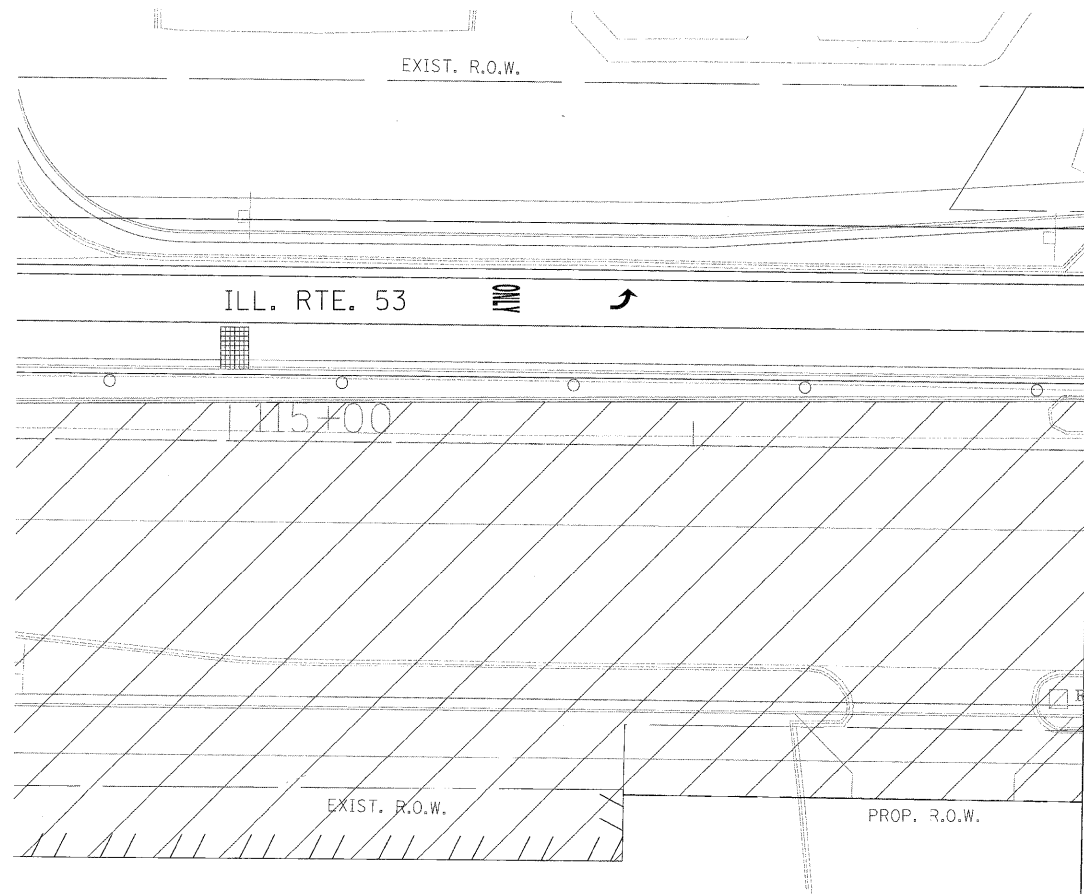

THE TRAFFIC SIGNAL CONTROL EQUIPMENT FOR THIS PROJECT SHALL BE "ECONOLITE" TO MATCH THE EXISTING ADJACENT SYSTEM.

NOTE:
THE VIDEO DETECTION ZONES SHOWN ON THE PLANS ARE FOR CONSTRUCTION STAGE 1 - SUBSTAGE 1 AND SHALL BE REDEFINED FOR EACH CONSTRUCTION STAGE AS A PART OF "TEMPORARY TRAFFIC SIGNAL INSTALLATION" WORK.

| | | | |
|------------------------|----------------------|-------------------|-----------|
| FILE NAME = #FILEL# | USER NAME = #USER# | DESIGNED - PKG | REVISED - |
| | PLOT SCALE = #SCALE# | DRAWN - MAA, EA | REVISED - |
| | PLOT DATE = #DATE# | CHECKED - PKG, EA | REVISED - |
| | | DATE - 5/10/2010 | REVISED - |

**STATE OF ILLINOIS
DEPARTMENT OF TRANSPORTATION**

| | | | |
|---|---------------------|--------------|--|
| TEMPORARY TRAFFIC SIGNAL INSTALLATION AND REMOVAL PLAN ILLINOIS ROUTE 53 (ROHLWING RD.) AT U.S. ROUTE 20 (LAKE ST.) PRE STAGE AND STAGE 1 (SHEET 2 OF 6) | | | |
| SCALE: 1"=20' | SHEET NO. OF SHEETS | STA. TO STA. | |

| | | | | |
|--------------------------------|--------------|---------------|-------------------------------------|---------------|
| F.A.P. RTE. 2578 | SECTION 532B | COUNTY DuPage | TOTAL SHEETS 781 | SHEET NO. 456 |
| FED. ROAD DIST. NO. - ILLINOIS | | | FED. AID PROJECT CONTRACT NO. 60477 | |

TEMPORARY TRAFFIC SIGNAL LEGEND

⊙ ◻ TEMPORARY COMBINATION TRAFFIC SIGNAL WOOD POLE

NOTE: THE VIDEO DETECTION ZONES SHOWN ON THE PLANS ARE FOR CONSTRUCTION STAGE 1 - SUBSTAGE 1 AND SHALL BE REDEFINED FOR EACH CONSTRUCTION STAGE AS A PART OF "TEMPORARY TRAFFIC SIGNAL INSTALLATION" WORK.




Ⓐ
LEFT ON
GREEN
ARROW
ONLY

R10-5,
24" X 30"
(8 REQUIRED)

R10-5 SIGNS SHALL BE MOUNTED, ONE EACH ON SPAN WIRE AND FAR LEFT POLE FOR ALL APPROACHES OF THE INTERSECTION

THE TRAFFIC SIGNAL CONTROL EQUIPMENT FOR THIS PROJECT SHALL BE "ECONOLITE" TO MATCH THE EXISTING ADJACENT SYSTEM.

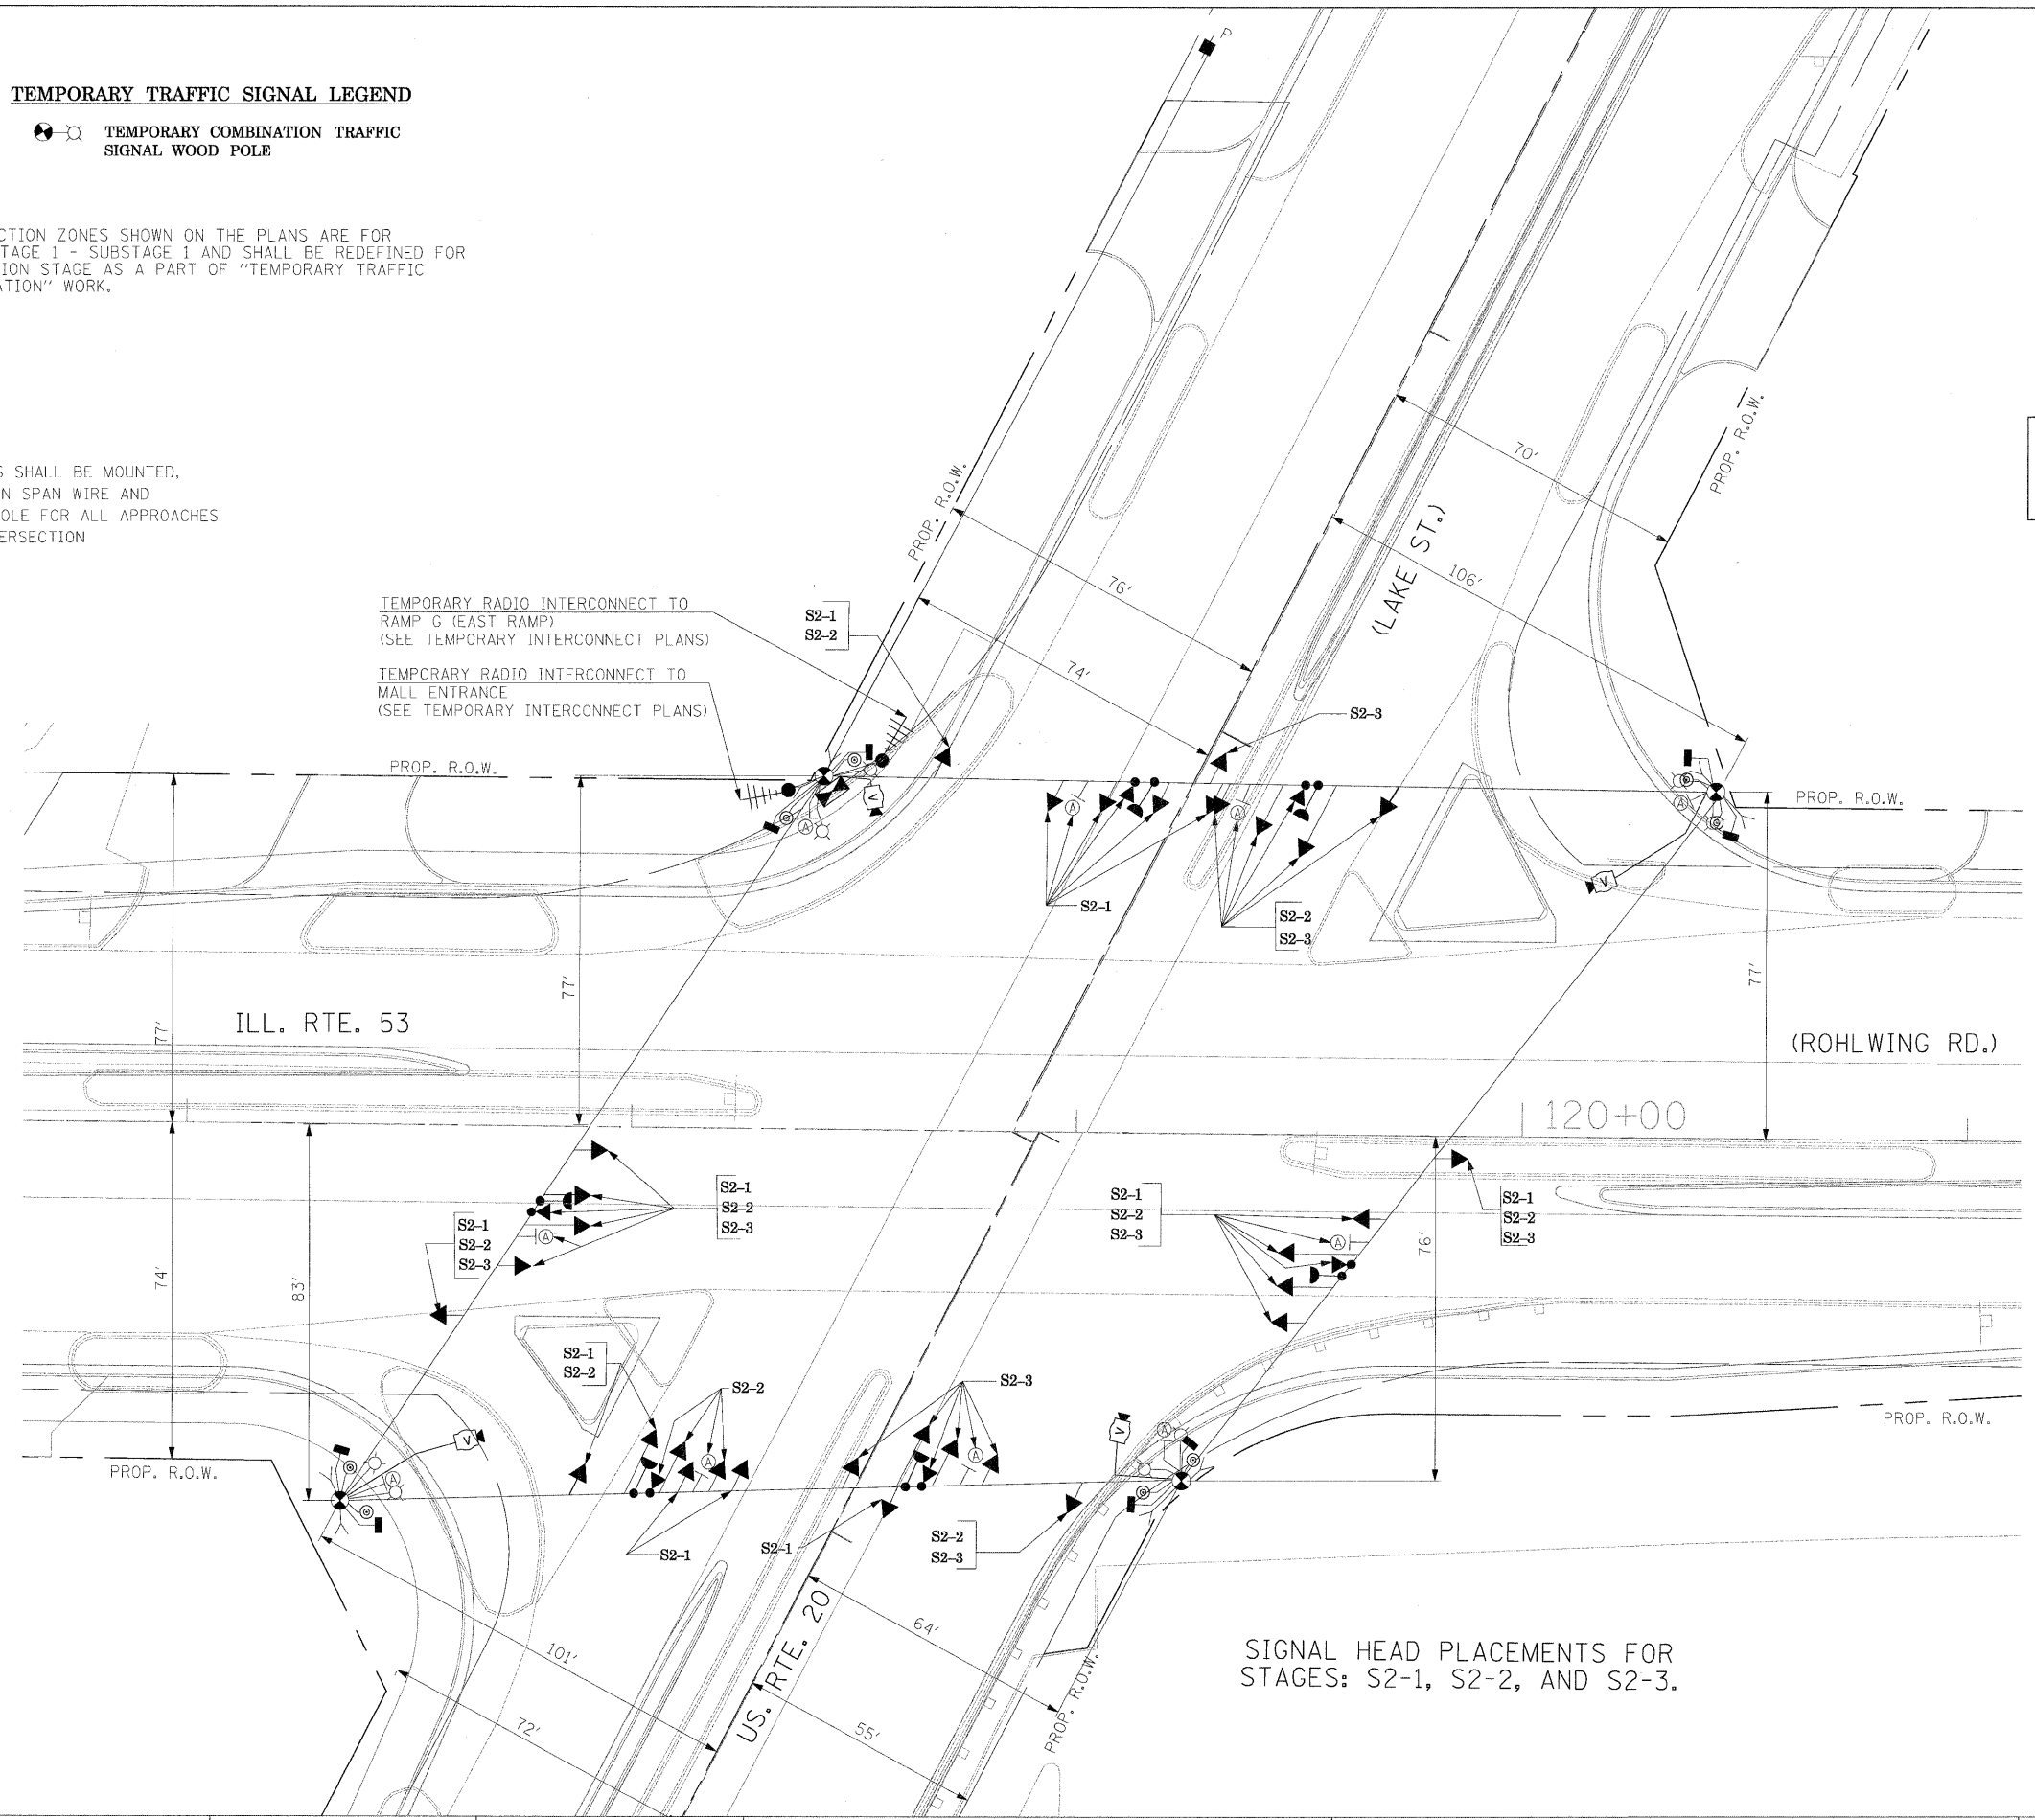

TEMPORARY RADIO INTERCONNECT TO RAMP G (EAST RAMP)
(SEE TEMPORARY INTERCONNECT PLANS)

TEMPORARY RADIO INTERCONNECT TO MALL ENTRANCE
(SEE TEMPORARY INTERCONNECT PLANS)

SIGNAL HEAD PLACEMENTS FOR STAGES: S2-1, S2-2, AND S2-3.

| | | | | | | | | | | | | |
|-------------|--------------------|--------------------|-----------|---|---|---------------------|--------------|---|-----------------|------------------|---------------------|------------------|
| FILE NAME = | USER NAME = #USER# | DESIGNED - PKG | REVISED - | STATE OF ILLINOIS DEPARTMENT OF TRANSPORTATION | TEMPORARY TRAFFIC SIGNAL INSTALLATION AND REMOVAL PLAN ILLINOIS ROUTE 53 (ROHLWING RD.) AT U.S. ROUTE 20 (LAKE ST.) STAGE 2 (SHEET 3 OF 6) | | | F.A.P. RTE. 2578 | SECTION 532B | COUNTY DuPage | TOTAL SHEETS 781 | SHEET NO. 457 |
| #FILE# | | DRAWN - MAA, EA | REVISED - | | SCALE: 1"=20' | SHEET NO. OF SHEETS | STA. TO STA. | FED. ROAD DIST. NO. - ILLINOIS FED. AID PROJECT | | | | |
| | | CHECKED - PKG, EA | REVISED - | | | | | CONTRACT NO. 60477 | | | | |
| | | PLOT DATE = #DATE# | REVISED - | | | | | | | | | |

TEMPORARY TRAFFIC SIGNAL LEGEND

⊙ ⊙ TEMPORARY COMBINATION TRAFFIC SIGNAL WOOD POLE




NOTE: THE VIDEO DETECTION ZONES SHOWN ON THE PLANS ARE FOR CONSTRUCTION STAGE 1 - SUBSTAGE 1 AND SHALL BE REDEFINED FOR EACH CONSTRUCTION STAGE AS A PART OF "TEMPORARY TRAFFIC SIGNAL INSTALLATION" WORK.

Ⓐ
LEFT ON GREEN ARROW ONLY
R10-5, 24" X 30" (8 REQUIRED)



R10-5 SIGNS SHALL BE MOUNTED, ONE EACH ON SPAN WIRE AND FAR LEFT POLE FOR ALL APPROACHES OF THE INTERSECTION

TEMPORARY RADIO INTERCONNECT TO RAMP C (EAST RAMP) (SEE TEMPORARY INTERCONNECT PLANS)
TEMPORARY RADIO INTERCONNECT TO MALL ENTRANCE (SEE TEMPORARY INTERCONNECT PLANS)

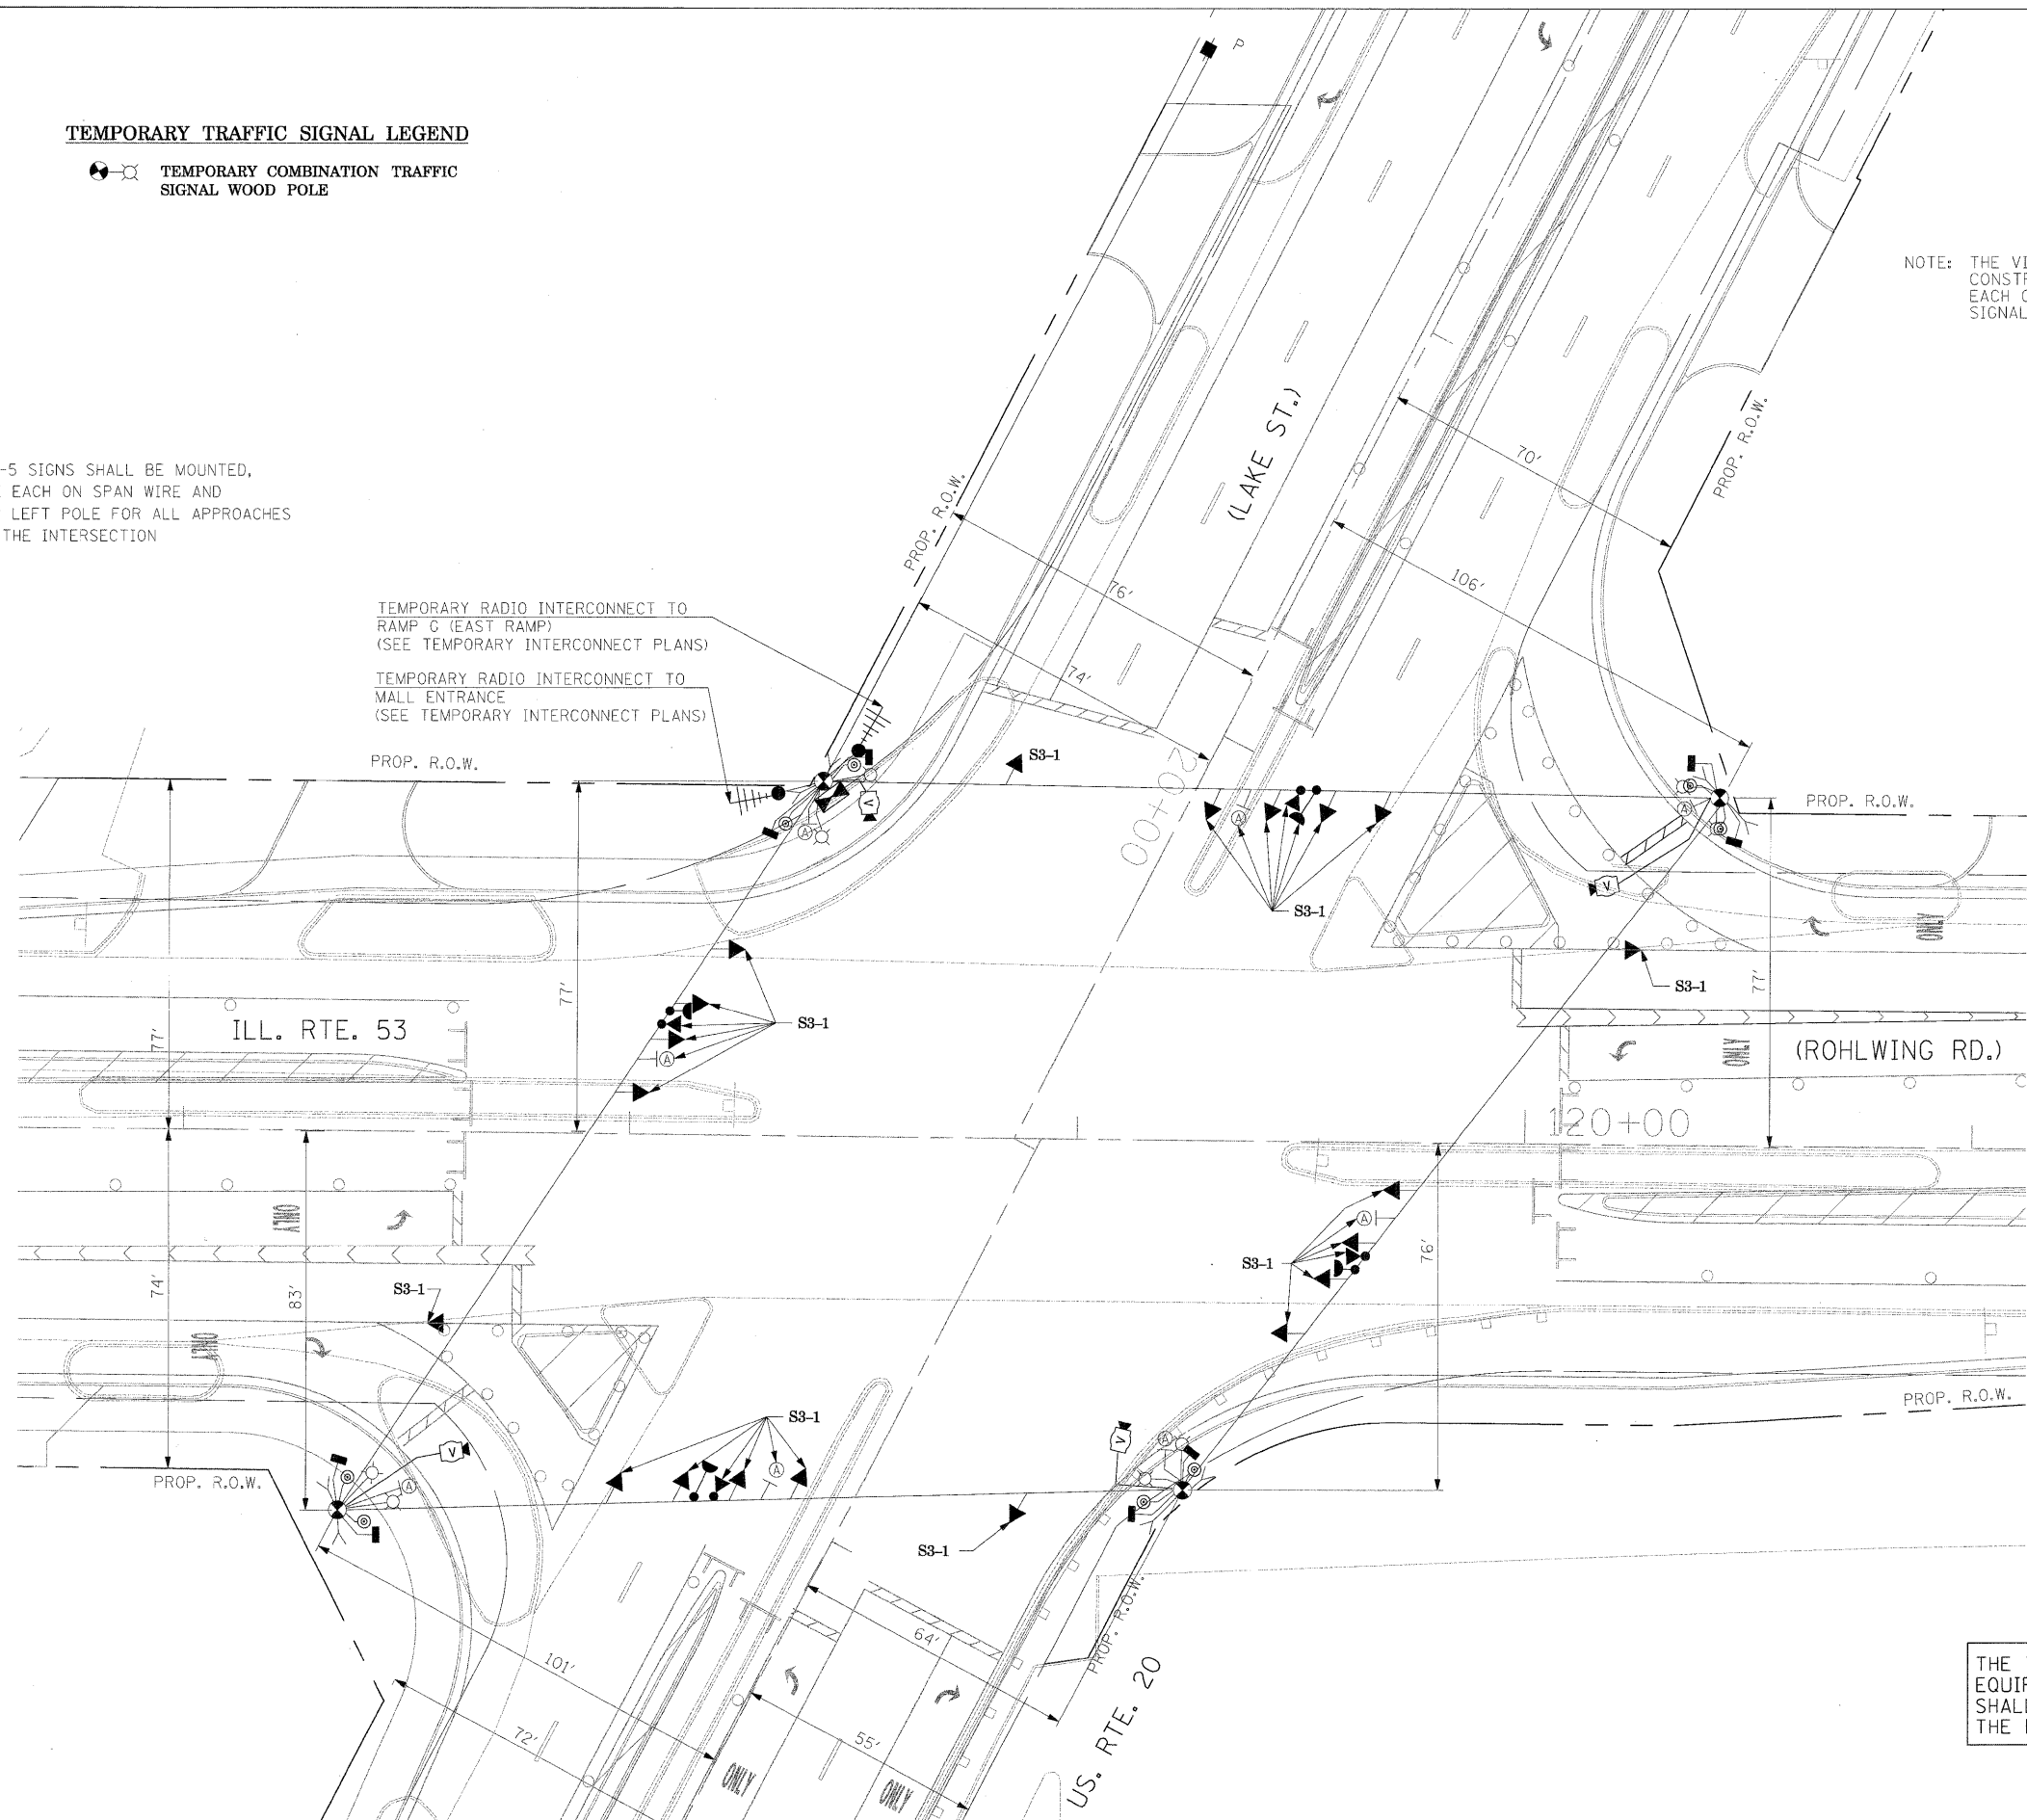


THE TRAFFIC SIGNAL CONTROL EQUIPMENT FOR THIS PROJECT SHALL BE "ECONOLITE" TO MATCH THE EXISTING ADJACENT SYSTEM.

| | | | | | | | | | | | | |
|--------------------|----------------------|-------------------|-----------|---|---|--------------|-------------|------------------|---|--------------------|------------------|---------------|
| FILE NAME = #FILE# | USER NAME = #USER# | DESIGNED - PKG | REVISED - | STATE OF ILLINOIS DEPARTMENT OF TRANSPORTATION | TEMPORARY TRAFFIC SIGNAL INSTALLATION AND REMOVAL PLAN ILLINOIS ROUTE 53 (ROHLWING RD.) AT U.S. ROUTE 20 (LAKE ST.) STAGE 3 (SHEET 4 OF 6) | | | F.A.P. RTE. 257B | SECTION 532B | COUNTY DuPage | TOTAL SHEETS 781 | SHEET NO. 458 |
| | PLOT SCALE = #SCALE# | DRAWN - MAA, EA | REVISED - | | SCALE: 1"=20' | SHEET NO. OF | SHEETS STA. | TO STA. | FED. ROAD DIST. NO. - ILLINOIS FED. AID PROJECT | CONTRACT NO. 60477 | | |
| | PLOT DATE = #DATE# | CHECKED - PKG, EA | REVISED - | | | | | | | | | |
| | | DATE - 5/10/2010 | REVISED - | | | | | | | | | |

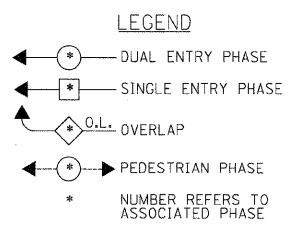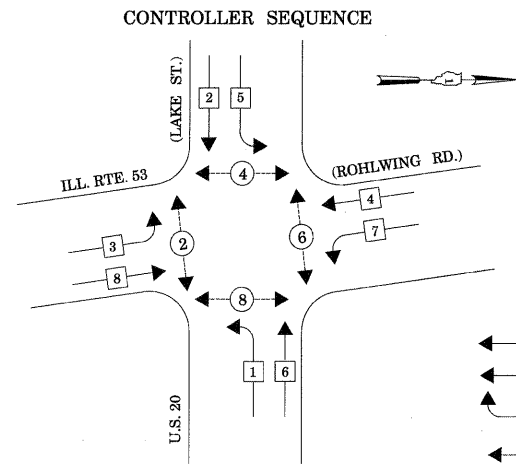

TEMPORARY PHASE DESIGNATION DIAGRAM
 STAGES: PRE-STAGE, S1-1, S1-3, S2-1, S2-3, S3, AND
 AFTER PROPOSED ROADWAY GEOMETRICS ARE BUILT


EMERGENCY VEHICLE PREEMPTION SEQUENCE

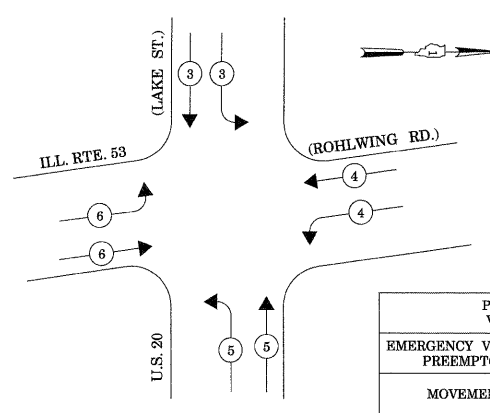

| PROPOSED EMERGENCY VEHICLE PREEMPTORS | | | | |
|---------------------------------------|-----|-----|-----|-----|
| EMERGENCY VEHICLE PREEMPTOR | 3 | 4 | 5 | 6 |
| MOVEMENT | ↓ ↓ | ← → | ↑ ↑ | → → |

STAGES: PRE-STAGE, S1-1, S1-3, S2-1, S2-3, S3, AND
 AFTER PROPOSED ROADWAY GEOMETRICS ARE BUILT

TEMPORARY RADIO INTERCONNECT TO RAMP G (EAST RAMP)
 (SEE TEMPORARY INTERCONNECT PLANS)
 TEMPORARY RADIO INTERCONNECT TO MALL ENTRANCE
 (SEE TEMPORARY INTERCONNECT PLANS)

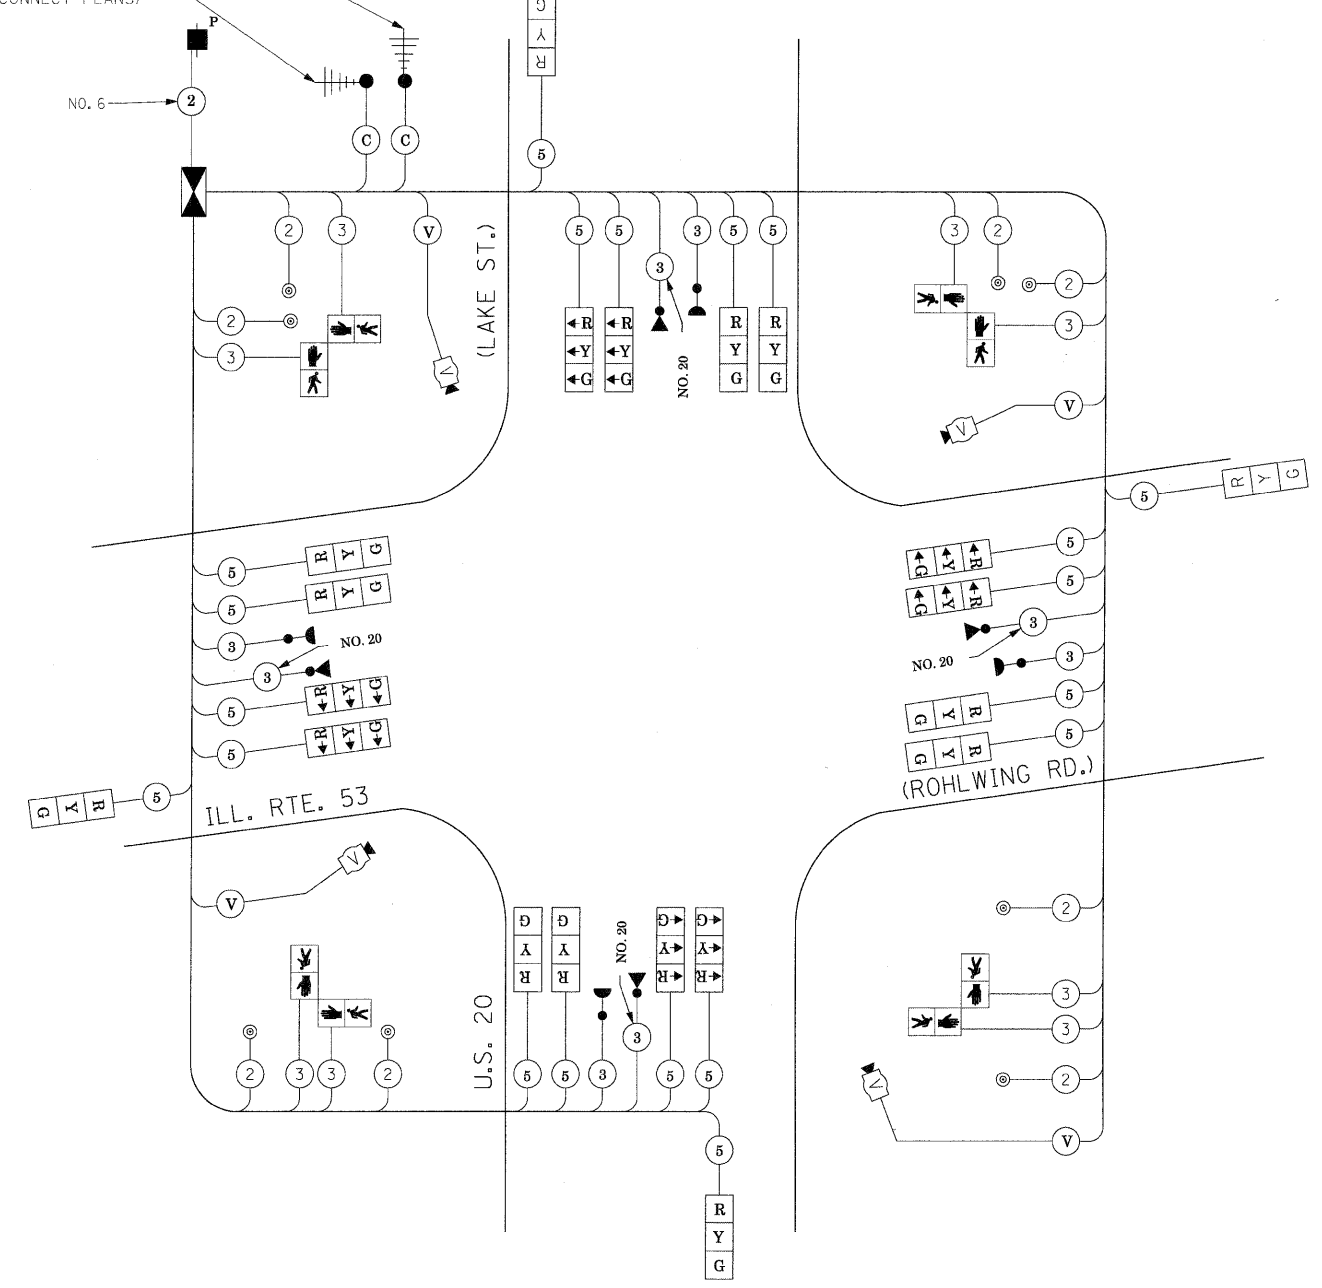

TEMPORARY CABLE PLAN

(NOT TO SCALE)

STAGES: PRE-STAGE, S1-1, S1-2, S1-3, S2-1, S2-2, S2-3, S3, AND
 AFTER PROPOSED ROADWAY GEOMETRICS ARE BUILT

THE TRAFFIC SIGNAL CONTROL EQUIPMENT FOR THIS PROJECT SHALL BE "ECONOLITE" TO MATCH THE EXISTING ADJACENT SYSTEM.

| I.D.O.T. TRAFFIC SIGNAL INSTALLATION ELECTRICAL SERVICE REQUIREMENTS | | | | | TOTAL WATTAGE |
|--|----------|---------|-----|------------|---------------|
| TYPE | NO LAMPS | WATTAGE | | %OPERATION | |
| | | INCAND. | LED | | |
| SIGNAL (RED) | 20 | 135 | 17 | 0.50 | 170 |
| (YELLOW) | 20 | 135 | 25 | 0.25 | 125 |
| (GREEN) | 20 | 135 | 15 | 0.25 | 75 |
| ARROW | | 135 | 12 | 0.10 | |
| PED. SIGNAL | | 90 | 25 | 1.00 | |
| CONTROLLER | 1 | 100 | 100 | 1.00 | 100 |
| ILLUM. SIGN | | | 25 | 0.05 | |
| VIDEO SYSTEM | 1 | 150 | | 1.00 | 150 |
| FLASHER | | | | 0.50 | |
| ENERGY COSTS TO: | | | | TOTAL = | 620 |

ILLINOIS DEPARTMENT OF TRANSPORTATION
 201 WEST CENTER COURT
 SCHAMBURG, ILLINOIS 60196-1096
 ENERGY SUPPLY CONTACT: CURTIS TOPPS
 PHONE: (630) 691-4356
 COMPANY: COMMONWEALTH EDISON

| | | | |
|-------------|----------------------|-------------------|-----------|
| FILE NAME = | USER NAME = #USER# | DESIGNED - PKG | REVISED - |
| #FILEL# | | DRAWN - MAA, EA | REVISED - |
| | PLOT SCALE = #SCALE# | CHECKED - PKG, EA | REVISED - |
| | PLOT DATE = #DATE# | DATE - 5/10/2010 | REVISED - |

STATE OF ILLINOIS
 DEPARTMENT OF TRANSPORTATION

TEMPORARY CABLE PLAN TEMPORARY PHASE DESIGNATION DIAGRAM
 TEMPORARY EMERGENCY VEHICLE PREEMPTION SEQUENCE
 ILLINOIS ROUTE 53 (ROHLWING RD.) AT U.S. 20 (LAKE ST.)
 PRE-STAGE, STAGE 1, STAGE 2, AND STAGE 3 (SHEET 6 OF 6).

| | | | | |
|---|---------|--------|--------------------|-----------|
| F.A.P. RTE. | SECTION | COUNTY | TOTAL SHEETS | SHEET NO. |
| 2578 | 532B | DuPage | 781 | 459 |
| FED. ROAD DIST. NO. - ILLINOIS FED. AID PROJECT | | | CONTRACT NO. 60477 | |

TEMPORARY EMERGENCY VEHICLE SEQUENCE OF OPERATION (FOR STAGE 1, SUB STAGE 2 AND STAGE 2, SUB STAGE 2 WITH LEAD-LAG OPERATION FOR US RTE. 20 AND ILL. RTE. 53)

| | | | | | | | | | | | | | | | | | | | | | | | | | | | | | | |
|---|-----|----|----|----------|----|----|----|----|----|----------|----|----|----|----|----|----------|----|----|----|----------|----|----|----|-----|-----|-----|-----|-----|-----|-----|
| CHANGE FROM NORMAL SEQUENCE OF OPERATION INTERVAL NUMBER | 1 | 1 | 5 | 5 | 5 | 10 | 10 | 14 | 14 | 18 | 18 | 18 | | | | | | | | | | | | | | | | | | |
| EMERGENCY VEHICLE PRE-EMPTION SEQUENCE OF OPERATION INTERVAL NUMBER | 1A | 1B | 1C | 1D | 1E | 1F | 1G | 1H | 1J | 1K | 1L | 1M | 1N | 1P | 1Q | 1R | 1S | 1T | 1U | 1V | 1W | 1X | 1Y | 1Z | 1AA | 1BB | 1CC | 1DD | 1EE | 1FF |
| CHANGE TO EMERGENCY VEHICLE PRE-EMPTION SEQUENCE OF OPERATION INTERVAL NUMBER | 2 | 1C | 1D | 3,4 5 | 1F | 1G | 2 | 1J | 1K | 3,4 5 | 1M | 1N | 4 | 1Q | 1R | 2,3 5 | 4 | 1U | 1V | 2,3 4 | 5 | 1Y | 1Z | 2,4 | 1BB | 1CC | 3 | 1EE | 1FF | 5 |
| US ROUTE 20 (LAKE STREET) NEAR RIGHT AND TWO FAR RIGHT SPAN WIRE SIGNAL | E/B | G | G | Y | R | G | G | G | Y | R | G | Y | R | R | R | R | R | R | R | R | R | R | R | R | R | R | R | R | R | R |
| US ROUTE 20 (LAKE STREET) TWO FAR LEFT SPAN WIRE SIGNALS WITH LEFT TURN ARROWS | E/B | ←G | ←G | ←Y | ←R | ←R |
| US ROUTE 20 (LAKE STREET) NEAR RIGHT AND TWO FAR RIGHT SPAN WIRE SIGNAL | W/B | R | R | R | R | G | Y | R | G | Y | R | G | G | G | Y | R | G | R | R | R | R | R | R | R | R | R | R | R | R | R |
| US ROUTE 20 (LAKE STREET) TWO FAR LEFT SPAN WIRE SIGNALS WITH LEFT TURN ARROWS | W/B | ←R | ←R | ←R | ←R | ←R | ←R | ←R | ←R | ←R | ←R | ←R | ←R | ←R | ←G | ←Y | ←R | ←G | ←R | ←R | ←R | ←R | ←R | ←R | ←R | ←R | ←R | ←R | ←R | ←R |
| ILLINOIS ROUTE 53 (ROHLWING ROAD) NEAR RIGHT AND TWO FAR RIGHT SPAN WIRE SIGNALS | N/B | R | R | R | R | R | R | R | R | R | R | R | R | R | R | R | R | G | Y | R | G | G | Y | R | G | Y | R | G | G | G |
| ILLINOIS ROUTE 53 (ROHLWING ROAD) TWO FAR LEFT SPAN WIRE SIGNALS WITH LEFT TURN ARROWS | N/B | ←R | ←R | ←R | ←R | ←R | ←R | ←R | ←R | ←R | ←R | ←R | ←R | ←R | ←R | ←R | ←R | ←G | ←Y | ←R | ←G | ←R | ←R | ←R | ←R | ←R | ←R | ←R | ←R | ←R |
| ILLINOIS ROUTE 53 (ROHLWING ROAD) NEAR RIGHT AND TWO FAR RIGHT SPAN WIRE SIGNALS | S/B | R | R | R | R | R | R | R | R | R | R | R | R | R | R | R | R | R | R | R | R | G | Y | R | G | G | G | G | Y | R |
| ILLINOIS ROUTE 53 (ROHLWING ROAD) TWO FAR LEFT SPAN WIRE SIGNALS WITH LEFT TURN ARROWS | S/B | ←R | ←R |
| PEDESTRIAN SIGNALS - CROSSING ILLINOIS ROUTE 53 (ROHLWING RD) ON NORTH SIDE OF US ROUTE 20 (LAKE STREET) | | H | H | H | H | FH | H | H | FH | H | H | FH | H | H | FH | H | H | FH | H | H | H | H | H | H | H | H | H | H | H | H |
| PEDESTRIAN SIGNALS - CROSSING ILLINOIS ROUTE 53 (ROHLWING RD) ON SOUTH SIDE OF US ROUTE 20 (LAKE STREET) | | FH | FH | H | H | FH | H | H | FH | H | H | FH | H | H | H | H | H | H | H | H | H | H | H | H | H | H | H | H | H | H |
| PEDESTRIAN SIGNALS - CROSSING US ROUTE 20 (LAKE STREET) ON EAST SIDE OF ILLINOIS ROUTE 53 (ROHLWING RD) | | H | H | H | H | H | H | H | H | H | H | H | H | H | H | H | H | FH | H | H | FH | H | H | FH | H | H | FH | H | H | H |
| PEDESTRIAN SIGNALS - CROSSING US ROUTE 20 (LAKE STREET) ON WEST SIDE OF ILLINOIS ROUTE 53 (ROHLWING RD) | | H | H | H | H | H | H | H | H | H | H | H | H | H | H | H | H | H | H | H | H | FH | H | H | FH | H | H | FH | H | H |

| | | | | | | | | | |
|---|-----|-----|----------|-----|-----------------------|-----------------------|-----------------------|-----------------------|-----------------------------------|
| | | | | | PREEMPTOR NUMBER 3 | PREEMPTOR NUMBER 4 | PREEMPTOR NUMBER 5 | PREEMPTOR NUMBER 6 | |
| CHANGE FROM NORMAL SEQUENCE OF OPERATION INTERVAL NUMBER | 23 | 23 | | | | | | | CLEAR TO NORMAL SEQUENCE |
| EMERGENCY VEHICLE PRE-EMPTION SEQUENCE OF OPERATION INTERVAL NUMBER | 1GG | 1HH | 1JJ | 1KK | 2 | 3 | 4 | 5 | |
| CHANGE TO EMERGENCY VEHICLE PRE-EMPTION SEQUENCE OF OPERATION INTERVAL NUMBER | 1HH | 1JJ | 2,4 5 | 3 | | | | | |
| US ROUTE 20 (LAKE STREET) NEAR RIGHT AND TWO FAR RIGHT SPAN WIRE SIGNAL | E/B | R | R | R | R | G | R | R | R |
| US ROUTE 20 (LAKE STREET) TWO FAR LEFT SPAN WIRE SIGNALS WITH LEFT TURN ARROWS | E/B | ←R | ←R | ←R | ←R | ←G | ←R | ←R | ←R |
| US ROUTE 20 (LAKE STREET) NEAR RIGHT AND TWO FAR RIGHT SPAN WIRE SIGNAL | W/B | R | R | R | R | R | G | R | ◇ |
| US ROUTE 20 (LAKE STREET) TWO FAR LEFT SPAN WIRE SIGNALS WITH LEFT TURN ARROWS | W/B | ←R | ←R | ←R | ←R | ←R | ←G | ←R | ◇ |
| ILLINOIS ROUTE 53 (ROHLWING ROAD) NEAR RIGHT AND TWO FAR RIGHT SPAN WIRE SIGNALS | N/B | R | R | R | R | R | R | G | ◇ |
| ILLINOIS ROUTE 53 (ROHLWING ROAD) TWO FAR LEFT SPAN WIRE SIGNALS WITH LEFT TURN ARROWS | N/B | ←R | ←R | ←R | ←R | ←R | ←R | ←G | ◇ |
| ILLINOIS ROUTE 53 (ROHLWING ROAD) NEAR RIGHT AND TWO FAR RIGHT SPAN WIRE SIGNALS | S/B | G | Y | R | G | R | G | R | ◇ |
| ILLINOIS ROUTE 53 (ROHLWING ROAD) TWO FAR LEFT SPAN WIRE SIGNALS WITH LEFT TURN ARROWS | S/B | ←G | ←Y | ←R | ←G | ←R | ←G | ←R | ◇ |
| PEDESTRIAN SIGNALS - CROSSING ILLINOIS ROUTE 53 (ROHLWING RD) ON NORTH SIDE OF US ROUTE 20 (LAKE STREET) | | H | H | H | H | H | H | H | ◇ |
| PEDESTRIAN SIGNALS - CROSSING ILLINOIS ROUTE 53 (ROHLWING RD) ON SOUTH SIDE OF US ROUTE 20 (LAKE STREET) | | H | H | H | H | H | H | H | ◇ |
| PEDESTRIAN SIGNALS - CROSSING US ROUTE 20 (LAKE STREET) ON EAST SIDE OF ILLINOIS ROUTE 53 (ROHLWING RD) | | H | H | H | H | H | H | H | ◇ |
| PEDESTRIAN SIGNALS - CROSSING US ROUTE 20 (LAKE STREET) ON WEST SIDE OF ILLINOIS ROUTE 53 (ROHLWING RD) | | FH | H | H | FH | H | H | H | ◇ |

◇ EMERGENCY VEHICLE SEQUENCE SHALL PROVIDE THE PROPER CLEARANCE INTERVAL TO RESUME THE NORMAL SEQUENCE OF OPERATION OR PROPER CLEARANCE INTERVAL TO DISPLAY A DIFFERENT EMERGENCY VEHICLE INTERVAL AFTER EMERGENCY VEHICLE INTERVAL 2, 3, 4, OR 5 IS TERMINATED.

THE TRAFFIC SIGNAL CONTROL EQUIPMENT FOR THIS PROJECT SHALL BE "ECONOLITE" TO MATCH THE EXISTING ADJACENT SYSTEM.




ILL. RTE. 53

U.S. 20 (LAKE ST.)

(ROHLWING RD.)

MATCH LINE 116+00

MATCH LINE 122+00

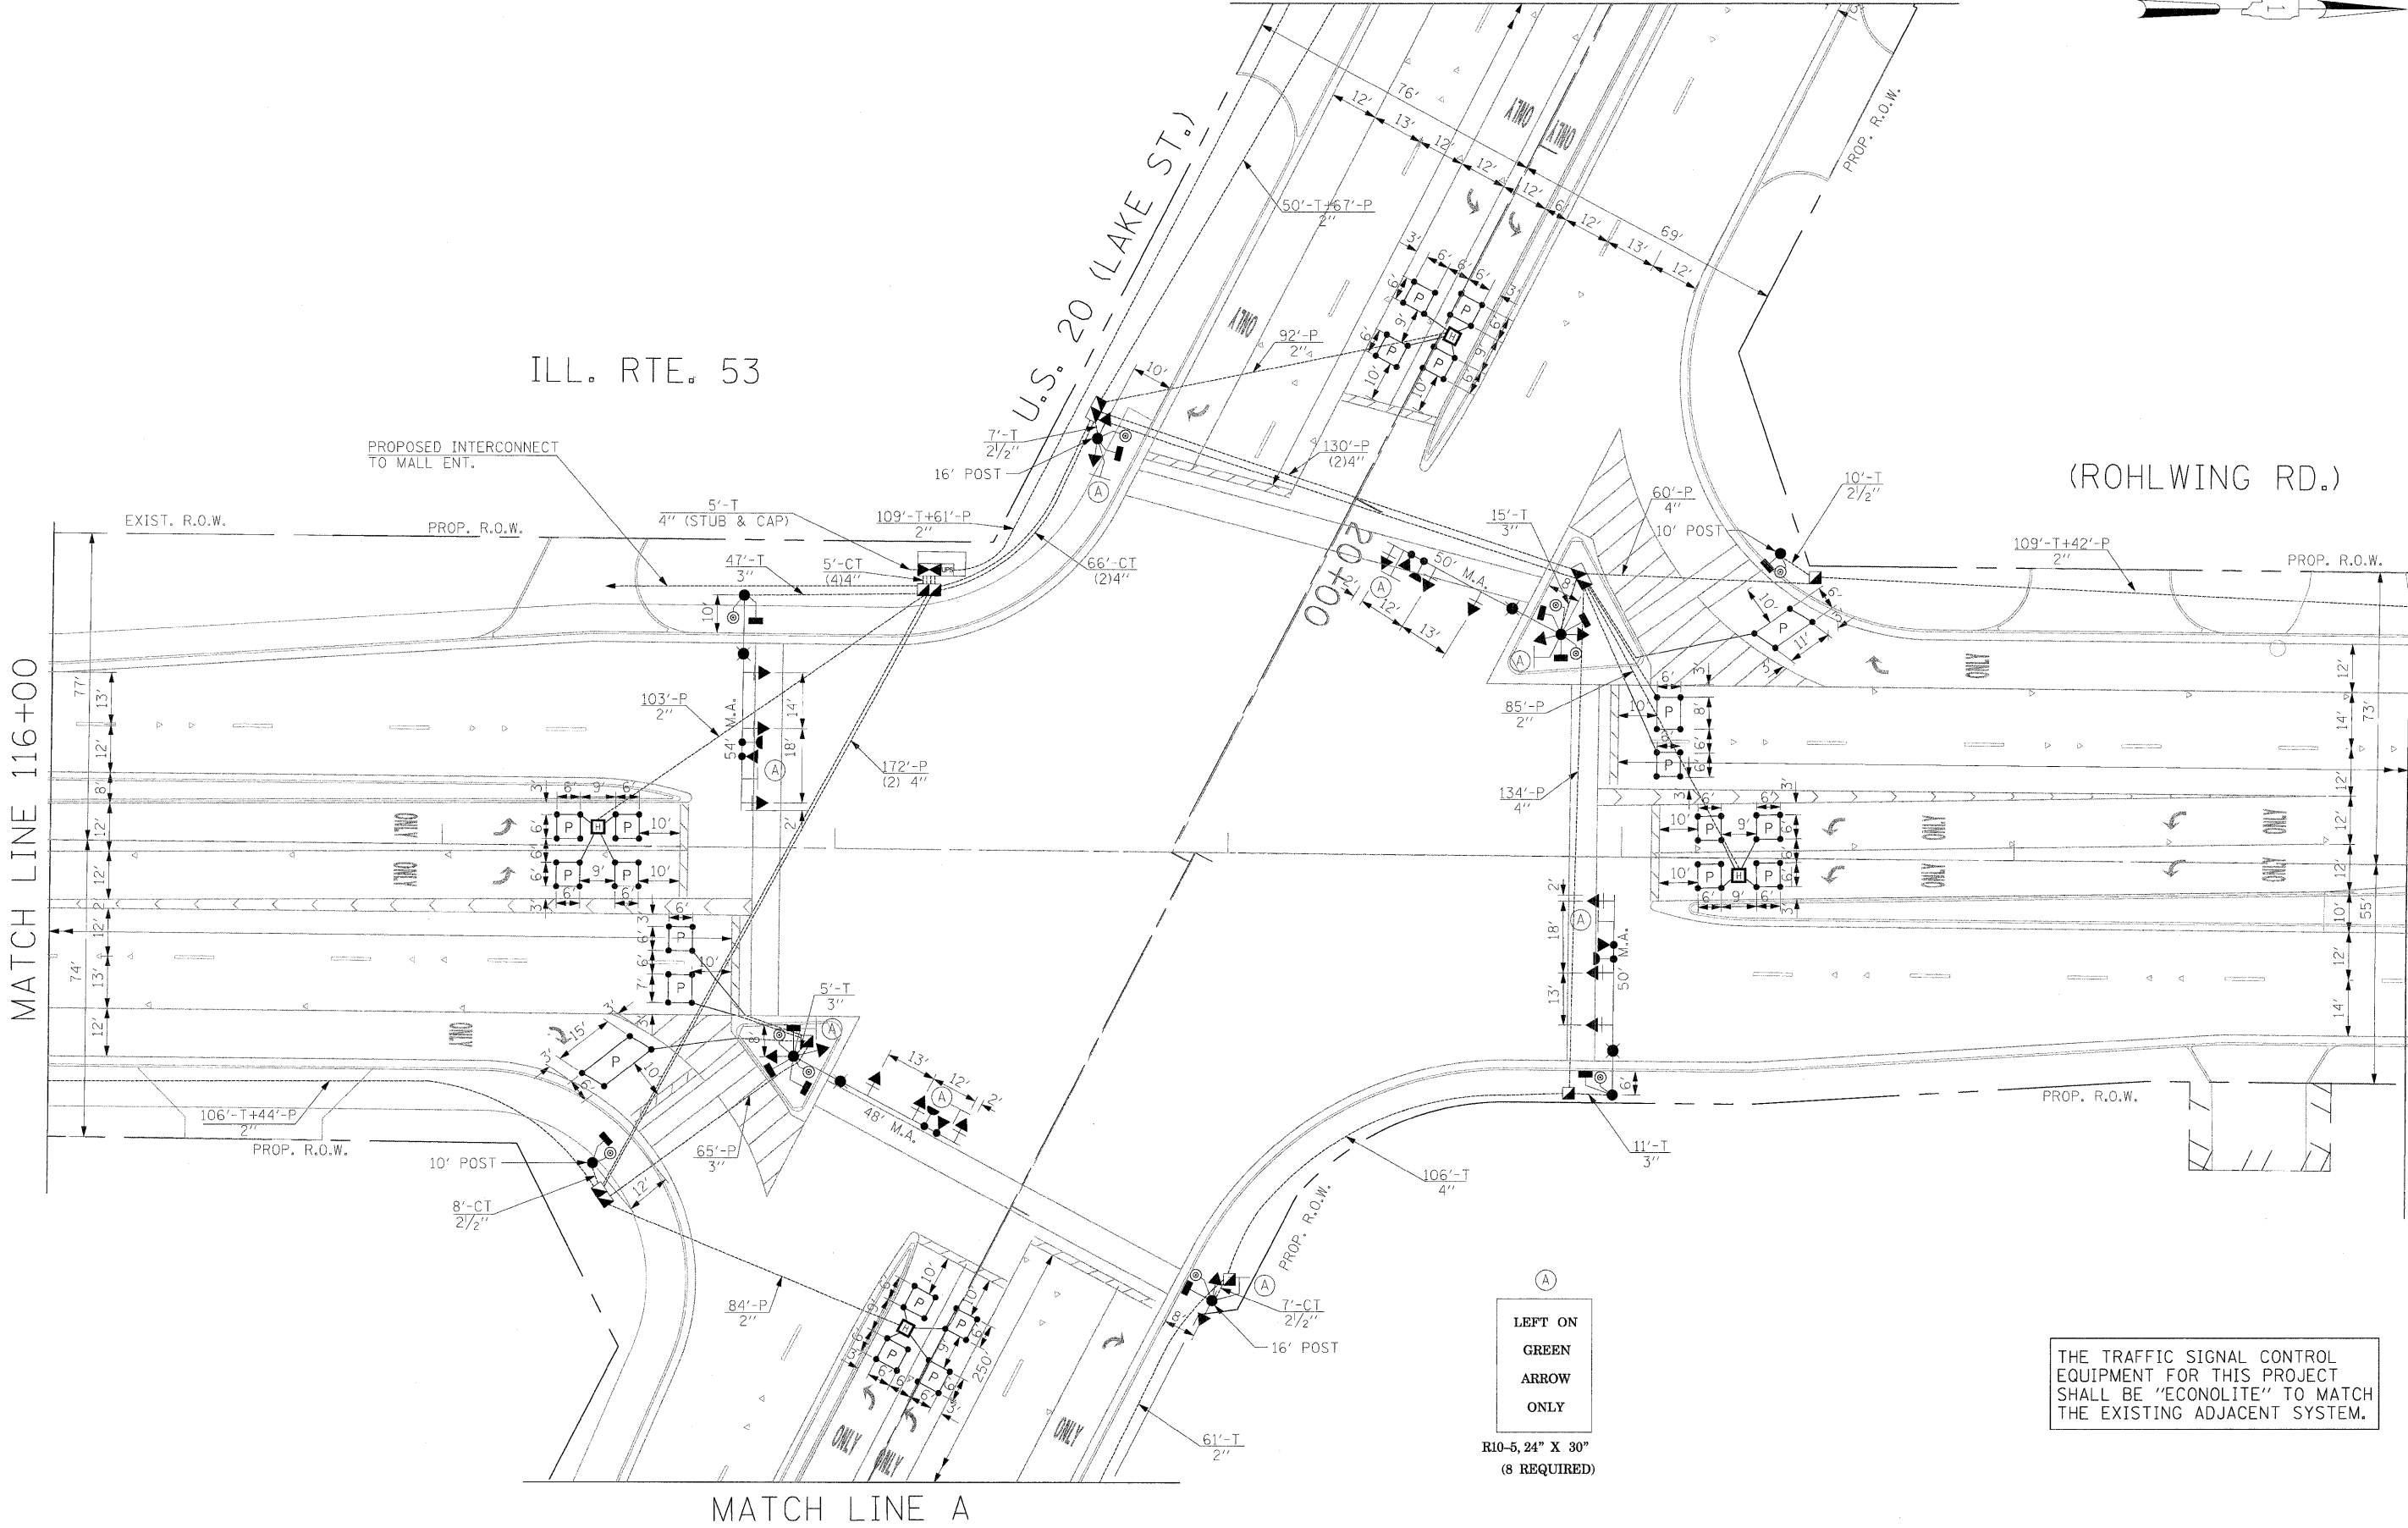


(A)
LEFT ON GREEN
ARROW ONLY

R10-5, 24" X 30"
(8 REQUIRED)




THE TRAFFIC SIGNAL CONTROL EQUIPMENT FOR THIS PROJECT SHALL BE "ECONOLITE" TO MATCH THE EXISTING ADJACENT SYSTEM.

MATCH LINE A


| | | | | | | | | | | | | |
|------------------------|----------------------|-----------------|------------------|---|--|-----------------|----------------------------------|---|--------------------|--------|--------------|-----------|
| FILE NAME # #FILELS | USER NAME = #USER# | DESIGNED - PKG | REVISED - | STATE OF ILLINOIS DEPARTMENT OF TRANSPORTATION | TRAFFIC SIGNAL INSTALLATION PLAN | | | F.A.P. RTE. | SECTION | COUNTY | TOTAL SHEETS | SHEET NO. |
| | PLOT SCALE = #SCALE# | DRAWN - MAA, EA | REVISED - | | ILLINOIS ROUTE 53 (ROHLWING RD.) AT U.S. 20 (LAKE ST.) | | | 2578 | 532B | DuPage | 781 | 462 |
| PLOT DATE = #DATE# | CHECKED - PKG, EA | REVISED - | DATE - 5/10/2010 | | REVISED - | (SHEET 1 OF 2). | | | CONTRACT NO. 60477 | | | |
| | | | | | | SCALE: 1"=20' | SHEET NO. OF SHEETS STA. TO STA. | FED. ROAD DIST. NO. - ILLINOIS FED. AID PROJECT | | | | |
| | | | | | | | | | | | | |

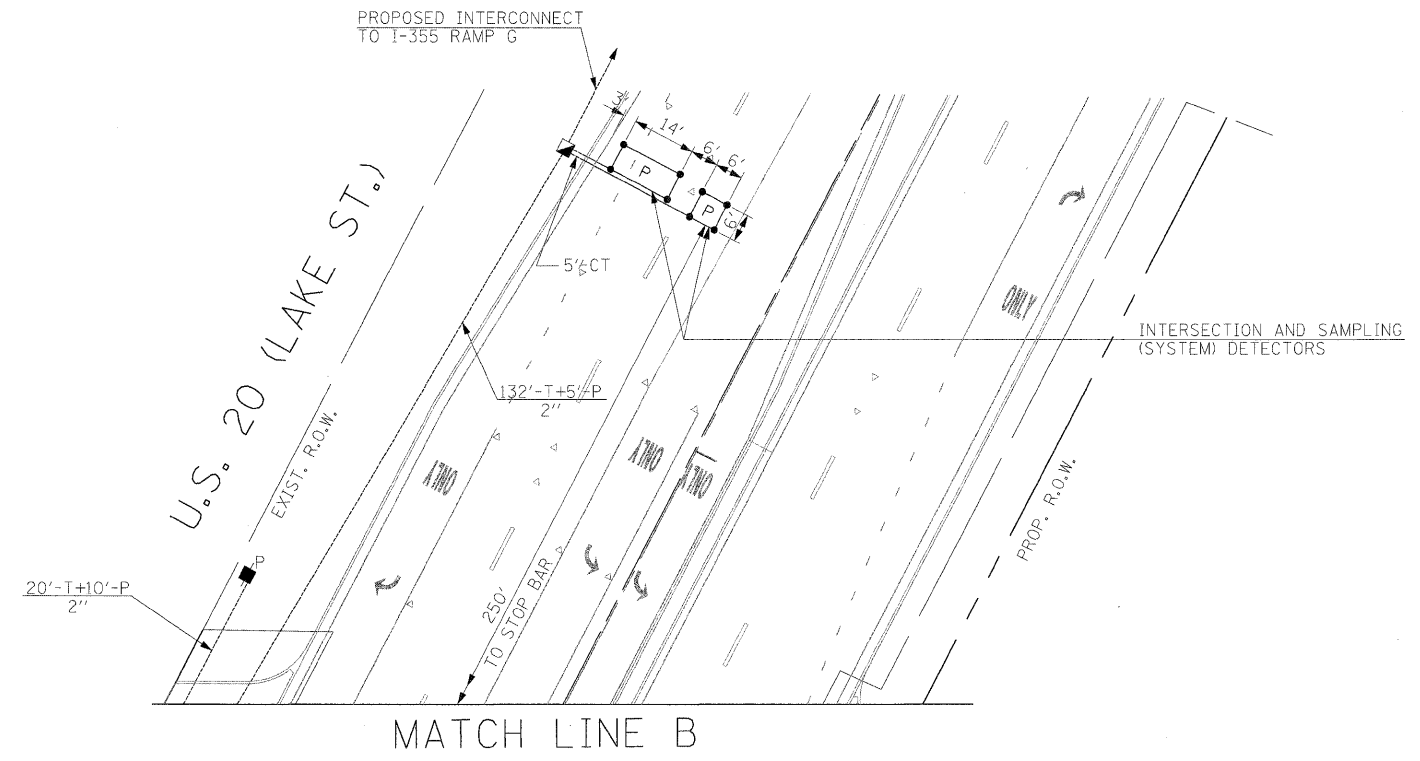

THE TRAFFIC SIGNAL CONTROL EQUIPMENT FOR THIS PROJECT SHALL BE "ECONOLITE" TO MATCH THE EXISTING ADJACENT SYSTEM.

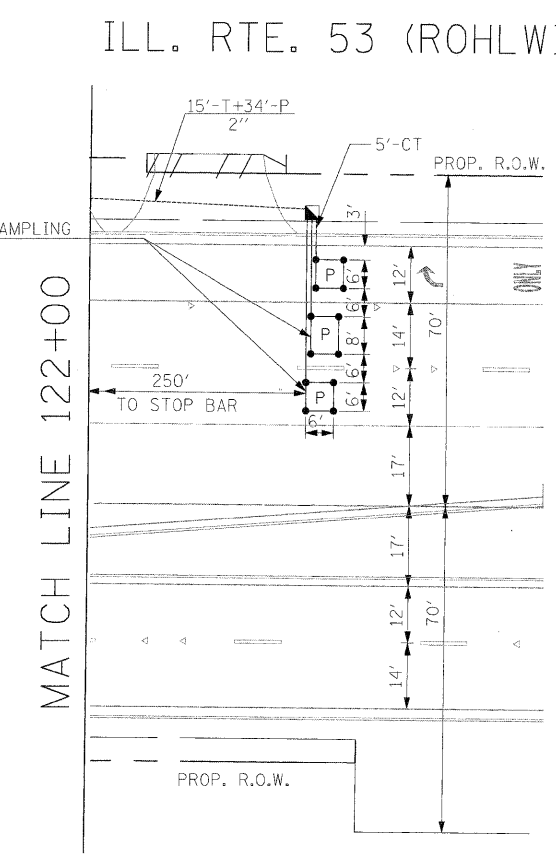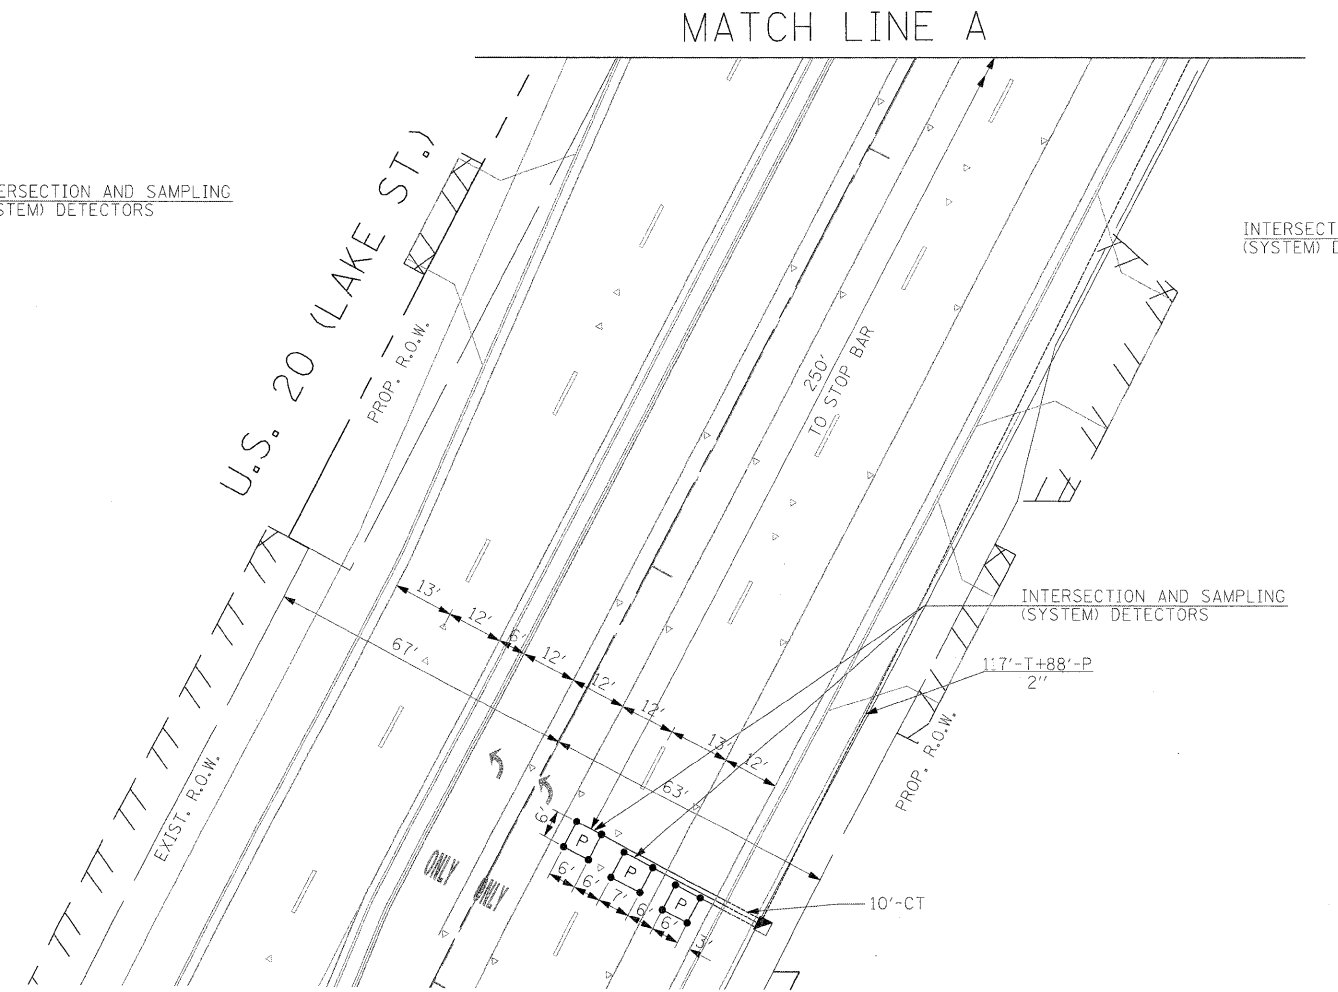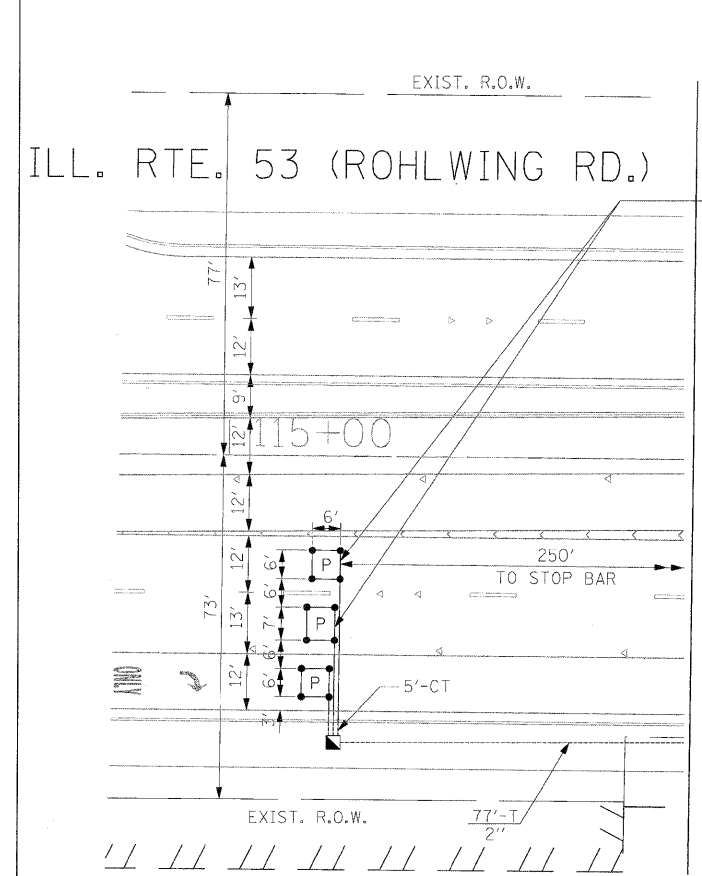


| | | | | | | | | | | | | |
|---------------------|----------------------|-------------------|-----------|---|--|---------------------|--------------|---|--------------|---------------|------------------|---------------|
| FILE NAME = #FILEL# | USER NAME = #USER# | DESIGNED - PKG | REVISED - | STATE OF ILLINOIS DEPARTMENT OF TRANSPORTATION | TRAFFIC SIGNAL INSTALLATION PLAN ILLINOIS ROUTE 53 (ROHLWING RD.) AT U.S. 20 (LAKE ST.) (SHEET 2 OF 2). | | | F.A.P. RTE. 2578 | SECTION 532B | COUNTY DuPage | TOTAL SHEETS 781 | SHEET NO. 463 |
| | PLOT SCALE = #SCALE# | DRAWN - MAA, EA | REVISED - | | SCALE: 1"=20' | SHEET NO. OF SHEETS | STA. TO STA. | FED. ROAD DIST. NO. - ILLINOIS FED. AID PROJECT | | | | |
| | PLOT DATE = #DATE# | CHECKED - PKG, EA | REVISED - | | | | | CONTRACT NO. 60477 | | | | |
| | | DATE - 5/10/2010 | REVISED - | | | | | | | | | |

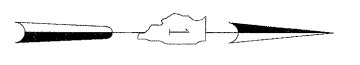

THE END OF THE TRACER CABLE SHALL BE CONTINUOUS AND EXTEND INTO THE CONTROLLER CABINET.

THE END OF THE TRACER CABLE SHALL BE CONTINUOUS AND EXTEND INTO THE CONTROLLER CABINET.

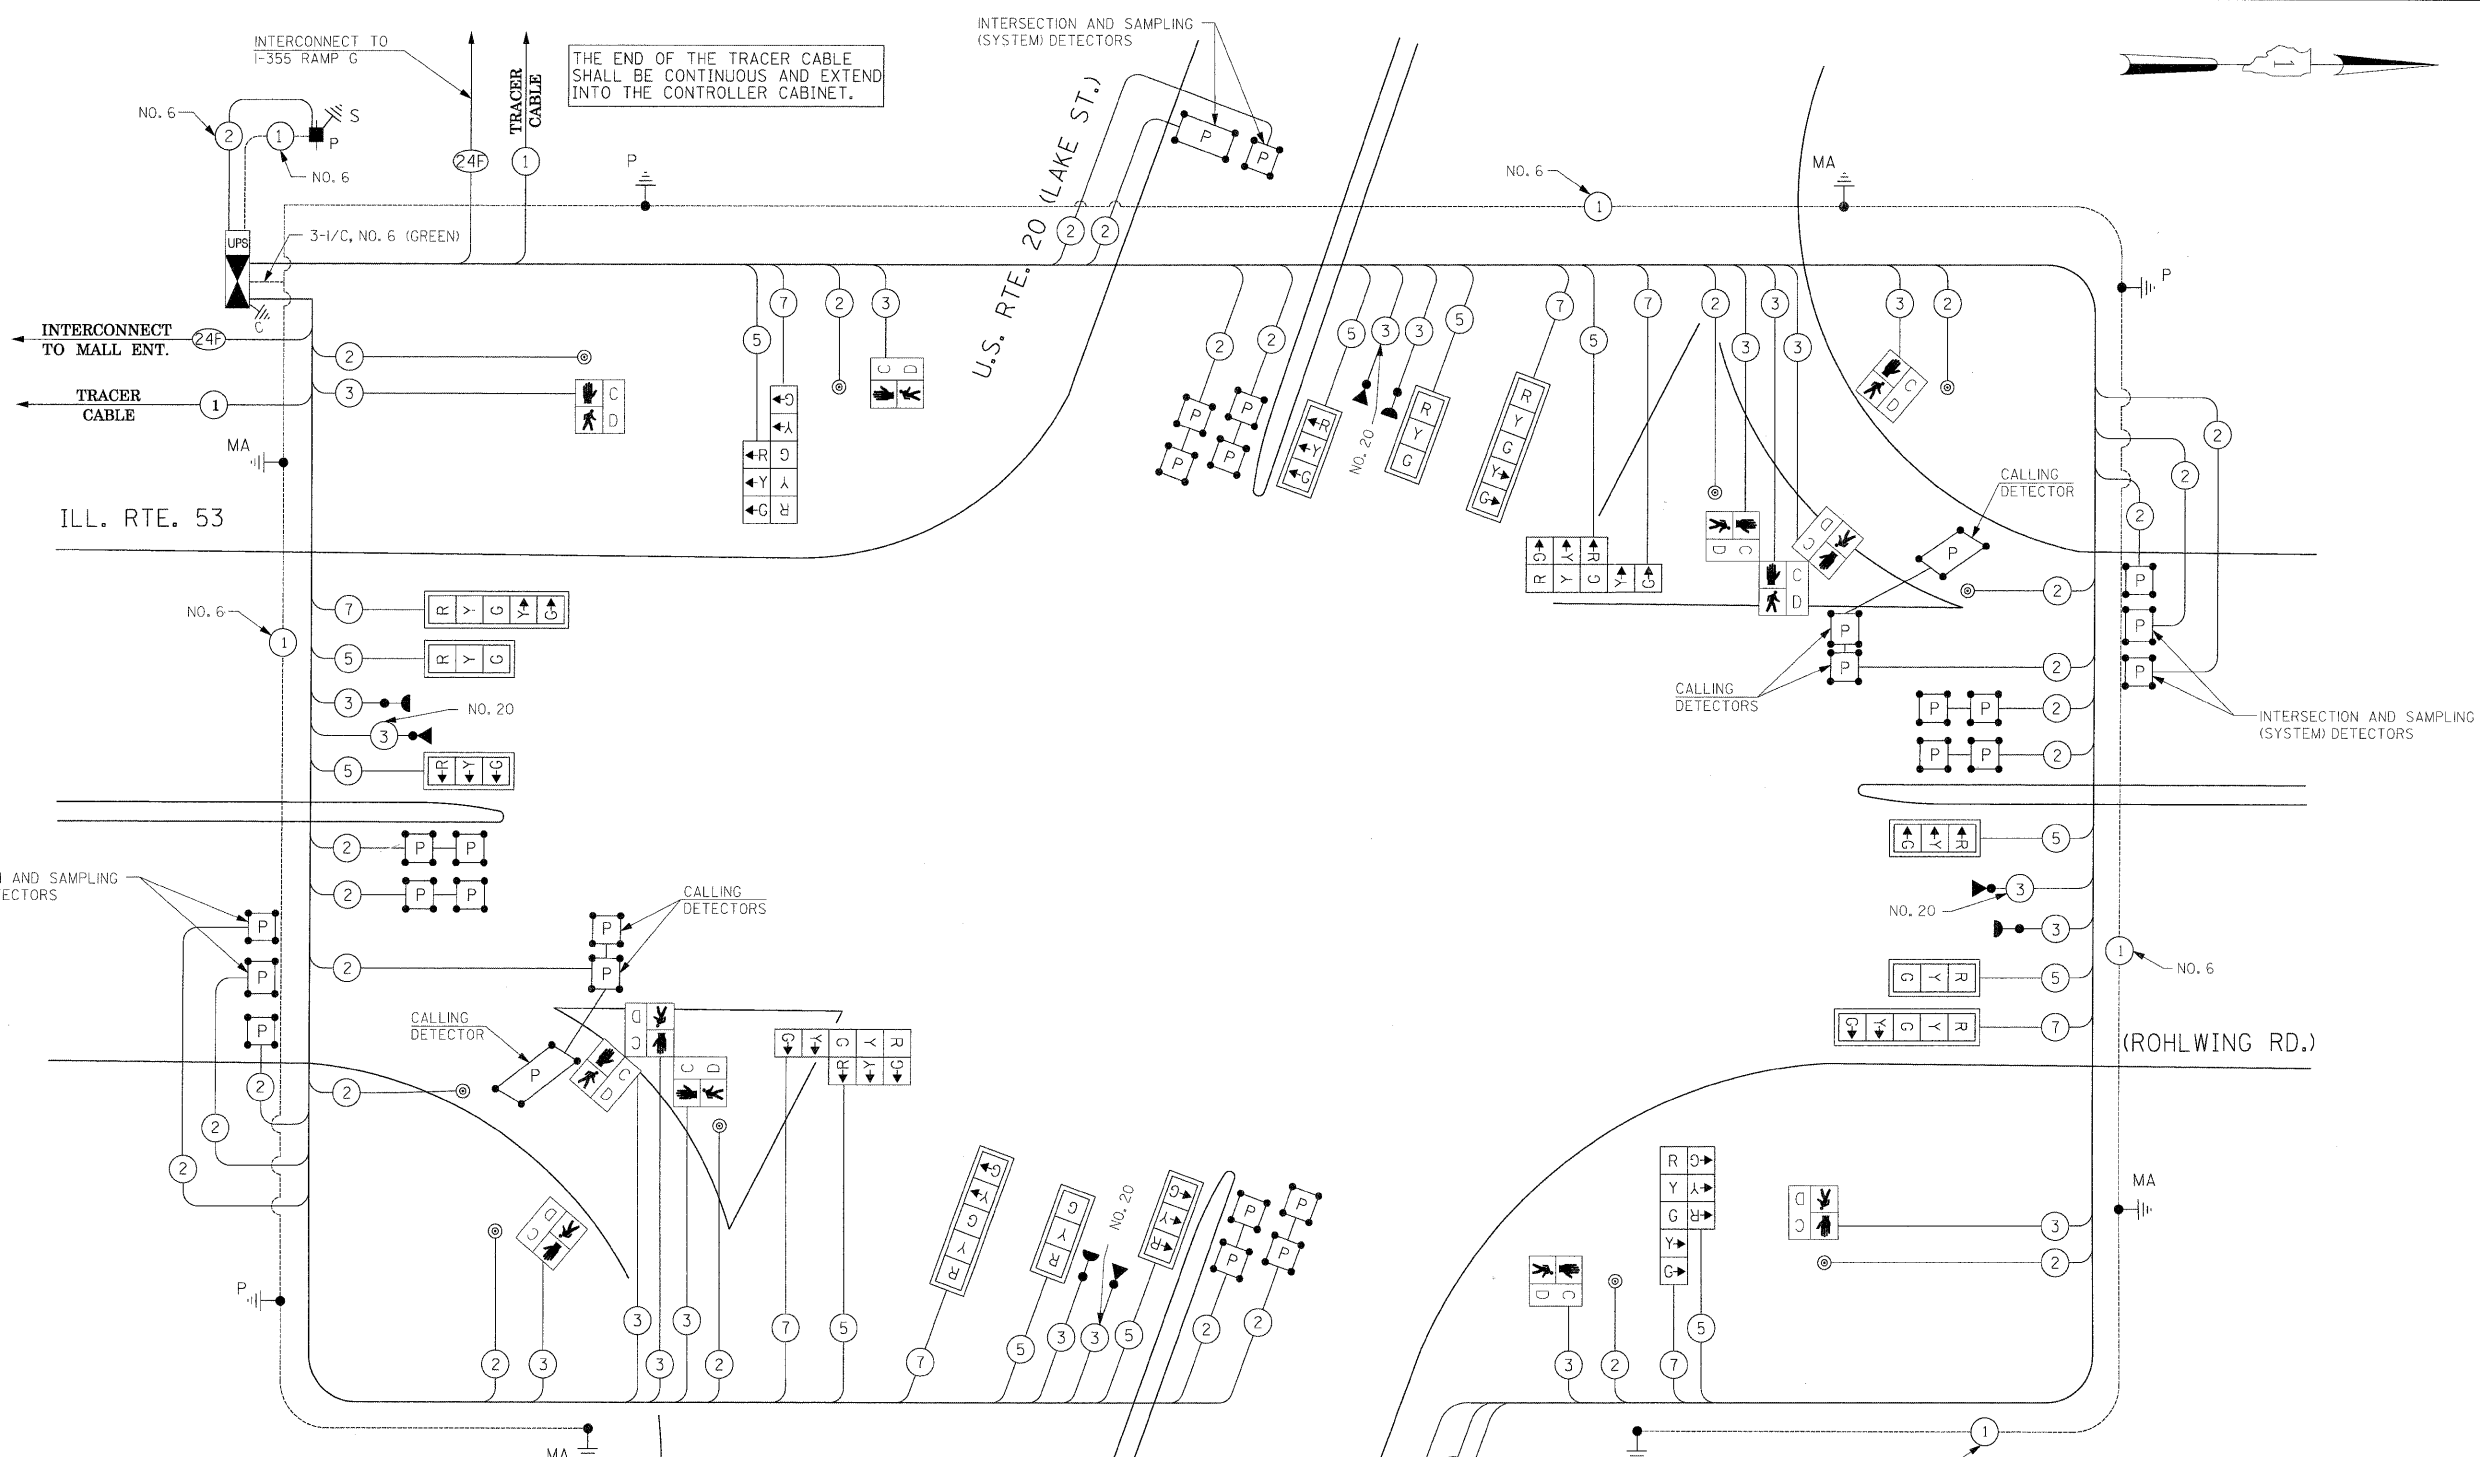

CABLE PLAN
(NOT TO SCALE)

THE TRAFFIC SIGNAL CONTROL EQUIPMENT FOR THIS PROJECT SHALL BE "ECONOLITE" TO MATCH THE EXISTING ADJACENT SYSTEM.

| I.D.O.T. TRAFFIC SIGNAL INSTALLATION ELECTRICAL SERVICE REQUIREMENTS | | | | | TOTAL WATTAGE |
|--|----------|---------|-----|------------|------------------|
| TYPE | NO LAMPS | WATTAGE | | %OPERATION | |
| SIGNAL (RED) | 20 | 135 | 17 | 0.50 | 170 |
| (YELLOW) | 20 | 135 | 25 | 0.25 | 125 |
| (GREEN) | 20 | 135 | 15 | 0.25 | 75 |
| ARROW | 16 | 135 | 12 | 0.10 | 19.2 |
| PED. SIGNAL | 12 | 90 | 25 | 1.00 | 300 |
| CONTROLLER | 1 | 100 | 100 | 1.00 | 100 |
| ILLUM. SIGN | | | 25 | 0.05 | |
| FLASHER | | | | 0.50 | |
| ENERGY COSTS TO: | | | | TOTAL = | 789.2 |

ILLINOIS DEPARTMENT OF TRANSPORTATION
201 WEST CENTER COURT
SCHAMBURG, ILLINOIS 60196-1096

ENERGY SUPPLY CONTACT: CURTIS TOPPS
PHONE: (630) 691-4356
COMPANY: COMMONWEALTH EDISON



SCHEDULE OF QUANTITIES

| QUANTITY | UNIT | ITEM |
|----------|-------|---|
| 58 | SQ FT | SIGN PANEL - TYPE 1 |
| 30 | SQ FT | SIGN PANEL - TYPE 2 |
| 796 | FOOT | CONDUIT IN TRENCH, 2" DIA., GALVANIZED STEEL |
| 32 | FOOT | CONDUIT IN TRENCH, 2 1/2" DIA., GALVANIZED STEEL |
| 78 | FOOT | CONDUIT IN TRENCH, 3" DIA., GALVANIZED STEEL |
| 263 | FOOT | CONDUIT IN TRENCH, 4" DIA., GALVANIZED STEEL |
| 715 | FOOT | CONDUIT PUSHED, 2" DIA., GALVANIZED STEEL |
| 65 | FOOT | CONDUIT PUSHED, 3" DIA., GALVANIZED STEEL |
| 798 | FOOT | CONDUIT PUSHED, 4" DIA., GALVANIZED STEEL |
| 8 | EACH | HANDHOLE |
| 4 | EACH | HEAVY-DUTY HANDHOLE |
| 4 | EACH | DOUBLE HANDHOLE |
| 1073 | FOOT | TRENCH AND BACKFILL FOR ELECTRICAL WORK |
| 1 | EACH | FULL-ACTUATED CONTROLLER AND TYPE IV CABINET, SPECIAL |
| 1 | EACH | TRANSCEIVER-FIBER OPTIC |
| 2816 | FOOT | ELECTRIC CABLE IN CONDUIT, SIGNAL NO. 14 2C |
| 4746 | FOOT | ELECTRIC CABLE IN CONDUIT, SIGNAL NO. 14 3C |
| 3788 | FOOT | ELECTRIC CABLE IN CONDUIT, SIGNAL NO. 14 5C |
| 2431 | FOOT | ELECTRIC CABLE IN CONDUIT, SIGNAL NO. 14 7C |
| 8347 | FOOT | ELECTRIC CABLE IN CONDUIT, LEAD-IN, NO. 14 1 PAIR |
| 220 | FOOT | ELECTRIC CABLE IN CONDUIT, SERVICE, NO. 6 2C |
| 2 | EACH | TRAFFIC SIGNAL POST, GALVANIZED STEEL 10 FT. |
| 2 | EACH | TRAFFIC SIGNAL POST, GALVANIZED STEEL 16 FT. |
| 1 | EACH | STEEL COMBINATION MAST ARM ASSEMBLY AND POLE, 48 FT. |
| 2 | EACH | STEEL COMBINATION MAST ARM ASSEMBLY AND POLE, 50 FT. |
| 1 | EACH | STEEL COMBINATION MAST ARM ASSEMBLY AND POLE, 54 FT. |
| 16 | FOOT | CONCRETE FOUNDATION, TYPE A |
| 4 | FOOT | CONCRETE FOUNDATION, TYPE C |
| 60 | FOOT | CONCRETE FOUNDATION, TYPE E 36-INCH DIAMETER |
| 8 | EACH | SIGNAL HEAD, LED, 1-FACE, 3-SECTION, MAST ARM MOUNTED |
| 4 | EACH | SIGNAL HEAD, LED, 1-FACE, 5-SECTION, MAST ARM MOUNTED |
| 4 | EACH | SIGNAL HEAD, LED, 2-FACE, 1-3 SECTION, 1-5 SECTION, BRACKET MOUNTED |
| 6 | EACH | PEDESTRIAN SIGNAL HEAD, LED, 1-FACE, BRACKET MOUNTED WITH COUNTDOWN TIMER |
| 2 | EACH | PEDESTRIAN SIGNAL HEAD, LED, 3-FACE, BRACKET MOUNTED WITH COUNTDOWN TIMER |
| 12 | EACH | TRAFFIC SIGNAL BACKPLATE, LOUVERED, ALUMINUM |
| 21 | EACH | INDUCTIVE LOOP DETECTOR |
| 4 | EACH | LIGHT DETECTOR |
| 1 | EACH | LIGHT DETECTOR AMPLIFIER |
| 10 | EACH | PEDESTRIAN PUSH-BUTTON |
| 1 | EACH | TEMPORARY TRAFFIC SIGNAL INSTALLATION |
| 1 | EACH | REMOVE EXISTING TRAFFIC SIGNAL EQUIPMENT |
| 12 | EACH | REMOVE EXISTING HANDHOLE |
| 9 | EACH | REMOVE EXISTING CONCRETE FOUNDATION |
| 1233 | FOOT | PREFORMED DETECTOR LOOP |
| 1 | EACH | TEMPORARY TRAFFIC SIGNAL TIMING |
| 1 | EACH | SERVICE INSTALLATION - POLE MOUNTED |
| 1 | EACH | UNINTERRUPTIBLE POWER SUPPLY |
| 1295 | FOOT | ELECTRIC CABLE IN CONDUIT, GROUNDING, NO. 6 1C |
| 1280 | FOOT | ELECTRIC CABLE IN CONDUIT NO. 20 3/C, TWISTED, SHIELDED |

* 100% COST TO VILLAGE OF ADDISON

THE TRAFFIC SIGNAL CONTROL EQUIPMENT FOR THIS PROJECT SHALL BE "ECONOLITE" TO MATCH THE EXISTING ADJACENT SYSTEM.


CONTROLLER SEQUENCE

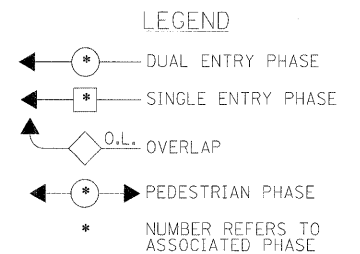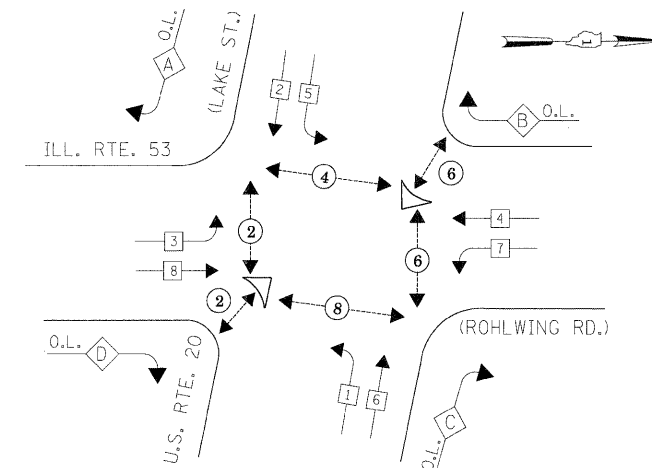

PHASE DESIGNATION DIAGRAM

| OVERLAP LETTER | PERMISSIVE PHASE | PROTECTED PHASE |
|----------------|------------------|-----------------|
| A | = 2 + 3 | |
| B | = 4 + 5 | |
| C | = 6 + 7 | |
| D | = 8 + 1 | |

EMERGENCY VEHICLE PREEMPTION SEQUENCE

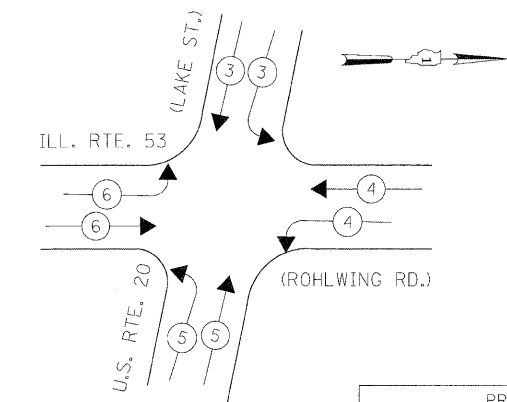

| PROPOSED EMERGENCY VEHICLE PREEMPTORS | | | | |
|---------------------------------------|---|---|---|---|
| EMERGENCY VEHICLE PREEMPTOR | 3 | 4 | 5 | 6 |
| MOVEMENT | ↕ | ↔ | ↕ | ↔ |

NOTES FOR TEMPORARY TRAFFIC SIGNALS

- ALL CONTROL EQUIPMENT INCLUDING EMERGENCY PRE-EMPTION AND COMMUNICATION DEVICES FOR THE TEMPORARY TRAFFIC SIGNAL(S) SHALL BE FURNISHED BY THE CONTRACTOR.
- ONLY CONTROLLERS SUPPLIED BY ONE OF THE DISTRICT APPROVED CLOSED LOOP EQUIPMENT MANUFACTURERS WILL BE APPROVED FOR USE AT TEMPORARY SIGNAL LOCATIONS. ALL CONTROLLERS USED FOR TEMPORARY TRAFFIC SIGNALS SHALL BE FULLY ACTUATED NEMA MICROPROCESSOR BASED WITH RS232 DATA ENTRY PORTS COMPATIBLE WITH EXISTING MONITORING SOFTWARE APPROVED BY IDOT DISTRICT 1, INSTALLED IN A NEMA TS2 CABINET. ONLY ONE BRAND OF CONTROLLER WILL BE ACCEPTED FOR ANY ONE CONTRACT.
- ALL TRAFFIC SIGNAL SECTIONS AND PEDESTRIAN SIGNAL SECTIONS SHALL BE LED AND 12" (300mm) DIAMETER. HEADS SHALL BE PLACED AS INDICATED ON THE TEMPORARY TRAFFIC SIGNAL PLAN OR AS DIRECTED BY THE ENGINEER. PEDESTRIAN SIGNALS SHALL INCLUDE SOLID INTERNATIONAL SYMBOLS. PEDESTRIAN SIGNALS WITH COUNTDOWN TIMERS SHALL BE USED WHEN THE EXISTING INSTALLATION UTILIZES COUNTDOWN TYPE OR AS DIRECTED BY THE ENGINEER. COUNTDOWN TYPE PEDESTRIAN SIGNALS ARE NOT TO BE INSTALLED AT A RAILROAD INTERSECTION. THE CONTRACTOR SHALL FURNISH ENOUGH CABLE SLACK TO RELOCATE HEADS TO ANY POSITION ON THE SPAN WIRE OR AT LOCATIONS ILLUSTRATED ON THE PLANS FOR CONSTRUCTION STAGING. THE TEMPORARY TRAFFIC SIGNAL SHALL REMAIN IN OPERATION DURING ALL SIGNAL HEAD RELOCATIONS. EACH TEMPORARY TRAFFIC SIGNAL HEAD SHALL HAVE ITS OWN CABLE FROM THE CONTROLLER CABINET TO THE SIGNAL HEAD.
- ALL EXISTING STREET NAME AND INTERSECTION REGULATORY SIGNS SHALL BE REMOVED FROM EXISTING POLES, RELOCATED AND SECURELY FASTENED TO THE SPAN WIRE OR WOOD POLE AS DIRECTED BY THE ENGINEER.
- ANY TEMPORARY SIGNAL WITHIN AN EXISTING CLOSED LOOP TRAFFIC SIGNAL SYSTEM SHALL BE INTERCONNECTED TO THAT SYSTEM USING SIMILAR BRAND CONTROL EQUIPMENT.
- THE TEMPORARY TRAFFIC SIGNAL SHALL HAVE THE SIGNAL HEAD DISPLAYS, SIGNAL HEAD PLACEMENTS AND CONTROLLER PHASING MATCH THE EXISTING TRAFFIC SIGNAL, AT THE TIME OF THE TURN ON, IF NO TRAFFIC STAGING IS IN PLACE OR WILL NOT BE STAGED ON THE DAY OF THE TURN ON.
- UNINTERRUPTIBLE POWER SUPPLY (UPS) SYSTEMS SHALL BE INSTALLED AND MADE OPERATIONAL AT TEMPORARY TRAFFIC SIGNAL INSTALLATIONS WHERE UPS IS INSTALLED AT THE EXISTING TRAFFIC SIGNAL, TEMPORARY TRAFFIC SIGNALS AT RAILROAD INTERSECTIONS, AND TEMPORARY TRAFFIC SIGNALS AT INTERSECTIONS WITH FIRE STATION ACTUATED EMERGENCY VEHICLE PRE-EMPTION, OR WHEN INDICATED ON THE PLANS.
- TRAFFIC SIGNAL MANAGEMENT SYSTEMS SHALL BE MAINTAINED IN OPERATION AS INDICATED ON THE PLANS OR AS DIRECTED BY THE ENGINEER. REQUIRED EQUIPMENT SHALL BE AS SHOWN ON THE PLANS AND THE CONTRACTOR SHALL PLACE THE EQUIPMENT IN OPERATION TO THE SATISFACTION OF THE ENGINEER AND THE AGENCY RESPONSIBLE FOR THE TRAFFIC SIGNAL MANAGEMENT SYSTEM.
- DETECTION AT TEMPORARY TRAFFIC SIGNALS SHALL BE INCLUDED FOR ALL APPROACHES OF THE INTERSECTION UNLESS INDICATED OTHERWISE ON THE PLANS. THE DETECTION SYSTEM MUST MEET THE SPECIFICATIONS OF DISTRICT 1 AND THE CONTRACTOR SHALL PLACE THE DETECTORS INTO OPERATION TO THE SATISFACTION OF THE ENGINEER.
- WHEN PAN, TILT, ZOOM CAMERAS ARE INSTALLED AT THE EXISTING INTERSECTION OR ARE CALLED FOR IN THE PLANS, THE CONTRACTOR SHALL BE RESPONSIBLE FOR INSTALLING AND MAINTAINING THE CAMERAS TO THE SATISFACTION OF THE ENGINEER AND THE AGENCY RESPONSIBLE FOR THE CAMERAS.


THE FOLLOWING ITEMS SHALL BE REMOVED BY THE CONTRACTOR AND SHALL BE DISPOSED OF BY THEM OUTSIDE THE RIGH-OF-WAY AT THEIR EXPENSE. THE SALVAGE VALUE OF THE REMOVED EQUIPMENT SHALL BE REFLECTED IN THE CONTRACTOR'S BID PRICE.

- 1 EACH CONTROLLER AND CABINET COMPLETE
- 4 EACH SIGNAL HEAD, 1-FACE 5-SECTION, BRACKET MOUNTED
- 4 EACH SIGNAL HEAD, 1-FACE 5-SECTION, MAST ARM MOUNTED
- 4 EACH TRAFFIC SIGNAL BACKPLATE
- 4 EACH TRAFFIC SIGNAL POST
- 4 EACH STEEL MAST ARM ASSEMBLY AND POLE
- 1 EACH SERVICE INSTALLATION

THE CONTRACTOR SHALL RELOCATE THE EXISTING EMERGENCY VEHICLE PRIORITY SYSTEM EQUIPMENTS TO THE NEW TRAFFIC SIGNAL INSTALLATION AT ILL. RTE. 53 (ROHLWING RD.) & NORDIC RD. / BLOOMINGDALE RD.



NOTE: THE VIDEO DETECTION ZONES SHOWN ON THE PLANS ARE FOR CONSTRUCTION STAGE 1 - SUBSTAGE 1 AND SHALL BE REDEFINED FOR EACH CONSTRUCTION STAGE AS A PART OF "TEMPORARY TRAFFIC SIGNAL INSTALLATION" WORK.

THE TRAFFIC SIGNAL CONTROL EQUIPMENT FOR THIS PROJECT SHALL BE "ECONOLITE" TO MATCH THE EXISTING ADJACENT SYSTEM.

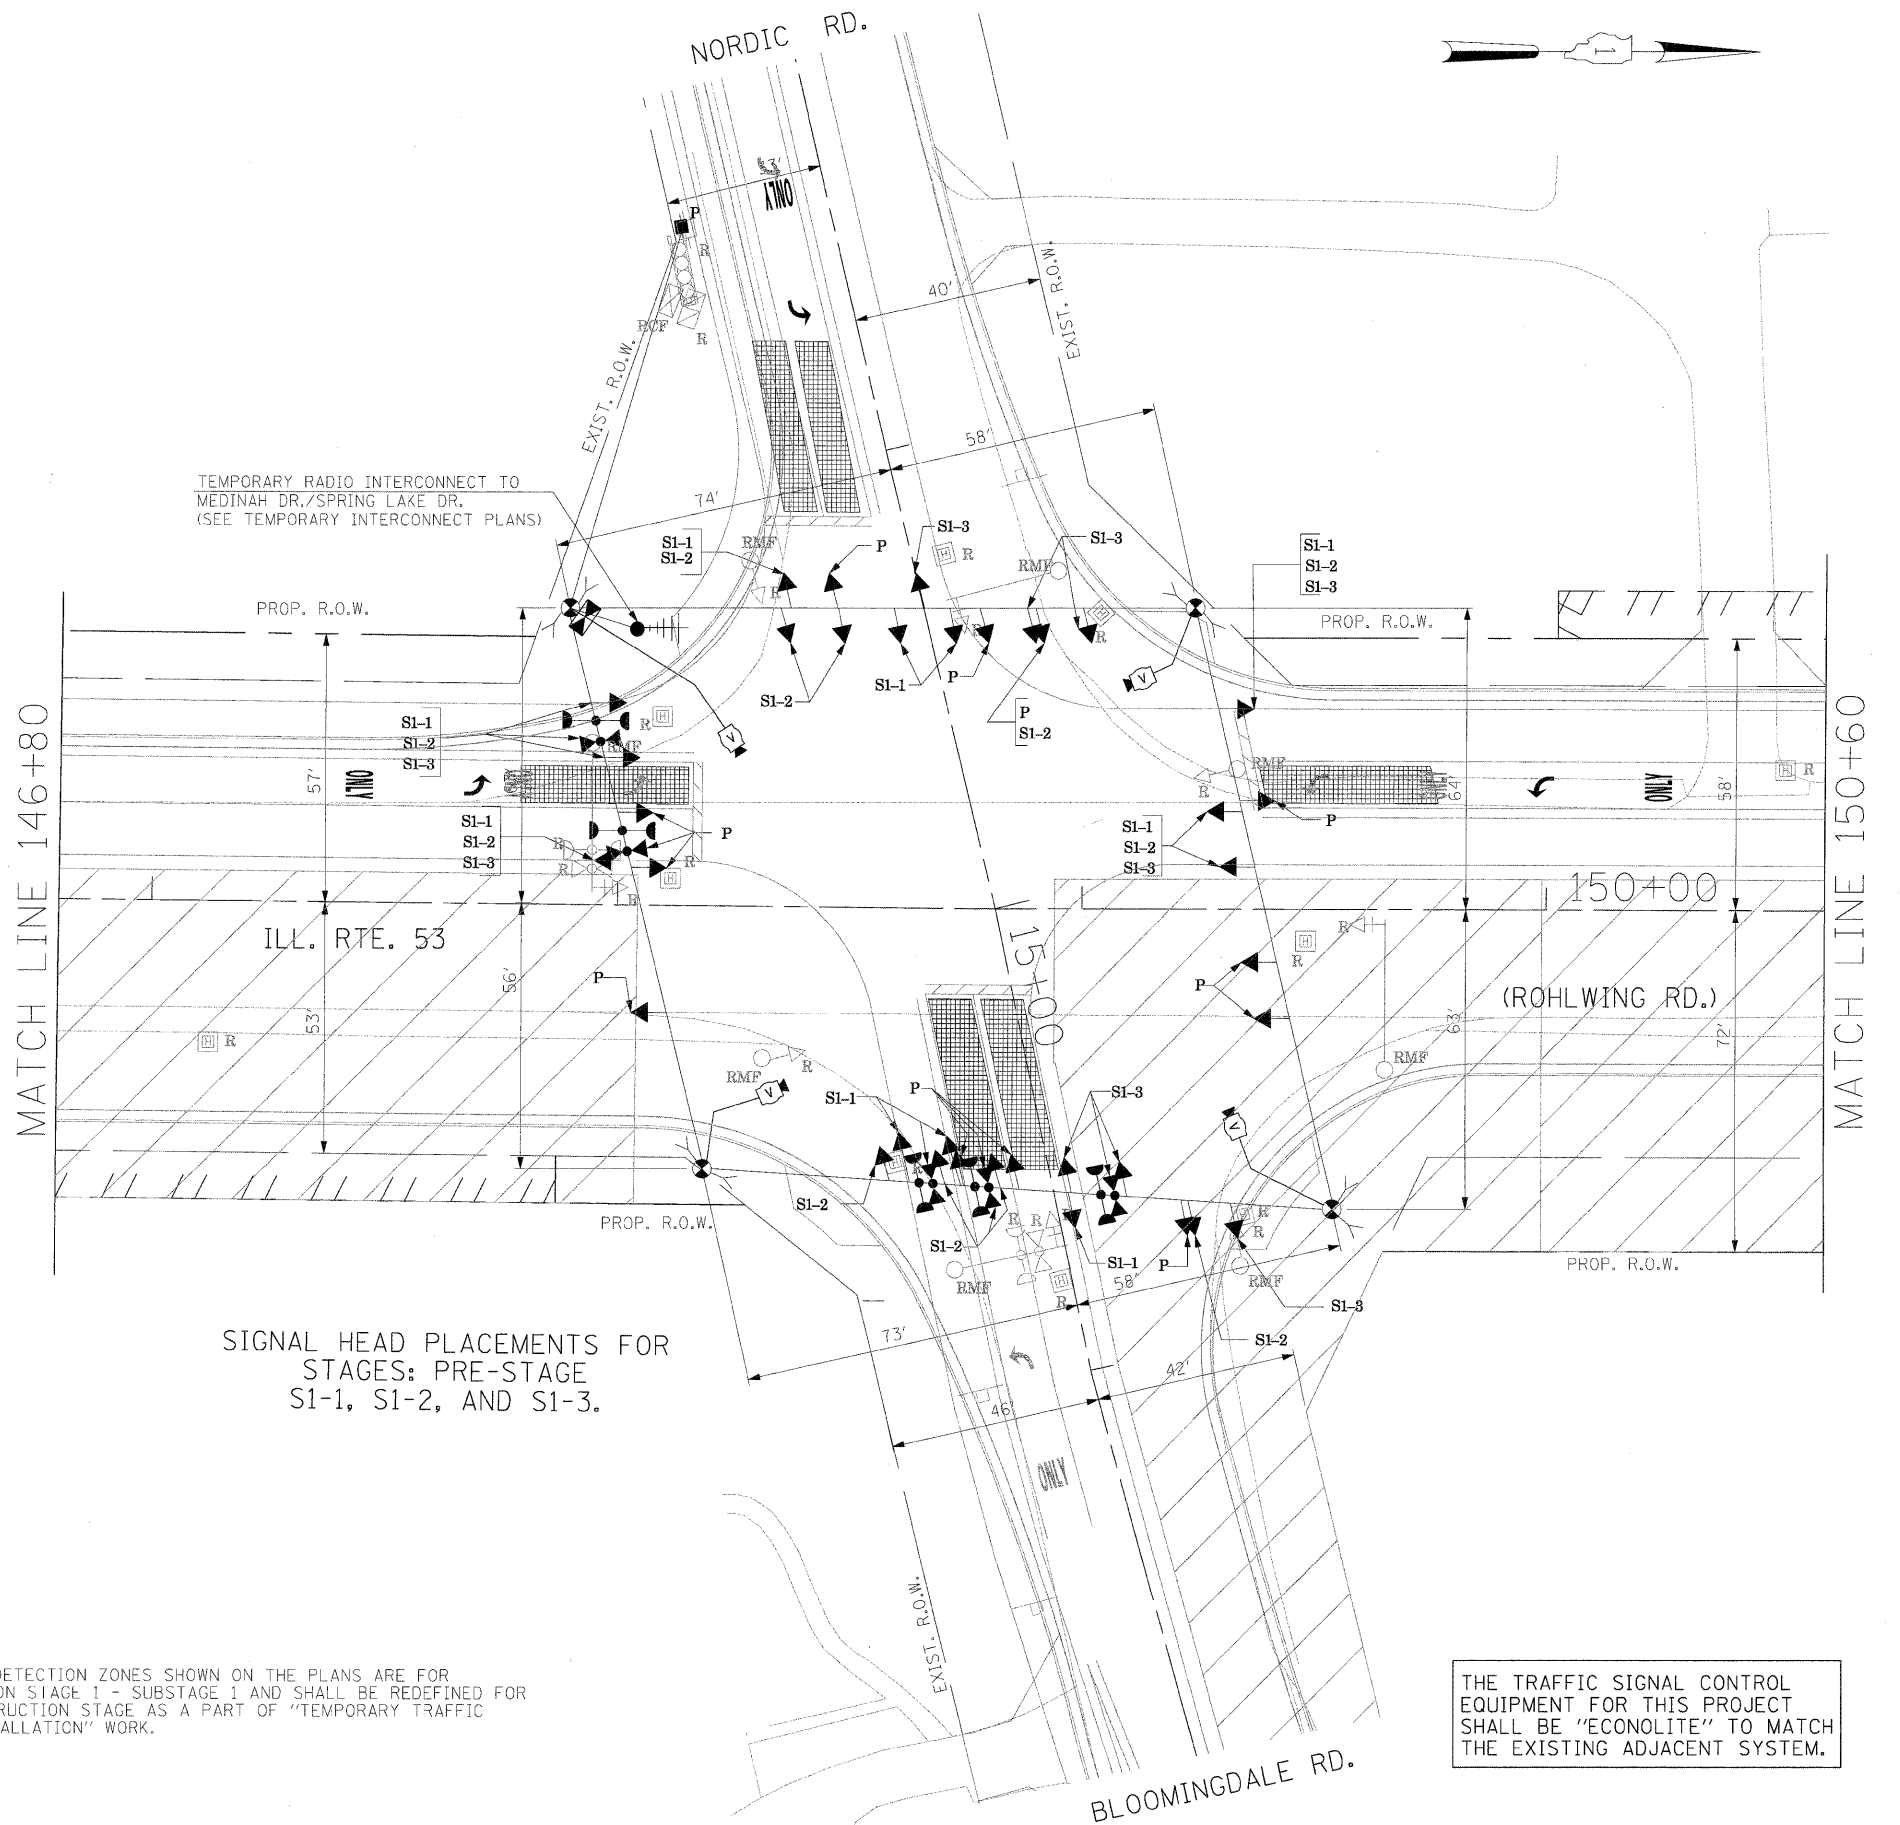

SIGNAL HEAD PLACEMENTS FOR STAGES: PRE-STAGE S1-1, S1-2, AND S1-3.


| | | | | | | | | | | | | | |
|-------------|----------------------|-------------------|-----------|---|---|-----------|--------|--------|-------------|---------|--------|-----------------------|-----------|
| FILE NAME = | USER NAME = #USER# | DESIGNED - PKG | REVISED - | STATE OF ILLINOIS DEPARTMENT OF TRANSPORTATION | TEMPORARY TRAFFIC SIGNAL INSTALLATION AND REMOVAL PLAN ILLINOIS ROUTE 53 (ROHLWING RD.) AT NORDIC RD./BLOOMINGDALE RD. PRE STAGE AND STAGE 1 (SHEET 1 OF 4). | | | | F.A.P. RTE. | SECTION | COUNTY | TOTAL SHEETS | SHEET NO. |
| #FILE# | | DRAWN - MAA, EA | REVISED - | | 2578 | 532B | DuPage | 781 | 466 | | | | |
| | PLOT SCALE = #SCALE# | CHECKED - PKG, EA | REVISED - | | CONTRACT NO. 60477 | | | | | | | | |
| | PLOT DATE = #DATE# | DATE - 5/10/2010 | REVISED - | | SCALE: 1"=20' | SHEET NO. | OF | SHEETS | STA. | TO | STA. | FED. ROAD DIST. NO. - | ILLINOIS |

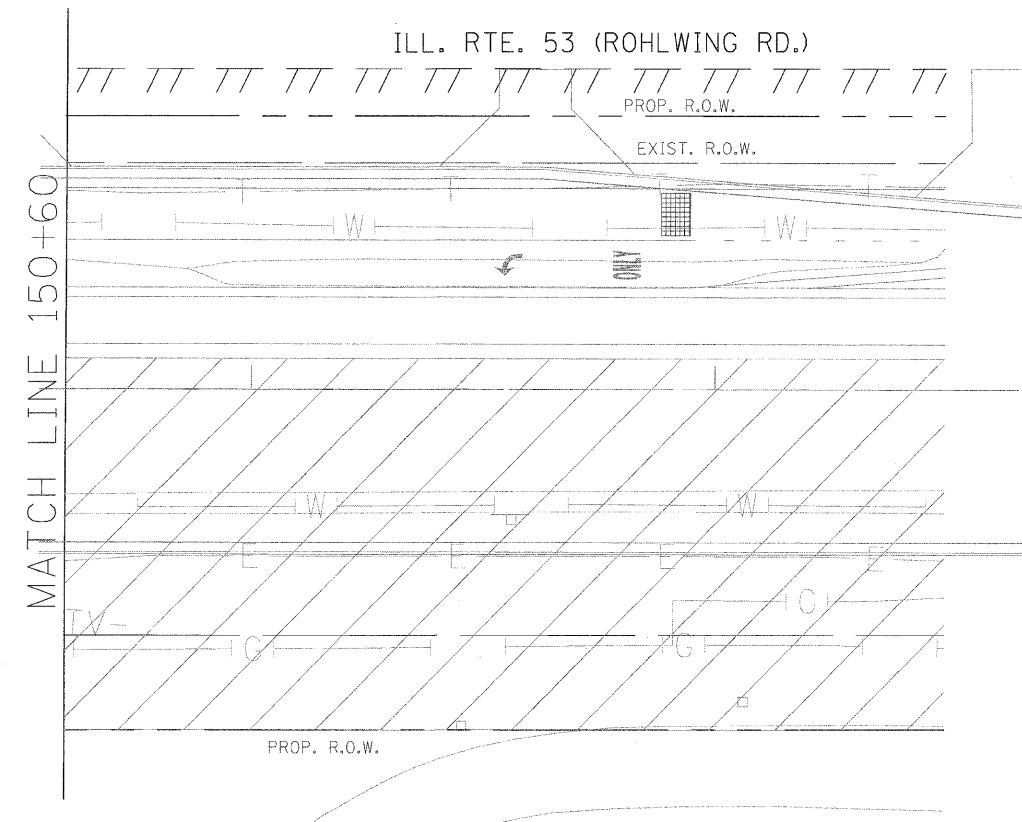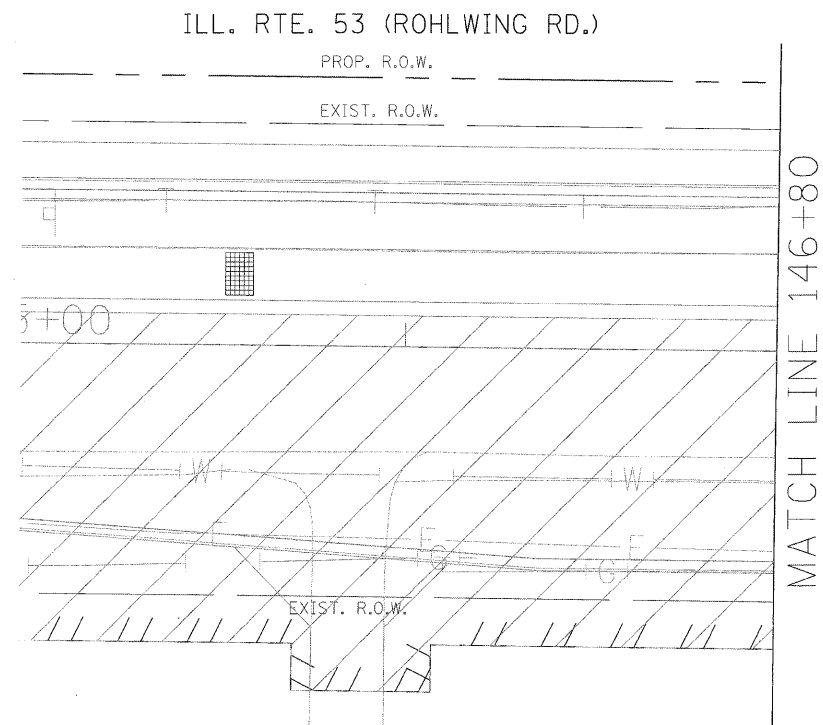


NOTE: THE VIDEO DETECTION ZONES SHOWN ON THE PLANS ARE FOR CONSTRUCTION STAGE 1 - SUBSTAGE 1 AND SHALL BE REDEFINED FOR EACH CONSTRUCTION STAGE AS A PART OF "TEMPORARY TRAFFIC SIGNAL INSTALLATION" WORK.

THE TRAFFIC SIGNAL CONTROL EQUIPMENT FOR THIS PROJECT SHALL BE "ECONOLITE" TO MATCH THE EXISTING ADJACENT SYSTEM.

| | | | | | | | | | | | | | | | |
|-------------|----------------------|-------------------|-----------|---|--|-----------|----|----------------|---------|---------|--------------|---|--------|-----|--------------------|
| FILE NAME - | USER NAME = #USER# | DESIGNED - PKG | REVISED - | STATE OF ILLINOIS DEPARTMENT OF TRANSPORTATION | TEMPORARY TRAFFIC SIGNAL INSTALLATION AND REMOVAL PLAN ILLINOIS ROUTE 53 (ROHLWING RD.) AT NORDIC RD./BLOOMINGDALE RD. PRE STAGE AND STAGE 1 (SHEET 2 OF 4) | | | F.A.P. RTE. | SECTION | COUNTY | TOTAL SHEETS | SHEET NO. | | | |
| #FILE# | | DRAWN - MAA, EA | REVISED - | | SCALE: 1"=20' | SHEET NO. | OF | SHEETS | STA. | TO STA. | 257B | 532B | DuPage | 781 | 467 |
| | PLOT SCALE = #SCALE# | CHECKED - PKG, EA | REVISED - | | | | | | | | | | | | |
| | PLOT DATE = #DATE# | DATE - 5/10/2010 | REVISED - | | | | | | | | | | | | CONTRACT NO. 60477 |
| | | | | | | | | | | | | FED. ROAD DIST. NO. - [ILLINOIS] FED. AID PROJECT | | | |

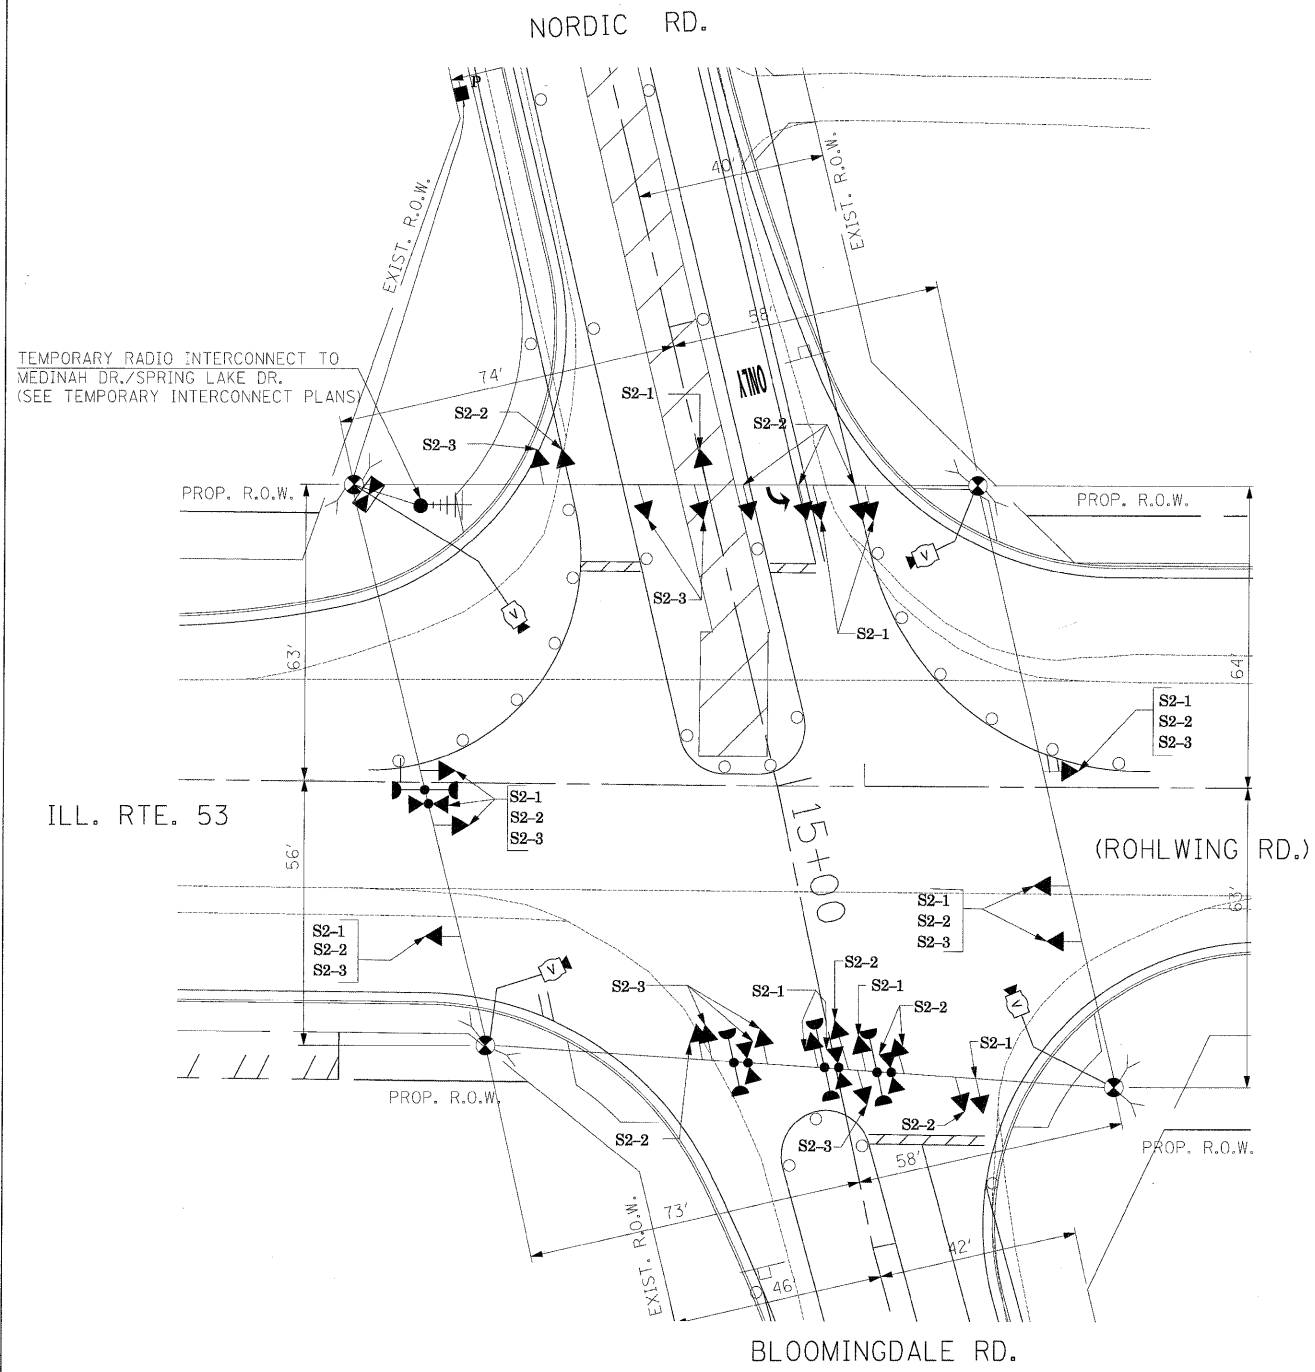

SIGNAL HEAD PLACEMENTS FOR STAGES: S2-1, S2-2, AND S2-3.

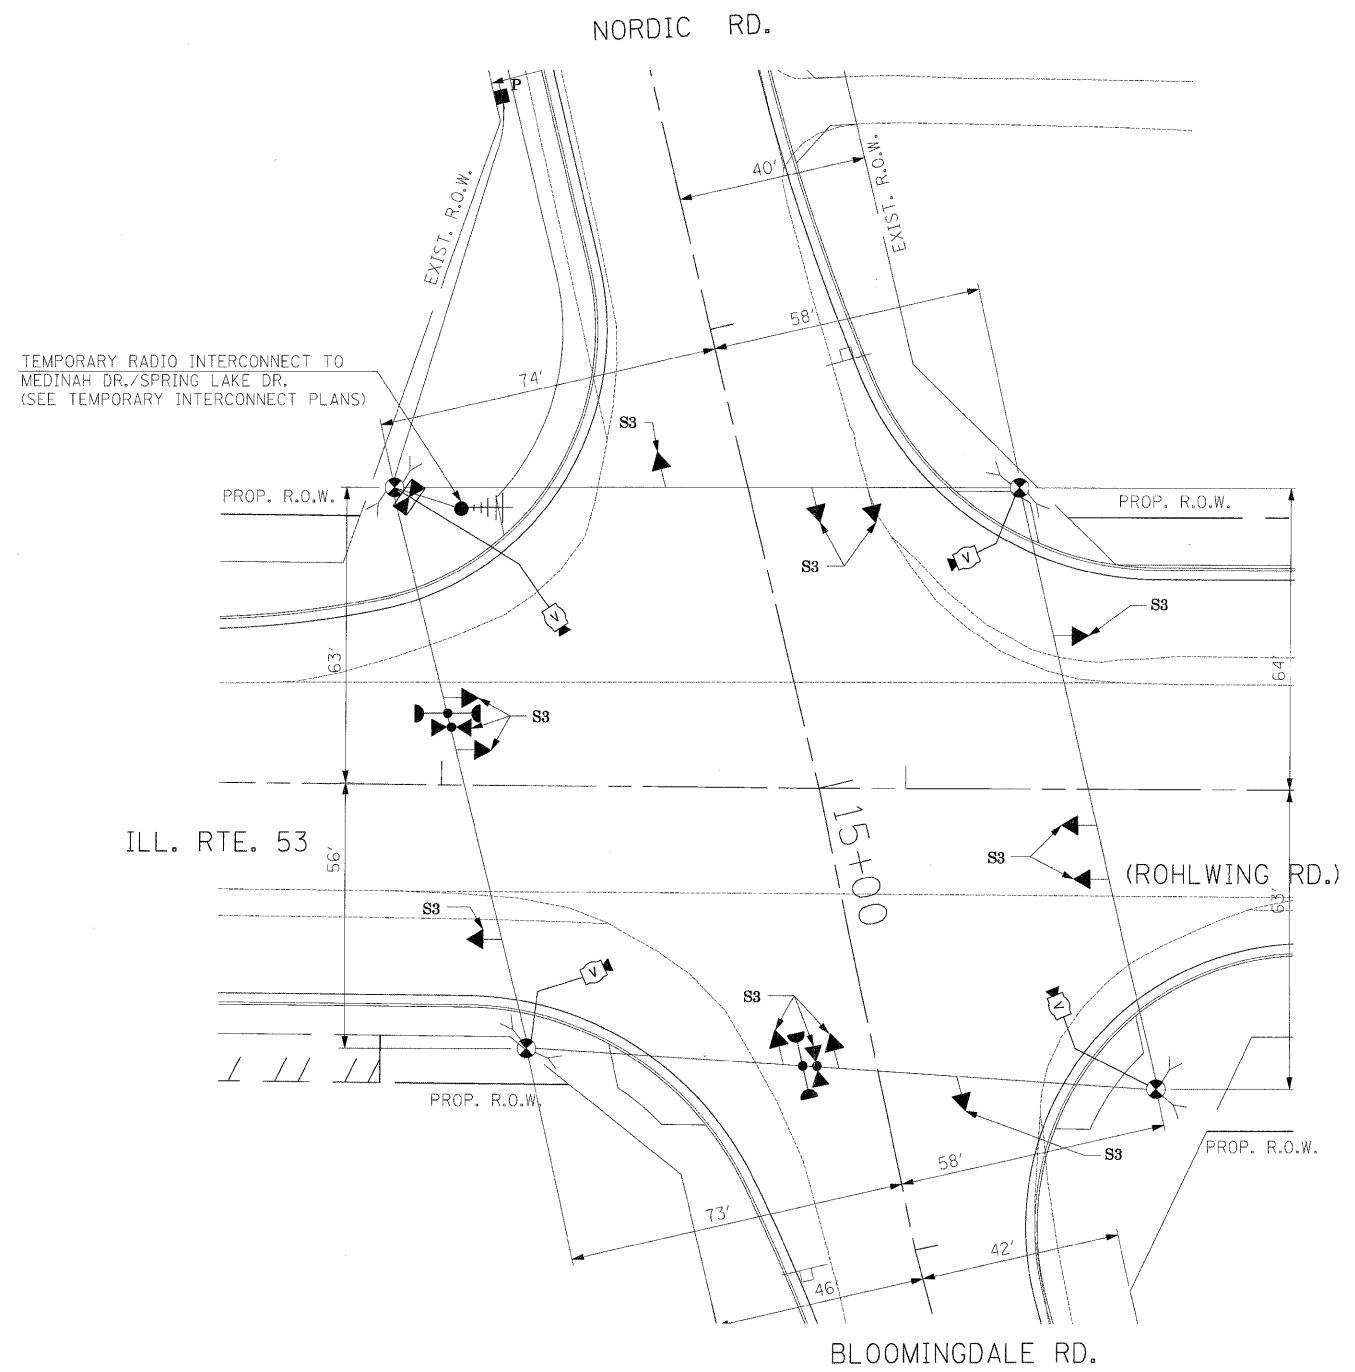


SIGNAL HEAD PLACEMENTS FOR STAGE: S3

THE TRAFFIC SIGNAL CONTROL EQUIPMENT FOR THIS PROJECT SHALL BE "ECONOLITE" TO MATCH THE EXISTING ADJACENT SYSTEM.

NOTE: THE VIDEO DETECTION ZONES SHOWN ON THE PLANS ARE FOR CONSTRUCTION STAGE 1 - SUBSTAGE 1 AND SHALL BE REDEFINED FOR EACH CONSTRUCTION STAGE AS A PART OF "TEMPORARY TRAFFIC SIGNAL INSTALLATION" WORK.

| | | | | | | | | | | | | |
|-------------|--------------------|-------------------|-----------|---|--|--------------------------|---------|---|-----------------|--------------------|------------------------|---------------------|
| FILE NAME = | USER NAME = #USER# | DESIGNED - PKG | REVISED - | STATE OF ILLINOIS DEPARTMENT OF TRANSPORTATION | TEMPORARY TRAFFIC SIGNAL INSTALLATION AND REMOVAL PLAN ILLINOIS ROUTE 53 (ROHLWING RD.) AT NORDIC RD./BLOOMINGDALE RD. STAGE 2 AND STAGE 3 (SHEET 3 OF 4) | | | F.A.P. RTE. 257B | SECTION 532B | COUNTY DuPage | TOTAL SHEETS 781 | SHEET NO. 468 |
| #FILE# | | DRAWN - MAA, EA | REVISED - | | SCALE: 1"=20' | SHEET NO. OF SHEETS STA. | TO STA. | FED. ROAD DIST. NO. - ILLINOIS FED. AID PROJECT | | CONTRACT NO. 60477 | | |
| | | CHECKED - PKG, EA | REVISED - | | | | | | | | | |
| | | DATE - 5/10/2010 | REVISED - | | | | | | | | | |


TEMPORARY RADIO INTERCONNECT TO
MEDINAH DR./SPRING LAKE DR.
(SEE TEMPORARY INTERCONNECT PLANS)

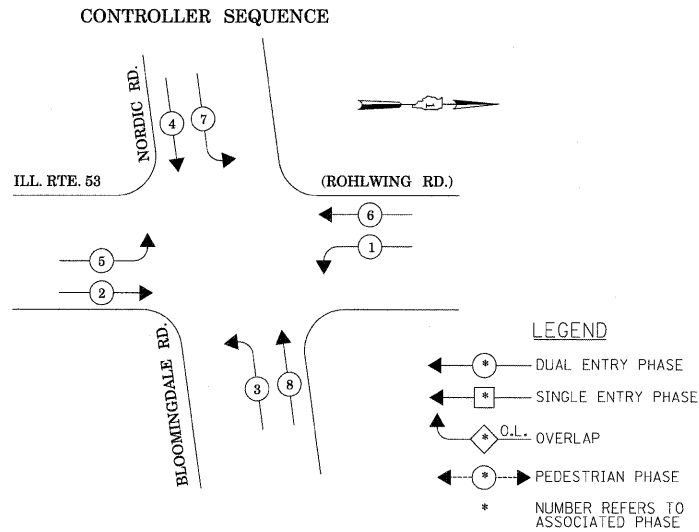


TEMPORARY PHASE DESIGNATION DIAGRAM

STAGES: PRE-STAGE, S1-1, S1-2, S1-3, S2-1, S2-2,
S2-3, S3, AND AFTER PROPOSED ROADWAY
GEOMETRICS ARE BUILT

EMERGENCY VEHICLE PREEMPTION SEQUENCE

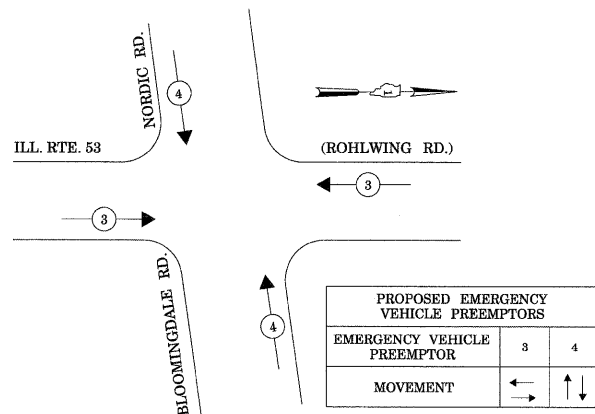

STAGES: PRE-STAGE, S1-1, S1-2, S1-3, S2-1, S2-2,
S2-3, S3, AND AFTER PROPOSED ROADWAY
GEOMETRICS ARE BUILT

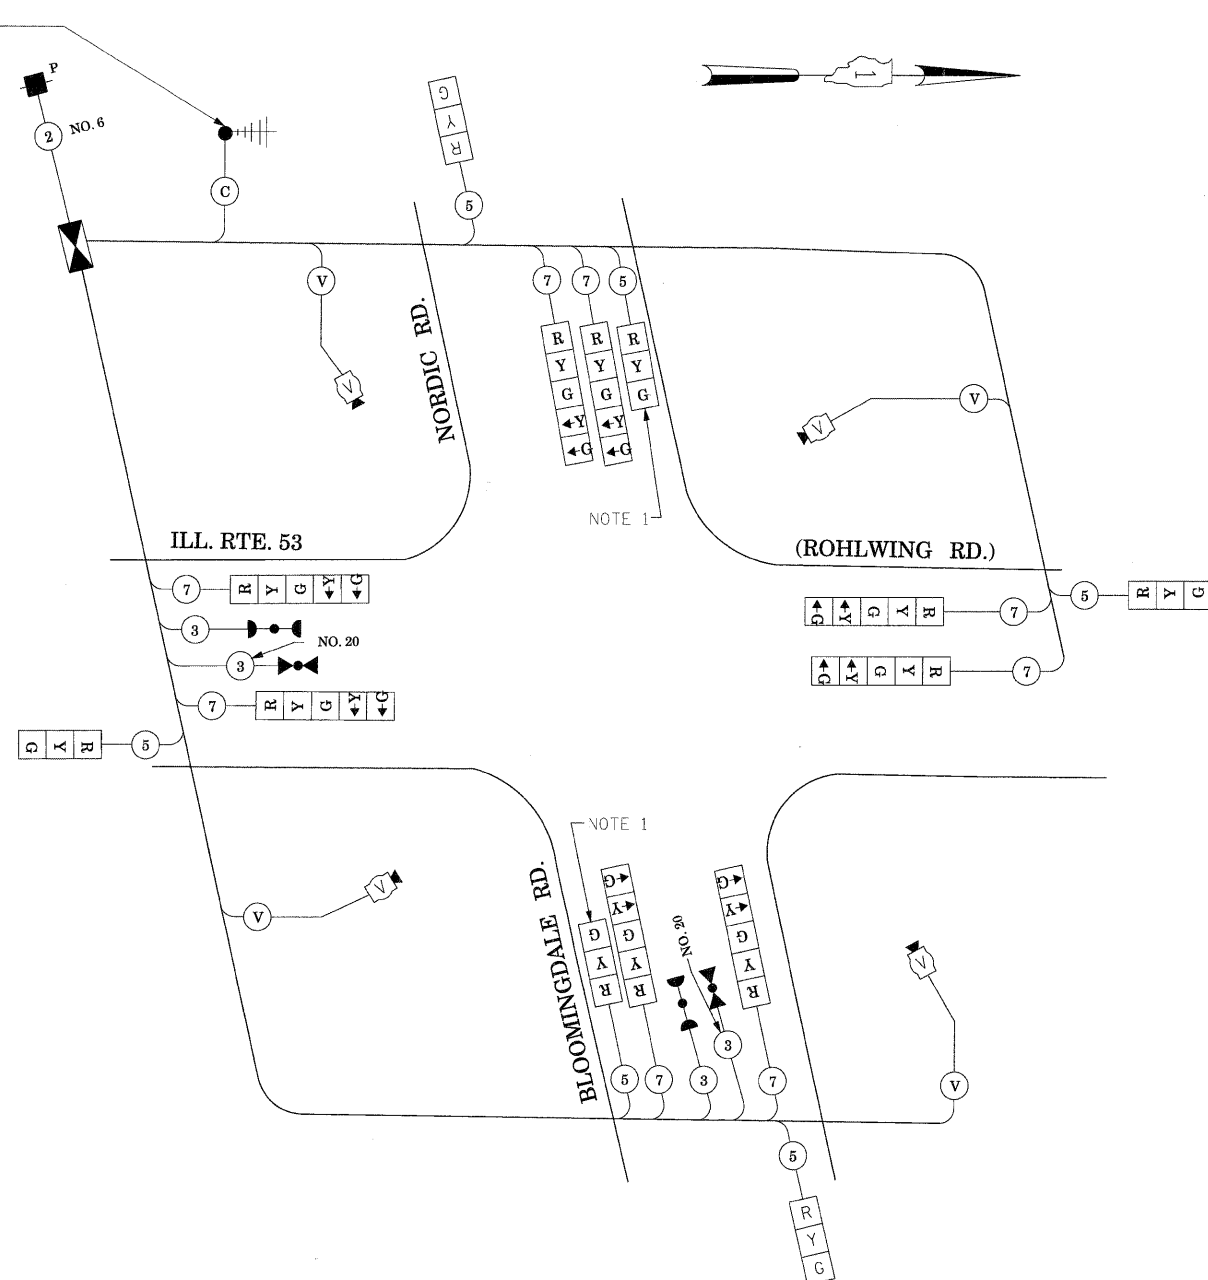

TEMPORARY CABLE PLAN

(NOT TO SCALE)

STAGES: PRE-STAGE, S1-1, S1-2, S1-3, S2-1, S2-2, S2-3, S3,
AND AFTER PROPOSED ROADWAY GEOMETRICS ARE BUILT

NOTE 1: THE 3-SECTION SIGNAL HEAD MOUNTED ON THE FAR-SIDE SPAN WIRE FOR EASTBOUND AND WESTBOUND DIRECTION OF TRAFFIC IS NEEDED DURING CONSTRUCTION STAGES S1-2 AND S2-2. IN ALL OTHER STAGES THIS 3-SECTION SIGNAL HEAD SHALL BE DISCONNECTED AND BAGGED.


THE TRAFFIC SIGNAL CONTROL EQUIPMENT FOR THIS PROJECT SHALL BE "ECONOLITE" TO MATCH THE EXISTING ADJACENT SYSTEM.

| I.D.O.T. TRAFFIC SIGNAL INSTALLATION ELECTRICAL SERVICE REQUIREMENTS | | | | | TOTAL WATTAGE |
|---|----------------------|-------------------|-----------|------------|---------------|
| TYPE | NO LAMPS | WATTAGE | | %OPERATION | |
| | | INCAND. | LED | | |
| SIGNAL (RED) | 14 | 135 | 17 | 0.50 | 119 |
| (YELLOW) | 14 | 135 | 25 | 0.25 | 87.5 |
| (GREEN) | 14 | 135 | 15 | 0.25 | 52.5 |
| ARROW | 16 | 135 | 12 | 0.10 | 19.2 |
| PED. SIGNAL | | 90 | 25 | 1.00 | |
| CONTROLLER | 1 | 100 | 100 | 1.00 | 100 |
| ILLUM. SIGN | | | 25 | 0.05 | |
| VIDEO SYSTEM | 1 | 150 | | 1.00 | 150 |
| FLASHER | | | | 0.50 | |
| ENERGY COSTS TO: | | | | TOTAL = | 528.2 |
| ILLINOIS DEPARTMENT OF TRANSPORTATION 201 WEST CENTER COURT SCHAUMBURG, ILLINOIS 60196-1096 ENERGY SUPPLY CONTACT: CURTIS TOPPS PHONE: (630) 691-4356 COMPANY: COMMONWEALTH EDISON | | | | | |
| FILE NAME = | USER NAME = #USER# | DESIGNED - PKG | REVISED - | | |
| #FILE# | | DRAWN - MAA, EA | REVISED - | | |
| | PLOT SCALE = #SCALE# | CHECKED - PKG, EA | REVISED - | | |
| | PLOT DATE = #DATE# | DATE - 5/10/2010 | REVISED - | | |

STATE OF ILLINOIS
DEPARTMENT OF TRANSPORTATION

TEMPORARY CABLE PLAN, TEMPORARY PHASE DESIGNATION DIAGRAM
TEMPORARY EMERGENCY VEHICLE PREEMPTION SEQUENCE
ILLINOIS ROUTE 53 (ROHLWING RD.) AT NORDIC RD./BLOOMINGDALE RD.
PRE-STAGE, STAGE 1, STAGE 2, AND STAGE 3 (SHEET 4 OF 4).

| F.A.P. RTE. | SECTION | COUNTY | TOTAL SHEETS | SHEET NO. |
|-------------|---------|--------|--------------|--------------------|
| 2578 | 532B | DuPage | 781 | 469 |
| | | | | CONTRACT NO. 60477 |

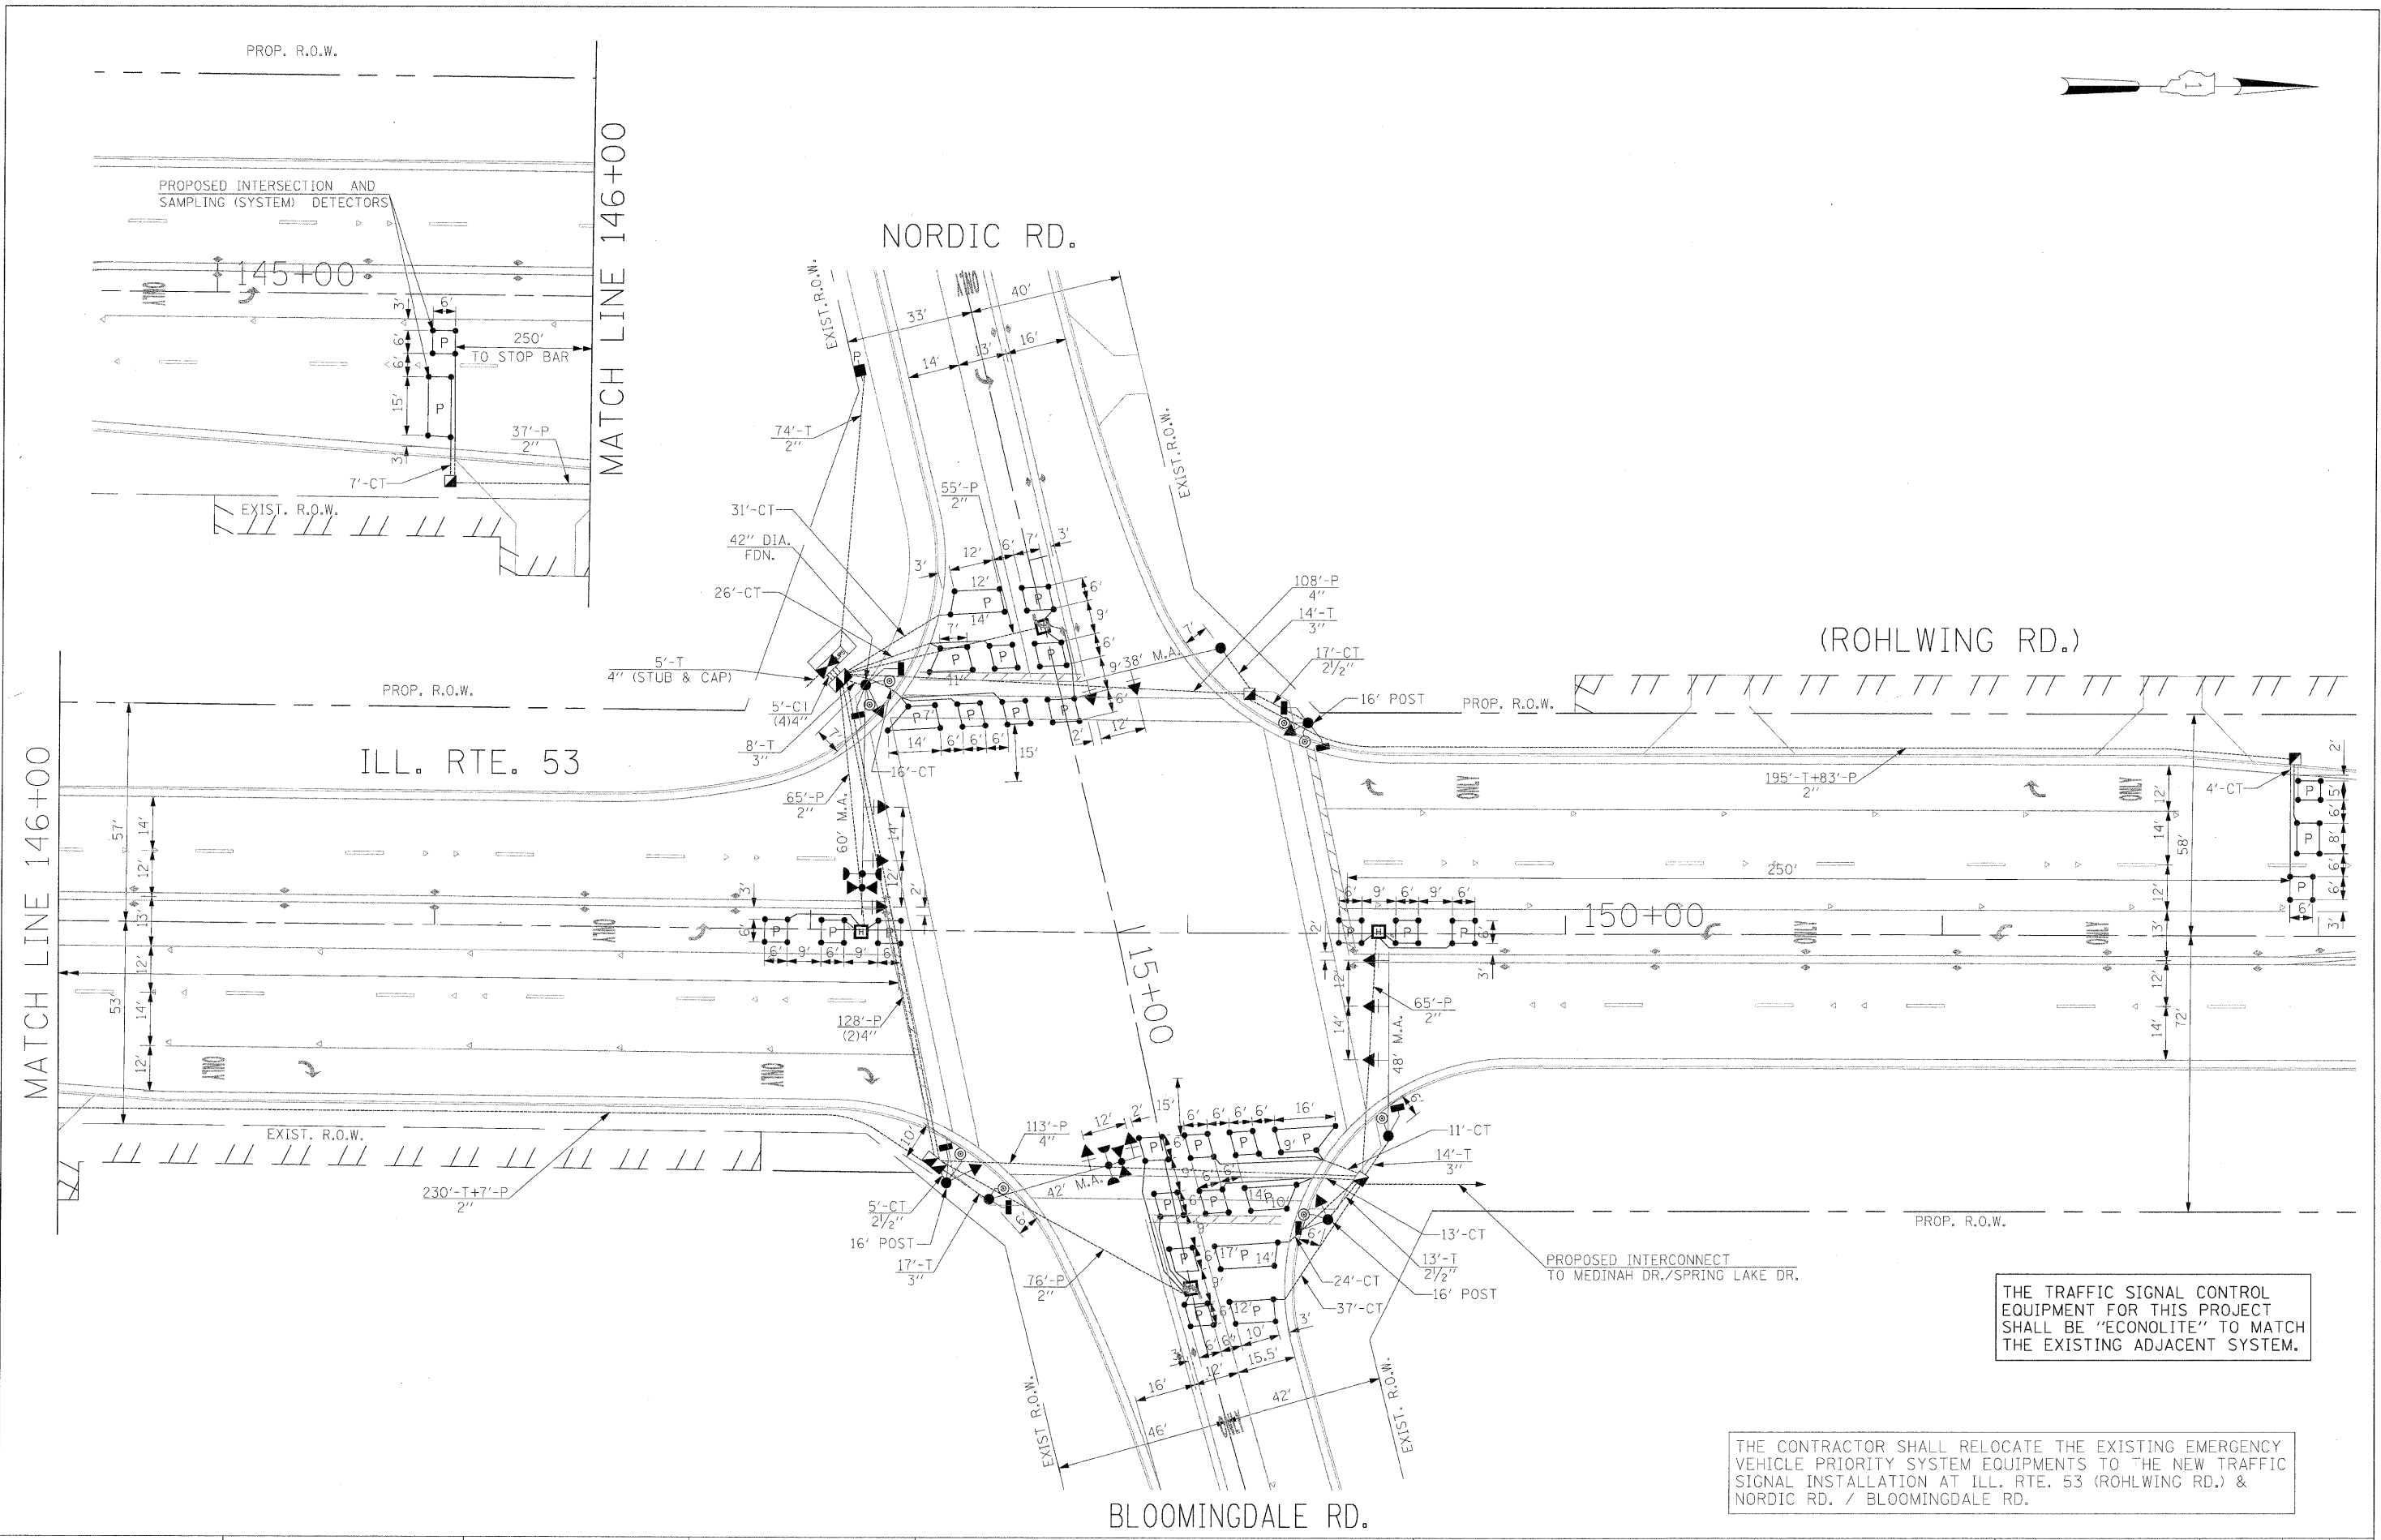

THE TRAFFIC SIGNAL CONTROL EQUIPMENT FOR THIS PROJECT SHALL BE "ECONOLITE" TO MATCH THE EXISTING ADJACENT SYSTEM.

THE CONTRACTOR SHALL RELOCATE THE EXISTING EMERGENCY VEHICLE PRIORITY SYSTEM EQUIPMENTS TO THE NEW TRAFFIC SIGNAL INSTALLATION AT ILL. RTE. 53 (ROHLWING RD.) & NORDIC RD. / BLOOMINGDALE RD.

| | | | | | | | | | | | | |
|--------------------|----------------------|-------------------|-----------|---|--|----------------------------------|---|------------------|--------------|---------------|------------------|---------------|
| FILE NAME = #FILE# | USER NAME = #USER# | DESIGNED - PKG | REVISED - | STATE OF ILLINOIS DEPARTMENT OF TRANSPORTATION | PROPOSED TRAFFIC SIGNAL INSTALLATION PLAN ILLINOIS ROUTE 53 (ROHLWING RD.) AT NORDIC RD./BLOOMINGDALE RD. | | | F.A.P. RTE. 2578 | SECTION 532B | COUNTY DuPage | TOTAL SHEETS 781 | SHEET NO. 470 |
| | PLOT SCALE = #SCALE# | DRAWN - MAA, EA | REVISED - | | SCALE: 1"=20' | SHEET NO. OF SHEETS STA. TO STA. | CONTRACT NO. 60477 | | | | | |
| | PLOT DATE = #DATE# | CHECKED - PKG, EA | REVISED - | | | | FED. ROAD DIST. NO. - [ILLINOIS] FED. AID PROJECT | | | | | |
| | | DATE - 5/10/2010 | REVISED - | | | | | | | | | |

SCHEDULE OF QUANTITIES

| QUANTITY | UNIT | ITEM |
|----------|-------|---|
| 33 | SQ FT | SIGN PANEL - TYPE 1 |
| 35 | SQ FT | SIGN PANEL - TYPE 2 |
| 499 | FOOT | CONDUIT IN TRENCH, 2" DIA., GALVANIZED STEEL |
| 35 | FOOT | CONDUIT IN TRENCH, 2 1/2" DIA., GALVANIZED STEEL |
| 53 | FOOT | CONDUIT IN TRENCH, 3" DIA., GALVANIZED STEEL |
| 25 | FOOT | CONDUIT IN TRENCH, 4" DIA., GALVANIZED STEEL |
| 388 | FOOT | CONDUIT PUSHED, 2" DIA., GALVANIZED STEEL |
| 477 | FOOT | CONDUIT PUSHED, 4" DIA., GALVANIZED STEEL |
| 4 | EACH | HANDHOLE |
| 4 | EACH | HEAVY-DUTY HANDHOLE |
| 2 | EACH | DOUBLE HANDHOLE |
| 621 | FOOT | TRENCH AND BACKFILL FOR ELECTRICAL WORK |
| 1 | EACH | FULL-ACTUATED CONTROLLER AND TYPE IV CABINET, SPECIAL |
| 1 | EACH | TRANSCIEVER-FIBER OPTIC |
| 1402 | FOOT | ELECTRIC CABLE IN CONDUIT, SIGNAL NO. 14 2C |
| 1804 | FOOT | ELECTRIC CABLE IN CONDUIT, SIGNAL NO. 14 3C |
| 1333 | FOOT | ELECTRIC CABLE IN CONDUIT, SIGNAL NO. 14 5C |
| 1675 | FOOT | ELECTRIC CABLE IN CONDUIT, SIGNAL NO. 14 7C |
| 2394 | FOOT | ELECTRIC CABLE IN CONDUIT, LEAD-IN, NO. 14 1 PAIR |
| 93 | FOOT | ELECTRIC CABLE IN CONDUIT, SERVICE, NO. 6 2C |
| 3 | EACH | TRAFFIC SIGNAL POST, GALVANIZED STEEL 16 FT. |
| 1 | EACH | STEEL MAST ARM ASSEMBLY AND POLE, 38 FT. |
| 1 | EACH | STEEL MAST ARM ASSEMBLY AND POLE, 42 FT. |
| 1 | EACH | STEEL MAST ARM ASSEMBLY AND POLE, 48 FT. |
| 1 | EACH | STEEL MAST ARM ASSEMBLY AND POLE, 60 FT. |
| 12 | FOOT | CONCRETE FOUNDATION, TYPE A |
| 4 | FOOT | CONCRETE FOUNDATION, TYPE C |
| 45 | FOOT | CONCRETE FOUNDATION, TYPE E 36-INCH DIAMETER |
| 21 | FOOT | CONCRETE FOUNDATION, TYPE E 42-INCH DIAMETER |
| 6 | EACH | SIGNAL HEAD, LED, 1-FACE, 3-SECTION, MAST ARM MOUNTED |
| 4 | EACH | SIGNAL HEAD, LED, 1-FACE, 5-SECTION, BRACKET MOUNTED |
| 4 | EACH | SIGNAL HEAD, LED, 1-FACE, 5-SECTION, MAST ARM MOUNTED |
| 4 | EACH | PEDESTRIAN SIGNAL HEAD, LED, 1-FACE, BRACKET MOUNTED WITH COUNTDOWN TIMER |
| 2 | EACH | PEDESTRIAN SIGNAL HEAD, LED, 2-FACE, BRACKET MOUNTED WITH COUNTDOWN TIMER |
| 10 | EACH | TRAFFIC SIGNAL BACKPLATE, LOUVERED, ALUMINUM |
| 9 | EACH | INDUCTIVE LOOP DETECTOR |
| 8 | EACH | PEDESTRIAN PUSH-BUTTON |
| 1 | EACH | TEMPORARY TRAFFIC SIGNAL INSTALLATION |
| 2 | EACH | RELOCATE EXISTING EMERGENCY VEHICLE PRIORITY SYSTEM, DETECTOR UNIT |
| 1 | EACH | RELOCATE EXISTING EMERGENCY VEHICLE PRIORITY SYSTEM, PHASING UNIT |
| 1 | EACH | REMOVE EXISTING TRAFFIC SIGNAL EQUIPMENT |
| 11 | EACH | REMOVE EXISTING HANDHOLE |
| 9 | EACH | REMOVE EXISTING CONCRETE FOUNDATION |
| 1224 | FOOT | PREFORMED DETECTOR LOOP |
| 1 | EACH | TEMPORARY TRAFFIC SIGNAL TIMING |
| 1 | EACH | SERVICE INSTALLATION - POLE MOUNTED |
| 1 | EACH | UNINTERRUPTIBLE POWER SUPPLY |
| 659 | FOOT | ELECTRIC CABLE IN CONDUIT, GROUNDING, NO. 6 1C |
| 346 | FOOT | ELECTRIC CABLE IN CONDUIT NO. 20 3/C, TWISTED, SHIELDED |

* 100% COST TO VILLAGE OF ITASCA


THE CONTRACTOR SHALL RELOCATE THE EXISTING EMERGENCY VEHICLE PRIORITY SYSTEM EQUIPMENTS TO THE NEW TRAFFIC SIGNAL INSTALLATION AT ILL. RTE. 53 (ROHLWING RD.) & NORDIC RD. / BLOOMINGDALE RD.

| I.D.O.T. TRAFFIC SIGNAL INSTALLATION ELECTRICAL SERVICE REQUIREMENTS | | | | | TOTAL WATTAGE |
|--|----------|---------|-----|------------|---------------|
| TYPE | NO LAMPS | INCAND. | LED | %OPERATION | |
| SIGNAL - (RED) | 14 | 135 | 17 | 0.50 | 119 |
| (YELLOW) | 14 | 135 | 25 | 0.25 | 87.5 |
| (GREEN) | 14 | 135 | 15 | 0.25 | 52.5 |
| ARROW | 16 | 135 | 12 | 0.10 | 19.2 |
| PED. SIGNAL | 8 | 90 | 25 | 1.00 | 200 |
| CONTROLLER | 1 | 100 | 100 | 1.00 | 100 |
| ILLUM. SIGN | | | 25 | 0.05 | |
| FLASHER | | | | 0.50 | |
| ENERGY COSTS TO: | | | | TOTAL = | 578.2 |

ILLINOIS DEPARTMENT OF TRANSPORTATION
201 WEST CENTER COURT
SCHAUMBURG, ILLINOIS 60196-1096

ENERGY SUPPLY CONTACT: CURTIS TOPPS
PHONE: (630) 691-4356
COMPANY: COMMONWEALTH EDISON


| | | | |
|-------------|--------------------|-------------------|-----------|
| FILE NAME = | USER NAME = #USER# | DESIGNED - PKG | REVISED - |
| #FILE# | | DRAWN - MAA, EA | REVISED - |
| | | CHECKED - PKG, EA | REVISED - |
| | | DATE - 5/10/2010 | REVISED - |

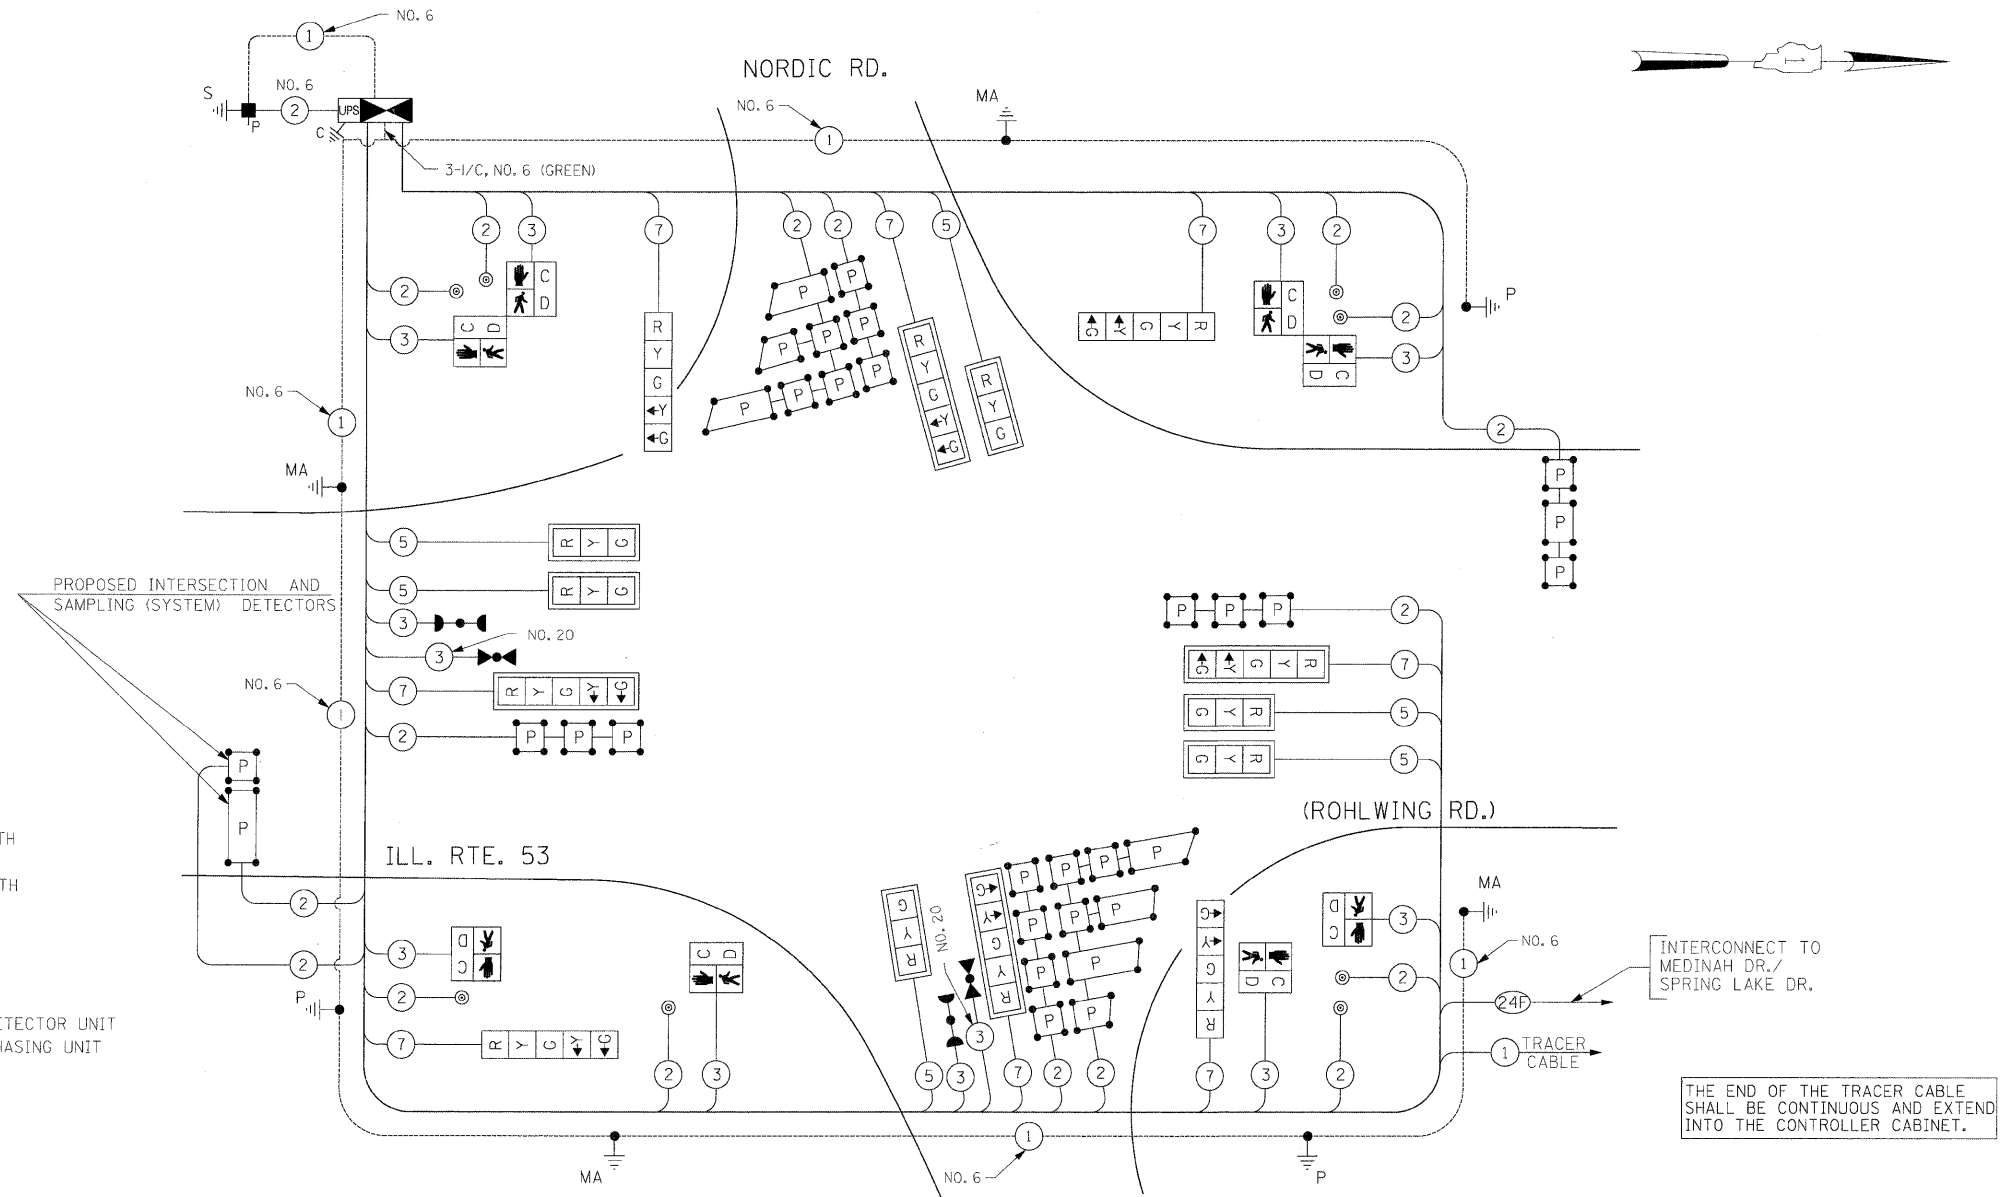

CONTROLLER SEQUENCE

BLOOMINGDALE RD. CABLE PLAN (NOT TO SCALE)

EMERGENCY VEHICLE PREEMPTION SEQUENCE

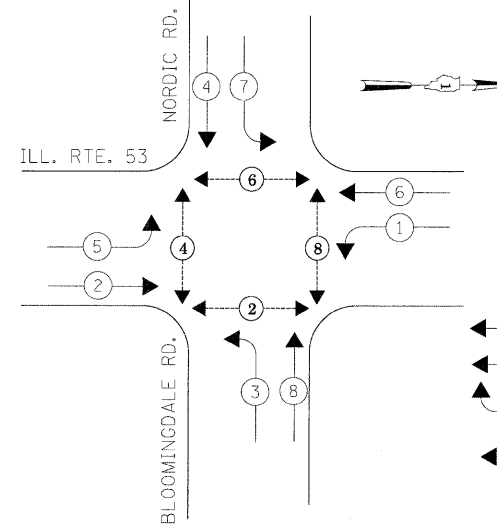

PHASE DESIGNATION DIAGRAM

LEGEND

- * DUAL ENTRY PHASE
- * SINGLE ENTRY PHASE
- ◇ OVERLAP
- * PEDESTRIAN PHASE
- * NUMBER REFERS TO ASSOCIATED PHASE

THE TRAFFIC SIGNAL CONTROL EQUIPMENT FOR THIS PROJECT SHALL BE "ECONOLITE" TO MATCH THE EXISTING ADJACENT SYSTEM.

| PROPOSED EMERGENCY VEHICLE PREEMPTORS | |
|---------------------------------------|---------|
| EMERGENCY VEHICLE PREEMPTOR | 3 4 |
| MOVEMENT | ← → ↑ ↓ |

STATE OF ILLINOIS DEPARTMENT OF TRANSPORTATION

| | | | | | | | | |
|--|--|--|--|--------------------|--------------|---|------------------|---------------|
| CABLE PLAN, PHASE DESIGNATION DIAGRAM, EMERGENCY VEHICLE PREEMPTION SEQUENCE, SCHEDULE OF QUANTITIES | | | | F.A.P. RTE. 2578 | SECTION 532B | COUNTY DuPage | TOTAL SHEETS 781 | SHEET NO. 471 |
| ILLINOIS ROUTE 53 (ROHLWING RD.) AT NORDIC RD./BLOOMINGDALE RD. | | | | CONTRACT NO. 60477 | | FED. ROAD DIST. NO. - ILLINOIS FED. AID PROJECT | | |

NOTES FOR TEMPORARY TRAFFIC SIGNALS



1. ALL CONTROL EQUIPMENT INCLUDING EMERGENCY PRE-EMPTION AND COMMUNICATION DEVICES FOR THE TEMPORARY TRAFFIC SIGNAL(S) SHALL BE FURNISHED BY THE CONTRACTOR.
2. ONLY CONTROLLERS SUPPLIED BY ONE OF THE DISTRICT APPROVED CLOSED LOOP EQUIPMENT MANUFACTURERS WILL BE APPROVED FOR USE AT TEMPORARY SIGNAL LOCATIONS. ALL CONTROLLERS USED FOR TEMPORARY TRAFFIC SIGNALS SHALL BE FULLY ACTUATED NEMA MICROPROCESSOR BASED WITH RS232 DATA ENTRY PORTS COMPATIBLE WITH EXISTING MONITORING SOFTWARE APPROVED BY IDOT DISTRICT 1, INSTALLED IN A NEMA TS2 CABINET. ONLY ONE BRAND OF CONTROLLER WILL BE ACCEPTED FOR ANY ONE CONTRACT.
3. ALL TRAFFIC SIGNAL SECTIONS AND PEDESTRIAN SIGNAL SECTIONS SHALL BE LED AND 12" (300mm) DIAMETER. HEADS SHALL BE PLACED AS INDICATED ON THE TEMPORARY TRAFFIC SIGNAL PLAN OR AS DIRECTED BY THE ENGINEER. PEDESTRIAN SIGNALS SHALL INCLUDE SOLID INTERNATIONAL SYMBOLS. PEDESTRIAN SIGNALS WITH COUNTDOWN TIMERS SHALL BE USED WHEN THE EXISTING INSTALLATION UTILIZES COUNTDOWN TYPE OR AS DIRECTED BY THE ENGINEER. COUNTDOWN TYPE PEDESTRIAN SIGNALS ARE NOT TO BE INSTALLED AT A RAILROAD INTERSECTION. THE CONTRACTOR SHALL FURNISH ENOUGH CABLE SLACK TO RELOCATE HEADS TO ANY POSITION ON THE SPAN WIRE OR AT LOCATIONS ILLUSTRATED ON THE PLANS FOR CONSTRUCTION STAGING. THE TEMPORARY TRAFFIC SIGNAL SHALL REMAIN IN OPERATION DURING ALL SIGNAL HEAD RELOCATIONS. EACH TEMPORARY TRAFFIC SIGNAL HEAD SHALL HAVE ITS OWN CABLE FROM THE CONTROLLER CABINET TO THE SIGNAL HEAD.
4. ALL EXISTING STREET NAME AND INTERSECTION REGULATORY SIGNS SHALL BE REMOVED FROM EXISTING POLES, RELOCATED AND SECURELY FASTENED TO THE SPAN WIRE OR WOOD POLE AS DIRECTED BY THE ENGINEER.
5. ANY TEMPORARY SIGNAL WITHIN AN EXISTING CLOSED LOOP TRAFFIC SIGNAL SYSTEM SHALL BE INTERCONNECTED TO THAT SYSTEM USING SIMILAR BRAND CONTROL EQUIPMENT.
6. THE TEMPORARY TRAFFIC SIGNAL SHALL HAVE THE SIGNAL HEAD DISPLAYS, SIGNAL HEAD PLACEMENTS AND CONTROLLER PHASING MATCH THE EXISTING TRAFFIC SIGNAL, AT THE TIME OF THE TURN ON, IF NO TRAFFIC STAGING IS IN PLACE OR WILL NOT BE STAGED ON THE DAY OF THE TURN ON.
7. UNINTERRUPTIBLE POWER SUPPLY (UPS) SYSTEMS SHALL BE INSTALLED AND MADE OPERATIONAL AT TEMPORARY TRAFFIC SIGNAL INSTALLATIONS WHERE UPS IS INSTALLED AT THE EXISTING TRAFFIC SIGNAL, TEMPORARY TRAFFIC SIGNALS AT RAILROAD INTERSECTIONS, AND TEMPORARY TRAFFIC SIGNALS AT INTERSECTIONS WITH FIRE STATION ACTUATED EMERGENCY VEHICLE PRE-EMPTION, OR WHEN INDICATED ON THE PLANS.
8. TRAFFIC SIGNAL MANAGEMENT SYSTEMS SHALL BE MAINTAINED IN OPERATION AS INDICATED ON THE PLANS OR AS DIRECTED BY THE ENGINEER. REQUIRED EQUIPMENT SHALL BE AS SHOWN ON THE PLANS AND THE CONTRACTOR SHALL PLACE THE EQUIPMENT IN OPERATION TO THE SATISFACTION OF THE ENGINEER AND THE AGENCY RESPONSIBLE FOR THE TRAFFIC SIGNAL MANAGEMENT SYSTEM.
9. DETECTION AT TEMPORARY TRAFFIC SIGNALS SHALL BE INCLUDED FOR ALL APPROACHES OF THE INTERSECTION UNLESS INDICATED OTHERWISE ON THE PLANS. THE DETECTION SYSTEM MUST MEET THE SPECIFICATIONS OF DISTRICT 1 AND THE CONTRACTOR SHALL PLACE THE DETECTORS INTO OPERATION TO THE SATISFACTION OF THE ENGINEER.
10. WHEN PAN, TILT, ZOOM CAMERAS ARE INSTALLED AT THE EXISTING INTERSECTION OR ARE CALLED FOR IN THE PLANS, THE CONTRACTOR SHALL BE RESPONSIBLE FOR INSTALLING AND MAINTAINING THE CAMERAS TO THE SATISFACTION OF THE ENGINEER AND THE AGENCY RESPONSIBLE FOR THE CAMERAS.

THE CONTRACTOR SHALL RELOCATE THE EXISTING EMERGENCY VEHICLE PRIORITY SYSTEM EQUIPMENTS TO THE NEW TRAFFIC SIGNAL INSTALLATION AT ILL. RTE. 53 (ROHLWING RD.) & MEDINAH DR./SPRING LAKE DR.

THE FOLLOWING ITEMS SHALL BE REMOVED BY THE CONTRACTOR AND SHALL BE DISPOSED OF BY THEM OUTSIDE THE RIGHT-OF-WAY AT THEIR EXPENSE. THE SALVAGE VALUE OF THE REMOVED EQUIPMENT SHALL BE REFLECTED IN THE CONTRACTOR'S BID PRICE.

- 1 EACH WOOD POLE
- 245 FOOT SPAN WIRE
- 245 FOOT TETHER WIRE
- 1 LSUM AERIAL ELECTRIC CABLES

NOTE 1: THE VIDEO DETECTION ZONES SHOWN ON THE PLANS ARE FOR CONSTRUCTION STAGE 1 - YEAR 2 AND SHALL BE REDEFINED FOR EACH CONSTRUCTION STAGE AS A PART OF "TEMPORARY TRAFFIC SIGNAL INSTALLATION" WORK.

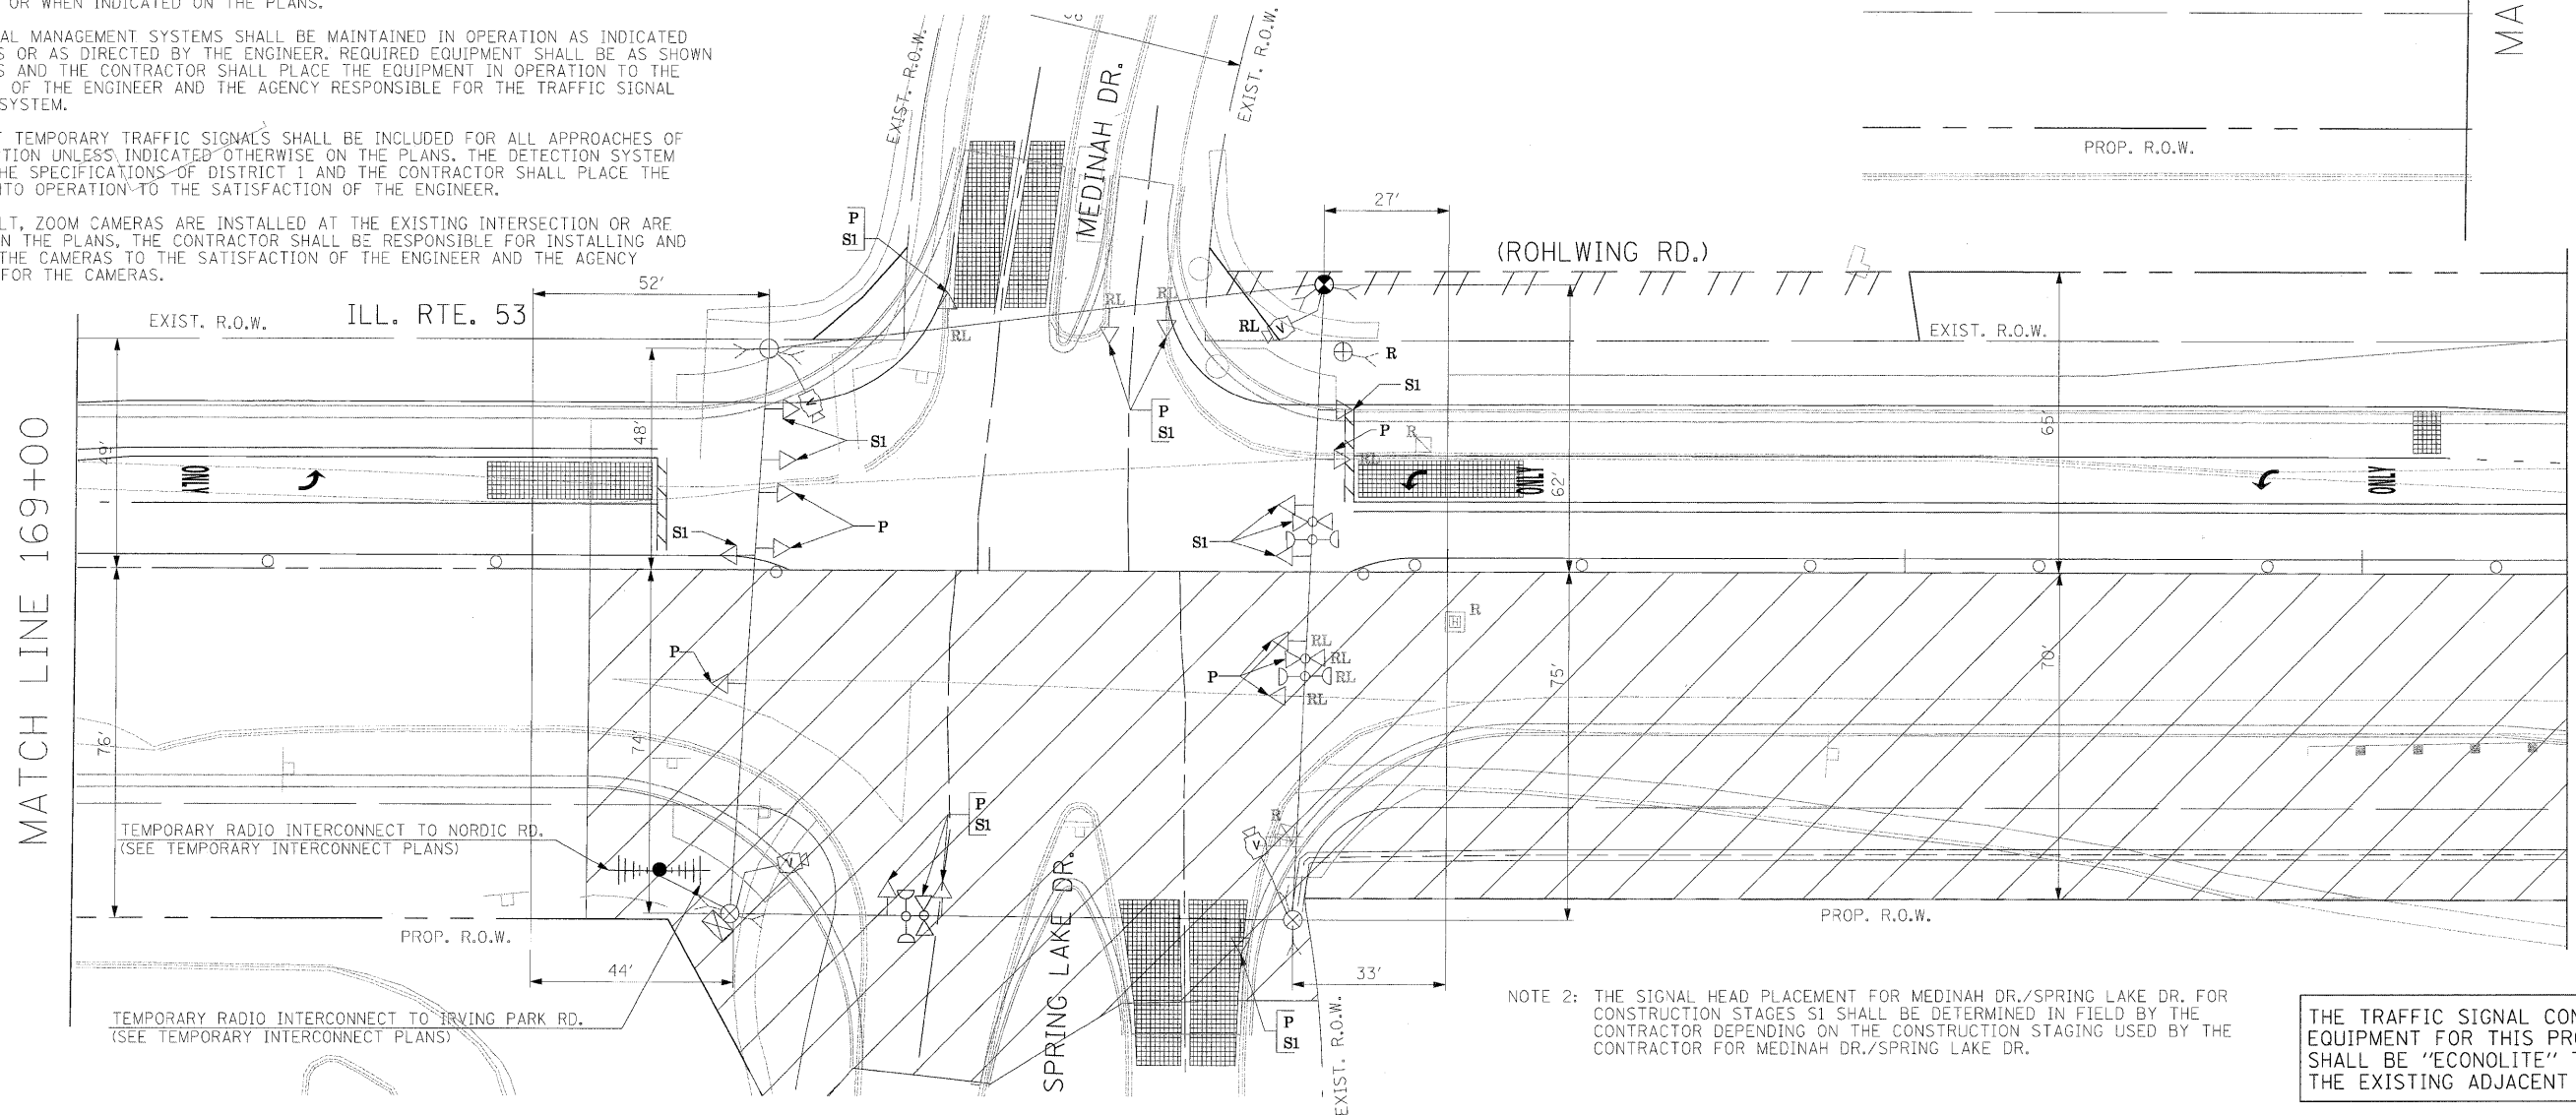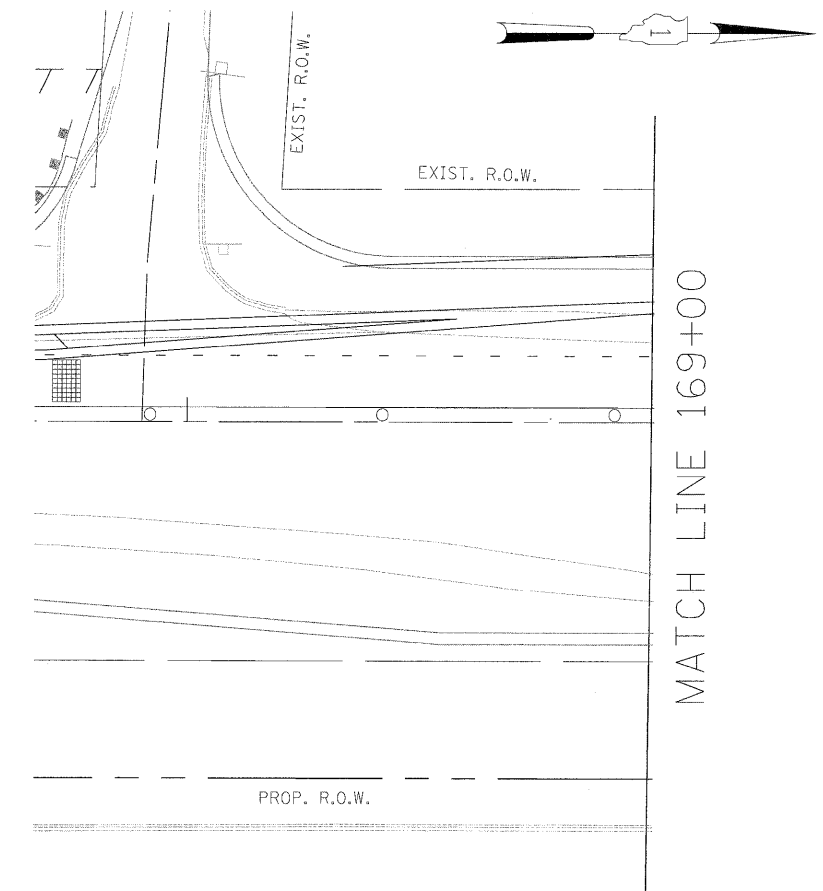


NOTE 2: THE SIGNAL HEAD PLACEMENT FOR MEDINAH DR./SPRING LAKE DR. FOR CONSTRUCTION STAGES S1 SHALL BE DETERMINED IN FIELD BY THE CONTRACTOR DEPENDING ON THE CONSTRUCTION STAGING USED BY THE CONTRACTOR FOR MEDINAH DR./SPRING LAKE DR.


THE TRAFFIC SIGNAL CONTROL EQUIPMENT FOR THIS PROJECT SHALL BE "ECONOLITE" TO MATCH THE EXISTING ADJACENT SYSTEM.

MATCH LINE 174+45
(SEE TEMPORARY CABLE PLAN SHT. 3 OF 3)

| | | | | | | | | | | | | | | | |
|-------------|----------------------|------------|-----------|-----------|--|---|--|------|--------|-----|---|---------|--------|--------------|-----------|
| FILE NAME = | USER NAME = #USER# | DESIGNED - | PKG | REVISED - | | STATE OF ILLINOIS DEPARTMENT OF TRANSPORTATION | EXISTING TEMPORARY TRAFFIC SIGNAL, MODIFICATION PLAN, AND REMOVAL PLAN ILLINOIS ROUTE 53 (ROHLWING RD.) AT MEDINAH DR./SPRING LAKE DR. PRE-STAGE AND STAGE 1 (SHEET 1 OF 3) | | | | F.A.P. RTE. | SECTION | COUNTY | TOTAL SHEETS | SHEET NO. |
| #FILE# | | DRAWN - | MAA, EA | REVISED - | | | 2578 | 532B | DuPage | 781 | 472 | | | | |
| | PLOT SCALE = #SCALE# | CHECKED - | PKG, EA | REVISED - | | | | | | | CONTRACT NO. 60477 | | | | |
| | PLOT DATE = #DATE# | DATE - | 5/10/2010 | REVISED - | | | | | | | FED. ROAD DIST. NO. ILLINOIS FED. AID PROJECT | | | | |

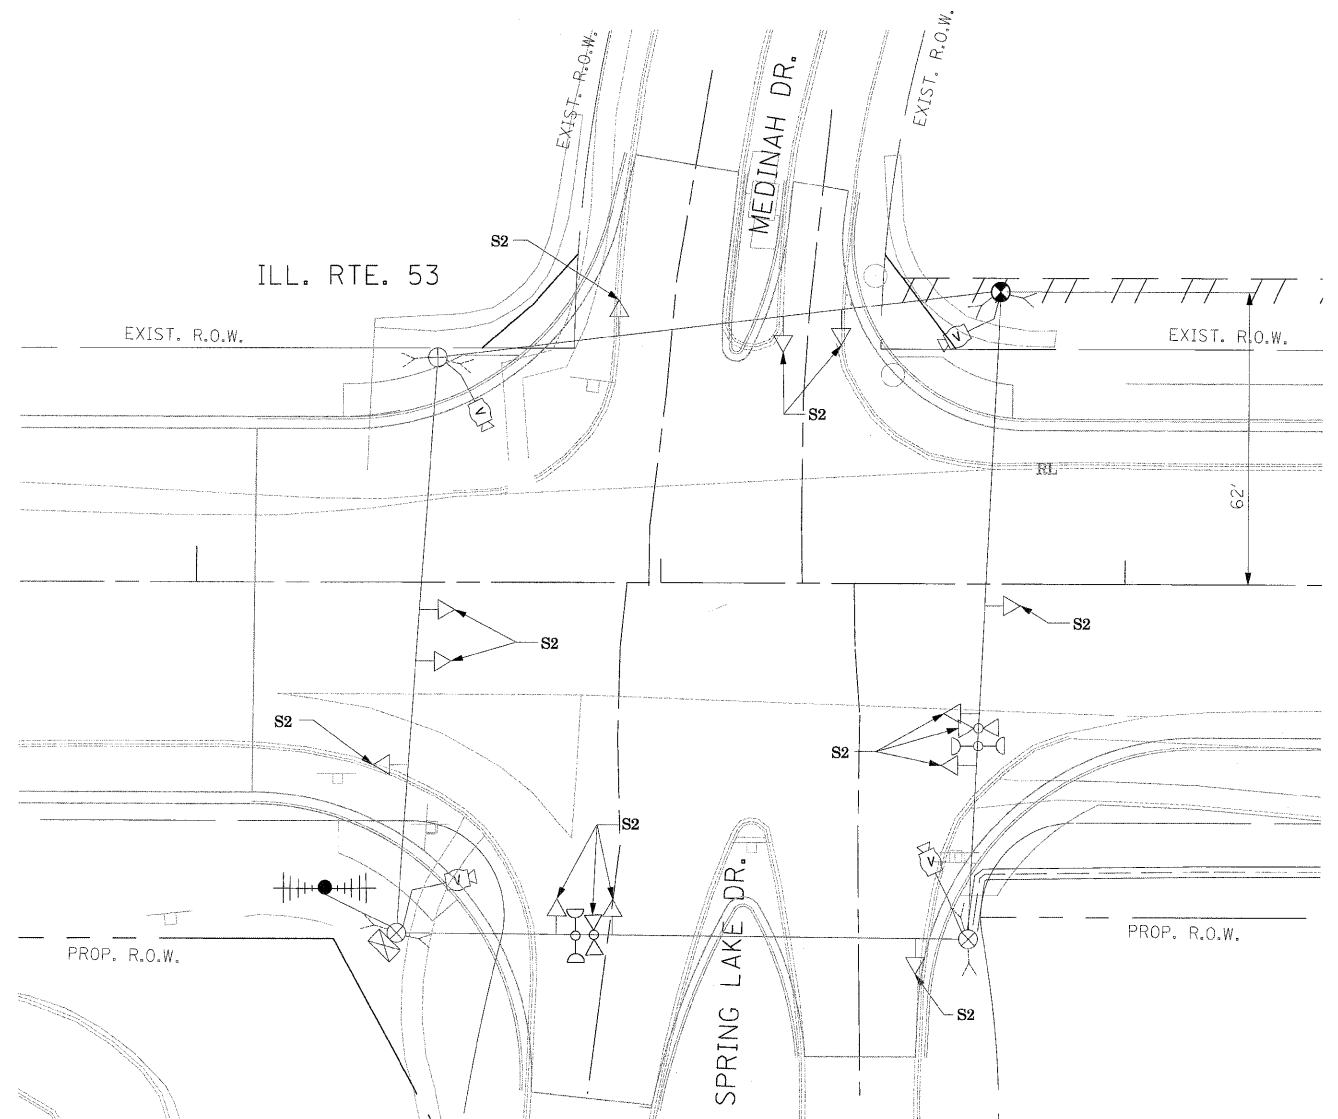

SIGNAL HEAD PLACEMENTS FOR
STAGE: S2

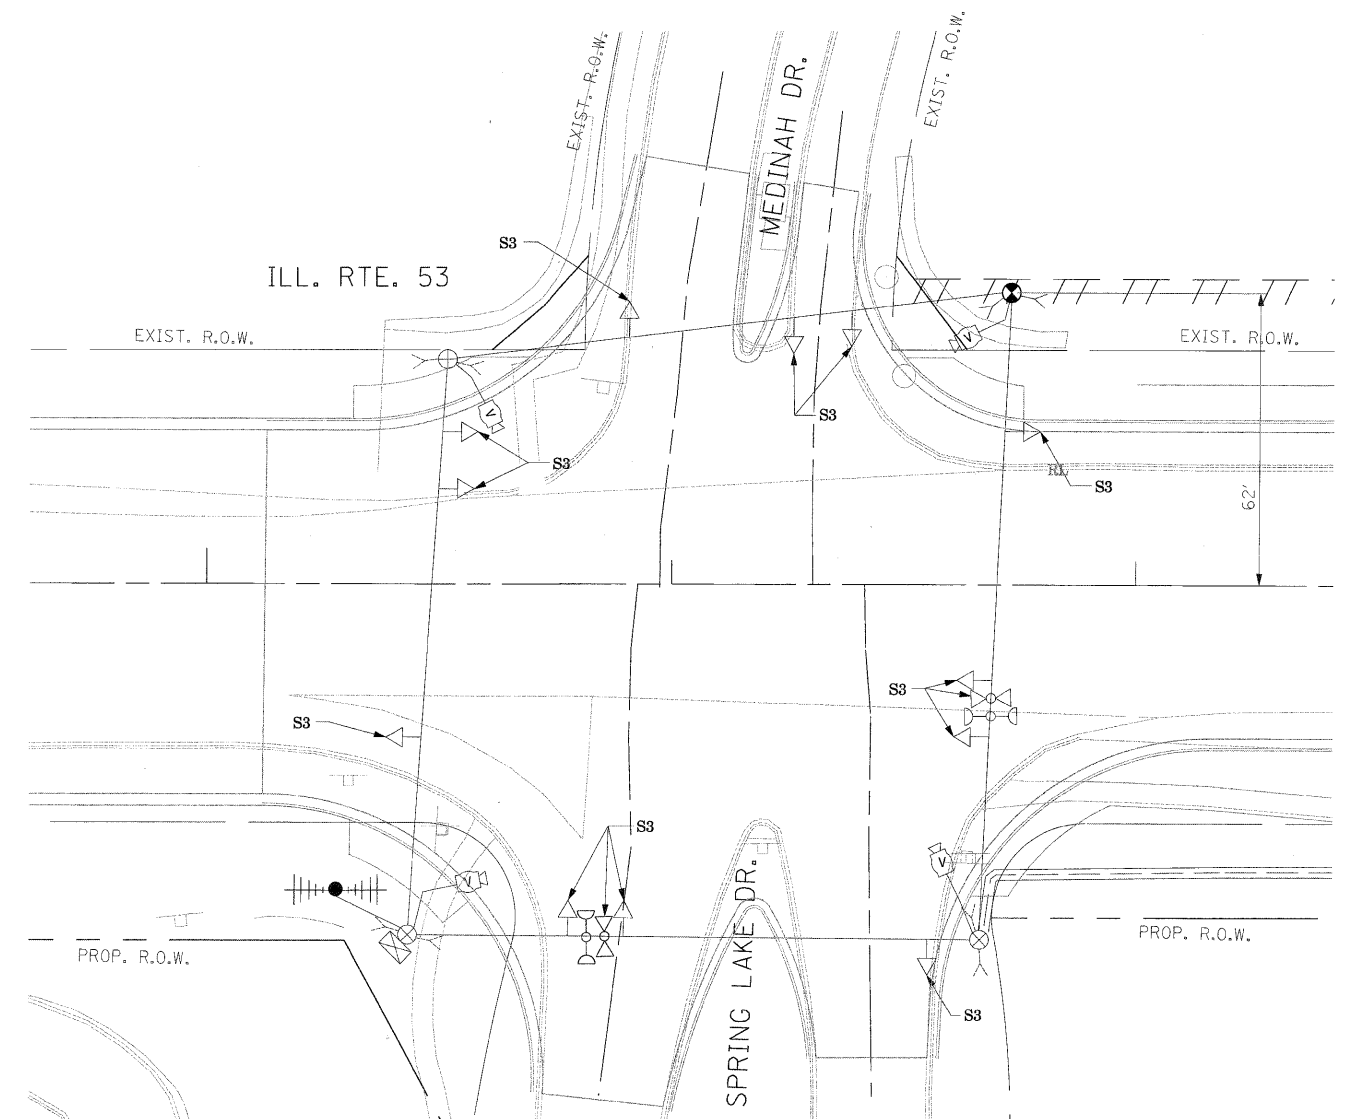

SIGNAL HEAD PLACEMENTS FOR
STAGE: S3

NOTE 1: THE VIDEO DETECTION ZONES SHOWN ON THE PLANS ARE FOR CONSTRUCTION STAGE 1 - YEAR 2 AND SHALL BE REDEFINED FOR EACH CONSTRUCTION STAGE AS A PART OF "TEMPORARY TRAFFIC SIGNAL INSTALLATION" WORK.

NOTE 2: THE SIGNAL HEAD PLACEMENT FOR MEDINAH/SPRING LAKE DRIVE FOR CONSTRUCTION STAGES S2 AND S3 SHALL BE DETERMINED IN FIELD BY THE CONTRACTOR DEPENDING ON THE CONSTRUCTION STAGING USED BY THE CONTRACTOR FOR MEDINAH/SPRING LAKE DRIVE.

THE TRAFFIC SIGNAL CONTROL EQUIPMENT FOR THIS PROJECT SHALL BE "ECONOLITE" TO MATCH THE EXISTING ADJACENT SYSTEM.


| | | | |
|-----------------------|--------------------|-------------------|-----------|
| FILE NAME = #FILE# | USER NAME = #USER# | DESIGNED - PKG | REVISED - |
| | | DRAWN - MAA, EA | REVISED - |
| | | CHECKED - PKG, EA | REVISED - |
| | | DATE - 5/10/2010 | REVISED - |

**STATE OF ILLINOIS
DEPARTMENT OF TRANSPORTATION**

| | | | |
|---|-----------|-----------|--------------|
| EXISTING TEMPORARY TRAFFIC SIGNAL, MODIFICATION PLAN, AND REMOVAL PLAN | | | |
| ILLINOIS ROUTE 53 (ROHLWING RD.) AT MEDINAH DR./SPRING LAKE DR. | | | |
| STAGE 2 AND STAGE 3 (SHEET 2 OF 3) | | | |
| SCALE: 1"=20' | SHEET NO. | OF SHEETS | STA. TO STA. |

| | | | | |
|--------------------------------|--------------|---------------|------------------|---------------|
| F.A.P. RTE. 2578 | SECTION 532B | COUNTY DuPage | TOTAL SHEETS 781 | SHEET NO. 473 |
| FED. ROAD DIST. NO. - ILLINOIS | | | FED. AID PROJECT | |
| CONTRACT NO. 60477 | | | | |


CONTROLLER SEQUENCE

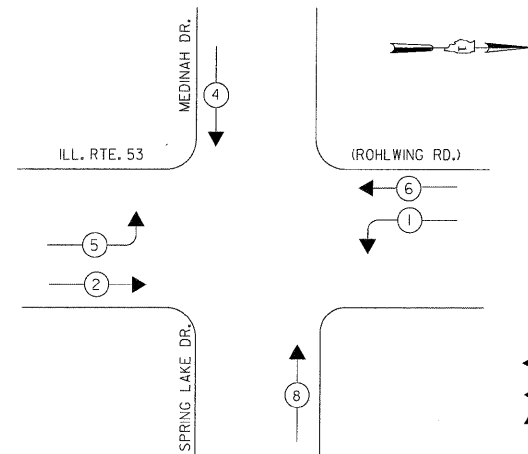

- LEGEND**
- ← * → DUAL ENTRY PHASE
 - ← * → SINGLE ENTRY PHASE
 - ◊ O.L. OVERLAP
 - ← * → PEDESTRIAN PHASE
 - * NUMBER REFERS TO ASSOCIATED PHASE


TEMPORARY PHASE DESIGNATION DIAGRAM
STAGES: PRE-STAGE, S1, S2, AND S3

EMERGENCY VEHICLE PREEMPTION SEQUENCE

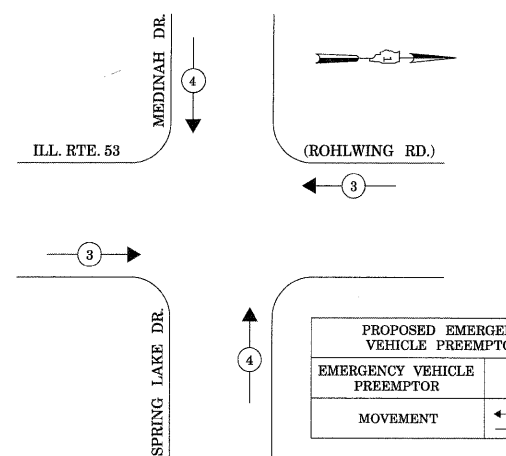

| PROPOSED EMERGENCY VEHICLE PREEMPTORS | | |
|---------------------------------------|-----|-----|
| EMERGENCY VEHICLE PREEMPTOR | 3 | 4 |
| MOVEMENT | ← → | ↑ ↓ |


STAGES: PRE-STAGE, S1, S2, AND S3

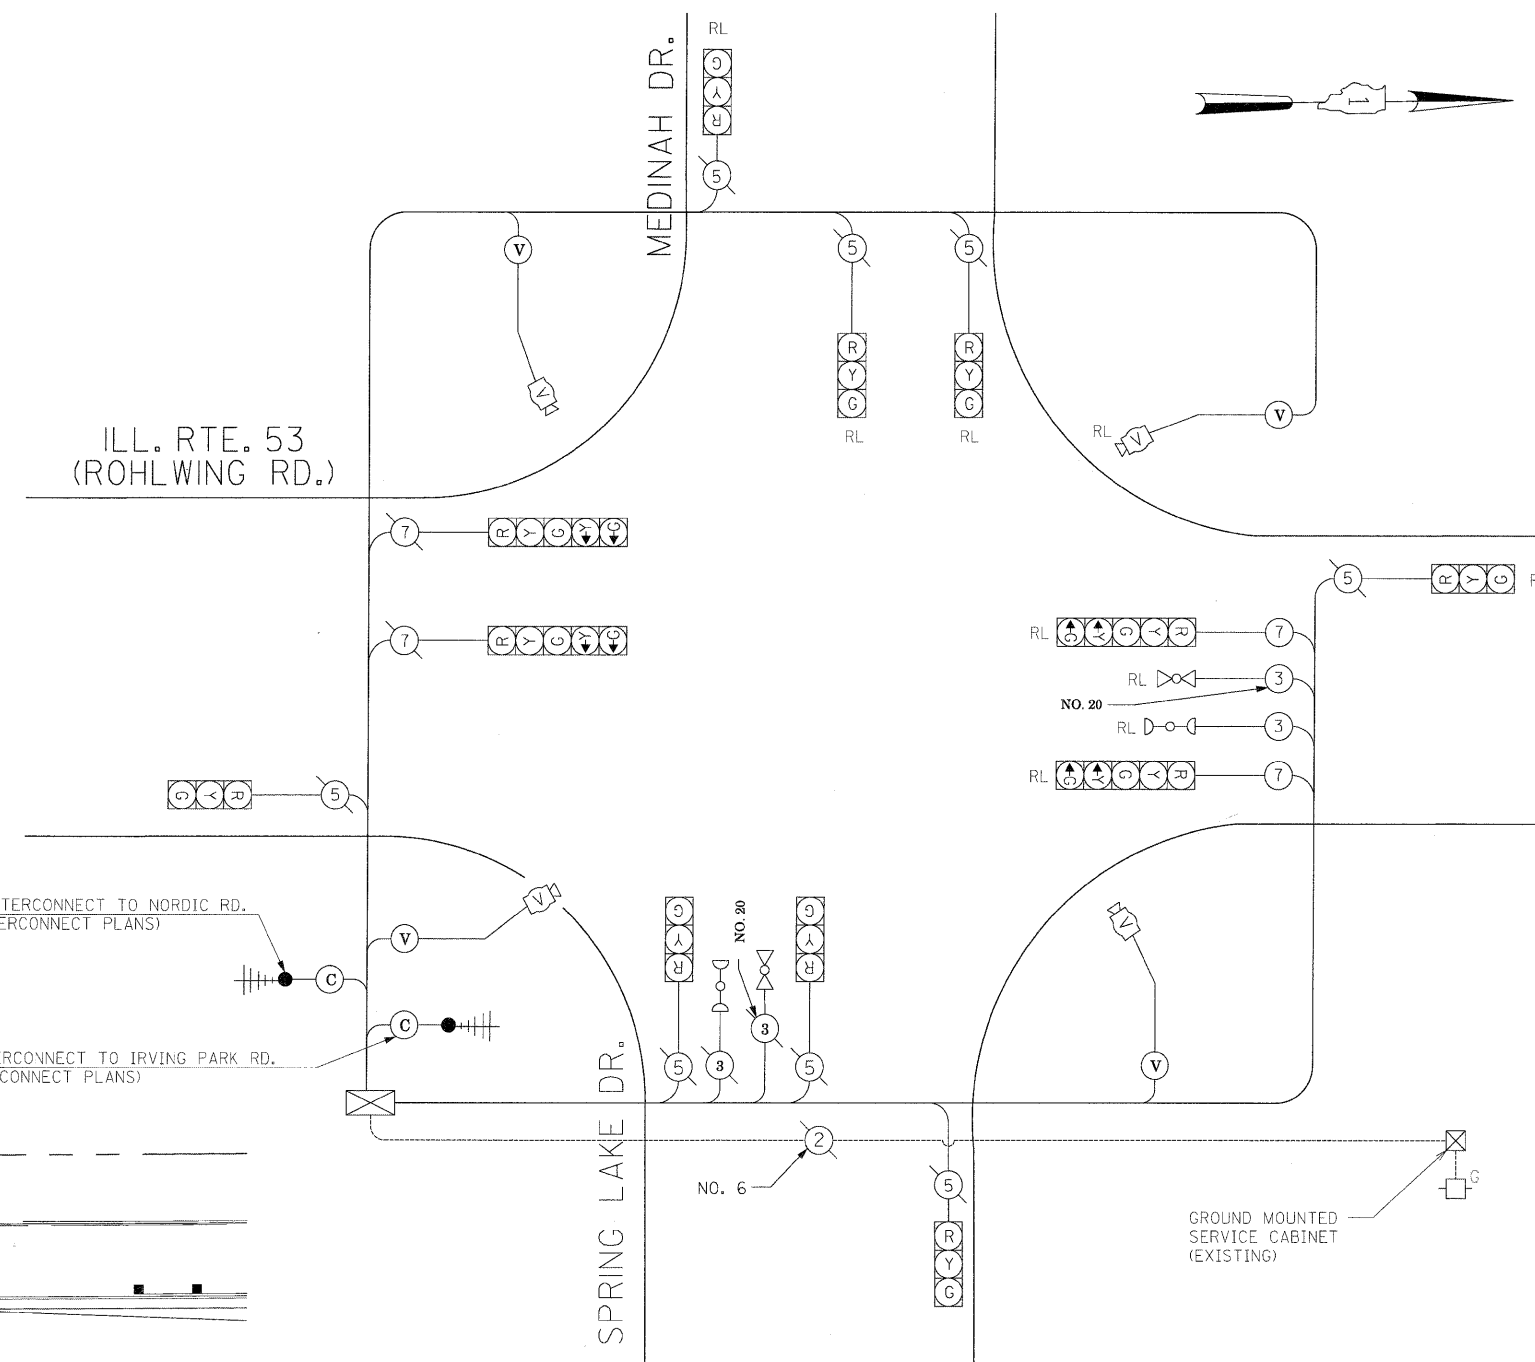

TEMPORARY CABLE PLAN

(NOT TO SCALE)

MATCH LINE 174+45
(SEE TEMPORARY INTERSECTION PLAN SHT. 1 OF 3)

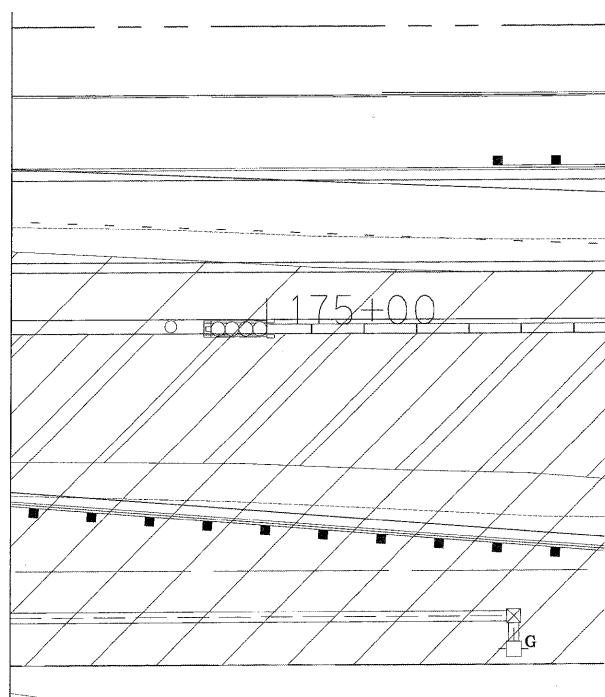

THE TRAFFIC SIGNAL CONTROL EQUIPMENT FOR THIS PROJECT SHALL BE "ECONOLITE" TO MATCH THE EXISTING ADJACENT SYSTEM.

| I.D.O.T. TRAFFIC SIGNAL INSTALLATION ELECTRICAL SERVICE REQUIREMENTS | | | | | TOTAL WATTAGE |
|--|----------|---------|-----|-----------|---------------|
| TYPE | NO LAMPS | WATTAGE | | OPERATION | |
| SIGNAL (RED) | 12 | 135 | 17 | 0.50 | 102 |
| (YELLOW) | 12 | 135 | 25 | 0.25 | 75 |
| (GREEN) | 12 | 135 | 15 | 0.25 | 45 |
| ARROW | 8 | 135 | 12 | 0.10 | 9.6 |
| PED. SIGNAL | 8 | 90 | 25 | 1.00 | 9.6 |
| CONTROLLER | 1 | 100 | 100 | 1.00 | 100 |
| ILLUM. SIGN | | | 25 | 0.05 | |
| VIDEO SYSTEM | 1 | 150 | | 1.00 | 150 |
| FLASHER | | | | 0.50 | |
| ENERGY COSTS TO: | | | | | TOTAL = 481.6 |

ILLINOIS DEPARTMENT OF TRANSPORTATION
201 WEST CENTER COURT
SCHAMBURG, ILLINOIS 60196-1096
ENERGY SUPPLY CONTACT: CURTIS TOPPS
PHONE: (630) 691-4356
COMPANY: COMMONWEALTH EDISON

| | | | |
|-------------|----------------------|-------------------|-----------|
| FILE NAME = | USER NAME = #USER# | DESIGNED - PKG | REVISED - |
| #FILEL# | | DRAWN - MAA, EA | REVISED - |
| | PLOT SCALE = #SCALE# | CHECKED - PKG, EA | REVISED - |
| | PLOT DATE = #DATE# | DATE - 5/10/2010 | REVISED - |

STATE OF ILLINOIS
DEPARTMENT OF TRANSPORTATION


TEMPORARY CABLE PLAN, TEMPORARY PHASE DESIGNATION DIAGRAM
TEMPORARY EMERGENCY VEHICLE PREEMPTION SEQUENCE
ILLINOIS ROUTE 53 (ROHLWING RD.) AT MEDINAH DR. (SPRING LAKE DR.)
PRE STAGE, STAGE 1, STAGE 2, AND STAGE 3 (SHEET 3 OF 3)

| | | | | |
|---|---------|--------|--------------------|-----------|
| F.A.P. RTE. | SECTION | COUNTY | TOTAL SHEETS | SHEET NO. |
| 2578 | 532B | DuPage | 781 | 474 |
| FED. ROAD DIST. NO. - ILLINOIS FED. AID PROJECT | | | CONTRACT NO. 60477 | |

SCHEDULE OF QUANTITIES

| QUANTITY | UNIT | ITEM |
|----------|-------|---|
| 36 | SQ FT | SIGN PANEL - TYPE 1 |
| 30 | SQ FT | SIGN PANEL - TYPE 2 |
| 871 | FOOT | CONDUIT IN TRENCH, 2" DIA., GALVANIZED STEEL |
| 16 | FOOT | CONDUIT IN TRENCH, 2 1/2" DIA., GALVANIZED STEEL |
| 87 | FOOT | CONDUIT IN TRENCH, 3" DIA., GALVANIZED STEEL |
| 45 | FOOT | CONDUIT IN TRENCH, 4" DIA., GALVANIZED STEEL |
| 130 | FOOT | CONDUIT PUSHED, 2" DIA., GALVANIZED STEEL |
| 478 | FOOT | CONDUIT PUSHED, 4" DIA., GALVANIZED STEEL |
| 4 | EACH | HANDHOLE |
| 2 | EACH | HEAVY-DUTY HANDHOLE |
| 2 | EACH | DOUBLE HANDHOLE |
| 988 | FOOT | TRENCH AND BACKFILL FOR ELECTRICAL WORK |
| 1 | EACH | FULL-ACTUATED CONTROLLER AND TYPE IV CABINET, SPECIAL |
| 1 | EACH | TRANSCEIVER-FIBER OPTIC |
| 1493 | FOOT | ELECTRIC CABLE IN CONDUIT, SIGNAL NO. 14 2C |
| 1948 | FOOT | ELECTRIC CABLE IN CONDUIT, SIGNAL NO. 14 3C |
| 2215 | FOOT | ELECTRIC CABLE IN CONDUIT, SIGNAL NO. 14 5C |
| 879 | FOOT | ELECTRIC CABLE IN CONDUIT, SIGNAL NO. 14 7C |
| 2296 | FOOT | ELECTRIC CABLE IN CONDUIT, LEAD-IN, NO. 14 1 PAIR |
| 398 | FOOT | ELECTRIC CABLE IN CONDUIT, SERVICE, NO. 6 2C |
| 1 | EACH | TRAFFIC SIGNAL POST, GALVANIZED STEEL 14 FT. |
| 1 | EACH | TRAFFIC SIGNAL POST, GALVANIZED STEEL 16 FT. |
| 1 | EACH | STEEL MAST ARM ASSEMBLY AND POLE, 38 FT. |
| 1 | EACH | STEEL MAST ARM ASSEMBLY AND POLE, 40 FT. |
| 1 | EACH | STEEL MAST ARM ASSEMBLY AND POLE, 44 FT. |
| 1 | EACH | STEEL MAST ARM ASSEMBLY AND POLE, 54 FT. |
| 8 | FOOT | CONCRETE FOUNDATION, TYPE A |
| 4 | FOOT | CONCRETE FOUNDATION, TYPE C |
| 60 | FOOT | CONCRETE FOUNDATION, TYPE E 36-INCH DIAMETER |
| 2 | EACH | SIGNAL HEAD, LED, 1-FACE, 3-SECTION, BRACKET MOUNTED |
| 8 | EACH | SIGNAL HEAD, LED, 1-FACE, 3-SECTION, MAST ARM MOUNTED |
| 2 | EACH | SIGNAL HEAD, LED, 1-FACE, 5 SECTION, BRACKET MOUNTED |
| 2 | EACH | SIGNAL HEAD, LED, 1-FACE, 5-SECTION, MAST ARM MOUNTED |
| 4 | EACH | PEDESTRIAN SIGNAL HEAD, LED, 2-FACE, BRACKET MOUNTED WITH COUNTDOWN TIMER |
| 10 | EACH | TRAFFIC SIGNAL BACKPLATE, LOUVERED, ALUMINUM |
| 9 | EACH | INDUCTIVE LOOP DETECTOR |
| 44 | FOOT | DETECTOR LOOP, TYPE 1 |
| 8 | EACH | PEDESTRIAN PUSH-BUTTON |
| 2 | EACH | RELOCATE EXISTING EMERGENCY VEHICLE PRIORITY SYSTEM, DETECTOR UNIT |
| 1 | EACH | RELOCATE EXISTING EMERGENCY VEHICLE PRIORITY SYSTEM, PHASING UNIT |
| 3 | EACH | REMOVE EXISTING HANDHOLE |
| 1 | EACH | REMOVE TEMPORARY TRAFFIC SIGNAL INSTALLATION |
| 1101 | FOOT | PERFORMED DETECTOR LOOP |
| 1 | EACH | TEMPORARY TRAFFIC SIGNAL TIMING |
| 1 | EACH | SERVICE INSTALLATION - GROUND MOUNTED |
| 1 | EACH | UNINTERRUPTIBLE POWER SUPPLY |
| 1007 | FOOT | ELECTRIC CABLE IN CONDUIT, GROUNDING, NO. 6 1C |
| 399 | FOOT | ELECTRIC CABLE IN CONDUIT NO. 20 3/C, TWISTED, SHIELDED |
| 1 | EACH | MODIFY TEMPORARY TRAFFIC SIGNAL INSTALLATION |

* 100% COST TO VILLAGE OF ITASCA

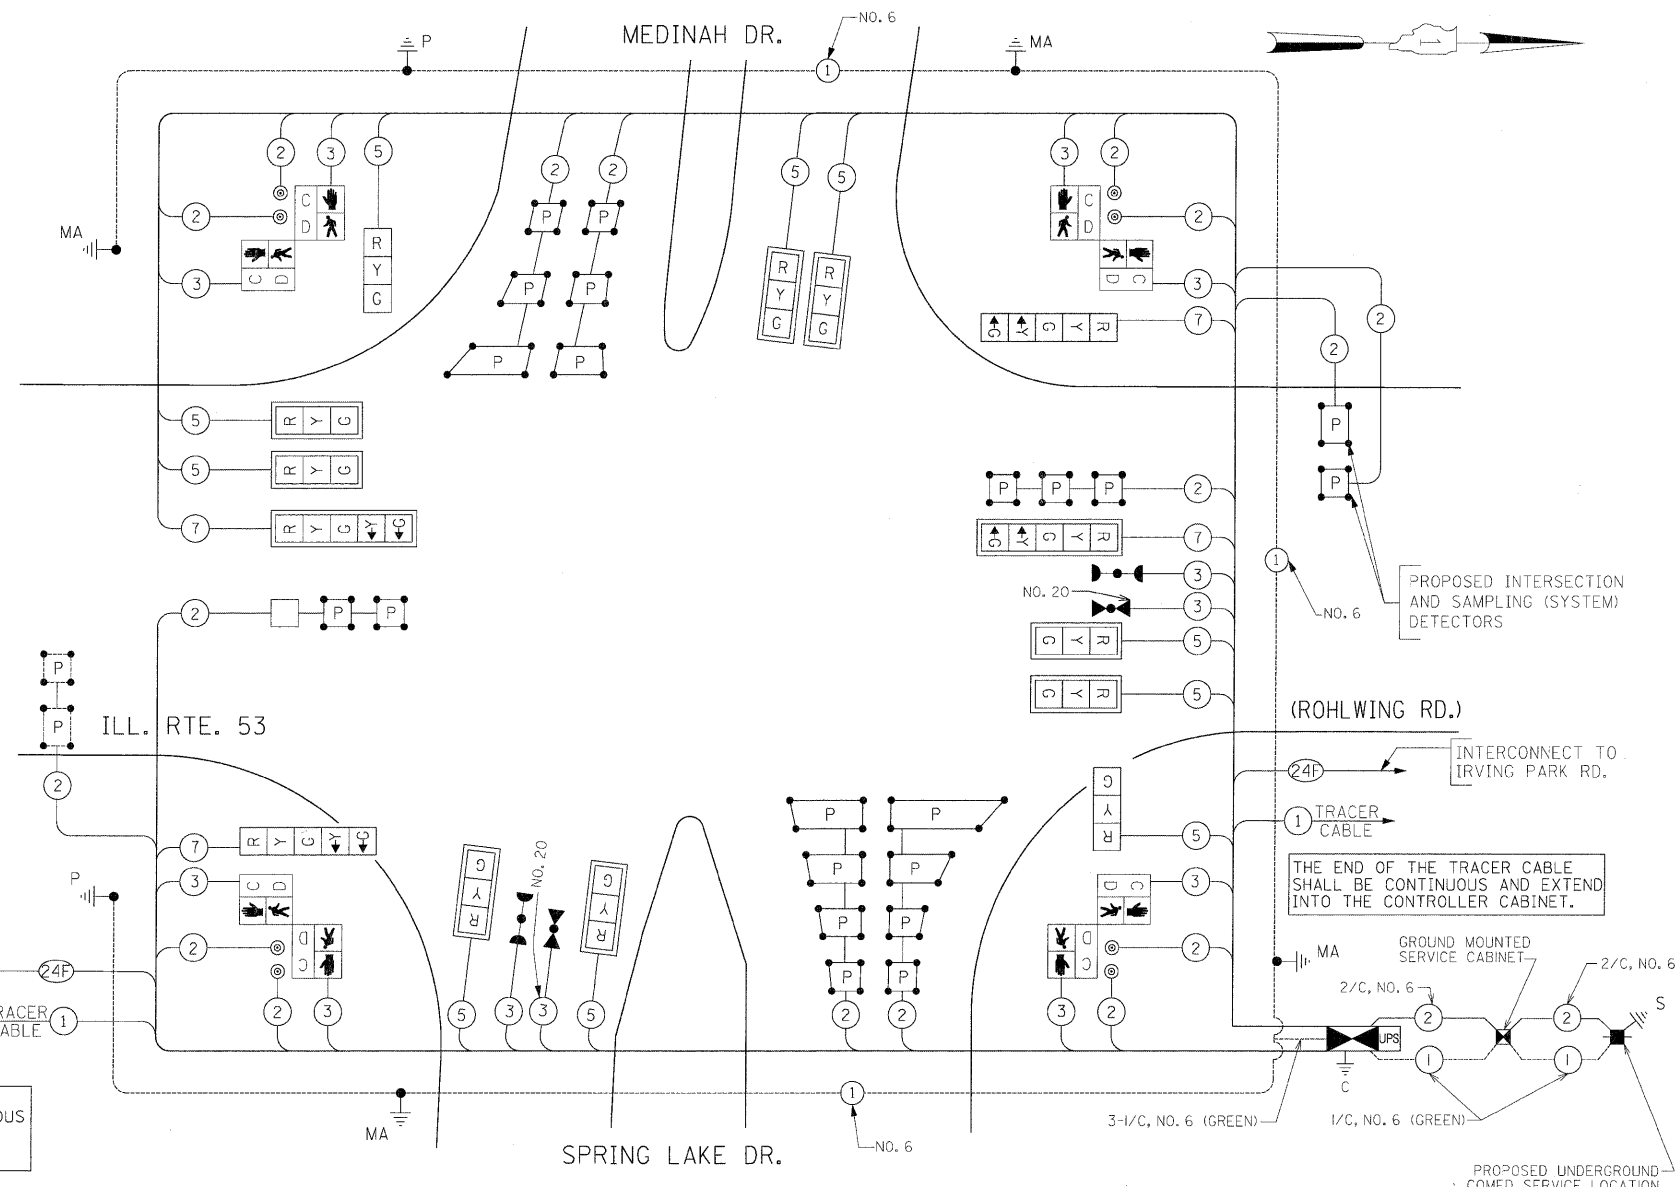


CABLE PLAN

(NOT TO SCALE)


THE CONTRACTOR SHALL RELOCATE THE EXISTING EMERGENCY VEHICLE PRIORITY SYSTEM EQUIPMENTS TO THE NEW TRAFFIC SIGNAL INSTALLATION AT ILL. RTE. 53 (ROHLWING RD.) & MEDINAH DR./SPRING LAKE DR.

CONTROLLER SEQUENCE

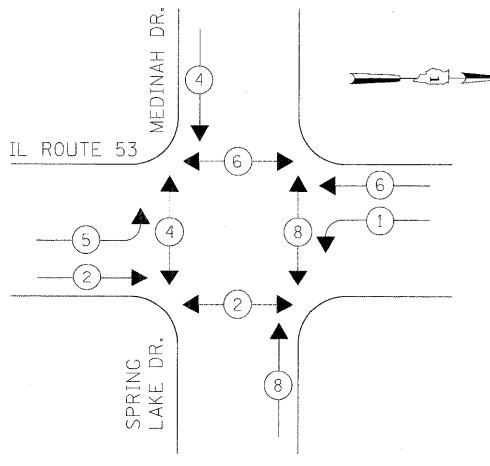

PHASE DESIGNATION DIAGRAM

EMERGENCY VEHICLE PREEMPTION SEQUENCE

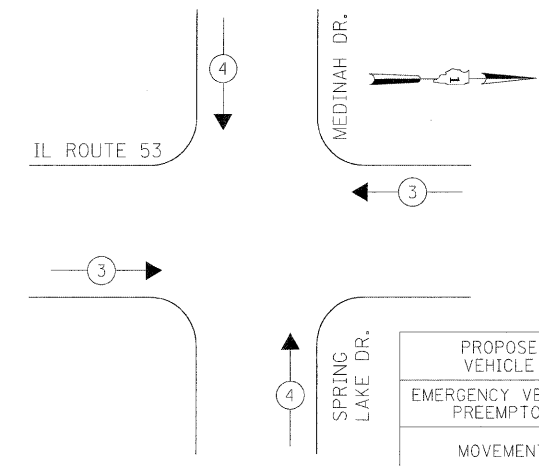

THE TRAFFIC SIGNAL CONTROL EQUIPMENT FOR THIS PROJECT SHALL BE "ECONOLITE" TO MATCH THE EXISTING ADJACENT SYSTEM.

| I.D.O.T. TRAFFIC SIGNAL INSTALLATION ELECTRICAL SERVICE REQUIREMENTS | | | | | TOTAL WATTAGE |
|--|----------|---------|-----------|---------|---------------|
| TYPE | NO LAMPS | WATTAGE | OPERATION | | |
| SIGNAL (RED) | 14 | 135 | 17 | 0.50 | 119.0 |
| | 14 | 135 | 25 | 0.25 | 87.5 |
| | 14 | 135 | 15 | 0.25 | 52.5 |
| ARROW | 8 | 135 | 12 | 0.10 | 9.6 |
| PED. SIGNAL | 8 | 90 | 25 | 1.00 | 200 |
| CONTROLLER | 1 | 100 | 100 | 1.00 | 100 |
| ILLUM. SIGN | | | 25 | 0.05 | |
| FLASHER | | | | 0.50 | |
| ENERGY COSTS TO: | | | | TOTAL = | 568.6 |

ILLINOIS DEPARTMENT OF TRANSPORTATION
201 WEST CENTER COURT
SCHAUMBURG, ILLINOIS 60196-1096
ENERGY SUPPLY CONTACT: CURTIS TOPPS
PHONE: (630) 691-4356
COMPANY: COMMONWEALTH EDISON

NOTES FOR TEMPORARY TRAFFIC SIGNALS

1. ALL CONTROL EQUIPMENT INCLUDING EMERGENCY PRE-EMPTION AND COMMUNICATION DEVICES FOR THE TEMPORARY TRAFFIC SIGNAL(S) SHALL BE FURNISHED BY THE CONTRACTOR.
2. ONLY CONTROLLERS SUPPLIED BY ONE OF THE DISTRICT APPROVED CLOSED LOOP EQUIPMENT MANUFACTURERS WILL BE APPROVED FOR USE AT TEMPORARY SIGNAL LOCATIONS. ALL CONTROLLERS USED FOR TEMPORARY TRAFFIC SIGNALS SHALL BE FULLY ACTUATED NEMA MICROPROCESSOR BASED WITH RS232 DATA ENTRY PORTS COMPATIBLE WITH EXISTING MONITORING SOFTWARE APPROVED BY IDOT DISTRICT 1, INSTALLED IN A NEMA TS2 CABINET. ONLY ONE BRAND OF CONTROLLER WILL BE ACCEPTED FOR ANY ONE CONTRACT.
3. ALL TRAFFIC SIGNAL SECTIONS AND PEDESTRIAN SIGNAL SECTIONS SHALL BE LED AND 12" (300mm) DIAMETER. HEADS SHALL BE PLACED AS INDICATED ON THE TEMPORARY TRAFFIC SIGNAL PLAN OR AS DIRECTED BY THE ENGINEER. PEDESTRIAN SIGNALS SHALL INCLUDE SOLID INTERNATIONAL SYMBOLS. PEDESTRIAN SIGNALS WITH COUNTDOWN TIMERS SHALL BE USED WHEN THE EXISTING INSTALLATION UTILIZES COUNTDOWN TYPE OR AS DIRECTED BY THE ENGINEER. COUNTDOWN TYPE PEDESTRIAN SIGNALS ARE NOT TO BE INSTALLED AT A RAILROAD INTERSECTION. THE CONTRACTOR SHALL FURNISH ENOUGH CABLE SLACK TO RELOCATE HEADS TO ANY POSITION ON THE SPAN WIRE OR AT LOCATIONS ILLUSTRATED ON THE PLANS FOR CONSTRUCTION STAGING. THE TEMPORARY TRAFFIC SIGNAL SHALL REMAIN IN OPERATION DURING ALL SIGNAL HEAD RELOCATIONS. EACH TEMPORARY TRAFFIC SIGNAL HEAD SHALL HAVE ITS OWN CABLE FROM THE CONTROLLER CABINET TO THE SIGNAL HEAD.
4. ALL EXISTING STREET NAME AND INTERSECTION REGULATORY SIGNS SHALL BE REMOVED FROM EXISTING POLES, RELOCATED AND SECURELY FASTENED TO THE SPAN WIRE OR WOOD POLE AS DIRECTED BY THE ENGINEER.
5. ANY TEMPORARY SIGNAL WITHIN AN EXISTING CLOSED LOOP TRAFFIC SIGNAL SYSTEM SHALL BE INTERCONNECTED TO THAT SYSTEM USING SIMILAR BRAND CONTROL EQUIPMENT.
6. THE TEMPORARY TRAFFIC SIGNAL SHALL HAVE THE SIGNAL HEAD DISPLAYS, SIGNAL HEAD PLACEMENTS AND CONTROLLER PHASING MATCH THE EXISTING TRAFFIC SIGNAL, AT THE TIME OF THE TURN ON, IF NO TRAFFIC STAGING IS IN PLACE OR WILL NOT BE STAGED ON THE DAY OF THE TURN ON.
7. UNINTERRUPTIBLE POWER SUPPLY (UPS) SYSTEMS SHALL BE INSTALLED AND MADE OPERATIONAL AT TEMPORARY TRAFFIC SIGNAL INSTALLATIONS WHERE UPS IS INSTALLED AT THE EXISTING TRAFFIC SIGNAL, TEMPORARY TRAFFIC SIGNALS AT RAILROAD INTERSECTIONS, AND TEMPORARY TRAFFIC SIGNALS AT INTERSECTIONS WITH FIRE STATION ACTUATED EMERGENCY VEHICLE PRE-EMPTION, OR WHEN INDICATED ON THE PLANS.
8. TRAFFIC SIGNAL MANAGEMENT SYSTEMS SHALL BE MAINTAINED IN OPERATION AS INDICATED ON THE PLANS OR AS DIRECTED BY THE ENGINEER. REQUIRED EQUIPMENT SHALL BE AS SHOWN ON THE PLANS AND THE CONTRACTOR SHALL PLACE THE EQUIPMENT IN OPERATION TO THE SATISFACTION OF THE ENGINEER AND THE AGENCY RESPONSIBLE FOR THE TRAFFIC SIGNAL MANAGEMENT SYSTEM.
9. DETECTION AT TEMPORARY TRAFFIC SIGNALS SHALL BE INCLUDED FOR ALL APPROACHES OF THE INTERSECTION UNLESS INDICATED OTHERWISE ON THE PLANS. THE DETECTION SYSTEM MUST MEET THE SPECIFICATIONS OF DISTRICT 1 AND THE CONTRACTOR SHALL PLACE THE DETECTORS INTO OPERATION TO THE SATISFACTION OF THE ENGINEER.
10. WHEN PAN, TILT, ZOOM CAMERAS ARE INSTALLED AT THE EXISTING INTERSECTION OR ARE CALLED FOR IN THE PLANS, THE CONTRACTOR SHALL BE RESPONSIBLE FOR INSTALLING AND MAINTAINING THE CAMERAS TO THE SATISFACTION OF THE ENGINEER AND THE AGENCY RESPONSIBLE FOR THE CAMERAS.

THE FOLLOWING ITEMS SHALL BE REMOVED BY THE CONTRACTOR AND SHALL BE DISPOSED OF BY THEM OUTSIDE THE RIGHT-OF-WAY AT THEIR EXPENSE. THE SALVAGE VALUE OF THE REMOVED EQUIPMENT SHALL BE REFLECTED IN THE CONTRACTOR'S BID PRICE.

- 1 EACH CONTROLLER AND CABINET COMPLETE
- 2 EACH SIGNAL HEAD, 1-FACE 3-SECTION, BRACKET MOUNTED
- 2 EACH SIGNAL HEAD, 1-FACE 5-SECTION, BRACKET MOUNTED
- 4 EACH SIGNAL HEAD, 1-FACE 5-SECTION, MAST ARM MOUNTED
- 2 EACH SIGNAL HEAD, 2-FACE, 1-3 SECTION, 1-5 SECTION, BRACKET MOUNTED
- 2 EACH SIGNAL HEAD, 2-FACE 5-SECTION, BRACKET MOUNTED
- 4 EACH TRAFFIC SIGNAL BACKPLATE
- 4 EACH TRAFFIC SIGNAL POST
- 1 EACH STEEL MAST ARM ASSEMBLY AND POLE
- 3 EACH ALUMINUM MAST ARM ASSEMBLY AND POLE
- 1 EACH SERVICE INSTALLATION

NOTE: THE VIDEO DETECTION ZONES SHOWN ON THE PLANS ARE FOR CONSTRUCTION STAGE 1 - SUBSTAGE 1 AND SHALL BE REDEFINED FOR EACH CONSTRUCTION STAGE AS A PART OF "TEMPORARY TRAFFIC SIGNAL INSTALLATION" WORK.


Ⓐ
LEFT ON
GREEN
ARROW
ONLY

R10-5 SIGNS SHALL BE MOUNTED, ONE EACH ON SPAN WIRE AND FAR LEFT POLE FOR ALL APPROACHES OF THE INTERSECTION

R10-5,
24" X 30"
(8 REQUIRED)

THE CONTRACTOR SHALL RELOCATE THE EXISTING EMERGENCY VEHICLE PRIORITY SYSTEM EQUIPMENTS TO THE NEW TRAFFIC SIGNAL INSTALLATION AT ILL. RTE. 53 (ROHLWING RD.) & ILL. RTE. 19 (IRVING PARK RD.) THE EXISTING LIGHT DETECTORS ARE SEPARATED AND SHALL BE DIVIDED, INCLUDING THE CONFIRMATION BEACONS, FOR MOUNTING AS PROPOSED IN THE PLANS FOR NEW SIGNAL PHASING.

MATCH LINE "B"

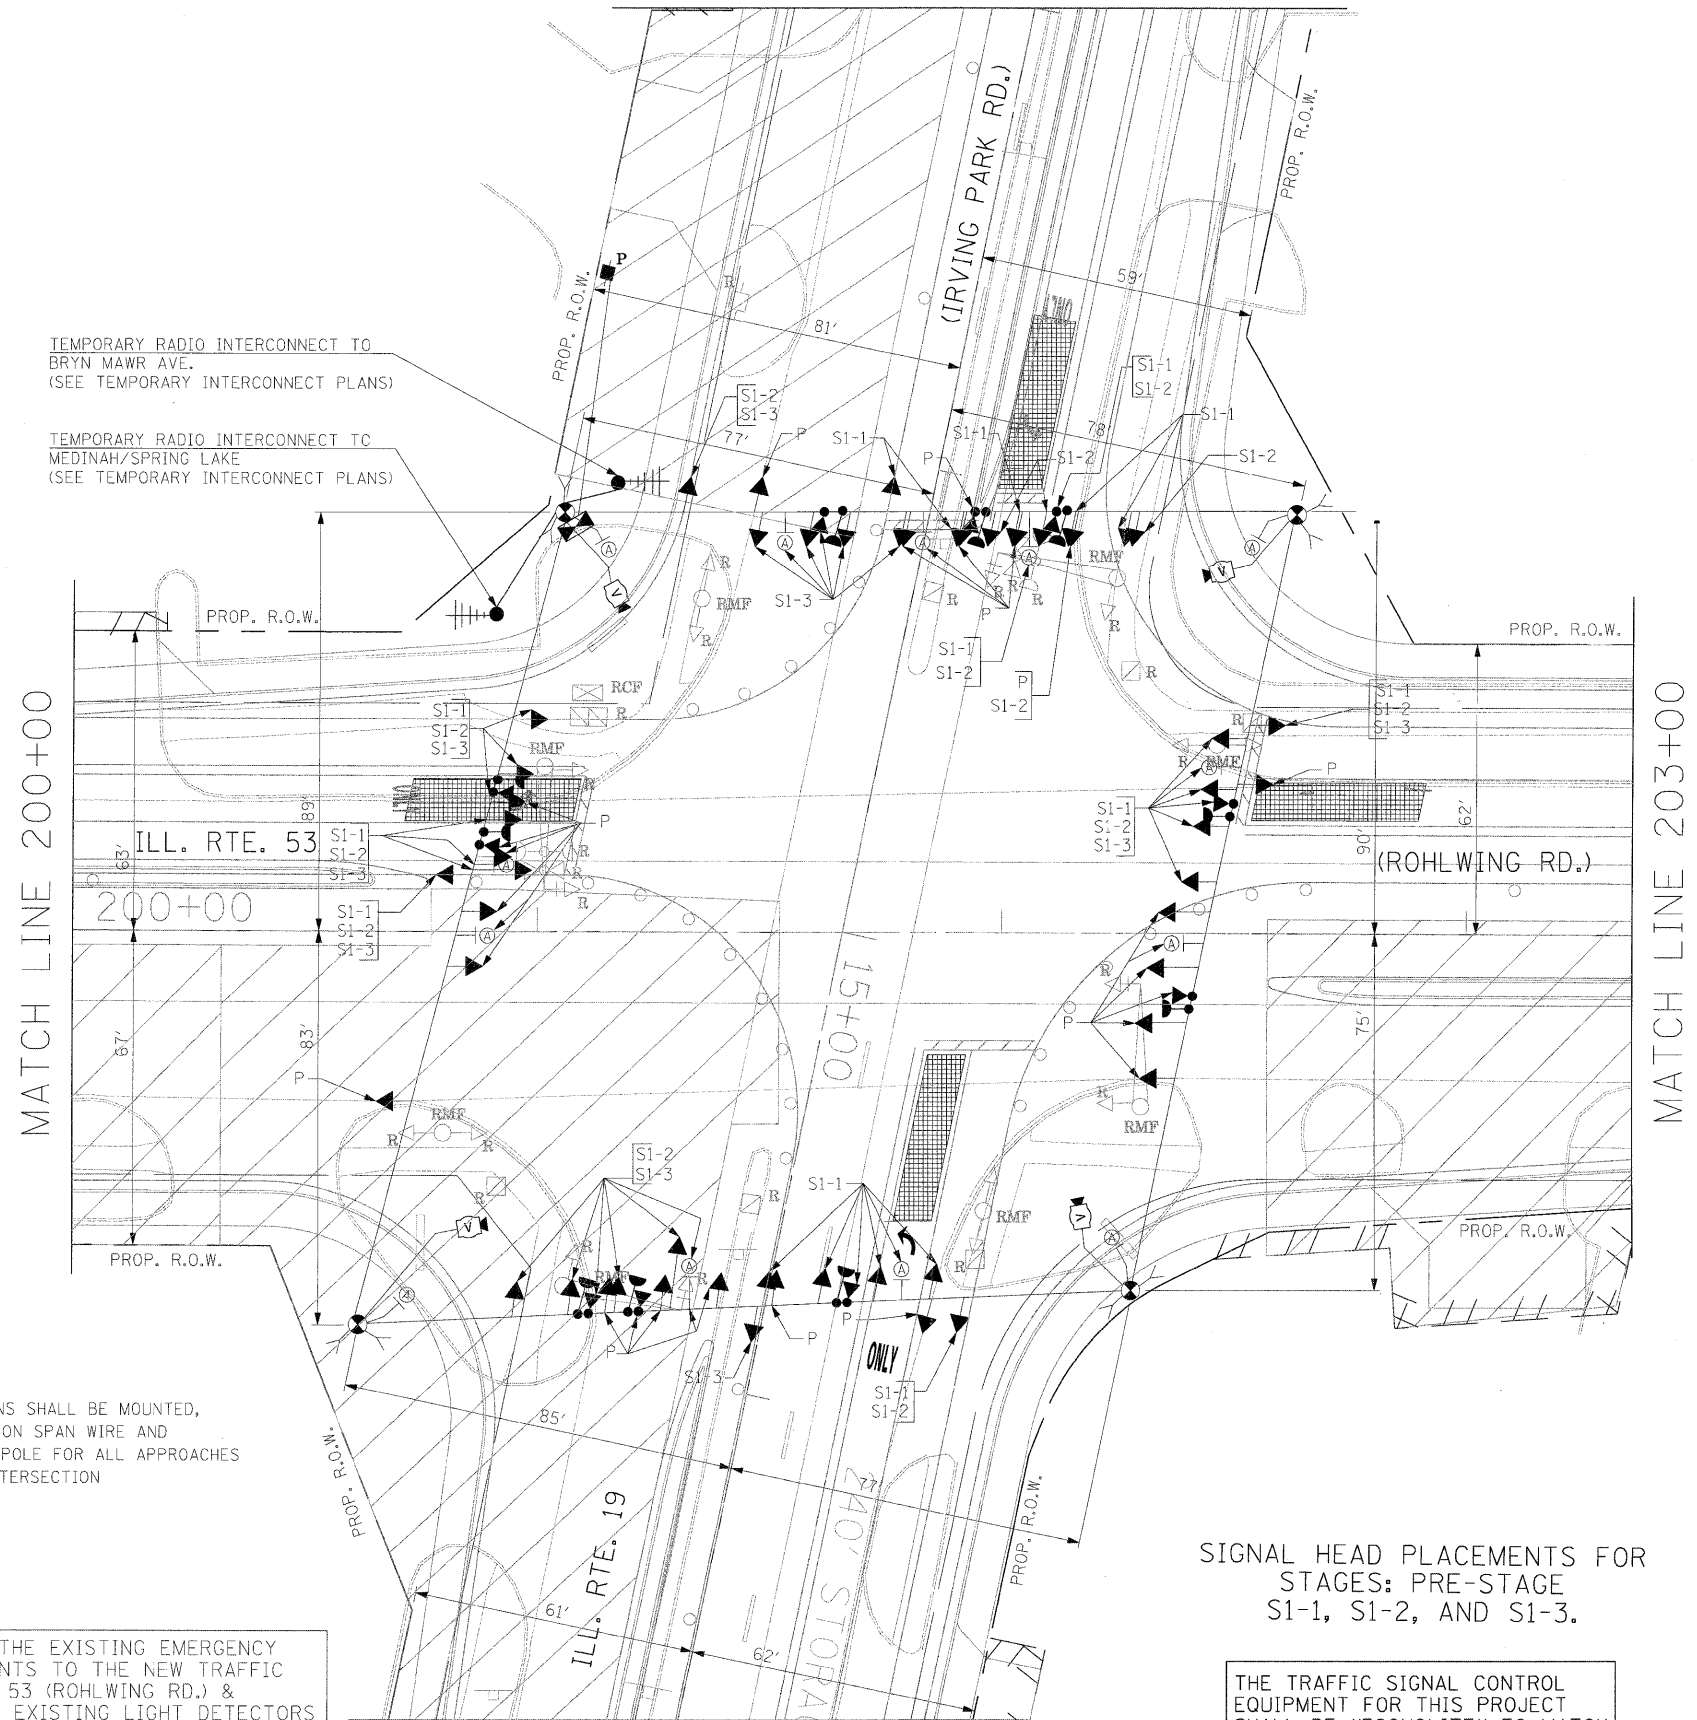



SIGNAL HEAD PLACEMENTS FOR STAGES: PRE-STAGE S1-1, S1-2, AND S1-3.

THE TRAFFIC SIGNAL CONTROL EQUIPMENT FOR THIS PROJECT SHALL BE "ECONOLITE" TO MATCH THE EXISTING ADJACENT SYSTEM.

| | | | | | | | | | | | | | |
|-------------|------------------------|-------------------|-----------|---|--|---|---|--|-------------|--------------------|--------|--------------|-----------|
| FILE NAME = | USER NAME = \$USER\$ | DESIGNED - PKG | REVISED - | STATE OF ILLINOIS DEPARTMENT OF TRANSPORTATION | | TEMPORARY TRAFFIC SIGNAL INSTALLATION AND REMOVAL PLAN ILLINOIS ROUTE 53 (ROHLWING RD.) AT ILL. RTE 19 (IRVING PARK RD.) PRE STAGE AND STAGE 1 (SHEET 1 OF 5) | | | F.A.P. RTE. | SECTION | COUNTY | TOTAL SHEETS | SHEET NO. |
| \$FILEL\$ | | DRAWN - MAA, EA | REVISED - | | | | | | 2578 | 532B | DuPage | 78! | 477 |
| | PLOT SCALE = \$SCALE\$ | CHECKED - PKG, EA | REVISED - | SCALE: SHEET NO. OF SHEETS STA. TO STA. | | | FED. ROAD DIST. NO. - ILLINOIS FED. AID PROJECT | | | CONTRACT NO. 60477 | | | |
| | PLOT DATE = \$DATE\$ | DATE - 5/10/2010 | REVISED - | | | | | | | | | | |




MATCH LINE 203+00

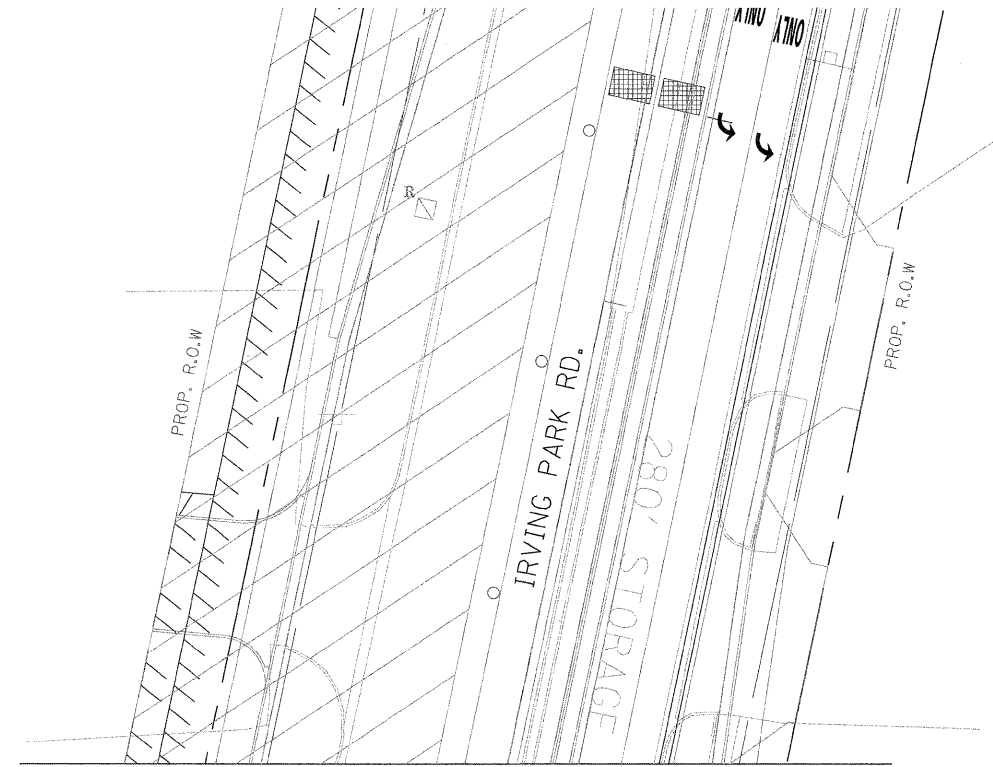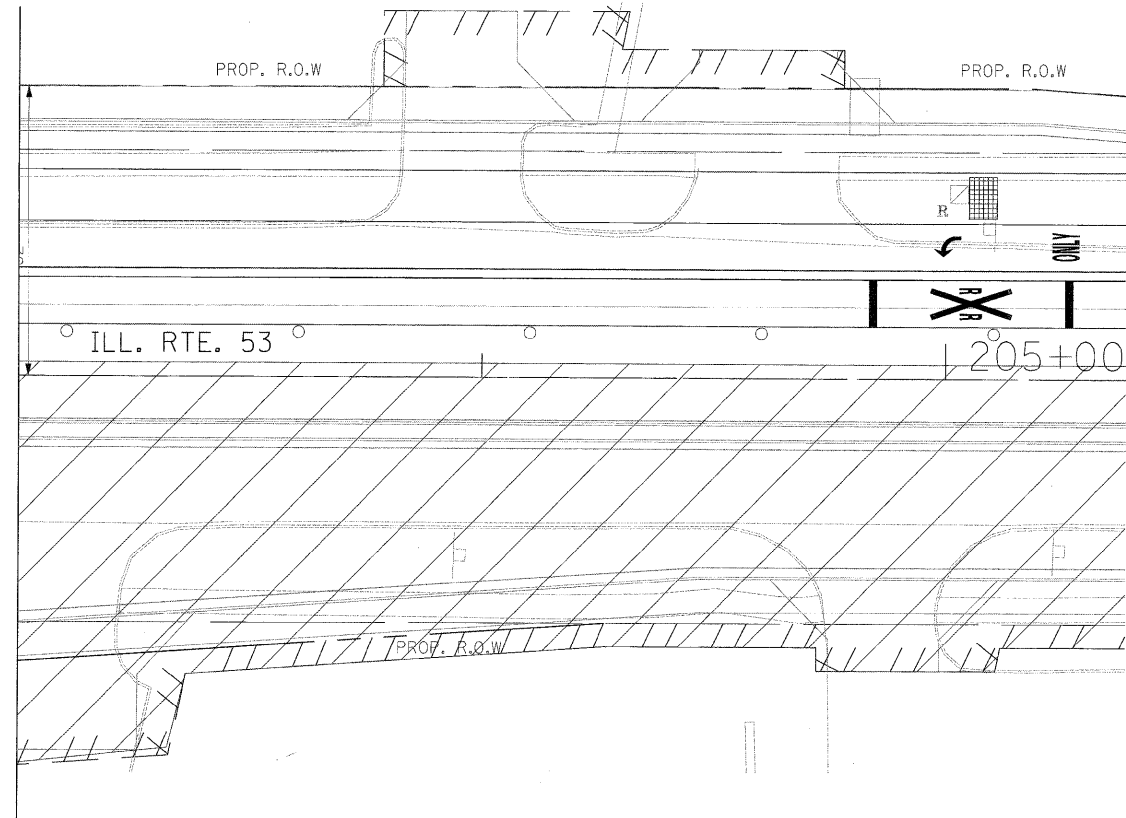


MATCH LINE "B"

NOTE: THE VIDEO DETECTION ZONES SHOWN ON THE PLANS ARE FOR PRE-CONSTRUCTION STAGE (EXISTING GEOMETRICS) AND SHALL BE REDEFINED FOR EACH CONSTRUCTION STAGE AS A PART OF "TEMPORARY TRAFFIC SIGNAL INSTALLATION" WORK.

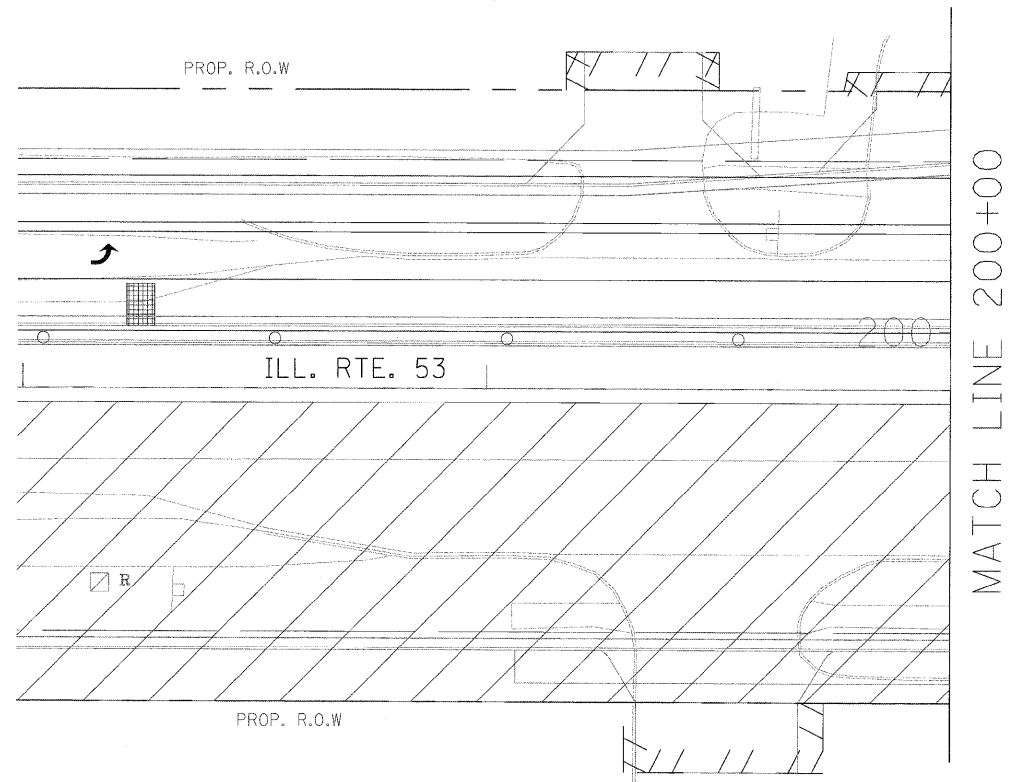


MATCH LINE 200+00

MATCH LINE "A"

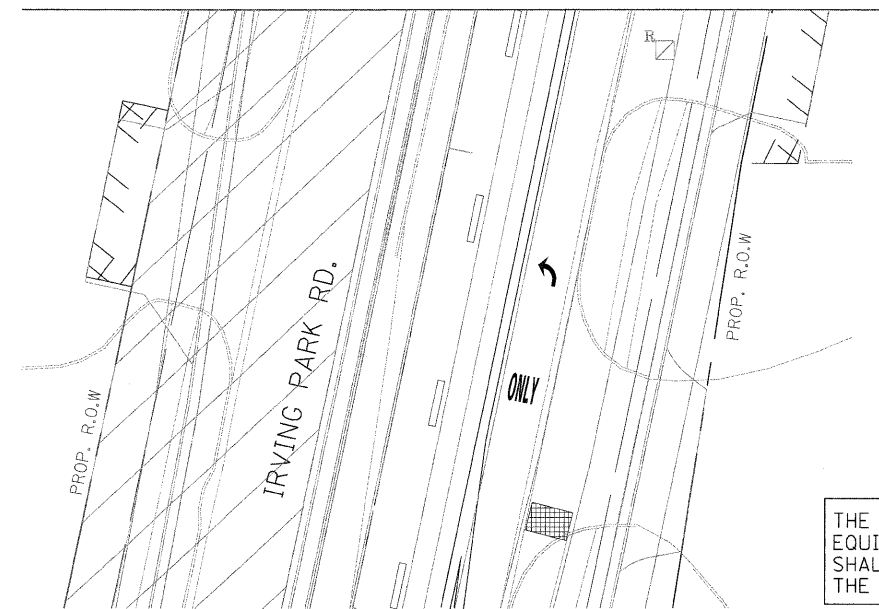

THE TRAFFIC SIGNAL CONTROL EQUIPMENT FOR THIS PROJECT SHALL BE "ECONOLITE" TO MATCH THE EXISTING ADJACENT SYSTEM.

| | | | | | | | | | | | | | |
|------------------------|----------------------|-------------------|-----------|---|---|-----------|----|--------|---------------------|-----------------|--------------------|---------------------|------------------|
| FILE NAME = #FILEL# | USER NAME = #USER# | DESIGNED - PKG | REVISED - | STATE OF ILLINOIS DEPARTMENT OF TRANSPORTATION | TEMPORARY TRAFFIC SIGNAL INSTALLATION AND REMOVAL PLAN ILLINOIS ROUTE 53 (ROHLWING RD.) AT ILL. RTE. 19 (IRVING PARK RD.) PRE STAGE AND STAGE 1 (SHEET 2 OF 5) | | | | F.A.P. RTE. 2578 | SECTION 532B | COUNTY DuPage | TOTAL SHEETS 781 | SHEET NO. 478 |
| | PLOT SCALE = #SCALE# | DRAWN - MAA, EA | REVISED - | | SCALE: | SHEET NO. | OF | SHEETS | STA. | TO STA. | CONTRACT NO. 60477 | | |
| | PLOT DATE = #DATE# | CHECKED - PKG, EA | REVISED - | | FED. ROAD DIST. NO. | ILLINOIS | | | FED. AID PROJECT | | | | |
| | | DATE - 5/10/2010 | REVISED - | | | | | | | | | | |

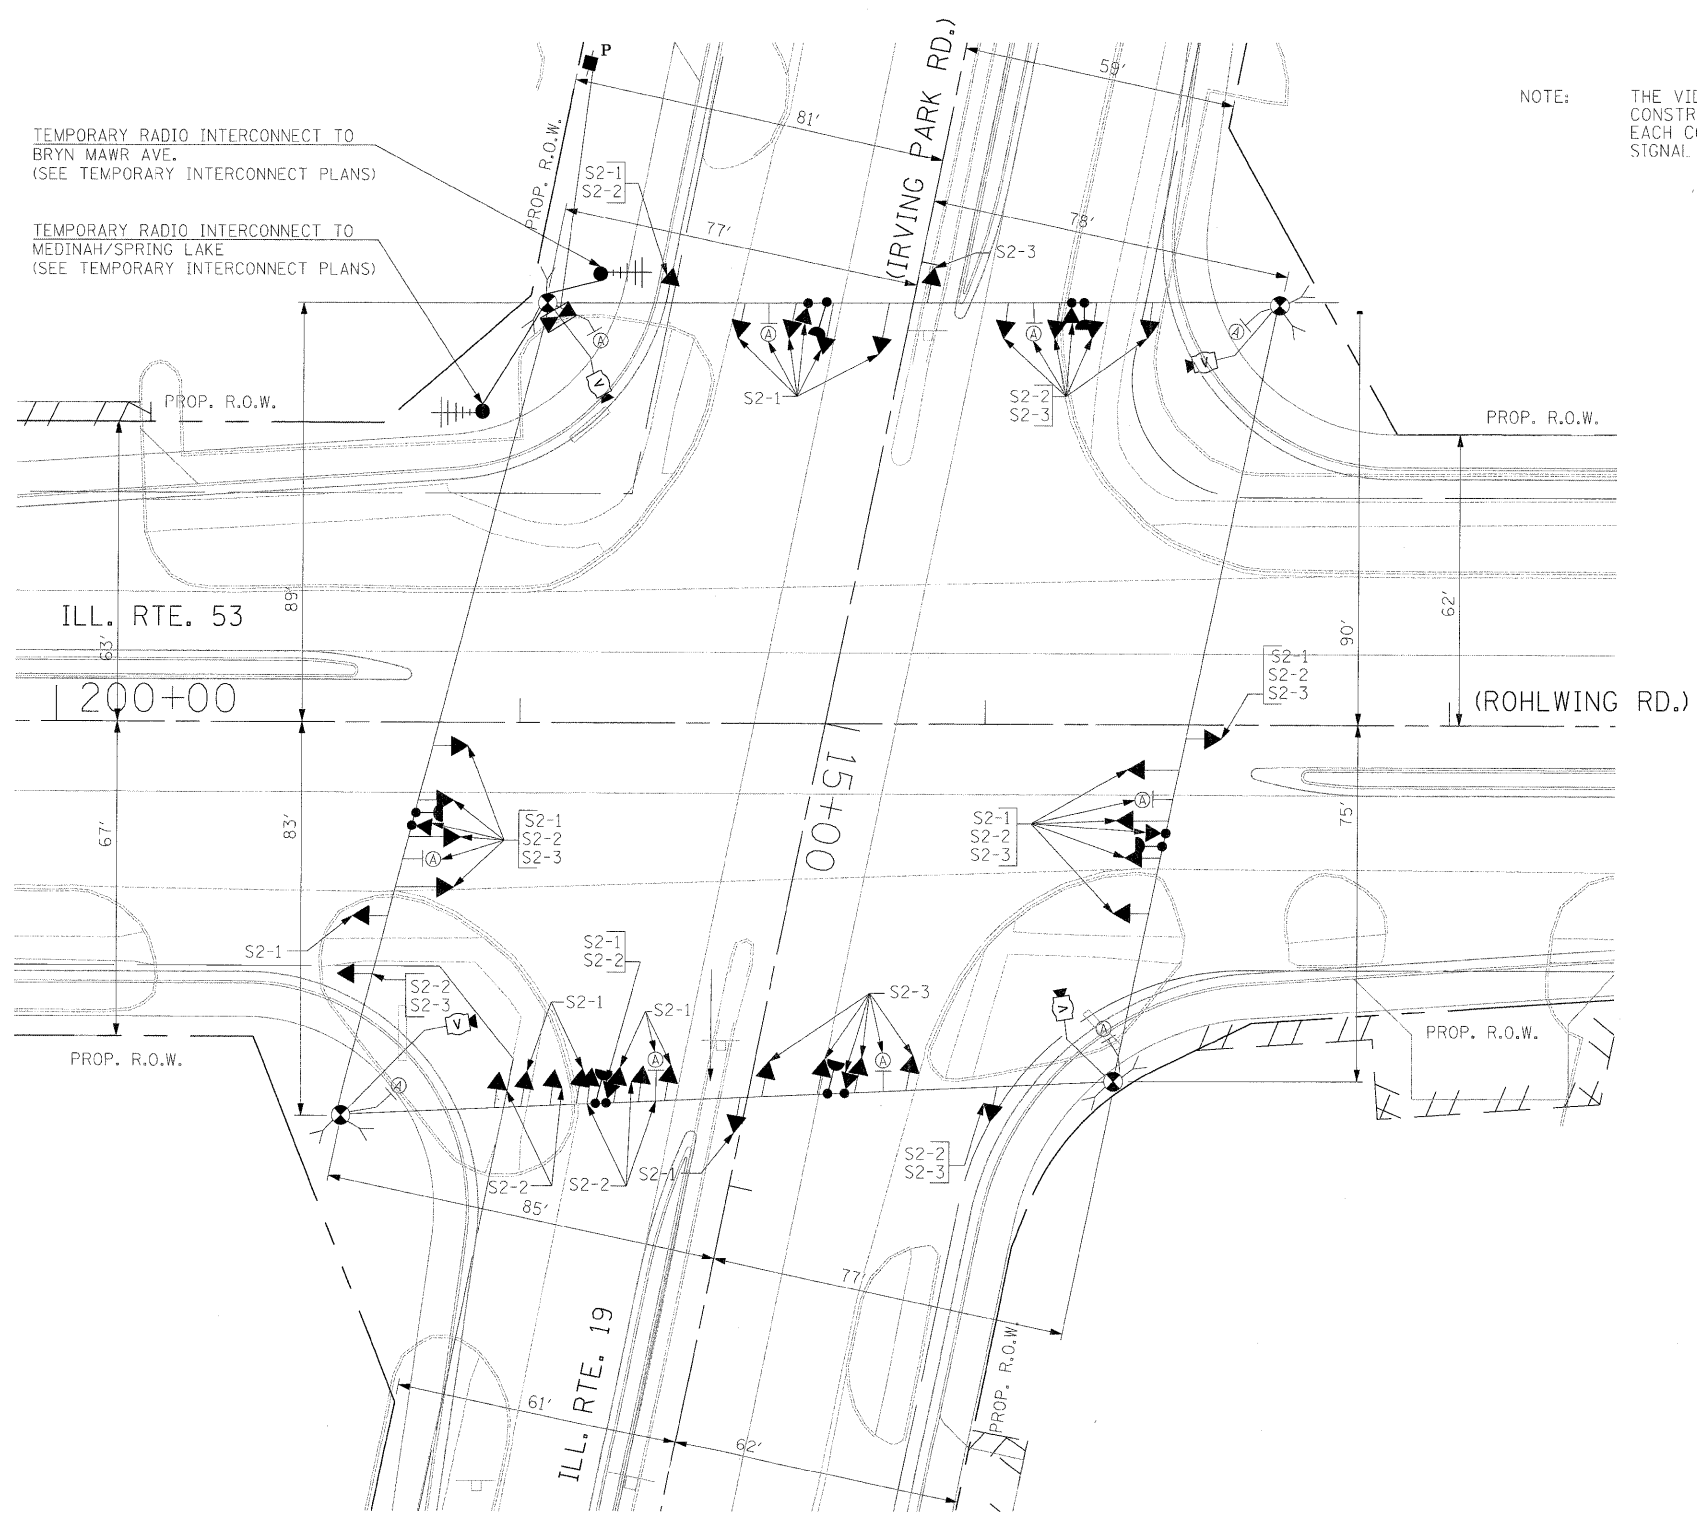

NOTE: THE VIDEO DETECTION ZONES SHOWN ON THE PLANS ARE FOR CONSTRUCTION STAGE 1 - SUBSTAGE 1 AND SHALL BE REDEFINED FOR EACH CONSTRUCTION STAGE AS A PART OF "TEMPORARY TRAFFIC SIGNAL INSTALLATION" WORK.

TEMPORARY RADIO INTERCONNECT TO BRYN MAWR AVE. (SEE TEMPORARY INTERCONNECT PLANS)

TEMPORARY RADIO INTERCONNECT TO MEDINAH/SPRING LAKE (SEE TEMPORARY INTERCONNECT PLANS)

SIGNAL HEAD PLACEMENTS FOR STAGES: S2-1, S2-2, AND S2-3.


Ⓐ
LEFT ON GREEN ARROW ONLY
 R10-5, 24" X 30" (8 REQUIRED)
 R10-5 SIGNS SHALL BE MOUNTED, ONE EACH ON SPAN WIRE AND FAR LEFT POLE FOR ALL APPROACHES OF THE INTERSECTION

THE TRAFFIC SIGNAL CONTROL EQUIPMENT FOR THIS PROJECT SHALL BE "ECONOLITE" TO MATCH THE EXISTING ADJACENT SYSTEM.

| | | | | | | | | | | | | | |
|-----------------------|----------------------|-------------------|-----------|---|---|-----------|----|--------|---------------------|-----------------|---|---------------------|------------------|
| FILE NAME = #FILE# | USER NAME = #USER# | DESIGNED - PKG | REVISED - | STATE OF ILLINOIS DEPARTMENT OF TRANSPORTATION | TEMPORARY TRAFFIC SIGNAL INSTALLATION AND REMOVAL PLAN ILLINOIS ROUTE 53 (ROHLWING RD.) AT ILL. RTE. 19 (IRVING PARK RD.) STAGE 2 (SHEET 3 OF 5) | | | | F.A.P. RTE. 2578 | SECTION 532B | COUNTY DuPage | TOTAL SHEETS 781 | SHEET NO. 479 |
| | PLOT SCALE = #SCALE# | DRAWN - MAA, EA | REVISED - | | SCALE: | SHEET NO. | OF | SHEETS | STA. | TO STA. | FED. ROAD DIST. NO. - [ILLINOIS] FED. AID PROJECT | | |
| | PLOT DATE = #DATE# | CHECKED - PKG, EA | REVISED - | | | | | | | | CONTRACT NO. 60477 | | |
| | | DATE - 5/10/2010 | REVISED - | | | | | | | | | | |



NOTE: THE VIDEO DETECTION ZONES SHOWN ON THE PLANS ARE FOR CONSTRUCTION STAGE 1 - SUBSTAGE 1 AND SHALL BE REDEFINED FOR EACH CONSTRUCTION STAGE AS A PART OF "TEMPORARY TRAFFIC SIGNAL INSTALLATION" WORK.

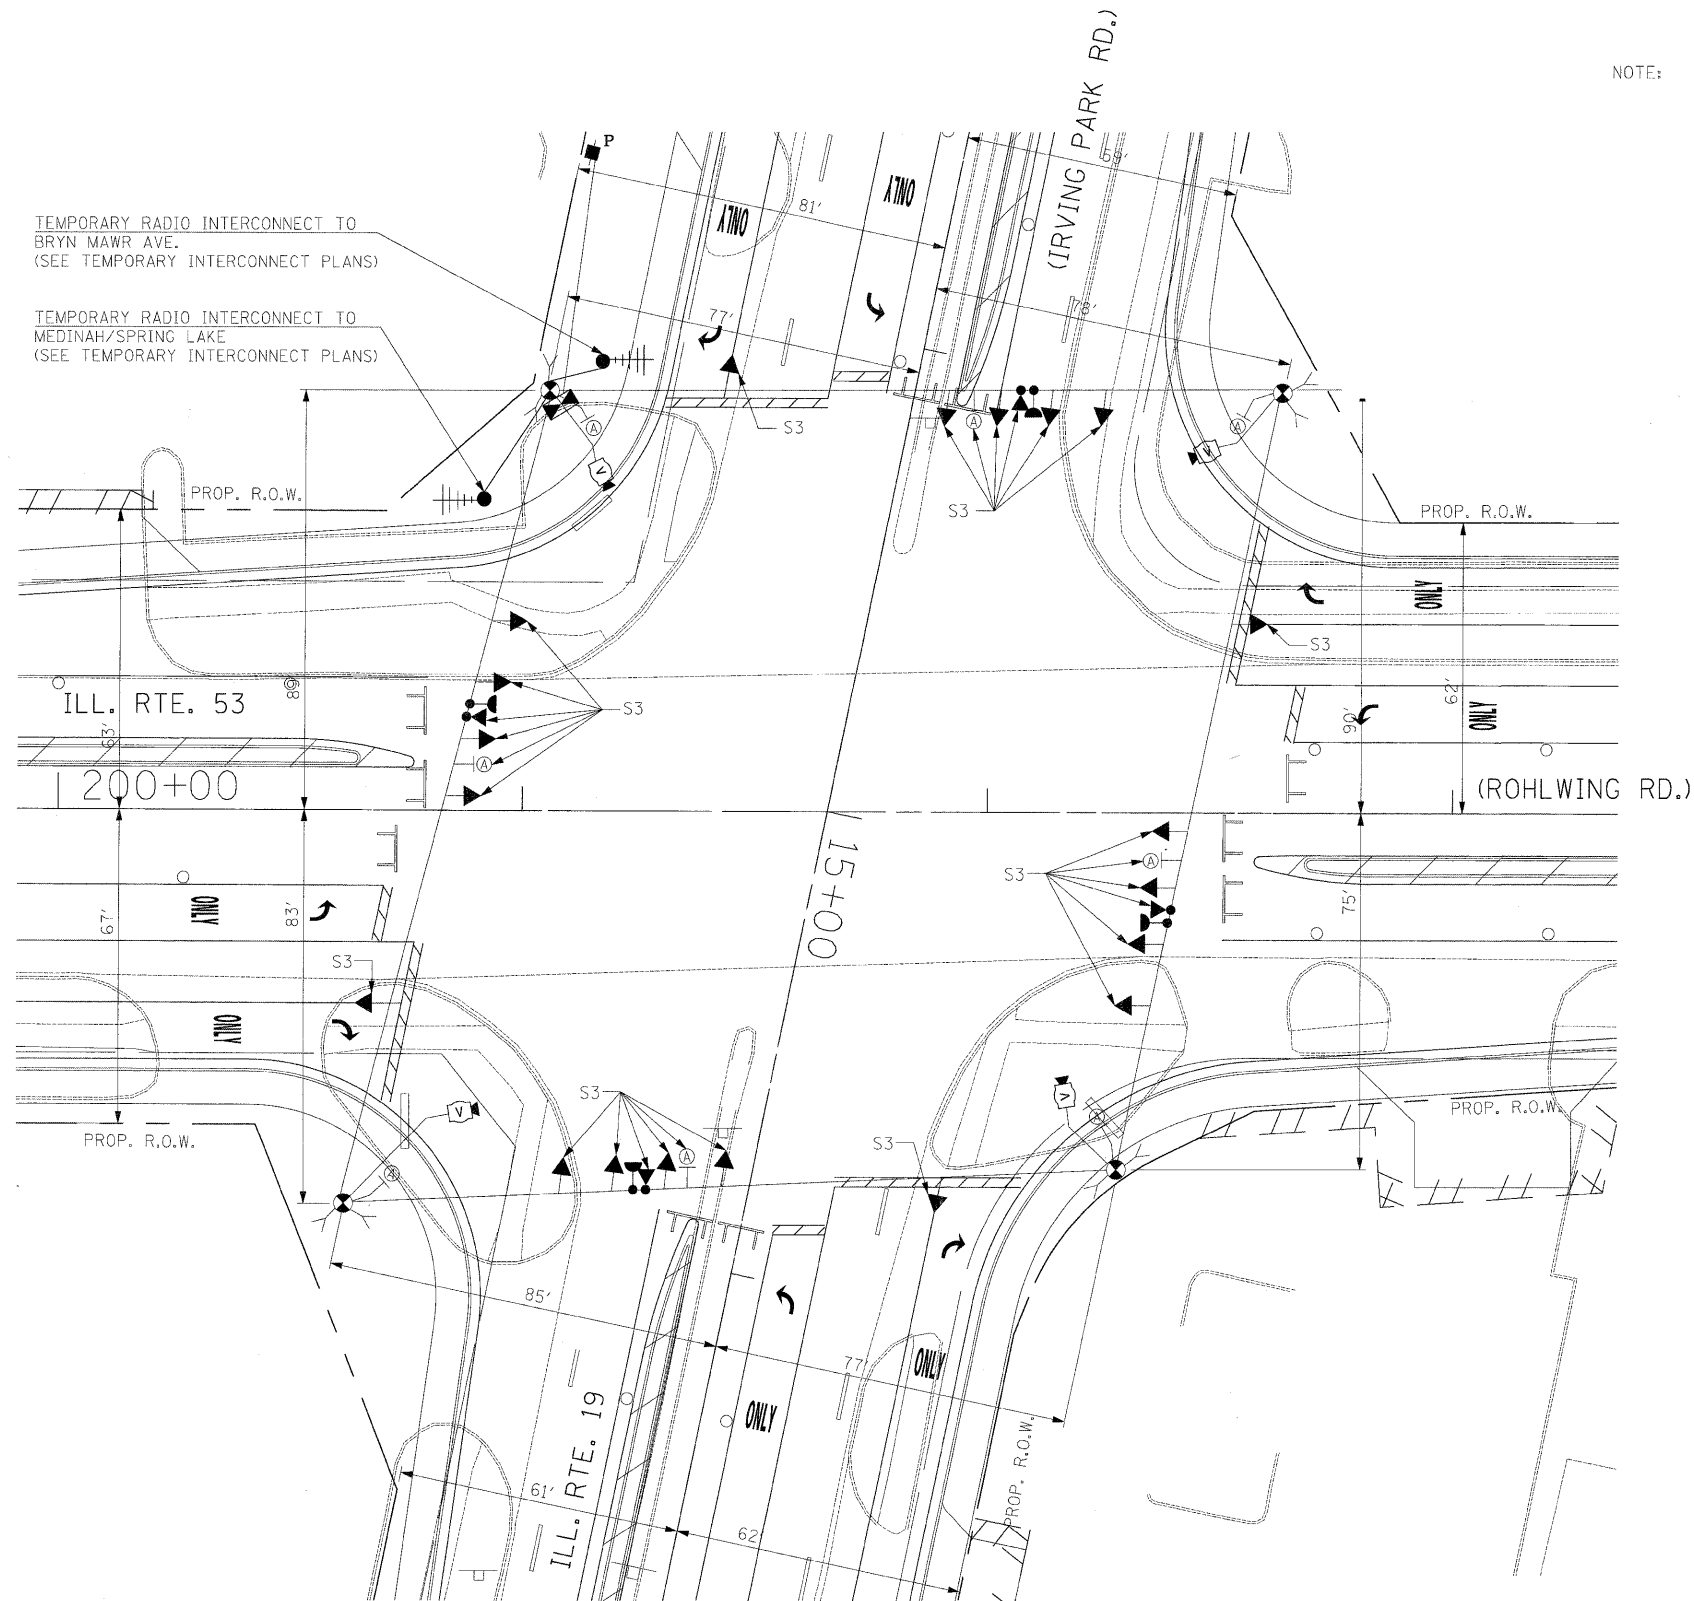



SIGNAL HEAD PLACEMENTS FOR STAGE S3

Ⓐ
LEFT ON GREEN ARROW ONLY
 R10-5, 24" X 30" (8 REQUIRED)
 R10-5 SIGNS SHALL BE MOUNTED, ONE EACH ON SPAN WIRE AND FAR LEFT POLE FOR ALL APPROACHES OF THE INTERSECTION

THE TRAFFIC SIGNAL CONTROL EQUIPMENT FOR THIS PROJECT SHALL BE "ECONOLITE" TO MATCH THE EXISTING ADJACENT SYSTEM.

| | | | | | | | | | | | | |
|------------------------|----------------------|-------------------|-----------|---|---|-----------|----|---------------------|-----------------|------------------|---|------------------|
| FILE NAME = #FILEL# | USER NAME = #USER# | DESIGNED - PKG | REVISED - | STATE OF ILLINOIS DEPARTMENT OF TRANSPORTATION | TEMPORARY TRAFFIC SIGNAL INSTALLATION AND REMOVAL PLAN ILLINOIS ROUTE 53 (ROHLWING RD.) AT ILL. RTE. 19 (IRVING PARK RD.) STAGE 3 (SHEET 4 OF 5) | | | F.A.P. RTE. 2578 | SECTION 532B | COUNTY DuPage | TOTAL SHEETS 781 | SHEET NO. 480 |
| | PLOT SCALE = #SCALE# | DRAWN - MAA, EA | REVISED - | | SCALE: | SHEET NO. | OF | SHEETS | STA. | TO STA. | CONTRACT NO. 60477 | |
| | PLOT DATE = #DATE# | CHECKED - PKG, EA | REVISED - | | | | | | | | FED. ROAD DIST. NO. - ILLINOIS FED. AID PROJECT | |
| | | DATE - 5/10/2010 | REVISED - | | | | | | | | | |


CONTROLLER SEQUENCE

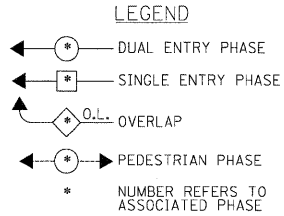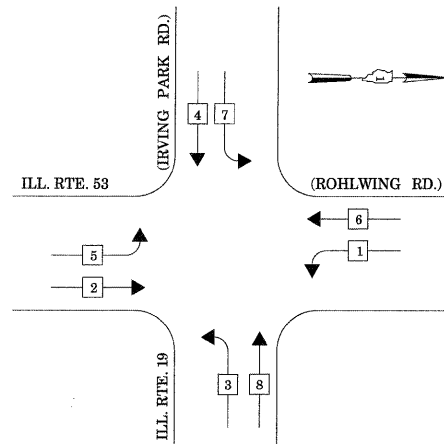

TEMPORARY PHASE DESIGNATION DIAGRAM

STAGES: PRE-STAGE, S1-1, S1-3, S2-1, S2-3, S3, AND AFTER PROPOSED ROADWAY GEOMETRICS ARE BUILT


EMERGENCY VEHICLE PREEMPTION SEQUENCE

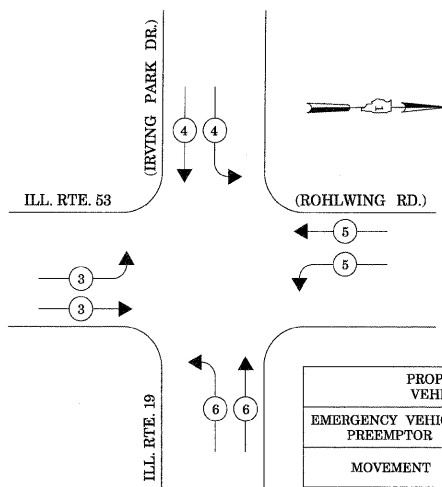

STAGES: PRE-STAGE, S1-1, S1-3, S2-1, S2-3, S3, AND AFTER PROPOSED ROADWAY GEOMETRICS ARE BUILT

TEMPORARY RADIO INTERCONNECT TO BRYN MAWR AVE. (SEE TEMPORARY INTERCONNECT PLANS)

TEMPORARY RADIO INTERCONNECT TO MEDINAH DR./SPRING LAKE DR. (SEE TEMPORARY INTERCONNECT PLANS)

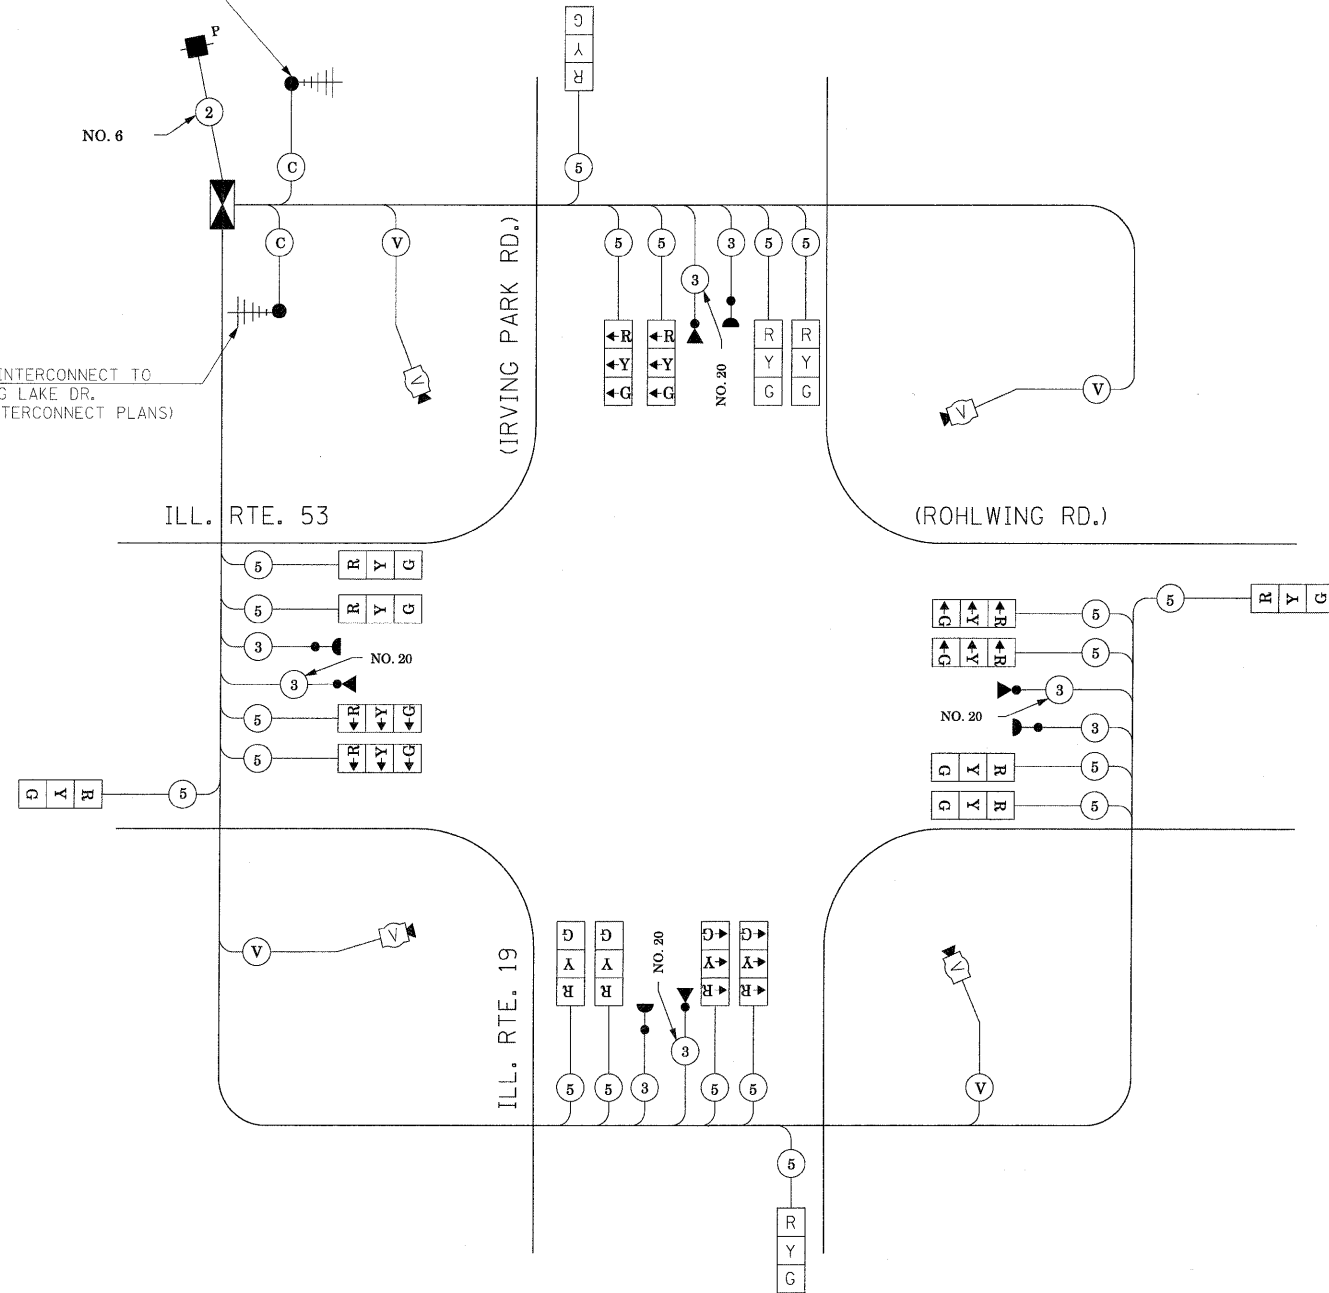

TEMPORARY CABLE PLAN

(NOT TO SCALE)

STAGES: PRE-STAGE, S1-1, S1-2, S1-3, S2-1, S2-2, S2-3, S3, AND AFTER PROPOSED ROADWAY GEOMETRICS ARE BUILT

THE TRAFFIC SIGNAL CONTROL EQUIPMENT FOR THIS PROJECT SHALL BE "ECONOLITE" TO MATCH THE EXISTING ADJACENT SYSTEM.

| I.D.O.T. TRAFFIC SIGNAL INSTALLATION ELECTRICAL SERVICE REQUIREMENTS | | | | | | TOTAL WATTAGE |
|--|----------|---------|-----|-----------|---------|---------------|
| TYPE | NO LAMPS | WATTAGE | | OPERATION | | |
| SIGNAL (RED) | 20 | 135 | 17 | 0.50 | | 170 |
| (YELLOW) | 20 | 135 | 25 | 0.25 | | 125 |
| (GREEN) | 20 | 135 | 15 | 0.25 | | 75 |
| ARROW | | 135 | 12 | 0.10 | | |
| PED. SIGNAL | | 90 | 25 | 1.00 | | |
| CONTROLLER | 1 | 100 | 100 | 1.00 | | 100 |
| ILLUM. SIGN | | | 25 | 0.05 | | |
| VIDEO SYSTEM | 1 | 150 | | 1.00 | | 150 |
| FLASHER | | | | 0.50 | | |
| ENERGY COSTS TO: | | | | | TOTAL = | 620 |

ILLINOIS DEPARTMENT OF TRANSPORTATION
201 WEST CENTER COURT
SCHAUMBURG, ILLINOIS 60196-1096
ENERGY SUPPLY CONTACT: CURTIS TOPPS
PHONE: (630) 691-4356
COMPANY: COMMONWEALTH EDISON

| | | | |
|-------------|----------------------|-------------------|-----------|
| FILE NAME = | USER NAME = #USER# | DESIGNED - PKG | REVISED - |
| #FILEL# | | DRAWN - MAA, EA | REVISED - |
| | PLOT SCALE = #SCALE# | CHECKED - PKG, EA | REVISED - |
| | PLOT DATE = #DATE# | DATE - 5/10/2010 | REVISED - |

STATE OF ILLINOIS DEPARTMENT OF TRANSPORTATION

TEMPORARY CABLE PLAN, TEMPORARY PHASE DESIGNATION DIAGRAM, TEMPORARY EMERGENCY VEHICLE PREEMPTION SEQUENCE
ILLINOIS ROUTE 53 (ROHLWING RD.) AT ILL. RTE. 19 (IRVING PARK RD.) PRE-STAGE, STAGE 1, STAGE 2, STAGE 3 AND AFTER PROPOSED ROADWAY GEOMETRICS ARE BUILT (SHEET 5 OF 5)

| | | | | |
|--------------------|--------------|---------------|---|---------------|
| F.A.P. RTE. 2578 | SECTION 532B | COUNTY DuPage | TOTAL SHEETS 781 | SHEET NO. 481 |
| CONTRACT NO. 60477 | | | FED. ROAD DIST. NO. - ILLINOIS FED. AID PROJECT | |

TEMPORARY SEQUENCE OF OPERATION (FOR STAGE 1, SUB STAGE 2 AND STAGE 2, SUB STAGE 2 WITH LEAD-LAG OPERATION FOR ILL. RTE. 19 AND ILL. RTE. 53)

| MOVEMENT | 2 5 | | 2 6 | | | | 1 6 | | | | 3 8 | | | | 4 8 | | | | 4 7 | | | | F L A S H | | | | | | | | | | | | | |
|--|-----|--------------------------|-----|-----|----|----|-----|----|-----|----|-------------------|----|----|--------------------------|-----|-----|-----|----|--------------------------|-----|-----|-----|-----------------------|----|-----|-----|-----|-----|-------------------|-----|----|--------------------------|-----|-----|-----|----|
| PHASE | 2+5 | | 2+6 | | | | 1+6 | | | | 3+8 | | | | 4+8 | | | | 4+7 | | | | | | | | | | | | | | | | | |
| INTERVAL | 1 | 2A | 2B | 3A | 3B | 4 | 5A | 5B | 6A | 6B | 7A | 7B | 8 | 9A | 9B | 10A | 10B | 11 | 12A | 12B | 13A | 13B | | 14 | 15A | 15B | 16A | 16B | 17A | 17B | 18 | 19A | 19B | 20A | 20B | |
| CHANGE TO | / | 1+6 3+8 4+7 4+8 | | 2+6 | | / | 1+6 | | 2+5 | | 3+8 4+7 4+8 | | / | 2+5 3+8 4+7 4+8 | | 2+6 | | / | 1+6 2+5 2+6 4+7 | | 4+8 | | | / | 4+7 | | 3+8 | | 1+6 2+5 2+6 | | / | 1+6 2+5 2+6 3+8 | | 4+8 | | |
| ILLINOIS ROUTE 19 (IRVING PARK ROAD) NEAR RIGHT AND TWO FAR RIGHT SPAN WIRE SIGNAL | E/B | G | Y | R | G | G | G | Y | R | G | G | Y | R | R | |
| ILLINOIS ROUTE 19 (IRVING PARK ROAD) TWO FAR LEFT SPAN WIRE SIGNALS WITH LEFT TURN ARROWS | E/B | ←G | ←Y | ←R | ←Y | ←R | ←R |
| ILLINOIS ROUTE 19 (IRVING PARK ROAD) NEAR RIGHT AND TWO FAR RIGHT SPAN WIRE SIGNAL | W/B | R | R | R | R | R | G | G | G | Y | R | Y | R | G | Y | R | G | G | R | R | R | R | R | R | R | R | R | R | R | R | R | R | R | R | R | R |
| ILLINOIS ROUTE 19 (IRVING PARK ROAD) TWO FAR LEFT SPAN WIRE SIGNALS WITH LEFT TURN ARROWS | W/B | ←R | ←R | ←R | ←R | ←R | ←R | ←R | ←R | ←R | ←R | ←R | ←R | ←G | ←Y | ←R | ←Y | ←R | ←R | ←R | ←R | ←R | ←R | ←R | ←R | ←R | ←R | ←R | ←R | ←R | ←R | ←R | ←R | ←R | ←R | ←R |
| ILLINOIS ROUTE 53 (ROHLWING ROAD) NEAR RIGHT AND TWO FAR RIGHT SPAN WIRE SIGNALS | N/B | R | R | R | R | R | R | R | R | R | R | R | R | R | R | R | R | R | G | Y | R | G | G | G | Y | R | G | G | Y | R | R | R | R | R | R | |
| ILLINOIS ROUTE 53 (ROHLWING ROAD) TWO FAR LEFT SPAN WIRE SIGNALS WITH LEFT TURN ARROWS | N/B | ←R | ←R | ←R | ←R | ←R | ←R | ←R | ←R | ←R | ←R | ←R | ←R | ←R | ←R | ←R | ←R | ←R | ←G | ←Y | ←R | ←Y | ←R | ←R | ←R | ←R | ←R | ←R | ←R | ←R | ←R | ←R | ←R | ←R | ←R | ←R |
| ILLINOIS ROUTE 53 (ROHLWING ROAD) NEAR RIGHT AND TWO FAR RIGHT SPAN WIRE SIGNALS | S/B | R | R | G | G | G | Y | R | Y | R | G | Y | R | G | G | R |
| ILLINOIS ROUTE 53 (ROHLWING ROAD) TWO FAR LEFT SPAN WIRE SIGNALS WITH LEFT TURN ARROWS | S/B | ←R | ←R |

PHASE 2 + 6 SHALL BE PLACED ON RECALL.


THE TRAFFIC SIGNAL CONTROL EQUIPMENT FOR THIS PROJECT SHALL BE "ECONOLITE" TO MATCH THE EXISTING ADJACENT SYSTEM.

TEMPORARY EMERGENCY VEHICLE PREEMPTION SEQUENCE OF OPERATION (FOR STAGE 1, SUB STAGE 2 AND STAGE 2, SUB STAGE 2 WITH LEAD-LAG OPERATION FOR ILL. RTE. 19 AND ILL. RTE. 53)

| CHANGE FROM NORMAL SEQUENCE OF OPERATION INTERVAL NUMBER | 1 | | 1 | | 4 | | 4 | | 4 | | 8 | | 8 | | 11 | | 11 | | 14 | | 14 | | 14 | | 18 | | 18 | | PREEMPTOR NUMBER 3 | PREEMPTOR NUMBER 4 | PREEMPTOR NUMBER 5 | PREEMPTOR NUMBER 6 | CLEAR TO NORMAL SEQUENCE |
|---|-----|----|----------|----|----|----|-----|----|----|----|----------|----|----|----------|----|----|-----|----|----|----|----|----|----------|----|----|----|----|----|--------------------|--------------------|--------------------|--------------------|--------------------------|
| | 1A | 1B | 1C | 1D | 1E | 1F | 1G | 1H | 1J | 1K | 1L | 1M | 1N | 1P | 1Q | 1R | 1S | 1T | 1U | 1V | 1W | 1X | 1Y | 1Z | 2 | 3 | 4 | 5 | | | | | |
| EMERGENCY VEHICLE PRE-EMPTION SEQUENCE OF OPERATION INTERVAL NUMBER | 1A | 1B | 1C | 1D | 1E | 1F | 1G | 1H | 1J | 1K | 1L | 1M | 1N | 1P | 1Q | 1R | 1S | 1T | 1U | 1V | 1W | 1X | 1Y | 1Z | | | | | | | | | |
| CHANGE TO EMERGENCY VEHICLE PRE-EMPTION SEQUENCE OF OPERATION INTERVAL NUMBER | 2 | 1C | 3,4 5 | 1E | 2 | 1G | 3,5 | 1J | 4 | 1L | 2,3 5 | 4 | 1P | 2,3 4 | 5 | 1S | 2,4 | 1U | 3 | 1W | 5 | 1Y | 2,4 5 | 3 | | | | | | | | | |
| ILLINOIS ROUTE 19 (IRVING PARK ROAD) NEAR RIGHT AND TWO FAR RIGHT SPAN WIRE SIGNAL | E/B | G | Y | R | G | G | Y | R | Y | R | R | R | R | R | R | R | R | R | R | R | R | R | R | R | R | G | R | R | R | R | ◇ | | |
| ILLINOIS ROUTE 19 (IRVING PARK ROAD) TWO FAR LEFT SPAN WIRE SIGNALS WITH LEFT TURN ARROWS | E/B | ←G | ←Y | ←R | ←R | ←G | ←R | ←R | ←R | ←R | ◇ | | |
| ILLINOIS ROUTE 19 (IRVING PARK ROAD) NEAR RIGHT AND TWO FAR RIGHT SPAN WIRE SIGNAL | W/B | R | R | R | Y | R | Y | R | G | G | Y | R | G | R | R | R | R | R | R | R | R | R | R | R | R | R | R | R | G | R | ◇ | | |
| ILLINOIS ROUTE 19 (IRVING PARK ROAD) TWO FAR LEFT SPAN WIRE SIGNALS WITH LEFT TURN ARROWS | W/B | ←R | ←R | ←R | ←R | ←R | ←R | ←R | ←R | ←Y | ←R | ←G | ←R | ←R | ←R | ←R | ←R | ←R | ←R | ←R | ←R | ←R | ←R | ←R | ←R | ←R | ←R | ←G | ←R | ◇ | | | |
| ILLINOIS ROUTE 53 (ROHLWING ROAD) NEAR RIGHT AND TWO FAR RIGHT SPAN WIRE SIGNALS | N/B | R | R | R | R | R | R | R | R | R | R | R | Y | R | G | Y | R | Y | R | G | G | R | R | R | R | R | R | R | R | G | ◇ | | |
| ILLINOIS ROUTE 53 (ROHLWING ROAD) TWO FAR LEFT SPAN WIRE SIGNALS WITH LEFT TURN ARROWS | N/B | ←R | ←R | ←R | ←R | ←R | ←R | ←R | ←R | ←R | ←R | ←R | ←Y | ←R | ←G | ←R | ←R | ←R | ←R | ←R | ←R | ←R | ←R | ←R | ←R | ←R | ←R | ←R | ←R | ←G | ◇ | | |
| ILLINOIS ROUTE 53 (ROHLWING ROAD) NEAR RIGHT AND TWO FAR RIGHT SPAN WIRE SIGNALS | S/B | R | R | R | R | R | R | R | R | R | R | R | R | R | R | Y | R | G | G | Y | R | Y | R | G | R | G | R | R | R | R | ◇ | | |
| ILLINOIS ROUTE 53 (ROHLWING ROAD) TWO FAR LEFT SPAN WIRE SIGNALS WITH LEFT TURN ARROWS | S/B | ←R | ←R | ←R | ←R | ←R | ←R | ←R | ←R | ←R | ←R | ←R | ←R | ←R | ←R | ←R | ←R | ←R | ←R | ←R | ←R | ←Y | ←R | ←G | ←R | ←G | ←R | ←R | ←R | ◇ | | | |

◇ EMERGENCY VEHICLE SEQUENCE SHALL PROVIDE THE PROPER CLEARANCE INTERVAL TO RESUME THE NORMAL SEQUENCE OF OPERATION OR PROPER CLEARANCE INTERVAL TO DISPLAY A DIFFERENT EMERGENCY VEHICLE INTERVAL AFTER EMERGENCY VEHICLE INTERVAL 2, 3, 4, OR 5 IS TERMINATED.

THE TRAFFIC SIGNAL CONTROL EQUIPMENT FOR THIS PROJECT SHALL BE "ECONOLITE" TO MATCH THE EXISTING ADJACENT SYSTEM.

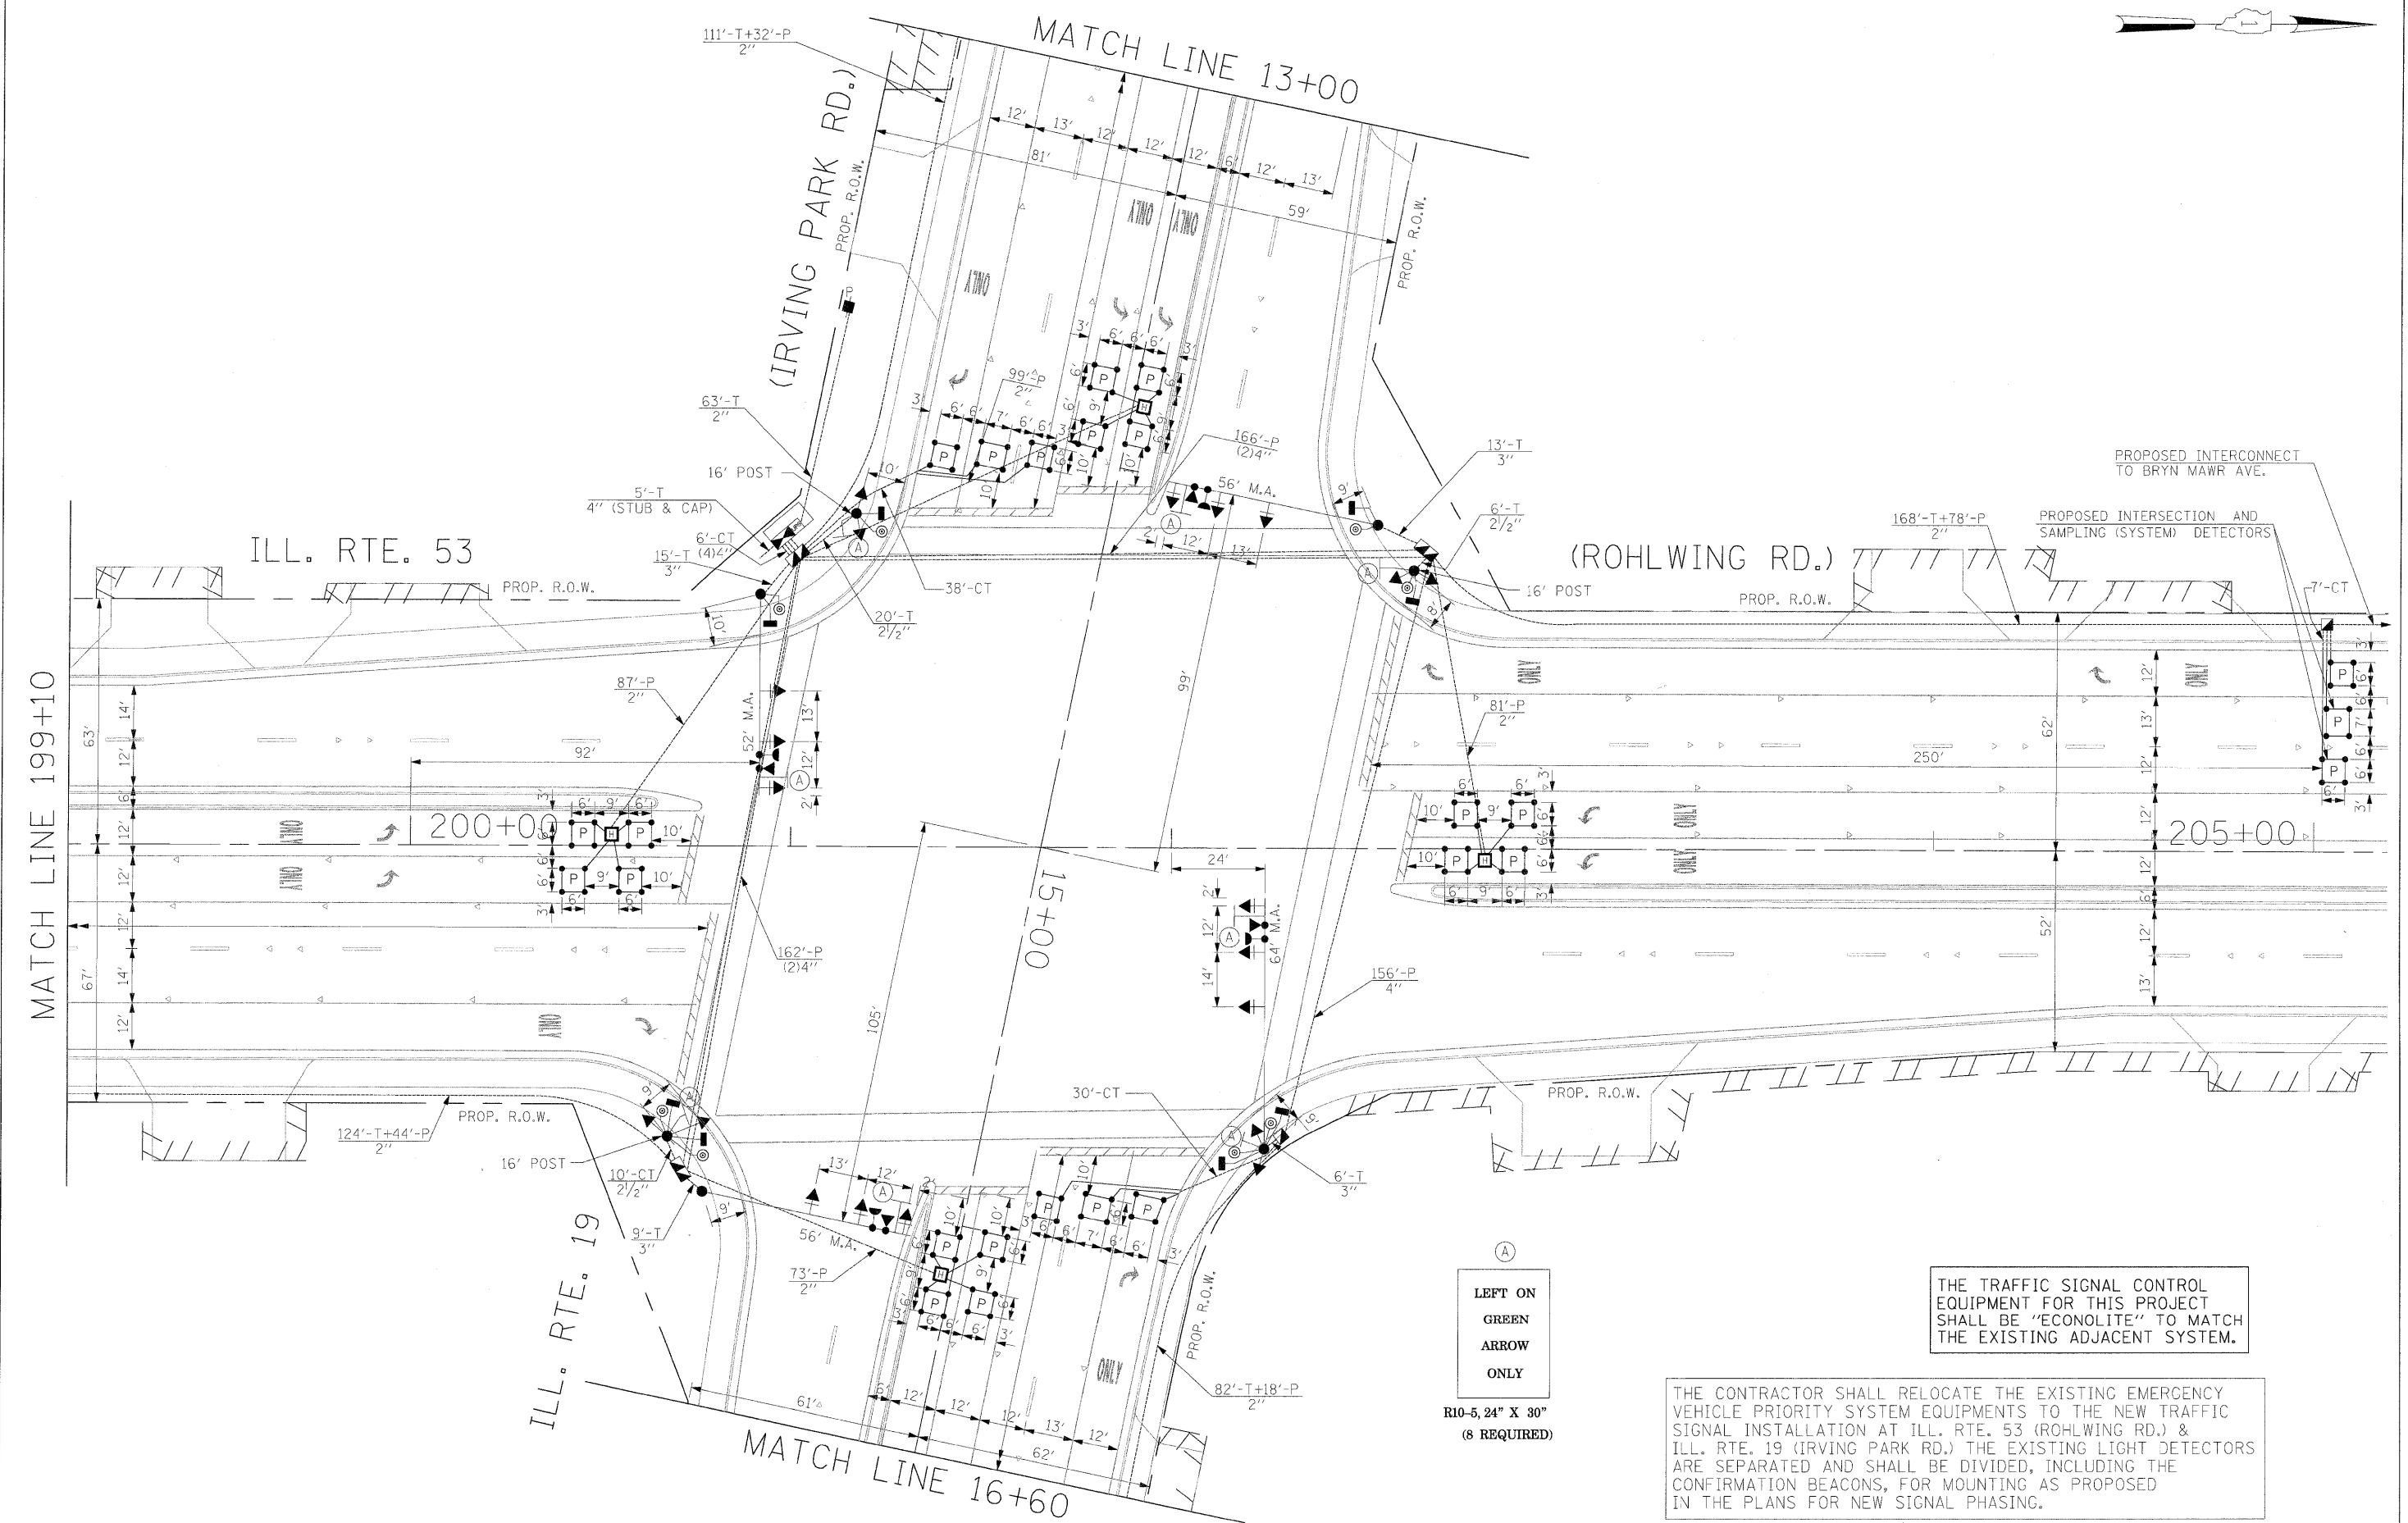

FILE NAME =
#FILE#

USER NAME = #USER#
PLOT SCALE = #SCALE#
PLOT DATE = #DATE#

DESIGNED - PKG
DRAWN - MAA, EA
CHECKED - PKG, EA
DATE - 5/10/2010


REVISED -
REVISED -
REVISED -
REVISED -

**STATE OF ILLINOIS
DEPARTMENT OF TRANSPORTATION**


**PROPOSED TRAFFIC SIGNAL INSTALLATION PLAN
ILLINOIS ROUTE 53 (ROHLWING RD.) AT ILL. RTE. 19 (IRVING PARK RD.)
(SHEET 1 OF 2).**

| F.A.P. RTE. | SECTION | COUNTY | TOTAL SHEETS | SHEET NO. |
|---|---------|--------|--------------------|-----------|
| 2578 | 532B | DuPage | 781 | 484 |
| FED. ROAD DIST. NO. - ILLINOIS FED. AID PROJECT | | | CONTRACT NO. 60477 | |

SCALE: 1"=20'
SHEET NO. OF SHEETS STA. TO STA.

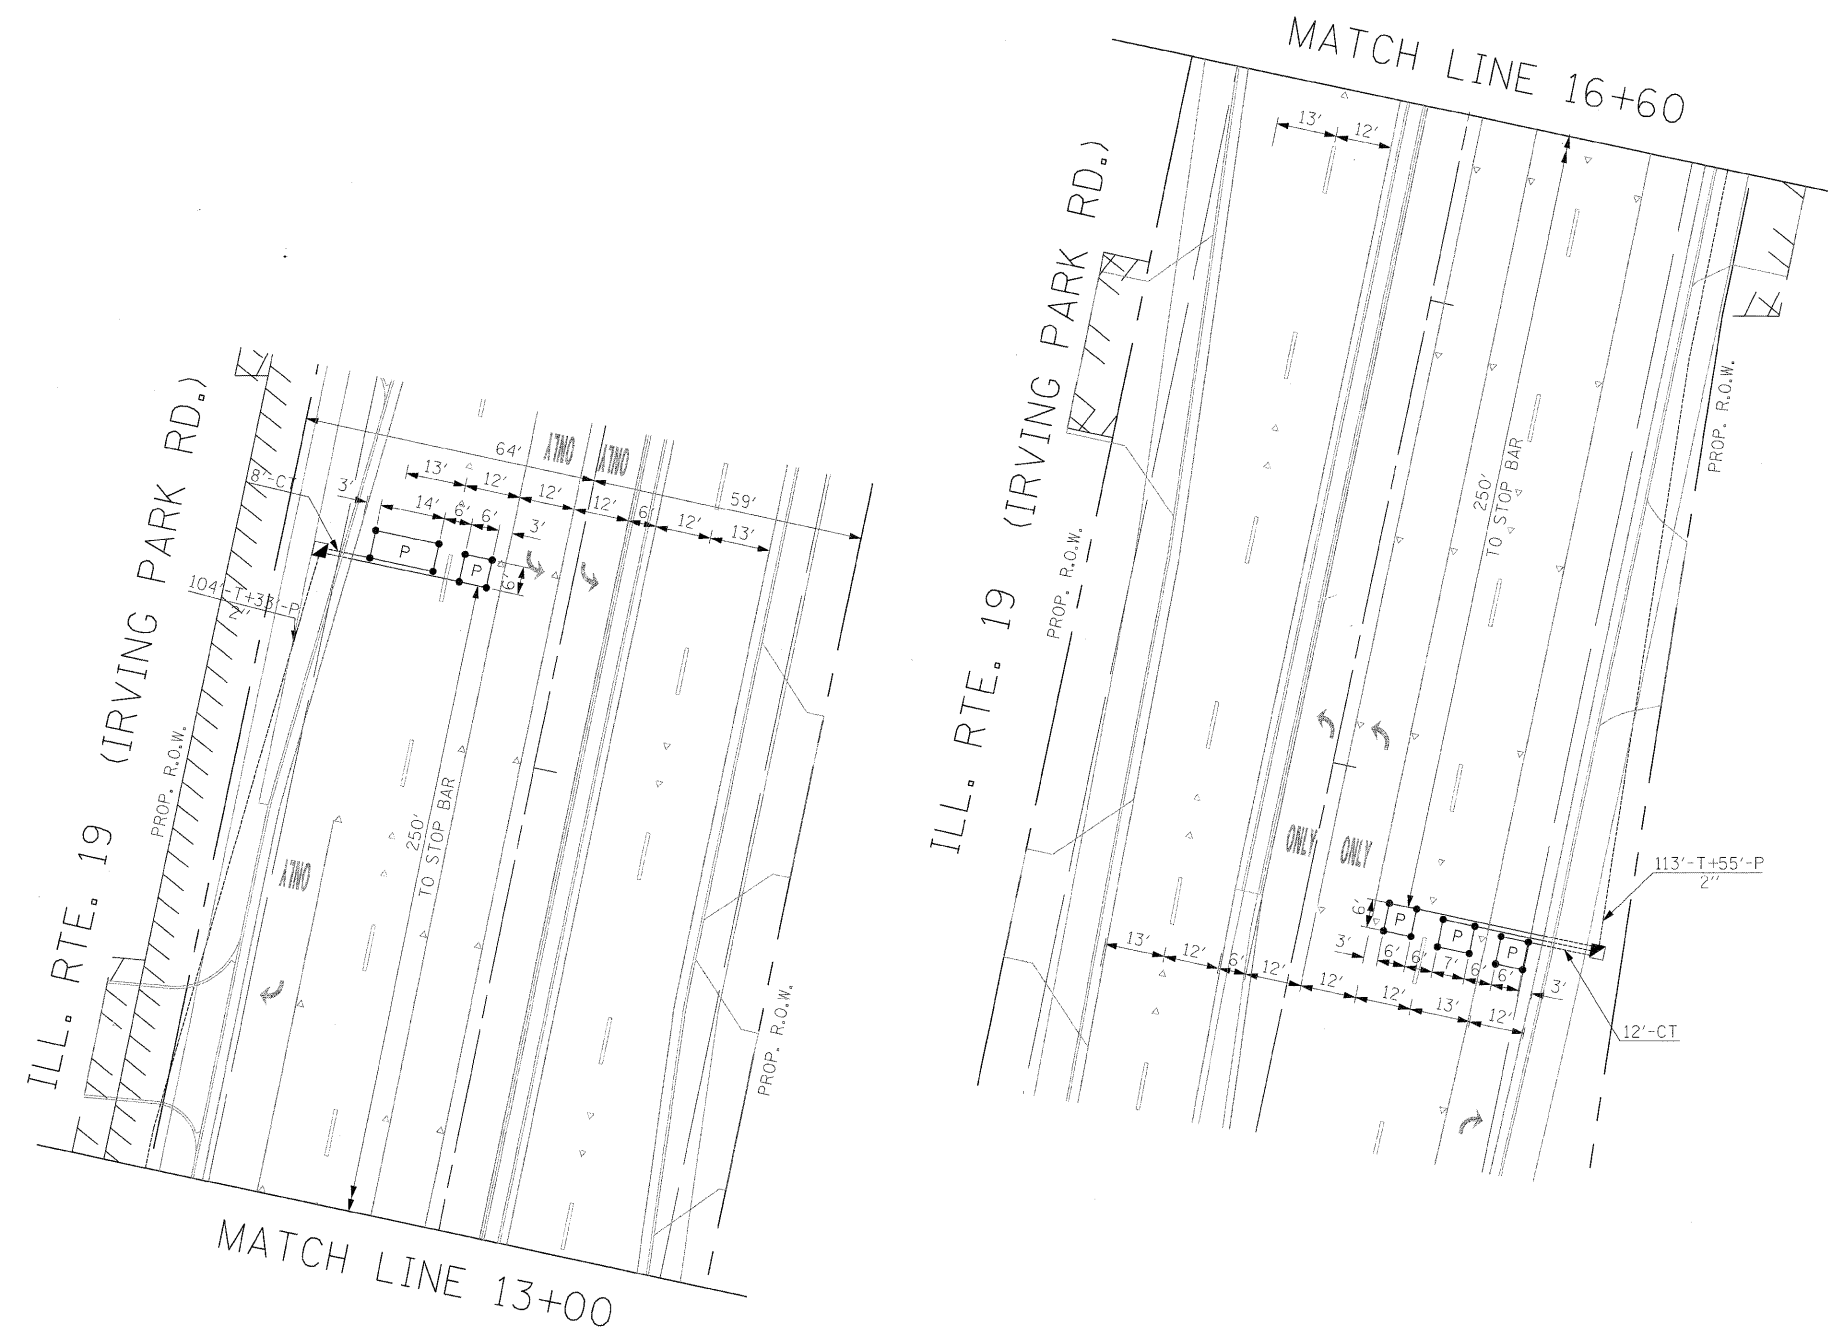

THE TRAFFIC SIGNAL CONTROL EQUIPMENT FOR THIS PROJECT SHALL BE "ECONOLITE" TO MATCH THE EXISTING ADJACENT SYSTEM.

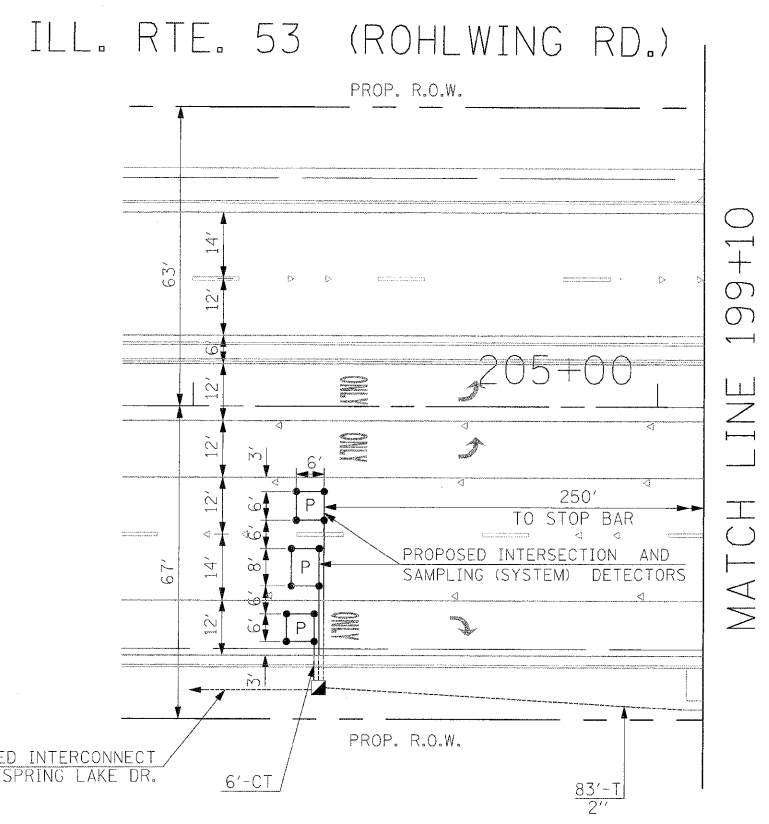


| | | | |
|-----------------------|--------------------|-------------------|-----------|
| FILE NAME = #FILE# | USER NAME = #USER# | DESIGNED - PKG | REVISED - |
| | | DRAWN - MAA, EA | REVISED - |
| | | CHECKED - PKG, EA | REVISED - |
| | | DATE - 5/10/2010 | REVISED - |

**STATE OF ILLINOIS
DEPARTMENT OF TRANSPORTATION**

**PROPOSED TRAFFIC SIGNAL INSTALLATION PLAN
ILLINOIS ROUTE 53 (ROHLWING RD.) AT ILL. RTE. 19 (IRVING PARK RD.)
(SHEET 2 OF 2).**

| | | | | |
|---|-----------------|------------------|---------------------|------------------|
| F.A.P. RTE. 2578 | SECTION 532B | COUNTY DuPage | TOTAL SHEETS 781 | SHEET NO. 485 |
| FED. ROAD DIST. NO. - ILLINOIS FED. AID PROJECT | | | CONTRACT NO. 60477 | |

SCALE: 1"=20' SHEET NO. 0' SHEETS STA. TO STA.

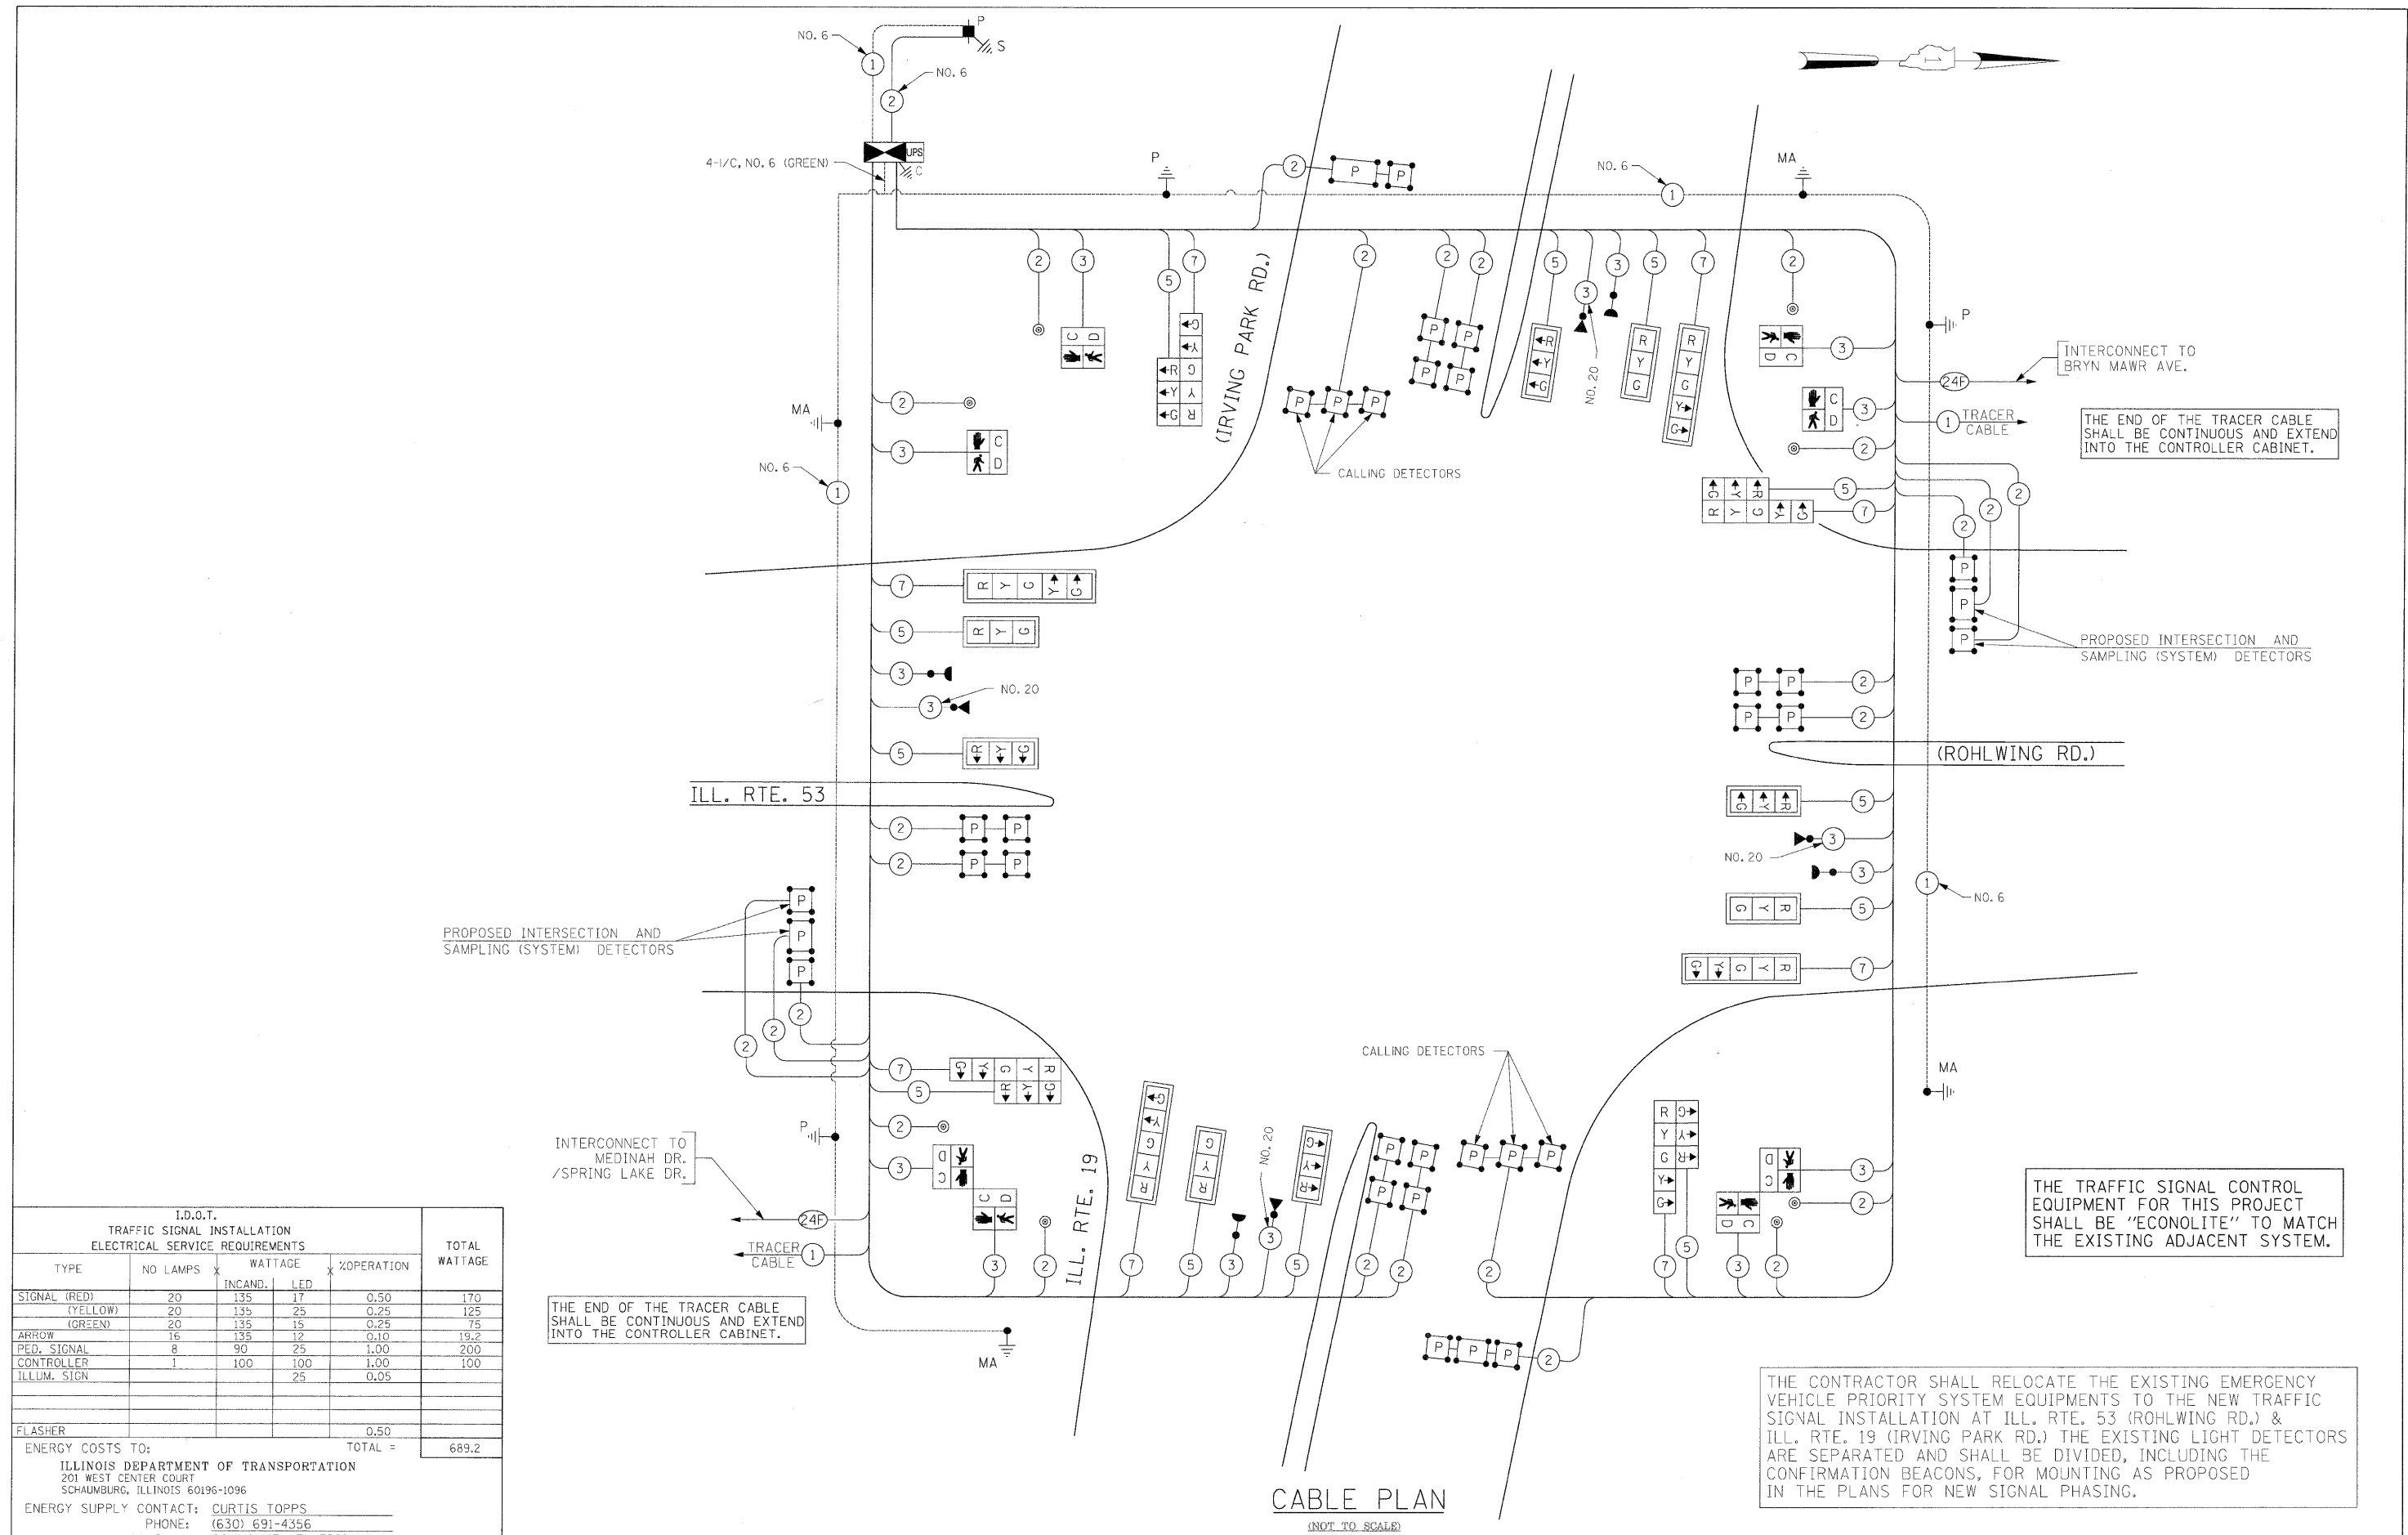

THE END OF THE TRACER CABLE SHALL BE CONTINUOUS AND EXTEND INTO THE CONTROLLER CABINET.

PROPOSED INTERSECTION AND SAMPLING (SYSTEM) DETECTORS

PROPOSED INTERSECTION AND SAMPLING (SYSTEM) DETECTORS

INTERCONNECT TO MEDINAH DR. / SPRING LAKE DR.

THE END OF THE TRACER CABLE SHALL BE CONTINUOUS AND EXTEND INTO THE CONTROLLER CABINET.

THE TRAFFIC SIGNAL CONTROL EQUIPMENT FOR THIS PROJECT SHALL BE "ECONOLITE" TO MATCH THE EXISTING ADJACENT SYSTEM.

THE CONTRACTOR SHALL RELOCATE THE EXISTING EMERGENCY VEHICLE PRIORITY SYSTEM EQUIPMENTS TO THE NEW TRAFFIC SIGNAL INSTALLATION AT ILL. RTE. 53 (ROHLWING RD.) & ILL. RTE. 19 (IRVING PARK RD.) THE EXISTING LIGHT DETECTORS ARE SEPARATED AND SHALL BE DIVIDED, INCLUDING THE CONFIRMATION BEACONS, FOR MOUNTING AS PROPOSED IN THE PLANS FOR NEW SIGNAL PHASING.

| I.D.O.T. TRAFFIC SIGNAL INSTALLATION ELECTRICAL SERVICE REQUIREMENTS | | | | | TOTAL WATTAGE | |
|--|----------|---------|-----|------------|------------------|-------|
| TYPE | NO LAMPS | WATTAGE | | %OPERATION | | |
| SIGNAL (RED) | 20 | INCAND. | 135 | 17 | 0.50 | 170 |
| (YELLOW) | 20 | INCAND. | 135 | 25 | 0.25 | 125 |
| (GREEN) | 20 | INCAND. | 135 | 15 | 0.25 | 75 |
| ARROW | 16 | INCAND. | 135 | 12 | 0.10 | 19.2 |
| PED. SIGNAL | 8 | LED | 90 | 25 | 1.00 | 200 |
| CONTROLLER | 1 | LED | 100 | 100 | 1.00 | 100 |
| ILLUM. SIGN | | LED | | 25 | 0.05 | |
| FLASHER | | | | | 0.50 | |
| ENERGY COSTS TO: | | | | | TOTAL = | 689.2 |

ILLINOIS DEPARTMENT OF TRANSPORTATION
201 WEST CENTER COURT
SCHAUMBURG, ILLINOIS 60196-1096

ENERGY SUPPLY CONTACT: CURTIS TOPPS
PHONE: (630) 691-4356
COMPANY: COMMONWEALTH EDISON

CABLE PLAN
(NOT TO SCALE)



SCHEDULE OF QUANTITIES

| QUANTITY | UNIT | ITEM |
|----------|-------|---|
| 58 | SQ FT | SIGN PANEL - TYPE 1 |
| 30 | SQ FT | SIGN PANEL - TYPE 2 |
| 848 | FOOT | CONDUIT IN TRENCH, 2" DIA., GALVANIZED STEEL |
| 36 | FOOT | CONDUIT IN TRENCH, 2 1/2" DIA., GALVANIZED STEEL |
| 43 | FOOT | CONDUIT IN TRENCH, 3" DIA., GALVANIZED STEEL |
| 29 | FOOT | CONDUIT IN TRENCH, 4" DIA., GALVANIZED STEEL |
| 501 | FOOT | CONDUIT PUSHED, 2" DIA., GALVANIZED STEEL |
| 488 | FOOT | CONDUIT PUSHED, 4" DIA., GALVANIZED STEEL |
| 5 | EACH | HANDHOLE |
| 4 | EACH | HEAVY-DUTY HANDHOLE |
| 3 | EACH | DOUBLE HANDHOLE |
| 928 | FOOT | TRENCH AND BACKFILL FOR ELECTRICAL WORK |
| 1 | EACH | FULL-ACTUATED CONTROLLER AND TYPE IV CABINET, SPECIAL |
| 1 | EACH | TRANSCEIVER-FIBER OPTIC |
| 1753 | FOOT | ELECTRIC CABLE IN CONDUIT, SIGNAL NO. 14 2C |
| 2938 | FOOT | ELECTRIC CABLE IN CONDUIT, SIGNAL NO. 14 3C |
| 3161 | FOOT | ELECTRIC CABLE IN CONDUIT, SIGNAL NO. 14 5C |
| 1955 | FOOT | ELECTRIC CABLE IN CONDUIT, SIGNAL NO. 14 7C |
| 5699 | FOOT | ELECTRIC CABLE IN CONDUIT, LEAD-IN, NO. 14 1 PAIR |
| 83 | FOOT | ELECTRIC CABLE IN CONDUIT, SERVICE, NO. 6 2C |
| 3 | EACH | TRAFFIC SIGNAL POST, GALVANIZED STEEL 16 FT. |
| 1 | EACH | STEEL MAST ARM ASSEMBLY AND POLE, 52 FT. |
| 2 | EACH | STEEL MAST ARM ASSEMBLY AND POLE, 56 FT. |
| 1 | EACH | STEEL MAST ARM ASSEMBLY AND POLE, 64 FT. |
| 12 | FOOT | CONCRETE FOUNDATION, TYPE A |
| 4 | FOOT | CONCRETE FOUNDATION, TYPE C |
| 15 | FOOT | CONCRETE FOUNDATION, TYPE E 36-INCH DIAMETER |
| 63 | FOOT | CONCRETE FOUNDATION, TYPE E 42-INCH DIAMETER |
| 8 | EACH | SIGNAL HEAD, LED, 1-FACE, 3-SECTION, MAST ARM MOUNTED |
| 4 | EACH | SIGNAL HEAD, LED, 1-FACE, 5-SECTION, MAST ARM MOUNTED |
| 4 | EACH | SIGNAL HEAD, LED, 2-FACE, 1-3 SECTION, 1-5 SECTION, BRACKET MOUNTED |
| 2 | EACH | PEDESTRIAN SIGNAL HEAD, LED, 1-FACE, BRACKET MOUNTED WITH COUNTDOWN TIMER |
| 3 | EACH | PEDESTRIAN SIGNAL HEAD, LED, 2-FACE, BRACKET MOUNTED WITH COUNTDOWN TIMER |
| 12 | EACH | TRAFFIC SIGNAL BACKPLATE, LOUVERED, ALUMINUM |
| 18 | EACH | INDUCTIVE LOOP DETECTOR |
| 8 | EACH | PEDESTRIAN PUSH-BUTTON |
| 1 | EACH | TEMPORARY TRAFFIC SIGNAL INSTALLATION |
| 2 | EACH | RELOCATE EXISTING EMERGENCY VEHICLE PRIORITY SYSTEM, DETECTOR UNIT |
| 1 | EACH | RELOCATE EXISTING EMERGENCY VEHICLE PRIORITY SYSTEM, PHASING UNIT |
| 1 | EACH | REMOVE EXISTING TRAFFIC SIGNAL EQUIPMENT |
| 13 | EACH | REMOVE EXISTING HANDHOLE |
| 9 | EACH | REMOVE EXISTING CONCRETE FOUNDATION |
| 1195 | FOOT | PREFORMED DETECTOR LOOP |
| 1 | EACH | TEMPORARY TRAFFIC SIGNAL TIMING |
| 1 | EACH | SERVICE INSTALLATION - POLE MOUNTED |
| 1 | EACH | UNINTERRUPTIBLE POWER SUPPLY |
| 836 | FOOT | ELECTRIC CABLE IN CONDUIT, GROUNDING, NO. 6 1C |
| 1129 | FOOT | ELECTRIC CABLE IN CONDUIT NO. 20 3/C, TWISTED, SHIELDED |

* 100% COST TO VILLAGE OF ADDISON

THE CONTRACTOR SHALL RELOCATE THE EXISTING EMERGENCY VEHICLE PRIORITY SYSTEM EQUIPMENTS TO THE NEW TRAFFIC SIGNAL INSTALLATION AT ILL. RTE. 53 (ROHLWING RD.) & ILL. RTE. 19 (IRVING PARK RD.) THE EXISTING LIGHT DETECTORS ARE SEPARATED AND SHALL BE DIVIDED, INCLUDING THE CONFIRMATION BEACONS, FOR MOUNTING AS PROPOSED IN THE PLANS FOR NEW SIGNAL PHASING.

THE TRAFFIC SIGNAL CONTROL EQUIPMENT FOR THIS PROJECT SHALL BE "ECONOLITE" TO MATCH THE EXISTING ADJACENT SYSTEM.

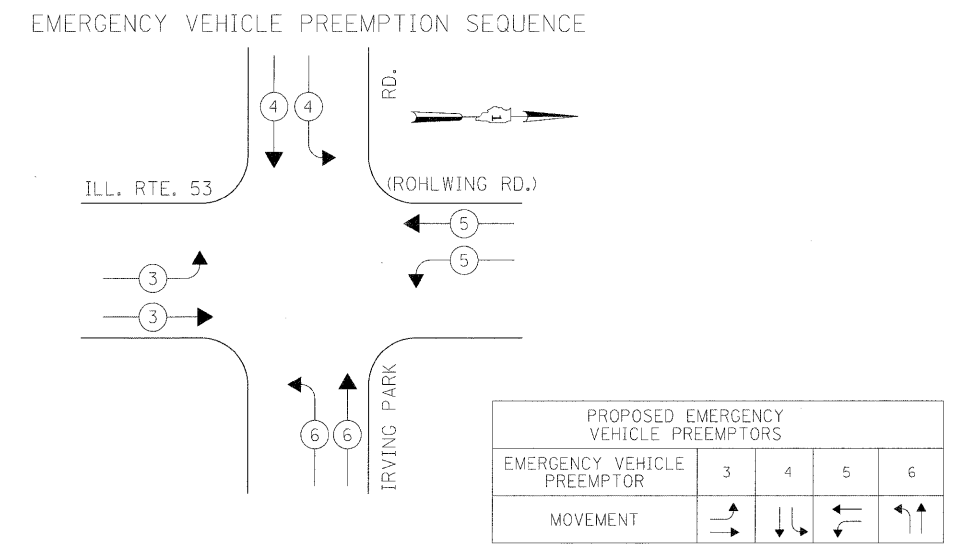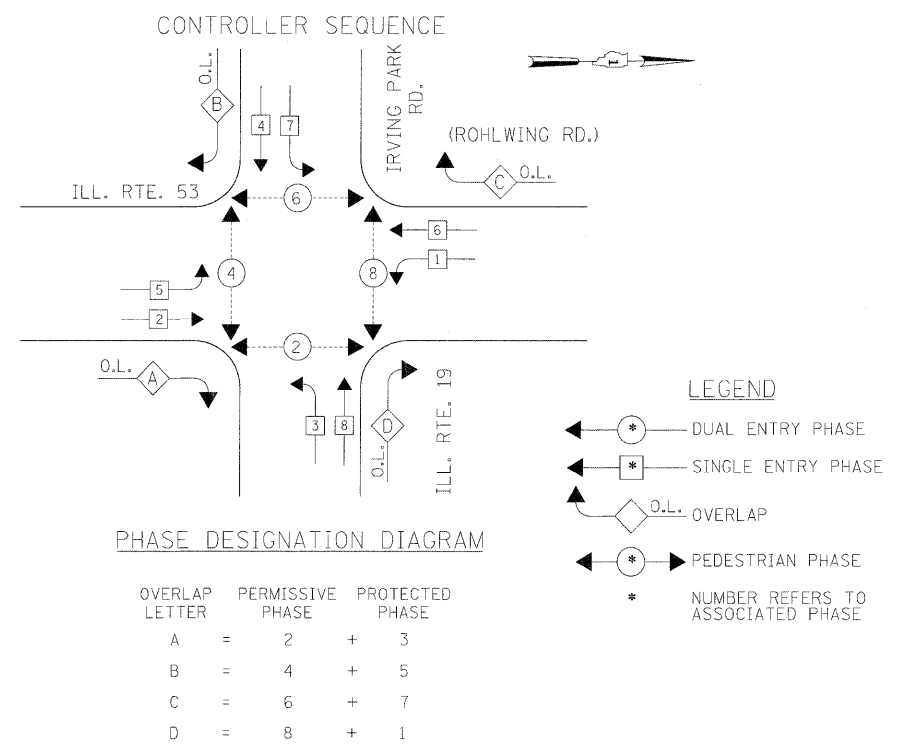

NOTES FOR TEMPORARY TRAFFIC SIGNALS




1. ALL CONTROL EQUIPMENT INCLUDING EMERGENCY PRE-EMPTION AND COMMUNICATION DEVICES FOR THE TEMPORARY TRAFFIC SIGNAL(S) SHALL BE FURNISHED BY THE CONTRACTOR.
2. ONLY CONTROLLERS SUPPLIED BY ONE OF THE DISTRICT APPROVED CLOSED LOOP EQUIPMENT MANUFACTURERS WILL BE APPROVED FOR USE AT TEMPORARY SIGNAL LOCATIONS. ALL CONTROLLERS USED FOR TEMPORARY TRAFFIC SIGNALS SHALL BE FULLY ACTUATED NEMA MICROPROCESSOR BASED WITH RS232 DATA ENTRY PORTS COMPATIBLE WITH EXISTING MONITORING SOFTWARE APPROVED BY IDOT DISTRICT 1, INSTALLED IN A NEMA 1S2 CABINET. ONLY ONE BRAND OF CONTROLLER WILL BE ACCEPTED FOR ANY ONE CONTRACT.
3. ALL TRAFFIC SIGNAL SECTIONS AND PEDESTRIAN SIGNAL SECTIONS SHALL BE LED AND 12" (300mm) DIAMETER. HEADS SHALL BE PLACED AS INDICATED ON THE TEMPORARY TRAFFIC SIGNAL PLAN OR AS DIRECTED BY THE ENGINEER. PEDESTRIAN SIGNALS SHALL INCLUDE SOLID INTERNATIONAL SYMBOLS. PEDESTRIAN SIGNALS WITH COUNTDOWN TIMERS SHALL BE USED WHEN THE EXISTING INSTALLATION UTILIZES COUNTDOWN TYPE OR AS DIRECTED BY THE ENGINEER. COUNTDOWN TYPE PEDESTRIAN SIGNALS ARE NOT TO BE INSTALLED AT A RAILROAD INTERSECTION. THE CONTRACTOR SHALL FURNISH ENOUGH CABLE SLACK TO RELOCATE HEADS TO ANY POSITION ON THE SPAN WIRE OR AT LOCATIONS ILLUSTRATED ON THE PLANS FOR CONSTRUCTION STAGING. THE TEMPORARY TRAFFIC SIGNAL SHALL REMAIN IN OPERATION DURING ALL SIGNAL HEAD RELOCATIONS. EACH TEMPORARY TRAFFIC SIGNAL HEAD SHALL HAVE ITS OWN CABLE FROM THE CONTROLLER CABINET TO THE SIGNAL HEAD.
4. ALL EXISTING STREET NAME AND INTERSECTION REGULATORY SIGNS SHALL BE REMOVED FROM EXISTING POLES, RELOCATED AND SECURELY FASTENED TO THE SPAN WIRE OR WOOD POLE AS DIRECTED BY THE ENGINEER.
5. ANY TEMPORARY SIGNAL WITHIN AN EXISTING CLOSED LOOP TRAFFIC SIGNAL SYSTEM SHALL BE INTERCONNECTED TO THAT SYSTEM USING SIMILAR BRAND CONTROL EQUIPMENT.
6. THE TEMPORARY TRAFFIC SIGNAL SHALL HAVE THE SIGNAL HEAD DISPLAYS, SIGNAL HEAD PLACEMENTS AND CONTROLLER PHASING MATCH THE EXISTING TRAFFIC SIGNAL, AT THE TIME OF THE TURN ON, IF NO TRAFFIC STAGING IS IN PLACE OR WILL NOT BE STAGED ON THE DAY OF THE TURN ON.
7. UNINTERRUPTIBLE POWER SUPPLY (UPS) SYSTEMS SHALL BE INSTALLED AND MADE OPERATIONAL AT TEMPORARY TRAFFIC SIGNAL INSTALLATIONS WHERE UPS IS INSTALLED AT THE EXISTING TRAFFIC SIGNAL, TEMPORARY TRAFFIC SIGNALS AT RAILROAD INTERSECTIONS, AND TEMPORARY TRAFFIC SIGNALS AT INTERSECTIONS WITH FIRE STATION ACTUATED EMERGENCY VEHICLE PRE-EMPTION, OR WHEN INDICATED ON THE PLANS.
8. TRAFFIC SIGNAL MANAGEMENT SYSTEMS SHALL BE MAINTAINED IN OPERATION AS INDICATED ON THE PLANS OR AS DIRECTED BY THE ENGINEER. REQUIRED EQUIPMENT SHALL BE AS SHOWN ON THE PLANS AND THE CONTRACTOR SHALL PLACE THE EQUIPMENT IN OPERATION TO THE SATISFACTION OF THE ENGINEER AND THE AGENCY RESPONSIBLE FOR THE TRAFFIC SIGNAL MANAGEMENT SYSTEM.
9. DETECTION AT TEMPORARY TRAFFIC SIGNALS SHALL BE INCLUDED FOR ALL APPROACHES OF THE INTERSECTION UNLESS INDICATED OTHERWISE ON THE PLANS. THE DETECTION SYSTEM MUST MEET THE SPECIFICATIONS OF DISTRICT 1 AND THE CONTRACTOR SHALL PLACE THE DETECTORS INTO OPERATION TO THE SATISFACTION OF THE ENGINEER.
10. WHEN PAN, TILT, ZOOM CAMERAS ARE INSTALLED AT THE EXISTING INTERSECTION OR ARE CALLED FOR IN THE PLANS, THE CONTRACTOR SHALL BE RESPONSIBLE FOR INSTALLING AND MAINTAINING THE CAMERAS TO THE SATISFACTION OF THE ENGINEER AND THE AGENCY RESPONSIBLE FOR THE CAMERAS.

NOTE: THE VIDEO DETECTION ZONES SHOWN ON THE PLANS ARE FOR CONSTRUCTION STAGE 1 - SUBSTAGE 1 AND SHALL BE REDEFINED FOR EACH CONSTRUCTION STAGE AS A PART OF "TEMPORARY TRAFFIC SIGNAL INSTALLATION" WORK.

THE FOLLOWING ITEMS SHALL BE REMOVED BY THE CONTRACTOR AND SHALL BE DISPOSED OF BY THEM OUTSIDE THE RIGHT-OF-WAY AT THEIR EXPENSE. THE SALVAGE VALUE OF THE REMOVED EQUIPMENT SHALL BE REFLECTED IN THE CONTRACTOR'S BID PRICE.

- 1 EACH CONTROLLER AND CABINET COMPLETE
- 2 EACH SIGNAL HEAD, 1-FACE 3-SECTION, MAST ARM MOUNTED
- 2 EACH SIGNAL HEAD, 1-FACE 5-SECTION, BRACKET MOUNTED
- 4 EACH SIGNAL HEAD, 1-FACE 5-SECTION, MAST ARM MOUNTED
- 2 EACH SIGNAL HEAD, 2-FACE, 1-3 SECTION, 1-5 SECTION, BRACKET MOUNTED
- 6 EACH TRAFFIC SIGNAL BACKPLATE
- 4 EACH TRAFFIC SIGNAL POST
- 4 EACH STEEL MAST ARM ASSEMBLY AND POLE
- 1 EACH SERVICE INSTALLATION

THE CONTRACTOR SHALL RELOCATE THE EXISTING EMERGENCY VEHICLE PRIORITY SYSTEM EQUIPMENTS TO THE NEW TRAFFIC SIGNAL INSTALLATION AT ILL. RTE. 53 (ROHLWING RD.) & BRYN MAWR AVE.

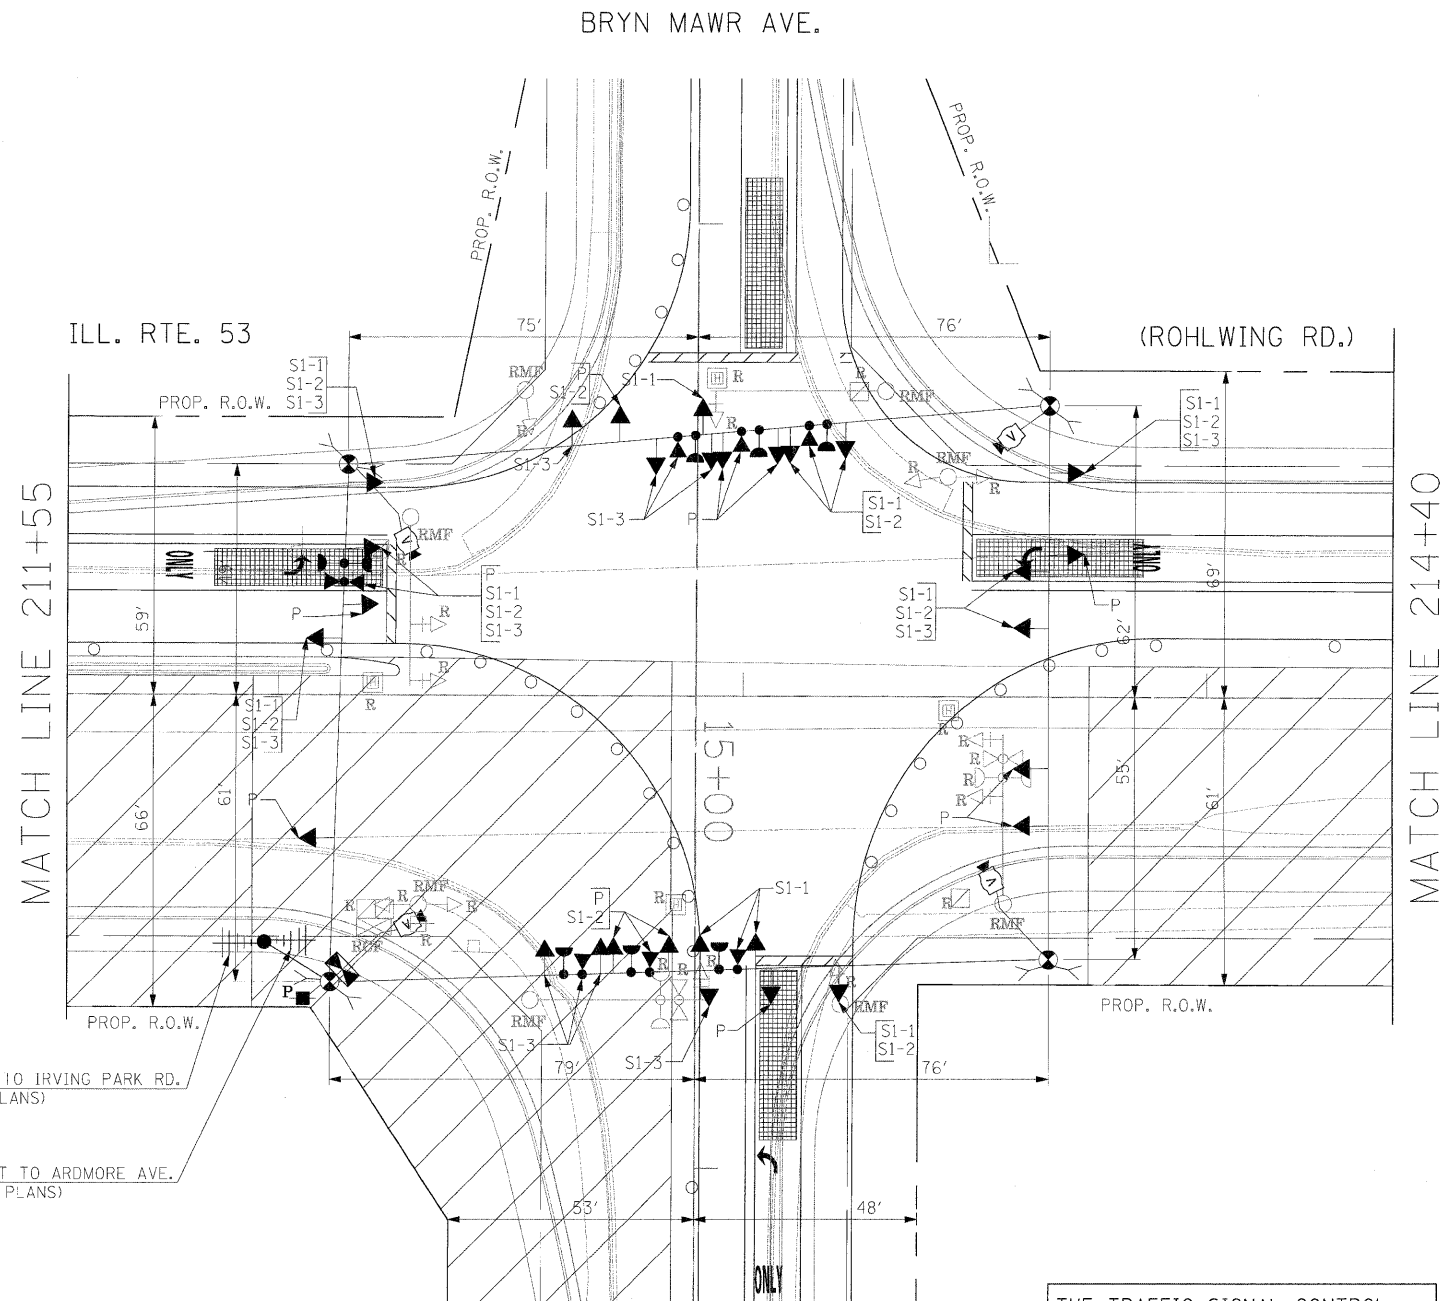



TEMPORARY RADIO INTERCONNECT TO IRVING PARK RD.
(SEE TEMPORARY INTERCONNECT PLANS)

TEMPORARY RADIO INTERCONNECT TO ARDMORE AVE.
(SEE TEMPORARY INTERCONNECT PLANS)

SIGNAL HEAD PLACEMENTS FOR STAGES: PRE-STAGE S1-1, S1-2, AND S1-3.

THE TRAFFIC SIGNAL CONTROL EQUIPMENT FOR THIS PROJECT SHALL BE "ECONOLITE" TO MATCH THE EXISTING ADJACENT SYSTEM.

| | | | | | | | | | | | |
|-------------|----------------------|-------------------|-----------|---|--|--------------------|---------------------|--------|--------------|--|--|
| FILE NAME = | USER NAME = #USER# | DESIGNED - PKG | REVISED - | STATE OF ILLINOIS DEPARTMENT OF TRANSPORTATION | TEMPORARY TRAFFIC SIGNAL INSTALLATION AND REMOVAL PLAN ILLINOIS ROUTE 53 (ROHLWING RD.) AT BRYN MAWR AVE. PRE STAGE AND STAGE 1 (SHEET 1 OF 4). | F.A.P. RTE. | SECTION | COUNTY | TOTAL SHEETS | SHEET NO. | |
| #FILE# | | DRAWN - MAA, EA | REVISED - | | | 2578 | 532B | DuPage | 781 | 488 | |
| | PLOT SCALE = #SCALE# | CHECKED - PKG, EA | REVISED - | | | CONTRACT NO. 60477 | | | | | |
| | PLOT DATE = #DATE# | DATE - 5/10/2010 | REVISED - | | | SCALE: | SHEET NO. OF SHEETS | STA. | TO STA. | FED. DIST. NO. - ILLINOIS FED. AID PROJECT | |

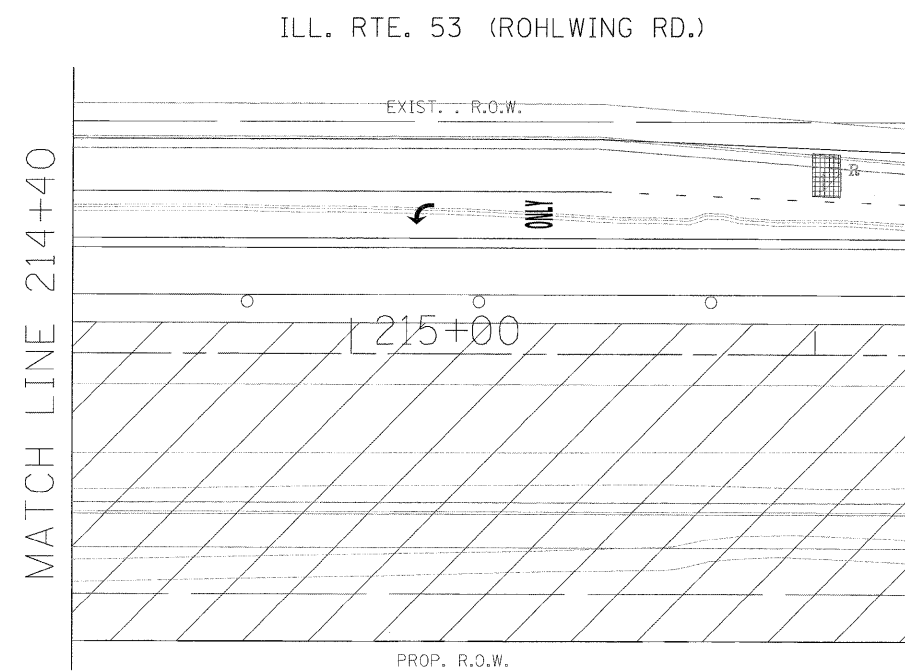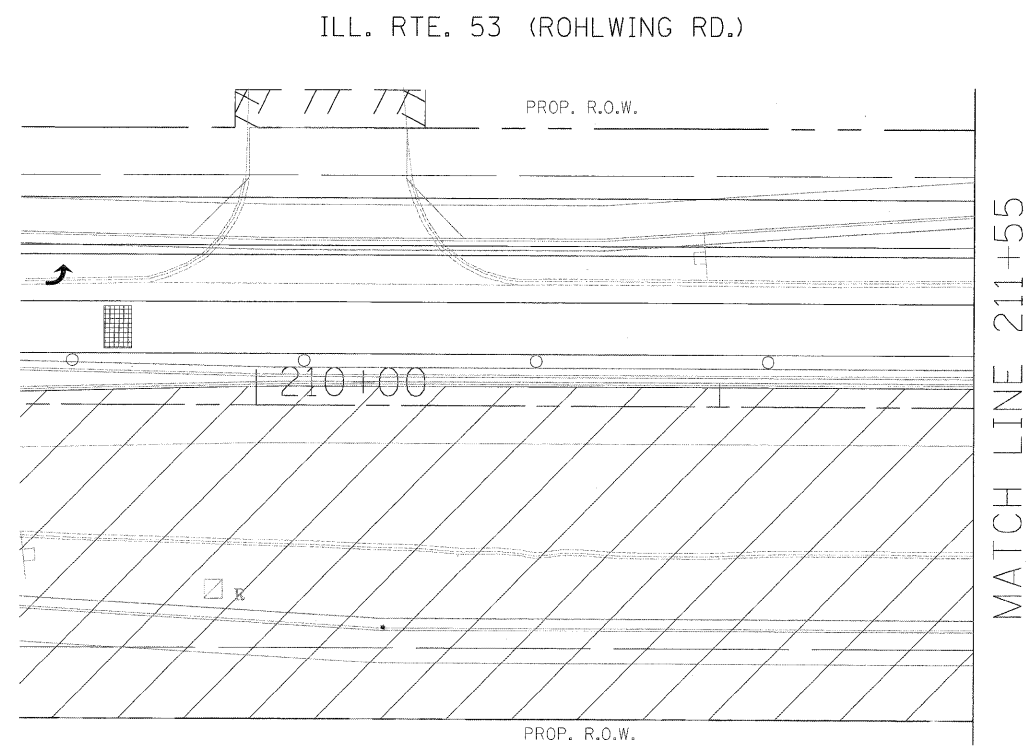

NOTE: THE VIDEO DETECTION ZONES SHOWN ON THE PLANS ARE FOR CONSTRUCTION STAGE 1 - SUBSTAGE 1 AND SHALL BE REDEFINED FOR EACH CONSTRUCTION STAGE AS A PART OF "TEMPORARY TRAFFIC SIGNAL INSTALLATION" WORK.


| | | | |
|-----------------------|--------------------|-------------------|-----------|
| FILE NAME = #FILE# | USER NAME = #USER# | DESIGNED - PKG | REVISED - |
| | | DRAWN - MAA, EA | REVISED - |
| | | CHECKED - PKG, EA | REVISED - |
| | | DATE - 5/10/2010 | REVISED - |

**STATE OF ILLINOIS
DEPARTMENT OF TRANSPORTATION**


**TEMPORARY TRAFFIC SIGNAL INSTALLATION AND REMOVAL PLAN
ILLINOIS ROUTE 53 (ROHLWING RD.) AT BRYN MAWR AVE. PRE STAGE
AND STAGE 1 (SHEET 2 OF 4)**

| | | | | |
|---|-----------------|------------------|---------------------|------------------|
| F.A.P. RTE. 2578 | SECTION 532B | COUNTY DuPage | TOTAL SHEETS 781 | SHEET NO. 489 |
| FED. ROAD DIST. NO. - ILLINOIS FED. AID PROJECT | | | CONTRACT NO. 60477 | |

SCALE: SHEET NO. OF SHEETS STA. 1"=20' TO STA.

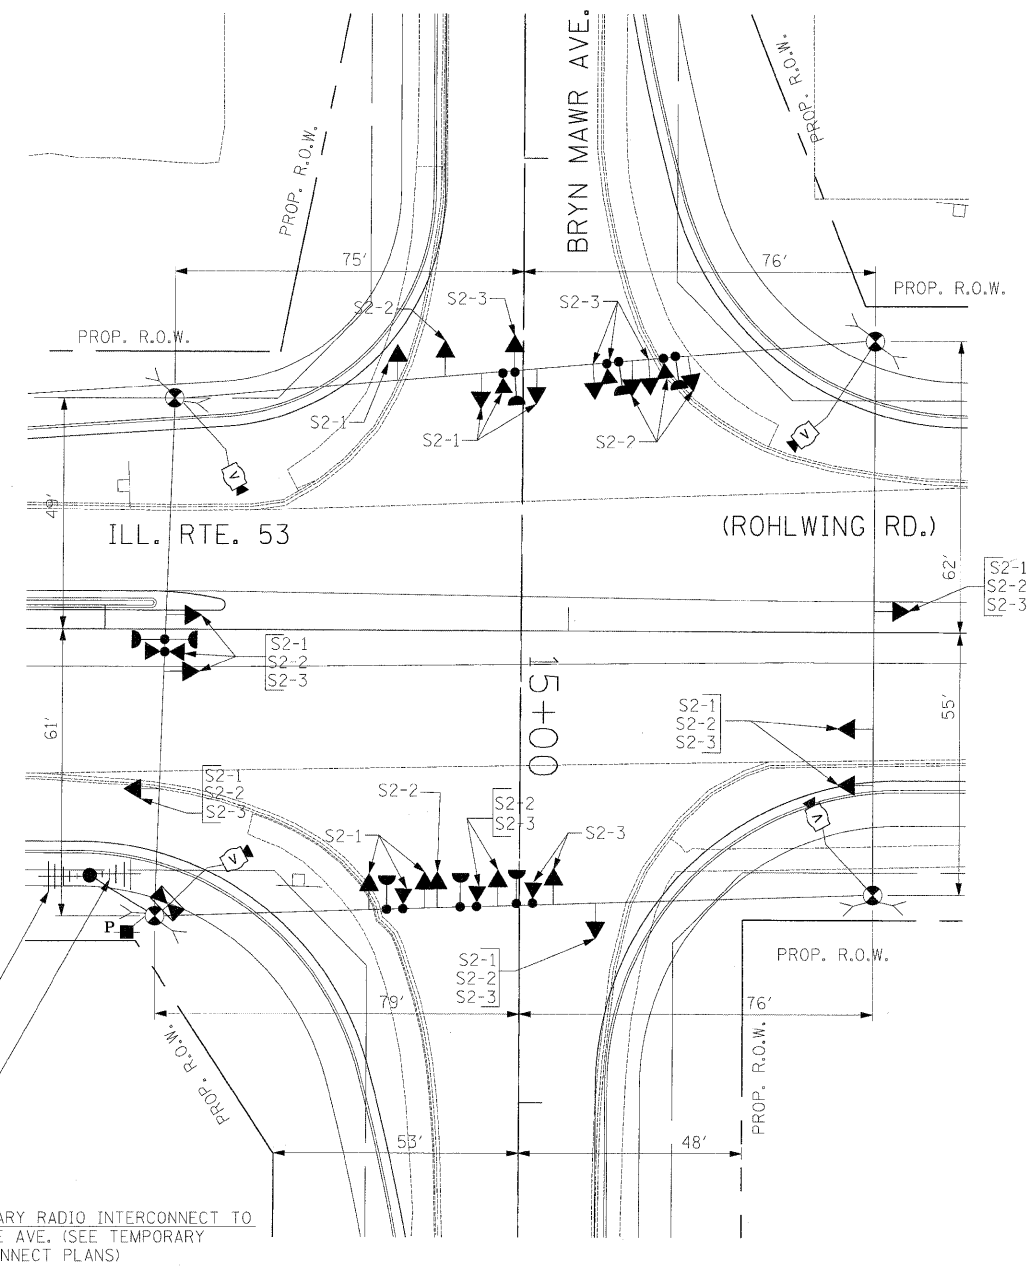

SIGNAL HEAD PLACEMENTS FOR STAGES: S2-1, S2-2, AND S2-3.

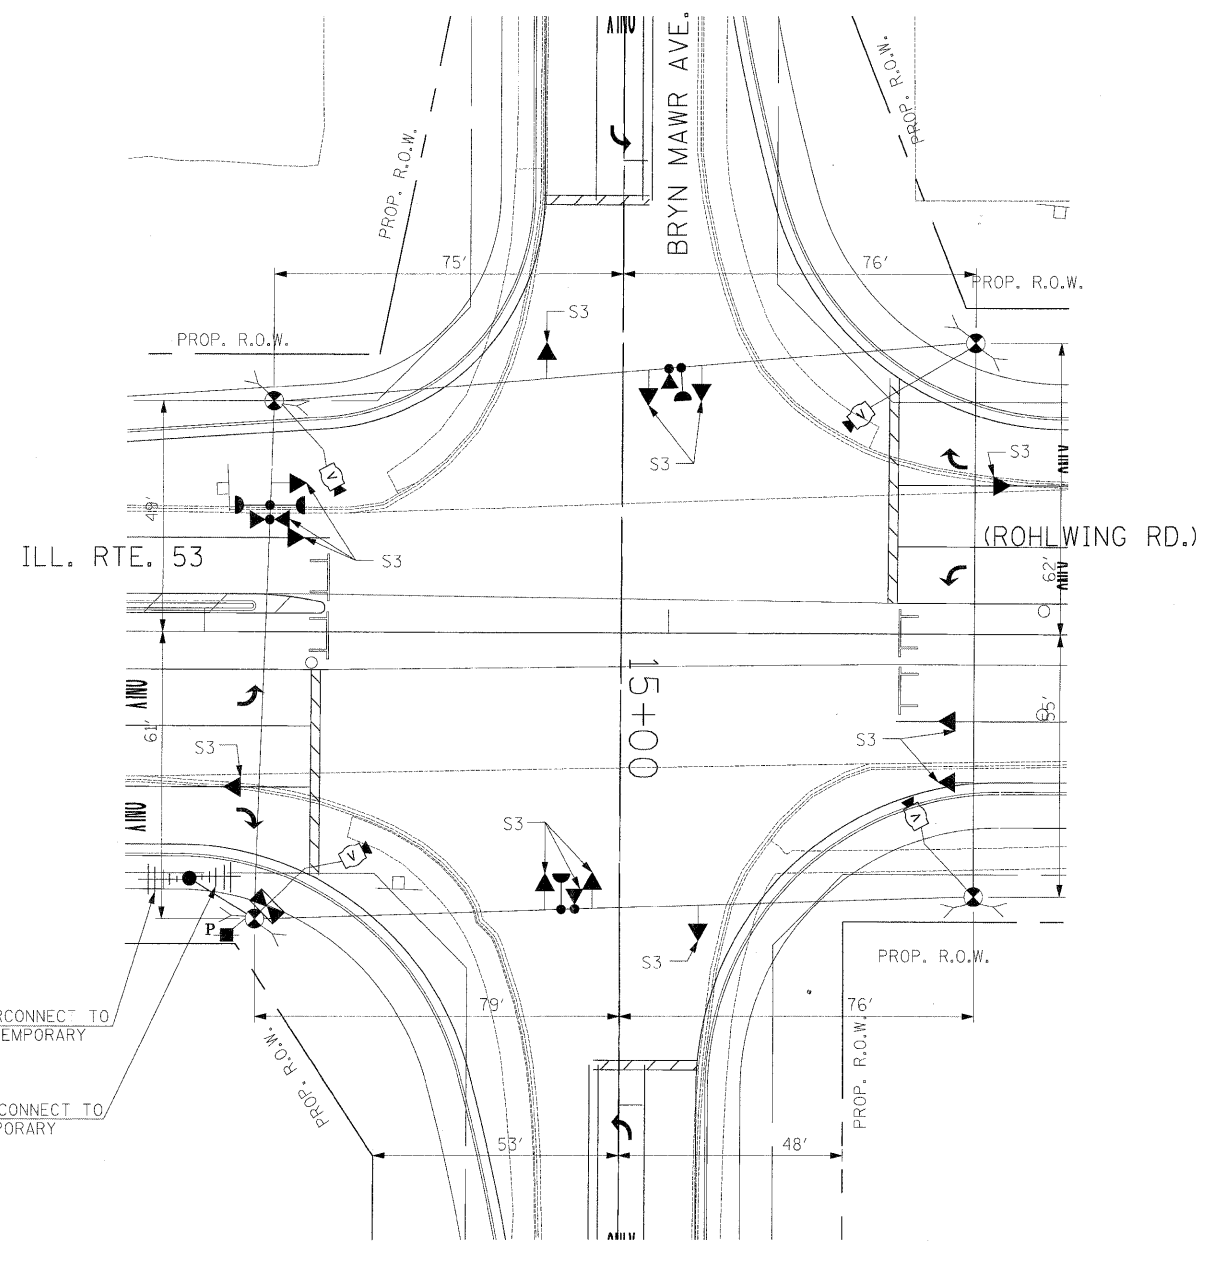

SIGNAL HEAD PLACEMENTS FOR STAGE S3

TEMPORARY RADIO INTERCONNECT TO IRVING PARK RD. (SEE TEMPORARY INTERCONNECT PLANS)

TEMPORARY RADIO INTERCONNECT TO ARDMORE AVE. (SEE TEMPORARY INTERCONNECT PLANS)


TEMPORARY RADIO INTERCONNECT TO ARDMORE AVE. (SEE TEMPORARY INTERCONNECT PLANS)

TEMPORARY RADIO INTERCONNECT TO IRVING PARK RD. (SEE TEMPORARY INTERCONNECT PLANS)

NOTE: THE VIDEO DETECTION ZONES SHOWN ON THE PLANS ARE FOR CONSTRUCTION STAGE 1 - SUBSTAGE 1 AND SHALL BE REDEFINED FOR EACH CONSTRUCTION STAGE AS A PART OF "TEMPORARY TRAFFIC SIGNAL INSTALLATION" WORK.

THE TRAFFIC SIGNAL CONTROL EQUIPMENT FOR THIS PROJECT SHALL BE "ECONOLITE" TO MATCH THE EXISTING ADJACENT SYSTEM.


| | | | | | | | | | | | | |
|------------------------|----------------------|-------------------|-----------|---|--|---------------------|--------------|---|-----------------|------------------|------------------------|---------------------|
| FILE NAME = #FILEL# | USER NAME = #USER# | DESIGNED - PKG | REVISED - | STATE OF ILLINOIS DEPARTMENT OF TRANSPORTATION | TEMPORARY TRAFFIC SIGNAL INSTALLATION AND REMOVAL PLAN ILLINOIS ROUTE 53 (ROHLWING RD.) AT BRYN MAWR AVE. STAGE 2 AND STAGE 3 (SHEET 3 OF 4). | | | F.A.P. RTE. 2578 | SECTION 532B | COUNTY DuPage | TOTAL SHEETS 781 | SHEET NO. 490 |
| | PLOT SCALE = #SCALE# | DRAWN - MAA, EA | REVISED - | | SCALE: 1"=20' | SHEET NO. OF SHEETS | STA. TO STA. | FED. ROAD DIST. NO. - [ILLINOIS] FED. AID PROJECT | | | | |
| | PLOT DATE = #DATE# | CHECKED - PKG, EA | REVISED - | | | | | CONTRACT NO. 60477 | | | | |
| | | DATE - 5/10/2010 | REVISED - | | | | | | | | | |

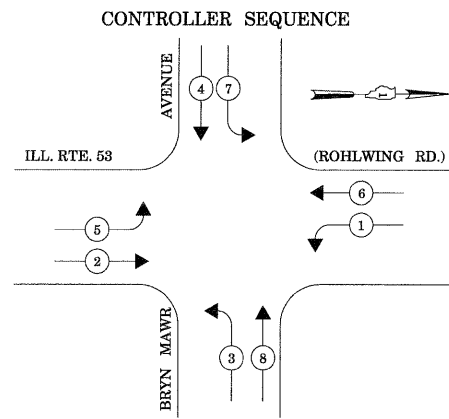



CONTROLLER SEQUENCE

TEMPORARY PHASE DESIGNATION DIAGRAM
STAGES: PRE-STAGE, S1-1, S1-2, S1-3, S2-1, S2-2, S3,
AND AFTER PROPOSED GEOMETRICS ARE BUILT

EMERGENCY VEHICLE PREEMPTION SEQUENCE

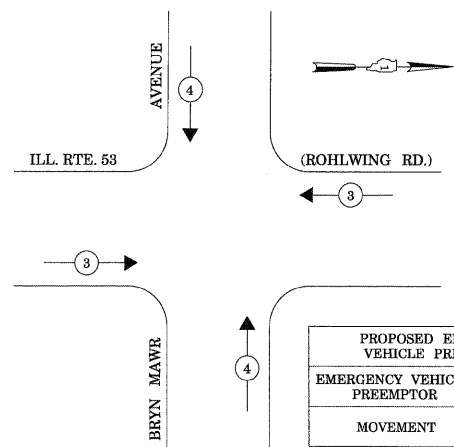


STAGES: PRE-STAGE, S1-1, S1-2, S1-3, S2-1, S2-2, S2-3, S3,
AND AFTER PROPOSED GEOMETRICS ARE BUILT

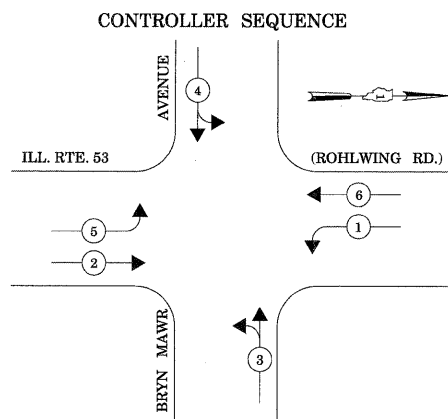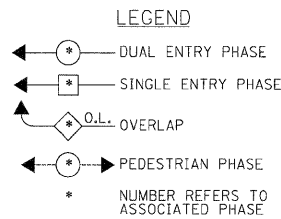

CONTROLLER SEQUENCE

TEMPORARY PHASE DESIGNATION DIAGRAM
STAGES: STAGE 2 - SUBSTAGE 3


EMERGENCY VEHICLE PREEMPTION SEQUENCE

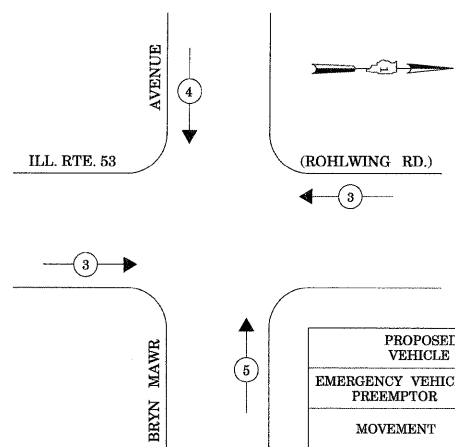

STAGES: STAGE 2 - SUBSTAGE 3

TEMPORARY RADIO INTERCONNECT TO ARDVORE AVE. (SEE TEMPORARY INTERCONNECT PLANS)

TEMPORARY RADIO INTERCONNECT TO IRVING PARK RD. (SEE TEMPORARY INTERCONNECT PLANS)

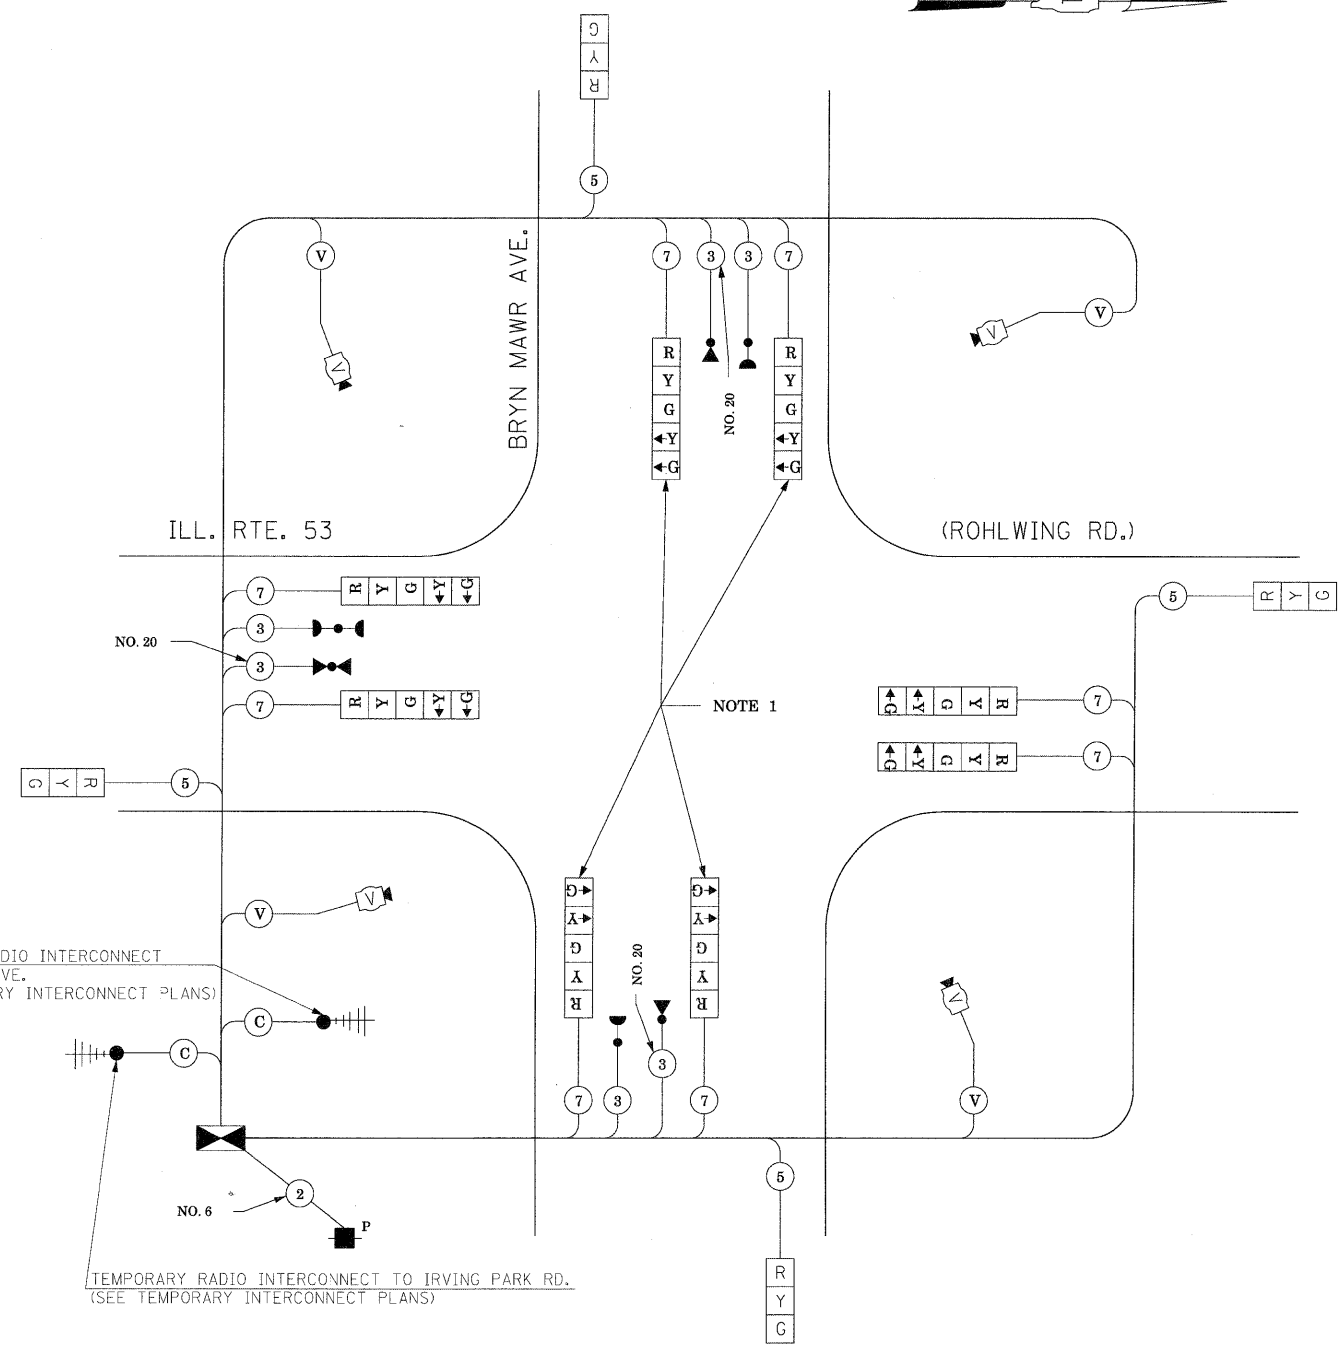

TEMPORARY CABLE PLAN

(NOT TO SCALE)


STAGES: PRE-STAGE, S1-1, S1-2, S1-3, S2-1, S2-2, S2-3, S3,
AND AFTER PROPOSED GEOMETRICS ARE BUILT

THE TRAFFIC SIGNAL CONTROL EQUIPMENT FOR THIS PROJECT SHALL BE "ECONOLITE" TO MATCH THE EXISTING ADJACENT SYSTEM.

| I.D.O.T. TRAFFIC SIGNAL INSTALLATION ELECTRICAL SERVICE REQUIREMENTS | | | | | TOTAL WATTAGE |
|--|----------|---------|-----|-----------|---------------|
| TYPE | NO LAMPS | WATTAGE | | OPERATION | |
| | | INCAND. | LED | | |
| SIGNAL (RED) | 12 | 135 | 17 | 0.50 | 102 |
| (YELLOW) | 12 | 135 | 25 | 0.25 | 75 |
| (GREEN) | 12 | 135 | 15 | 0.25 | 45 |
| ARROW | 16 | 135 | 12 | 0.10 | 19.2 |
| PED. SIGNAL | | 90 | 25 | 1.00 | |
| CONTROLLER | 1 | 100 | 100 | 1.00 | 100 |
| ILLUM. SIGN | | | 25 | 0.05 | |
| VIDEO SYSTEM | 1 | 150 | | 1.00 | 150 |
| FLASHER | | | | 0.50 | |
| ENERGY COSTS TO: | | | | | TOTAL = 491.2 |

ILLINOIS DEPARTMENT OF TRANSPORTATION
201 WEST CENTER COURT
SCHAUMBURG, ILLINOIS 60196-1096
ENERGY SUPPLY CONTACT: CURTIS TOPPS
PHONE: (630) 691-4356
COMPANY: COMMONWEALTH EDISON

NOTE 1: THE LEFT TURN YELLOW ARROW INDICATION SECTIONS FOR BRYN MAWR AVENUE SHALL BE DISCONNECTED AND BAGGED DURING CONSTRUCTION STAGE 2 - SUBSTAGE 3.

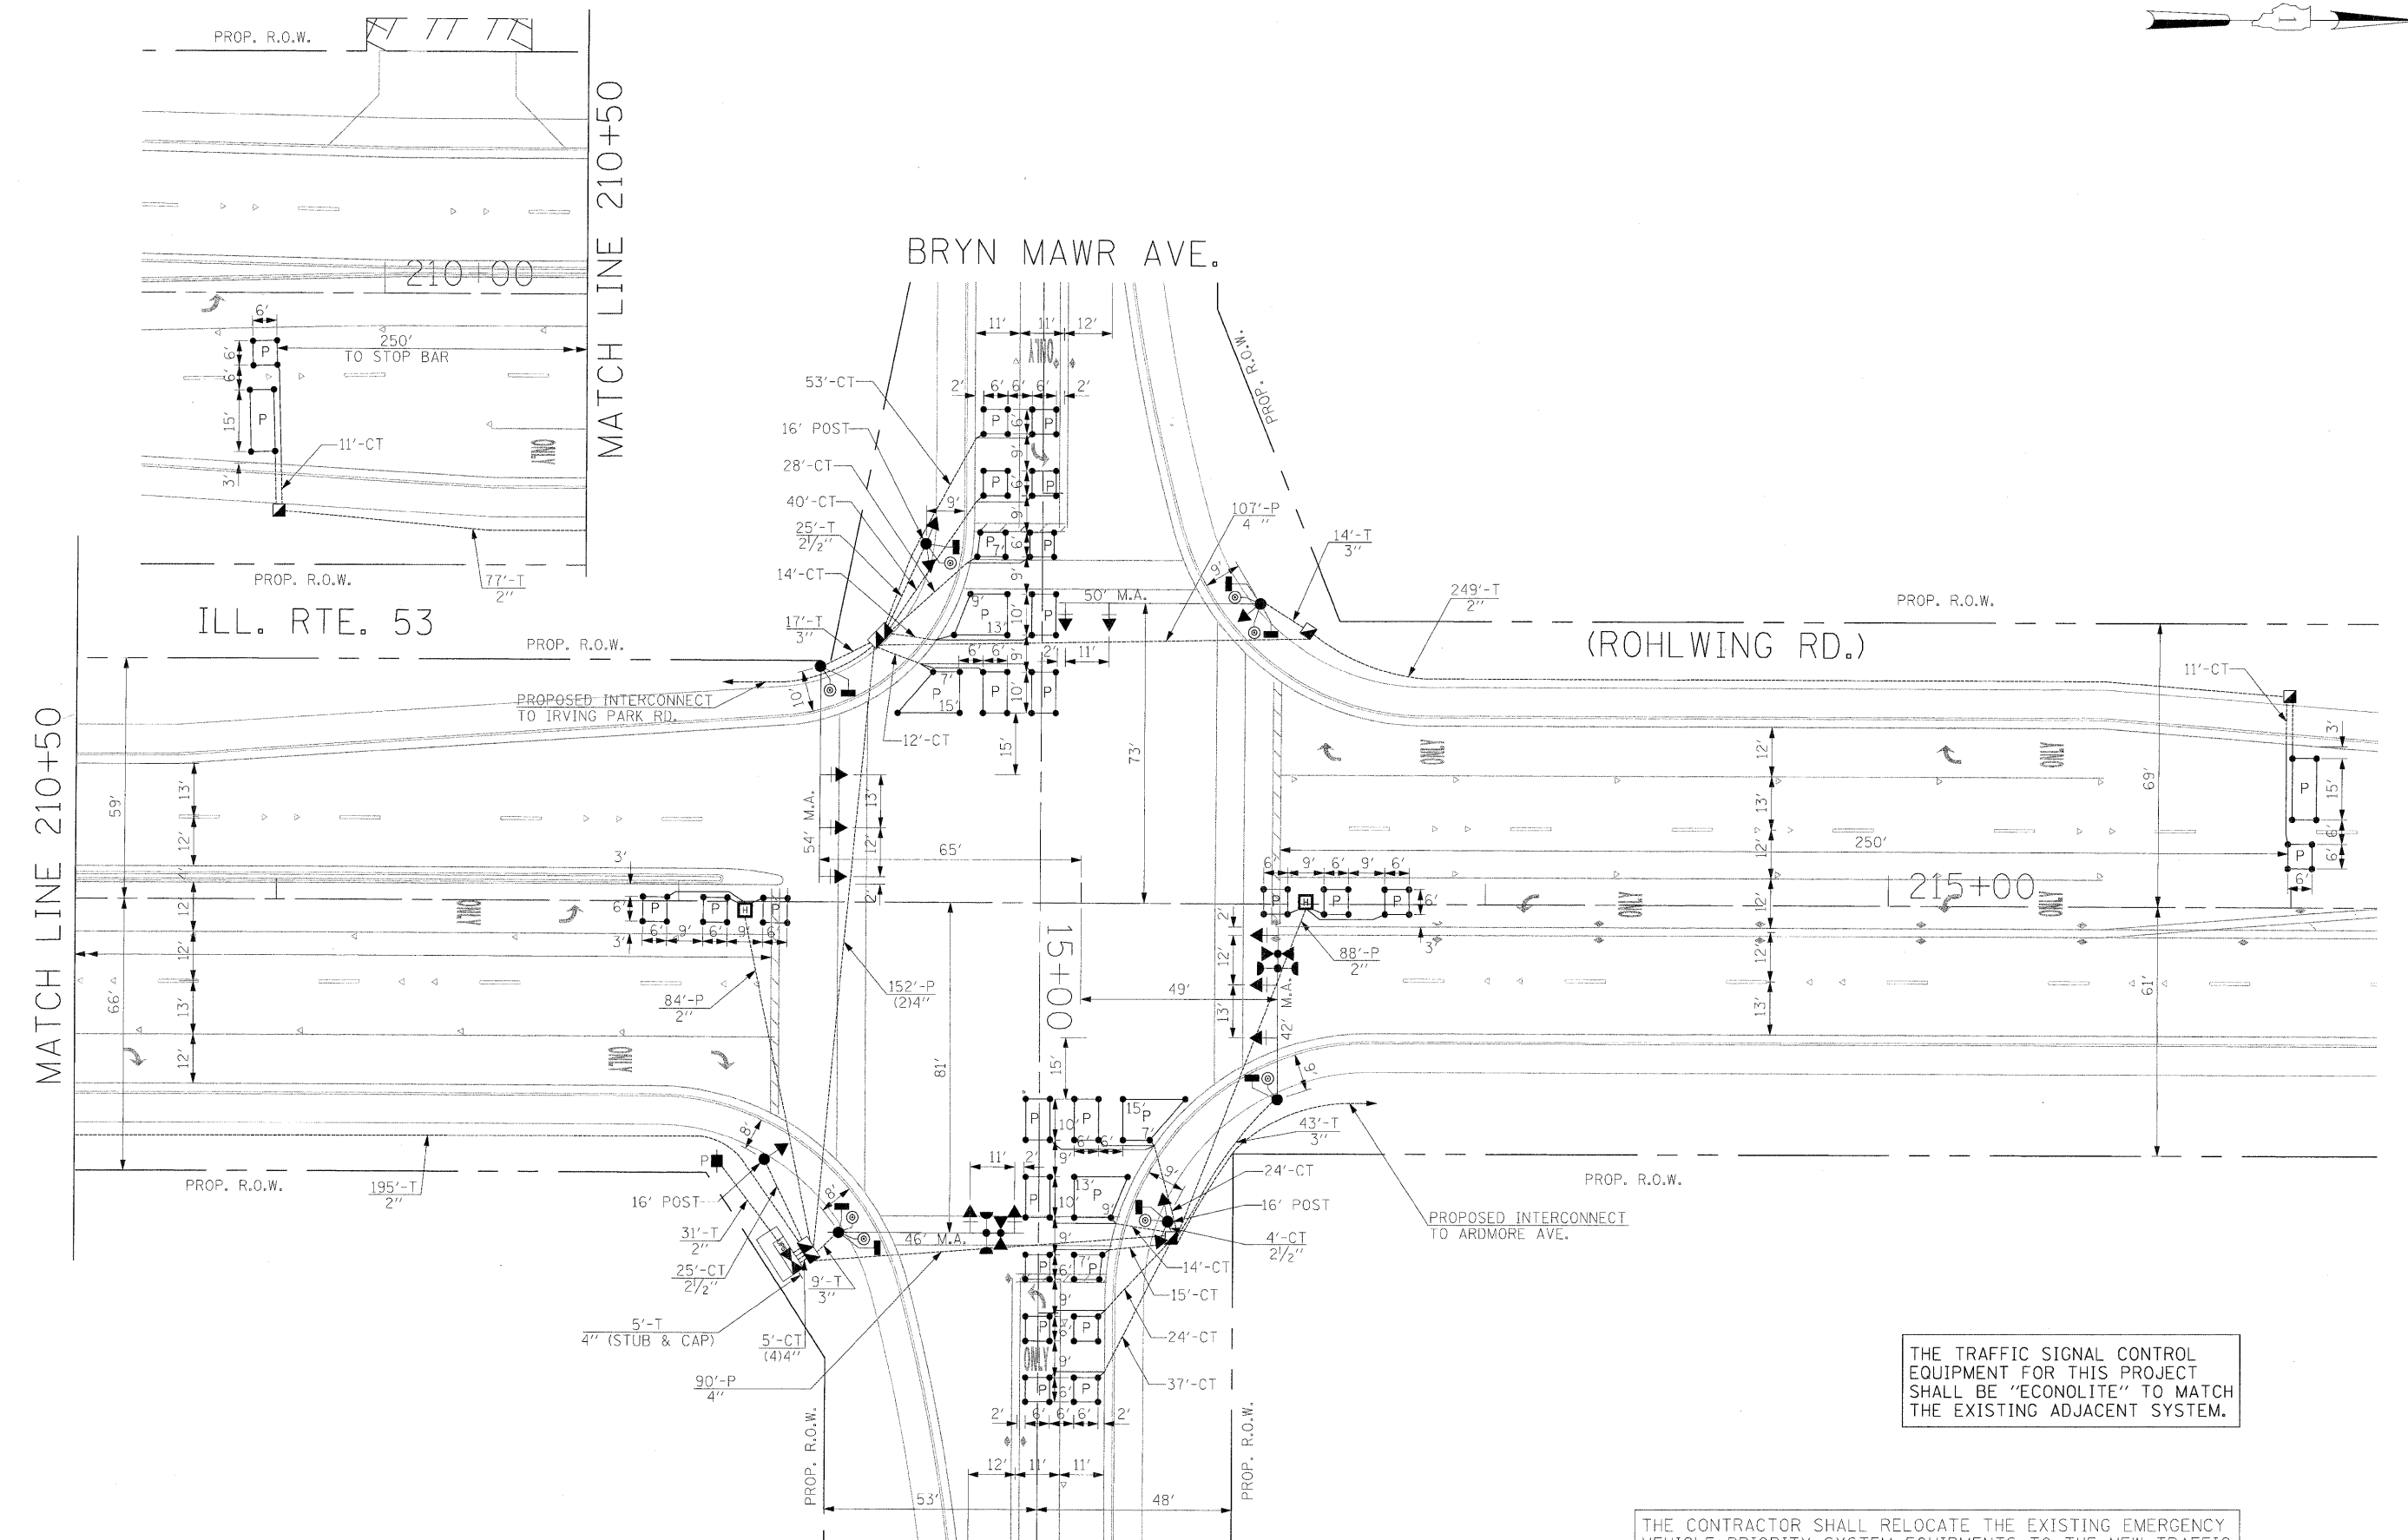

THE TRAFFIC SIGNAL CONTROL EQUIPMENT FOR THIS PROJECT SHALL BE "ECONOLITE" TO MATCH THE EXISTING ADJACENT SYSTEM.

THE CONTRACTOR SHALL RELOCATE THE EXISTING EMERGENCY VEHICLE PRIORITY SYSTEM EQUIPMENTS TO THE NEW TRAFFIC SIGNAL INSTALLATION AT ILL. RTE. 53 (ROHLWING RD.) & BRYN MAWR AVE.

| | | | | | | | | | | |
|----------------------|--------------------|----------------|---|---|---|----------------------------------|---------|--------|--------------|-----------|
| FILE NAME = | USER NAME = #USER# | DESIGNED - PKG | REVISED - | STATE OF ILLINOIS DEPARTMENT OF TRANSPORTATION | PROPOSED TRAFFIC SIGNAL INSTALLATION PLAN ILLINOIS ROUTE 53 (ROHLWING RD.) AT BRYN MAWR AVE. | F.A.P. RTE. | SECTION | COUNTY | TOTAL SHEETS | SHEET NO. |
| #FILE# | DRAWN - MAA, EA | REVISED - | 2578 | | | 532B | DuPage | 781 | 492 | |
| PLOT SCALE = #SCALE# | CHECKED - PKG, EA | REVISED - | CONTRACT NO. 60477 | | | | | | | |
| PLOT DATE = #DATE# | DATE - 5/10/2010 | REVISED - | FED. ROAD DIST. NO. - ILLINOIS FED. AID PROJECT | | | | | | | |
| SCALE: 1"=20' | | | | | | SHEET NO. OF SHEETS STA. TO STA. | | | | |


SCHEDULE OF QUANTITIES

| QUANTITY | UNIT | ITEM |
|----------|-------|---|
| 18 | SQ FT | SIGN PANEL - TYPE 1 |
| 30 | SQ FT | SIGN PANEL - TYPE 2 |
| 552 | FOOT | CONDUIT IN TRENCH, 2" DIA., GALVANIZED STEEL |
| 54 | FOOT | CONDUIT IN TRENCH, 2 1/2" DIA., GALVANIZED STEEL |
| 69 | FOOT | CONDUIT IN TRENCH, 3" DIA., GALVANIZED STEEL |
| 25 | FOOT | CONDUIT IN TRENCH, 4" DIA., GALVANIZED STEEL |
| 172 | FOOT | CONDUIT PUSHED, 2" DIA., GALVANIZED STEEL |
| 278 | FOOT | CONDUIT PUSHED, 4" DIA., GALVANIZED STEEL |
| 4 | EACH | HANDHOLE |
| 2 | EACH | HEAVY-DUTY HANDHOLE |
| 2 | EACH | DOUBLE HANDHOLE |
| 645 | FOOT | TRENCH AND BACKFILL FOR ELECTRICAL WORK |
| 1 | EACH | FULL-ACTUATED CONTROLLER AND TYPE IV CABINET, SPECIAL |
| 1 | EACH | TRANSCEIVER-FIBER OPTIC |
| 1493 | FOOT | ELECTRIC CABLE IN CONDUIT, SIGNAL NO. 14 2C |
| 1865 | FOOT | ELECTRIC CABLE IN CONDUIT, SIGNAL NO. 14 3C |
| 1783 | FOOT | ELECTRIC CABLE IN CONDUIT, SIGNAL NO. 14 5C |
| 1766 | FOOT | ELECTRIC CABLE IN CONDUIT, SIGNAL NO. 14 7C |
| 1797 | FOOT | ELECTRIC CABLE IN CONDUIT, LEAD-IN, NO. 14 1 PAIR |
| 51 | FOOT | ELECTRIC CABLE IN CONDUIT, SERVICE, NO. 6 2C |
| 3 | EACH | TRAFFIC SIGNAL POST, GALVANIZED STEEL 16 FT. |
| 1 | EACH | STEEL MAST ARM ASSEMBLY AND POLE, 42 FT. |
| 1 | EACH | STEEL MAST ARM ASSEMBLY AND POLE, 46 FT. |
| 1 | EACH | STEEL MAST ARM ASSEMBLY AND POLE, 50 FT. |
| 1 | EACH | STEEL MAST ARM ASSEMBLY AND POLE, 54 FT. |
| 12 | FOOT | CONCRETE FOUNDATION, TYPE A |
| 4 | FOOT | CONCRETE FOUNDATION, TYPE C |
| 60 | FOOT | CONCRETE FOUNDATION, TYPE E 36-INCH DIAMETER |
| 6 | EACH | SIGNAL HEAD, LED, 1-FACE, 3-SECTION, MAST ARM MOUNTED |
| 2 | EACH | SIGNAL HEAD, LED, 1-FACE, 5-SECTION, BRACKET MOUNTED |
| 4 | EACH | SIGNAL HEAD, LED, 1-FACE, 5-SECTION, MAST ARM MOUNTED |
| 2 | EACH | SIGNAL HEAD, LED, 2-FACE, 1-3 SECTION, 1-5 SECTION, BRACKET MOUNTED |
| 4 | EACH | PEDESTRIAN SIGNAL HEAD, LED, 1-FACE, BRACKET MOUNTED WITH COUNTDOWN TIMER |
| 2 | EACH | PEDESTRIAN SIGNAL HEAD, LED, 2-FACE, BRACKET MOUNTED WITH COUNTDOWN TIMER |
| 10 | EACH | TRAFFIC SIGNAL BACKPLATE, LOUVERED, ALUMINUM |
| 8 | EACH | INDUCTIVE LOOP DETECTOR |
| 8 | EACH | PEDESTRIAN PUSH-BUTTON |
| 1 | EACH | TEMPORARY TRAFFIC SIGNAL INSTALLATION |
| 2 | EACH | RELOCATE EXISTING EMERGENCY VEHICLE PRIORITY SYSTEM, DETECTOR UNIT |
| 1 | EACH | RELOCATE EXISTING EMERGENCY VEHICLE PRIORITY SYSTEM, PHASING UNIT |
| 1 | EACH | REMOVE EXISTING TRAFFIC SIGNAL EQUIPMENT |
| 10 | EACH | REMOVE EXISTING HANDHOLE |
| 9 | EACH | REMOVE EXISTING CONCRETE FOUNDATION |
| 1228 | FOOT | PREFORMED DETECTOR LOOP |
| 1 | EACH | TEMPORARY TRAFFIC SIGNAL TIMING |
| 1 | EACH | SERVICE INSTALLATION - POLE MOUNTED |
| 1 | EACH | UNINTERRUPTIBLE POWER SUPPLY |
| 723 | FOOT | ELECTRIC CABLE IN CONDUIT, GROUNDING, NO. 6 1C |
| 317 | FOOT | ELECTRIC CABLE IN CONDUIT NO. 20 3/C, TWISTED, SHIELDED |

* 100% COST TO VILLAGE OF ITASCA


THE END OF THE TRACER CABLE SHALL BE CONTINUOUS AND EXTEND INTO THE CONTROLLER CABINET.

THE END OF THE TRACER CABLE SHALL BE CONTINUOUS AND EXTEND INTO THE CONTROLLER CABINET.

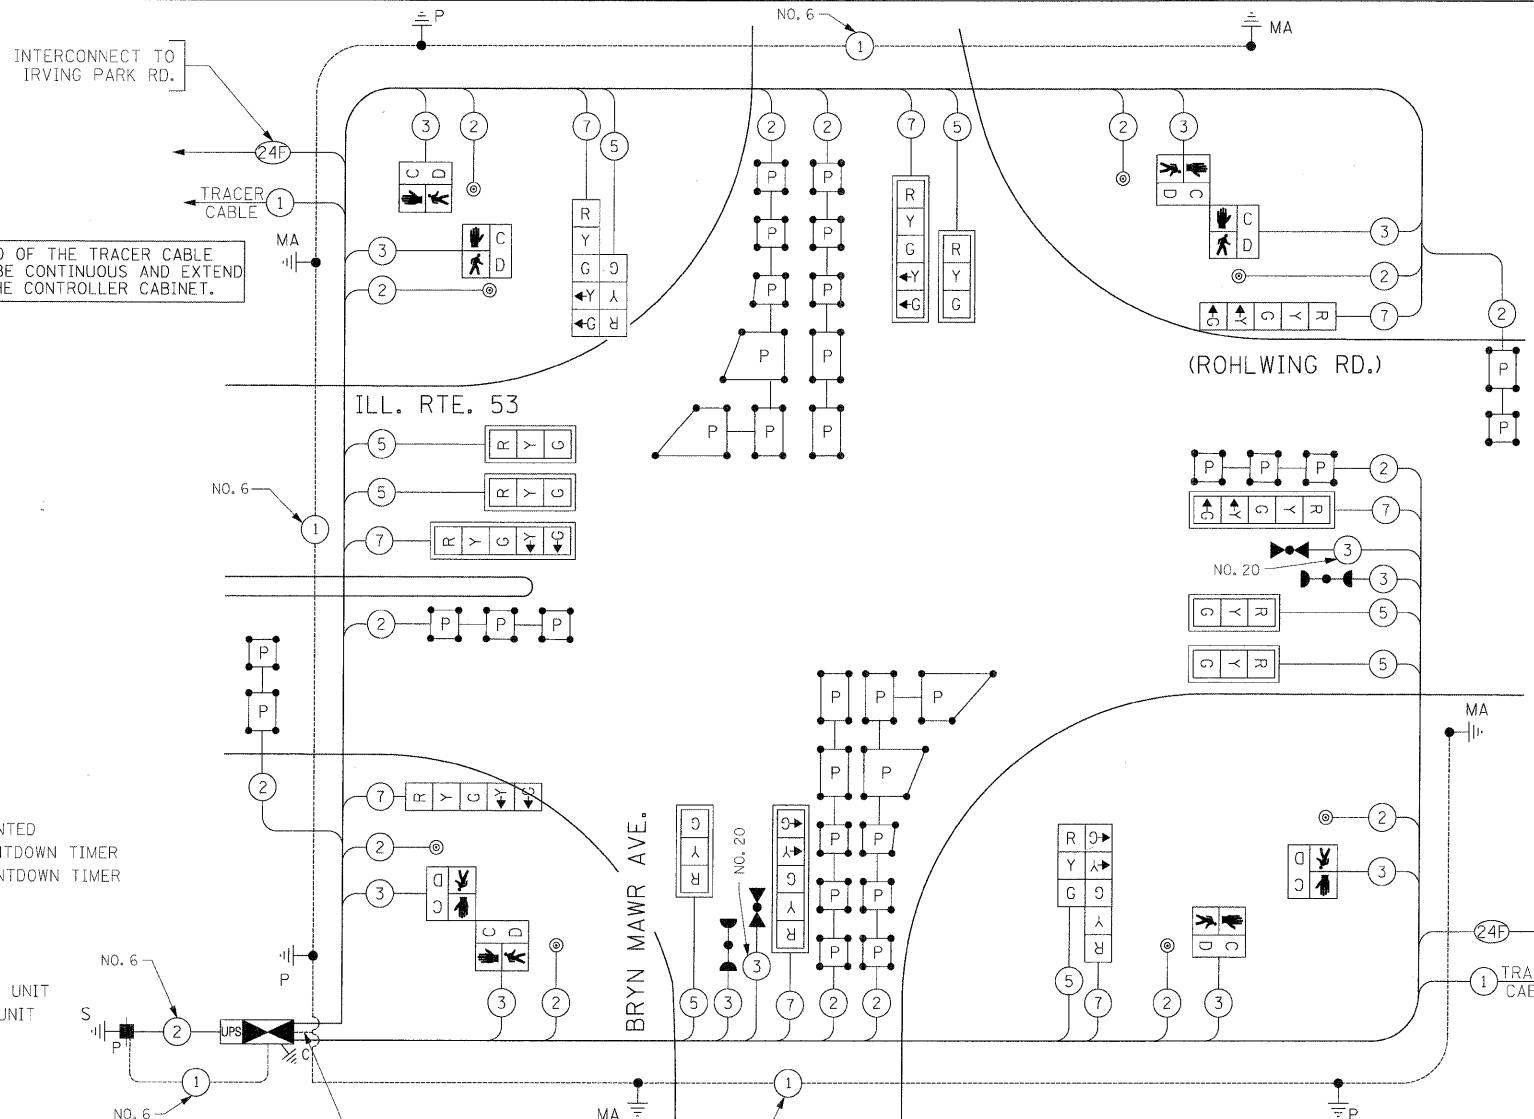


CABLE PLAN
(NOT TO SCALE)

THE CONTRACTOR SHALL RELOCATE THE EXISTING EMERGENCY VEHICLE PRIORITY SYSTEM EQUIPMENTS TO THE NEW TRAFFIC SIGNAL INSTALLATION AT ILL. RTE. 53 (ROHLWING RD.) & BRYN MAWR AVE.

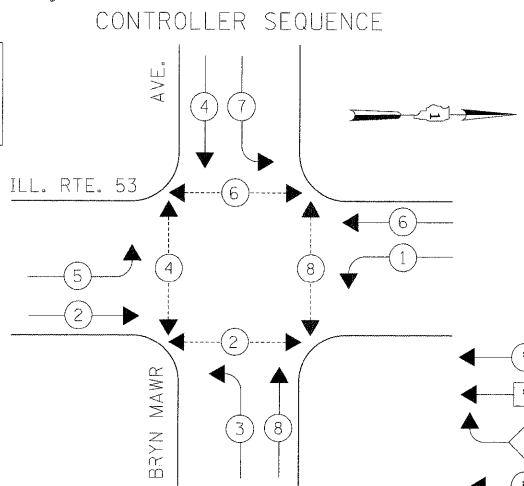

PHASE DESIGNATION DIAGRAM

EMERGENCY VEHICLE PREEMPTION SEQUENCE

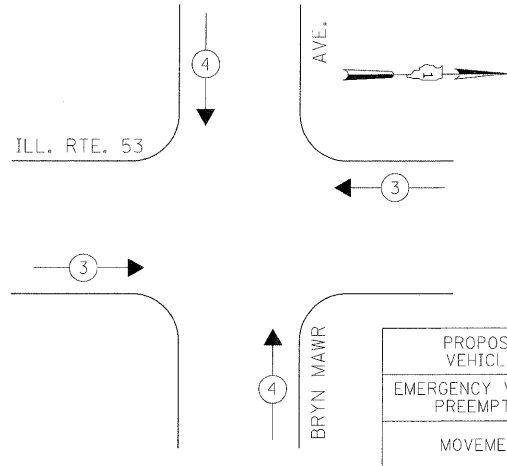

LEGEND
 * DUAL ENTRY PHASE
 * SINGLE ENTRY PHASE
 O.L. OVERLAP
 * PEDESTRIAN PHASE
 * NUMBER REFERS TO ASSOCIATED PHASE

| PROPOSED EMERGENCY VEHICLE PREEMPTORS | | |
|---------------------------------------|---|---|
| EMERGENCY VEHICLE PREEMPTOR | 3 | 4 |
| MOVEMENT | ← | ↓ |

THE TRAFFIC SIGNAL CONTROL EQUIPMENT FOR THIS PROJECT SHALL BE "ECONOLITE" TO MATCH THE EXISTING ADJACENT SYSTEM.

| I.D.O.T. TRAFFIC SIGNAL INSTALLATION ELECTRICAL SERVICE REQUIREMENTS | | | | | TOTAL WATTAGE |
|--|----------|---------|-----|------------|---------------|
| TYPE | NO LAMPS | WATTAGE | | %OPERATION | |
| SIGNAL (RED) | 16 | 135 | 17 | 0.50 | 136 |
| | 16 | 135 | 25 | 0.25 | |
| | 16 | 135 | 15 | 0.25 | |
| ARROW | 16 | 135 | 12 | 0.10 | 19.2 |
| PED. SIGNAL | 8 | 90 | 25 | 1.00 | 200 |
| CONTROLLER | 1 | 100 | 100 | 1.00 | 100 |
| ILLUM. SIGN | | | 25 | 0.05 | |
| FLASHER | | | | 0.50 | |
| ENERGY COSTS TO: | | | | TOTAL = | 615.2 |

ILLINOIS DEPARTMENT OF TRANSPORTATION
 201 WEST CENTER COURT
 SCHAMBURG, ILLINOIS 60196-1096
 ENERGY SUPPLY CONTACT: CURTIS TOPPS
 PHONE: (630) 691-4356
 COMPANY: COMMONWEALTH EDISON

| | | | |
|-------------|----------------------|-------------------|-----------|
| FILE NAME = | USER NAME = #USER# | DESIGNED - PKG | REVISED - |
| #FILE# | | DRAWN - MAA, EA | REVISED - |
| | PLOT SCALE = #SCALE# | CHECKED - PKG, EA | REVISED - |
| | PLOT DATE = #DATE# | DATE - 5/10/2010 | REVISED - |

STATE OF ILLINOIS
 DEPARTMENT OF TRANSPORTATION

CABLE PLAN, PHASE DESIGNATION DIAGRAM,
 EMERGENCY VEHICLE PREEMPTION SEQUENCE, SCHEDULE OF QUANTITIES
 ILLINOIS ROUTE 53 (ROHLWING RD.) AT BRYN MAWR AVE.

| | | | | |
|--------------------------------|--------------|---------------|------------------|---------------|
| F.A.P. RTE. 2578 | SECTION 532B | COUNTY DuPage | TOTAL SHEETS 781 | SHEET NO. 493 |
| FED. ROAD DIST. NO. - ILLINOIS | | | FED. AID PROJECT | |
| CONTRACT NO. 60477 | | | | |

NOTES FOR TEMPORARY TRAFFIC SIGNALS


1. ALL CONTROL EQUIPMENT INCLUDING EMERGENCY PRE-EMPTION AND COMMUNICATION DEVICES FOR THE TEMPORARY TRAFFIC SIGNAL(S) SHALL BE FURNISHED BY THE CONTRACTOR.
2. ONLY CONTROLLERS SUPPLIED BY ONE OF THE DISTRICT APPROVED CLOSED LOOP EQUIPMENT MANUFACTURERS WILL BE APPROVED FOR USE AT TEMPORARY SIGNAL LOCATIONS. ALL CONTROLLERS USED FOR TEMPORARY TRAFFIC SIGNALS SHALL BE FULLY ACTUATED NEMA MICROPROCESSOR BASED WITH RS232 DATA ENTRY PORTS COMPATIBLE WITH EXISTING MONITORING SOFTWARE APPROVED BY IDOT DISTRICT 1, INSTALLED IN A NEMA TS2 CABINET. ONLY ONE BRAND OF CONTROLLER WILL BE ACCEPTED FOR ANY ONE CONTRACT.
3. ALL TRAFFIC SIGNAL SECTIONS AND PEDESTRIAN SIGNAL SECTIONS SHALL BE LED AND 12" (300mm) DIAMETER. HEADS SHALL BE PLACED AS INDICATED ON THE TEMPORARY TRAFFIC SIGNAL PLAN OR AS DIRECTED BY THE ENGINEER. PEDESTRIAN SIGNALS SHALL INCLUDE SOLID INTERNATIONAL SYMBOLS. PEDESTRIAN SIGNALS WITH COUNTDOWN TIMERS SHALL BE USED WHEN THE EXISTING INSTALLATION UTILIZES COUNTDOWN TYPE OR AS DIRECTED BY THE ENGINEER. COUNTDOWN TYPE PEDESTRIAN SIGNALS ARE NOT TO BE INSTALLED AT A RAILROAD INTERSECTION. THE CONTRACTOR SHALL FURNISH ENOUGH CABLE SLACK TO RELOCATE HEADS TO ANY POSITION ON THE SPAN WIRE OR AT LOCATIONS ILLUSTRATED ON THE PLANS FOR CONSTRUCTION STAGING. THE TEMPORARY TRAFFIC SIGNAL SHALL REMAIN IN OPERATION DURING ALL SIGNAL HEAD RELOCATIONS. EACH TEMPORARY TRAFFIC SIGNAL HEAD SHALL HAVE ITS OWN CABLE FROM THE CONTROLLER CABINET TO THE SIGNAL HEAD.
4. ALL EXISTING STREET NAME AND INTERSECTION REGULATORY SIGNS SHALL BE REMOVED FROM EXISTING POLES, RELOCATED AND SECURELY FASTENED TO THE SPAN WIRE OR WOOD POLE AS DIRECTED BY THE ENGINEER.
5. ANY TEMPORARY SIGNAL WITHIN AN EXISTING CLOSED LOOP TRAFFIC SIGNAL SYSTEM SHALL BE INTERCONNECTED TO THAT SYSTEM USING SIMILAR BRAND CONTROL EQUIPMENT.
6. THE TEMPORARY TRAFFIC SIGNAL SHALL HAVE THE SIGNAL HEAD DISPLAYS, SIGNAL HEAD PLACEMENTS AND CONTROLLER PHASING MATCH THE EXISTING TRAFFIC SIGNAL, AT THE TIME OF THE TURN ON, IF NO TRAFFIC STAGING IS IN PLACE OR WILL NOT BE STAGED ON THE DAY OF THE TURN ON.
7. UNINTERRUPTIBLE POWER SUPPLY (UPS) SYSTEMS SHALL BE INSTALLED AND MADE OPERATIONAL AT TEMPORARY TRAFFIC SIGNAL INSTALLATIONS WHERE UPS IS INSTALLED AT THE EXISTING TRAFFIC SIGNAL, TEMPORARY TRAFFIC SIGNALS AT RAILROAD INTERSECTIONS, AND TEMPORARY TRAFFIC SIGNALS AT INTERSECTIONS WITH FIRE STATION ACTUATED EMERGENCY VEHICLE PRE-EMPTION, OR WHEN INDICATED ON THE PLANS.
8. TRAFFIC SIGNAL MANAGEMENT SYSTEMS SHALL BE MAINTAINED IN OPERATION AS INDICATED ON THE PLANS OR AS DIRECTED BY THE ENGINEER. REQUIRED EQUIPMENT SHALL BE AS SHOWN ON THE PLANS AND THE CONTRACTOR SHALL PLACE THE EQUIPMENT IN OPERATION TO THE SATISFACTION OF THE ENGINEER AND THE AGENCY RESPONSIBLE FOR THE TRAFFIC SIGNAL MANAGEMENT SYSTEM.
9. DETECTION AT TEMPORARY TRAFFIC SIGNALS SHALL BE INCLUDED FOR ALL APPROACHES OF THE INTERSECTION UNLESS INDICATED OTHERWISE ON THE PLANS. THE DETECTION SYSTEM MUST MEET THE SPECIFICATIONS OF DISTRICT 1 AND THE CONTRACTOR SHALL PLACE THE DETECTORS INTO OPERATION TO THE SATISFACTION OF THE ENGINEER.
10. WHEN PAN, TILT, ZOOM CAMERAS ARE INSTALLED AT THE EXISTING INTERSECTION OR ARE CALLED FOR IN THE PLANS, THE CONTRACTOR SHALL BE RESPONSIBLE FOR INSTALLING AND MAINTAINING THE CAMERAS TO THE SATISFACTION OF THE ENGINEER AND THE AGENCY RESPONSIBLE FOR THE CAMERAS.

THE FOLLOWING ITEMS SHALL BE REMOVED BY THE CONTRACTOR AND SHALL BE DISPOSED OF BY THEM OUTSIDE THE RIGH-OF-WAY AT THEIR EXPENSE. THE SALVAGE VALUE OF THE REMOVED EQUIPMENT SHALL BE REFLECTED IN THE CONTRACTOR'S BID PRICE.

- 1 EACH CONTROLLER AND CABINET COMPLETE
- 4 EACH SIGNAL HEAD, 1-FACE 3-SECTION, BRACKET MOUNTED
- 2 EACH SIGNAL HEAD, 1-FACE 5-SECTION, BRACKET MOUNTED
- 2 EACH SIGNAL HEAD, 1-FACE 5-SECTION, MAST ARM MOUNTED
- 2 EACH TRAFFIC SIGNAL BACKPLATE
- 6 EACH TRAFFIC SIGNAL POST
- 2 EACH STEEL MAST ARM ASSEMBLY AND POLE
- 1 EACH SERVICE INSTALLATION



THE CONTRACTOR SHALL RELOCATE THE EXISTING EMERGENCY VEHICLE PRIORITY SYSTEM EQUIPMENTS TO THE NEW TRAFFIC SIGNAL INSTALLATION AT ILL. RTE. 53 (ROHLWING RD.) & ARDMORE AVE.

NOTE: THE VIDEO DETECTION ZONES SHOWN ON THE PLANS ARE FOR CONSTRUCTION STAGE 1 - SUBSTAGE 1 AND SHALL BE REDEFINED FOR EACH CONSTRUCTION STAGE AS A PART OF "TEMPORARY TRAFFIC SIGNAL INSTALLATION" WORK.

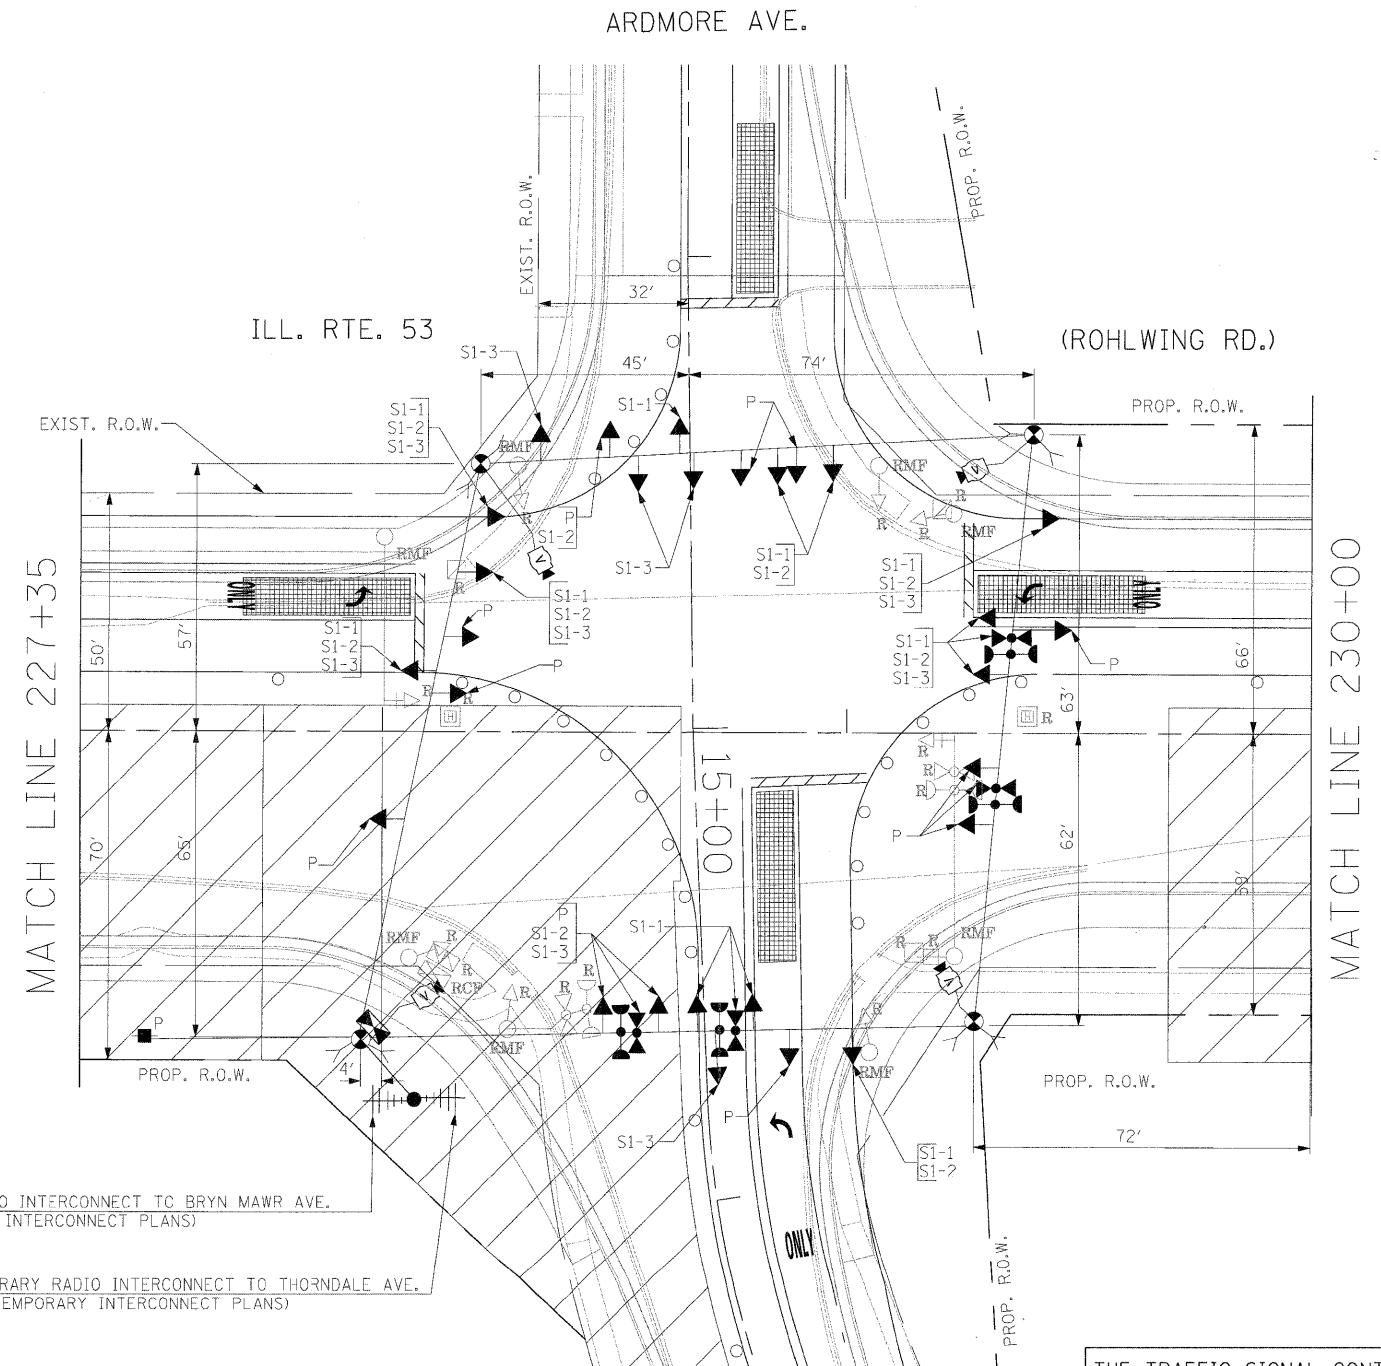


THE TRAFFIC SIGNAL CONTROL EQUIPMENT FOR THIS PROJECT SHALL BE "ECONOLITE" TO MATCH THE EXISTING ADJACENT SYSTEM.


| | | | | | | | | | | |
|-------------|--------------------|-------------------|-----------|---|--|---|---------|--------|--------------|-----------|
| FILE NAME = | USER NAME = #USER# | DESIGNED - PKG | REVISED - | STATE OF ILLINOIS DEPARTMENT OF TRANSPORTATION | TEMPORARY TRAFFIC SIGNAL INSTALLATION AND REMOVAL PLAN ILLINOIS ROUTE 53 (ROHLWING RD.) AT ARDMORE AVE. PRE STAGE AND STAGE 1 (SHEET 1 OF 4). | F.A.P. RTE. | SECTION | COUNTY | TOTAL SHEETS | SHEET NO. |
| #FILE# | | DRAWN - MAA, EA | REVISED - | | | 2578 | 532B | DuPage | 781 | 494 |
| | | CHECKED - PKG, EA | REVISED - | | | CONTRACT NO. 60477 | | | | |
| | | DATE - 5/10/2010 | REVISED - | SCALE: 1"=20' | SHEET NO. OF SHEETS STA. TO STA. | FED. ROAD DIST. NO. - [ILLINOIS] FED. AID PROJECT | | | | |

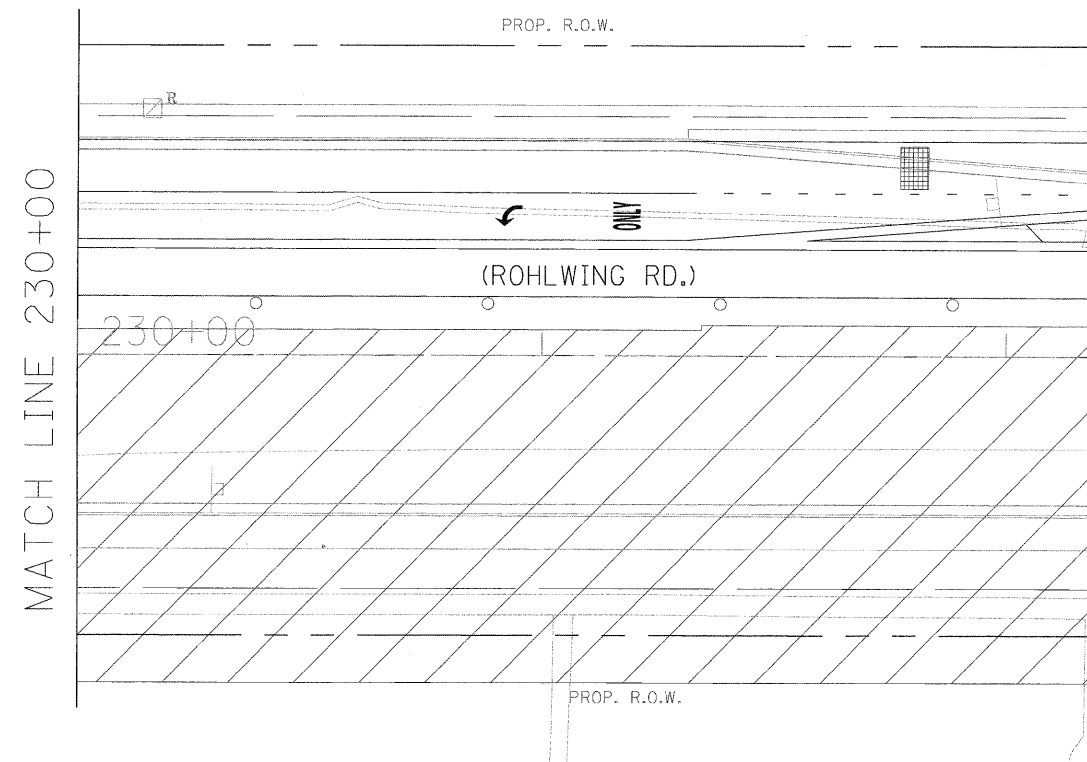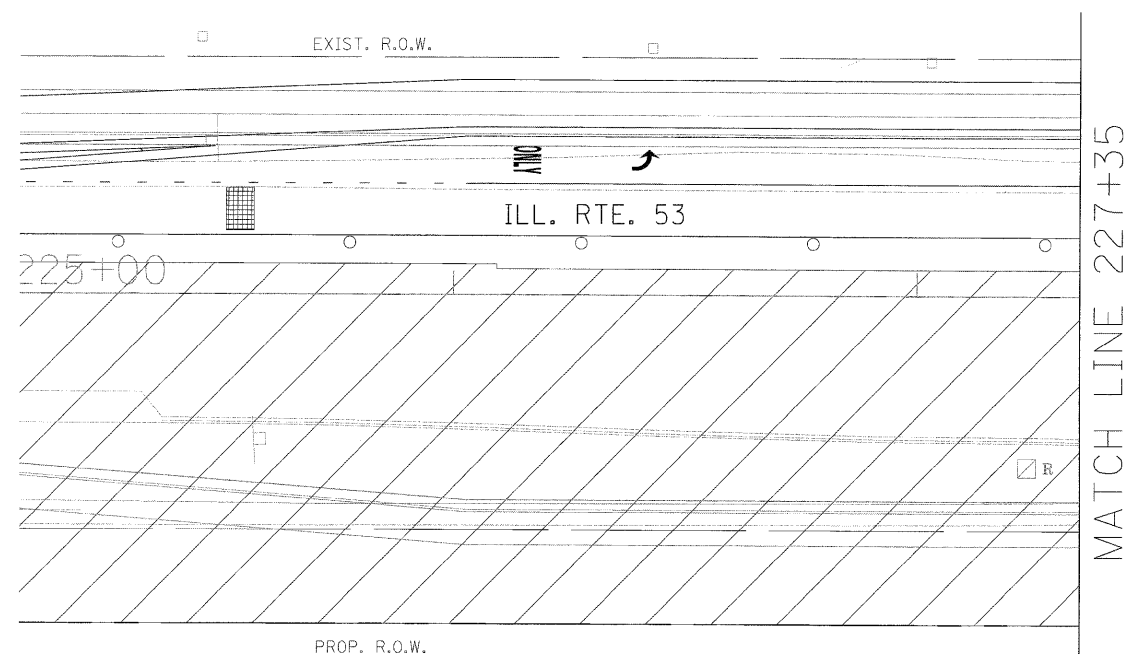

| | | | | | | | | | | | |
|-------------|----------------------|-------------------|-----------|---|--|--------------------|--------------------------------|--------|------------------|-----------|--|
| FILE NAME = | USER NAME = *USER* | DESIGNED - PKG | REVISED - | STATE OF ILLINOIS DEPARTMENT OF TRANSPORTATION | TEMPORARY TRAFFIC SIGNAL INSTALLATION AND REMOVAL PLAN ILLINOIS ROUTE 53 (ROHLWING RD.) AT ARDMORE AVE. PRE STAGE AND STAGE 1 (SHEET 2 OF 4). | F.A.P. RTE. | SECTION | COUNTY | TOTAL SHEETS | SHEET NO. | |
| %FILEL% | | DRAWN - MAA, EA | REVISED - | | | 2578 | 532B | DuPage | 781 | 495 | |
| | PLOT SCALE = %SCALE% | CHECKED - PKG, EA | REVISED - | | | CONTRACT NO. 60477 | | | | | |
| | PLOT DATE = %DATE% | DATE - 5/10/2010 | REVISED - | | | | | | | | |
| | | | | | SCALE: 1"=20' | SHEET NO. | OF | SHEETS | STA. | TO STA. | |
| | | | | | | | FED. ROAD DIST. NO. - ILLINOIS | | FED. AID PROJECT | | |

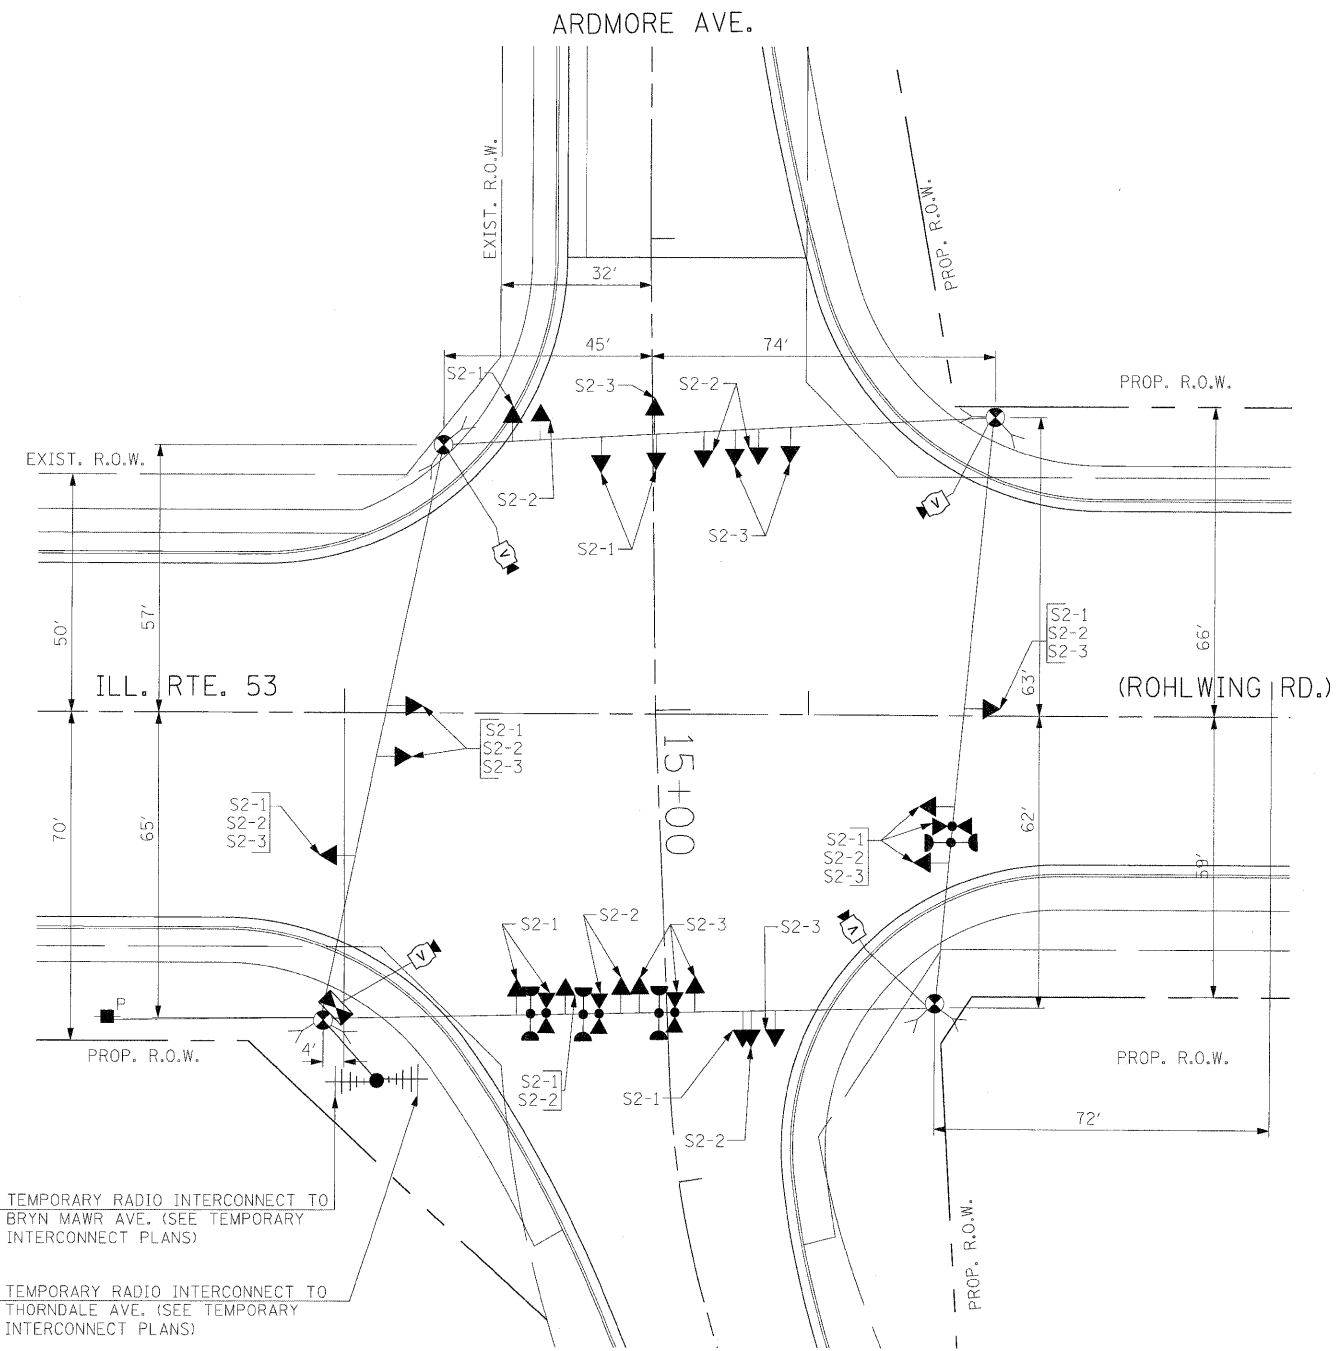

SIGNAL HEAD PLACEMENTS FOR STAGES: S2-1, S2-2, AND S2-3.

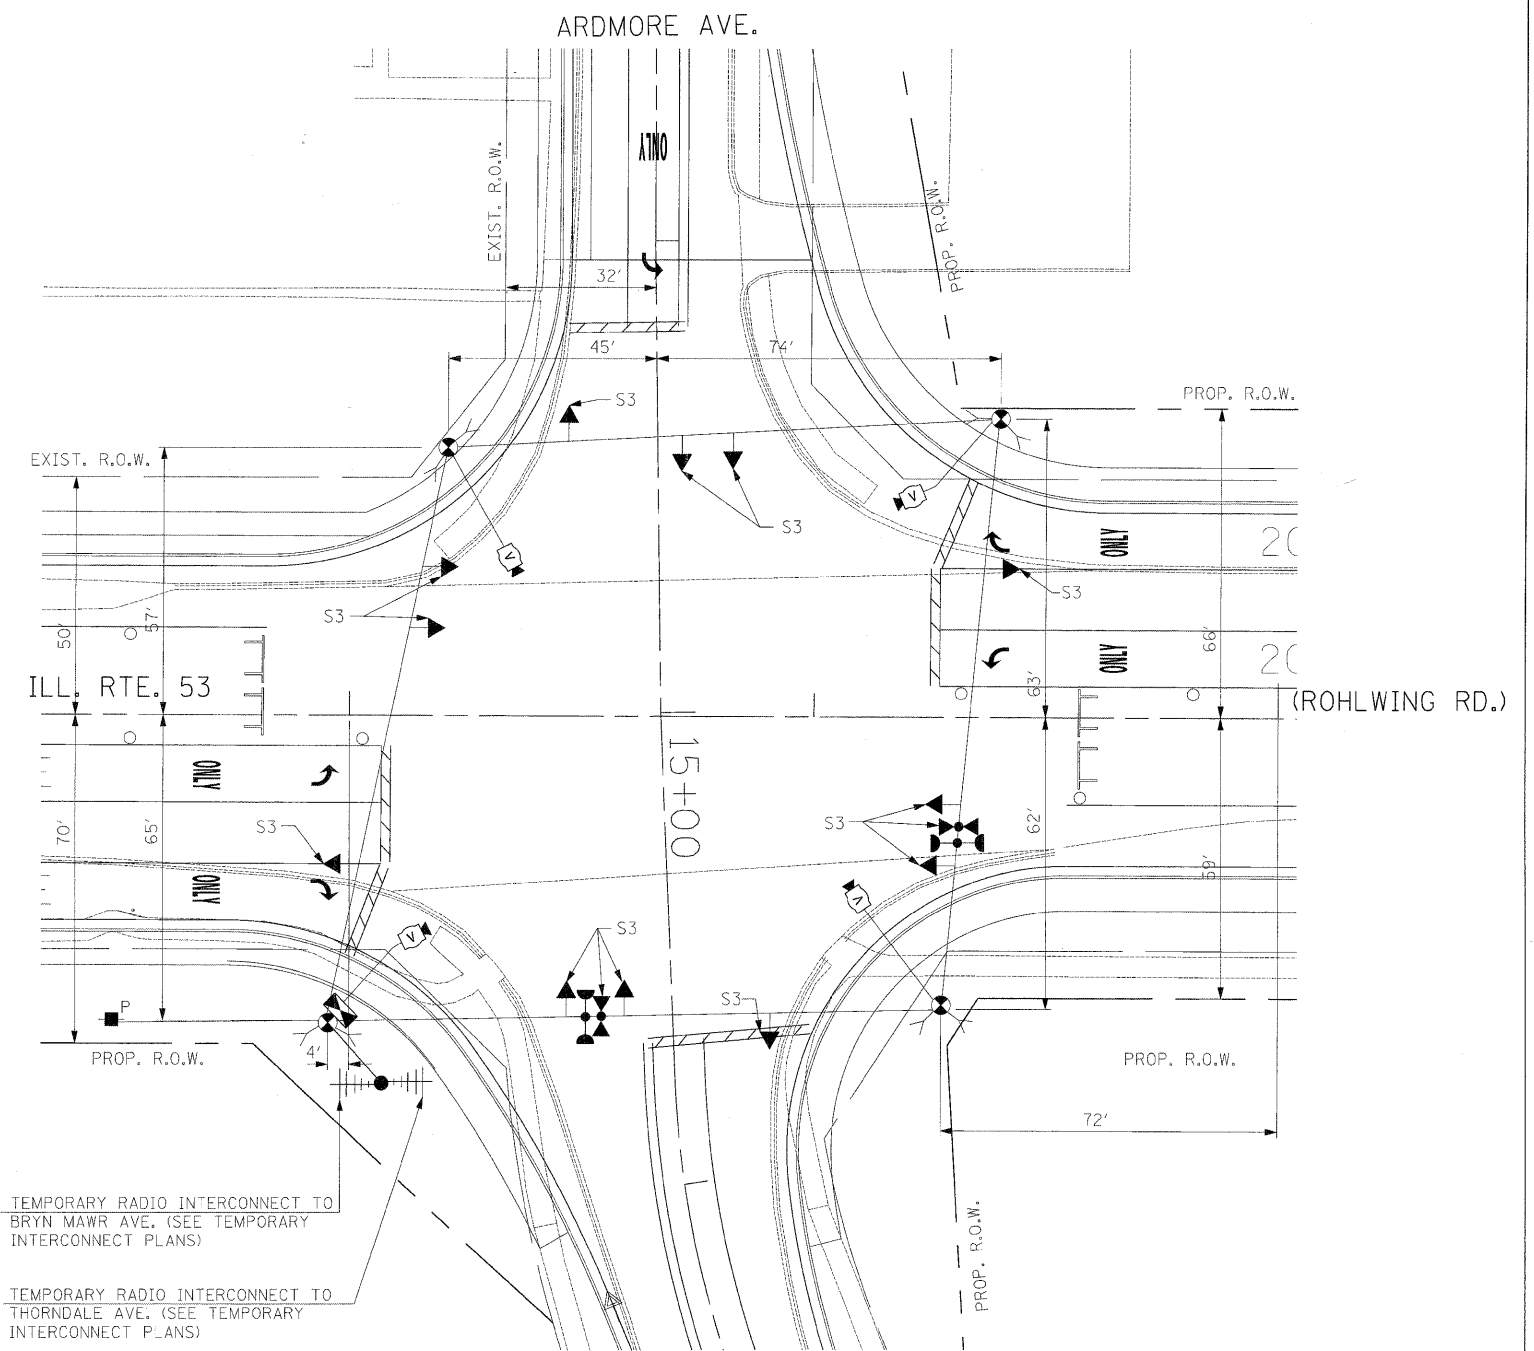

SIGNAL HEAD PLACEMENTS FOR STAGES S3

THE TRAFFIC SIGNAL CONTROL EQUIPMENT FOR THIS PROJECT SHALL BE "ECONOLITE" TO MATCH THE EXISTING ADJACENT SYSTEM.

TEMPORARY RADIO INTERCONNECT TO BRYN MAWR AVE. (SEE TEMPORARY INTERCONNECT PLANS)
 TEMPORARY RADIO INTERCONNECT TO THORNDALE AVE. (SEE TEMPORARY INTERCONNECT PLANS)

TEMPORARY RADIO INTERCONNECT TO BRYN MAWR AVE. (SEE TEMPORARY INTERCONNECT PLANS)
 TEMPORARY RADIO INTERCONNECT TO THORNDALE AVE. (SEE TEMPORARY INTERCONNECT PLANS)

| | | | |
|-------------|----------------------|-------------------|-----------|
| FILE NAME = | USER NAME = #USER# | DESIGNED - PKG | REVISED - |
| #FILEL# | | DRAWN - MAA, EA | REVISED - |
| | PLOT SCALE = #SCALE# | CHECKED - PKG, EA | REVISED - |
| | PLOT DATE = #DATE# | DATE - 5/10/2010 | REVISED - |

STATE OF ILLINOIS
 DEPARTMENT OF TRANSPORTATION



TEMPORARY TRAFFIC SIGNAL INSTALLATION AND REMOVAL PLAN
 ILLINOIS ROUTE 53 (ROHLWING RD.) AT ARDMORE AVE.
 STAGE 2 AND STAGE 3 (SHEET 3 OF 4).

| | | | | |
|--------------------|---------|--------|--------------|-----------|
| F.A.P. RTE. | SECTION | COUNTY | TOTAL SHEETS | SHEET NO. |
| 2578 | 532B | DuPage | 781 | 496 |
| CONTRACT NO. 60477 | | | | |

SCALE: SHEET NO. OF SHEETS STA. TO STA.

FED. ROAD DIST. NO. - ILLINOIS FED. AID PROJECT


CONTROLLER SEQUENCE

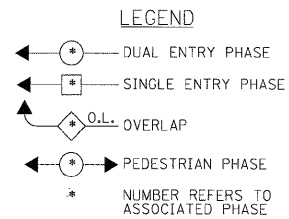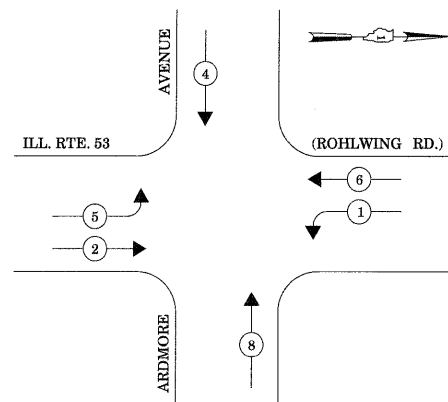

TEMPORARY PHASE DESIGNATION DIAGRAM

STAGES: PRE-STAGE, S1-1, S1-2, S1-3, S2-1, S2-2, S2-3, S3, AND AFTER PROPOSED GEOMETRICS ARE BUILT

EMERGENCY VEHICLE PREEMPTION SEQUENCE

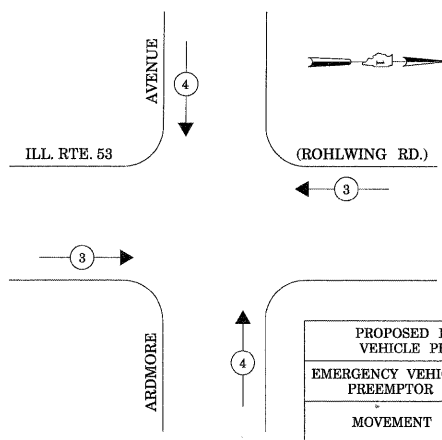

| PROPOSED EMERGENCY VEHICLE PREEMPTORS | | |
|---------------------------------------|----|----|
| EMERGENCY VEHICLE PREEMPTOR | 3 | 4 |
| MOVEMENT | ←→ | ↑↓ |

STAGES: PRE-STAGE, S1-1, S1-2, S1-3, S2-1, S2-2, S2-3, S3, AND AFTER PROPOSED GEOMETRICS ARE BUILT

| I.D.O.T. TRAFFIC SIGNAL INSTALLATION ELECTRICAL SERVICE REQUIREMENTS | | | | | TOTAL WATTAGE |
|--|----------|---------|-----|-----------|---------------|
| TYPE | NO LAMPS | WATTAGE | | OPERATION | |
| | | INCAND. | LED | | |
| SIGNAL (RED) | 12 | 135 | 17 | 0.50 | 102 |
| (YELLOW) | 12 | 135 | 25 | 0.25 | 75 |
| (GREEN) | 12 | 135 | 15 | 0.25 | 45 |
| ARROW | 8 | 135 | 12 | 0.10 | 9.6 |
| PED. SIGNAL | | 90 | 25 | 1.00 | |
| CONTROLLER | 1 | 100 | 100 | 1.00 | 100 |
| ILLUM. SIGN | | | 25 | 0.05 | |
| VIDEO SYSTEM | 1 | 150 | | 1.00 | 150 |
| FLASHER | | | | 0.50 | |
| ENERGY COSTS TO: | | | | TOTAL = | 481.6 |

ILLINOIS DEPARTMENT OF TRANSPORTATION
201 WEST CENTER COURT
SCHAMBURG, ILLINOIS 60196-1096


ENERGY SUPPLY CONTACT: CURTIS TOPPS
PHONE: (630) 691-4356
COMPANY: COMMONWEALTH EDISON

| | | | |
|-------------|----------------------|-------------------|-----------|
| FILE NAME = | USER NAME = #USER# | DESIGNED - PKG | REVISED - |
| #FILE# | | DRAWN - MAA, EA | REVISED - |
| | PLOT SCALE = #SCALE# | CHECKED - PKG, EA | REVISED - |
| | PLOT DATE = #DATE# | DATE - 5/10/2010 | REVISED - |

**STATE OF ILLINOIS
DEPARTMENT OF TRANSPORTATION**

**TEMPORARY CABLE PLAN, TEMPORARY PHASE DESIGNATION DIAGRAM
TEMPORARY EMERGENCY VEHICLE PREEMPTION SEQUENCE
ILLINOIS ROUTE 53 (ROHLWING RD.) AT ARDMORE AVE.
PRE STAGE, STAGE 1, STAGE 2 AND STAGE 3 (SHEET 4 OF 4)**

| | | | | |
|---|---------|--------|--------------|-----------|
| F.A.P. RTE. | SECTION | COUNTY | TOTAL SHEETS | SHEET NO. |
| 257B | 532B | DuPage | 781 | 497 |
| CONTRACT NO. 60477 | | | | |
| FED. ROAD DIST. NO. - ILLINOIS FED. AID PROJECT | | | | |

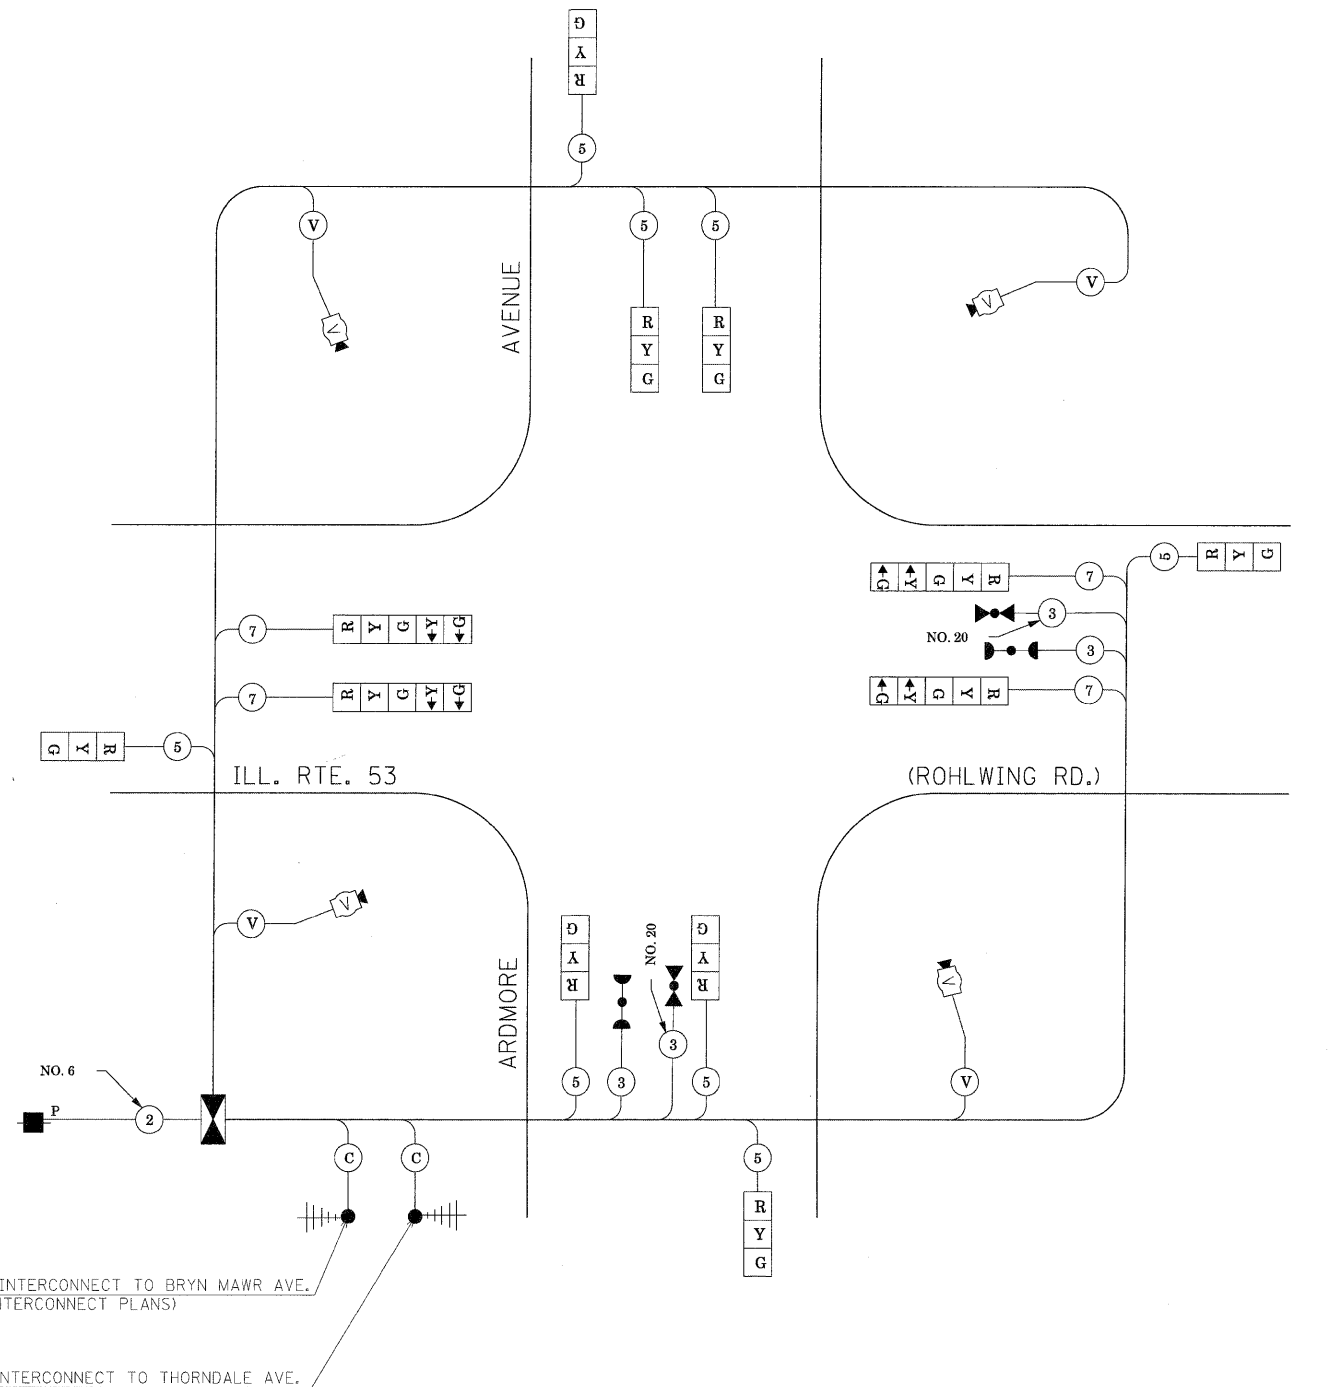


TEMPORARY CABLE PLAN

(NOT TO SCALE)

STAGES: PRE-STAGE, S1-1, S1-2, S1-3, S2-1, S2-2, S2-3, S3, AND AFTER PROPOSED GEOMETRICS ARE BUILT

THE TRAFFIC SIGNAL CONTROL EQUIPMENT FOR THIS PROJECT SHALL BE "ECONOLITE" TO MATCH THE EXISTING ADJACENT SYSTEM.

SCALE: NONE SHEET NO. OF SHEETS STA. TO STA.

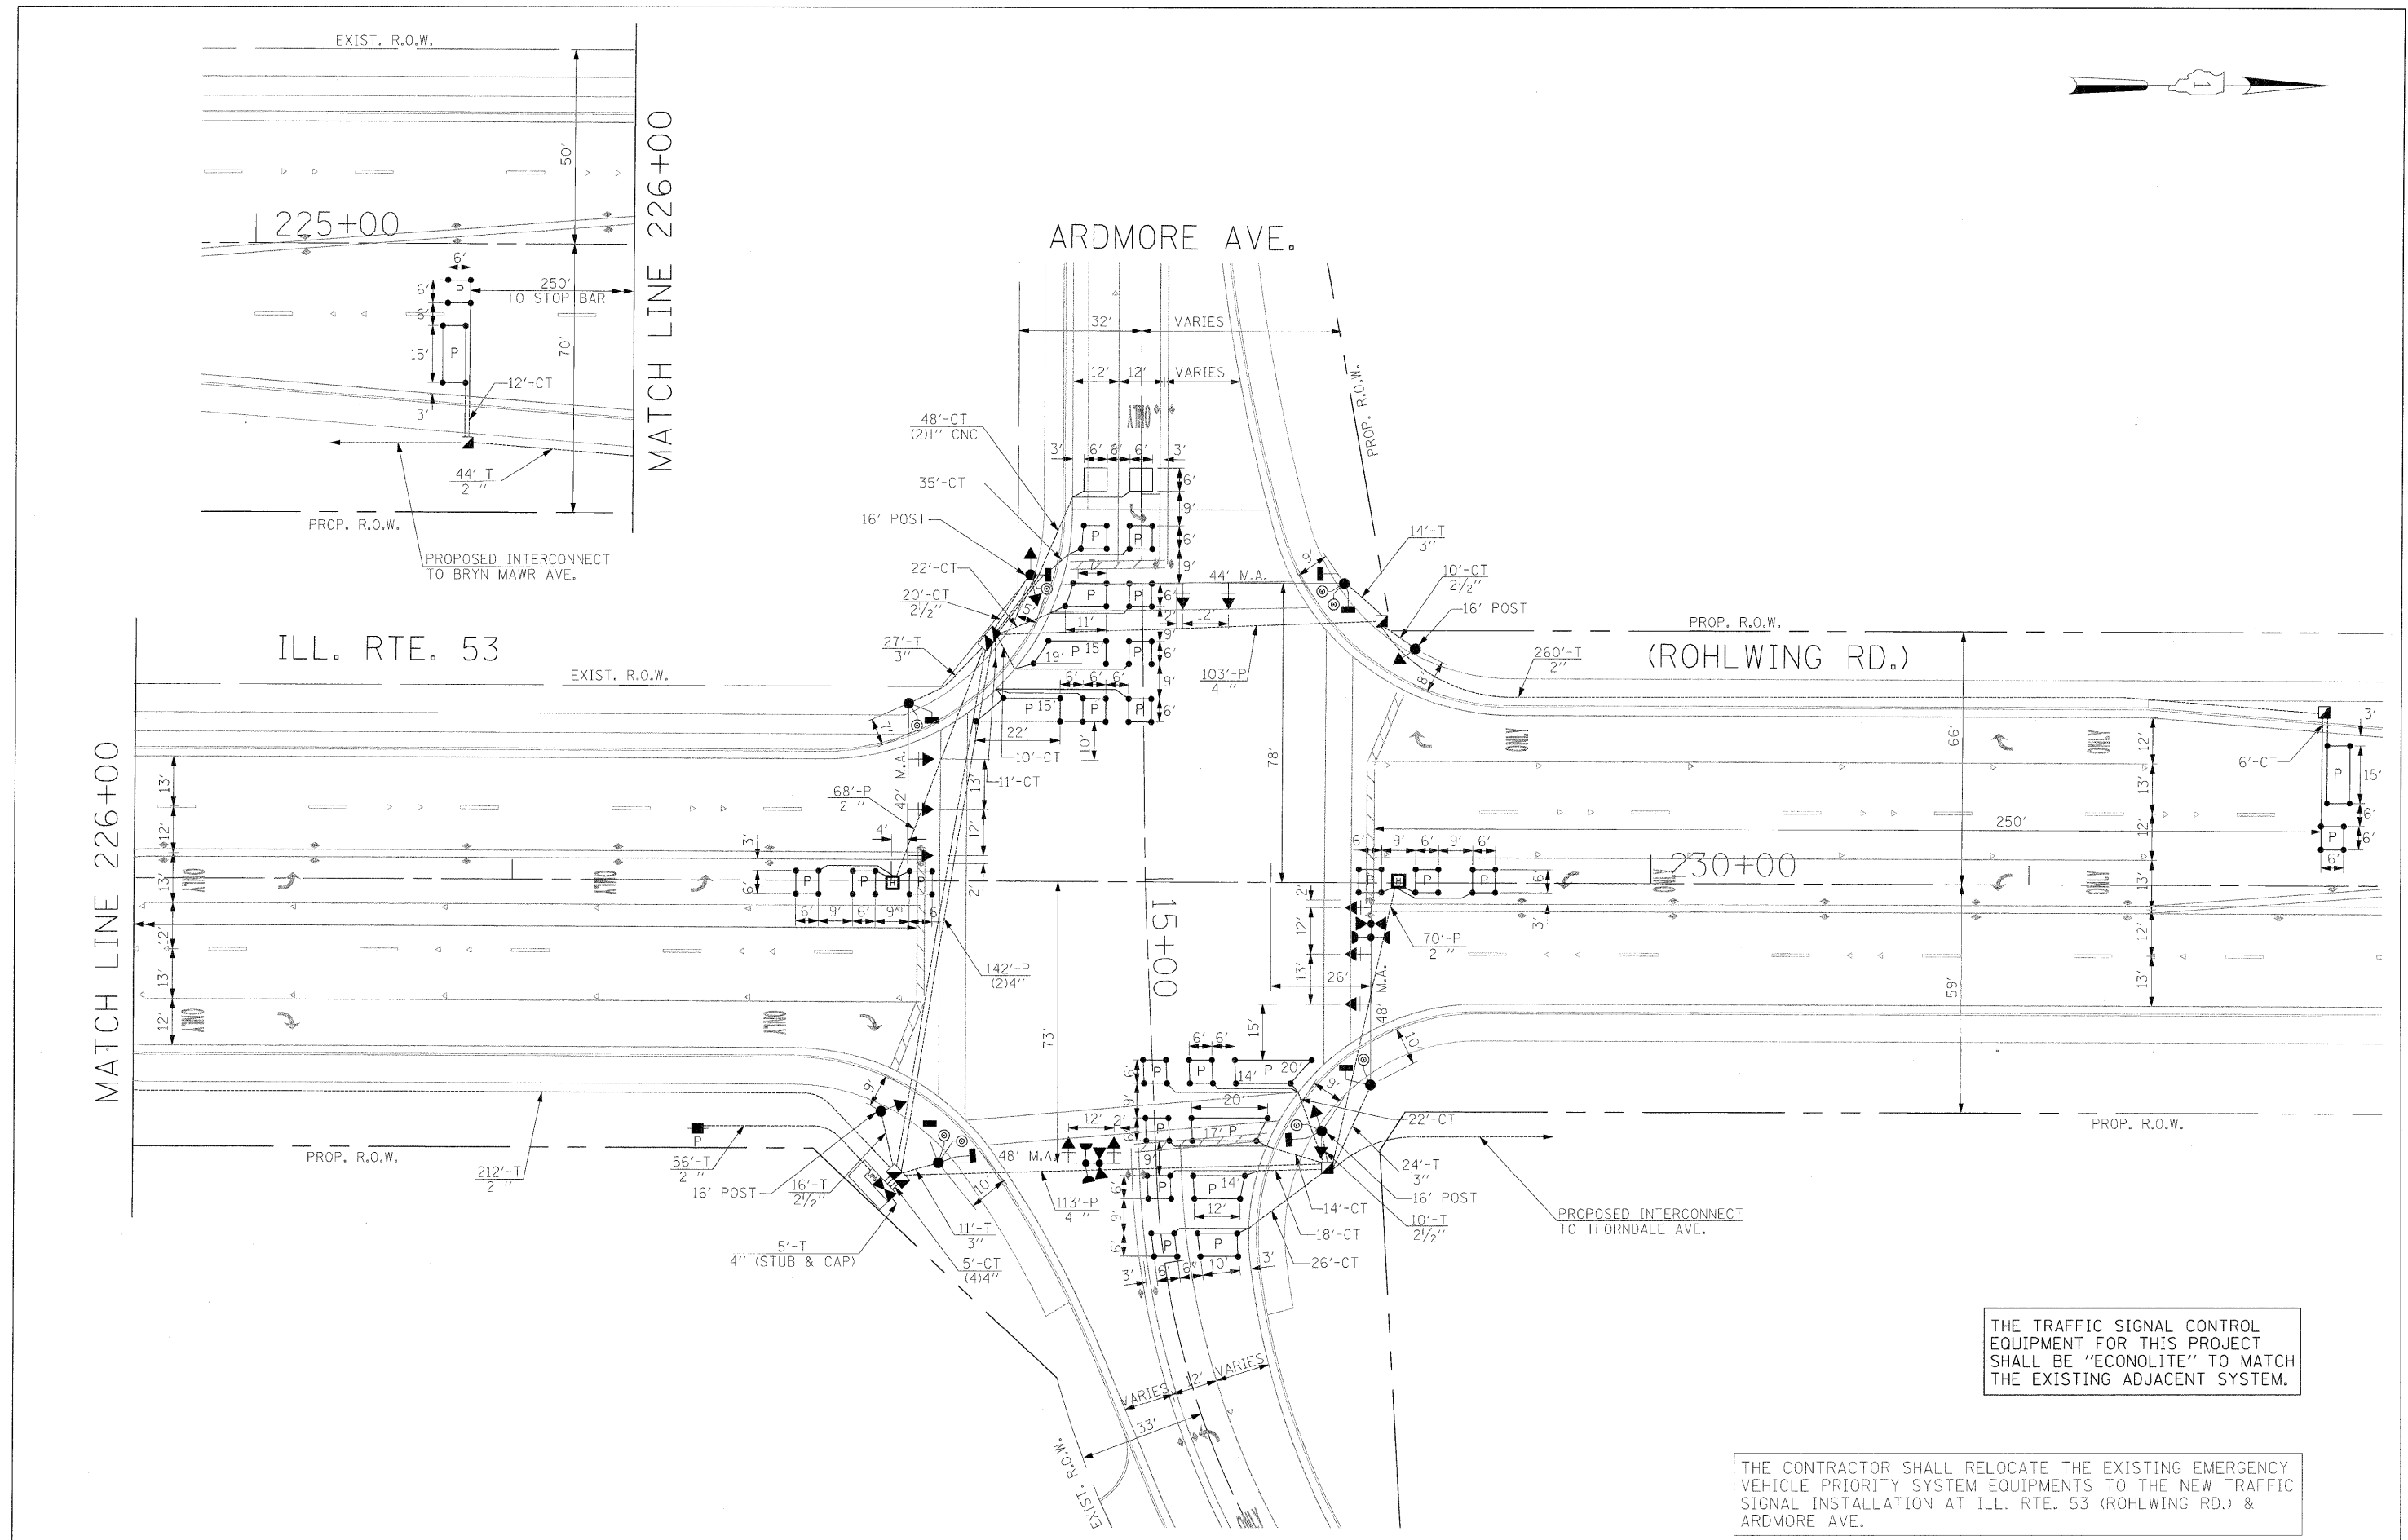

THE TRAFFIC SIGNAL CONTROL EQUIPMENT FOR THIS PROJECT SHALL BE "ECONOLITE" TO MATCH THE EXISTING ADJACENT SYSTEM.

THE CONTRACTOR SHALL RELOCATE THE EXISTING EMERGENCY VEHICLE PRIORITY SYSTEM EQUIPMENTS TO THE NEW TRAFFIC SIGNAL INSTALLATION AT ILL. RTE. 53 (ROHLWING RD.) & ARDMORE AVE.

| | | | | | | | | | | |
|-----------------------|----------------------|------------------|-----------|---|---|--|---------|--------|--------------|-----------|
| FILE NAME - #FILE# | USER NAME = #USER# | DESIGNED - PKG | REVISED - | STATE OF ILLINOIS DEPARTMENT OF TRANSPORTATION | PROPOSED TRAFFIC SIGNAL INSTALLATION PLAN ILLINOIS ROUTE 53 (ROHLWING RD.) AT ARDMORE AVE. | F.A.P. RTE. | SECTION | COUNTY | TOTAL SHEETS | SHEET NO. |
| | PLOT SCALE = #SCALE# | DRAWN - MAA, EA | REVISED - | | | 2578 | 532B | DuPage | 781 | 498 |
| PLOT DATE = #DATE# | CHECKED - PKG, EA | DATE - 5/10/2010 | REVISED - | SCALE: 1"=20' | SHEET NO. OF SHEETS STA. TO STA. | FED. ROAD DIST. NO. - [ILLINOIS] FED. AID PROJECT CONTRACT NO. 60477 | | | | |

| SCHEDULE OF QUANTITIES | | |
|------------------------|-------|---|
| QUANTITY | UNIT | ITEM |
| 36 | SQ FT | SIGN PANEL - TYPE 1 |
| 572 | FOOT | CONDUIT IN TRENCH, 2" DIA., GALVANIZED STEEL |
| 46 | FOOT | CONDUIT IN TRENCH, 2 1/2" DIA., GALVANIZED STEEL |
| 78 | FOOT | CONDUIT IN TRENCH, 3" DIA., GALVANIZED STEEL |
| 25 | FOOT | CONDUIT IN TRENCH, 4" DIA., GALVANIZED STEEL |
| 144 | FOOT | CONDUIT PUSHED, 2" DIA., GALVANIZED STEEL |
| 500 | FOOT | CONDUIT PUSHED, 4" DIA., GALVANIZED STEEL |
| 4 | EACH | HANDHOLE |
| 2 | EACH | HEAVY-DUTY HANDHOLE |
| 2 | EACH | DOUBLE HANDHOLE |
| 660 | FOOT | TRENCH AND BACKFILL FOR ELECTRICAL WORK |
| 1 | EACH | FULL-ACTUATED CONTROLLER AND TYPE IV CABINET, SPECIAL |
| 1 | EACH | TRANSCEIVER-FIBER OPTIC |
| 1480 | FOOT | ELECTRIC CABLE IN CONDUIT, SIGNAL NO. 14 2C |
| 1879 | FOOT | ELECTRIC CABLE IN CONDUIT, SIGNAL NO. 14 3C |
| 1788 | FOOT | ELECTRIC CABLE IN CONDUIT, SIGNAL NO. 14 5C |
| 1750 | FOOT | ELECTRIC CABLE IN CONDUIT, SIGNAL NO. 14 7C |
| 1954 | FOOT | ELECTRIC CABLE IN CONDUIT, LEAD-IN, NO. 14 1 PAIR |
| 76 | FOOT | ELECTRIC CABLE IN CONDUIT, SERVICE, NO. 6 2C |
| 4 | EACH | TRAFFIC SIGNAL POST, GALVANIZED STEEL 16 FT. |
| 1 | EACH | STEEL MAST ARM ASSEMBLY AND POLE, 42 FT. |
| 1 | EACH | STEEL MAST ARM ASSEMBLY AND POLE, 44 FT. |
| 2 | EACH | STEEL MAST ARM ASSEMBLY AND POLE, 48 FT. |
| 16 | FOOT | CONCRETE FOUNDATION, TYPE A |
| 4 | FOOT | CONCRETE FOUNDATION, TYPE C |
| 60 | FOOT | CONCRETE FOUNDATION, TYPE E 36-INCH DIAMETER |
| 6 | EACH | SIGNAL HEAD, LED, 1-FACE, 3-SECTION, MAST ARM MOUNTED |
| 2 | EACH | SIGNAL HEAD, LED, 1-FACE, 5-SECTION, BRACKET MOUNTED |
| 4 | EACH | SIGNAL HEAD, LED, 1-FACE, 5-SECTION, MAST ARM MOUNTED |
| 2 | EACH | SIGNAL HEAD, LED, 2-FACE, 1-3 SECTION, 1-5 SECTION, BRACKET MOUNTED |
| 4 | EACH | PEDESTRIAN SIGNAL HEAD, LED, 1-FACE, BRACKET MOUNTED WITH COUNTDOWN TIMER |
| 2 | EACH | PEDESTRIAN SIGNAL HEAD, LED, 2-FACE, BRACKET MOUNTED WITH COUNTDOWN TIMER |
| 10 | EACH | TRAFFIC SIGNAL BACKPLATE, LOUVERED, ALUMINUM |
| 8 | EACH | INDUCTIVE LOOP DETECTOR |
| 66 | FOOT | DETECTOR LOOP, TYPE 1 |
| 8 | EACH | PEDESTRIAN PUSH-BUTTON |
| 1 | EACH | TEMPORARY TRAFFIC SIGNAL INSTALLATION |
| 2 | EACH | RELOCATE EXISTING EMERGENCY VEHICLE PRIORITY SYSTEM, DETECTOR UNIT |
| 1 | EACH | RELOCATE EXISTING EMERGENCY VEHICLE PRIORITY SYSTEM, PHASING UNIT |
| 1 | EACH | REMOVE EXISTING TRAFFIC SIGNAL EQUIPMENT |
| 8 | EACH | REMOVE EXISTING HANDHOLE |
| 9 | EACH | REMOVE EXISTING CONCRETE FOUNDATION |
| 1192 | FOOT | PREFORMED DETECTOR LOOP |
| 1 | EACH | TEMPORARY TRAFFIC SIGNAL TIMING |
| 1 | EACH | SERVICE INSTALLATION - POLE MOUNTED |
| 1 | EACH | UNINTERRUPTIBLE POWER SUPPLY |
| 854 | FOOT | ELECTRIC CABLE IN CONDUIT, GROUNDING, NO. 6 1C |
| 343 | FOOT | ELECTRIC CABLE IN CONDUIT NO. 20 3/C, TWISTED, SHIELDED |

• 100% COST TO VILLAGE OF ITASCA

THE END OF THE TRACER CABLE SHALL BE CONTINUOUS AND EXTEND INTO THE CONTROLLER CABINET.

INTERCONNECT TO BRYN MAWR AVE.

TRACER CABLE

NO. 6

P

NO. 6

NO. 6

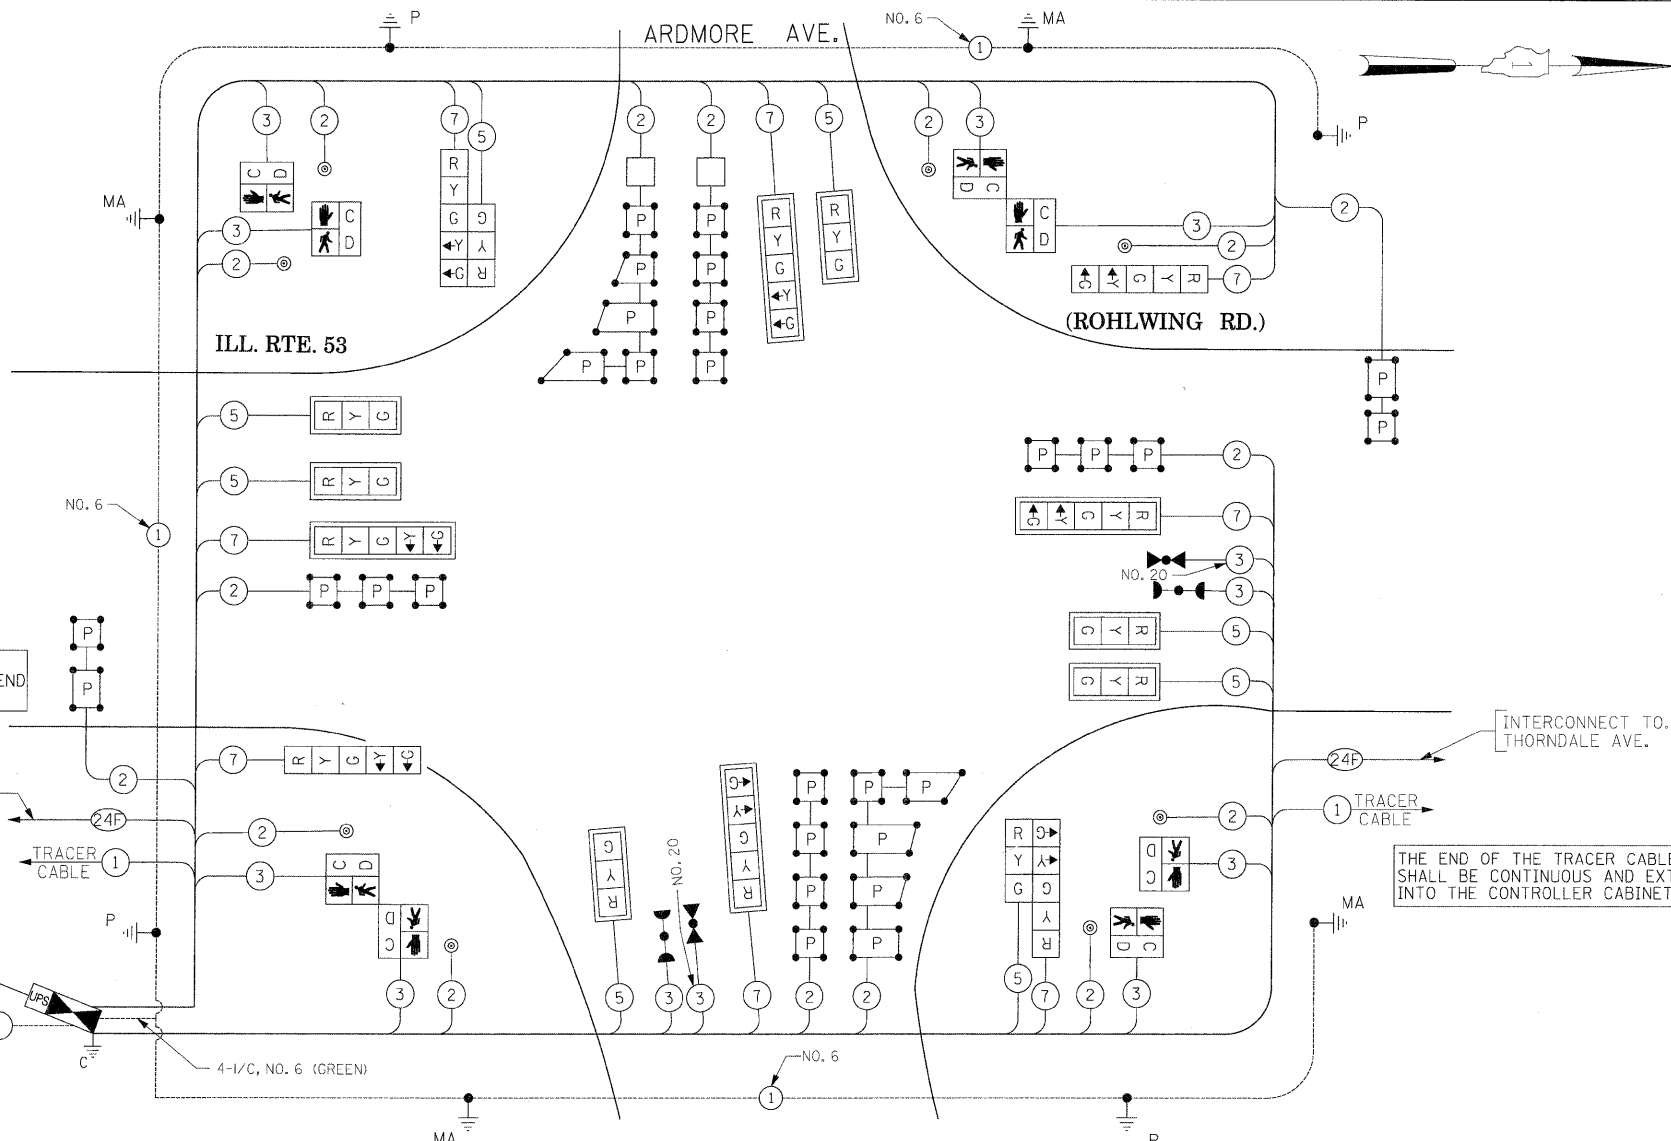


CABLE PLAN
(NOT TO SCALE)

THE END OF THE TRACER CABLE SHALL BE CONTINUOUS AND EXTEND INTO THE CONTROLLER CABINET.


THE TRAFFIC SIGNAL CONTROL EQUIPMENT FOR THIS PROJECT SHALL BE "ECONOLITE" TO MATCH THE EXISTING ADJACENT SYSTEM.

CONTROLLER SEQUENCE

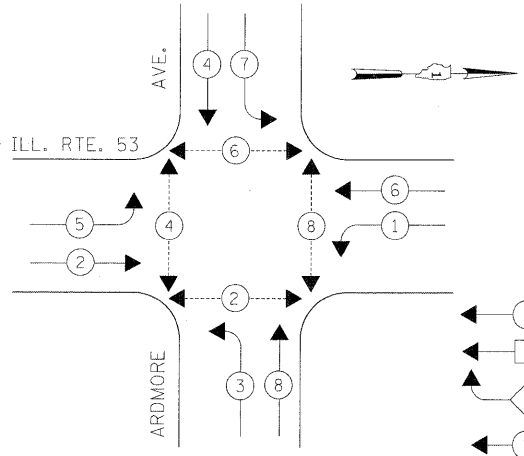

PHASE DESIGNATION DIAGRAM

EMERGENCY VEHICLE PREEMPTION SEQUENCE

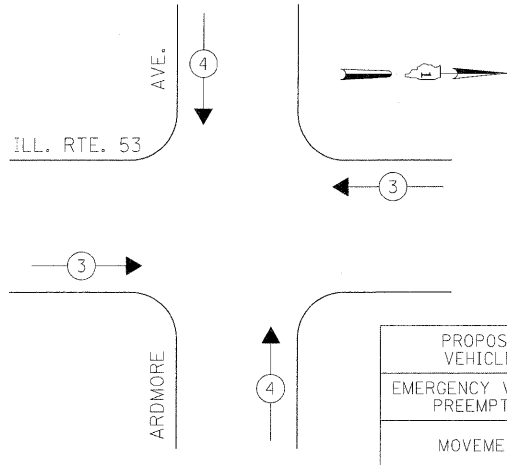

THE CONTRACTOR SHALL RELOCATE THE EXISTING EMERGENCY VEHICLE PRIORITY SYSTEM EQUIPMENTS TO THE NEW TRAFFIC SIGNAL INSTALLATION AT ILL. RTE. 53 (ROHLWING RD.) & ARDMORE AVE.

| I.D.O.T. TRAFFIC SIGNAL INSTALLATION ELECTRICAL SERVICE REQUIREMENTS | | | | | TOTAL WATTAGE |
|---|----------|---------|-----------|------|---------------|
| TYPE | NO LAMPS | WATTAGE | OPERATION | | |
| | | INCAND. | LED | | |
| SIGNAL (RED) | 16 | 135 | 17 | 0.50 | 136 |
| (YELLOW) | 16 | 135 | 25 | 0.25 | 100 |
| (GREEN) | 16 | 135 | 15 | 0.25 | 80 |
| ARROW | 16 | 135 | 12 | 0.10 | 19.2 |
| PED. SIGNAL | 8 | 90 | 25 | 1.00 | 200 |
| CONTROLLER | 1 | 100 | 100 | 1.00 | 100 |
| ILLUM. SIGN | | | 25 | 0.05 | |
| FLASHER | | | | 0.50 | |
| ENERGY COSTS TO: | | | | | TOTAL = 615.2 |
| ILLINOIS DEPARTMENT OF TRANSPORTATION 201 WEST CENTER COURT SCHAUMBURG, ILLINOIS 60196-1096 | | | | | |
| ENERGY SUPPLY CONTACT: CURTIS TOPPS PHONE: (630) 691-4356 COMPANY: COMMONWEALTH EDISON | | | | | |

STATE OF ILLINOIS
DEPARTMENT OF TRANSPORTATION

CABLE PLAN, PHASE DESIGNATION DIAGRAM,
EMERGENCY VEHICLE PREEMPTION SEQUENCE, SCHEDULE OF QUANTITIES
ILLINOIS ROUTE 53 (ROHLWING RD.) AT ARDMORE AVE.

| F.A.P. RTE. | SECTION | COUNTY | TOTAL SHEETS | SHEET NO. |
|--------------------|---------|--------|--------------|-----------|
| 2578 | 532B | DuPage | 781 | 499 |
| CONTRACT NO. 60477 | | | | |

SCALE: NONE SHEET NO. OF SHEETS STA. TO STA.

FED. ROAD DIST. NO. ILLINOIS FED. AID PROJECT

NOTES FOR TEMPORARY TRAFFIC SIGNALS




- ALL CONTROL EQUIPMENT INCLUDING EMERGENCY PRE-EMPTION AND COMMUNICATION DEVICES FOR THE TEMPORARY TRAFFIC SIGNAL(S) SHALL BE FURNISHED BY THE CONTRACTOR.
- ONLY CONTROLLERS SUPPLIED BY ONE OF THE DISTRICT APPROVED CLOSED LOOP EQUIPMENT MANUFACTURERS WILL BE APPROVED FOR USE AT TEMPORARY SIGNAL LOCATIONS. ALL CONTROLLERS USED FOR TEMPORARY TRAFFIC SIGNALS SHALL BE FULLY ACTUATED NEMA MICROPROCESSOR BASED WITH RS232 DATA ENTRY PORTS COMPATIBLE WITH EXISTING MONITORING SOFTWARE APPROVED BY IDOT DISTRICT 1. INSTALLED IN A NEMA TS2 CABINET. ONLY ONE BRAND OF CONTROLLER WILL BE ACCEPTED FOR ANY ONE CONTRACT.
- ALL TRAFFIC SIGNAL SECTIONS AND PEDESTRIAN SIGNAL SECTIONS SHALL BE LED AND 12" (300mm) DIAMETER. HEADS SHALL BE PLACED AS INDICATED ON THE TEMPORARY TRAFFIC SIGNAL PLAN OR AS DIRECTED BY THE ENGINEER. PEDESTRIAN SIGNALS SHALL INCLUDE SOLID INTERNATIONAL SYMBOLS. PEDESTRIAN SIGNALS WITH COUNTDOWN TIMERS SHALL BE USED WHEN THE EXISTING INSTALLATION UTILIZES COUNTDOWN TYPE OR AS DIRECTED BY THE ENGINEER. COUNTDOWN TYPE PEDESTRIAN SIGNALS ARE NOT TO BE INSTALLED AT A RAILROAD INTERSECTION. THE CONTRACTOR SHALL FURNISH ENOUGH CABLE SLACK TO RELOCATE HEADS TO ANY POSITION ON THE SPAN WIRE OR AT LOCATIONS ILLUSTRATED ON THE PLANS FOR CONSTRUCTION STAGING. THE TEMPORARY TRAFFIC SIGNAL SHALL REMAIN IN OPERATION DURING ALL SIGNAL HEAD RELOCATIONS. EACH TEMPORARY TRAFFIC SIGNAL HEAD SHALL HAVE ITS OWN CABLE FROM THE CONTROLLER CABINET TO THE SIGNAL HEAD.
- ALL EXISTING STREET NAME AND INTERSECTION REGULATORY SIGNS SHALL BE REMOVED FROM EXISTING POLES, RELOCATED AND SECURELY FASTENED TO THE SPAN WIRE OR WOOD POLE AS DIRECTED BY THE ENGINEER.
- ANY TEMPORARY SIGNAL WITHIN AN EXISTING CLOSED LOOP TRAFFIC SIGNAL SYSTEM SHALL BE INTERCONNECTED TO THAT SYSTEM USING SIMILAR BRAND CONTROL EQUIPMENT.
- THE TEMPORARY TRAFFIC SIGNAL SHALL HAVE THE SIGNAL HEAD DISPLAYS, SIGNAL HEAD PLACEMENTS AND CONTROLLER PHASING MATCH THE EXISTING TRAFFIC SIGNAL, AT THE TIME OF THE TURN ON, IF NO TRAFFIC STAGING IS IN PLACE OR WILL NOT BE STAGED ON THE DAY OF THE TURN ON.
- UNINTERRUPTIBLE POWER SUPPLY (UPS) SYSTEMS SHALL BE INSTALLED AND MADE OPERATIONAL AT TEMPORARY TRAFFIC SIGNAL INSTALLATIONS WHERE UPS IS INSTALLED AT THE EXISTING TRAFFIC SIGNAL. TEMPORARY TRAFFIC SIGNALS AT RAILROAD INTERSECTIONS, AND TEMPORARY TRAFFIC SIGNALS AT INTERSECTIONS WITH FIRE STATION ACTUATED EMERGENCY VEHICLE PRE-EMPTION, OR WHEN INDICATED ON THE PLANS.
- TRAFFIC SIGNAL MANAGEMENT SYSTEMS SHALL BE MAINTAINED IN OPERATION AS INDICATED ON THE PLANS OR AS DIRECTED BY THE ENGINEER. REQUIRED EQUIPMENT SHALL BE AS SHOWN ON THE PLANS AND THE CONTRACTOR SHALL PLACE THE EQUIPMENT IN OPERATION TO THE SATISFACTION OF THE ENGINEER AND THE AGENCY RESPONSIBLE FOR THE TRAFFIC SIGNAL MANAGEMENT SYSTEM.
- DETECTION AT TEMPORARY TRAFFIC SIGNALS SHALL BE INCLUDED FOR ALL APPROACHES OF THE INTERSECTION UNLESS INDICATED OTHERWISE ON THE PLANS. THE DETECTION SYSTEM MUST MEET THE SPECIFICATIONS OF DISTRICT 1 AND THE CONTRACTOR SHALL PLACE THE DETECTORS INTO OPERATION TO THE SATISFACTION OF THE ENGINEER.
- WHEN PAN, TILT, ZOOM CAMERAS ARE INSTALLED AT THE EXISTING INTERSECTION OR ARE CALLED FOR IN THE PLANS, THE CONTRACTOR SHALL BE RESPONSIBLE FOR INSTALLING AND MAINTAINING THE CAMERAS TO THE SATISFACTION OF THE ENGINEER AND THE AGENCY RESPONSIBLE FOR THE CAMERAS.

THE FOLLOWING ITEMS SHALL BE REMOVED BY THE CONTRACTOR AND SHALL BE DISPOSED OF BY THEM OUTSIDE THE RIGHT-OF-WAY AT THEIR EXPENSE. THE SALVAGE VALUE OF THE REMOVED EQUIPMENT SHALL BE REFLECTED IN THE CONTRACTOR'S BID PRICE.

- 1 EACH CONTROLLER AND CABINET COMPLETE
- 4 EACH SIGNAL HEAD, 1-FACE 3-SECTION, BRACKET MOUNTED
- 2 EACH SIGNAL HEAD, 1-FACE 5-SECTION, BRACKET MOUNTED
- 2 EACH SIGNAL HEAD, 1-FACE 5-SECTION, MAST ARM MOUNTED
- 2 EACH TRAFFIC SIGNAL BACKPLATE
- 6 EACH TRAFFIC SIGNAL POST
- 2 EACH STEEL MAST ARM ASSEMBLY AND POLE
- 1 EACH SERVICE INSTALLATION

NOTE: THE VIDEO DETECTION ZONES SHOWN ON THE PLANS ARE FOR CONSTRUCTION STAGE 1 - SUBSTAGE 1 AND SHALL BE REDEFINED FOR EACH CONSTRUCTION STAGE AS A PART OF "TEMPORARY TRAFFIC SIGNAL INSTALLATION" WORK.

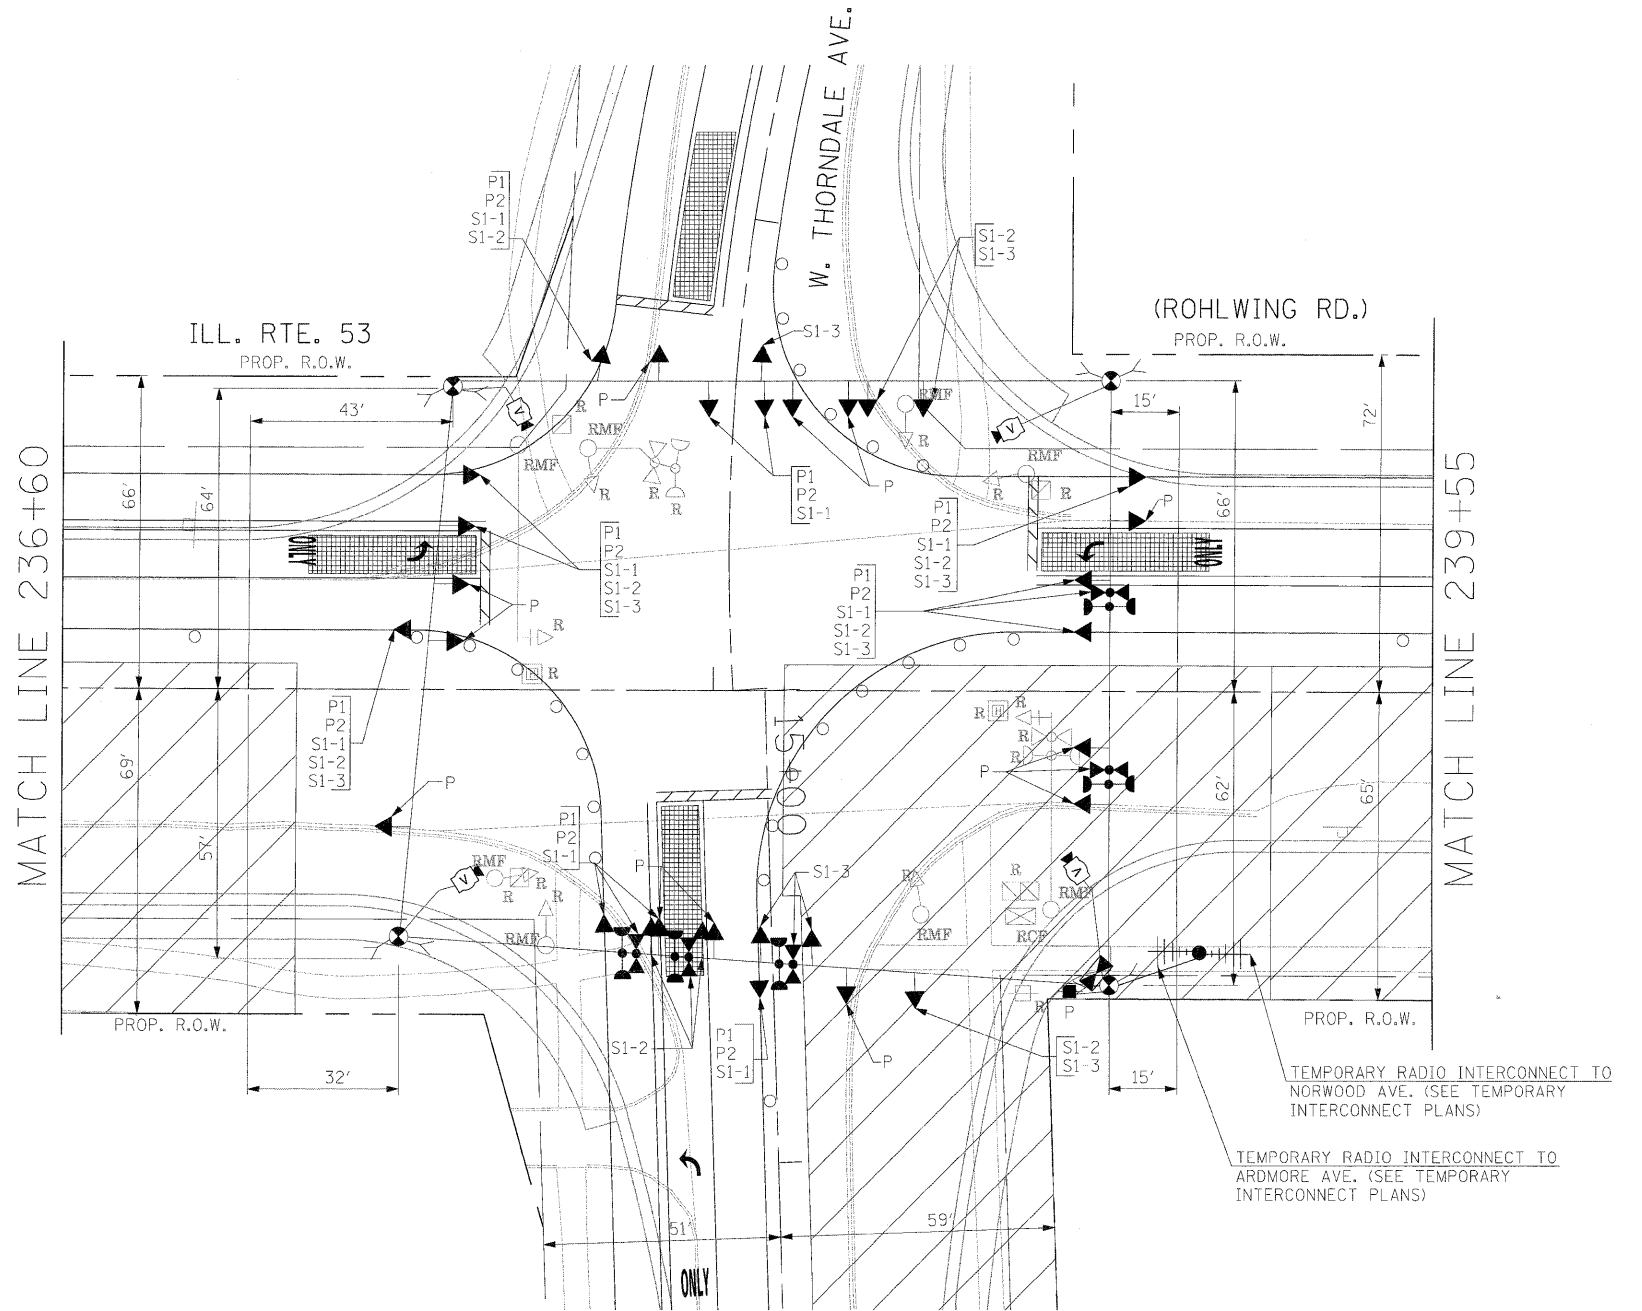

SIGNAL HEAD PLACEMENTS FOR STAGES: PRE-STAGE S1-1, S1-2, AND S1-3.

THE TRAFFIC SIGNAL CONTROL EQUIPMENT FOR THIS PROJECT SHALL BE "ECONOLITE" TO MATCH THE EXISTING ADJACENT SYSTEM.

THE CONTRACTOR SHALL RELOCATE THE EXISTING EMERGENCY VEHICLE PRIORITY SYSTEM EQUIPMENTS TO THE NEW TRAFFIC SIGNAL INSTALLATION AT ILL. RTE. 53 (ROHLWING RD.) & W. THORNDALE AVE.

| | | | | | | | | | | | | | |
|-------------|----------------------|-------------------|-----------|---|--|-----------|--------|--------|-------------|---------|--------|---------------------|---------------------------|
| FILE NAME = | USER NAME = #USER# | DESIGNED - PKG | REVISED - | STATE OF ILLINOIS DEPARTMENT OF TRANSPORTATION | TEMPORARY TRAFFIC SIGNAL INSTALLATION AND REMOVAL PLAN ILLINOIS ROUTE 53 (ROHLWING RD.) AT W. THORNDALE AVE. PRE STAGE AND STAGE 1 (SHEET 1 OF 4) | | | | F.A.P. RTE. | SECTION | COUNTY | TOTAL SHEETS | SHEET NO. |
| #FILE# | | DRAWN - MAA, EA | REVISED - | | 2578 | 532B | DuPage | 781 | 500 | | | | |
| | PLOT SCALE = #SCALE# | CHECKED - PKG, EA | REVISED - | | CONTRACT NO. 60477 | | | | | | | | |
| | PLOT DATE = #DATE# | DATE - 5/10/2010 | REVISED - | | SCALE: 1"=20' | SHEET NO. | OF | SHEETS | STA. | TO | STA. | FED. ROAD DIST. NO. | ILLINOIS FED. AID PROJECT |