### **INDEX OF SHEETS**

SHEET NO.	DESCRIPTION
1 2 3 4 5	COVER SHEET GENERAL NOTES & SPECIFICATIONS SUMMARY OF OUANTITIES TYPICAL SECTIONS PLAN AND PROFILE TEMPORARY DETOUR PLAN
7 8-16 17-18	STRIPING, EROSION CONTROL & RESTORATION PLAN BRIDGE PLANS CROSS SECTIONS


### STATE STANDARDS

	Andrew 1997 - 19
000001-05 280001-05	STANDARD SYMBOLS, ABBREVIATIONS AND PATTERNS TEMPORARY EROSION CONTROL SYSTEM
515001-03	· <del></del>
542301-02	
602001-01	· · · · · · · · · · · · · · · · · · ·
602401-02	
604001-03	
604006-04	
606001-04	
	CONCRETE CURB AND GUTTER
630001-08	STEEL PLATE BEAM GUARDRAIL
630301-05	SHOULDER WIDENING FOR TYPE 1 (SPECIAL) GUARDRAIL TERMINALS
631031-08	
635006-03	
635011-02	
701006-03	
	15' (4.5M) TO 24'' (600mm) FROM PAVEMENT EDGE
701001 07	
101201-03	LANE CLOSURE, 2L, 2W, DAY ONLY, FOR SPEEDS <u>&gt;</u> 45 MPH
701301-03	
	SHORT TIME OPERATIONS
701901-01	TRAFFIC CONTROL DEVICES SIGN PANEL MOUNTING DETAILS
720001-01	
720006-02	
720011-01	METAL POSTS FOR SIGNS, MARKERS AND DELINEATORS
728001-01	TELESCOPING STEEL SIGN SUPPORT
729001-01	APPLICATIONS OF TYPES A & B METAL POSTS
700001 00	(FOR SIGNS AND MARKERS) TYPICAL PAVEMENT MARKINGS
780001-02 BLR 21-8	TYPICAL PAVEMENT MARKINGS TYPICAL APPLICATION OF TRAFFIC CONTROL DEVICES
BLR 21-8	FOR CONSTRUCTION ON RURAL LOCAL HIGHWAYS
701801-04	LANE CLOSURE MULTILANE IW OR ZW CROSSWALK
	OF SIDELIALL PLACES
BLR 22-6	TYPICAL APPLICATION OF TRAFFIC CONTROL DEVICES
	FOR CONSTRUCTION ON RURAL LOCAL HIGHWAYS

### **STRUCTURE INFORMATION:**

EXISTING SN: 101-6124:
EXISTING THREE SPAN STRUCTURE CONSISTS OF CONTINUOUS REINFORCED CONCRETE SLAB WITH AN OUT-TO-OUT WIDTH OF 39'-O" AND A TOTAL LENGTH OF 76"-3 5/8" BK. TO BK.
ABUTMENTS WITH A 9 DEGREE 56 MINUTE SKEW. THE SUBSTRUCTURES CONSIST OF PILE BENT PIERS AND ABUTMENTS. SUPERSTRUCTURE TO BE REMOVED AS SHOWN. SALVAGED EXISTING ALUMINUM RAILINGS TO REMAIN PROPERTY OF THE CITY.

PROPOSED WORK INCLUDES PLACING A REINFORCED CONCRETE SLAB SUPERSTRUCTURE AS SHOWN.

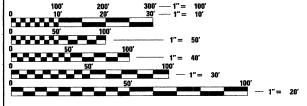

FULL SIZE PLANS HAVE BEEN PREPARED USING STANDARD ENGINEERING SCALES. REDUCED SIZED PLANS WILL NOT CONFORM TO STANDARD SCALES. IN MAKING MEASUREMENTS ON REDUCED PLANS, THE ABOVE SCALES MAY BE USED.

J.U.L.I.E.

JOINT UTILITY LOCATION INFORMATION FOR EXCAVATION 1-800-892-0123

CONTRACT NO. 85508


### **ENGINEER AND SURVEYOR:**

SEC GROUP INC.
420 NORTH FRONT STREET
MCHENRY, ILLINOIS 60050-2136
(815) 385-1778
CONTACT:
BOB DAVIES, S.E., P.E. - STRUCTURAL ENGINEER
KEVIN M. ARFT, P.E. - PROJECT ENGINEER

CITY OF ROCKFORD

# PLANS FOR PROPOSED FEDERAL AID HIGHWAY

FAU ROUTE 5102
CENTRAL AVENUE
OVER THE SOUTH BRANCH OF KENT CREEK
SECTION 09-00557-00-BR
BRIDGE SUPERSTRUCTURE REPLACEMENT
PROJECT NO. BHM-5099 (081)
S.N. 101-6124
WINNEBAGO COUNTY
C-92-097-09

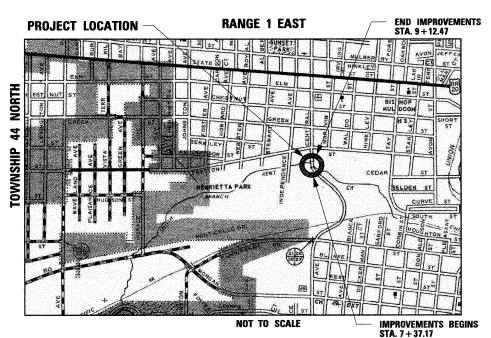

FUNCTIONAL CLASSIFICATION MINOR ARTERIAL (URBAN)

<u>DESIGN SPEED</u> CENTRAL AVE.: 35 MPH

SPEED LIMIT CENTRAL AVE.: 30 MPH

TRAFFIC DATA:

CENTRAL AVE: ADT = 5,800 (2008)

ADT = 7,200 (2030)

 F.A.U. RTE.
 SECTION
 COUNTY SHEET SHEET NO.

 5102
 09-00557-00-BR
 Winnebago
 18
 1

 FED. ROAD DIST. NO. 2
 ILLINOIS
 CONTRACT
 NO.
 85508



# PRINTED BY THE AUTHORITY OF THE STATE OF ILLINOIS

-	CITY OF ROCKFORD
APPROVED	Bud T. Mobing (DATE)  CITY OF ROCKFORD, CITY ENGINEER
	CITY OF ROCKFORD, CITY ENGINEER
PASSED	FEBRUARY 9, 2010 (DATE)
RELEASING FOR BID BASED ON LIMITED REVIEW	DISTRICT 2 ENGINEER OF LOCAL ROADS & STREETS
	DEBUTY DIRECTOR OF HIGHWAYS, REGION 2 ENGINEER

GROSS LENGTH OF IMPROVEMENT = 176 FT. = 0.03 MILES NET LENGTH OF IMPROVEMENT = 176 FT. = 0.03 MILES

**ROCKFORD TOWNSHIP** 

ITH OF IMPROVEMENT = 176 F1. = 0.03 MILES	
STRUCTURAL ENGINEER'S SIGN & SEAL	or and the second secon
ROBERT G. DAVIES, S.E., P.E.	- Constitution of the second
1-26-2010	
DATE	STRUCTURAL THE
11/30/2010	EXPIRES: 11/30/3010
EXPIRES	

PROFESSIONAL ENGINEER'S SIGN & SEAL	
for Mast	M. ARAM
CI- 26- 2010	062-059077  REGISTERED PROFESSIONAL *
DATE	ENGINEER OF
//- 30 - 20// EXPIRES	Manufacture 1

### GENERAL NOTES

- REMOVAL AND DISPOSAL OF UNSUITABLE MATERIAL, AND POROUS GRANULAR EMBANKMENT SUBGRADE HAS BEEN ADDED FOR USE IF UNSUITABLE MATERIAL IS ENCOUNTERED IN THE FIELD, AS DETERMINED BY THE ENGINEER. IF UNSUITABLE AND/OR UNSTABLE MATERIALS IS NOT ENCOUNTERED, THEN THE QUANTITY SHALL BE DEDUCTED AND NO COMPENSATION WILL BE DUE THE CONTRACTOR.
- 2. FORTY EIGHT HOURS BEFORE STARTING EXCAVATION THE CONTRACTOR WILL CALL J.U.L.I.E. (1-800-892-0123) TO HAVE THE LOCATION OF EXISTING UTILITIES
- 3. THE CONTRACTOR SHALL CONTACT THE CITY OF ROCKFORD AT LEAST 72 HOURS IN ADVANCE OF BEGINNING ANY WORK ON CENTRAL AVENUE.
- 4. THE CONTRACTOR WILL NOT BE ALLOWED TO SET UP A YARD OR FIELD OFFICE ON CITY PROPERTY WITHOUT WRITTEN PERMISSION FROM THE CITY OF ROCKFORD.
- 5. PRIOR TO COMMENCEMENT OF CONSTRUCTION, THE CONTRACTOR SHALL VERIFY ALL DIMENSIONS AND CONDITIONS AFFECTING THEIR WORK WITH THE ACTUAL CONDITIONS AT THE JOB SITE. IN ADDITION, THE CONTRACTOR MUST VERIFY THE ENGINEER'S LINE AND GRADE STAKES. IF THERE ARE ANY DISCREPANCIES FROM WHAT IS SHOWN ON THE CONSTRUCTION PLANS, HE MUST IMMEDIATELY REPORT SAME TO THE ENGINEER BEFORE DOING ANY WORK, OTHERWISE THE CONTRACTOR ASSUMES FULL RESPONSIBILITY. IN THE EVENT OF DISAGREEMENT BETWEEN THE CONSTRUCTION PLANS, STANDARD SPECIFICATIONS AND/OR SPECIAL DETAILS, THE CONTRACTOR SHALL SECURE WRITTEN INSTRUCTIONS FROM THE ENGINEER PRIOR TO PROCEEDING WITH ANY PART OF THE WORK AFFECTED BY OMISSIONS OR DISCREPANCIES. FAILING TO SECURE SUCH INSTRUCTIONS, THE CONTRACTOR WILL BE CONSIDERED TO HAVE PROCEEDED AT HIS OWN RISK AND EXPENSE. IN THE EVENT OF ANY DOUBT OR QUESTION ARISING WITH RESPECT TO THE TRUE MEANING OF THE CONSTRUCTION PLANS OR SPECIFICATIONS, THE DECISION OF THE ENGINEER SHALL BE FINAL AND CONCLUSIVE.
- 6. THE LENGTH OF "GUARDRAIL REMOVAL" INCLUDES THE LENGTH OF THE TRAFFIC BARRIER TERMINALS.
- 7. THE WORK UNDER THIS CONTRACT SHALL CONFORM TO ALL REGULATIONS GIVEN IN THE ARMY CORPS OF ENGINEERS PERMIT ISSUED FOR THE PROJECT.
- 8. REMOVAL AND RELOCATION OF EXISTING SIGNS AND EXISTING TRAFFIC CONTROL SIGNS WILL NOT BE PAID SEPARATELY BUT WILL BE INCLUDED IN THE UNIT COST OF THE PAY ITEMS PERSUANT TO ARTICLE 107 OF THE "STANDARD SPECIFICATIONS"
- 9. THE CONTRACTOR SHALL PROVIDE ACCESS TO ALL ABUTTING PROPERTY AT ALL TIMES DURING THE CONSTRUCTION OF THIS PROJECT, EXCEPT FOR PERIODS OF SHORT DURATION AS DETERMINED
- 10. THE ENGINEER WILL BE THE SOLE JUDGE CONCERNING CURING TIME FOR THE VARIOUS
- 11. EXCEPT AS NOTED ON THE PLANS, PAVEMENT GRADES SHOWN ARE AT THE TOP OF PAVEMENT SURFACES.
- 12. OFFSET LOCATIONS GIVEN IN THE PLANS FOR STRUCTURES, EDGE OF PAVEMENT, ETC. ARE FROM THE ROADWAY CENTERLINE UNLESS NOTED OTHERWISE.
- 13. ALL ELEVATIONS REFERRING TO U.S.G.S. MEAN SEA LEVEL DATUM.
- 14. ADDITIONAL SHOULDER WIDENING INDICATED IN HIGHWAY STANDARD 630301-05 WILL NOT BE REQUIRED
- 15. THE EXISTING BRIDGE DESIGN PLANS ARE AVAILABLE AT THE CITY OF ROCKFORD.


### UTILITY CONTACTS

CITY OF ROCKFORD WATER DIVISION	GREG CASSARO	(815)	987-3084
ROCK RIVER WATER RECLAMATION DISTRICT	MIKE OLSON	(815)	387-7663
COMCAST	MICHAEL OWENS	(815)	509-7876
COMED	MIKE LENOX	(815)	490-2869
AT&T	STEVEN JONES	(815)	394-7270
NICOR	CHRIS WINTERS	(815)	455-0271

16. THE LOCATION OF EXISTING DRAINAGE STRUCTURES, STORM SEWERS, WATER MAINS, SANITARY SEWERS, AND ANY OTHER PUBLIC OR PRIVATE UTILITIES AS SHOWN ON THE PLANS IS APPROXIMATE AND THEIR EXACT LOCATION IS TO BE DETERMINED IN THE FIELD BY THE CONTRACTOR, THIS WORK SHALL BE CONSIDERED AS INCLUDED IN THE UNIT BID PRICES OF THE CONTRACT, AND NO ADDITIONAL COMPENSATION WILL BE ALLOWED.

17. THE CONTRACTOR SHALL BE RESPONSIBLE FOR THE PROTECTION OF ALL UNDERGROUND AND SURFACE UTILITIES EVEN THOUGH THEY MIGHT NOT BE SHOWN ON THE PLANS. ANY UTILITY PROPERTY DAMAGED DURING CONSTRUCTION SHALL BE REPAIRED OR REPLACED TO THE SATISFACTION OF THE OWNER AT THE CONTRACTOR'S EXPENSE.

- 18. ANY LOOSE MATERIAL DEPOSITED IN THE FLOWLINES OF DRAINAGE STRUCTURES WHICH OBSTRUCT THE NATURAL FLOW OF WATER SHALL BE REMOVED AT THE CLOSE OF EACH WORKING DAY. PRIOR TO ACCEPTANCE OF THE IMPROVEMENT, ALL DRAINAGE STRUCTURES SHALL BE FREE OF DIRT AND DEBRIS. THIS WORK SHALL NOT BE PAID FOR SEPARATELY BUT SHALL BE CONSIDERED AS INCLUDED IN THE UNIT BID PRICES OF THE CONTRACT.
- 19. WHERE NEW WORK MEETS EXISTING FEATURES TO REMAIN, THE CONTRACTOR SHALL FIELD CHECK ALL DIMENSIONS AND ELEVATIONS PRIOR TO PROCEEDING WITH CONSTRUCTION AND NOTIFY THE ENGINEER IMMEDIATELY OF ANY DISCREPANCIES.
- 20. SEEDING WILL NOT BE PERMITTED AT ANY TIME WHEN THE GROUND IS FROZEN, WET, OR IN AN UNTILLABLE CONDITION. LOCATIONS TO BE SEEDED WILL BE DETERMINED BY THE
- 21. SAW CUTTING WILL BE REQUIRED FOR ALL REMOVAL ITEMS LISTED IN SECTION 440 OF THE STANDARD SPECIFICATIONS, SHOWN IN THE PLANS, AND AS DIRECTED BY THE ENGINEER. THE COST OF SAW CUTTING WILL BE INCLUDED IN CONTRACT UNIT BID PRICES FOR THE ITEMS BEING REMOVED.
- 22. THE COST FOR FURNISHING AND INSTALLING REFLECTOR MARKERS IN ACCORDANCE WITH HIGHWAY STANDARDS 635006 AND 635011 IS INCLUDED IN THE COST OF TRAFFIC BARRIER TERMINALS, OF THE TYPE SPECIFIED.

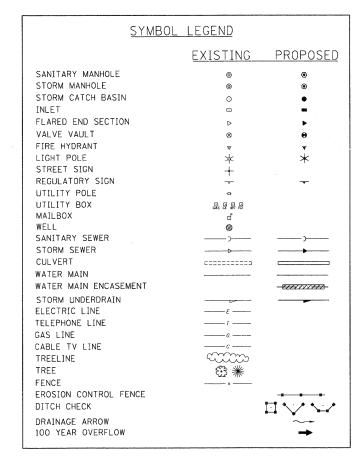

### STANDARD ABBREVIATIONS B-B - BACK TO BACK OF CURB B.C. - BACK OF CURB

B.O.C. - BACK OF CURB B.S.L. - BUILDING SETBACK LINE C.B. - STORM CATCH BASIN

C.E. - COMMONWEALTH EDISON CO. D.F. - DRAINAGE EASEMENT

E-E - EDGE TO EDGE OF PAVEMENT E.O.P. - EDGE OF PAVEMENT

E.O.S. - EDGE OF SHOULDER E.P. - EDGE OF PAVEMENT

E.S. - EDGE OF SHOULDER F.E.S. - FLARED END SECTION

I.B.T. - ILLINOIS BELL TELEPHONE CO. L.E. - LANDSCAPE EASEMENT

M.H. - MANHOLE (TYPE SPECIFIED ON PLANS) R.O.W. - RIGHT OF WAY

T.B.F. - TRENCH BACKFILL T.C. - TOP OF CURB

T.C.E. - TEMPORARY CONSTRUCTION EASEMENT T.O.B. - TOP OF BERM

T.O.C. - TOP OF CURB U.E. - UTILITY EASEMENT

ALIGNMENT DETAIL SEE PLAN AND PROFILE FOR

PI STA. 8+22.88

N: 2042972.0930

E: 2580928.0695

CURVE PR\_2\_CENT\_2 ---

PCC STA. 8+68.42-

N: 2042928.3169

E: 2580943.3026

CURVE PR\_2\_CENT\_1-

PC STA, 7+76,53-

SET PK NAIL

N: 2043018,4408 E: 2580927.5452

-SET PK NAIL

-POT STA. 3+82.00

N: 2043412.9487

E: 2580923.0828

DESIGNED - KMA REVISED JSER NAME = whood SEC Group, Inc. DRAWN WJH REVISED PLOT SCALE = NTS CHECKED -REVISED DATE REVISED 1/26/10

CENTRAL AVENUE OVER THE SOUTH BRANCH OF KENT CREEK **GENERAL NOTES AND SPECIFICATIONS** 

SHEET NO. 1 OF SHEETS STA.

PC STA. 14+79.66-

-SET PK NAIL

N: 2042523.1954

E: 2581392.8626

-SET PK NAIL

-PT STA. 10+06.99

N: 2042816.8559

E: 2581022.4806

-PI STA. 9+39.61

N: 2042861.0833

E: 2580966.6984

SCALE: NTS

-SET PK NAIL

COUNTY TOTAL SHEE SHEETS NO. 09-00557-00-BR Winnebago 18 2 CONTRACT NO. 85508 FED. ROAD DIST, NO. 2 ILLINOIS FED. AID PROJECT

CITY OF ROCKFORD

ADDITIONAL CURVE INFORMATION

	SUMMARY OF QUANTITIES	r/	TOTAL	ROADWAY	BRIDGE
CODE NUMBER	PAY ITEMS	UNIT	QUANTITY	1000	X020-2/
20201200	REMOVAL AND DISPOSAL OF UNSUITABLE MATERIAL	CU. YD.	44.4	44.4	
20700400	POROUS GRANULAR EMBANKMENT, SPECIAL	CU. YD.	32.6		32.6
20700420	POROUS GRANULAR EMBANKMENT, SUBGRADE	CU. YD.	44.4	44.4	· ·
21101615	TOPSOIL FURNISH AND PLACE, 4"	SQ. YD.	316	316	
25000210	SEEDING CLASS 2A	ACRE	0.10	0.10	
25000400	NITROGEN FERTILIZER NUTRIENT	POUND	9	9	
25000500	PHOSPHOROUS FERTILIZER NUTRIENT	POUND	9	9	
25000600	POTASSIUM FERTILIZER NUTRIENT	POUND	9	. 9	
25100630	EROSION CONTROL BLANKET	SO. YD.	316	316	
28000305	TEMPORARY DITCH CHECKS	FOOT	32	32	
28000400	PERIMETER EROSION BARRIER	FOOT	532	532	
28100109	STONE RIPRAP CLASS A5	50. YD.	523		523
28200200	FILTER FABRIC	SQ. YD.	523		523
31101200	SUB-BASE GRANULAR MATERIAL, TYPE B, 4"	SO. YD.	156	156	
40600100	BITUMINOUS MATERIALS (PRIME COAT)	GAL.	64	64	
40600982	HOT-MIX ASPHALT SURFACE REMOVAL - BUTT JOINT	SO. YD.	192	192	
40603080	HOT-MIX ASPHALT BINDER COURSE, IL-19.0, N50	TON	71	71	
40603335	HOT-MIX ASPHALT SURFACE COURSE, MIX "D", N50	TON	36	36	
42400200	PORTLAND CEMENT CONCRETE SIDEWALK, 5"	SQ. FT.	245	245	
44000100	PAVEMENT REMOVAL	SQ. YD.	127	127	
44000500	COMBINATION CURB AND GUTTER REMOVAL	FOOT	90	90	
44000600	SIDEWALK REMOVAL	SQ. FT.	245	245	
50101500	REMOVAL OF EXISTING SUPERSTRUCTURES	EACH	1		1
50200100	STRUCTURE EXCAVATION	CU. YD.	32.6		32.6
50300255	CONCRETE SUPERSTRUCTURE	CU. YD.	160.4		160.4
50300260	BRIDGE DECK GROOVING	SO. YD.	246		246
50300300	PROTECTIVE COAT	SQ. YD.	363		363
50800209	REINFORCEMENT BARS, EPOXY COATED	POUND	42,350		42350
50900105	ALUMINUM RAILING, TYPE L	FOOT	72		72
51500100	NAME PLATES	EACH	1		1
54213675	PRECAST REINFORCED CONCRETE FLARED END SECTIONS 30"	EACH	1	1	:
550A0430	STORM SEWERS, CLASS A, TYPE 2 30"	FOOT	78	78	,
55101400	STORM SEWER REMOVAL 30"	FOOT	42	42	
6020400	CATCH BASINS, TYPE A, 5' DIAMETER, TYPE 3 FRAME AND GRATE	EACH	1	1	
60221100	MANHOLE, TYPE A, 5' DIAMETER, TYPE 1 FRAME, CLOSED LID	EACH	1	1	
6060440	COMBINATION CONCRETE CURB AND GUTTER, TYPE B-6.18	FOOT	90	90	
6300000	STEEL PLATE BEAM GUARDRAIL, TYPE A, 6 FOOT POSTS	FOOT	125	125	
63100085	TRAFFIC BARRIER TERMINAL, TYPE 6	EACH	1	1	~
63100167	TRAFFIC BARRIER TERMINAL, TYPE 1 (SPECIAL) TANGENT	EACH	1	1	
63200310	GUARDRAIL REMOVAL	FOOT	254	254	
6700040	ENGINEER'S FIELD OFFICE, TYPE A	CAL MO	4	4	
67100100		L SUM	1	0.5	0.5
70101700		L SUM	1	1	
78005110		FOOT	800	800	
78201000		EACH	1	1	
X5610010		FOOT	74	-24	74
	CONSTRUCTION LAYOUT	L SUM	1	<del> </del>	

<sup>-</sup> DENOTES SPECIALTY ITEM

SEC Group, Inc.

USER NAME = whood	DESIGNED - KMA	REVISED -
FILE NAME := Ø9ØØ26-Soq.dgn	DRAWN - WJH	REVISED -
PLOT SCALE = NTS	CHECKED - TH	REVISED -
PLOT DATE = 2/3/2010	DATE - 2/3/10	REVISED -

PROPOSED HMA PAVEMENT


4. 5, 6, 13 AS SHOWN ON PROPOSED TYPICAL SECTION LIMITS OF HMA SURFACE REMOVAL - BUTT JOINT
(SEE PLAN AND PROFILE) SAWCUT -PROPOSED HMA RESURFACING

AS SHOWN ON PROPOSED TYPICAL SECTION EXISTING HMA PAVEMENT-EXISTING HMA PAVEMENT PAVEMENT REMOVAL

### HMA SURFACE REMOVAL - BUTT JOINT DETAIL

### STORM SEWER TAGS

- EXIST. MH
  STA. = 7+63.53, 24.8' RT
  RIM = 722.96
  INV = 713.96 N (2-EXIST. 18" RCP)
  INV = 713.96 N (2-EXIST. 15" RCP)
  INV = 713.96 E (PROP. 30" RCP)
  CORE INTO EXIST. MH.
  OPENING LEFT FROM REMOVED 30" RCP
  SHALL BE SEALED WITH CLASS SI CONCRETE.
  THE COST FOR CORING PROP. 30" RCP AND
  CLOSING THE OPENING SHALL BE INCLUDED
  IN THE COST OF STORM SEWER 30".
- 5 MH TA 5' DIA CL STA. = 7+85.43, 26.8' LT RIM = 722.00 INV. = 713.01 W INV. = 712.91 S
- 6 29 LIN FT SS CL A 2 30" @ 1.41%
- 7 PRC FLAR END SEC 30" STA. = 8+15.30, 28.9' LT INV. = 712.50
- 2 43 LIN FT SS CL A 2 30" @ 1.50%
- 3 CB TA 5' DIA T3 F&C STA. = 7+84.97, 16.8' LT RIM = 722.53 (FLOWLINE OF CURB) INV. = 713.0 E
- 4 6 LIN FT SS CL A 2 30" @ 1.50%

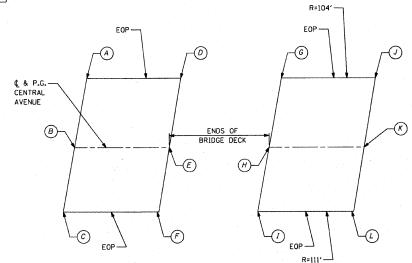


### **PAVEMENT ELEVATION DETAIL**

POINT	STA	EOP OFFSET	PROP. ELEV.
Α	7+69.94	14.72' LT	722.37
В	7+67.17	0.001	722.60
С	7+64.72	13.38' RT	722.65
D	7+90.68	15.44' LT	722.72
Ε	7+87.17	0.00′	723.09
F	7+84.42	13.50' RT	723.43
G	8+70.99	15.59' LT	724.12
Н	8+62.40	0.00′	724.68
I	8+55.79	13.53′ RT	725.08
J	8+91.64	13.54′ LT	724.50
К	8+82.40	0.00′	725.02
L	8+74.09	13.98' RT	725.30

CENTRAL AVENUE OVER THE SOUTH BRANCH OF	KENT CREEK	F.A.U. RTE.	SECTION	COUNTY	TOTAL SHEETS	SHEET NO.	
SUMMARY OF QUANTITIES		5102	09-00557-00-BR	Winnebago	18	3	ı
COMMINANT OF GOTHERIES				CONTRACT	NO. 8	35508	
SCALE: NTS SHEET NO. 1 OF SHEETS STA. T	TO STA.	FED. R	OAD DIST. NO. 2 ILLINOIS FED. AL	D PROJECT	***************************************		

CITY OF ROCKFORD

<sup>△</sup> DENOTES SPECIAL PROVISION

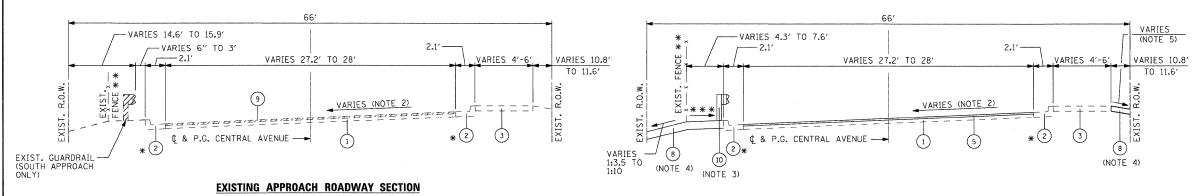


STA. 7+37.17 TO STA. 7+67.17 STA. 8+82.47 TO STA. 9+12.47

HMA SURFACE COVERS EXIST. GUTTER STA. 8+62.97 TO STA. 9+12.47 SOUTH END ONLY


### PROPOSED APPROACH ROADWAY SECTION

HMA SURFACE COVERS EXIST. GUTTER STA. 8+62.97 TO STA. 9+12.47 SOUTH END ONLY VARIES 1.50% TO MATCHING EXIST.

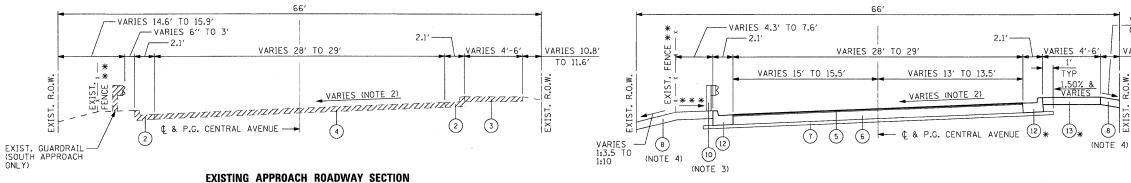

STA. 7+67.17 TO STA. 7+86.67 STA. 8+62.97 TO STA. 8+82.47

\*\* STA. 8+62.97 TO STA. 9+12.47 SOUTH END ONLY

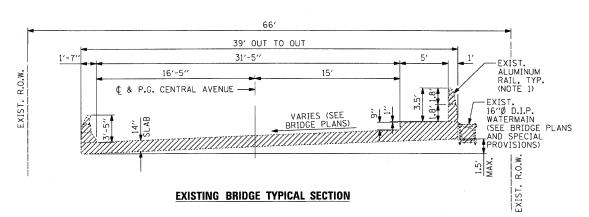


HOT-MIX ASPHALT MIXTURE REQUIREMENTS					
MIXTURE USE	SURFACE	BINDER			
PG:	PG 64-22	PG 58-22			
DESIGN AIR VOIDS	4.0 @ N50	4.0 @ N50			
MIXURE COMPOSITION (GRADIATION MIXTURE)	IL 9.5 OR 12.5	IL 19.0			
FRICTION AGGREGATE	D.	N/A			
20 YEAR ESAL	0.0	0.0			
MIX UNIT WEIGHT	112 LBS/SY/IN				

### PROPOSED APPROACH ROADWAY SECTION

STA. 7+67.17 TO STA. 7+86.67 STA. 8+62.97 TO STA. 8+82.47

STA. 7+55.00 TO STA. 7+86.67 NORTH END STA. 8+62.97 TO STA. 9+12.47 SOUTH END ONLY VARIES 1.50% TO MATCHING EXIST.

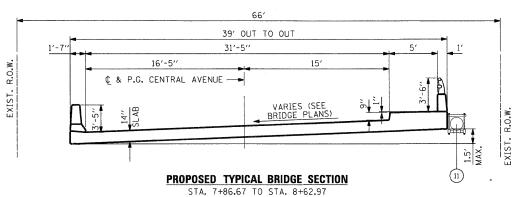

### NOTES

(NOTE 5)

VARIES 10.8

TO 11.6'

- COST FOR REMOVAL INCLUDED IN THE ITEM REMOVAL OF EXISTING SUPERSTRUCTURE
- 2. SEE PAVEMENT ELEVATION DETAIL ON SHEET 3 AND THE CROSS SECTIONS.
- 3. SOUTH APPROACH ONLY
- 4. SEE STRIPING, EROSION CONTROL & RESTORATION PLAN FOR LIMITS
- 5. SEE CROSS SECTIONS

### TYPICAL SECTION LEGEND

- EXISTING HMA PAVEMENT (THICKNESS VARIES 5" TO 10")
- EXIST. COMB. CC&G TB6.18
- EXIST. PCC SIDEWALK
- PAVEMENT REMOVAL
- HOT-MIX ASPHALT SURFACE COURSE MIX "D" N50 @ 2"
- HOT-MIX ASPHALT BINDER COURSE IL - 19.0, N50 @ 10"
- SUBBASE GRANULAR MATERIAL, TYPE B 4"
- TOPSOIL FURNISH & PLACE 4" WITH SEEDING CLASS 2A
- HOT-MIX ASPHALT SURFACE REMOVAL BUTT JOINT
- STEEL PLATE BEAM GUARDRAIL, TYPE A, 6' POSTS (SOUTH APPROACH ONLY)
- RE-ATTACH 16" DIA. D.I.P. WATER MAIN WITH NEW HANGERS (SEE BRIDGE PLANS)
- COMBINATION CONCRETE CURB AND GUTTER, TYPE B-6.18
- PORTLAND CEMENT CONCRETE SIDEWALK 5"




INDICATES ITEMS TO BE REMOVED

SEC Group, Inc.  An HR Green Company 420 N. Front Struct.  Methony, IL 600002 (238)  L 1813.981.778 (4 (6) 309.1781	USER NAME = whood	DESIGNED	-	KMA	REVISED	-
	FILE NAME = Ø9ØØ26-Typ.dgn	DRAWN	-	WJH	REVISED	
	PLOT SCALE = NTS	CHECKED	-	ТН	REVISED	-
www.segroupinc.com  *McHerry,IL *Yorkvile,IL *New Lenox,IL *Chicago,IL	PLOT DATE = 1/26/2010	DATE	-	1/26/10	REVISED	

	CENTRAL	<b>AVENUE OVER</b>	THE SOUTH	BRANCH	OF KENT C
CITY OF ROCKFORD		TY	PICAL SECT	IONS	
	SCALE: NTS	SHEET NO. 1 OF	SHEETS	STA.	TO STA.

ENTRAL	AVENUE	OVER	THE SOU	TH BR	ANCH (	)F K	ENT	CREEK	F.A.U. RTE.	SECTION	COUNTY	TOTAL SHEETS	SHEET NO.
		Т	YPICAL SE	CTIONS	3				5102	09-00557-00-BR	Winnebago	18	4
			II IOAL OL	0110140	<b>,</b>						CONTRACT	NO. 8	35508
NTS	SHEET NO	. 1 0	F SHEET	S STA.		TO	STA.		FED. RO	AD DIST. NO. 2   ILLINOIS FED. A	D PROJECT		

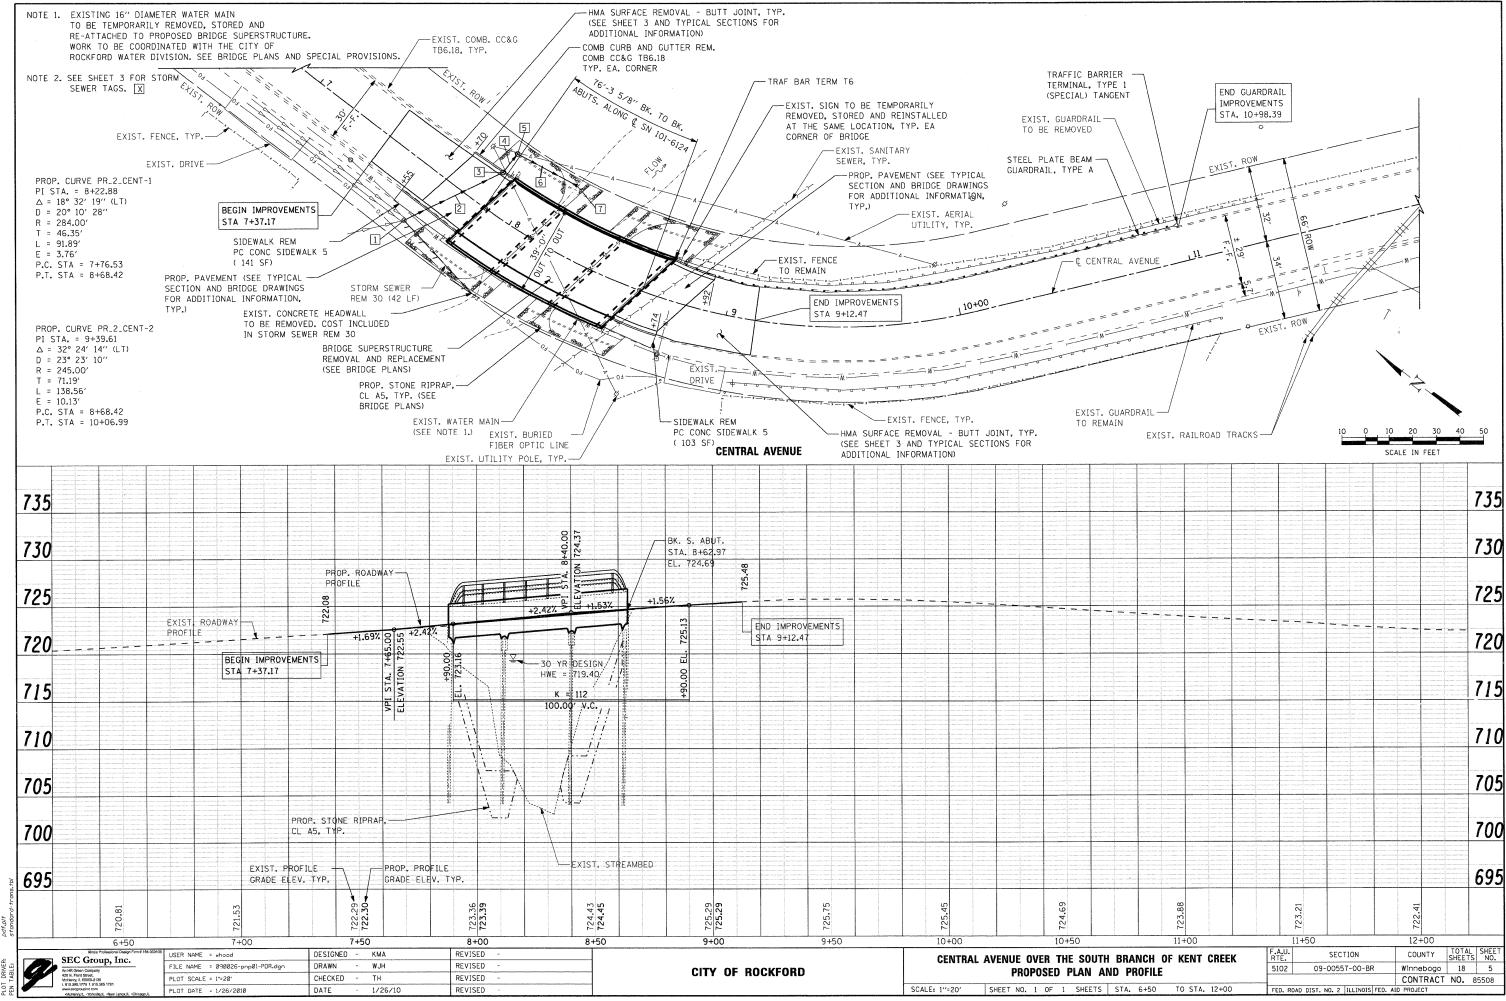

ME. SEC GROUP, INC.

NIACT: Robert G. Davies

City of Rockford

ED: 1/26/2010 is0is9 PM


090026-prp01-PDR.dgn

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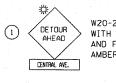
COMPANY NAME. SEC 63 PROJECT CONTACT: RODOR CLENT:
CLENT: C.Try 0 DATE PLOTTED: 1/26/2 FILE NAME: 09002 PLOT DRIVER: pdf.pd. PFN TABLE: strong PFN TABLE:

### **ROAD CLOSURE GENERAL NOTES:**

- THE CONTRACTOR WILL BE ALLOWED TO CLOSE CENTRAL AVENUE TO THRU TRAFFIC BETWEEN STATE STREET AND CUNNINGHAM ROAD IN ACCORDANCE WITH THE
- 2. THE DETOUR ROUTE SHALL BE POSTED PRIOR TO CLOSING THE ROAD.
- ALL TRAFFIC CONTROL WORK ASSOCIATED WITH THE ROAD CLOSURE, SIGNING, TEMPORARY FENCING AND BARRICADING SHALL BE INCLUDED IN THE PAY ITEM FOR 'TRAFFIC CONTROL AND PROTECTION".
- 4. THE CONTRATOR SHALL GIVE THE ENGINEER, THE CITY, IDOT, AND THE WINNEBAGO COUNTY HIGHWAY DEPARTMENT A 72 HOUR NOTICE PRIOR TO PLACING THE ADVANCE
- 5. ADVANCE NOTICE SIGNS, (12), SHALL BE PLACED TWO WEEKS PRIOR TO CLOSING
- 6. ALL SIGNS SHALL CONFORM TO SPACING REQUIREMENTS SET FORTH IN THE 'MANUAL ON UNIFORM TRAFFIC CONTROL DEVICES FOR STREETS AND HIGHWAYS'.
- 7. THE CONTRACTOR SHALL MAINTAIN ACCESS TO ADJACENT DRIVEWAYS IN ACCORDANCE WITH THE SPECIAL PROVISIONS.

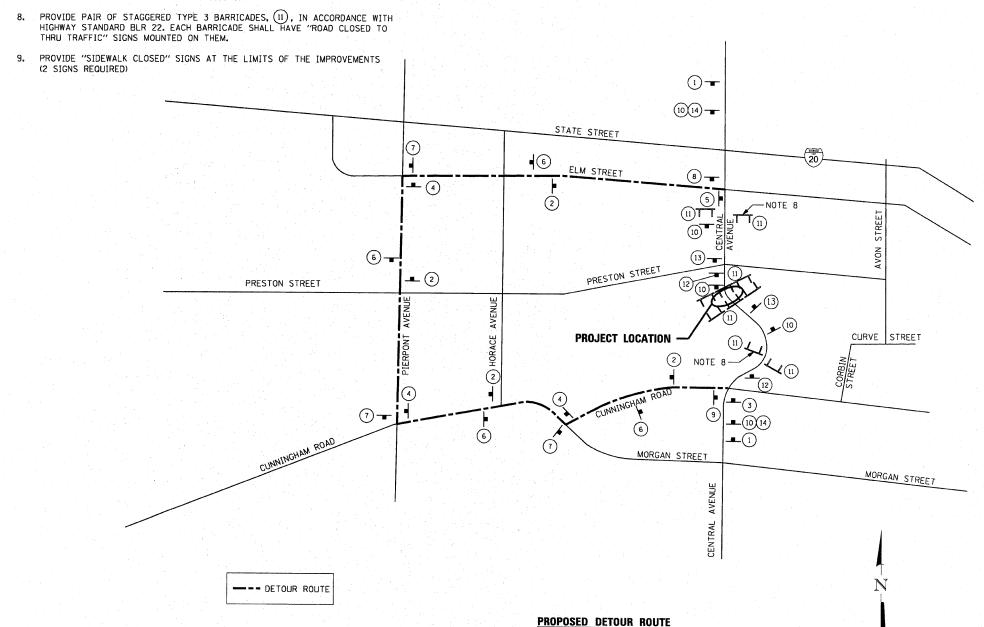

### SIGN LEGEND



W20-2 (48"×48") WITH STREET SIGN AND FLASHING AMBER LIGHT



M4-9L (30"×24") WITH STREET SIGN AND DIRECTION OF TRAFFIC



M4-9 (30"x21") WITH STREET SIGN AND DIRECTION OF TRAFFIC



M4-9R (30"x24") WITH STREET SIGN AND DIRECTION OF



M4-9L (30"x24") TRAFFIC



WITH STREET SIGN AND DIRECTION OF



M4-9R (30"x24") WITH STREET SIGN AND DIRECTION OF TRAFFIC




M4-8a (24"x18") WITH STREET SIGN AND INFORMATION



M4-9 (30"x24") WITH STREET SIGN AND DIRECTION OF TRAFFIC



M4-8a (24"x18") WITH STREET SIGN AND INFORMATION SIGN

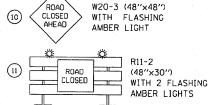



INFO CLOSED (48"×30")



W20-3 (48"×48") WITH FLASHING AMBER LIGHT



... MILES DISTANCE SIGN

Design Firm # 184-000108	USER NAME = whood	DESIGNED -	KMA	REVISED -	•
	FILE NAME = 090026-Dtr.dgn	DRAWN -	WJH	REVISED -	
	PLOT SCALE = 1'=20'	CHECKED -	TH	REVISED -	
ox,II. •Chlongo,II.	PLOT DATE = 2/3/2010	DATE -	2/3/10	REVISED -	
					٠

CITY OF ROCKFORD

(CENTRAL AVENUE - BRIDGE RE-CONTRUCTION)


CENTRAL			HE SOUTH		OF KENT CREEK
SCALE: 1"=20"	SHEET NO.	1 OF	SHEETS	STA.	TO STA.

F.A.U. RTE.	SECTION	COUNTY	TOTAL	SHEET
5102	09-00557-00-BR	Winnebago	18	6
		CONTRACT	NO. 8	5508
 FED. RC	AD DIST. NO. 2   ILLINOIS FED. A	D PROJECT		14.

### EROSION CONTROL NOTES


- 1. THE CONTRACTOR WILL BE REQUIRED TO IMPLEMENT AND MAINTAIN EROSION CONTROL MEASURES IMMEDIATELY AFTER STRIPPING OF EXISTING VEGETATION.
- 2. TEMPORARY DITCH CHECKS ARE MEASURED PER FOOT, REGARDLESS OF TYPE
- 3. STOCKPILES OF SOIL AND OTHER BUILDING MATERIALS TO REMAIN IN PLACE MORE THAN THREE (3) DAYS SHALL BE FURNISHED WITH EROSION AND SEDIMENT CONTROL MEASURES (I.E. PERIMETER SILT FENCE), STOCKPILES TO REMAIN IN PLACE FOR 30 DAYS OR MORE SHALL RECEIVE TEMPORARY SEEDING.
- 4. THE CONTRACTOR SHALL TAKE ALL PRECAUTIONS TO PREVENT POLLUTION OF STORM WATER AND SHALL FOLLOW IEPA REGULATIONS & IDOT CONSTRUCTION


- 5. STABILIZATION MEASURES SHALL BE INITIATED WITHIN 7 DAYS OF CONSTRUCTION ACTIVITY TEMPORARILY OR PERMANENTLY CEASING IN AREAS WHERE IT WILL NOT OCCUR FOR A PERIOD OF 14 OR MORE CALENDAR DAYS.
- 6. THE SOIL EROSION AND SEDIMENT CONTROL PRACTICES WILL BE INSPECTED WEEKLY AND AFTER 1/2 INCH OF RAIN OR MORE BY THE INDIVIDUAL ON SITE IN CHARGE OF SOIL EROSION AND SEDIMENT CONTROL DURING THE CONSTRUCTION OF THE PROJECT.
- 7. SILT FENCE SHALL BE INSTALLED FOLLOWING THE COMPLETION AND STABILIZATION OF THE STORMWATER FACILITIES AND WILL REMAIN IN PLACE UNTIL THE CONTRIBUTING AREA IS STABILIZED.
- 8. ALL ADJACENT STREETS MUST BE KEPT CLEAR OF DEBRIS. INSPECTED DAILY AND CLEANED WHEN NECESSARY OR AS DIRECTED BY THE ENGINEER.
- 9. ALL SOIL EROSION AND SEDIMENT CONTROL PRACTICES ARE REFERENCED FROM THE ILLINOIS URBAN MANUAL.

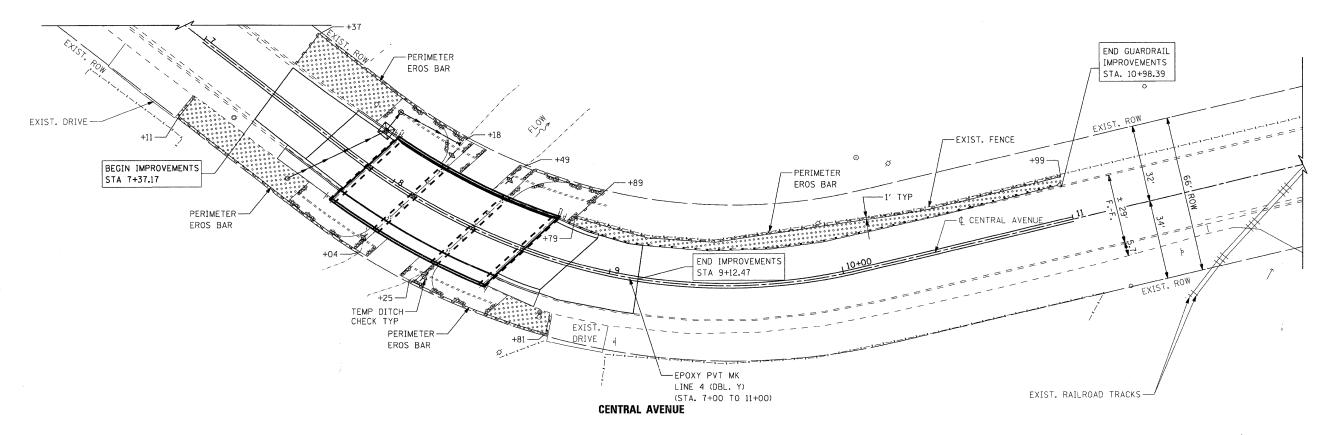

### TEMPORARY EROSION CONTROL SEQUENCE OF CONSTRUCTION

- ESTABLISH TEMPORARY EROSION CONTROL MEASURES AND ERECT PERIMETER EROSION BARRIER ALONG SITE BOUNDARIES PRIOR TO EARTHWORK.
- INSTALL DITCH CHECKS IMMEDIATELY AFTER DITCH GRADING IS COMPLETED.
- 3. INSTALL TEMPORARY EROSION CONTROL SEEDING.

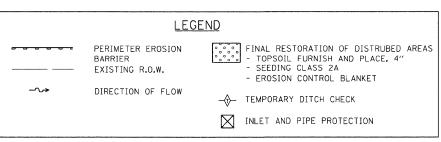

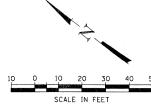


SEC Group, Inc.

00108	USER NAME = whood	DESIGNED - KMA	REVISED
	FILE NAME = 090026-Ero.dgn	DRAWN -	REVISED -
	PLOT SCALE =	CHECKED - TH	REVISED -
	PLOT DATE = 1/26/2010	DATE - 1/26/10	REVISED -

CENTRAL AVENUE OVER THE SOUTH BRANCH OF KENT CREEK STRIPING, EROSION CONTROL, AND RESTORATION PLAN SHEET NO. 1 OF SHEETS STA.

TO STA.

F.A.U. RTE.	SECTION	COUNTY	TOTAL SHEETS	SHEET NO.
5102	09-00557-00-BR	Winnebago	18	7
		CONTRACT	NO. 8	35508

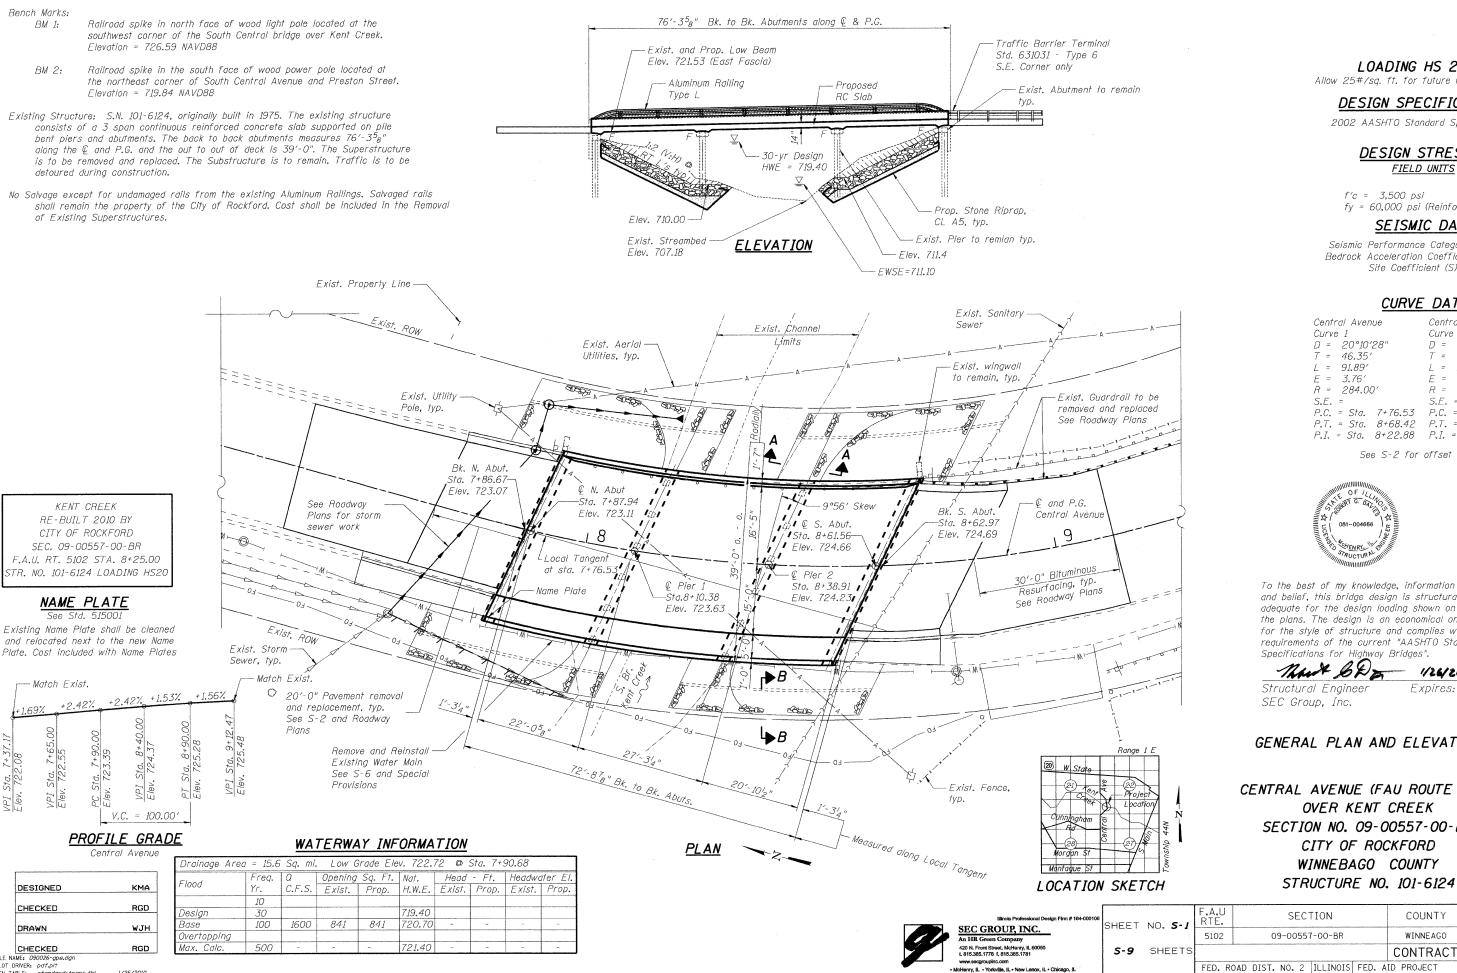

LOADING HS 20-44

Allow 25#/sq. ft. for future wearing surface.

### DESIGN SPECIFICATIONS

2002 AASHTO Standard Specifications

### **DESIGN STRESSES** FIELD UNITS

f'c = 3.500 psi fy = 60,000 psi (Reinforcement)

### SEISMIC DATA

Seismic Performance Category (SPC) = A Bedrock Acceleration Coefficient (A) = 4%g Site Coefficient (S) = 1.0

### CURVE DATA

Central Avenue	Central Avenue
Curve 1	Curve 2
D = 20°10′28"	D = 23°23′10"
T = 46.35'	T = 71.19'
L = 91.89'	L = 138.56'
E = 3.76'	E = 10.13'
R = 284.00'	R = 245.00'
S.E. =	S.E. =
P.C. = Sta. 7+76.53	P.C. = Sta. 8+68.42
P.T. = Sta. 8+68.42	P.T. = Sta. 10+06.99
P.I. = Sta. 8+22.88	P.I. = Sta. 9+39.61

See S-2 for offset sketch

and belief, this bridge design is structurally adequate for the design loading shown on the plans. The design is an economical one for the style of structure and complies with requirements of the current "AASHTO Standard

1/26/2010

Expires: 11/30/2010

GENERAL PLAN AND ELEVATION

CENTRAL AVENUE (FAU ROUTE 5102) OVER KENT CREEK SECTION NO. 09-00557-00-BR CITY OF ROCKFORD WINNEBAGO COUNTY STRUCTURE NO. 101-6124

DATE: 1/26/10



# GENERAL NOTES:

Reinforcement bars shall conform to the requirements of ASTM A 706 Gr 60. See Special Provisions.

Reinforcement bars designated (E) shall be epoxy coated.

Plan dimensions and details relative to existing plans are subject to nominal construction variations. The Contractor shall field verify existing dimensions and details affecting new construction and make necessary approved adjustments prior to construction or ordering of materials. Such variations shall not be cause for additional compensation for a change in scope of the work, however, the Contractor will be paid for the quantity actually furnished at the unit price bid for the work.

Layout of Slope Protection System may be varied to suit ground conditions in field as directed by the Engineer.


The Contractor shall make allowance for the deflection of forms, shrinkage and settlement of falsework, in addition to allowance for dead load deflection. Forms for deck slab shall be removed prior to placement of bridge approach

Excavation behind existing abutment walls shall be performed to balance front and back soil pressure before removing the existing superstructure.

Backfill shall be placed behind the abutment after the superstructure has been poured and falsework removed. See Article 502.10 of the Standard Specifications.

The Contractor shall obtain a construction permit from the Illinois Department of Natural Resources (IDNR), Office of Water Resources for any temporary construction activity not included in Statewide Permit #9. Any permit application by the Contractor shall refer to the IDNR Statewide permit included in the contract

Incidental excavation / shaping required to place Stone Riprap shall be in accordance with the applicable portion of Section 202 of the Standard Specifications. The cost for this work shall be included in Stone Riprap, Class A5.

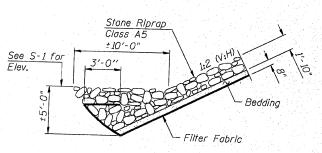

# SECTION A-A

KMA

RGD

WJH

RGD .

DESIGNED


CHECKED

DRAWN

CHECKED

LOT DRIVER: pdf.plf

Modify as shown in the Elevation on S-1 (See General Notes).

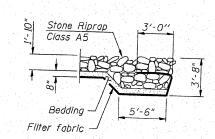


# STATE OF ILLINOIS DEPARTMENT OF TRANSPORTATION

# TOTAL BILL OF MATERIAL


ITEM				
Porous Granular Embankment, Special	UNIT	SUPER	SUB	TOTAL
Stone Riprap, Class A5	Cu. Yd.		32.6	32.6
Filter Fabric	Sq. Yd.		523	523.0
Removal of Existing Superstructures	Sq. Yd.		523	523.0
Structure Excavation	Each	1		1
Concrete Superstructure	Cu. Yd.		32.6	32.6
Bridge Deck Grooving	Cu. Yd.	160.4	·	160.4
Protective Coat	Sq. Yd.	246		246
Reinforcement Bars, Epoxy Coated	Sq. Yd.	363		363
Aluminum Railing, Type L	Pound	42,350		42,350
Name Plates	Foot	7.2		72
Remove and Reinstall Existing Water Main	Each	1		. 1
English Externing World Main	Foot	74		74

# INDEX OF SHEETS

- General Plan and Elevation
- General Notes and Total Bill of Materials Top of Slab Elevations
- Superstructure Plan and Cross Section S-5 Superstructure Details
- 5-6 Superstructure Details
- Superstructure Details
- 5-8 Aluminum Railing, Type L
- Substructure Details

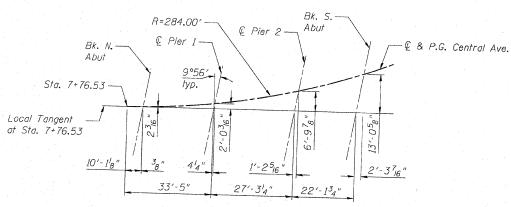

OFFSET SKETCH

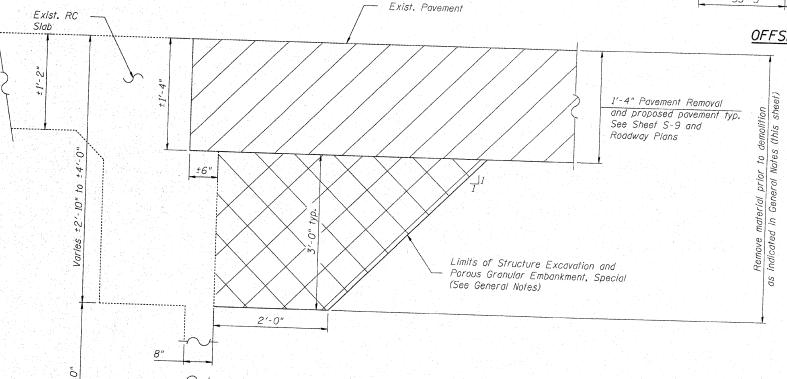

SECTION THRU ABUTMENT


GENERAL NOTES, AND TOTAL BILL OF MATERIALS

CENTRAL AVENUE (FAU ROUTE 5102) OVER KENT CREEK SECTION NO. 09-00557-00-BR CITY OF ROCKFORD WINNEBAGO COUNTY STRUCTURE NO. 101-6124

SEC GROUP, INC. McHenry, IL . Yorkville, IL . New Lenox, IL . Chicago,

DATE: 2/3/10 TOTAL SHEET SHEETS NO. SECTION COUNTY SHEET NO. 5-2 5102 09-00557-00-BR WINNEAGO 18 S-9 SHEETS CONTRACT NO. 85508 FED. ROAD DIST. NO. 2 ILLINOIS FED. AID PROJECT BHM 5099 (081)

SECTION B-B

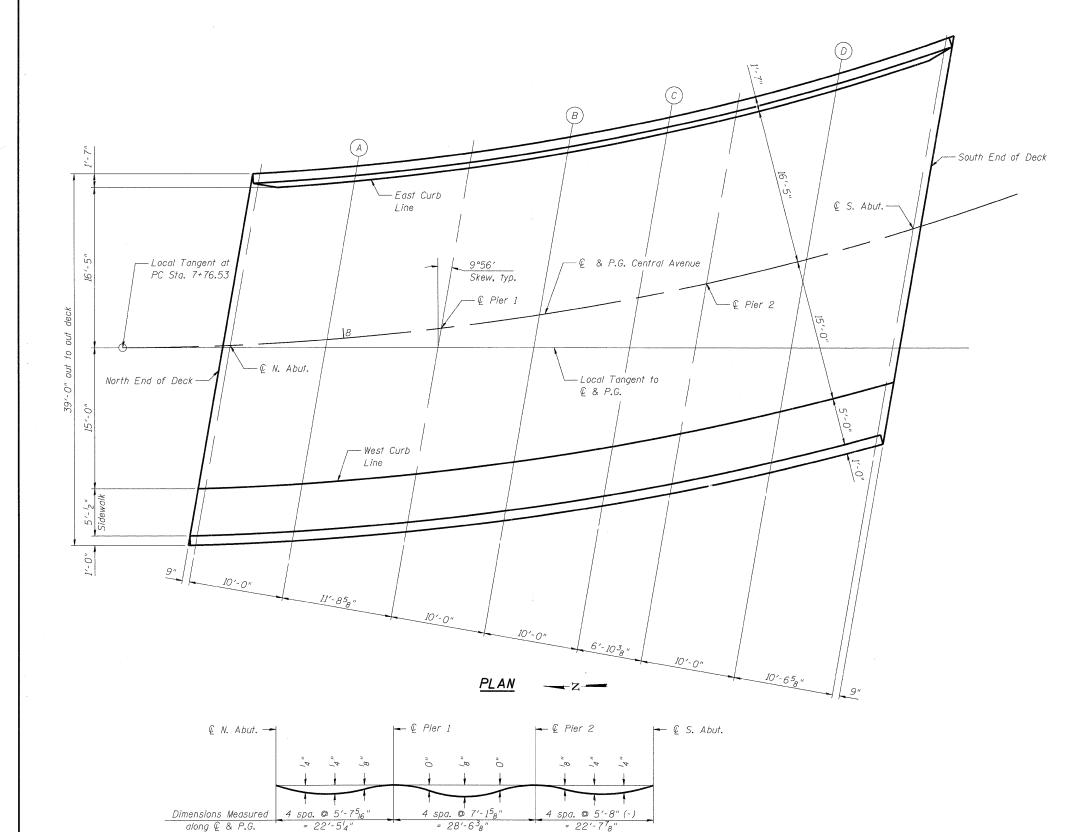

# DEAD LOAD DEFLECTION DIAGRAM

(Includes weight of concrete only.)

DESIGNED CHECKED WJH

DRAWN RGD CHECKED T DRIVER: pdf.plf
TABLE: standard-

The above deflections are not to be used in the field if the engineer is working from the grade elevations adjusted for dead load deflections as shown.

# EAST CURB LINE

Loca	ation	Station	Offset to ℚ & P.G.	Theoretical Grade Elevations	Theoretical Grade Elevations Adjusted For Dead Load Deflection
	d of Deck L Abut. A Pier 1 B C C Pier 2 D L Abut. d of Deck	7+90.90 7+91.72 8+02.66 8+15.64 8+26.86 8+38.25 8+46.17 8+57.90 8+70.57 8+71.48	- 16.417 - 16.417 - 16.417 - 16.417 - 16.417 - 16.417 - 16.417 - 16.417 - 16.417	722.68 722.70 722.92 723.14 723.33 723.52 723.65 723.86 724.07 724.09	722.68 722.70 722.94 723.14 723.34 723.53 723.65 723.88 724.07 724.09

# CENTERLINE AND PROFILE GRADE LINE

N. End of Deck     7+87.17     0.000     723.09     723.09       © N. Abut.     7+87.94     0.000     723.11     723.11       A     7+98.21     0.000     723.35     723.37       © Pier 1     8+10.38     0.000     723.63     723.63       B     8+20.88     0.000     723.86     723.87       C     8+31.52     0.000     724.09     724.10       © Pier 2     8+38.91     0.000     724.23     724.23       D     8+49.83     0.000     724.45     724.47	Location	Station	Offset to (£ & P.G.	Theoretical Grade Elevations	Theoretical Grade Elevations Adjusted For Dead Load Deflection
© S. Abut.   8+61.56   0.000   724.66   724.66	© N. Abut. A © Pier I B C © Pier 2 D	7+87.94 7+98.21 8+10.38 8+20.88 8+31.52 8+38.91 8+49.83	0.000 0.000 0.000 0.000 0.000 0.000 0.000	723.11 723.35 723.63 723.86 724.09 724.23 724.45	723.11 723.37 723.63 723.87 724.10 724.23 724.47

# WEST CURB LINE


Location	Station	Offset to ℚ & P.G.	Theoretical Grade Elevations	Theoretical Grade Elevations Adjusted For Dead Load Deflection
N. End of Deck	7+84.13 7+84.85 7+94.59 8+06.10 8+16.03 8+26.07 8+33.03 8+43.30 8+54.32 8+55.11	15.000 15.000 15.000 15.000 15.000 15.000 15.000 15.000 15.000	723.47 723.49 723.66 724.03 724.23 724.47 724.63 724.86 725.09 725.12	723.47 723.49 723.68 724.03 724.24 724.48 724.63 724.88 725.09 725.12


TOP OF SLAB ELEVATIONS

CENTRAL AVENUE (FAU ROUTE 5102) OVER KENT CREEK SECTION NO. 09-00557-00-BR CITY OF ROCKFORD WINNEBAGO COUNTY STRUCTURE NO. 101-6124



												DATE: 1/2	26/10
١	SHEET	NO. <b>S-3</b>	F.A.U RTE.	SECTION							COUNTY	TOTAL SHEETS	SHEE NO.
			5102	09-00557-00-BR							WINNEAGO	18	10
	s-9	SHEETS									CONTRACT	NO. 8	5508
			FED. R	DAC	DIST.	NO.	2	ILLINOIS	FED.	AID	PROJECT	BHM 5099	(081)

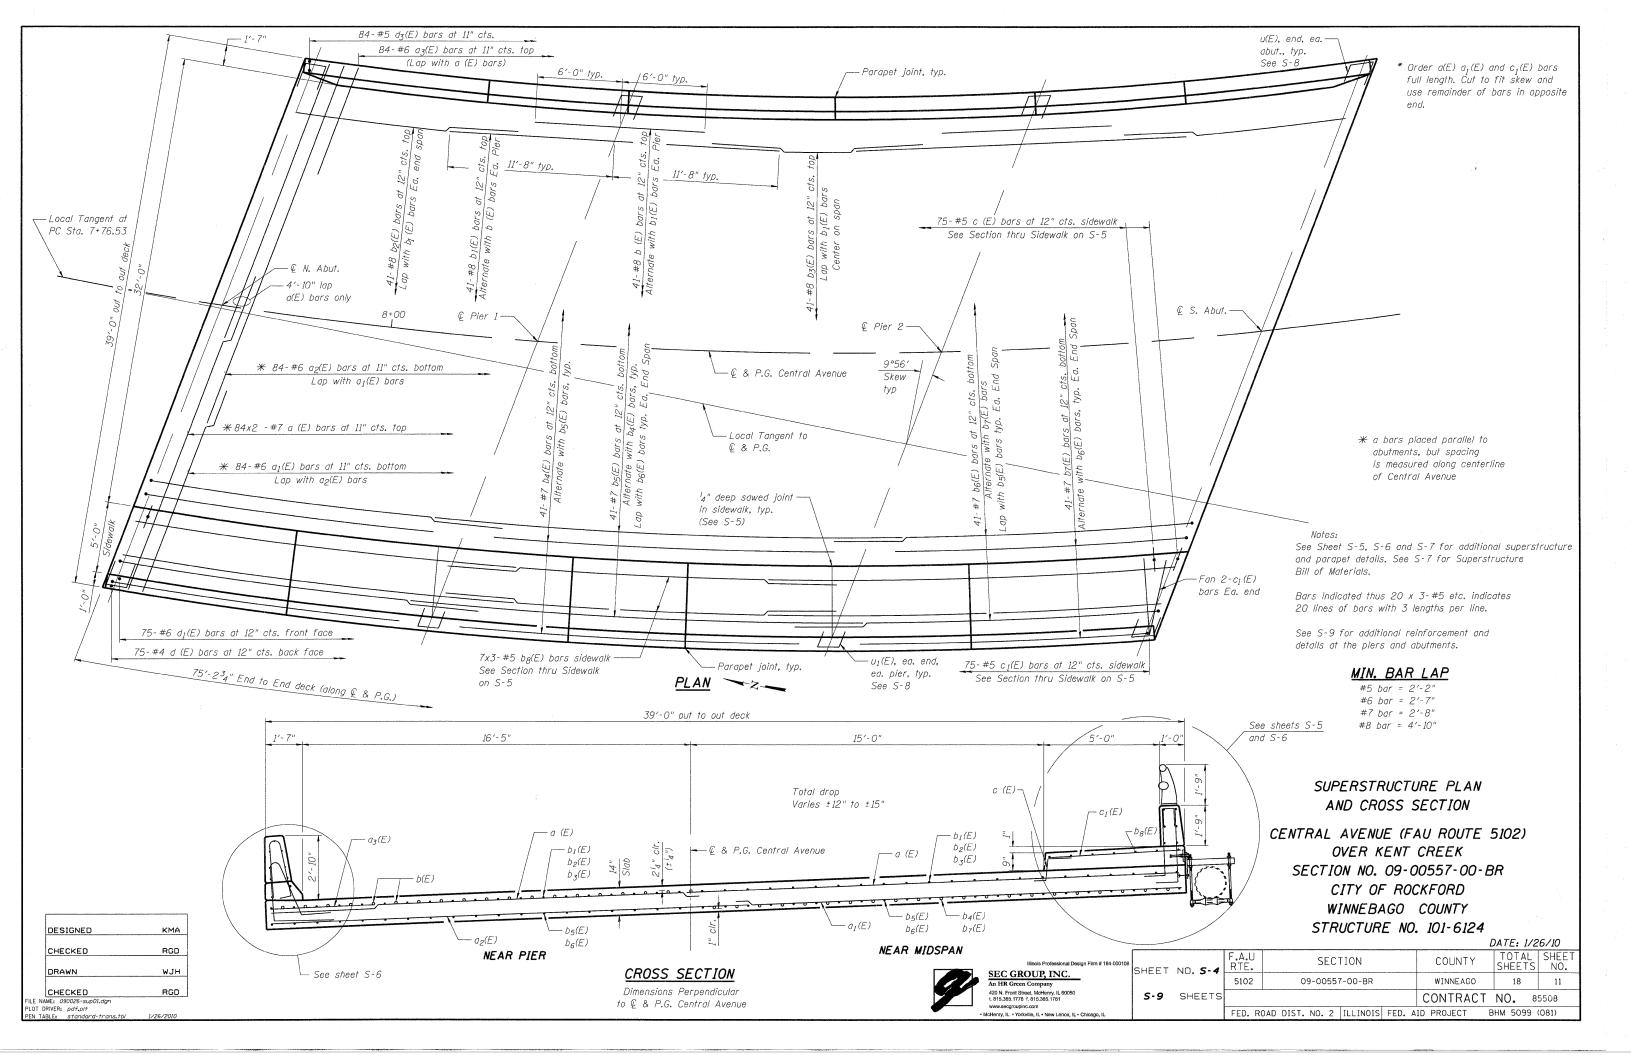

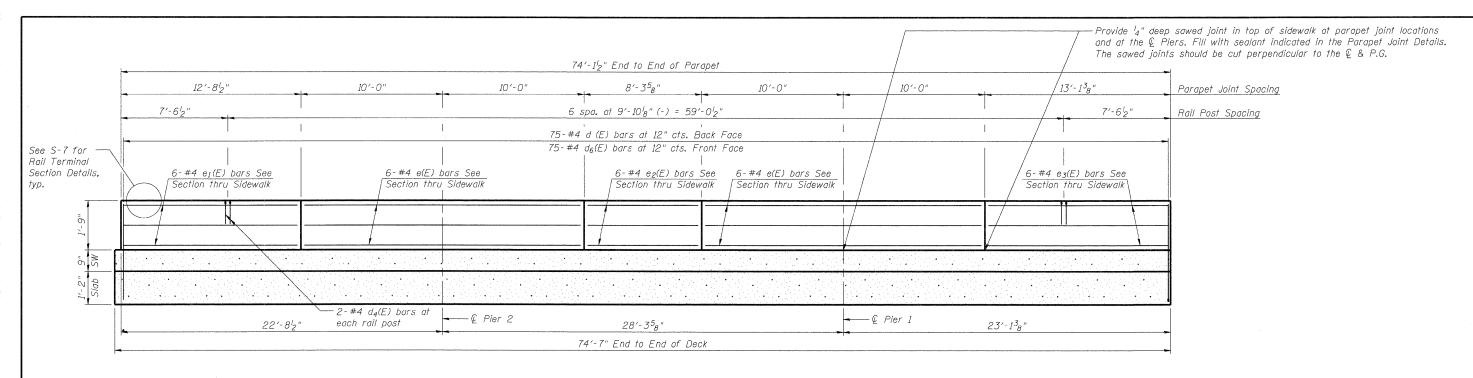



# MINIMUM BAR LAP

(Parapet) #4 bar = 1'-8''

# INSIDE ELEVATION OF WEST PARAPET

All dimensions measured along front face of parapet

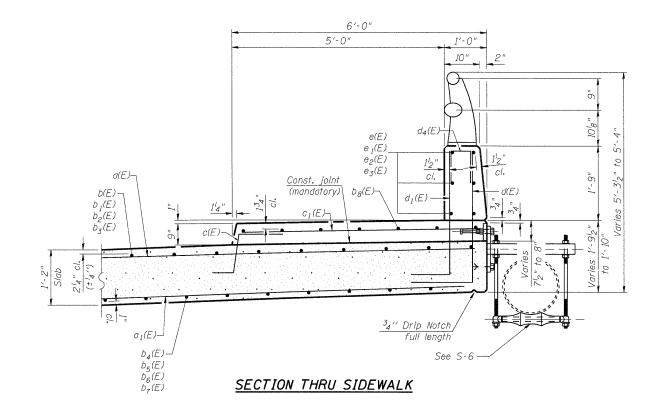

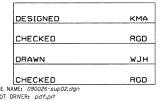

Illinois Professional Design Firm # 184-000108

SEC GROUP, INC.


An FIR Green Company

420 N. Front Street, Michemy, IL 80080

1. 815.385.1778 f. 816.385.1781

www.secgroupinc.com

• Melheny, IL • Yorkville, IL • New Lenox, IL • Chicago, IL

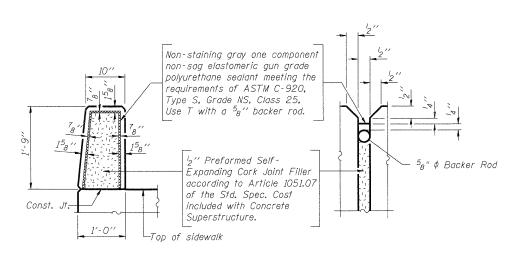

# PARAPET JOINT DETAILS

SHEET NO. 5-5

S-9 SHEETS

SUPERSTRUCTURE DETAILS

CENTRAL AVENUE (FAU ROUTE 5102)

OVER KENT CREEK

SECTION NO. 09-00557-00-BR


CITY OF ROCKFORD

WINNEBAGO COUNTY

STRUCTURE NO. 101-6124

		DATE: 1/26/10						
F.A.U RTE.	SECTION	COUNTY	TOTAL SHEETS	SHEET NO.				
5102	09-00557-00-BR	WINNEAGO	18	12				
		CONTRACT	NO. 8	5508				

FED. ROAD DIST. NO. 2 | ILLINOIS | FED. AID PROJECT | BHM 5099 (081)

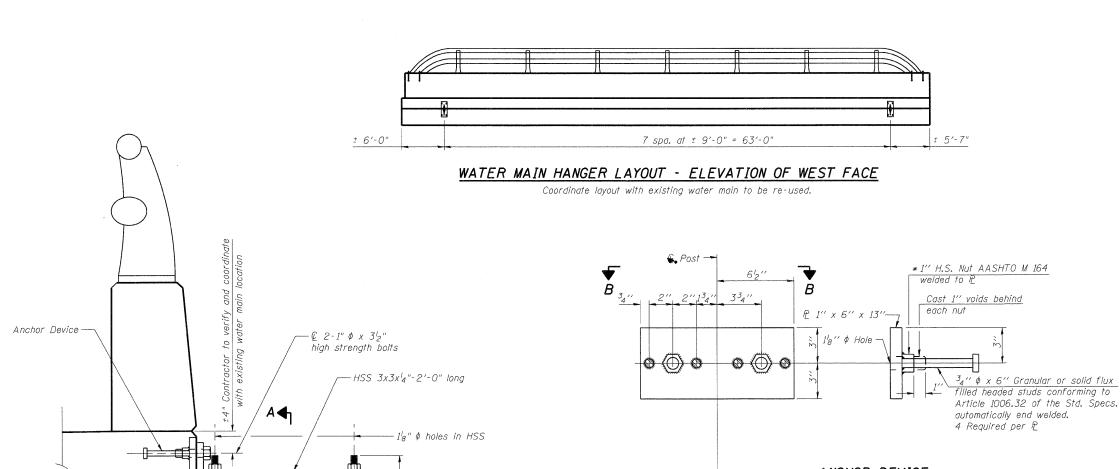

-2-1" Ø X 2'-2" long hot dipped galvanized anchor rods. Coordinate

threading with pipe hanger manufacturer.

14"

-8" Threaded

 $A \blacktriangleleft J$ 

1934"

WATER MAIN HANGER DETAIL

(8 Assemblies reg'd)

Existing 16" Ø DIP


Water Main -8" Threaded

-Cooper B-Line

approved equal

B3114-16 Hanger, or

ANCHOR DEVICE \* Threaded areas shall be plugged or blocked off during casting of beam.

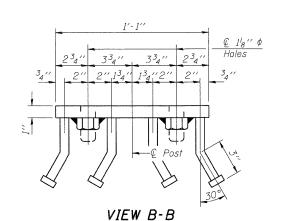

### **NOTES**

- 1. Hollow structural steel tubing shall conform to the requirements of ASTM designation A500 Grade B Structural Steel Tubing and shall meet the longitudinal CVN requirements of 15 ft.-lbs. at
- 2. All other steel shapes and plates shall conform to the requirements of AASHTO M 270 Grade 36.
- 3. Bolts and nuts shall conform to the requirements of ASTM designation A307 except for high strength bolts, nuts and washer's noted which shall conform to AASHTO M 164.
- 4. All bolts, nuts, washers and lock washers shall be galvanized according to AASHTO M 232.
- 5. All anchor devices plates and HSS shall be galvanized after shop fabrication according to AASHTO M-111 and ASTM A 385.
- 6. The 1" \$\phi\$ high strength bolts connecting the plate to the concrete shall be tightend to a snug fit and given an additional 18 turn.

SUPERSTRUCTURE DETAILS

CENTRAL AVENUE (FAU ROUTE 5102) OVER KENT CREEK SECTION NO. 09-00557-00-BR CITY OF ROCKFORD WINNEBAGO COUNTY STRUCTURE NO. 101-6124

VIEW A-A

 $^3\!_4$ "  $\phi$  holes

10" 

334"

Heavy hex nut

³⊿" ø hole

# 1"x10"x1'-1"

in plate

14'

w/standard

washer, typ.

Water Main not shown for clarity



			3111001011 <u>m</u> 1101			
					DATE: 1/2	6/10
	NO. <b>S-6</b>	F.A.U RTE.	SECTION	COUNTY	TOTAL SHEETS	SHEE NO.
	110. 5 0	5102	09-00557-00-BR	WINNEAGO	18	13
5-9	SHEETS			CONTRACT	NO. 8	5508
		FED. R	DAD DIST. NO. 2   ILLINOIS   FED. A	ID PROJECT E	ЗНМ 5099 (	081)


DESIGNED KMA CHECKED RGD DRAWN WJH CHECKED


ILE NAME: 090026-sup03.dgr


LOT DRIVER: pdf.pit RGD

2-5/8" φ x 6" long Hilti Kwik Bolt 3.

or approved equal, hot dipped galvanized

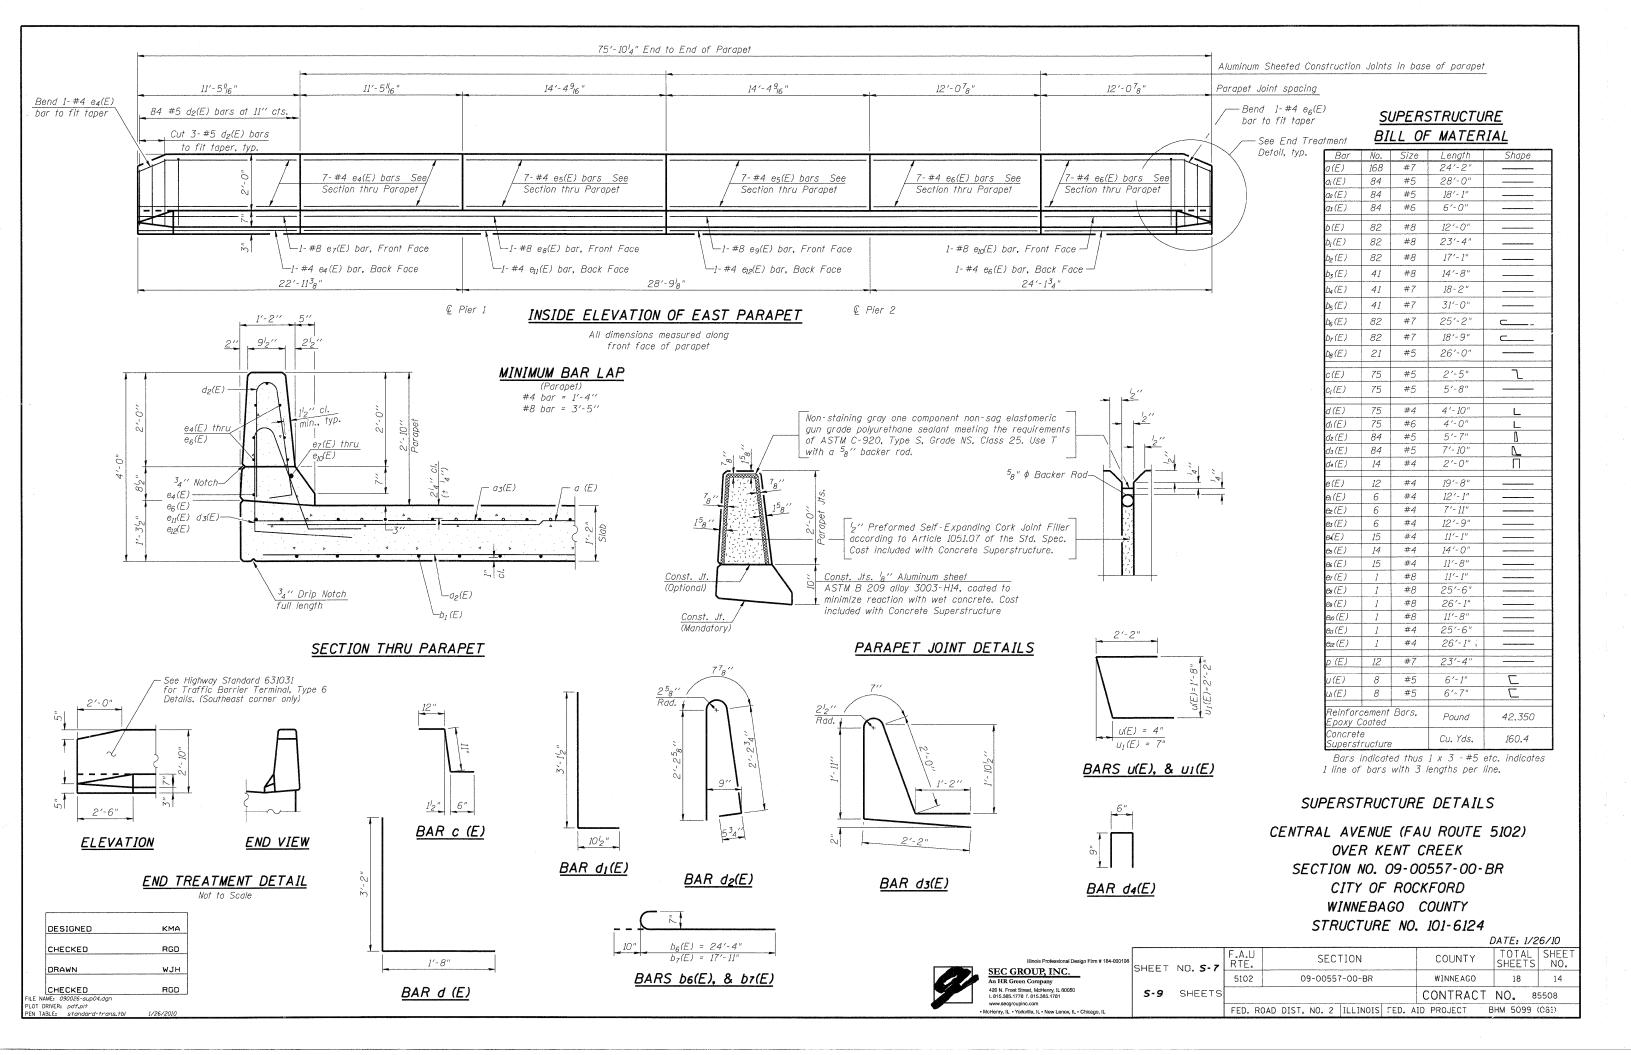


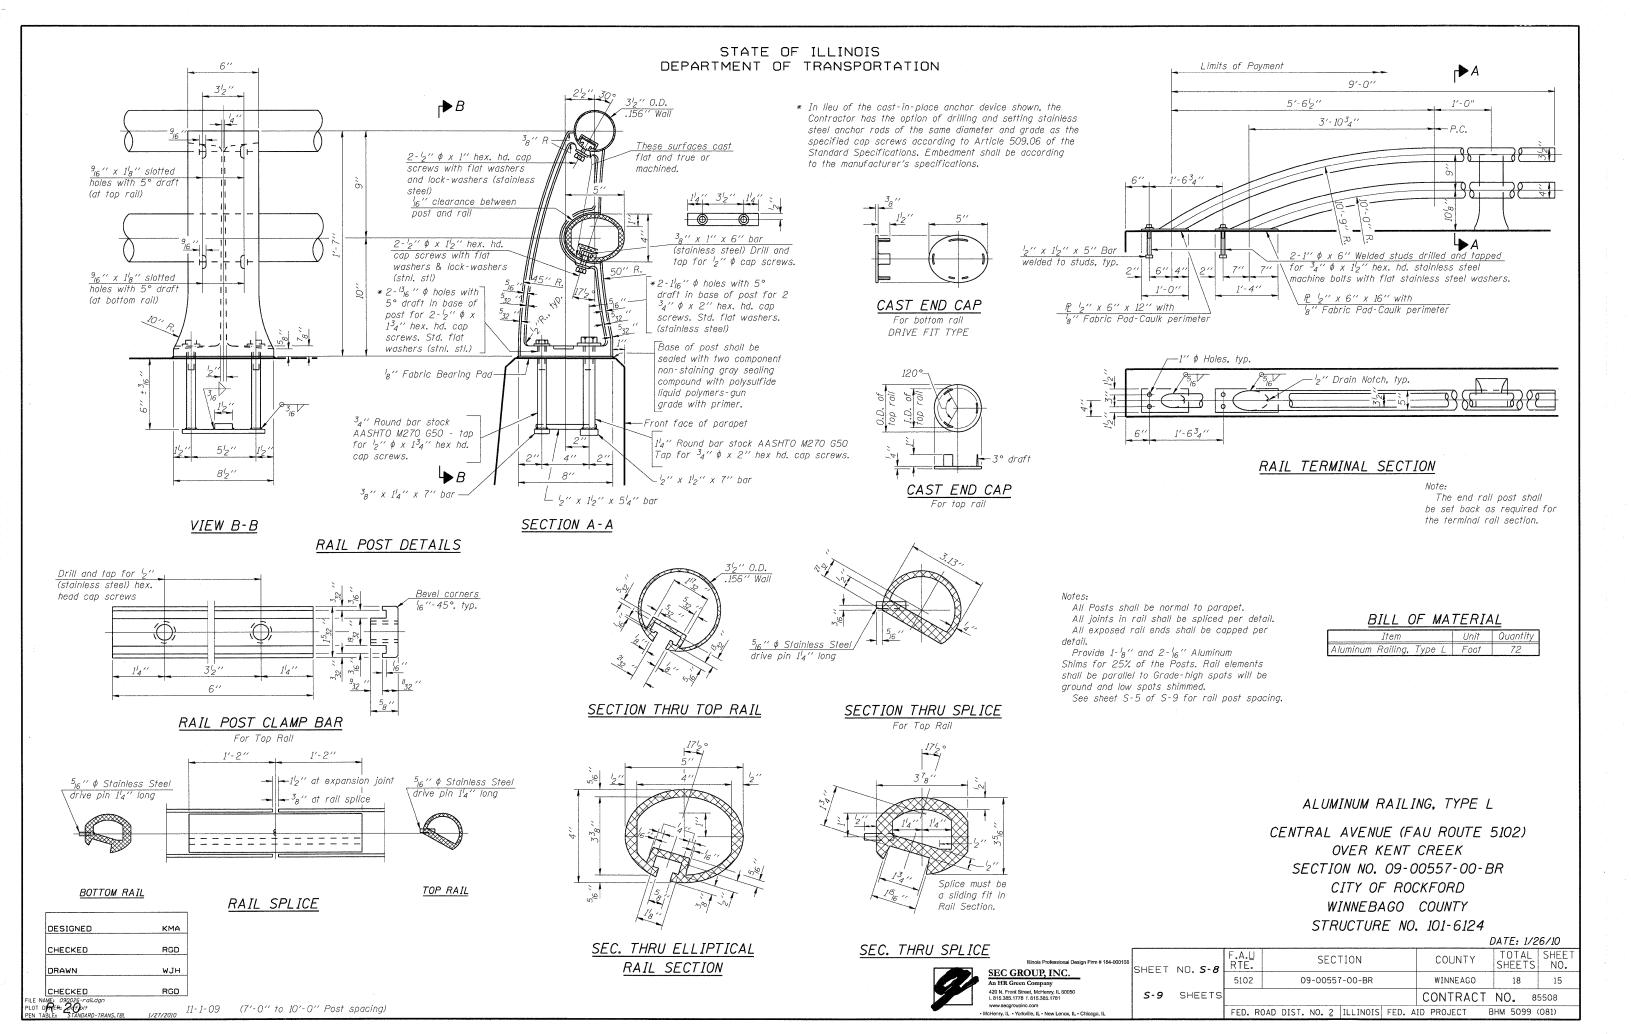

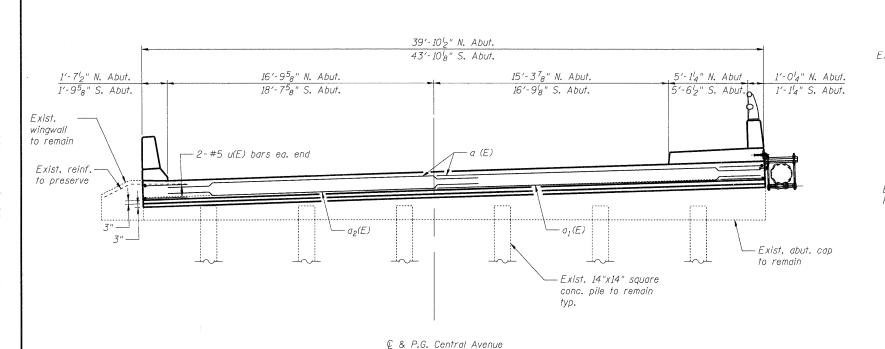

### ABUTMENT ELEVATION

South Abutment looking South (North Abutment similar, but opposite hand) Dimensions along skew

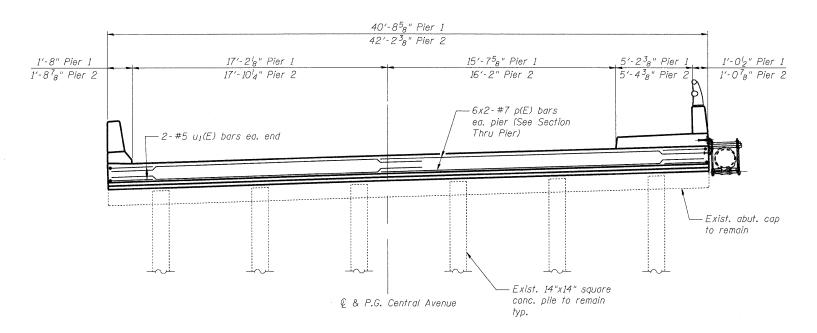


# PIER ELEVATION

Looking South Dimensions along skew




€ Abut.-Exist. reinf. to preserve Exist. Conc. Pile to Remain 1'-3" 2'-6"


> REMOVAL SECTION THRU ABUT.

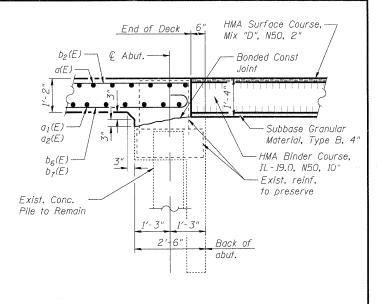

# SECTION THRU ABUT.

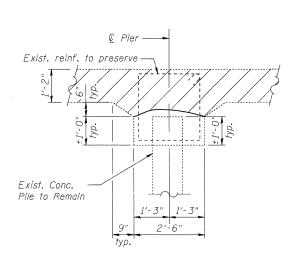

REMOVAL SECTION THRU PIER

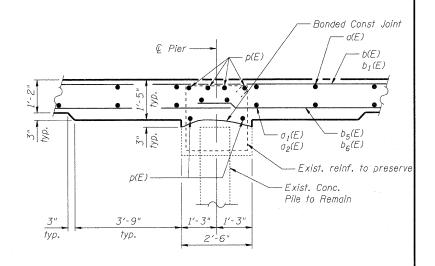

# SECTION THRU PIER

- See Superstructure Bill of Materials
- 2. Existing reinforcement shall be cleaned and incorporated into the new construction. Cost included in Removal of Existing

SUBSTRUCTURE DETAILS

CENTRAL AVENUE (FAU ROUTE 5102) OVER KENT CREEK SECTION NO. 09-00557-00-BR CITY OF ROCKFORD WINNEBAGO COUNTY STRUCTURE NO. 101-6124

SEC GROUP, INC. An HR Green Company 420 N. Front Street, McHenry, IL 60050 t. 815.385.1778 f. 815.385.1781

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											DATE: 1/2	26/10
SHEET	NO. <b>5-9</b>	F.A.L RTE.								COUNTY	TOTAL SHEETS	SHEE NO.
OHEE	110.00	5102		0	9-00	557	7-00-BR			WINNEAGO	18	16
5-9	SHEETS									CONTRACT	NO. 8	5508
		FED.	ROAD	DIST.	NO.	2	ILLINOIS	FED.	ΑII	PROJECT	BHM 5099	(081)

<u>NOTES</u>

for u(E),  $u_1(E)$ , and p(E) bars.

Superstructures.

