SEE SHEET 2 FOR INDEX OF SHEETS AND LIST OF ILLINOIS DOT HIGHWAY STANDARDS

04-23-2021 LETTING ITEM 104

UTILITY CONTACTS:

UTILITY TYPE: ELECTRIC MENARD ELECTRIC COOP ATT: BRADY SMITH PHONE: (217) 632–7746

UTILITY TYPE: ELECTRIC AMEREN CIPS (NORTH) ATT: MARTIN FULLER PHONE: (618) 301–5327

UTILITY TYPE: ELECTRIC PRAIRIE POWER, INC. ATT: WILL PLATT /ENG DEPT PHONE: (217) 245-6161

UTILITY TYPE: FIBER OPTIC METRO COMMUNICATIONS ATT: JASON KOONCE PHONE: (217) 728–3605

UTILITY TYPE: FIBER OPTIC MEDIACOM ATT: DAVID BRUST PHONE: (217) 243-4293

UTILITY TYPE: WIND SUGAR CREEK WIND ONE LLC ATT: CHRIS EDWARDS PHONE: (423) 754–2649

UTILITY TYPE: GAS PIPELINE PANHANDLE EASTERN PIPE LINE ATT: MATT DONALDSON EMAIL: MATTHEW.DONALDSON © ENERGYTRANSFER.COM

UTILITY TYPE: TELEPHONE ATT /T (TRANSMISSION) ATTN: KENNETH COLWELL PHONE: (630) 383–9249

PHUNE: (0.50) 303-9249100' 200' 300' - 1'' = 100' 50' - 100' - 1'' = 50' 50' - 100' - 1'' = 50' 50' - 100' - 1'' = 30' 50' - 100' - 1'' = 30'1'' = 100' - 1'' = 10'

FULL SIZE PLANS HAVE BEEN PREPARED USING STANDARD ENGINEERING SCALES. REDUCED SIZED PLANS WILL NOT CONFORM TO STANDARD SCALES. IN MAKING MEASUREMENTS ON REDUCED PLANS, THE ABOVE SCALES MAY BE USED.

J.U.L.I.E. Joint utility location information for excavation 1-800-892-0123 Or 811



UTILITY TYPE: TELEPHONE FRONTIER COMMUNICATIONS ATT: KALIN HINSHAW PHONE: (815) 895–1515

UTILITY TYPE: TELEPHONE ATT/OISTRIBUTION ATT: G11629 Q att.com

UTILITY TYPE: COMMUNICATIONS LEVEL3 (CENTURYLINK) ATT: NETWORK RELOCATIONS PHONE: (877) 366–8344

UTILITY TYPE: COMMUNICATIONS /INTERNET WINDSTREAM KDL /MCLEOD USA ATT: LOCATE DESK PHONE: (800) 289–1901

UTILITY TYPE: WATER/SEWER VILLAGE OF BROADWELL ATT: MARK SHORT PHONE: (217) 737-4780


UTILITY TYPE: WATER/SEWER VILLAGE OF ELKHART ATT: LYLE FOUT PHONE: (217) 801-4146

-N-

UTILITY TYPE: WATER /SEWER VILLAGE OF MIDDLETOWN ATT: MIKE VIRGIL PHONE: (217) 445-2537 104STATE OF ILLINOISDEPARTMENT OF TRANSPORTATION


PLANS FOR PROPOSED FEDERAL-AID PROJECT HSIP FUNDS

VARIOUS ROUTES SECTION 18-00125-00-SP PROJECT NO. S2WH(995) LOGAN COUNTY C-96-025-19

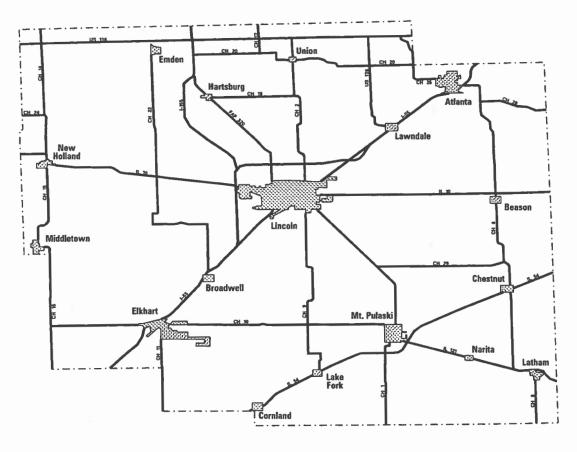

LAYOUT LOGAN COUNTY COUNTY WIDE (NOT TO SCALE) SG016 PROFESSIONAL PROFESSIONAL CLINOIS

)

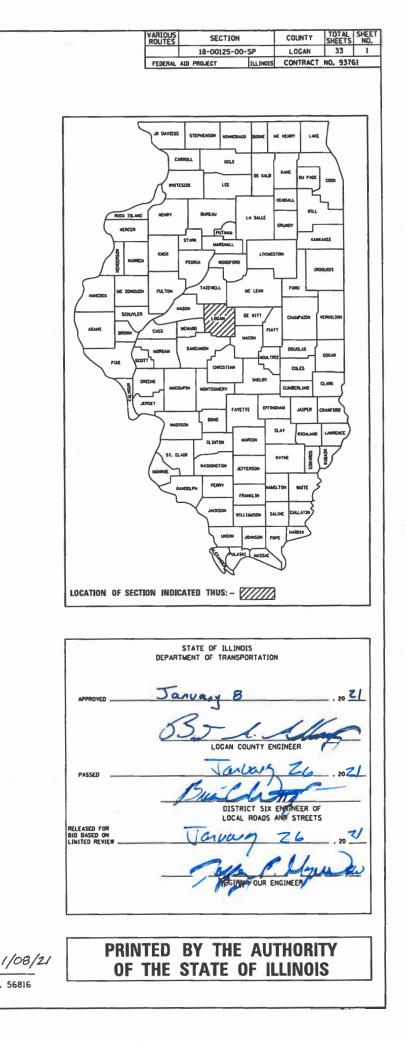

ILLINOIS PROFESSIONAL NO. 56816 (Expires 11/30/21)

GENERAL NOTES

INDEX OF SHEETS

SHEET NO.

- COVER SHEET
- 2 INDEX OF SHEETS, HIGHWAY STANDARDS, GENERAL NOTES, AND ENTRANCE DETAILS


<u>TITLE</u>

- 3-4 SUMMARY OF QUANTITIES
- 5 TYPICAL CROSS SECTIONS
- 6-9 SCHEDULES OF QUANTITIES
- LOCATION MAP 10
- 11-32 PLAN SHEETS
- 33 STEEL RAILING, TYPE 2399

- 1. THIS PROJECT IS LOCATED ON VARIOUS ROUTES IN LOGAN COUNTY. THE WORK INCLUDED IN THE SECTION CONSISTS OF VARIOUS TYPES OF GUARDRAIL REMOVAL. REPLACEMENT. AND ALL OTHER WORK NECESSARY TO COMPLETE THE PROJECT.
- 2. NO MATERIAL SHALL BE LEFT ON OR NEAR THE ROADWAY DURING NON-WORKING HOURS.
- 3. ANY NECESSARY TRAFFIC CONTROL WILL BE PROVIDED BY THE CONTRACTOR. APPROPRIATE STANDARDS ARE INCLUDED IN THE PLANS AND CONTRACT DOCUMENTS.
- 4. ILLINOIS STATE LAW REQUIRES 48 HOUR NOTICE TO BE GIVEN TO UTILITIES BEFORE DIGGING. FIELD MARKING OF FACILITIES MAY BE OBTAINED BY CONTACTING J.U.L.I.E. (PHONE 800-892-0123) OR FOR NON-MEMBERS THE UTILITY COMPANY DIRECTLY.
- 5. WHEN NO WORK IS BEING PERFORMED. THE FLAGGERS WILL NOT BE REQUIRED. IF THE FLAGGERS ARE NOT PRESENT, THE FLAGGER SIGNS SHALL BE REMOVED OR COVERED.
- 6. ARTICLE 701.20 OF THE STANDARD SPECIFICATIONS DISCUSSES AN ADJUSTED UNIT PRICE. NO ADJUSTMENTS SHALL BE MADE TO THE TRAFFIC CONTROL AND PROTECTION PAY ITEMS FOR THIS CONTRACT.
- 7. THE CONTRACTOR IS ADVISED THAT THE GUARDRAIL AND TERMINAL PAY ITEMS INCLUDED IN THE PLANS WILL BE USED TO REPLACE STEEL PLATE BEAM GUARDRAIL AND TRAFFIC BARRIER TERMINALS FOR EITHER CURRENT MIDWEST STYLES OR STEEL PLATE BEAM GUARDRAIL AND TRAFFIC BARRIER TERMINALS INSTALLED PRIOR TO JANUARY 1, 2007. NO ADDITIONAL COMPENSATION WILL BE ALLOWED FOR UTILIZING THE CURRENT MIDWEST STANDARDS.
- 8. ANY REFERENCE TO A STANDARD IN THESE PLANS SHALL BE INTERPRETED TO MEAN THE EDITION AS INDICATED BY THE REVISION NUMBER SHOWN IN THE LIST OF ILLINOIS DOT HIGHWAY STANDARDS OR THE COPY INCLUDED IN THESE PLANS.
- 9. EXISTING VEGETATION AND GROUND SURFACE SHALL BE THOROUGHLY DISTURBED BEFORE FILL IS PLACED. ALL FILL SHALL BE PLACED. SHAPED, AND COMPACTED BEFORE GUARDRAIL IS INSTALLED.

LIST OF ILLINOIS DOT HIGHWAY STANDARDS

000001-08	STANDARD SYMBOLS, ABBREVIATIONS AND PATTERNS
280001-07	TEMPORARY EROSION CONTROL SYSTEMS
542401-04	METAL FLARED END SECTION FOR PIPE CULVERTS
630001-12	STEEL PLATE BEAM GUARDRAIL
630101-10	STRONG POST GUARDRAIL ATTACHED TO CULVERT
630106-02	LONG-SPAN GUARDRAIL OVER CULVERT
630301-09	SHOULDER WIDENING FOR TYPE 1 (SPECIAL) GUARDRAIL TERMINALS
631011-10	TRAFFIC BARRIER TERMINAL, TYPE 2
631031-17	TRAFFIC BARRIER TERMINAL, TYPE 6
631032-09	TRAFFIC BARRIER TERMINAL, TYPE 6A
631046-04	TRAFFIC BARRIER TERMINAL, TYPE 10
701001-02	OFF-ROAD OPERATIONS, 2L, 2W, MORE THAN 15' AWAY FROM EDGE OF PAVEMENT
701006-05	OFF-ROAD OPERATIONS, 2L, 2W, 15' TO 24" AWAY
701201-05	LANE CLOSURE, 2L, 2W, DAY ONLY, FOR SPEEDS > 45 MPH
701901-08	TRAFFIC CONTROL DEVICES
725001-01	OBJECT AND TERMINAL MARKERS
782006-01	GUARDRAIL AND BARRIER WALL REFLECTOR MOUNTING DETAILS
BLR 21-9	TRAFFIC CONTROL AND PROTECTION, STANDARD BLR 21
BLR 26-3	STEEL PLATE BEAM GUARDRAIL 29" HEIGHT
BLR 27-1	TRAFFIC BARRIER TERMINAL TYPE 5A

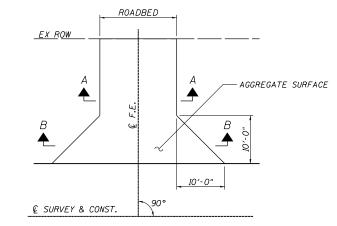

ENTRANCE DETAIL SEE ENTRANCE SCHEDULE FOR LOCATIONS AND WIDTHS

	JOB = 2578.1	DESIGNED -	CGF	REVISED -			INDEX OF SHEETS, HIGHWAY STANDARDS,		ROUTE VARIOUS	SECTION	COUNTY	TOTAL SHEET		
Engineering	FILE NAME = 2578.1-sht-gen.dgn	DRAWN -	SJS	REVISED -	LOGAN COUNTY	GENERAL NOTES, AND ENTRANCE DETAILS		VANIOUS	18-00125-00-SP	LOGAN	33 2			
Corporation	PLOT SCALE = 100.0000 '/in.	CHECKED -	THF	REVISED -	GUARDRAIL IMPROVEMENTS		GENERAL	NUTES,	AND ENTRAN	LE DETAILS			CONTRACT	NO. 93761
Civil and Structural Engineering	PLOT DATE = 1/8/2021	DATE -	8/05/2020	REVISED -	SCALE: SHEET OF SHEETS STA. TO STA.		SCALE: SHEET OF SHEETS STA. TO STA.			ILLINOIS FED.	AID PROJECT			
					•									

10. GUARDRAIL POSTS THAT NEED TO BE DRIVEN THROUGH EXISTING HOT-MIX ASPHALT SHOULDERS WILL NOT BE PAID FOR SEPARATELY. BUT SHALL BE INCLUDED IN THE COST OF STEEL PLATE BEAM GUARDRAIL

II. REMOVED GUARDRAIL THAT IS NOT REPLACED ON THE SAME DAY MUST BE DELINEATED WITH LIGHTED BARRICADES. NO LOCATIONS SHALL BE LEFT WITHOUT EITHER LIGHTED BARRICADES OR RESTORED GUARDRAIL AT ANY TIME.

12. ALL STEEL PLATE BEAM GUARDRAIL RAIL ELEMENTS, POSTS AND HARDWARE THAT ARE NOT REINCORPORATED INTO THE PROJECT SHALL BECOME THE PROPERTY OF THE CONTRACTOR. THIS WORK WILL INCLUDE THE REMOVAL. HAULING, AND DISPOSAL OF ALL MATERIAL AND SHALL BE INCLUDED IN THE COST OF THE REMOVAL ITEMS.


13. FURNISHED EXCAVATION, AS SHOWN, IS FOR CONSTRUCTION THE PROPOSED SHOULDER WIDENING FOR TYPE I (SPECIAL) GUARDRAIL TERMINALS AND FOR SHOULDER WIDENING ALONG STEEL PLATE BEAM GUARDRAIL AS NEEDED. SHOULDER WIDENING AT TYPE I (SPECIAL) TERMINALS SHALL BE AS SHOWN ON STANDARD 630301. SHOULDER WIDENING AT STEEL PLATE BEAM GUARDRAIL TYPE A, SIX FOOT POSTS WILL BE TWO FEET BEHIND THE POST AS SHOWN ON STANDARD 630001. SHOULDER WIDENING AT STEEL PLATE BEAM GUARDRAIL TYPE A, NINE FOOT POSTS WILL BE TO THE FACE OF THE POST AS SHOWN ON STANDARD 630001. QUANTITIES SHOWN ARE APPROXIMATE.

14. CONTRACTOR SHALL MAKE SURE ALL DRUMS AND BARRICADES ARE IN PLACE WHERE GUARDRAIL POSTS ARE REMOVED IN ACCORDANCE WITH ARTICLE 701 OF THE STANDARD SPECIFICATIONS.

15. TEMPORARY SEEDING OPERATION SHALL BE COMPLETED WITHIN 3 DAYS OF COMPLETING GUARDRAIL WORK.

APPLICATION RATES USED IN QUANTITY CALCULATIONS TEMPORARY EROSION CONTROL SEEDING _ _ _ _ 100 LBS/ACRE

COMMITMENTS NONE AT THIS TIME

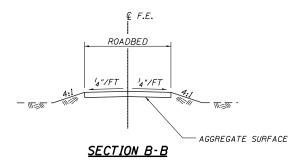

	<u>SUMMARY OF QUANTITIES</u>			CONSTRUCTION CON HSIP FUNDS 90% FEDERAL 10% LOCAL ROADWAY
CODE NO	ITEM	UNIT	TOTAL QUANTITY	0021 RURAL
20400800	FURNISHED EXCAVATION	CU YD	2,625	2,625
21400100	GRADING AND SHAPING DITCHES	FOOT	361	361
			0.70	0.20
25100630	EROSION CONTROL BLANKET	5Q YD	939	939
28000250	TEMPORARY EROSION CONTROL SEEDING	POUND	191	. 191
28000305	TEMPORARY DITCH CHECKS	FOOT	40	40
28000400	PERIMETER EROSION BARRIER	FOOT	4,617	4,617
28000500	INLET AND PIPE PROTECTION	EACH	4	4
40200800	AGGREGATE SURFACE COURSE, TYPE B	TON	92	92
50105220	PIPE CULVERT REMOVAL	FOOT	156	156
50900200	STEEL RAILING, TYPE 2399	FOOT	334	334
54261724	STEEL FLARED END SECTIONS 24"	EACH	1	1
542D0220	PIPE CULVERTS, CLASS D, TYPE 1 15"	FOOT	30	30
542D0223	PIPE CULVERTS, CLASS D, TYPE 1 18"	FOOT	96	96
542D0229	PIPE CULVERTS, CLASS D, TYPE 1 24"	FOOT	154	154
63000001	STEEL PLATE BEAM GUARDRAIL, TYPE A, 6 FOOT POSTS	FOOT	937.5	937.5
		FOOT	1,425.0	1,425.0
63000003	STEEL PLATE BEAM GUARDRAIL, TYPE A, 9 FOOT POSTS		1,423.0	1,423.0

CODE NO ITEM 63000007 STEEL PLATE BEAM GUARDRAIL, TYPE B, 6 FOOT POSTS 63000009 STEEL PLATE BEAM GUARDRAIL, TYPE B, 9 FOOT POSTS 63000030 STRONG POST GUARDRAIL ATTACHED TO CULVERT 63000350 LONG-SPAN GUARDRAIL OVER CULVERT, 12 FT 6 IN SPAN 63000360 LONG-SPAN GUARDRAIL OVER CULVERT, 18 FT 9 IN SPAN 63100045 TRAFFIC BARRIER TERMINAL, TYPE 2 63100075 TRAFFIC BARRIER TERMINAL, TYPE 5A 63100085 TRAFFIC BARRIER TERMINAL, TYPE 6 63100087 TRAFFIC BARRIER TERMINAL, TYPE 6A 63100105 TRAFFIC BARRIER TERMINAL, TYPE 10 63100167 TRAFFIC BARRIER TERMINAL, TYPE 1 (SPECIAL) TANGEN • 63200310 GUARDRAIL REMOVAL 67100100 MOBILIZATION 70100450 TRAFFIC CONTROL AND PROTECTION, STANDARD 701201 72501000 TERMINAL MARKER - DIRECT APPLIED 78200005 GUARDRAIL REFLECTORS, TYPE A

SUMMARY OF QUANTITIES

SEE SPECIAL PROVISIONS

D SPECIALTY ITEMS

SEE SPECIAL PROVISIONS

△ SPECIALTY ITEMS



	Cummins	JOB = 2578.1	DESIGNED -	CGF	REVISED -		SUMMARY OF QUANTITIES				ROUTE VARIOUS	SECTION	COUNTY TOTAL SHEET SHEETS NO.		
	Engineering	FILE NAME = 2578.1-sht-gen.dgn	DRAWN -	CGF	REVISED ~	LOGAN COUNTY			SUMMAR		ANTITIES			18-00125-00-SP	LOGAN 33 5
	Corporation	PLOT SCALE = 100.0000 '/ In.	CHECKED -	THF	REVISED -	GUARDRAIL IMPROVEMENTS					·····		-		CONTRACT NO. 93761
ctural Eng	ineering	PLOT DATE = 1/8/2021	DATE -	9/03/2020	REVISED -		SCALE:	SHEET	OF	SHEETS	STA.	TO STA.		ILLINOIS FED. A	ID PROJECT

			CONSTRUCTION CODE HSIP FUNDS
			90% FEDERAL 10% LOCAL
			ROADWAY
	UNIT	TOTAL	0021
		QUANTITY	RURAL
	FOOT	37.5	37.5
	FOOT	200.0	200.0
	FOOT	150.0	150.0
· · · · · · · · · · · · · · · · · · ·	FOOT	75.0	75.0
	5007	07 E	87.5
	FOOT	87.5	07.5
	EACH	5	5
	EACH	22	22
	EACH	23	23
	EACH	8	8
	EACH	1	1
T	EACH	87	87
	FOOT	5,312.5	5,312.5
	L SUM	1	1
	L SUM	1	1
	EACH	87	87
	EACH	338	338

	SUMMARY OF QUANTITIES			CONSTRUCTION COD HSIP FUNDS
				90% FEDERAL
				10% LOCAL
				ROADWAY
			TOTAL	0021
CODE NO	ITEM	UNIT	QUANTITY	RURAL
X2501000	SEEDING, CLASS 2 (SPECIAL)	ACRE	2.00	2.00
X6300210	GUARDRAIL BLOCKS	EACH	508	508
X6320100	GUARDRAIL REMOVAL SPECIAL	FOOT	325.0	325.0
X6311205	TRAFFIC BARRIER TERMINAL, TYPE 5A (SPECIAL)	EACH	2	2
x7011800	TRAFFIC CONTROL AND PROTECTION, STANDARD BLR 21	L SUM	1	1
20076600	TRAINEES	HOUR	500	
20076604	TRAINEES TRAINING PROGRAM GRADUATE	HOUR	500	
		·		


	SUMMARY OF QUANTITIES			CONSTRUCTION CODE HSIP FUNDS 90% FEDERAL 10% LOCAL ROADWAY
ODE NO	ITEM	UNIT	TOTAL QUANTITY	0021 RURAL
	•			-
				· · · · · · · · · · · · · · · · · · ·
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 SEE SPECIAL PROVISIONS ∆ SPECIALTY ITEMS #=0042

DESIGNED - CGF DRAWN - CGF REVISED -REVISED -CECC Cummins Engineering Corporation JOB = 2578.1 FILE NAME = 2576.1-eht-gen.dgn PLOT SCALE = 100.0000'/ in. JOB = 2578.1 LOGAN COUNTY GUARDRAIL IMPROVEMENTS SUMMARY OF QUANT
 CHECKED
 THF

 DATE
 9/03/2020
REVISED -SHEET OF SHEETS STA Civil and Structural Engineering PLOT DATE = 1/8/2021 REVISED -SCALE:

		ROUTE	SECTION	COUNTY	TOTAL SHEETS	SHEET NO.
TITIES			18-00125-00-SP	LOGAN	33	4
				CONTRAC	T NO. S	3761
ΓΑ.	TO STA.		ILLINDIS FED. A	ID PROJECT		

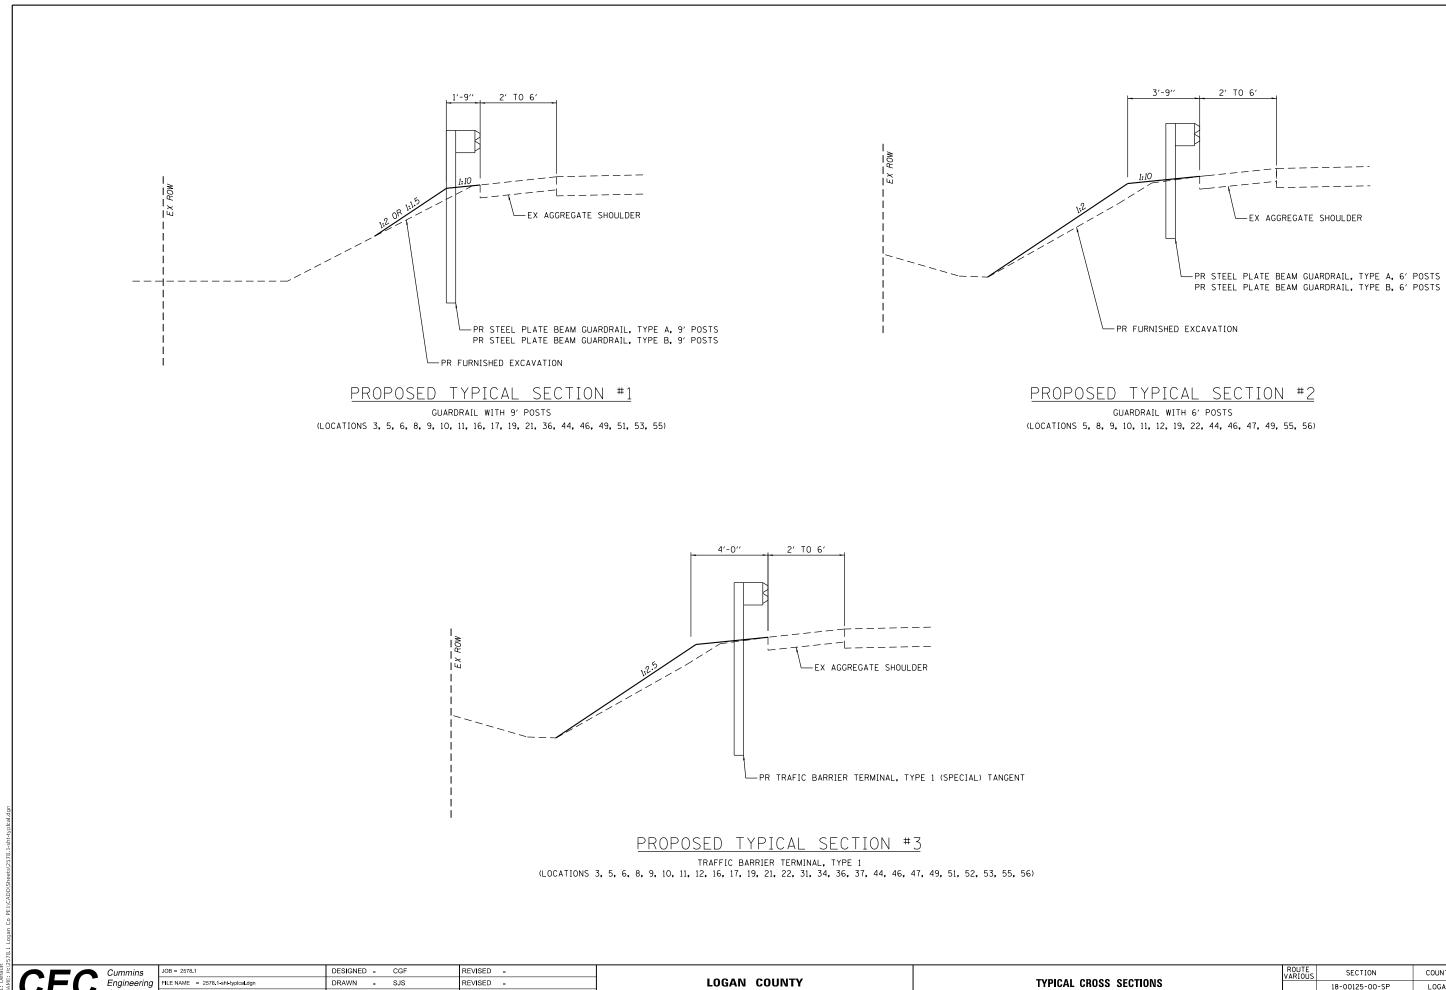

PLOT SCALE = 5.0000 '/In. CHECKED - THF EVISED -**GUARDRAIL IMPROVEMENTS** Civil and Structural Engineering PLOT DATE = 1/8/2021 DATE - 9/03/2020 SCALE: REVISED -

SHEET OF SHEETS

SECTIONS		ROUTE VARIOUS	SECTION	COUNTY	TOTAL SHEETS	SHEET NO.				
		18-00125-00-			LOGAN	33	5			
					CONTRACT	「 NO. 9	3761			
TS	STA.	TO STA.		ILLINOIS FED. AID PROJECT						

Location Number	Quadrant (NE, SE, NW, SW, LEFT, RIGHT)	FURNISHED EXCAVATION
		CU YD
3	LEFT, RIGHT	120
5	SW, SE	20
6	LEFT, RIGHT	100
8	SW	5
9	SW, NW, NE	365
10	LEFT, RIGHT	95
11	LEFT, RIGHT	20
16	NW, SW, NE, SE	225
17	NW, NE, SE, SW	185
19	NE, NW, SE, SW	80
21	NW, SW, NE, SE	95
34	LEFT	80
36	LEFT	335
37	RIGHT	30
44	NW, SW, NE, SE	315
46	SE, SW, NE, NW	60
47	SW, NE, SE	60
49	NW, SW, NE, SE	40
51	NW, SW, NE, SE	75
52	NW, SW, NE, SE	75
53	NW, SW, NE, SE	230
55	SW, SE	15
TOTAL		2,625

Location Number	Quadrant (NE, SE, NW, SW, LEFT, RIGHT)	PIPE CULVERTS, CLASS D, TYPE 1 15"	PIPE CULVERTS, CLASS D, TYPE 1 18"	PIPE CULVERTS, CLASS D, TYPE 1 24"	STEEL FLARED END SECTIONS 24"	PIPE CULVERT REMOVAL
		FOOT	FOOT	FOOT	EACH	FOOT
10	LEFT	30		44	1	40
53	SW		96			60
	SE			110		56
TOTAL		30	96	154	1	156

Location Number	LOCATION	TYPE	WIDTH	AGGREGATE SURFACE COURSE, TYPE B
			FOOT	TON
			FOOT	TON
3	LEFT	FE	40	41
10	LEFT	FE	20	18
56	RIGHT	FE	30	32
TOTAL				92



DESIGNED -	CGF	REVISED -		l			
DRAWN -	CGF	REVISED -	LOGAN COUNTY			SCHEDULE	S OF
CHECKED -	THF	REVISED -	GUARDRAIL IMPROVEMENTS				
DATE -	9/03/2020	20 REVISED -		SCALE:	SHEET	OF	SHE

Location Number	Qua SE, LEF
3	
5	
6	
8 9	
10	
11	
16	
17	
19	
21	
34 36	
37	
44	
46	
47	
49	
SCHEDULES (OF QU

Quadrant (NE, SE, NW, SW, LEFT, RIGHT)	SEEDING, CLASS 2 (SPECIAL)
	ACRE
LEFT	0.055
RIGHT	0.059
SW	0.023
SE	0.023
LEFT	0.051
RIGHT	0.060
SW	0.003
SW	0.078
NW	0.018
NE	0.075
LEFT	0.048
RIGHT	0.048
LEFT	0.025
RIGHT	0.023
NW	0.020
SW	0.003
NE	0.036
SE	0.043
	0.043
NW NE	
	0.036
SE	0.052
SW	0.040
NE	0.019
NW	0.047
SE	0.001
SW	0.002
NW	0.026
SW	0.048
NE	0.021
SE	0.017
LEFT	0.041
LEFT	0.195
RIGHT	0.041
NW	0.058
SW	0.049
NE	0.032
SE	0.060
SW	0.007
SE	0.006
NW	0.032
NE	0.003
SW	0.005
NE	0.012
SE	0.012
NW	0.008
SW	0.016
NE	0.007
SE	0.023

Location Number	Quadrant (NE, SE, NW, SW, LEFT, RIGHT)	SEEDING, CLASS 2 (SPECIAL)
		ACRE
51	NW	0.016
	SW	0.029
	NE	0.028
	SE	0.026
52	NW	0.006
	SW	0.030
	NE	0.018
	SE	0.023
53	NW	0.015
	SW	0.025
	NE	0.016
	SE	0.034
55	SW	0.006
	SE	0.021
TOTAL		1.91
ROUNDED	TOTAL	2.00

	ROUTE VARIOUS	SECTION	COUNTY	TOTAL SHEETS	SHEET NO.
OF QUANTITIES		18-00125-00-SP	LOGAN	33	6
			CONTRACT	NO. 9	3761
SHEETS STA. TO STA.		ILLINOIS FED. AI	D PROJECT		

Location Number	Quadrant (NE, SE, NW, SW, LEFT, RIGHT)	PERIMETER EROSION BARRIER	TEMPORARY EROSION CONTROL SEEDING	TEMPORARY DITCH CHECKS	INLET AND PIPE PROTECION	GRADING AND SHAPING DITCHES	EROSION CONTROL BLANKET
		FOOT	POUND	FOOT	EACH	FOOT	SQ YD
3	LEFT	286	5.5				
	RIGHT	276	5.9				
5	SW		2.3				
	SE	137	1.3				
6	LEFT	198	5.1				
	RIGHT	150	6.0	8		67	
8	SW	25	0.3				
9	SW	138	7.8				
	NW	45	1.8				
	NE	156	7.5				
10	LEFT	33	4.8		1	52	
	RIGHT	142	3.0				
11	LEFT	234	2.5				
	RIGHT	184	2.0				
16	NW		3.3				
	SW		0.4				
	NE		3.6				-
	SE	26	4.3				-
17	NW	90	2.3				
	NE	139	3.6				
	SE	36	5.2	8		59	
	SW	133	4.0				
19	NE	116	1.9				
	NW	136	4.7				
	SE		0.1				
	SW	18	0.2				
21	NW		2.6				
	SW		4.8	8		83	
	NE		2.1				
	SE		1.7	8		37	
34	LEFT	163	4.1				1
36		163	19.5				
37	RIGHT	146	4.1				1
44	NW	404	5.8				1
	SW	134	4.9				
	NE	99	3.2				
40	SE	97	6.0 0.7		1	26	2
46	SW SE	60 20	0.7				
	NW	103	3.2				
	NE	103	0.3				
47	SW	36	0.3				
41	NE	30	1.2				
	SE		1.2				
49	NW	74	0.8				
43	SW	/4	1.6				
	NE		0.7				
	SE		2.3				

Location Number	Quadrant (NE, SE, NW, SW, LEFT, RIGHT)	PERIMETER EROSION BARRIER	TEMPORARY EROSION CONTROL SEEDING	TEMPORARY DITCH CHECKS	INLET AND PIPE PROTECION	GRADING AND SHAPING DITCHES	EROSION CONTROL BLANKET
		FOOT	POUND	FOOT	EACH	FOOT	SQ YD
51	NW	83	1.6				
	SW	102	2.9				
	NE	112	2.8				
	SE	91	2.6				115
52	NW	60	0.6				
	SW		3.0				
	NE	126	1.8				
	SE		2.3	8		37	
53	NW	99	1.5				
	SW		2.5		1		
	NE		1.6				
	SE		3.4		1		
55	SW	47	0.6				
	SE	87	2.1				
TOTAL		4,617	190.6	40	4	361	939
ROUNDED	TOTAL		191				

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JUEL: Default E NAME: H/V	CEC
ΣĒ	Civil and Structu

	Cummins	JOB = 2578.1	DESIGNED -	CGF	REVISED -							ROUTE	SECTION	COUNTY	TOTAL SHEET SHEETS NO.
H ()	Engineering	FILE NAME = 2578.1-sht-schedules.dgn	DRAWN -	CGF	REVISED -	LOGAN COUNTY		SCHEDULES OF QUANTITIES					18-00125-00-SP	LOGAN	33 7
		PLOT SCALE = 2.0000 '/In.	CHECKED -	THF	REVISED -	GUARDRAIL IMPROVEMENTS								CONTRACT	T NO. 93761
ivil and Structural	Engineering	PLOT DATE = 1/8/2021	DATE -	9/03/2020	REVISED -		SCALE:	SHEET	OF	SHEETS STA.	TO STA.		ILLINOIS FED. A	ID PROJECT	

Location Number	Quadrant (NE, SE, NW, SW, LEFT, RIGHT)	SPBGR TY A 6' Posts	SPBGR TY A 9' Posts	SPBGR TY B 6' Posts	SPBGR TY B 9' Posts	LONG-SPAN GUARDRAIL OVER CULVERT, 12 FT 6 IN SPAN	LONG-SPAN GUARDRAIL OVER CULVERT, 18 FT 9 IN SPAN	STRONG POST GUARDRAIL ATTACHED TO CULVERT	STEEL RAILING, TYPE 2399	TBT TY 1 (SPECIAL) TANGENT 50'	TBT TYPE 2	TBT TYPE 5A	TBT TYPE 5A (SPECIAL)	TBT TYPE 6	TBT TYPE 6A	TBT TYPE 10	GUARDRAIL REMOVAL	GUARDRAIL REMOVAL SPECIAL	GUARDRAIL REFLECTORS, TYPE A	TERMINAL MARKER - DIRECT APPLIED	GUARDRAIL BLOCKS
		FOOT	FOOT	FOOT	FOOT	FOOT	FOOT	FOOT	FOOT	EACH	EACH	EACH	EACH	EACH	EACH	EACH	FOOT	FOOT	EACH	EACH	EACH
3	LEFT		25.0					37.5	87.5	2					2			87.5	8	2	
	RIGHT		25.0					37.5	87.5	2					2			87.5	8	2	
5	NW	37.5								1							37.5		4	1	5
	SW									1							37.5			1	5
	NE									1							37.5			1	5
	SE		37.5							1							37.5		4	1	5
6	LEFT		25.0		50.0	37.5				2							225.0		4	2	ļ
	RIGHT		25.0		50.0	37.5				2							225.0		4	2	
8	NW	75.0								1		1					37.5		4	1	
	SW		37.5									1					37.5		4		
	NE	12.5								1		1					37.5		4	1	
	SE	75.0								1		1					37.5		4	1	
9	SW									1				1			75.0		4	1	ll
	SE	25.0												1			50.0		4		l
	NW		87.5											1			75.0 75.0		4		
10	NE		100.0		50.0		40.75			1				1					4	1	ll
10	LEFT		100.0	25.0	50.0		43.75			1							75.0 87.5		4	1	
- 11	RIGHT		12.5 37.5	25.0	25.0		43.75		70.5	-					2		87.5		4	2	ł – – – – – – – – – – – – – – – – – – –
11		37.5	37.5						79.5 79.5						2			75.0 75.0			
12	RIGHT NW	25.0							79.5	Z				1	2		112.5		0		<u> </u>
12	SE	25.0 25.0								1				1			112.5		4	1	<u> </u>
16	NW	20.0	12.5							1				1			62.5		4	1	
10	SW		37.5							1	1			1		1	37.5		4	1	
	NE		01.0							1	•			1			62.5		4	1	
	SE		12.5							1				1			62.5		4	1	
17	NW									1				1					4	1	
	NE									1				1					4	1	
	SE		50.0					37.5		1				1					4	1	
	SW		12.5					37.5		1				1					4	1	
19	NE		25.0							1		1					87.5		4	1	
	NW									1		1					100.0		4	1	
	SE	112.5								1		1					175.0		4	1	
	SW	12.5								1		1					87.5		4	1	
20	LEFT																100.0				ļ
21	NW		12.5							1							37.5		4	1	5
	SW		62.5							1							37.5		4	1	5
	NE		62.5							1							37.5		4	1	5
	SE		12.5							1							37.5		4	1	5
22	SW	37.5								1							125.0		4	1	<u> </u>]
	NE	37.5								1							125.0		4	1	
31	NW									1									13	1	154
	SW									1									4	1	50
	NE									1									13	1	154
24	SE LEFT									1							100.0		4	2	50
34	LEFT		237.5							2							325.0		A	2	
36 37	RIGHT		231.3							2							325.0		4	2	
	NOTI				I]		1	1	1	2		1	1	I		1	57.5			<u> </u>	

ODEL: Default LE NAME: H:\2578.1 L


	= 2578.1 NAME = 2578.1-shl-schedules.dgn T SCALE = 2.0000 '/In.	DESIGNED - DRAWN - CHECKED -	CGF CGF THF	REVISED - REVISED - REVISED -	LOGAN COUNTY GUARDRAIL IMPROVEMENTS		SC	HEDULES	GF QU	41
Civil and Structural Engineering PLOT D	T DATE = 1/11/2021	DATE -	9/03/2020	REVISED -		SCALE:	SHEET	OF	SHEETS	S

			ROUTE VARIOUS	SECTION		COUNTY	TOTAL SHEETS	SHEET NO.
U	IANTITIES			18-00125-00-	SP	LOGAN	33	8
_						CONTRACT	NO. 9	93761
S	STA.	TO STA.		ILLING	IS FED. A	ID PROJECT		

Location Number	Quadrant (NE, SE, NW, SW, LEFT, RIGHT)	SPBGR TY A 6' Posts	SPBGR TY A 9' Posts	SPBGR TY B 6' Posts	SPBGR TY B 9' Posts	LONG-SPAN GUARDRAIL OVER CULVERT, 12 FT 6 IN SPAN		STRONG POST GUARDRAIL ATTACHED TO CULVERT	STEEL RAILING, TYPE 2399	TBT TY 1 (SPECIAL) TANGENT 50'	TBT TYPE 2	TBT TYPE 5A	TBT TYPE 5A (SPECIAL)	TBT TYPE 6	TBT TYPE 6A	TBT TYPE 10	GUARDRAIL REMOVAL	GUARDRAIL REMOVAL SPECIAL	GUARDRAIL REFLECTORS, TYPE A	TERMINAL MARKER - DIRECT APPLIED	GUARDRAI BLOCKS
		FOOT	FOOT	FOOT	FOOT	FOOT	FOOT	FOOT	FOOT	EACH	EACH	EACH	EACH	EACH	EACH	EACH	FOOT	FOOT	EACH	EACH	EACH
44	NW		75.0							1		1					100.0		4	1	
	SW		25.0							1		1					125.0		4	1	1
	NE		25.0							1		1					37.5		4	1	
	SE			12.5						2	1		1				75.0		4	2	-
46	SW	25.0								1							62.5		4	1	
	SE		75.0								1						50.0		4		L
	NW									1							50.0			1	
	NE		75.0								1						62.5		4		
47	NW	37.5								1		1					75.0		4	1	
	SW	25.0								1		1					37.5		4	1	
	NE	25.0								1		1					37.5		4	1	
40	SE	50.0								1		1					75.0		4	1	
49	NW	50.0	10 5							1							37.5 37.5		4	1	
	SW NE	12.5	12.5							1							37.5		4	1	
	SE	12.5	50.0							1							37.5		4	1	
51	NW		12.5							1		1					37.5		4	1	
51	SW		12.0							1		1					37.5			1	
	NE									1		1					37.5		4	1	
	SE		12.5							1		1					37.5		4	1	-
52	NW									1				1			75.0		4	1	
	SW									1				1			75.0		4	1	-
	NE									1				1			75.0		4	1	1
	SE									1				1			75.0		4	1	
53	NW		12.5							1							37.5		4	1	
	SW									1							37.5			1	
	NE									1							37.5			1	
	SE		12.5							1							37.5		4	1	
55	NW	25.0								1		1					37.5		4	1	
	SW		87.5							1		1					150.0		4	1	<u> </u>
	NE				25.0						1		1				50.0		4		<u> </u>
	SE	25.0								1		1					37.5		4	1	
56	NW									1				1			62.5		4	1	<u> </u>
	SW	100.0								1				1			162.5		4	1	<u> </u>
	NE	50.0								1				1			162.5		4	1	<u> </u>
DTAL	SE	937.5	1,425.0	37.5	200.0	75.0	87.5	150.0	334.0	1) 87	5	22		<u>1</u> 23		1	62.5 5,312.5		338	1 87	7



Cummins	JOB = 2578.1	DESIGNED - CGF		REVISED -								ROUTE VARIOUS	SECTION	COUNTY	TOTAL SHEET SHEETS NO.
	FILE NAME = 2578.1 sht schedules dgn	DRAWN - CGF		REVISED -	LOGAN COUNTY	SCHEDULES OF QUANTITIES					18-00125-00-SP	LOGAN	33 9		
	PLOT SCALE = 2.0000 '/In	CHECKED - THF		REVISED -	GUARDRAIL IMPROVEMENTS				_		CONTRAC	CT NO. 93761			
Civil and Structural Engineering	PLOT DATE = 1/11/2021	DATE - 9/03/20	020	REVISED -		SCALE:	SHEET	OF	SHEE	TS STA.	TO STA.		ILLINOIS FED. AI	ID PROJECT	

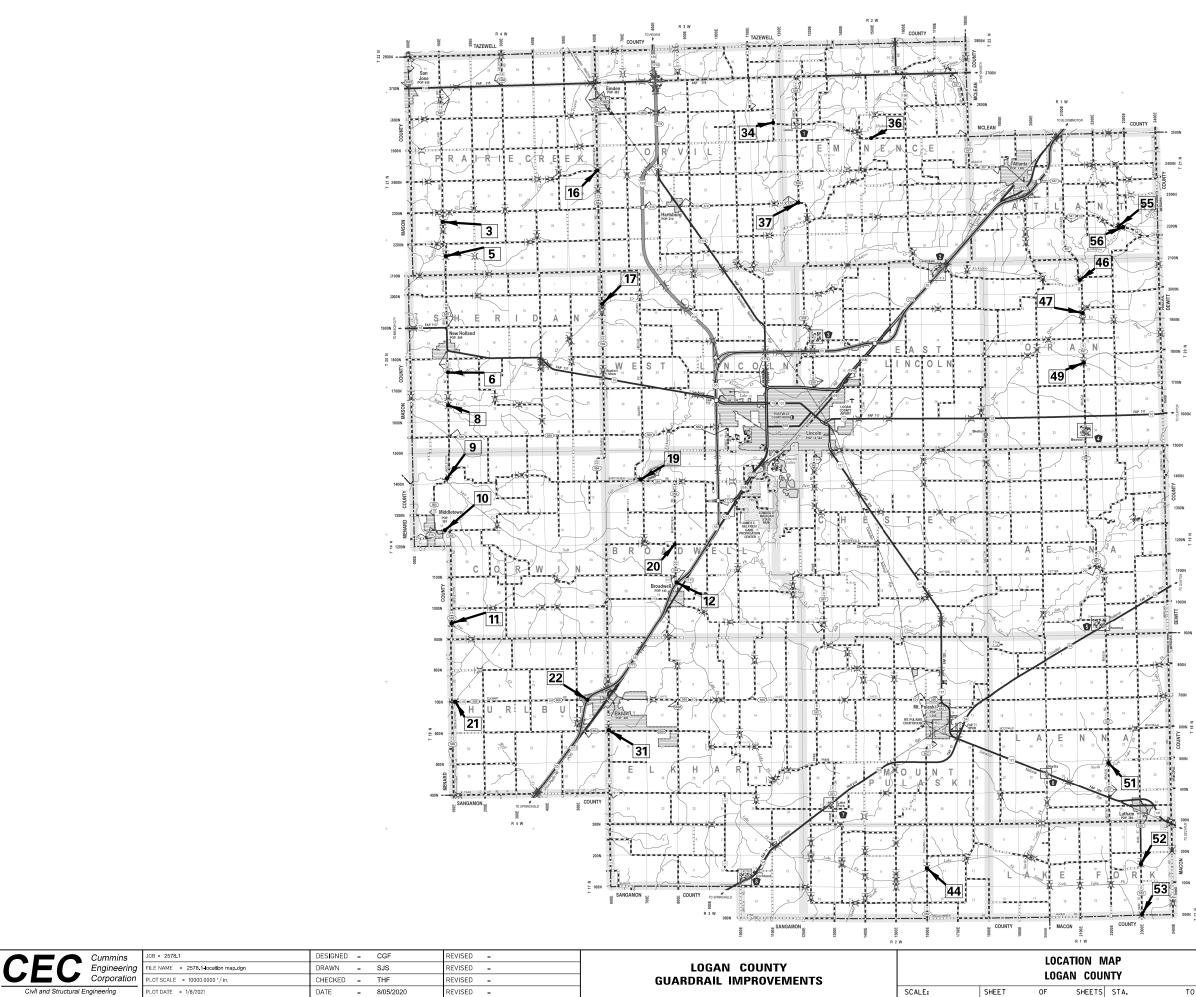


Civil and Structural Engineering


SHEET OF SHEET

N	MAP			SECTION	COUNTY	TOTAL SHEETS	SHEET NO.			
	UNTY			18-00125-00-SP	LOGAN	33	10			
				CONTRACT NO. 9376						
TS	STA.	TO STA.	ILLINOIS FED. AID PROJECT							


AP	ROUTE VARIOUS	SECTION		COUNTY	TOTAL SHEETS	SHEET NO.
ΙТΥ		18-00125-00	-SP	LOGAN	33	10
				CONTRACT	NO. 9	3761
STA. TO STA.		ILLIN	IOIS FED. AI	D PROJECT		

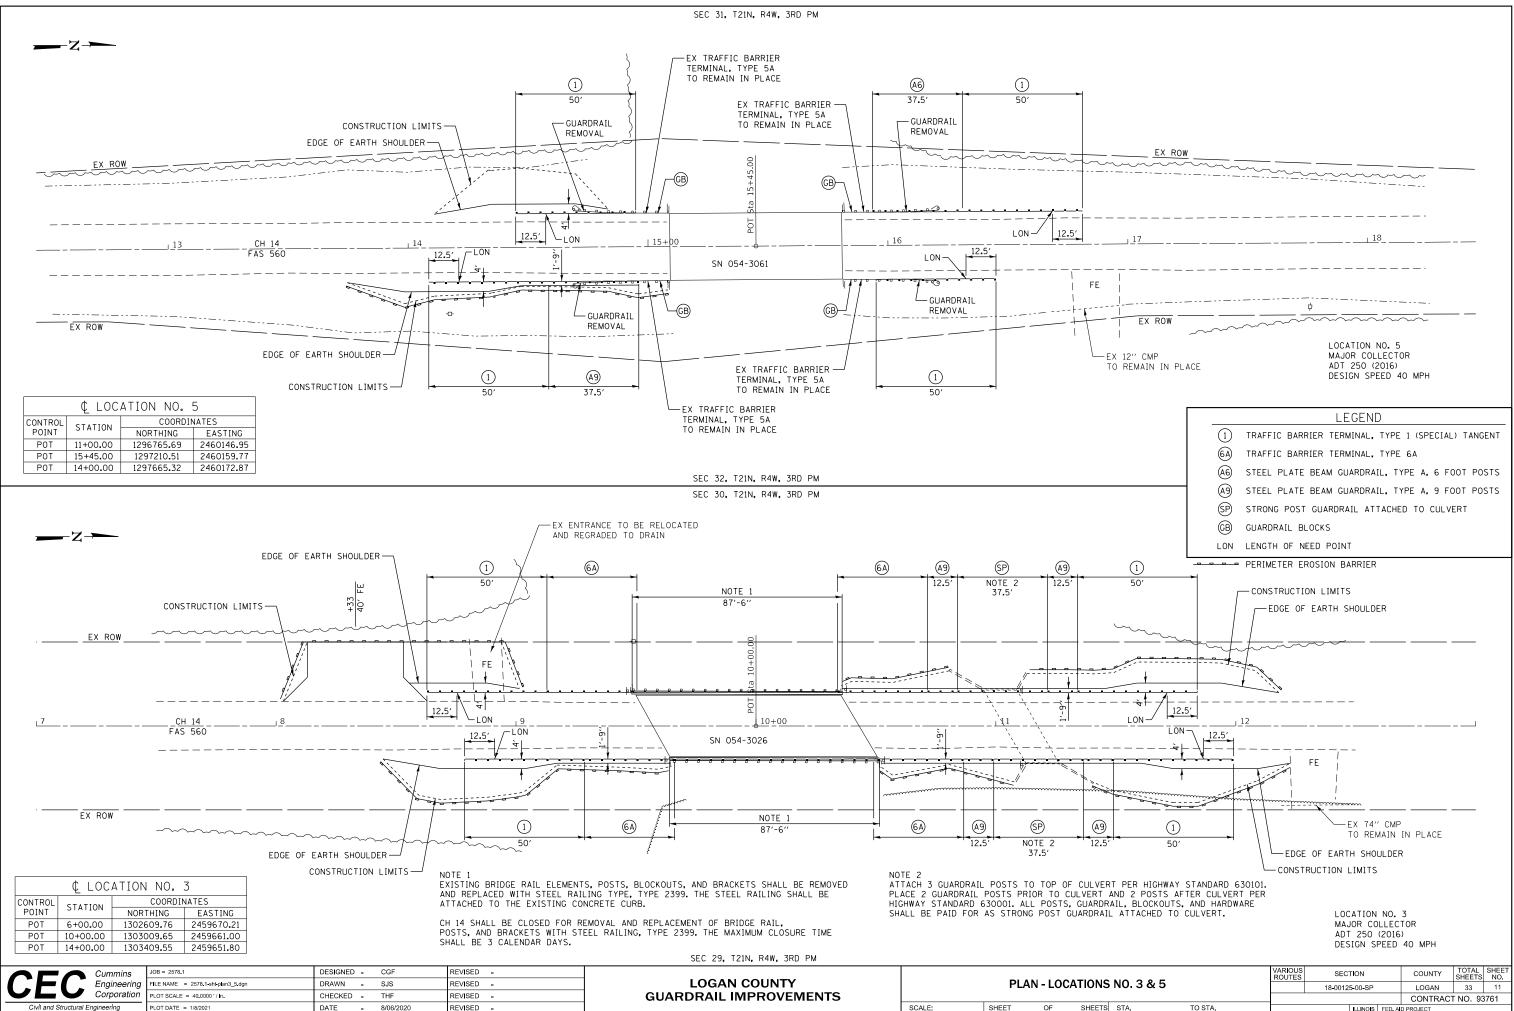


OF SHEETS STA.

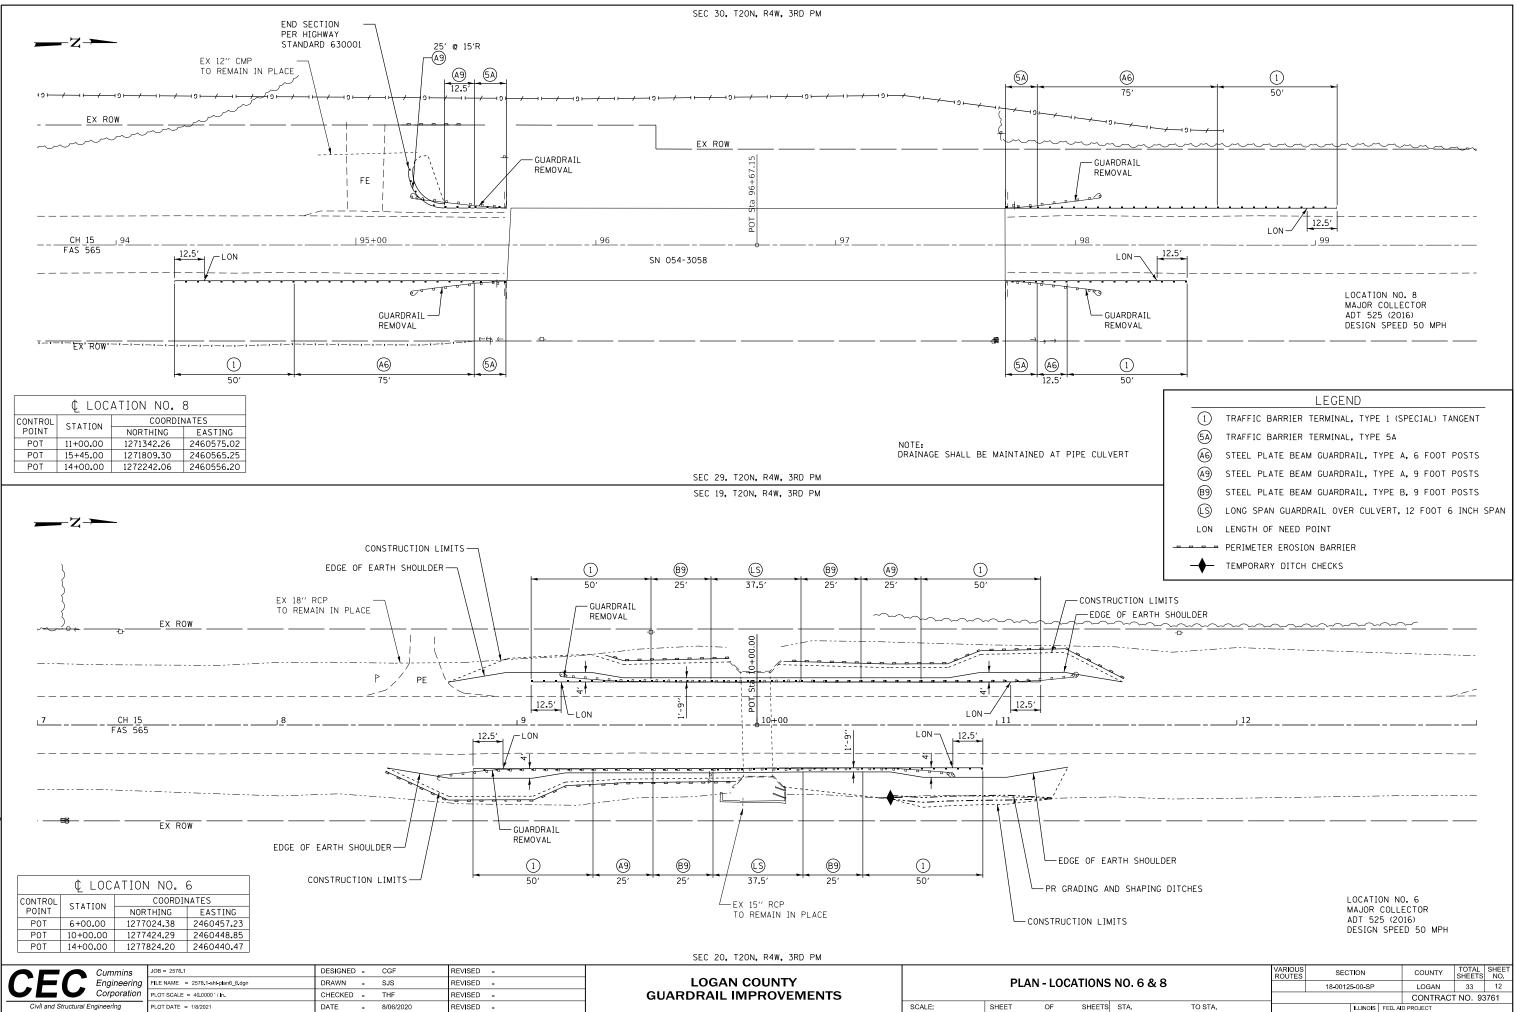

IS	NO.6&8		ROUTES	18-0012	5-00-SP		LOGAN	33	12
							CONTRAC	F NO. 93	8761
гs	STA.	TO STA.			ILLINOIS	FED. A	D PROJECT		

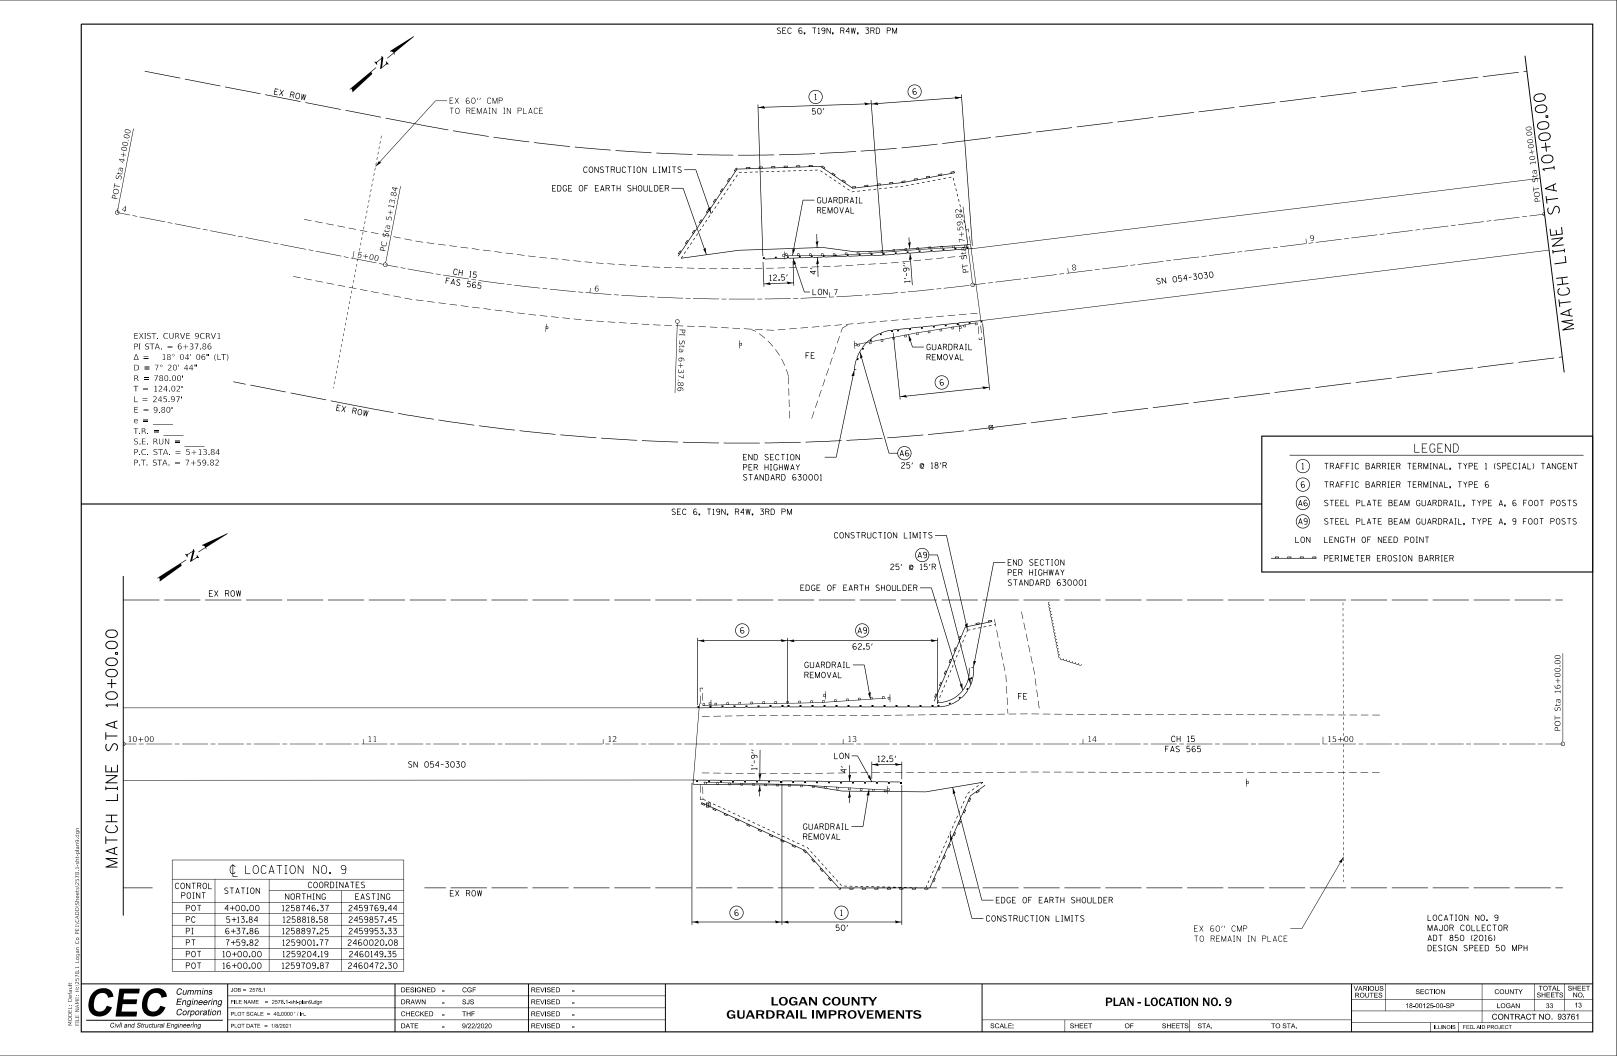

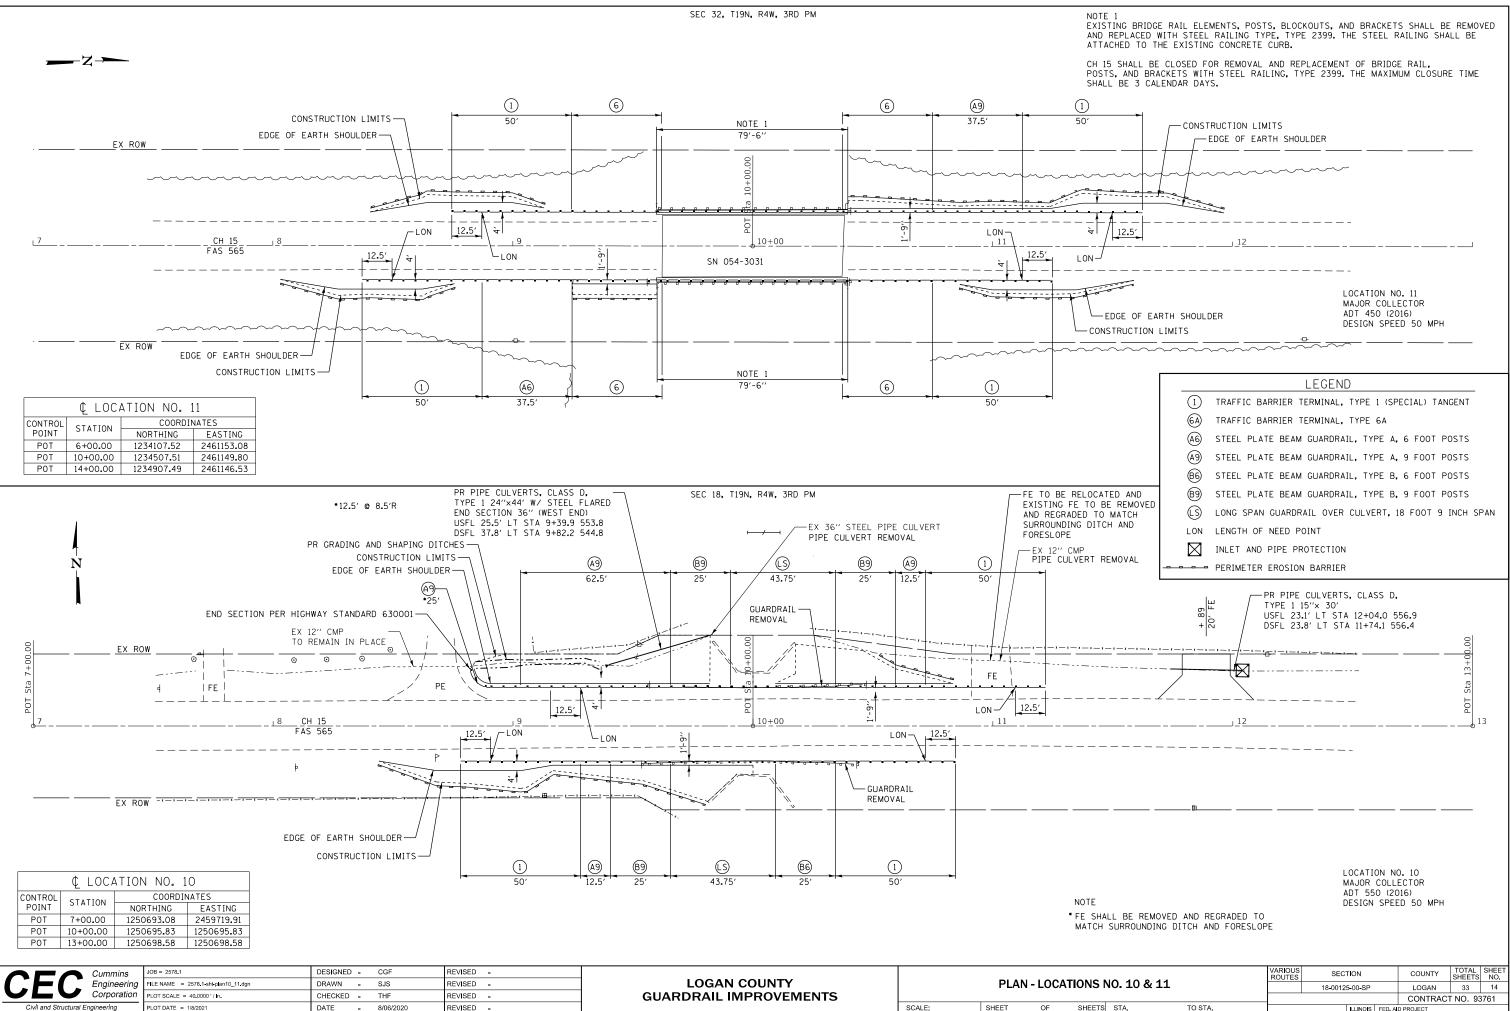

Civil and Structural Engineering

PLOT DATE = 1/8/2021


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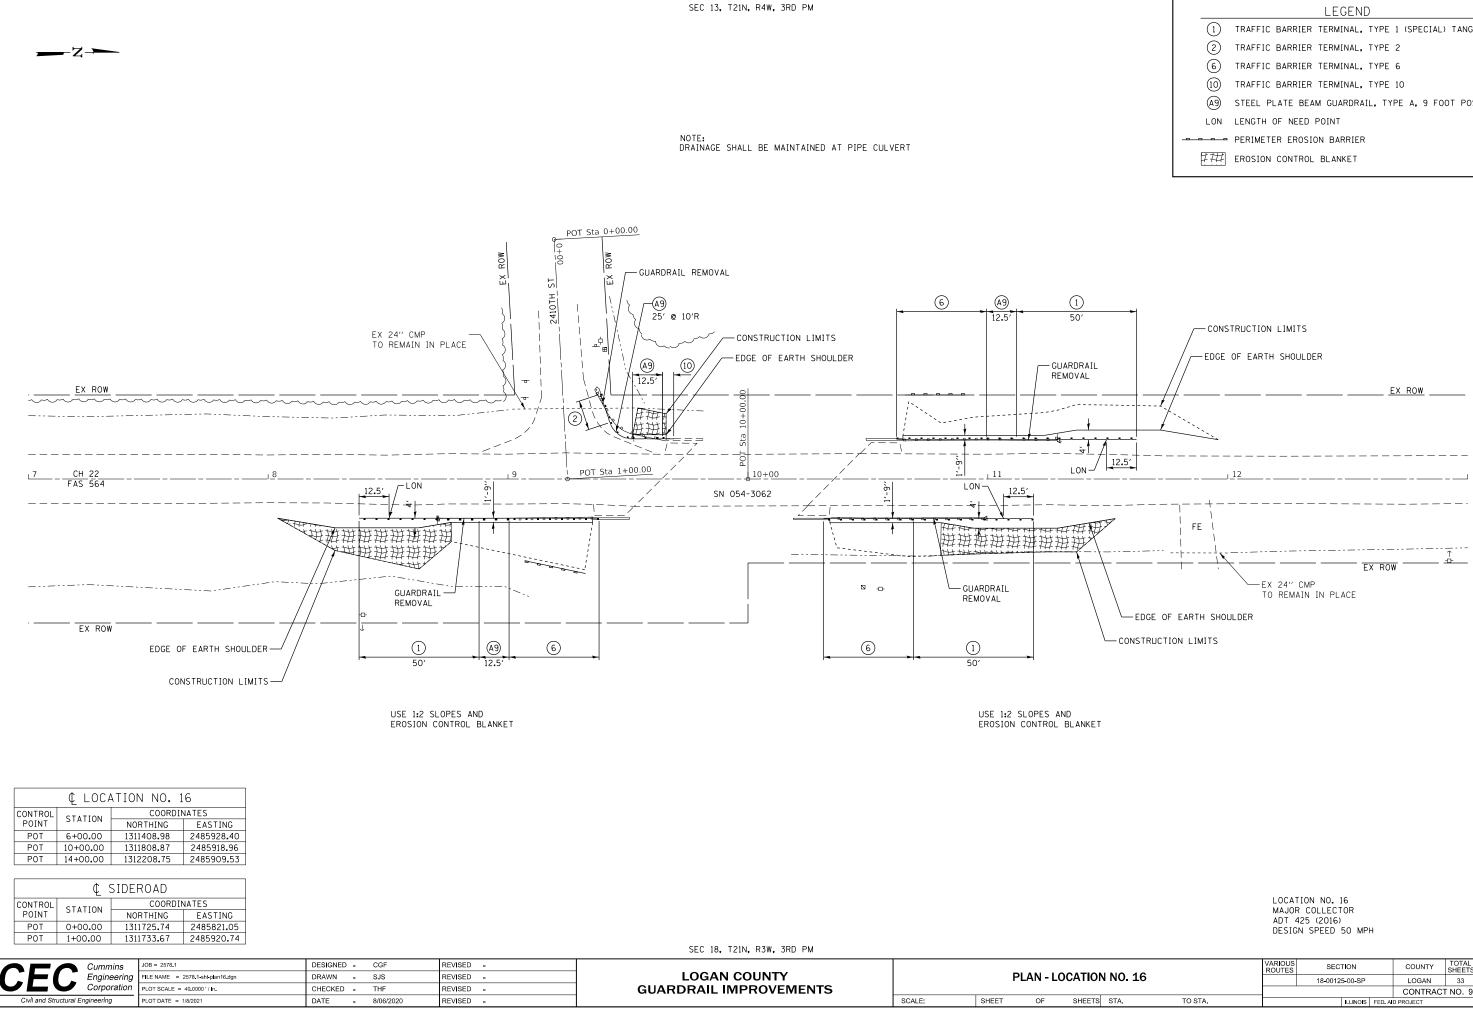
- 8/06/2020

REVISED -

SHEET OF SHEET


		18-0012	5-00-SP		LOGAN	- 33	14
_					CONTRACT	F NO. 93	3761
s	STA. TO STA.		ILLINOIS	FED. A	D PROJECT		




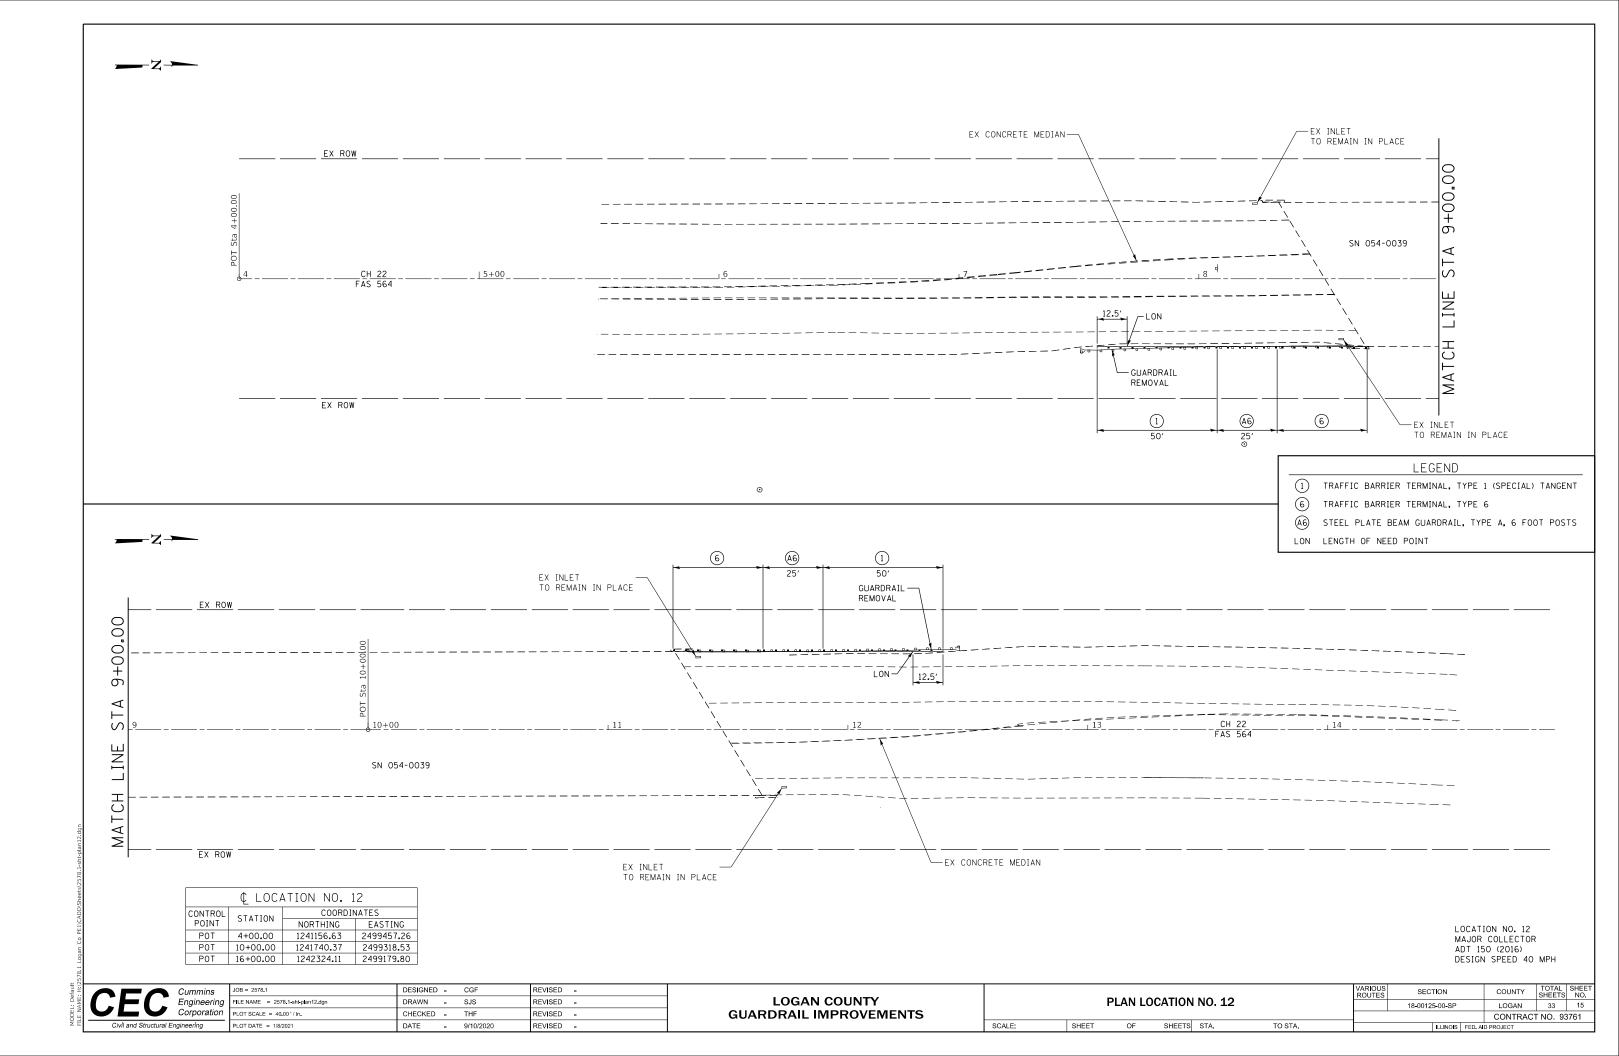


	LEGEND												
1	TRAFFIC BARRIER TERMINAL, TYPE 1 (SPECIAL) TANGENT												
2	TRAFFIC BARRIER TERMINAL, TYPE 2												
6	TRAFFIC BARRIER TERMINAL, TYPE 6												
10	TRAFFIC BARRIER TERMINAL, TYPE 10												
(A9	STEEL PLATE BEAM GUARDRAIL, TYPE A, 9 FOOT POSTS												
LON	LENGTH OF NEED POINT												
	PERIMETER EROSION BARRIER												
###	EROSION CONTROL BLANKET												


	VARIOUS ROUTES			COUNTY	TOTAL SHEETS	SHEET NO.	
ON NO. 16		18-00125-00-SP			LOGAN	33	16
					CONTRAC	F NO. 93	8761
TS STA. TO STA.			ILLINOIS	FED. A	D PROJECT		

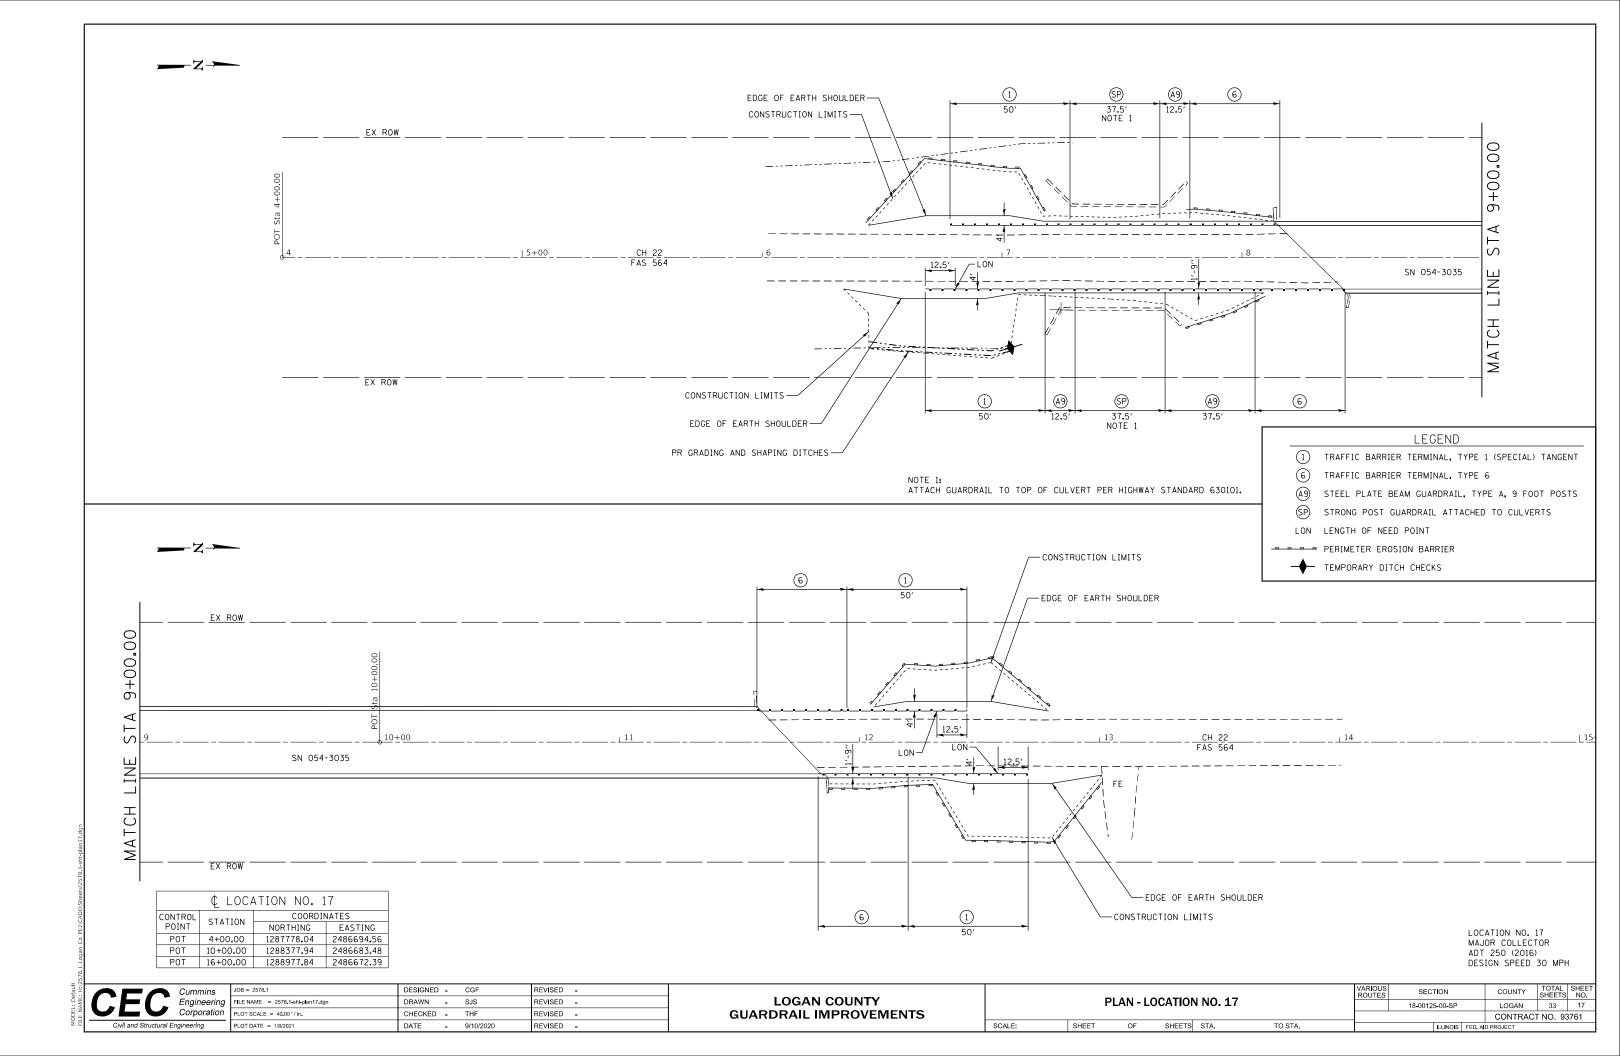

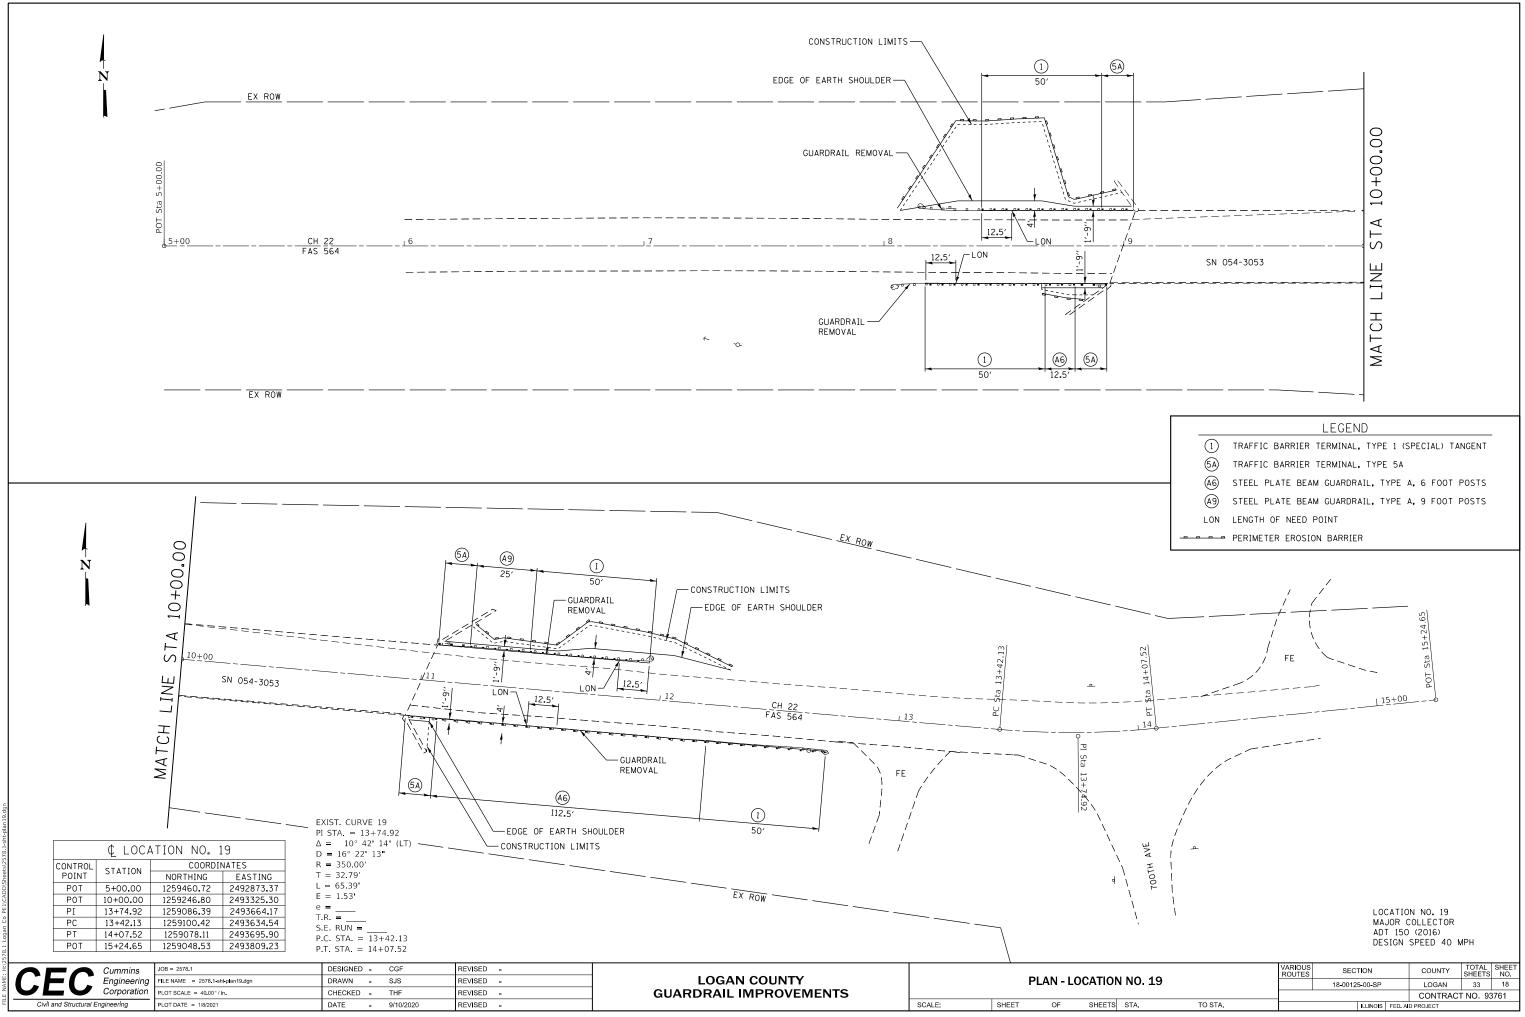

0.			18-0012	5-00-SP		LOGAN	33	18
						CONTRACT	'NO. 9	93761
TS	STA.	TO STA.		ILLINOIS	FED. A	D PROJECT		

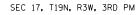

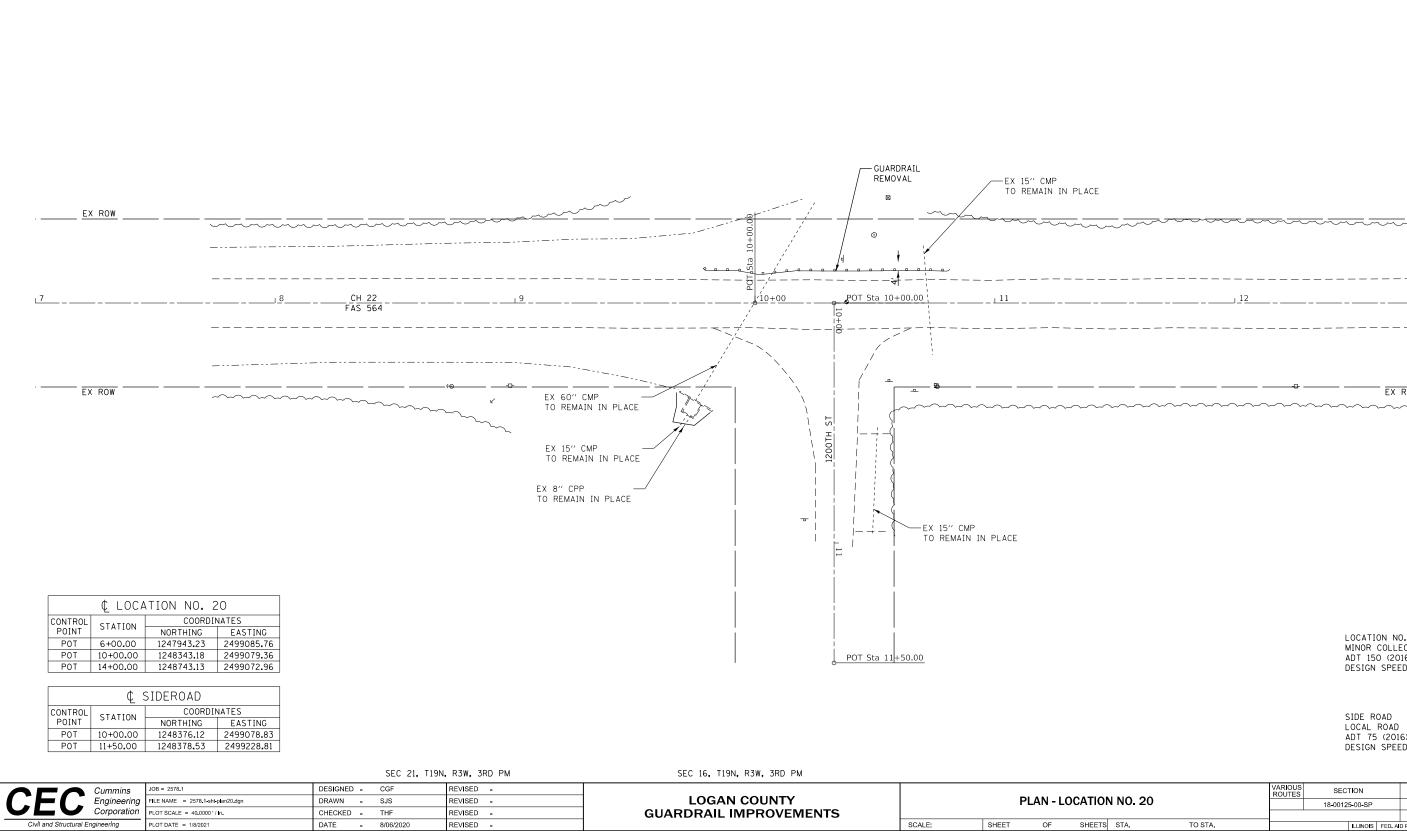


LOCATION NO. 20 MINOR COLLECTOR ADT 150 (2016) DESIGN SPEED 40 MPH

EX ROW

 $\sim\sim\sim\sim\sim\sim\sim$

SIDE ROAD LOCAL ROAD ADT 75 (2016) DESIGN SPEED 30 MPH


	DN NO. 20		VARIOUS ROUTES					TOTAL SHEETS	SHEET NO.
UN				18-0012	5-00-SP		LOGAN	33	19
							CONTRACT	F NO. 93	8761
тs	STA.	TO STA.			ILLINOIS	FED. A	D PROJECT		

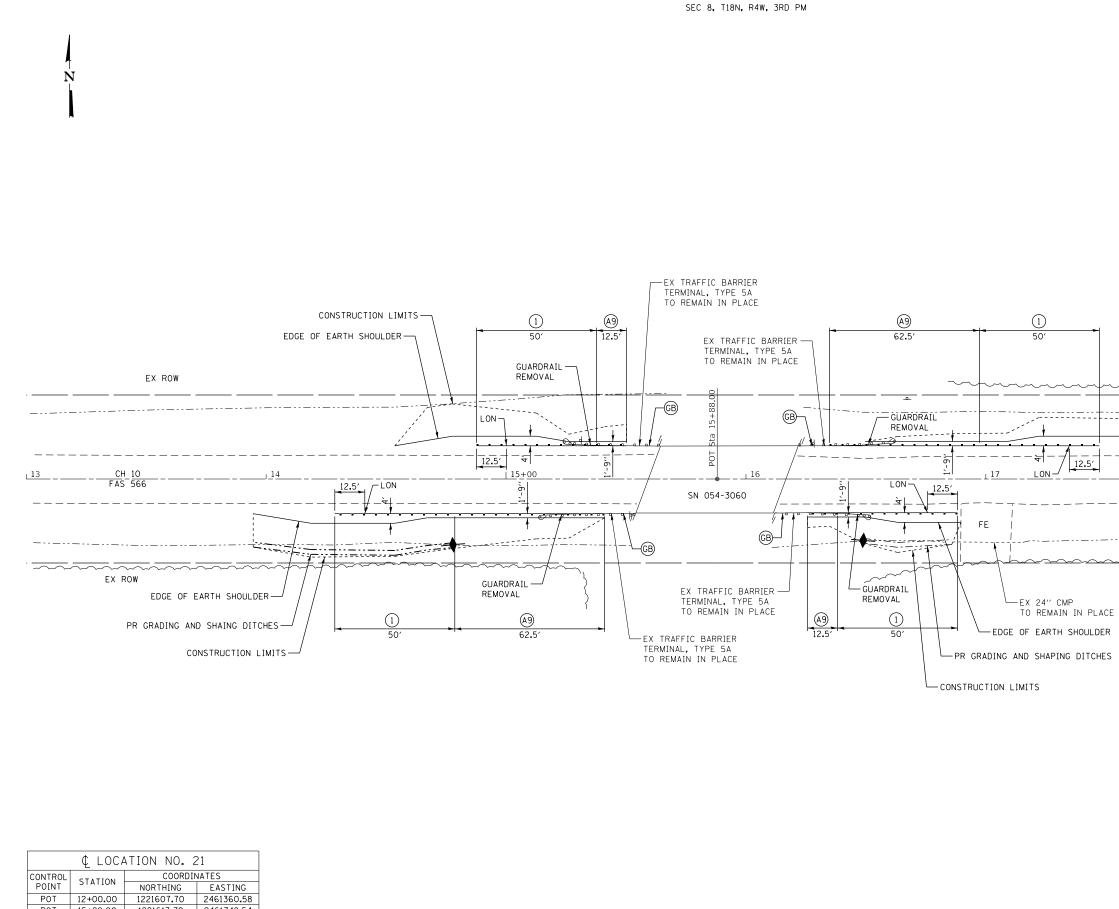

	€ LOCATION NO. 21													
CONTROL	STATION	COORDIN	NATES											
POINT	STATION	NORTHING	EASTING											
POT	12+00.00	1221607.70	2461360.58											
POT	15+88.00	1221613.79	2461748.54											
POT	19+00.00	1221618.68	2462060.50											

SEC 17, T18N, R4W, 3RD PM


HIX		Cummins	JOB = 2578.1	DESIGNED -	CGF	REVISED -					
AME:	([– (] –	Engineering	FILE NAME = 2578.1-sht-plan21.dgn	DRAWN -	SJS	REVISED -	LOGAN COUNTY		PL/	AN - LO	CATION N
E N		Corporation	PLOT SCALE = 40.0000 ' / In.	CHECKED -	THF	REVISED -	GUARDRAIL IMPROVEMENTS				
FIL	Civil and Structural Eng	gineering	PLOT DATE = 1/8/2021	DATE -	8/06/2020	REVISED -		SCALE:	SHEET	OF	SHEETS ST.

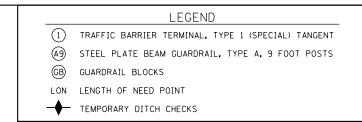


CONSTRUCTION LIMITS	
EDGE OF EARTH SHOULDER	
	POT Sta 19+00 00
_	₫
	_


LOCATION NO. 21 MAJOR COLLECTOR ADT 400 (2016) DESIGN SPEED 50 MPH

			VARIOUS ROUTES	SEC	SECTION		COUNTY	TOTAL SHEETS	SHEET NO.
)r				18-0012	5-00-SP		LOGAN	33	20
_							CONTRACT NO. 93761		
s	STA.	TO STA.			ILLINOIS	FED. A	D PROJECT		

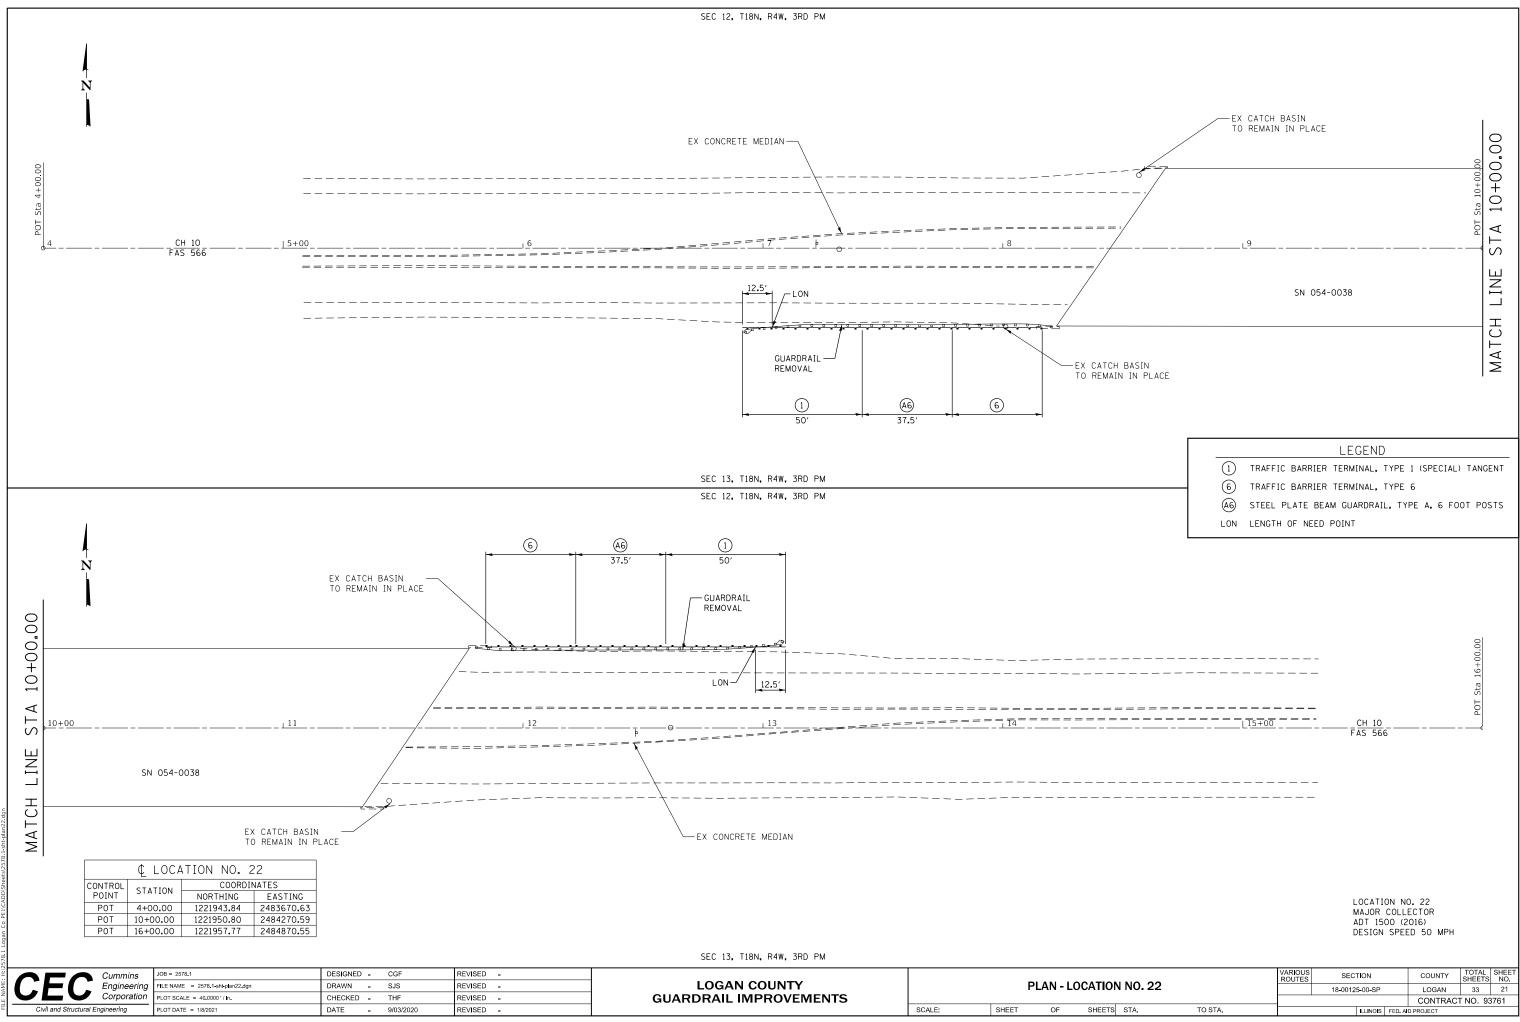


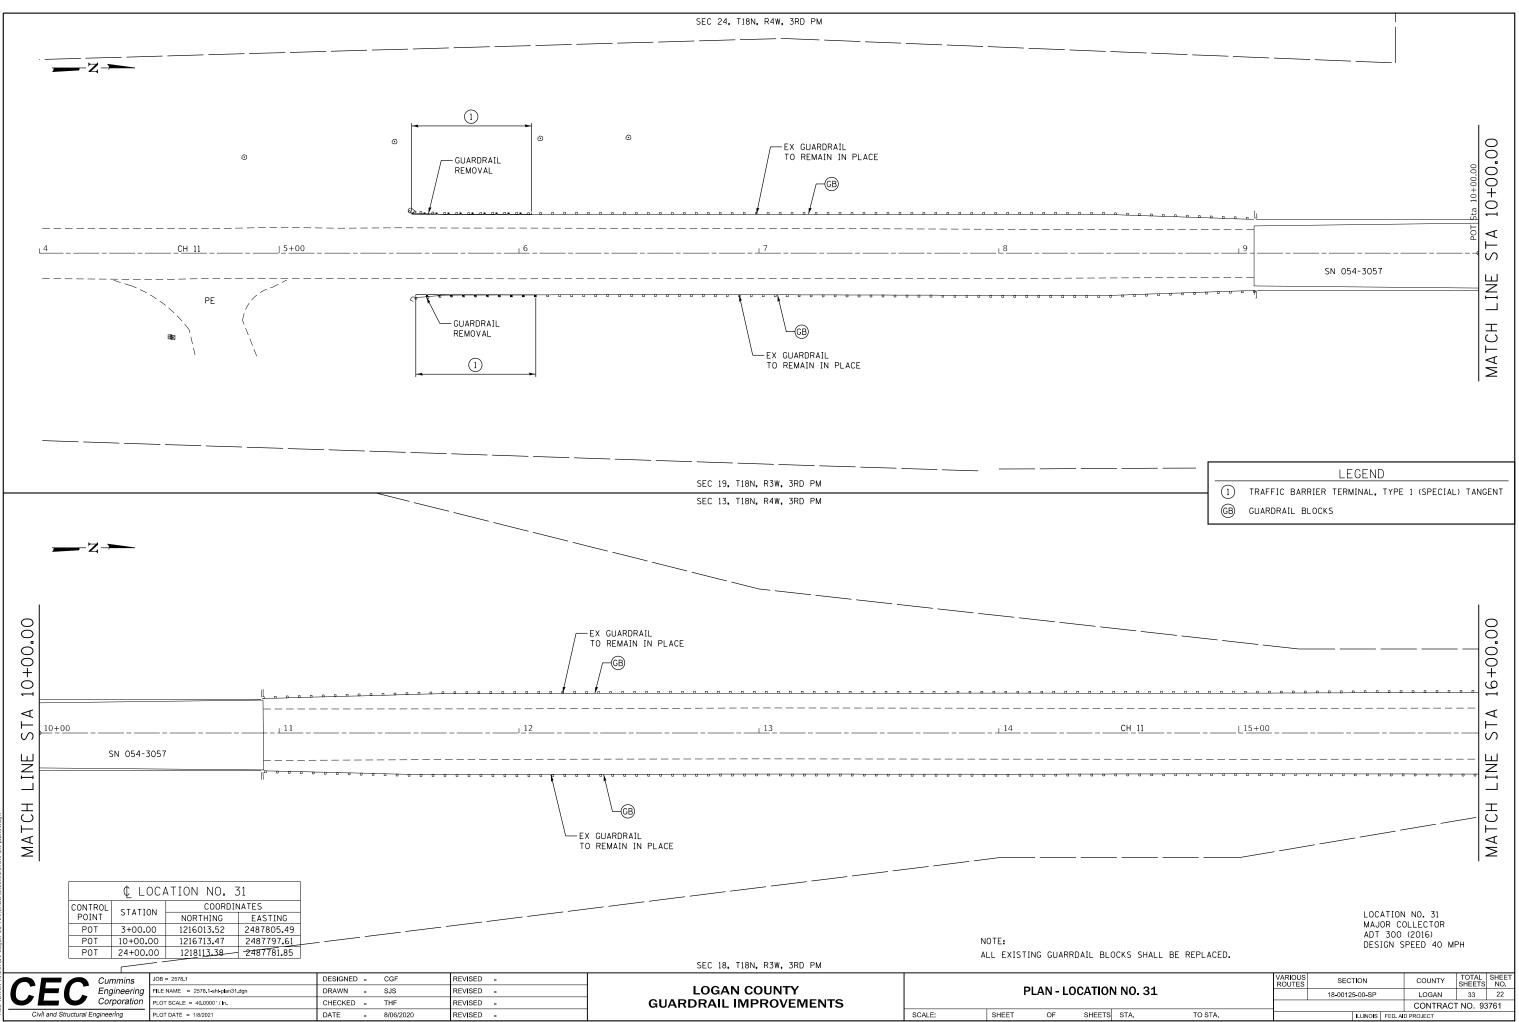

			18-0012	5-00-SP		LOGAN	- 33		
						CONTRAC	۶NO.	93	7
s	STA.	TO STA.		ILLINOIS	FED. A	D PROJECT			
									7

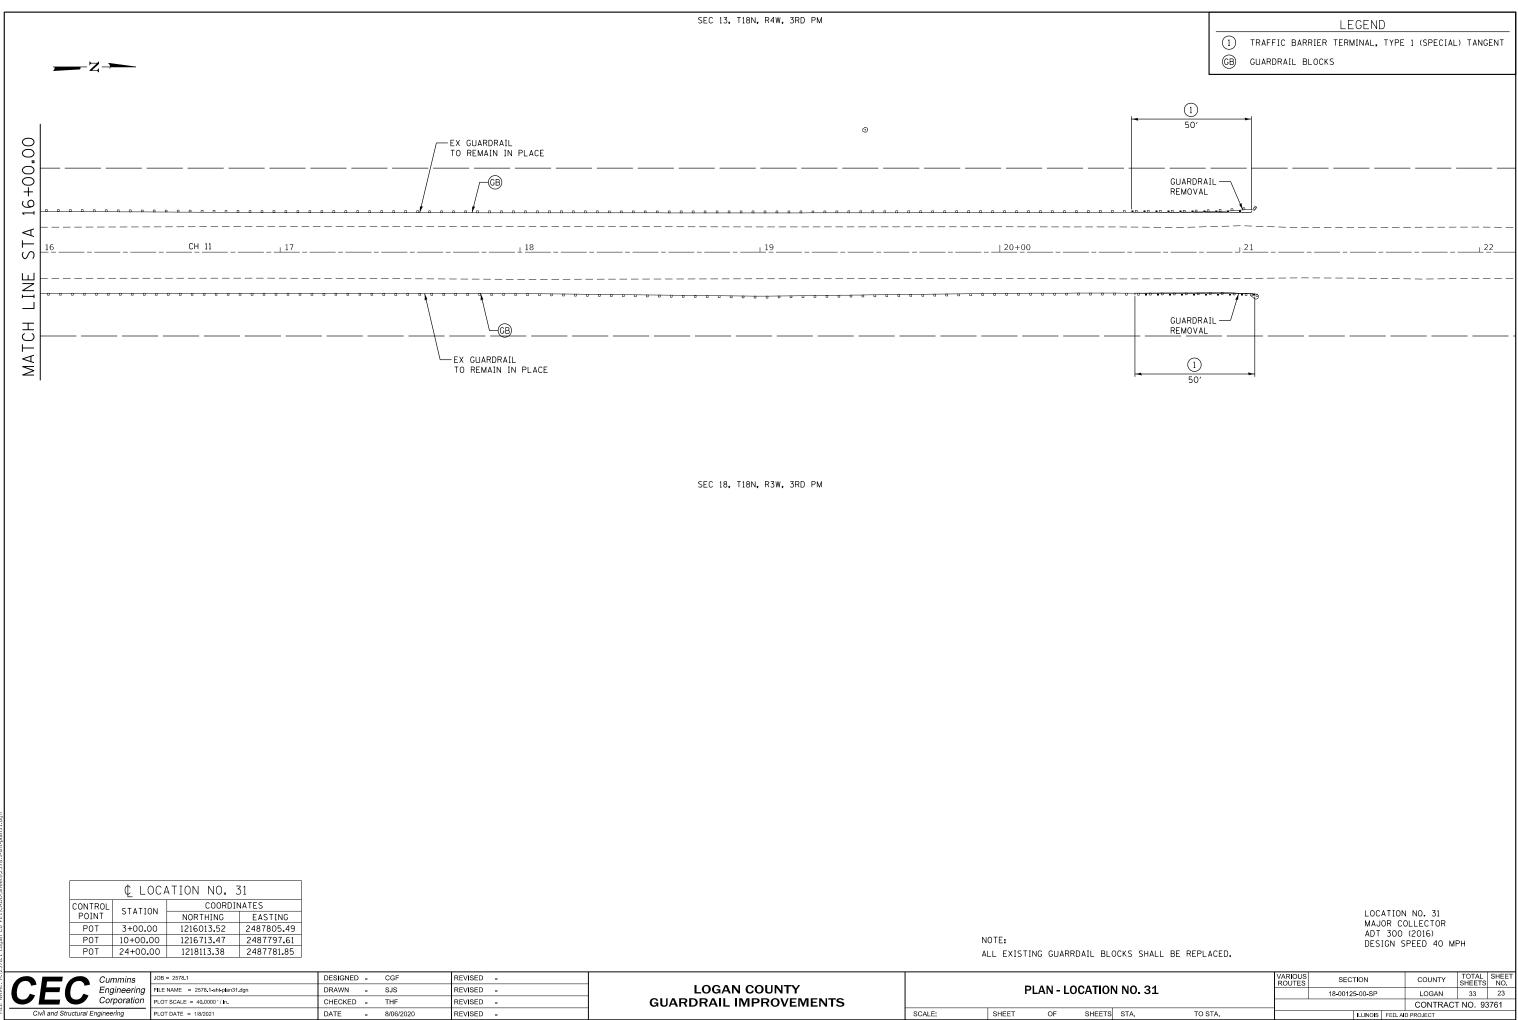

ON NO. 21		VARIOUS ROUTES	SEC.	FION		COUNTY	TOTAL SHEETS	SHEET NO.	
Or	DN NO. 31 TS STA. TO STA.			18-0012	5-00-SP		LOGAN	33	23
							CONTRACT NO. 93761		
TS					ILLINOIS	FED. A	D PROJECT		

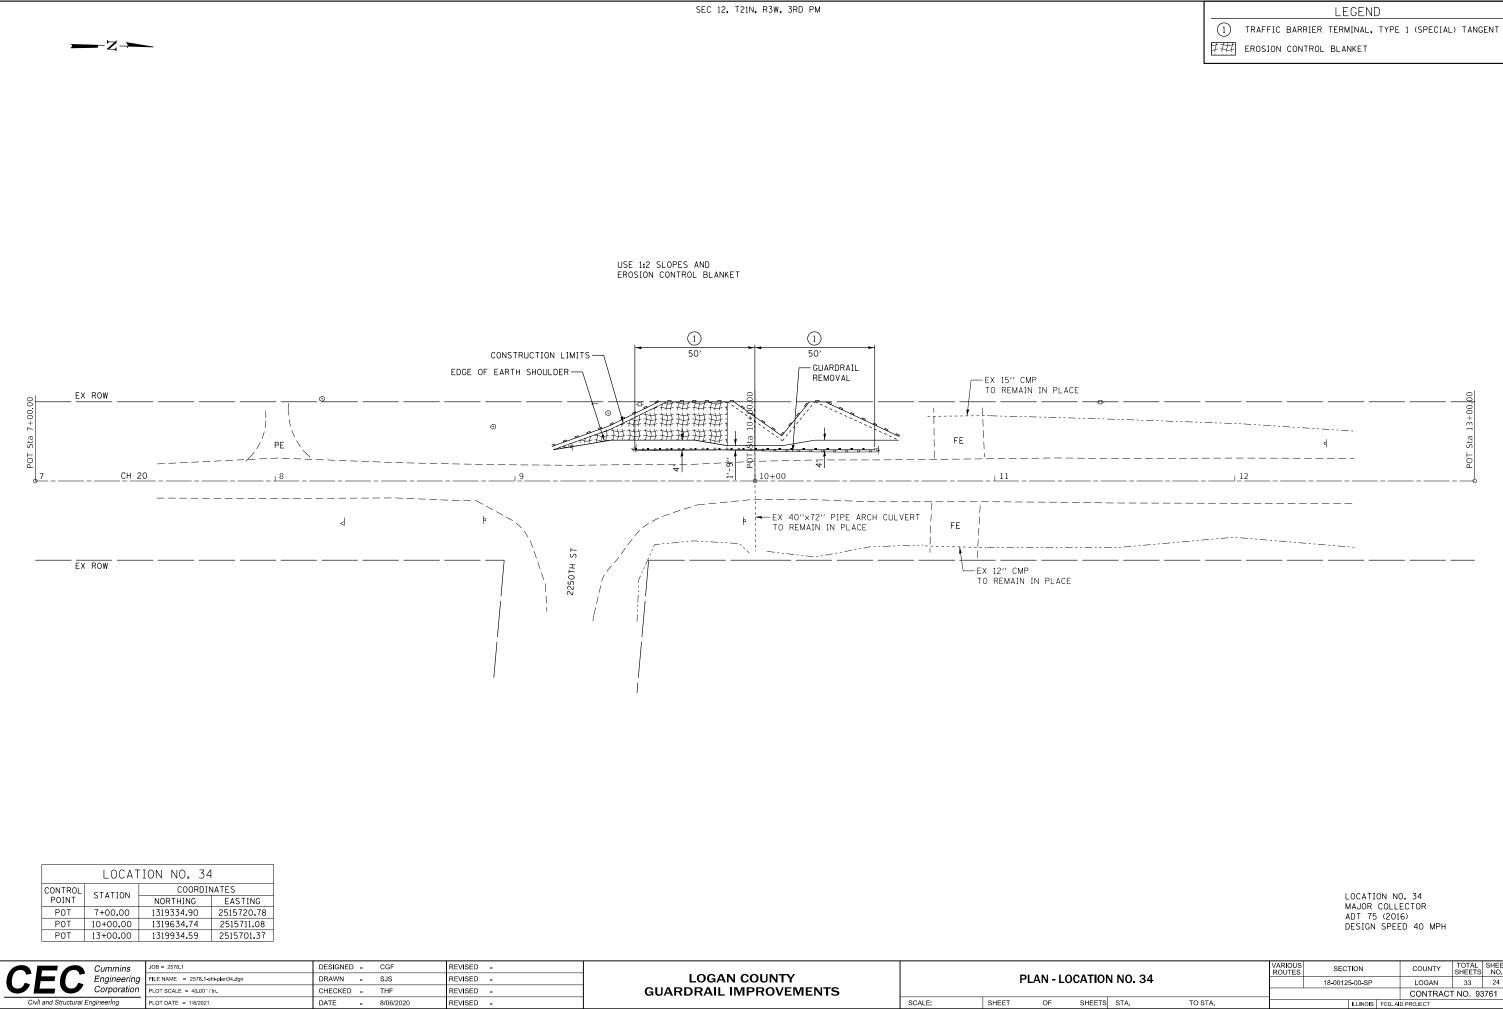


PLOT DATE = 1/8/2021

REVISED -






		VARIOUS ROUTES	SECTION		COUNTY	TOTAL SHEETS	SHEET NO.		
Or	ON NO. 34 TS STA. TO STA.			18-0012	5-00-SP		LOGAN	33	24
							CONTRAC	F NO. 93	3761
TS					ILLINOIS	FED. A	D PROJECT		

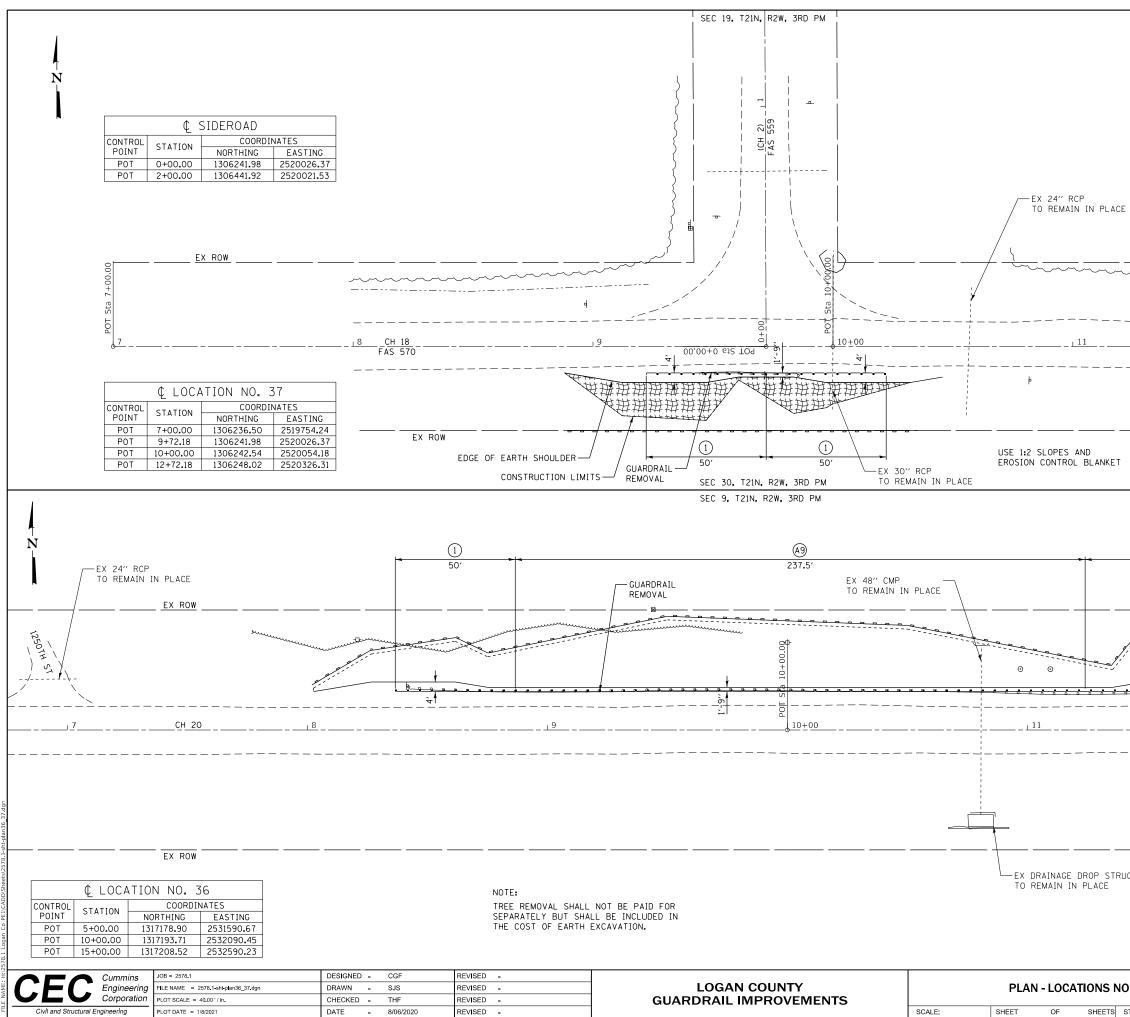


					POT Sta 12+72.18	
			LOCATION NO MAJOR COLL ADT 225 (20 DESIGN SPEE	ECTOR 016)		
ET	A9 STEEL	_ PLATE Meter ef	LEGEND RIER TERMINAL, TYPE BEAM GUARDRAIL, TY ROSION BARRIER TROL BLANKET			
			LIMITS ARTH SHOULDER			1
TRUCTURE			LOCATION N MAJOR COLL ADT 125 (20 DESIGN SPEE	ECTOR 16)		
NO 26 8 27		VARIOUS ROUTES	SECTION	COUNTY	TOTAL SHEETS	SHEET NO.


	0 00 0 07		ROUTES					SHEETS	NO.
r	NO. 36 & 37			18-0012	5-00-SP		LOGAN	33	25
_							CONTRACT	F NO. 93	8761
S	STA.	TO STA.			ILLINOIS	FED. A	D PROJECT		

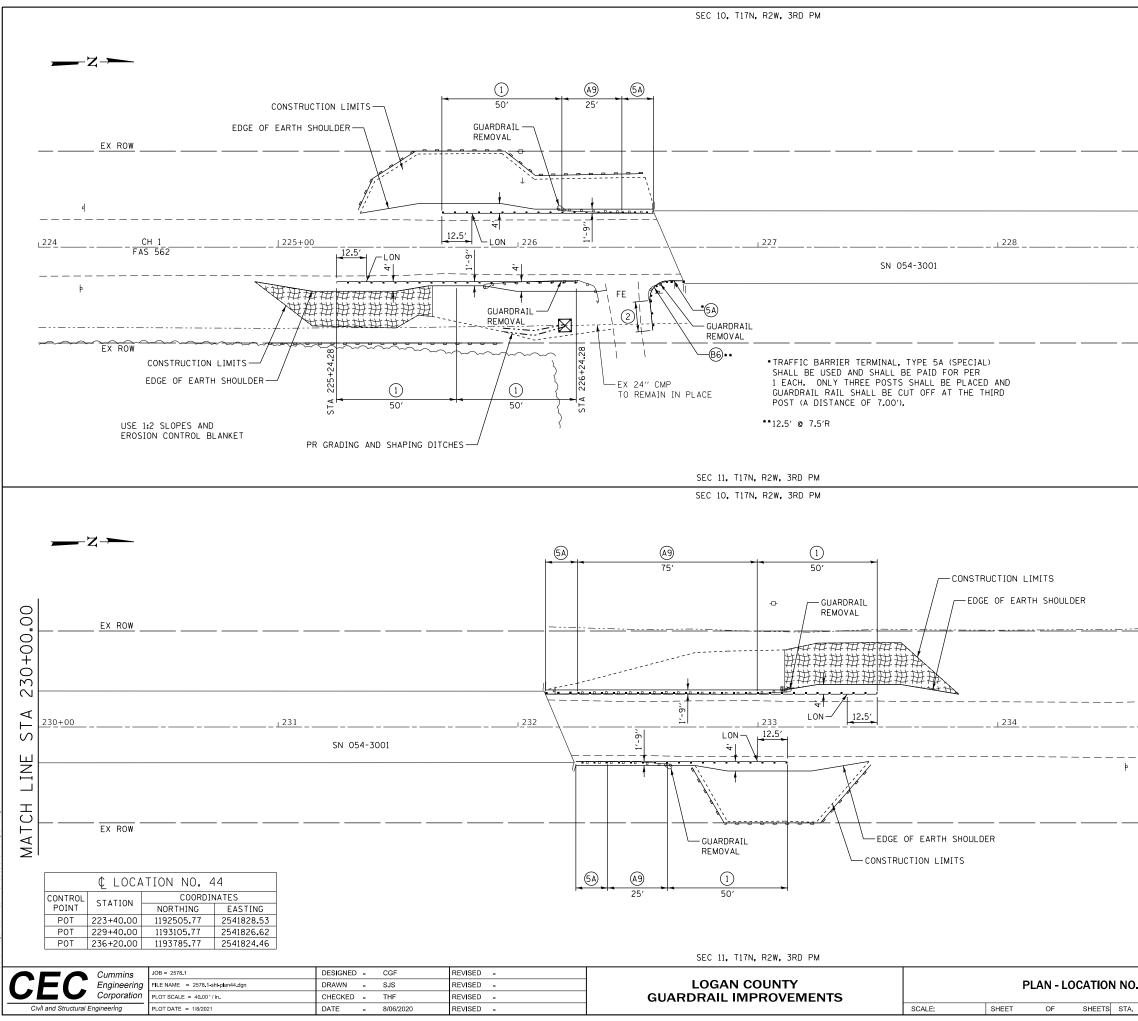

			PI Sta 229+40.00		MATCH LINE STA 230+00.00
	1 TRAFF	FIC BARRIEF	LEGEND R terminal, type	1 (SPECIAL) TANGENT
	2 TRAFI •5A TRAFI 5A TRAFI 86 STEEL A9 STEEL LON LENG PERIN	FIC BARRIEF FIC BARRIEF - PLATE BE - PLATE BE TH OF NEED METER EROS	R TERMINAL, TYPE R TERMINAL, TYPE AM GUARDRAIL, TY AM GUARDRAIL, TY POINT ION BARRIER PROTECTION	5A (SPECI) 5A YPE B, 6 F(DOT POSTS
	EROS	ION CONTRO	L BLANKET		
<u></u> <u></u>	<u></u> <u></u>		EX ROW		
4 C FAS ¢	 <u>2H 1</u> <u>235+00</u> 5 562)			1
			EX ROW		
			LOCATION N MAJOR COLL ADT 650 (2 DESIGN SPEE	ECTOR 016)	
ON NO. 44		VARIOUS ROUTES	SECTION 18-00125-00-SP	COUNTY	TOTAL SHEETSSHEET NO.3326
TS STA.	TO STA.		ILLINOIS FED. A		T NO. 93761

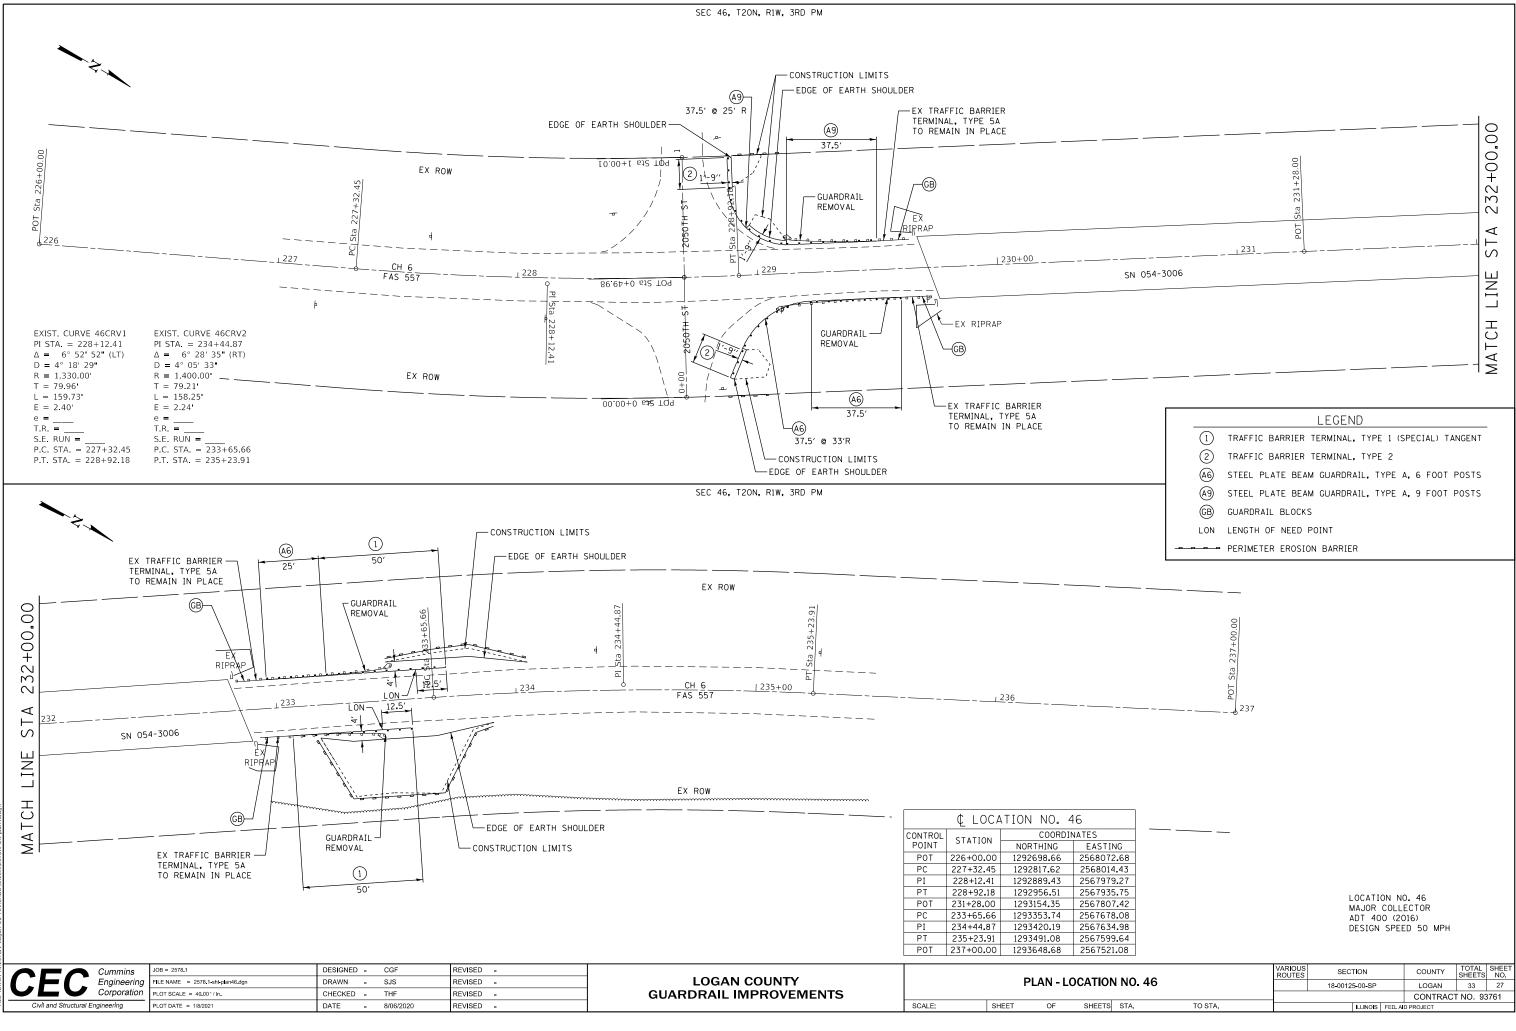


_					CONTRACT NO. 9
s	STA.	TO STA. ILLINOIS		FED. A	D PROJECT

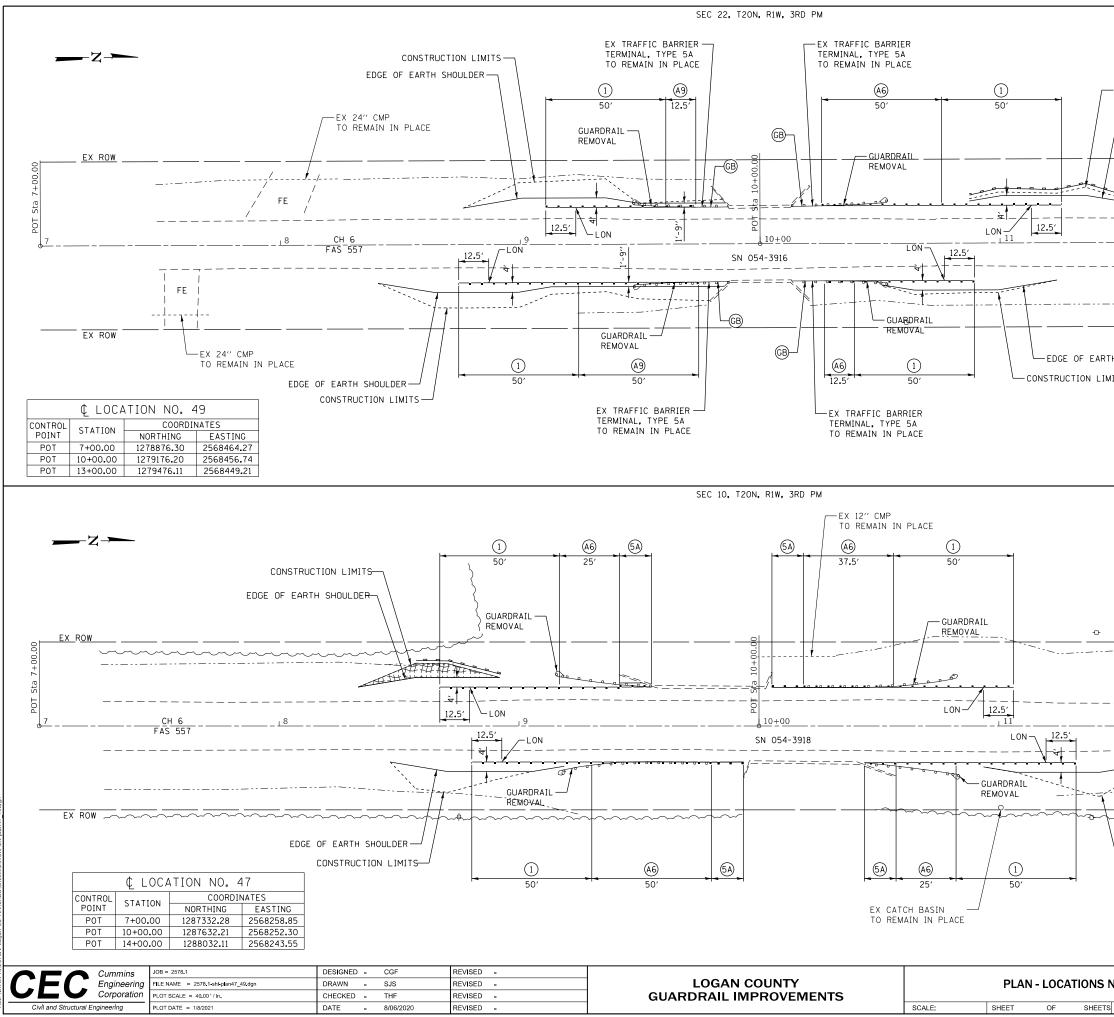

-CONSTRUCTION L	IMITS					
EDGE OF EAR	TH SHOULDER				ol	
					POT Sta 13+00.00	
	12					13
TH SHOULDER MITS			LOCATION NO. MAJOR COLLEC ADT 400 (2011 DESIGN SPEED	TOR .)		
	GA TRAFF (AG) STEEL (AG) STEEL (GB) GUARC LON LENGT PERIM	FIC BAR PLATE PLATE DRAIL B TH OF N TETER E	IEED POINT ROSION BARRIER	5A YPE A, 6 F(DOT PO	STS
	EROSI	E	TROL BLANKET X 15" CMP – O REMAIN IN PLACE			
				PE	+ 	<u> </u>
EDGE OF CONSTRUCTIO	EARTH SHOULDER				1	<u>-</u> -
			LOCATION NO MAJOR COLLE ADT 400 (20 DESIGN SPEE	ECTOR 11)		
NO. 47 & 49		VARIOUS ROUTES	SECTION 18-00125-00-SP	COUNTY	TOTAL SHEETS 33	SHEET NO. 28

			18-0012	5-00-SP		LOGAN	33	28
_						CONTRACT	NO. 93	3761
S	STA.	TO STA.		ILLINOIS	FED. A	D PROJECT		
							-	

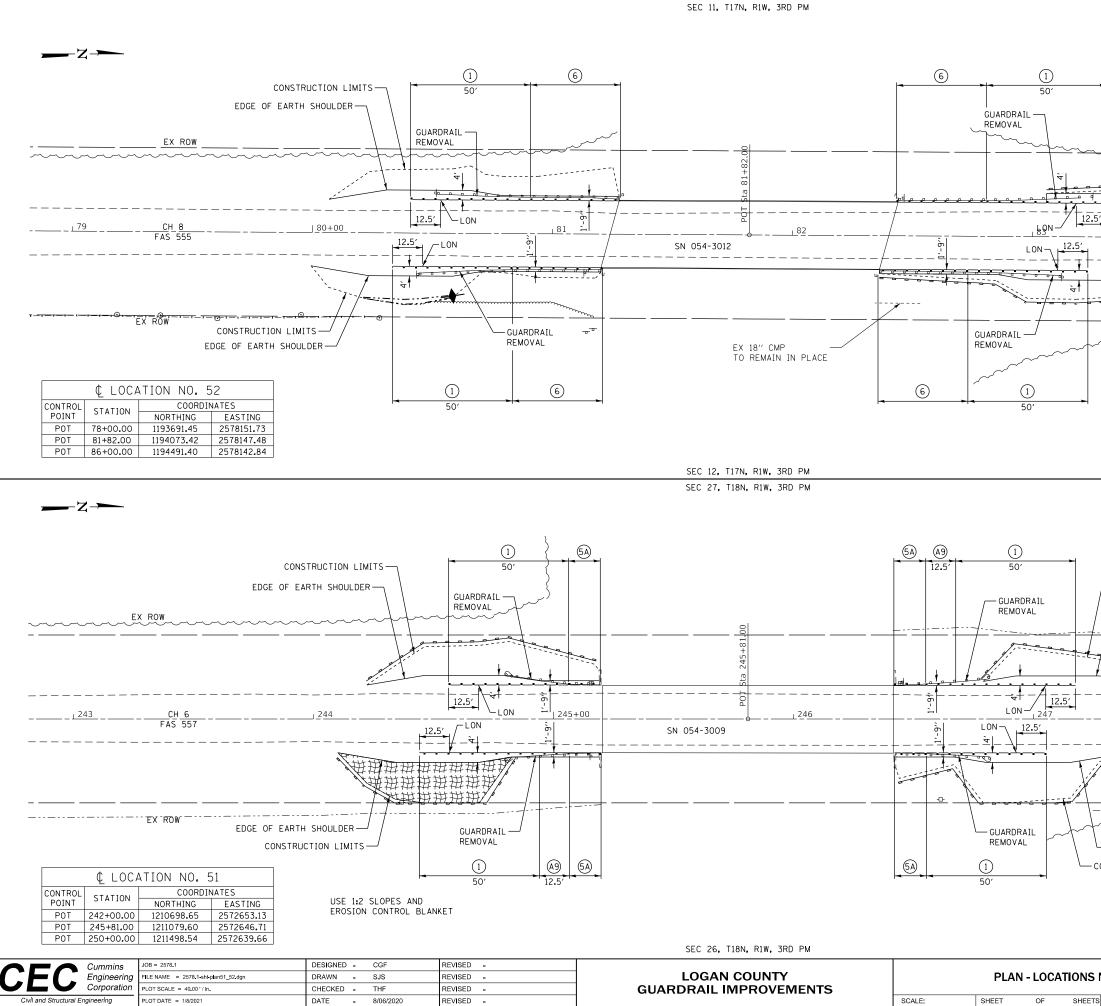


REVISED -

PLOT DATE = 1/8/2021

EDGE OF EARTH SHOL	ILDER				
CONSTRUCTION LI	MITS				
	~~~~			~~~	
´►  	<u>84</u>				
		~~~~~~~~~~~~~~~~~~~~~~~~~~~~~~~~~~~~~~			
		LOCATION NO. 52		20	
CONSTRUCTION LIMI		MAJOR COLLECTOR ADT 200 (2016)			
		DESIGN SPEED 40	MPH		
Γ		LEGEND			
1) TRAF	FIC BAR	RIER TERMINAL, TYPE	1 (SPECIA	L) TANG	ENT
		RIER TERMINAL, TYPE			
	FIC BAR	RIER TERMINAL, TYPE	5A		
A9 STEE	l plate	BEAM GUARDRAIL, TY	(PE A, 9 F	00T PO	STS
		EED POINT			
		ROSION BARRIER			
<u>E + + + + 4</u> EROS	ION CON	TROL BLANKET			
EDGE OF EARTH SHOULDER					
				-	
	248				
				-	
1 months and the second s					
	~ ~ ~			~	
EDGE OF EARTH SHOULDER					
CONSTRUCTION LIMITS					
		LOCATION N	D. 51		
		MAJOR COLL ADT 250 (20	ECTOR		
		DESIGN SPEE			
	VARIOUS	SECTION	COUNTY	TOTAL SHEETS	SHEET
NO. 51 & 52	ROUTES	18-00125-00-SP	LOGAN	SHEETS	NO. 29

NU. 51 & 52		18-00125-00-SP			LOGAN	33	29	
					CONTRACT	NO. 93	3761	
s	STA.	TO STA.		ILLINOIS	FED. A	D PROJECT		

SEC 14, T17N, R1W, 3RD PM

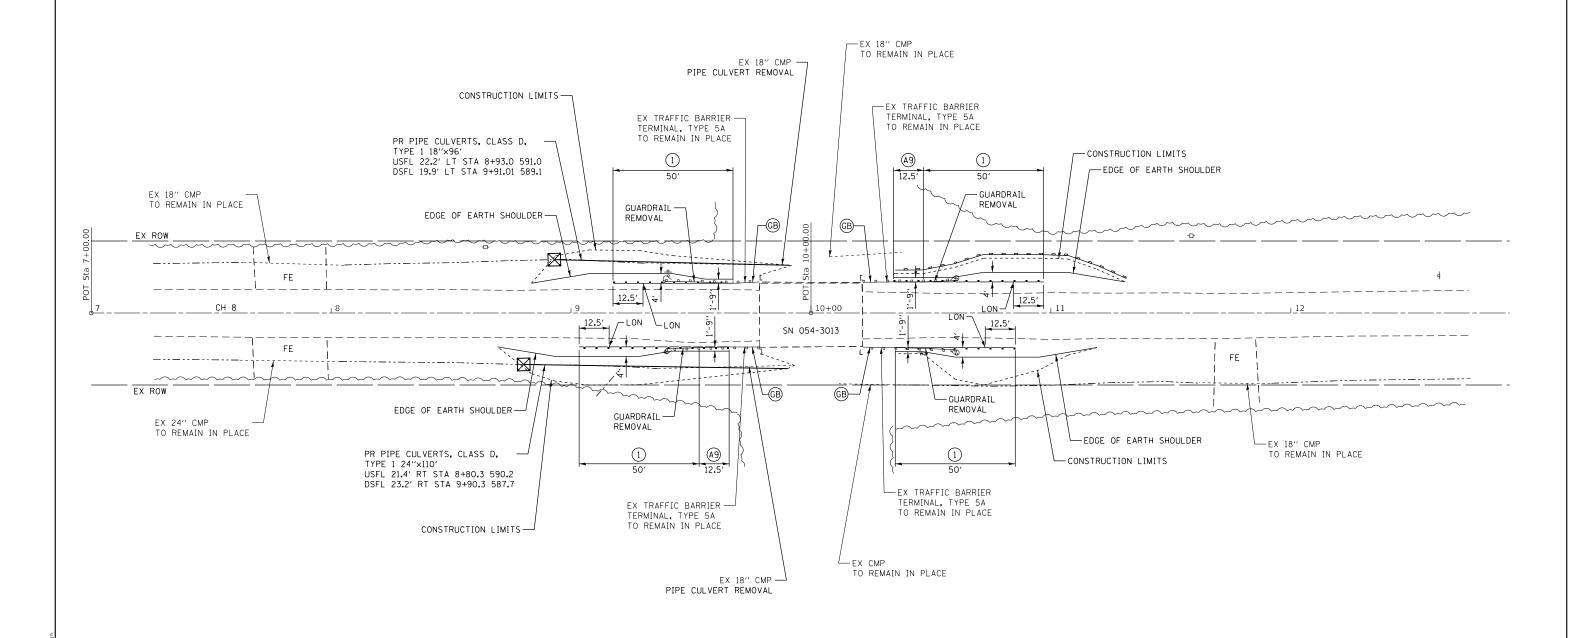


¢ LOCATION NO. 53								
CONTROL	STATION	COORDI	NATES					
POINT	STATION	NORTHING	EASTING					
POT	7+00.00	1185086.93	2578306.11					
POT	10+00.00	1185386.93	2578305.76					
POT	13+00.00	1185686.93	2578305.42					

SEC 13, T17N, R1W, 3RD PM

H:\2		JOB = 2578.1	DESIGNED -	CGF	REVISED -					VARIOUS ROUTES	SECTION	COUNTY	TOTAL SHEET			
AME	Engineering	FILE NAME = 2578.1-sht-plan53.dgn	DRAWN -	SJS	REVISED -	LOGAN COUNTY	PLAN - LOCATION NO. 53		1100120	18-00125-00-SP	LOGAN	33 30				
E N	Corporation	PLOT SCALE = 40.00 ' / In.	CHECKED -	THF	REVISED -	GUARDRAIL IMPROVEMENTS									CONTRAC	T NO. 93761
M III	Civil and Structural Engineering	PLOT DATE = 1/8/2021	DATE -	9/17/2020	REVISED -		SCALE:	SHEET	OF	SHEETS	STA.	TO STA.		ILLINOIS FED.	AID PROJECT	

	LEGEND
1	TRAFFIC BARRIER TERMINAL, TYPE 1 (SPECIAL) TANGENT
A9	STEEL PLATE BEAM GUARDRAIL, TYPE A, 9 FOOT POSTS
GB	GUARDRAIL BLOCKS
LON	LENGTH OF NEED POINT
\boxtimes	INLET AND PIPE PROTECTION
	PERIMETER EROSION BARRIER


LOCATION NO. 53 MAJOR COLLECTOR ADT 200 (2016) DESIGN SPEED 40 MPH

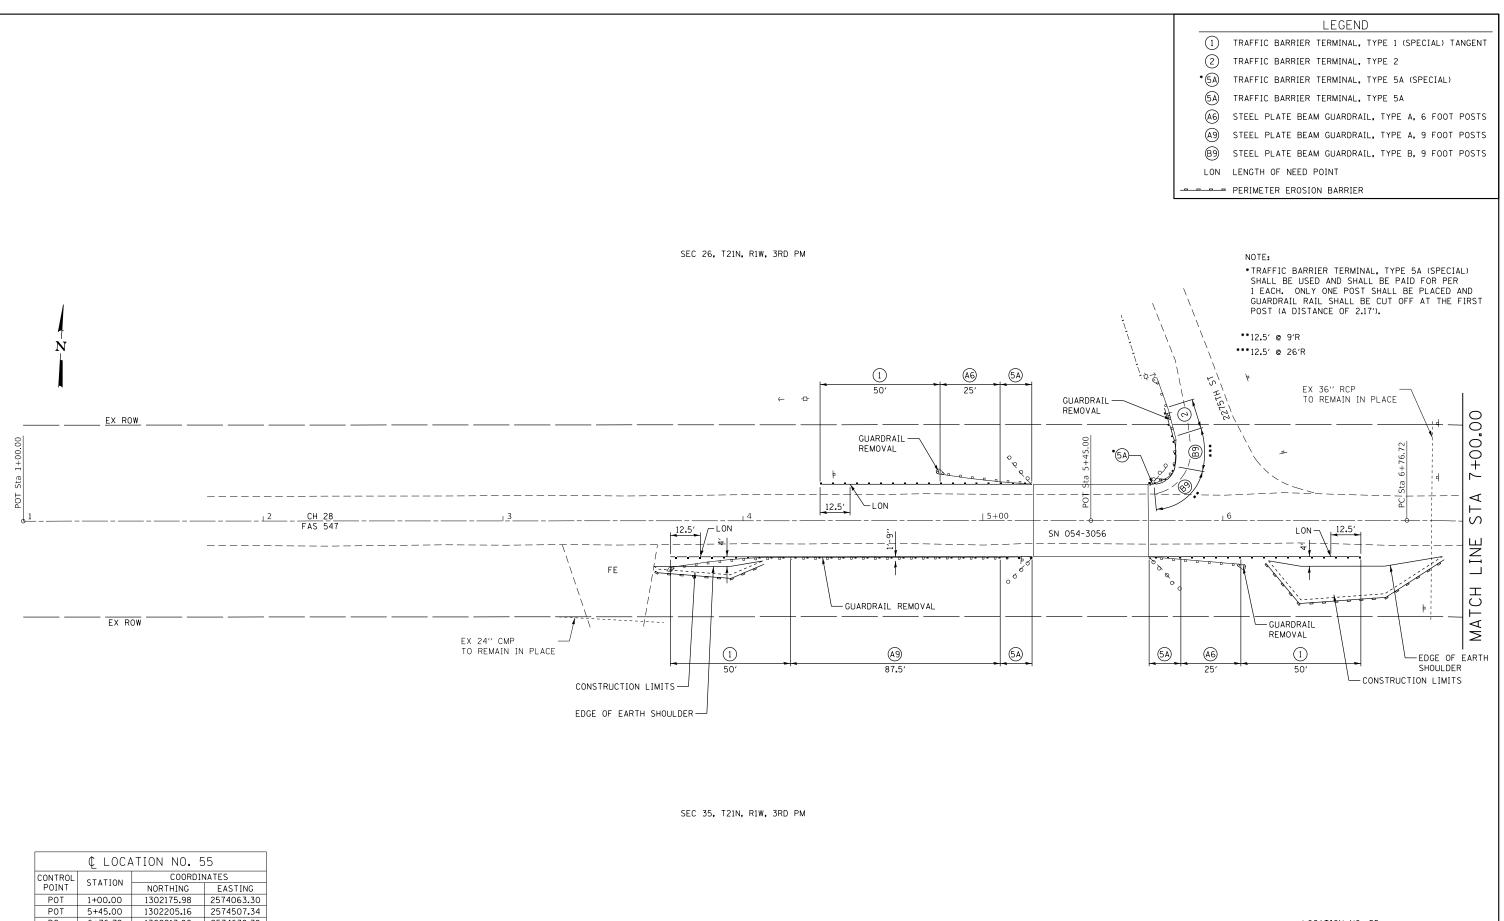


	¢ loca	ATION NO. 5	55
CONTROL	STATION	COORDI	NATES
POINT	STATION	NORTHING	EASTING
POT	1+00.00	1302175.98	2574063.30
POT	5+45.00	1302205.16	2574507.34
PC	6+76.72	1302213.80	2574638.78
PI	7+91.93	1302221.35	2574753.74
PT	9+05.75	1302198.03	2574866.57

L: Default IAME: H:\2	CFC Cummins Engineering	JOB = 2578.1 FILE NAME = 2578.1-sht-plan55_56.dgn	DESIGNED - CGF DRAWN - SJS	REVISED -	LOGAN COUNTY	PLAN - LOCATION NO. 55		VARIOUS SECTION COUNTY TOTAL SHEETS NO. 18-00125-00-SP LOGAN 33 31
ODE LE N		PLOT SCALE = 40.00 ' / In.	CHECKED - THF	REVISED -	GUARDRAIL IMPROVEMENTS			CONTRACT NO. 93761
ΣE	Civil and Structural Engineering	PLOT DATE = 1/8/2021	DATE - 8/06/2020	REVISED -		SCALE:	SHEET OF SHEETS STA. TO STA.	ILLINOIS FED. AID PROJECT

LOCATION NO. 55 MAJOR COLLECTOR ADT 550 (2016) DESIGN SPEED 50 MPH

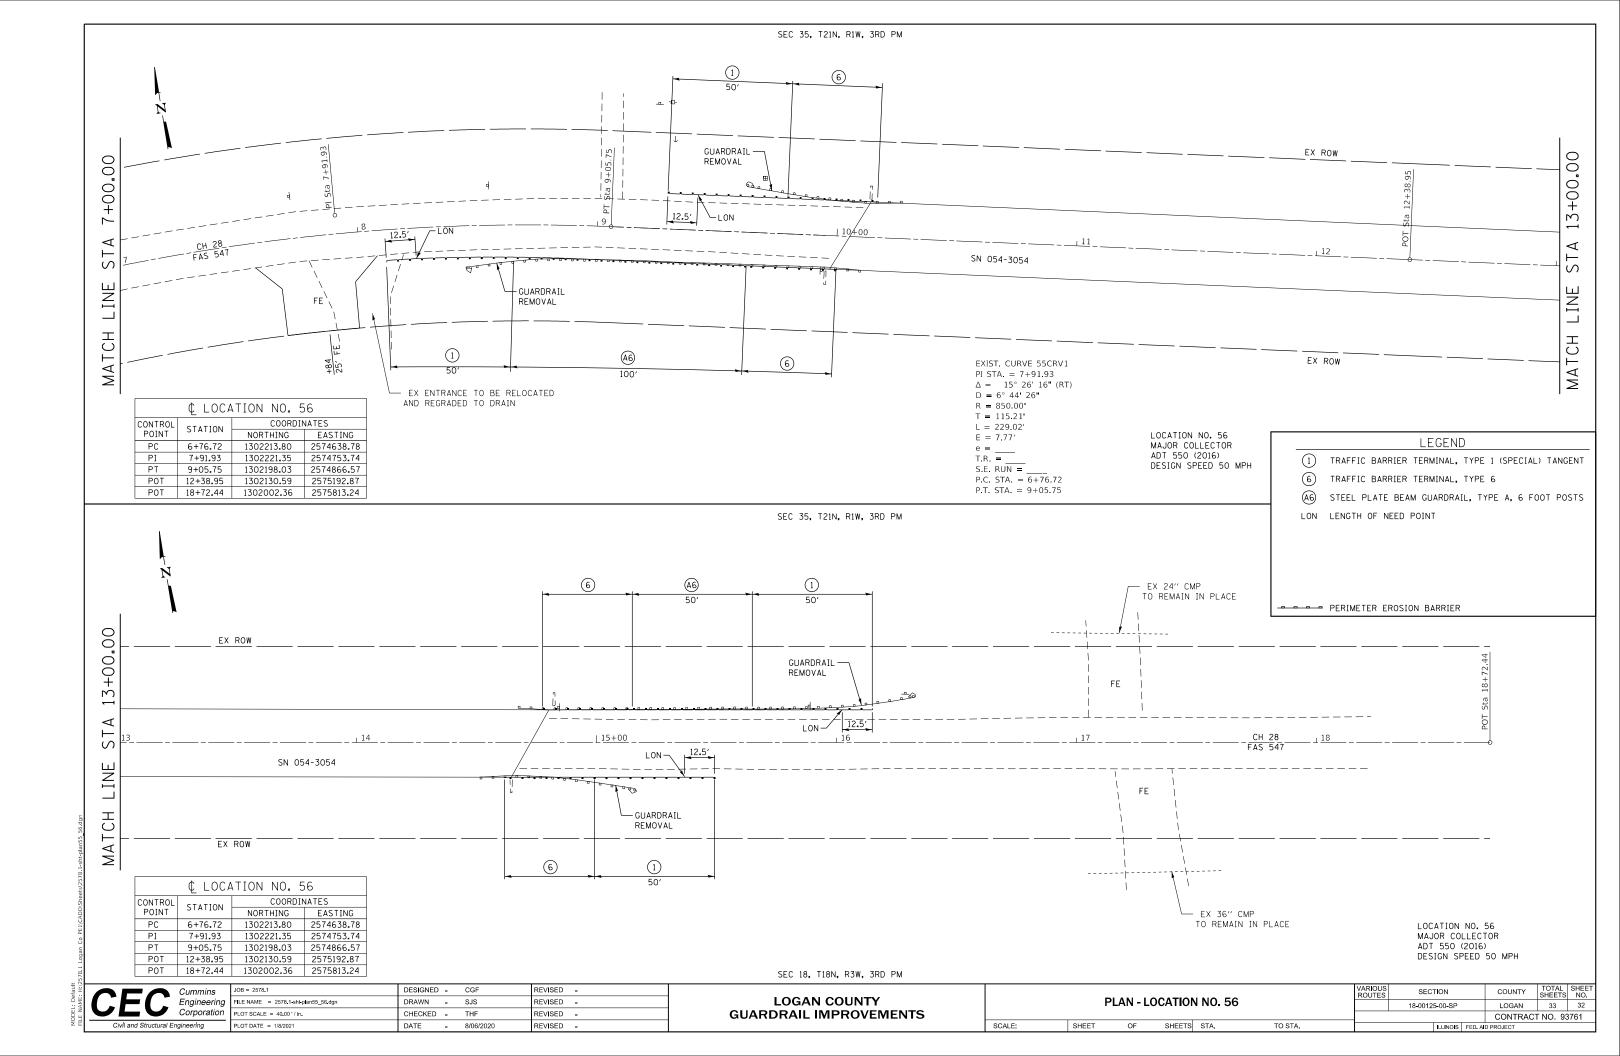

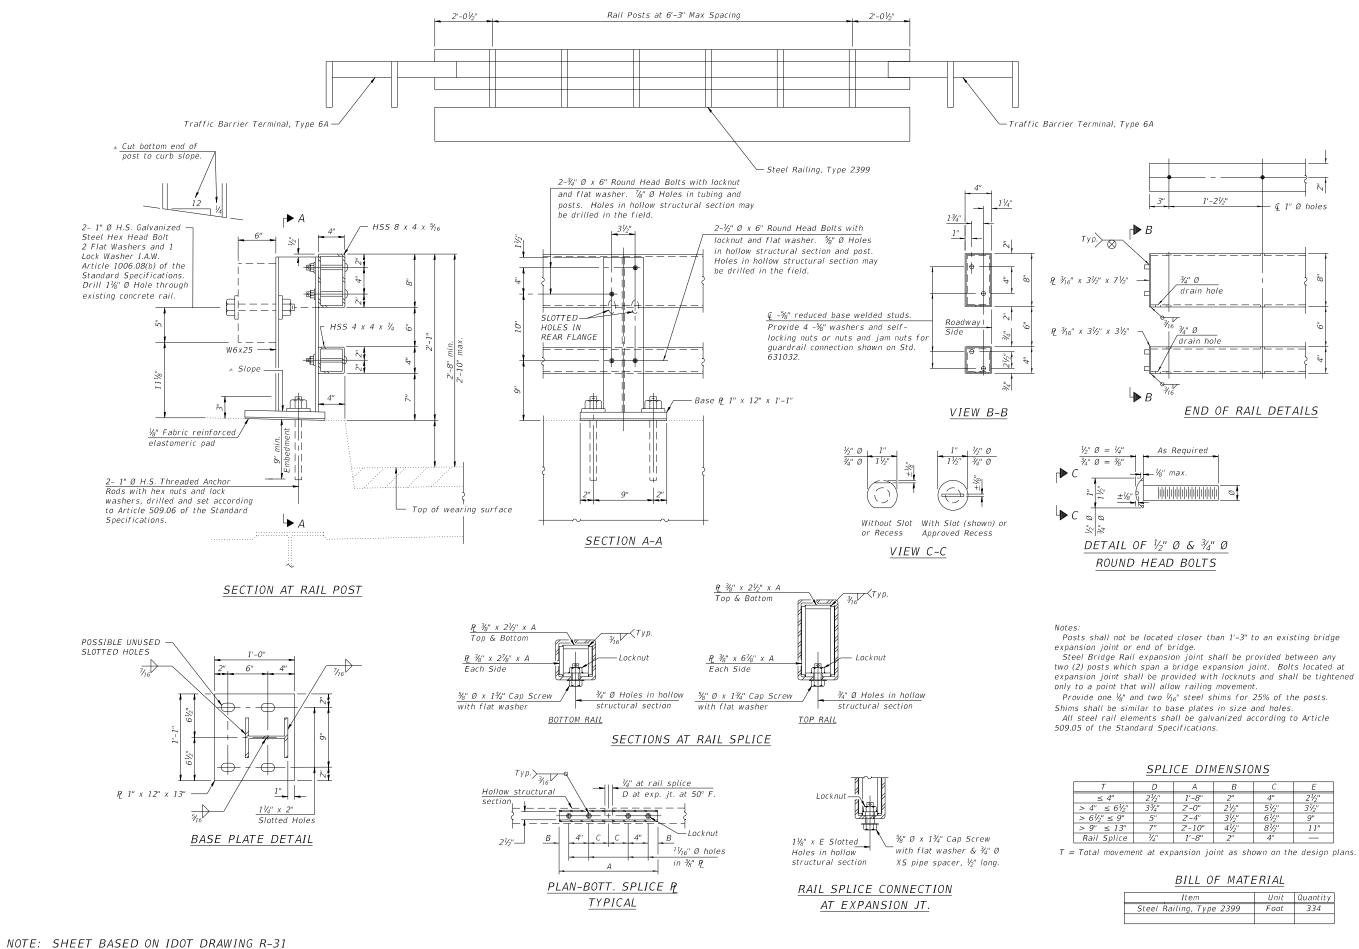

Cummins	JOB = 2578.1	DESIGNED - CGF	REVISED -			STEEL RAILING, TYPE 2399		SECTION	COUNTY TOTAL SHEET
	FILE NAME = 2578.1-Steel_Railing_2399.dgn	DRAWN - CGF	REVISED -	LOGAN COUNTY				18-00125-00-SP	LOGAN 33 33
	PLOT SCALE = 40:0.000 ':' / in.	CHECKED - THF	REVISED -	GUARDRAIL IMPROVEMENTS	LOCATION NO. 3 & LOCATION NO. 11		_		CONTRACT NO. 93761
Civil and Structural Engineering	PLOT DATE = 1/8/2021	DATE - 10/12/2020	REVISED -		SCALE:	SHEET NO. OF SHEETS STA. TO STA.	FED. ROAD DI	IST. NO. ILLINOIS FED. A	ID PROJECT

Т	D	А	В	С	E
≤ 4"	2 ¹ / ₂ "	1'-8"	2"	4"	2½"
$4'' \leq 6^{1/2''}$	3¾"	2'-0"	21/2"	5½"	31/2"
$6\frac{1}{2}" \le 9"$	5"	2'-4"	31/2"	6½"	9"
9″ ≤ 13″	7"	2'-10"	4½"	8½"	11"
ail Splice	1/."	1'-8"	2"	4"	

Item	Unit	Quantity
Steel Railing, Type 2399	Foot	334