



GRAPHIC SCALE

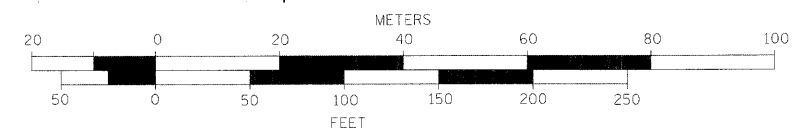

LEGEND:

- CULVERT INLET PROTECTION - STONE
- INLET AND PIPE PROTECTION
- TEMPORARY DITCH CHECK, ROLLED EXCELSIOR
- ROCK CHECK DAM - RIPRAP
- INLET FILTERS
- SEDIMENT CONTROL, SILT FENCE
- EROSION CONTROL BLANKET (SPECIAL 1)
- EROSION CONTROL BLANKET (SPECIAL 2)
- EROSION CONTROL BLANKET (SPECIAL 3)
- HEAVY DUTY EROSION CONTROL BLANKET, SPECIAL
- MULCH, METHOD 2
- FLOCCULATION LOG

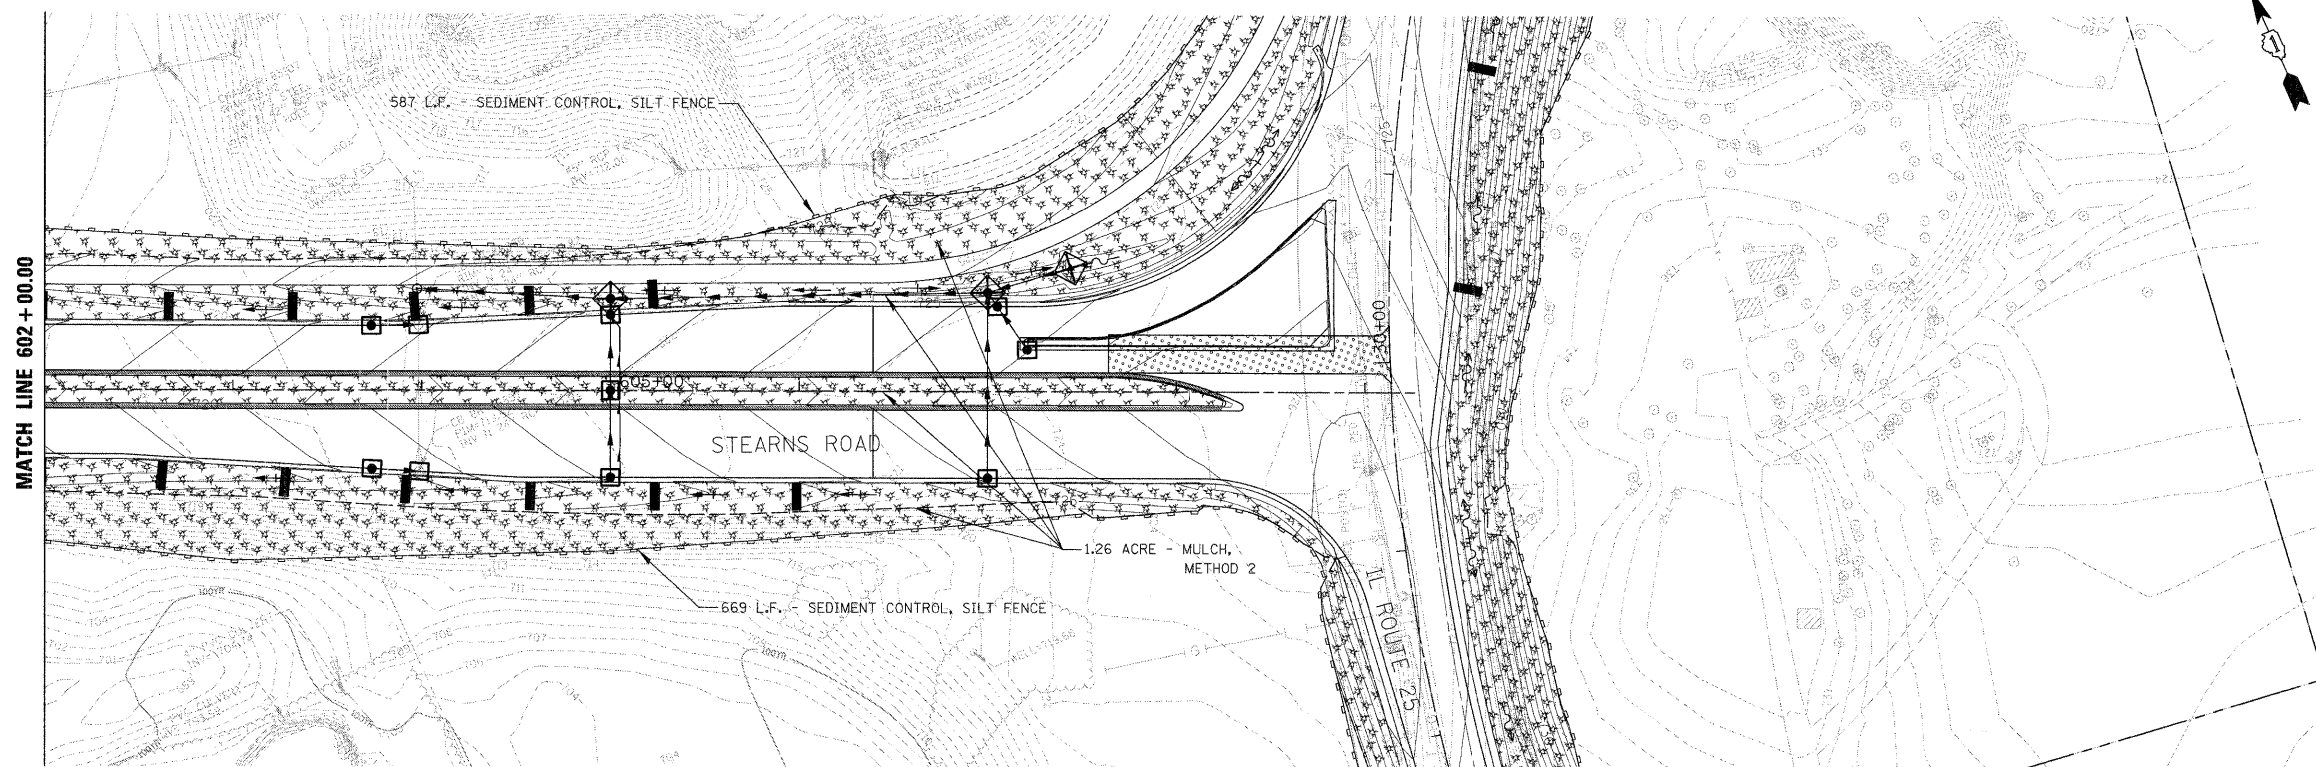

FILE NAME =  
ECP\_070793\_04.SHT

USER NAME = dvrmond

DESIGNED - MSK  
DRAWN - DJV

REVISOR -  
REVISOR -  
REVISOR -  
REVISOR -

PLOT SCALE = 50'  
PLOT DATE = 1/14/2009

CHECKED - JWV  
DATE - 1/16/09

**STATE OF ILLINOIS  
DEPARTMENT OF TRANSPORTATION**

**STEARNS ROAD  
EROSION AND SEDIMENT CONTROL PLAN**

SCALE: 1"= 50' SHEET NO. 4 OF 7 SHEETS STA. 590+00.00 TO STA. 609+26.95

F.A.P. RTE.	SECTION	COUNTY	TOTAL SHEETS	SHEET NO.
361	06-00214-20-BR	KANE	320	55
CONTRACT NO.				

FED. ROAD DIST. NO. 1 ILLINOIS FED. AID PROJECT