INDEX OF SHEETS

- COVER SHEET, INDEX OF SHEETS, LOCATION MAP INDEX OF STATE STANDARDS
- 2. SUMMARY OF QUANTITIES & GENERAL NOTES
- 3. TYPICAL CROSS SECTION
- 4-5. PAVEMENT PLAN
- 6-7. STRIPING PLAN

000001-05

8.-10. DISTRICT ONE STANDARD DETAILS

STATE OF ILLINOIS DEPARTMENT OF TRANSPORTATION DIVISION OF HIGHWAYS

PLANS FOR PROPOSED FEDERAL AID HIGHWAY

FAU 1583 / 115TH STREET
HARLEM AVENUE TO RIDGELAND AVENUE
LOCAL AGENCY PAVEMENT PRESERVATION

STREET RESURFACING

PROJECT: M-9003(124)

SECTION NO.: 08-00056-00-RS

JOB NO.: C-91-140-09
VILLAGE OF WORTH

COOK COUNTY

HIGHWAY STANDARDS STANDARD STANDARDS, ABBREVIATIONS AND PATTERNS TEMPORARY EROSION CONTROL SYSTEMS

280001-04 TEMPORARY EROSION CONTROL SYSTE 424001-05 CURB RAMPS FOR SIDEWALK

442201-03 CLASS C AND D PATCHES 604001-03 FRAME AND LIDS, TYPE 1


606001-04 CONCRETE CURB TYPE B AND COMBINATION CONCRETE CURB & GUTTER

701501-05 URBAN LANE CLOSURE 2-L, 2-W, UNDIVIDED
701606.06 URBAN LANE CLOSURE, MULTILANE, 2W WITH MOUNTABLE MEDIAN

701701-06 URBAN LANE CLOSURE, MULTILANE INTERSECTION
701801-04 LANE CLOSURE, MULTILANE, 1W OR 2W, CROSSWALK
OR SIDEWALK CLOSURE.

701901-01 TRAFFIC CONTROL DEVICES
780001-02 TYPICAL PAVEMENT MARKINGS


PLAN - 1"=50'
PROFILE HORIZ. - 1"=50'
PROFILE VERT. - 1"=5'
CROSS SECTIONS - 1"=10'

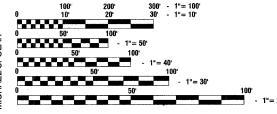

FULL SIZE PLANS HAVE BEEN PREPARED USING STANDARD ENGINEERING SCALES, REDUCED SIZED PLANS WILL NOT CONFORM TO STANDARD SCALES, IN MAKING MEASUREMENTS ON REDUCED PLANS, THE ABOVE SCALES MAY BE USED.

J. U. L. I. E. Joint Utility Location information for excavation 1 - 800 - 892 - 0123 or 811


CONTRACT NO. 63116

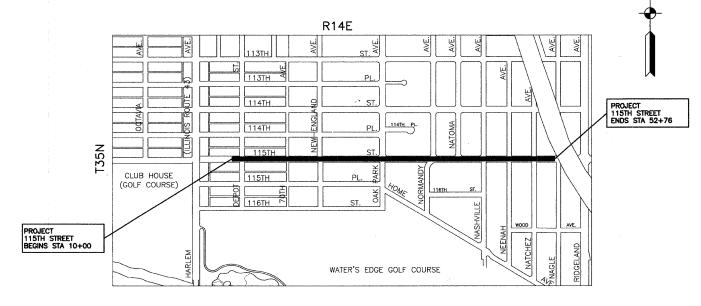


LOCATION MAP


INDICATES PROPOSED IMPROVEMENT

GROSS LENGTH= 4,276 FEET = 0.81 MILES NET LENGTH= 4,276 FEET = 0.81 MILES 115TH STREET COLLECTOR
ADT=5,500 (2008)
=5,500 (2030)
DESIGN SPEED=35 MPH
SPEED LIMIT= 35 MPH

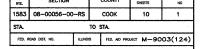


CONTRACT #63116

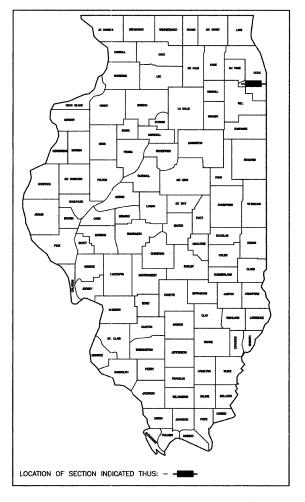

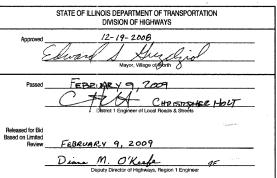

PRINTED BY THE AUTHORITY OF THE STATE OF ILLINOIS

PREPARED BY OR UNDER THE DIRECT SUPERVISION OF:

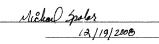




UCENSE EXPIRES: 11/30/09

		SUMMARY OF QUANTITIES	. ,		PAVEMENT MARKINGS SIGNS LANDSCAPE LIGHTS SIGNALS						TRAINING
61	CODE NO.	PAY ITEM	UNIT	QUAN	1000	L 0==1/45		NSTRUCTION		V0.74	T V000
3.1.	CODE NO.		-	QUAIT	1000	SFTY-1D	Y002-1C	Y003	Y030-1E	Y031	Y080
	40600100	BITUMINOUS MATERIALS (PRIME COAT)	GALLON	1889	1889						
	40600300	AGGREGATE (PRIME COAT)	TON	38	38						
ļ	40600895	CONSTRUCTING TEST STRIP	EACH	2	2						
	40600982	HOT-MIX ASPHALT SURFACE REMOVAL - BUTT JOINT	SQ YD	820	820						
	40603335	HOT-MIX ASPHALT SURFACE COURSE, MIX "D", N50	TON	1635	1635						
	42300300	PORTLAND CEMENT CONCRETE DRIVEWAY PAVEMENT, 7 INCH	SQ YD	100	100						
	42400200	PORTLAND CEMENT CONCRETE SIDEWALK 5 INCH	SQ FT	591	591						
	42400800	DETECTABLE WARNINGS	SQ FT	450	450						
	44000157	HOT-MIX ASPHALT SURFACE REMOVAL, 2"	SQ YD	18074	18074						
	44000200	DRIVEWAY PAVEMENT REMOVAL	SQ YD	200	200						
	44000600	SIDEWALK REMOVAL	SQ FT	591	591						
L	44001700	COMBINATION CONCRETE CURB AND GUTTER REMOVAL AND REPLACEMENT	FOOT	522	522						
	44201753	CLASS D PATCHES, TYPE II, 9 INCH	SQ YD	86	86						
	44201757	CLASS D PATCHES, TYPE III, 9 INCH	SQ YD	292	292						
	44201759	CLASS D PATCHES, TYPE IV, 9 INCH	SQ YD	393	393						
	60250200	CATCH BASINS TO BE ADJUSTED	EACH	5	5						
l	60252800	CATCH BASINS TO BE RECONSTRUCTED	EACH	2	2						
	60255500	MANHOLES TO BE ADJUSTED	EACH	10	10						
	60257900	MANHOLES TO BE RECONSTRUCTED	EACH	2	2						
	60266600	VALVE BOXES TO BE ADJUSTED	EACH	2	2						
	60406100	FRAMES AND LIDS, TYPE 1, CLOSED LID	EACH	2	2						
	67100100	MOBILIZATION	L SUM	1	1						
	70102620	TRAFFIC CONTROL AND PROTECTION, STANDARD 701501	L SUM	1	1						
	70102625	TRAFFIC CONTROL AND PROTECTION, STANDARD 701606	L SUM	1	1						
	70102635	TRAFFIC CONTROL AND PROTECTION, STANDARD 701701	L SUM	1	1						
	70102640	TRAFFIC CONTROL AND PROTECTION, STANDARD 701801	L SUM	1	1						
	70300100	SHORT-TERM PAVEMENT MARKING	FOOT	1000		1000					
*	78000200	THERMOPLASTIC PAVEMENT MARKING LINE 4"	FOOT	8688		8688					
*	78000400	THERMOPLASTIC PAVEMENT MARKING - LINE 6"	FOOT	636		636				_	
*	78000600	THERMOPLASTIC PAVEMENT MARKING - LINE 12"	FOOT	704		704					
*	78000650	THERMOPLASTIC PAVEMENT MARKING - LINE 24"	FOOT	783	L	783	National Control of the Control of t				
	X4067107	POLYMERIZED LEVELING BINDER (MACHINE \METHOD), IL-4.75, N50	TON	794		794					
	XX006806	HOT-MIX ASPHALT DRIVEWAY PAVEMENT	SQ YD	200	200					.	
].							<u> </u>
1											

* - INDICATES SPECIALTY ITEMS

GENERAL NOTES:

- 1. BEFORE STARTING ANY EXCAVATION, THE CONTRACTOR SHALL CALL "J.U.L.I.E." AT (800) 892-0123 AT (312) 744-7000 FOR FIELD LOCATIONS OF BURIED ELECTRIC, TELEPHONE AND GAS UTILITIES. (48 HOUR NOTIFICATION IS REQUIRED).
- UTILITIES INDICATED ON THE PLANS ARE PROVIDED FOR THE CONTRACTORS USE AND ARE BASED UPON INFORMATION AVAILABLE AT THE TIME OF THE ADVERTISEMENT FOR BIDS. THE OWNER AND ENGINEER DO NOT GUARANTEE THE ACCURACY OF UTILITIES INFORMATION.
- IT SHALL BE THE CONTRACTOR'S RESPONSIBILITY TO VERIFY ALL DIMENSIONS AND CONDITIONS EXISTING IN THE FIELD PRIOR TO CONSTRUCTION AND ORDERING OF MATERIALS.
- 4. SCHEDULES INCLUDED IN THE PLANS HAVE BEEN PREPARED FROM FIELD NOTES. EXACT LOCATIONS FOR PATCHING SHALL BE DETERMINED IN THE FIELD BY THE ENGINEER.
- ANY REFERENCE TO STANDARDS THROUGHOUT THE PLANS OR SPECIAL PROVISIONS SHALL BE INTERPRETED TO BE THE LATEST STANDARDS OF THE ILLINOIS DEPARTMENT OF TRANSPORTATION.
- 6. THE NOMINAL THICKNESS OF HOT—MIX ASPHALT MIXTURE STATED IN THE SPECIFICATIONS IS THE NOMINAL THICKNESS. DEVIATIONS FROM THE NOMINAL THICKNESS WILL BE PERMITTED WHEN SUCH DEVIATIONS OCCUR DUE TO IRREGULARITIES IN THE EXISTING SURFACE OR BASE ON WHICH THE HOT—MIX ASPHALT SURFACE IS PLACED.

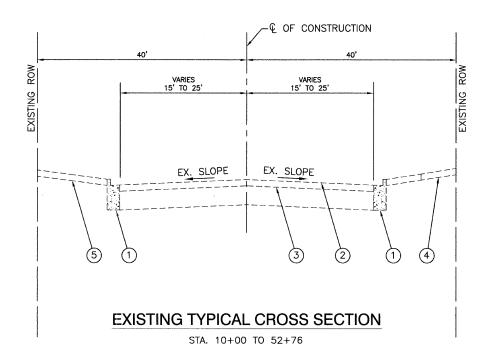

- EXISTING CURB & GUTTER TO BE REMOVED AT LOCATIONS AS SHOWN ON PLANS OR DIRECTED BY ENGINEER
- HOT-MIX ASPHALT SURFACE REMOVAL, 2"
- EXISTING BITUMINOUS BASE COURSE TO REMAIN, ±10"
- EXISTING P.C. CONCRETE SIDEWALK TO BE REMOVED AT LOCATIONS AS SHOWN ON PLANS OR DIRECTED BY ENGINEER
- EXISTING DRIVEWAY PAVEMENT TO BE REMOVED AT LOCATIONS AS SHOWN ON PLANS OR DIRECTED BY ENGINEER
- HOT-MIX ASPHALT SURFACE COURSE, MIX D, N50 1½"
- COMBINATION CONCRETE CURB & GUTTER, B6.12 AT LOCATIONS AS SHOWN ON PLANS OR DIRECTED BY ENGINEER
- POLYMERIZED LEVELING BINDER (MACHINE METHOD), IL-4.75, N50, 3/4"
- PORTLAND CEMENT CONCRETE SIDEWALK, 5 INCH AT LOCATIONS SHOWN ON PLANS OR DIRECTED BY ENGINEER
- PORTLAND CEMENT CONCRETE DRIVEWAY PAVEMENT AT LOCATIONS SHOWN ON PLANS OR DIRECTED BY ENGINEER
- HOT-MIX ASPHALT SURFACE COURSE, MIX "C", N50, 2"
- HOT-MIX ASPHALT BASE COURSE, 6"

CHECKED — PKB

CHECKED - MJD

HOT-MIX ASPHALT MIXTURE REQUIREMENTS

MIXTURE TYPE	AC TYPE	AIR VOIDS
RESURFACING		
HOT-MIX ASPHALT SURFACE COURSE, MIX "D", N50(IL-9.5mm); 1 1/2"	PG 64-22	4% © 50 Gyr.
POLYMERIZED LEVELING BINDER (MACHINE METHOD), IL-4.75, N50, 3/4"	SBS/SBR PG 76-28 *	4% © 50 Gyr.
DRIVEWAYS		
HOT MIX ASPHALT SURFACE COURSE, MIX "C", N50(IL-9.5mm); 2"	PG 64-22	4% © 50 Gyr.
HOT MIX ASPHALT BASE COURSE, (HMA BINDER IL-19.0mm); 6"	PG 64-22 *	4% © 50 Gyr.
PATCHING		
CLASS D PATCHES, TYPE II, III, IV, (HMA BINDER IL-19.0mm); 9"	PG 64-22 *	4% © 70 Gyr.

USER NAME =

PLOT SCALE = NONE PLOT DATE = 12/18/08

FILE NAME = 08478-TYPX-01 - P01

NOTE:

1. THE UNIT WEIGHT USED TO CALCULATE ALL HOT-MIX ASPHALT SURFACE MIXTURE QUANTITIES IS 112 LBS/SY/IN.

2. *WHEN RAP EXCEEDS 20%, THE NEW ASPHALT BINDER IN THE MIX SHALL BE PG 58-22.

REVISED

DESIGNED — MRS REVISED —

'
 STATE OF ILLINOIS
DEPARTMENT OF TRANSPORTATION


-				PICAL (EET RES CROSS S RTH, ILLII	ECTIO		
	SCALE:	NONE	SHEET NO. 3	OF 10	SHEETS	STA.	 TO STA.	


F.A. RTE.	SECT	TION		COUNTY	TOTAL SHEETS	SHEET NO.
1583	08-0005	6-00-RS		соок	10	3
				CONTRACT	VO. 6311	16
FED. RO.	AD DIST. NO. 1	ILLINOIS	FED. A	D PROJECT M-900	3(124)	


1			€ OF CON	STRUCTION		l
	•	40'		40'		
NG ROW		VARIES 15' TO 25'	VARIES 15' TO 2	5'	VARIES	NG ROW
EXISTING			 			EXISTING
		2%	_2%			
	9	(7) 	8	6	⑦ ⑪ ⑫	
	PF	STA. 10+00		SECTIO	<u>N</u>	

~€ OF CONSTRUCTION 2% PROPOSED TYPICAL CROSS SECTION

STA. 10+00 TO 52+76

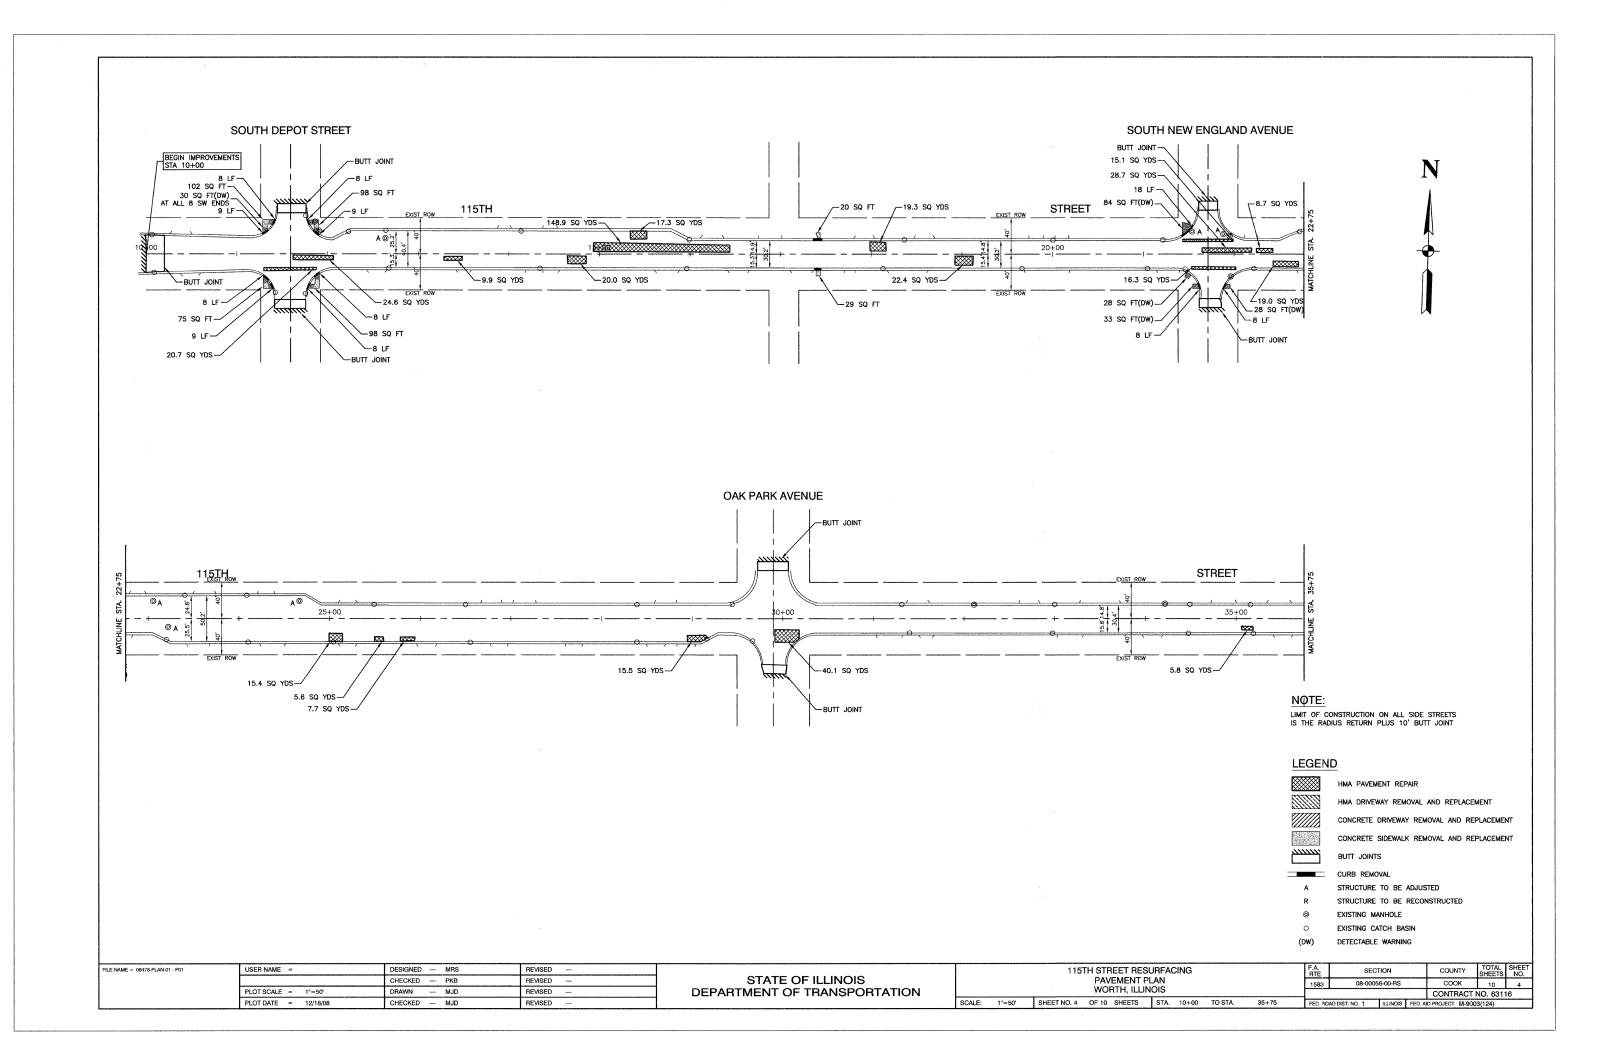

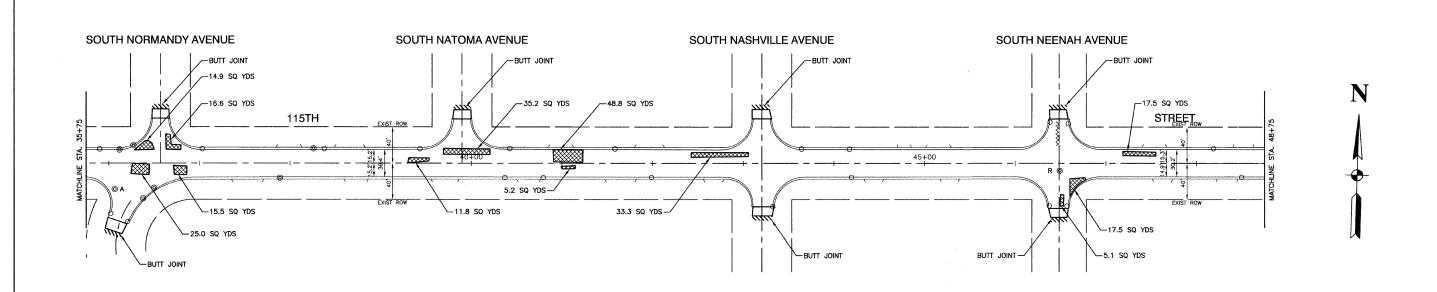

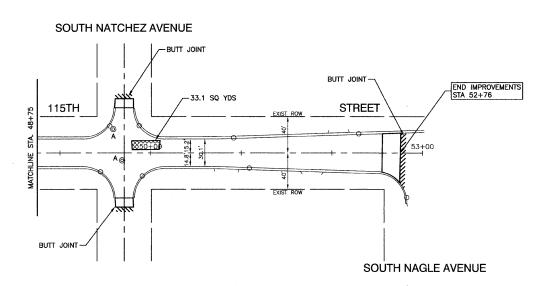

NOTE:

LIMIT OF CONSTRUCTION ON ALL SIDE STREETS IS THE RADIUS RETURN PLUS 10' BUTT JOINT

LEGEND

AMH

HMA PAVEMENT REPAIR

HMA DRIVEWAY REMOVAL AND REPLACEMENT

CONCRETE DRIVEWAY REMOVAL AND REPLACEMENT

CONCRETE SIDEWALK REMOVAL AND REPLACEMENT

BUTT JOINTS

CURB REMOVAL

STRUCTURE TO BE ADJUSTED


STRUCTURE TO BE RECONSTRUCTED


EXISTING MANHOLE


EXISTING CATCH BAS

DETECTABLE WARNING

FILE NAME = 08478-PLAN-01 - P02	USER NAME =	DESIGNED MRS	REVISED —		115TH STREET RESURFACING	F.A.	SECTION	COUNTY	TOTAL	SHEET
		CHECKED PKB	REVISED —	STATE OF ILLINOIS	PAVEMENT PLAN	1583	08-00056-00-RS	COOK	10	
	PLOT SCALE = 1"=50'	DRAWN MJD	REVISED	DEPARTMENT OF TRANSPORTATION	WORTH, ILLINOIS			CONTRACT	NO. 6311	6
	PLOT DATE = 12/18/08	CHECKED MJD	REVISED —		SCALE: 1"=50' SHEET NO. 5 OF 10 SHEETS STA. 35+75 TO STA. 52+76	FED. ROAD	AD DIST. NO. 1 ILLINOIS FED. AIL	D PROJECT M-900:	03(124)	

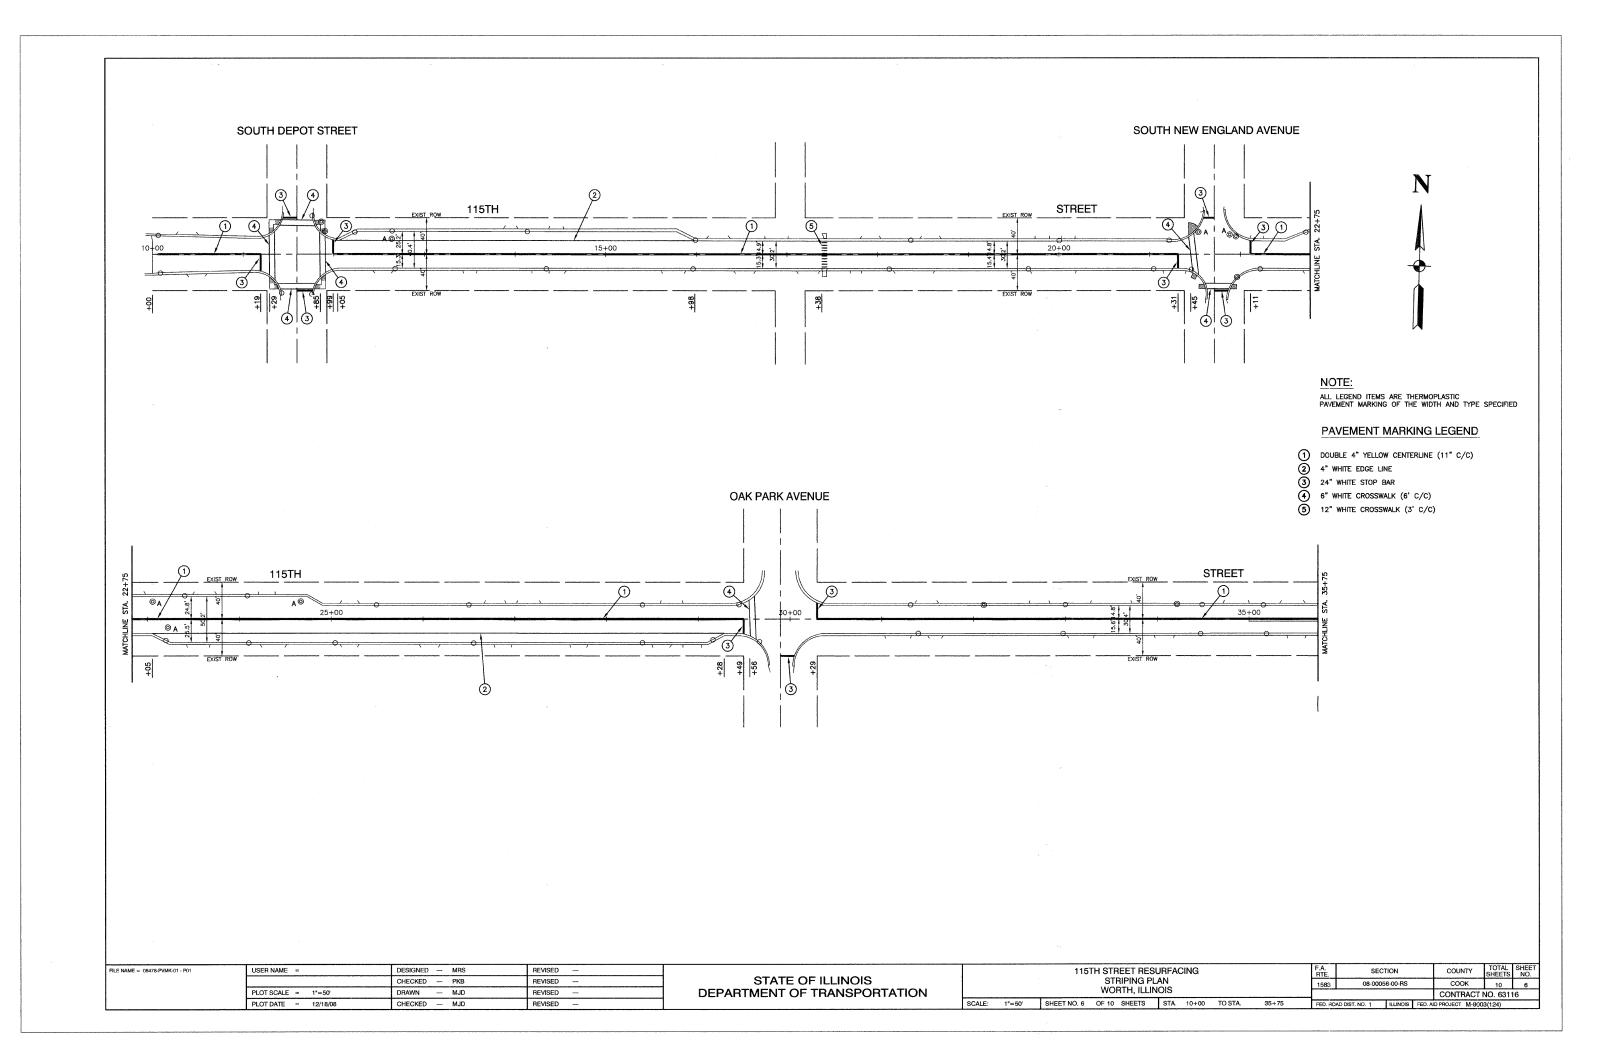

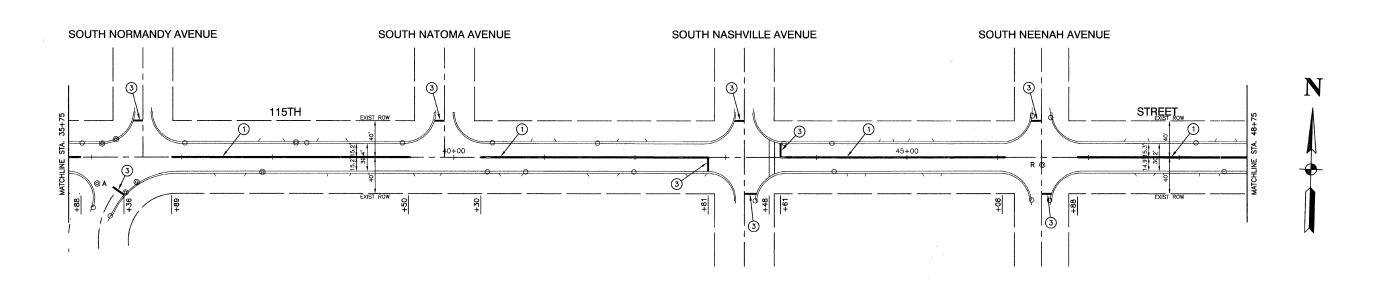

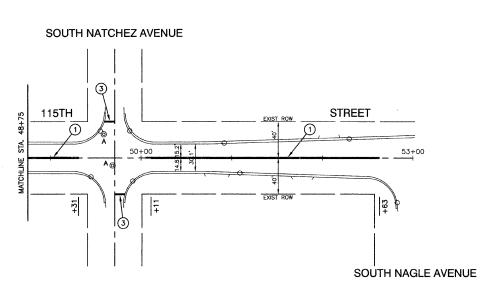

NOTE:


ALL LEGEND ITEMS ARE THERMOPLASTIC PAVEMENT MARKING OF THE WIDTH AND TYPE SPECIFIED

PAVEMENT MARKING LEGEND


- 1 DOUBLE 4" YELLOW CENTERLINE (11" C/C)

- 2 4" WHITE EDGE LINE
 3 24" WHITE STOP BAR
 6" WHITE CROSSWALK (6' C/C)
 5 12" WHITE CROSSWALK (3' C/C)

FILE NAME = 08478-PVMK-01 - P02	USER NAME =	DESIGNED MRS	REVISED —		115TH STREET RESURFACING	F.A. S	SECTION	COUNTY	TOTAL	SHEET
		CHECKED — PKB	REVISED —	STATE OF ILLINOIS	STRIPING PLAN	1583 08-0	00056-00-RS	соок	10	7
	PLOT SCALE = 1"=50"	DRAWN — MJD	REVISED —	DEPARTMENT OF TRANSPORTATION	WORTH, ILLINOIS	1.000			IO. 6311	
	PLOT DATE = 12/18/08	CHECKED MJD	REVISED —		SCALE: 1"=50' SHEET NO. 7 OF 10 SHEETS STA. 35+75 TO STA. 52+76	FED. ROAD DIST. NO. 1	ILLINOIS FED. AID	PROJECT M-9003	3(124)	

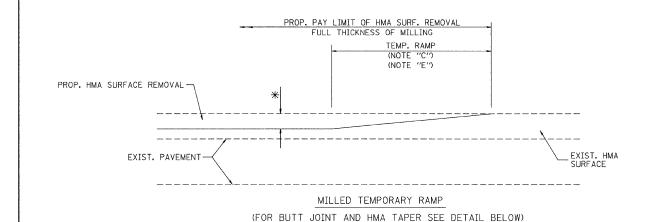


OPTION 1

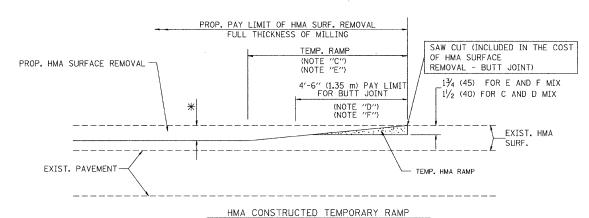

(FOR BUTT JOINT AND HMA TAPER SEE DETAIL BELOW)

OPTION 2

TYPICAL TEMPORARY RAMP

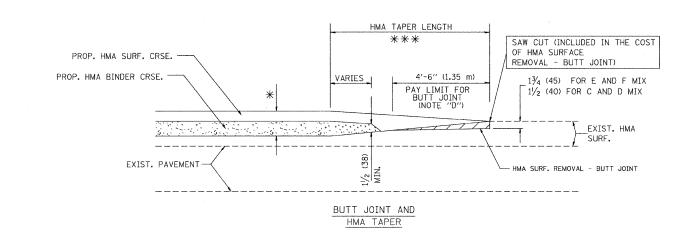


TYPICAL BUTT JOINT AND HMA TAPER FOR MILLING AND RESURFACING

EXIST. HMA OR PCC SURFACE

SURFACE REMOVAL - BUTT JOINT
30'-0" (9.0 m) (NOTE "A")
15'-0" (4.5 m) (NOTE "B")
(NOTE "D")

** * EXIST. PAVEMENT

BUTT JOINT DETAIL

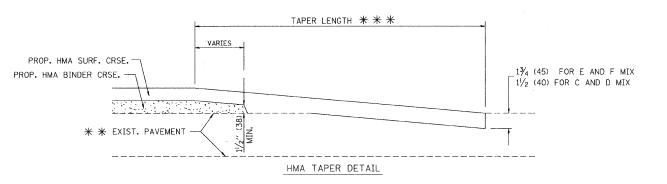

TYPICAL BUTT JOINT AND HMA TAPER FOR RESURFACING ONLY

* * PC CONCRETE, HMA OR HMA RESURFACED PAVEMENT.

NOTES


- A: MAINLINE ROADWAYS AND MAJOR SIDE ROADS.
- B: MINOR SIDE ROADS.
- C: THE TEMP. RAMP SHALL BE CONSTRUCTED IMMEDIATELY UPON REMOVAL OF THE EXISTING HMA SURFACE.
- D: THE BUTT JOINT SHALL BE CONSTRUCTED IMMEDIATELY PRIOR TO PLACING THE PROPOSED HMA COURSES.
- E: TAPER THE TEMP. RAMP AT A RATE OF 3'-0" (900 mm) PER 1 INCH (25 mm) OF MILLING THICKNESS.
- F: INSTALLATION AND REMOVAL OF THE 4'-6" (1.35 m) TEMP. RAMP IS INCLUDED IN COST OF HMA SURFACE REMOVAL BUTT JOINT
- G: SEE ARTICLE 406.08 AND 406.14 OF THE STANDARD SPECIFICATIONS FOR "HMA AND/OR PCC SURFACE REMOVAL, BUTT JOINT".
- * SEE TYPICAL SECTIONS FOR MILLING THICKNESS.
- * * * 20'-0" (6.1 m) PER 1 (25) RESURFACING (NOTE "A') 10'-0" (3.0 m) PER 1 (25) RESURFACING (NOTE "B")


BASIS OF PAYMENT:

THE BUTT JOINT WILL BE PAID FOR AT THE CONTRACT UNIT PRICE PER SQUARE YARD (SQUARE METER) FOR "HOT-MIX ASPHALT SURFACE REMOVAL - BUTT JOINT" OR FOR "PORTLAND CEMENT CONCRETE SURFACE REMOVAL- BUTT JOINT".

ALL DIMENSIONS ARE IN INCHES (MILLIMETERS) UNLESS OTHERWISE SHOWN.

FILE NAME = DESIGNED - M. DE YONG REVISED - R. SHAH 10-25-94 DISTRICT ONE STATE OF ILLINOIS DRAWN -REVISED - A. ABBAS 03-21-97 **BUTT JOINT AND** W:\diststd\22x34\bd32.dgn 08-00056-00-BS COOK 10 8 **DEPARTMENT OF TRANSPORTATION** HMA TAPER DETAILS PLOT SCALE = 50.0000 '/ IN. CHECKED REVISED - M. GOMEZ 04-06-01 BD400-05 BD32 CONTRACT NO. 63116 SCALE: NONE SHEET NO. 8 OF 10 SHEETS STA. PLOT DATE = 1/4/2008 DATE - 06-13-90 REVISED - R. BORO 01-01-07 FED. ROAD DIST. NO. 1 ILLINOIS FED. AID PROJECT M-9003(124)

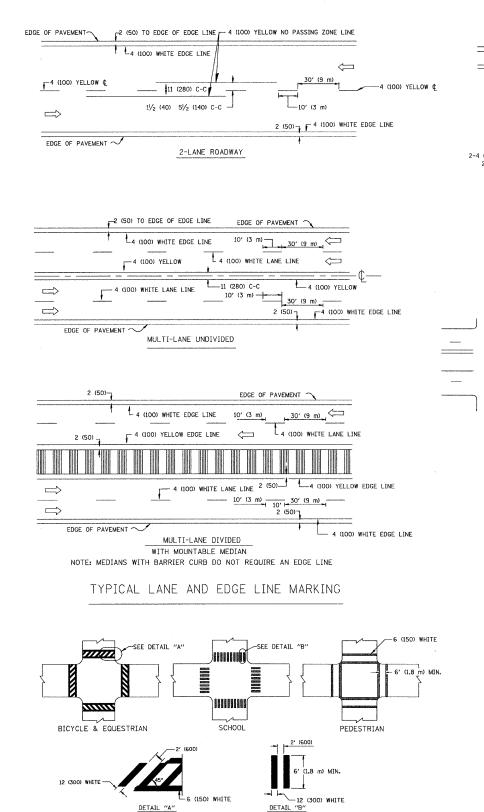

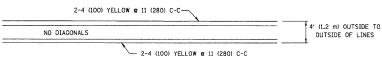


2-4 (100) @ 11 (280) C-C 2-4 (100) @ 11 (280) C-C MINIMUM 5) MEDIAN LENGTH FOR MEDIAN LENGTHS WHERE DIAGONAL SPACING CANNOT BE ATTAINED, USE 5 (FIVE) EQUALLY SPACED DIAGONAL LINES.


4' (1.2 m) WIDE MEDIANS ONLY

DIAGONAL LINE SPACING: 50' (15 m) C-C (LESS THAN 30MPH (50 km/h))
75' (25 m) C-C 30MPH (50 km/h) TO 45MPH (70 km/h))
150' (45 m) C-C (MORE THAN 45MPH (70 km/h))

MEDIANS OVER 4' (1.2 m) WIDE

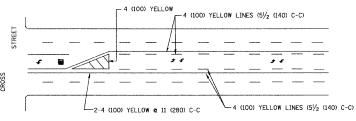


A MINIMUM OF TWO PAIRS OF TURN ARROWS SHALL BE USED, WHITE IN COLOR. ADDITIONAL PAIRS SHALL BE PLACED AT 200' (60 m) TO 300' (90 m) INTERVALS.

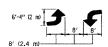

MEDIAN WITH TWO-WAY LEFT TURN LANE

TYPICAL PAINTED MEDIAN MARKING

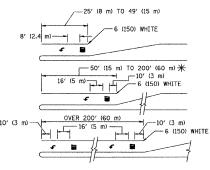


FULL SIZE LETTERS 8' (2.4 m) AND ARROWS SHALL BE USED. \P AREA = 15.6 SO. FT. (1.5 m²) \P AREA = 20.8 SO. FT. (1.9 m²)

* TURN LANES IN EXCESS OF 400' (120 m) IN LENGTH MAY HAVE AN ADDITIONAL SET OF ARROW - "ONLY" INSTALLED MIDWAY BETWEEN THE OTHER TWO SETS OF ARROW - "ONLY".

TYPICAL LEFT (OR RIGHT) TURN LANE

TYPICAL TURN LANE MARKING

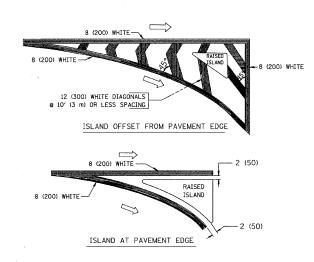

TYPICAL ISLAND MARKING

	1		1	
TYPE OF MARKING	WIDTH OF LINE	PATTERN	COLOR	SPACING / REMARKS
CENTERLINE ON 2 LANE PAVEMENT	4 (100)	SKIP-DASH	YELLOW	10' (3 m) LINE WITH 30' (9 m) SPACE
CENTERLINE ON MULTI-LANE UNDIVEDED PAVEMENT	2 @ 4 (100)	SOLID	YELLOW	11 (280) C-C
NO PASSING ZONE LINES: FOR ONE DIRECTION FOR BOTH DIRECTIONS	4 (100) 2 e 4 (100)	SOLID SOLID	YELLOW YELLOW	5½ (140) C-C FROM SKIP-DASH CENTERLINE 11 (280) C-C OMIT SKIP-DASH CENTERLINE BETWEEN
LANE LINES	4 (100) 5 (125) ON FREEWAYS	SKIP-DASH SKIP-DASH	WHITE WHITE	10' (3 m) LINE WITH 30' (9 m) SPACE
DOTTED LINES (EXTENSIONS OF CENTER, LANE OR TURN LANE MARKINGS)	SAME AS LINE BEING EXTENDED	SKIP-DASH	SAME AS LINE BEING EXTENDED	2' (600) LINE WITH 6' (1.8 m) SPACE
EDGE LINES	4 (100)	SOLID	YELLOW-LEFT WHITE-RIGHT	OUTLINE MOUNTABLE MEDIANS IN YELLOW: EDGE LINES ARE NOT USED NEXT TO BARRIER CURB
TURN LANE MARKINGS	6 (150) LINE; FULL SIZE LETTERS & SYMBOLS (8' (2.4m))	SOLID	WHITE	SEE TYPICAL TURN LANE MARKING DETAIL
TWO WAY LEFT TURN MARKING	2 @ 4 (100) EACH DIRECTION	SKIP-DASH AND SOLID	YELLOW	10' (3 m) LINE WITH 30' (9 m) SPACE FOR SKIP-DASH: 5½ (140) C-C BETWEEN SOLID LINE AND SKIP-DASH LINE
	8' (2.4m) LEFT ARROW	IN PAIRS	WHITE	SEE TYPICAL TWO-WAY LEFT TURN MARKING DETAIL
CROSSWALK LINES (PEDESTRIAN) A. DIAGONALS (BIKE & EQUESTRIAN) B. LONGITUDINAL BARS (SCHOOL)	2 @ 6 (150) 12 (300) @ 45° 12 (300) @ 90°	SOLID SOLID SOLID	WHITE WHITE WHITE	NOT LESS THAN 6' (1.8 m) APART 2' (600) APART 2' (500) APART SEE TYPICAL CROSSWALK MARKING DETAILS.
STOP LINES	24 (600)	SOLID	WHITE	PLACE 4' (1.2 m) IN ADVANCE OF AND PARALLEL TO CROSSMALK, IF PRESENT. OTHERWISE, PLACE AT DESIRED STOPPING POINT. PARALLEL TO CROSSROAD CENTERLINE, WHERE POSSIBLE.
PAINTED MEDIANS	2 @ 4 (100) WITH 12 (300) DIAGONALS @ 45°	SOLID	YELLOW: TWO WAY TRAFFIC	11 (280) C-C FOR THE DOUBLE LINE SEE TYPICAL PAINTED MEDIAN MARKING.
	NO DIAGONALS USED FOR 4' (1.2 m) WIDE MEDIANS		WHITE: ONE WAY TRAFFIC	SEE TIFICAL FAINTED MEDIAN MARKING.
GORE MARKING AND CHANNELIZING LINES	8 (200) WITH 12 (300) DIAGONALS @ 45°	SOLID	WHITE	DIAGONALS: 15' (4.5 m) C-C (LESS THAN 30MPH (50 km/h)) 20' (6 m) C-C 30MPH (50 km/h) TO 45MPH (70 km/h)) 30' (9 m) C-C (OVER 45MPH (70 km/h))
RAILROAD CROSSING	24 (600) TRANSVERSE LINES; "RR" IS 6' (1.8 m) LETTERS; 16 (400) LINE FOR "X"	SOLID	WHITE	SEE STATE STANDARD 780001 AREA OF: "R"=3.6 SQ. FT. (0.33 m²) EACH "X"=54.0 SQ. FT. (5.0 m²)
SHOULDER DIAGONALS	12 (300) c 45°	SOLID	WHITE - RIGHT YELLOW - LEFT	50' (15 m) C-C (LESS THAN 30MPH (50 km/h)) 75' (25 m) C-C (30 MPH (50 km/h) TO 45MPH (70 km/h)) 150' (45 m) C-C (0VER 45MPH (70 km/h))

FOR FURTHER DETAILS ON PAVEMENT MARKING REFER TO STANDARD SPECIFICATIONS FOR ROAD AND BRIDGE CONSTRUCTION AND STATE STANDARD 780001.


All dimensions are in inches (millimeters) unless otherwise shown.

П				
	FILE NAME =	USER NAME = gaglianobt	DESIGNED - EVERS	REVISED -T. RAMMACHER 10-27-94
l	W:\diststd\22x34\tc13.dgn		DRAWN -	REVISED -A. HOUSEH 10-09-96
		PLOT SCALE = 50.000 '/ IN.	CHECKED -	REVISED -A. HOUSEH 10-17-96
		PLOT DATE = 1/4/2008	DATE - 03-19-90	REVISED -T. RAMMACHER 01-06-00

TYPICAL CROSSWALK MARKING

STATE OF ILLINOIS
DEPARTMENT OF TRANSPORTATION

	DIOTRIOT ONE						SECTION	COUNTY	TOTAL SHEETS	SHEET NO.
	TYPICAL PAVEMENT MARKINGS					1583	08-00056-00-RS	COOK	10	9
						TC-13 CONTRACT NO. 6			NO. 6311	6
						FED. ROA	AD DIST. NO. 1 ILLINOIS FED. A	D PROJECT M-900	3(124)	

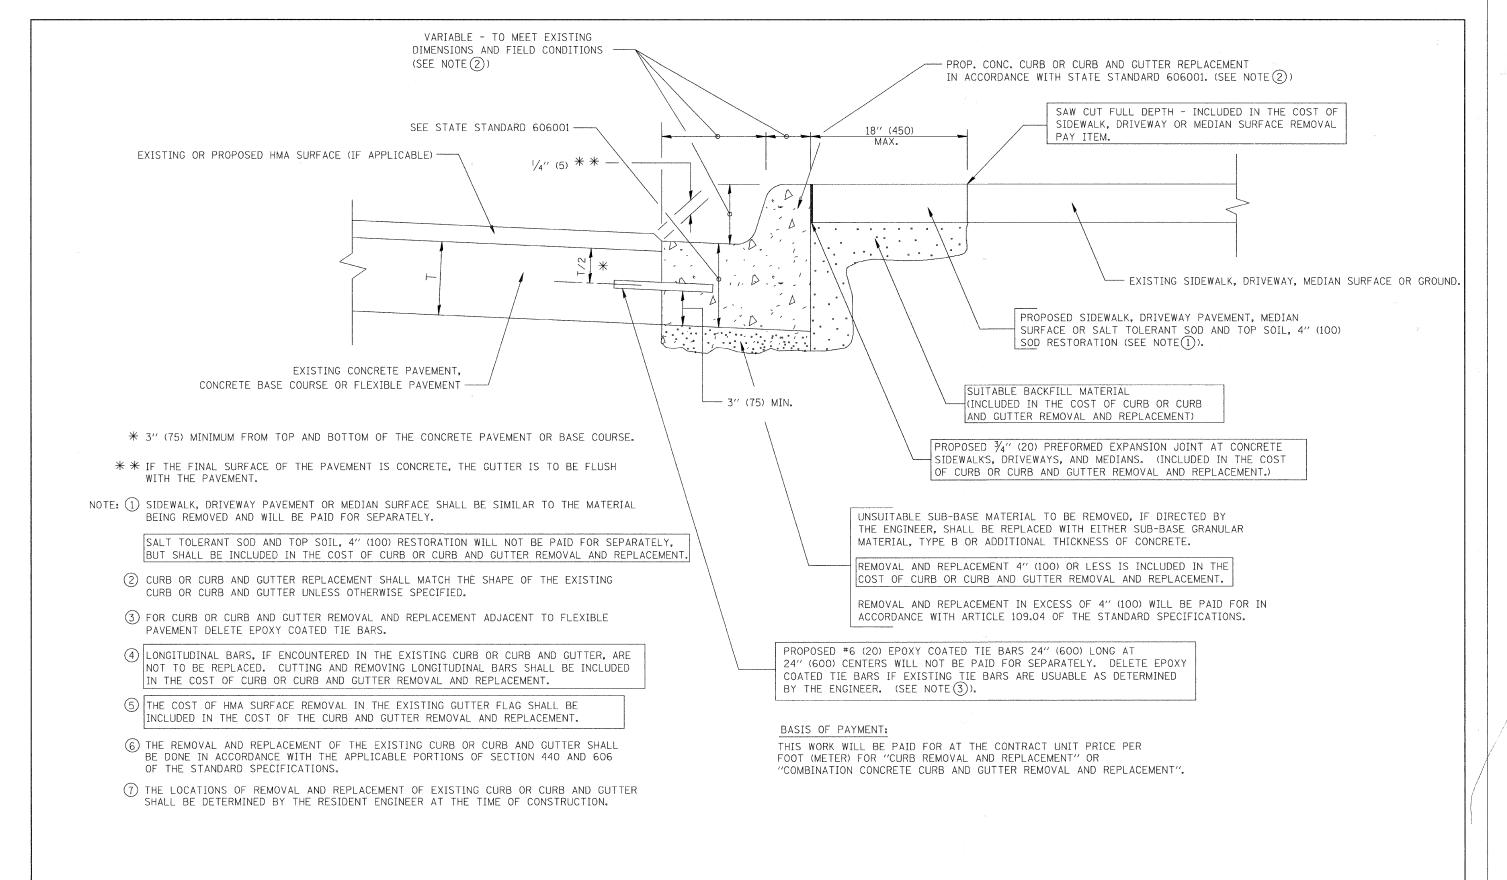

CURB OR CURB AND GUTTER REMOVAL AND REPLACEMENT

ALL DIMENSIONS ARE IN INCHES (MILLIMETERS) UNLESS OTHERWISE SHOWN.

FILE NAME =	USER NAME = gaglianobt	DESIGNED - A. HOUSEH	REVISED - R. SHAH 10	-03-96					SECTION	COUNTY	TOTAL :	HEET NO.
W:\diststd\22x34\bd24.dgn		DRAWN -	REVISED - A. ABBAS C	3-21-97		1	DISTRICT ONE	1583	08-00056-00-RS	соок	10	10
	PLOT SCALE = 50.000 '/ IN.	CHECKED -	REVISED - M. GOMEZ (1-22-01	DEPARTMENT OF TRANSPORTATION		TYPICAL PAVEMENT MARKINGS	BD600-06 (BD-24)		CONTRACT NO. 63116		
	PLOT DATE = 1/4/2008	DATE - 03-11-94	REVISED - R. BORO 01	-01-07		SCALE: NONE	SHEET NO. 10 OF 10 SHEETS STA. TO STA.	FED. ROAD DIST. NO. 1 ILLINOIS FED. AID PROJECT M-9003(124)				